FOR INDEX OF SHEETS, SEE SHEET NO. 2

FOR INDEX OF HIGHWAY STANDARDS; SEE SHEET 2

PROJECT IS LOCATED IN: CITY OF CHICAGO VILLAGE OF TINLEY PARK VILLAGE OF WILLOWBROOK

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TRAFFIC DATA

I-9094 CURVE AT ADDISON STREET (INTERSTATE) 2009 ADT - 325,400 POSTED SPEED LIMIT 55 MPH DESIGN SPEED 60 MPH

I-9094 EASTBOUND TO OHIO STREET EXIT RAMP (INTERSTATE)
2002 ADT - 22,900
POSTED SPEED LIMIT 30 MPH
DESIGN SPEED 35 MPH


I-80 WESTBOUND TO US ROUTE 45 EXIT RAMP (INTERSTATE)
ADT - UNAVAILABLE
POSTED SPEED LIMIT 30 MPH

IL ROUTE 83 NORTHBOUND TO 1-55 NORTHBOUND RAMP (INTERSTATE)
2012 ADT - 5800
POSTED SPEED LIMIT 35 MPH

I-9094 WESTBOUND TO CERMARK ROAD RAMP S-CURVE (INTERSTATE)
2010 ADT - 2750
POSTED SPEED LIMIT 30 MPH
DESIGN SPEED 30 MPH

I-57 S-CURVE NEAR 107TH STREET (INTERSTATE) 2012 ADT - 139,500 POSTED SPEED LIMIT 55 MPH

I-290 S-CURVE NEAR KOSTNER AVENUE (INTERSTATE)
2012 ADT - 191,300
POSTED SPEED LIMIT 55 MPH

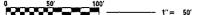

FULL SIZE PLANS HAVE BEEN PREPARED USING STANDARD ENGINEERING SCALES. REDUCED SIZED PLANS WILL NOT CONFORM TO STANDARD SCALES. IN MAKING MEASUREMENTS ON REDUCED PLANS, THE ABOVE SCALES MAY BE USED.

J.U.L.I.E.
JOINT UTILITY LOCATION INFORMATION FOR EXCAVATION
1-800-892-0123
OR 811

PROJECT ENGINEER: STEVE SCHUESSLER (630) 641–9900 (SE3) PROJECT MANAGER: DAN WILGREEN (847) 705–4247 (IDOT) CONTRACT NO. 62A62

STATE OF ILLINOIS

DEPARTMENT OF TRANSPORTATION

DIVISION OF HIGHWAYS

PROPOSED HIGHWAY PLANS

VARIOUS ROUTES

SECTION: 2015-0081

AT VARIOUS EXPRESSWAY CURVES

SAFETY IMPROVEMENTS

PROJECT: ACHSIP-000Y (030)

COOK, DUPAGE AND WILL COUNTIES

C-91-275-15


FOR LOCATION MAPS, SEE SHEET NO. 3

D-91-275-15







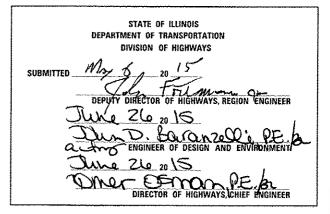

PRINTED BY THE AUTHORITY OF THE STATE OF ILLINOIS

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781001- <i>03</i>	TYPICAL APPLICATIONS RAISED REFLECTIVE PAVEMENT MARKERS
812001	RACEWAY EMBEDDED IN STRUCTURE

COMMITMENTS

THERE ARE NO COMMITMENTS FOR THIS PROJECT.

BENCHMARKS

A SURVEY HAS NOT BEEN PREFORMED AND BENCHMARKS HAVE NOT BEEN ESTABLISHED.

THE EXISTING CENTERLINE AND BASELINE ALIGNMENTS HAVE NOT BEEN SURVEYED. THE ALIGNMENTS ARE SHOWN AT APPROXIMATE LOCATIONS BASED ON AERIAL MAPPING.

GENERAL NOTES

- 1. ALL CONSTRUCTION SHALL BE DONE IN ACCORDANCE WITH THE DETAILS IN THE PLANS. THE SPECIAL PROVISIONS INCLUDED IN THE CONTRACT DOCUMENTS, AND THE LATEST EDITION OF THE FOLLOWING STATE OF ILLINOIS SPECIFICATIONS: "THE STANDARD SPECIFICATIONS FOR ROAD AND BRIDGE CONSTRUCTION" (REFERRED TO AS THE "STANDARD SPECIFICATIONS"). THE "SUPPLEMENTAL SPECIFICATIONS AND RECURRING SPECIAL PROVISIONS", THE "MANUAL ON UNIFORM TRAFFIC CONTROL DEVICES FOR STREETS AND HIGHWAYS", THE "MANUAL OF TEST PROCEDURES FOR MATERIALS" AND THE "STANDARD SPECIFICATIONS FOR WATER AND SEWER MAIN CONSTRUCTION IN ILLINOIS".
- BEFORE STARTING ANY EXCAVATING, THE CONTRACTOR SHALL CALL "JULIE" AT (800) 892-0123 OR 811 FOR FIELD LOCATIONS OF BURIED ELECTRIC. TELEPHONE OR GAS UTILITIES. 48 NOTIFICATION IS REQUIRED.
- THE CONTRACTOR SHALL NOT BE ALLOWED TO SET UP A YARD OR FIELD OFFICE ON STATE PROPERTY WITHOUT WRITTEN CONSENT FROM THE
- 4. THE CONTRACTOR SHALL COORDINATE CONSTRUCTION ACTIVITIES WITH UTILITY COMPANIES AND THE CITY OF CHICAGO, VILLAGE OF TINLEY PARK AND THE VILLAGE OF WILLOWBROOK.
- BUTT JOINTS WILL BE INSTALLED AT THE ENDS OF ALL RESURFACING (WHERE RESURFACING MEETS EXISTING PAVEMENTI, IN ACCORDANCE WITH THE "BUTT JOINT AND TAPER DETAILS" SHEET INCLUDED IN THE PLANS UNLESS OTHERWISE SPECIFIED.
- 6. WHEN MILLED PAVEMENT IS OPEN TO TRAFFIC, THE MAXIMUM GRADE DIFFERENTIAL BETWEEN PASSES OF THE MILLING MACHINE SHALL NOT EXCEED 1 1/2 INCHES WHERE THE SPEED LIMIT IS 45 MPH OR LESS AND 1 INCH WHERE THE SPEED LIMIT IS GREATER THAN 45 MPH. WITH WRITTEN APPROVAL FROM THE ENGINEER, A MAXIMUM GRADE DIFFERENTIAL OF 3 INCHES MAY BE ALLOWED IF THE EDGE OF THE MILLING IS SLOPED AT A MINIMUM OF 1:3 (V:H).
- THE RESIDENT ENGINEER SHALL CONTACT THE AREA TRAFFIC FIELD TECHNICIAN A MINIMUM OF TWO (2) WEEKS PRIOR TO PLACING PERMANENT PAVEMENT MARKINGS.
- 8. THE CONTRACTOR SHALL CONTACT THE DISTRICT ONE EXPRESSWAY TRAFFIC CONTROL SUPERVISOR AT (847) 705-4155 A MINIMUM OF 72 HOURS IN
- THE CONTRACTOR SHALL BE RESPONSIBLE FOR VERIFYING ALL DIMENSIONS AND EXISTING CONDITIONS DURING THE CONSTRUCTION OF THIS PROJECT.
- 10. THE CONTRACTOR SHALL BE RESPONSIBLE FOR THE PROTECTION OF ALL UNDERGROUND OR SURFACE UTILITIES EVEN THOUGH THEY MAY NOT BE SHOWN ON THE PLANS. ANY UTILITY THAT IS DAMAGED DURING CONSTRUCTION SHALL BE REPLACED TO THE SATISFACTION OF THE ENGINEER AT THE CONTRACTOR'S OWN EXPENSE.
- ANY EXISTING STORM SEWER OR STRUCTURES DAMAGED BY THE CONTRACTOR DURING CONSTRUCTION SHALL BE REPLACED TO THE SATISFACTION OF THE ENGINEER AT THE CONTRACTOR'S OWN EXPENSE.
- 12. BEFORE BEGINNING ANY WORK, THE CONTRACTOR SHALL RETAIN AND RECORD FOR FUTURE REFERENCE, ALL EXISTING PAVEMENT MARKING LINES (AND RAISED REFLECTIVE PAVEMENT MARKERS) IN ORDER THAT THESE LOCATIONS CAN BE RE-ESTABLISHED FOR STRIPING. EXACT LOCATIONS OF ALL PAVEMENT MARKINGS SHALL BE AS DIRECTED BY THE ENGINEER.
- 13. DURING CONSTRUCTION OPERATIONS, IF ANY LOOSE MATERIAL IS DEPOSITED IN THE FLOW LINE OF DRAINAGE STRUCTURES SUCH THAT THE NATURAL FLOW OF WATER IS OBSTRUCTED. THE MATERIAL SHALL BE REMOVED AT THE CLOSE OF EACH WORKING DAY. AT THE CONCLUSION OF CONSTRUCTION OPERATIONS, ALL UTILITY STRUCTURES SHALL BE FREE FROM DUST AND DEBRIS. THE WORK SPECIFIED ABOVE WILL NOT BE PAID SEPARATELY BUT SHALL BE INCLUDED IN THE COST OF THE CONTRACT.
- 14. THE CONTRACTOR SHALL BE RESPONSIBLE FOR VERIFYING ALL DIMENSIONS AND EXISTING CONDITIONS DURING THE CONSTRUCTION OF THIS PROJECT.
- 15. THE THICKNESS OF HMA SHOWN ON THE PLANS IS THE NOMINAL THICKNESS. DEVIATIONS FROM THE NOMINAL THICKNESS WILL BE PERMITTED WHEN SUCH DEVIATIONS OCCUR DUE TO IRREGULARITIES IN THE EXISTING SURFACE OR BASE ON WHICH THE HMA IS PLACED.
- 16. BEFORE STARTING ANY WORK, THE CONTRACTOR SHALL CONTACT ROY LAWSON WITH THE BUREAU OF TRAFFIC AND ELECTRICAL OPERATIONS AT (708) 524-2145 TO AVOID POSSIBLE CONFLICTS WITH EXISTING UNDERGROUND CONDUIT AT VARIOUS LOCATIONS THROUGHOUT THE CONTRACT.

COUNTY

TOTAL SHEE SHEETS NO.


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CONTRACT NO. 62A62


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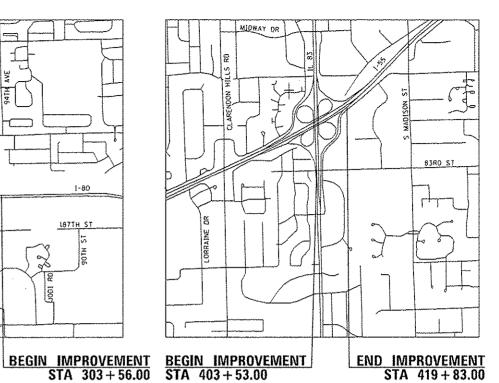
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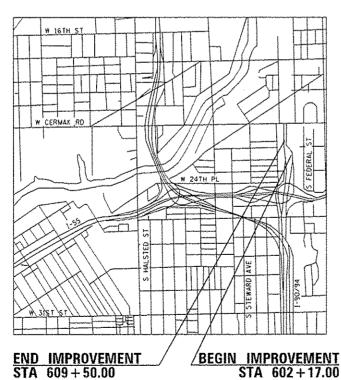



CITY OF CHICAGO, COOK COUNTY


I-90/94 EASTBOUND TO OHIO STREET EASTBOUND RAMP CITY OF CHICAGO, COOK COUNTY

I-80 WESTBOUND TO US ROUTE 45 RAMP VILLAGE OF TINLEY PARK, WILL COUNTY

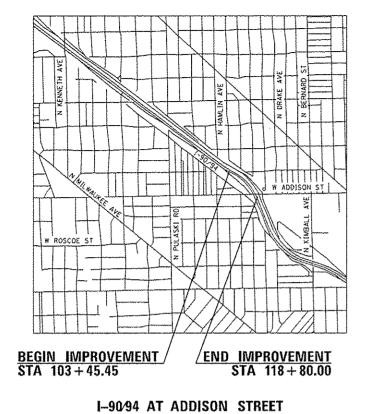IL ROUTE 83 NORTHBOUND TO I-55 NORTHBOUND RAMP VILLAGE OF WILLOWBROOK, DUPAGE COUNTY

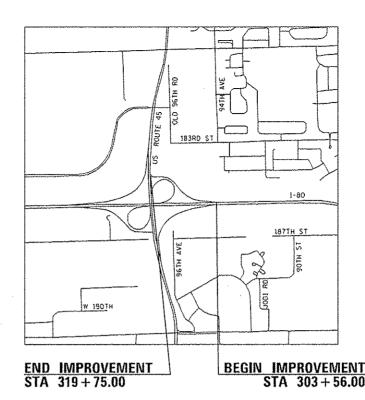

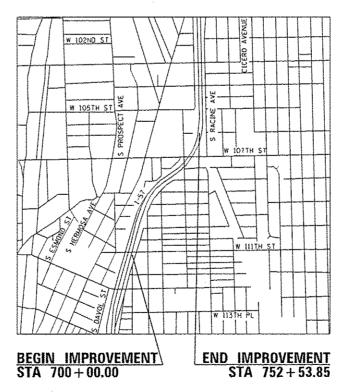

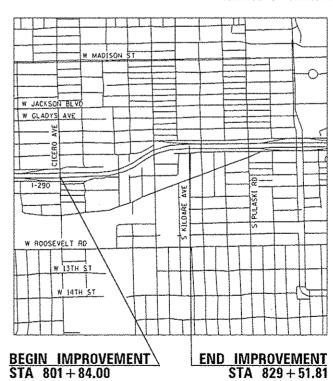

I-90/94 WESTBOUND TO CERMARK ROAD RAMP S-CURVE CITY OF CHICAGO, COOK COUNTY

I-57 (S-CURVE NEAR 107TH STREET) CITY OF CHICAGO, COOK COUNTY

I-290 (S-CURVE NEAR KOSTNER AVENUE) CITY OF CHICAGO, COOK COUNTY

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	SUMMARY OF QUANTITIES		URBAN	CONST	RUCTION TYP	ION TYPE CODE		
CODE NO.	ITEM	UNIT	TOTAL QUANTITY	COOK COUNTY	FED 90% STATE 10% DUPAGE COUNTY 0021	FED 90% STATE 10% WILL COUNTY 0021		
2010140	O NITROGEN FERTILIZER NUTRIENT	POUND	14	14				
2010150	O PHOSPHORUS FERTILIZER NUTRIENT	POUND	14	14				
2010160	O POTASSIUM FERTILIZER NUTRIENT	POUND	14	14				
				-				
2020010	0 EARTH EXCAVATION	CU YD	60	60				
21101600	TOPSOIL FURNISH AND PLACE, VARIABLE DEPTH	SO YD	445	446				
21101615	TOPSOIL FURNISH AND PLACE, 4"	SQ YD	290	290				
2500021	O SEEDING, CLASS 2A	ACRE	0.25	0.25				
2510063	0 EROSION CONTROL BLANKET	SO YO	1056	1056				
2800051	O INLET FILTERS	EACH	12	12				
406002	75 BITUMINOUS MATERIALS (PRIME COAT)	POUND	1649	1649				
4060040	DO MIXTURE FOR CRACKS, JOINTS, AND FLANGEWAYS	TON	6	6				
4060359	DS POLYMERIZED HOT-MIX ASPHALT SURFACE COURSE, MIX "F", N90	TON	410	410				
4400015	7 HOT-MIX ASPHALT SURFACE REMOVAL. 2"	SO YD	3665	3665				
440042	50 PAVED SHOULDER REMOVAL	SO YO	21	21	u na			
14	The second second of the secon			,				

	•	SUMMARY OF QUANTITIES		URBAN	CONSTR	RUCTION TYP	E CODE
	CODE NO.	· ITEM	UNIT	TOTAL OUANTITY	FED 90% STATE 10% COOK COUNTY 0021	FED 90% STATE 10% DUPAGE COUNTY 0021	FED 90% STATE 10% WILL COUNTY 0021
	44213202	TIE BARS 1"	EACH	37	37		
	48101498	AGGREGATE SHOULDERS, TYPE B 4"	SO YD	94	94		
	50102400	CONCRETE REMOVAL	CU YD	14.5	14.5		
	50300225	CONCRETE STRUCTURES	CU YD	9.3	9.3		
	50300300	PROTECTIVE COAT	SO YO	65	65		
X	63100089	TRAFFIC BARRIER TERMINAL, TYPE 6B	EACH	1	1		
*	63100167	TRAFFIC BARRIER TERMINAL, TYPE 1 (SPECIAL) TANGENT	EACH	1	1		
	63500105	DELINEATORS	EACH	180		97	83
	64200116	SHOULDER RUMBLE STRIPS, 16 INCH	FOOT	8414	8414		
	64300260	IMPACT ATTENUATORS (FULLY REDIRECTIVE, NARROW), TEST LEVEL 3	EACH	2	2		
¥	66900200	NON-SPECIAL WASTE DISPOSAL	cu yo	60	60		
¥	66900450	SPECIAL WASTE PLANS AND REPORTS	L SUM	1	1		
*	66900530	SOIL DISPOSAL ANALYSIS	EACH	2	S		
	67100100	MOSILIZATION	L SUM	1	0.7	0.15	0.15
	14						

· SPECIALTY ITEMS

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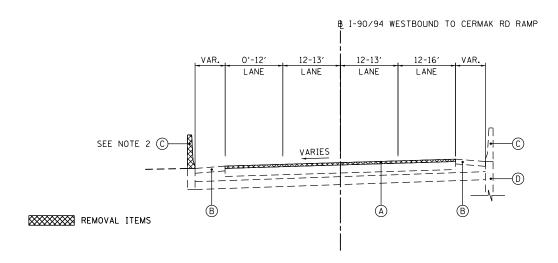
STATE OF ILLINOIS
DEPARTMENT OF TRANSPORTATION

SUMMARY OF QUANTITIES									SECTION	COUNTY	Ş
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<u></u>	SUMMARY OF QUANTITIES		URBAN	CONSTI	RUCTION TYP	E CODE	SUMMARY OF QUANTITIES							URBAN	CONST	RUCTION TYP	E CODE
CODE NO.	ITEM	UNIF	TOTAL OUANTITY	COUNTY	FED 90% STATE 10% DUPAGE COUNTY 0021	FED 90% STATE 10% WILL COUNTY 0021	Andreas de la companya del la companya de la companya del la companya de la compa	CODE NO.	***************************************		ITEM		UNIT	TOTAL	FED 90% STATE 10% COOK COUNTY DO21	FED 90% STATE 10% DUPAGE COUNTY 0021	FED 90% STATE 10% WILL COUNTY 0021
					0001			110.						COANTITI	0021	0021	002.
70300210	TEMPORARY PAVEMENT MARKING LETTERS AND SYMBOLS	SO FT	292	292			•	78100100	RAISED REFLEC	CTIVE PAVEMENT M	MARKER		EACH	38	38		
70300220	TEMPORARY PAVEMENT MARKING - LINE 4"	FOOT	2960	2960			*	78200100	MONODIRECTION	NAL PRISMATIC BA	ARRIER REFLECTOR		EACH	527	527		
70300230	TEMPORARY PAVEMENT MARKING - LINE S"	FOOT	640	640			* 1	78200200	BIDIRECTIONAL	PRISMATIC BARRI	IER REFLECTOR		EACH	78	78		
70300240	TEMPORARY PAVEMENT MARKING - LINE 6"	FOOT	230	230			*	78200410	GUARDRAIL MAF	RKERS, TYPE A			EACH	8	8		
70300250	TEMPORARY PAVEMENT MARKING - LINE 8"	FOOT	830	058			*	78200530	BARRJER WALL	MARKERS, TYPE C	<u> </u>		EACH	27	27		
70300260	TEMPORARY PAVEMENT MARKING - LINE 12"	FOOT	42	42			*	78201000	TERMINAL MARI	KER - DIRECT APP	PLIED		EACH	1	. 1		
70301000	WORK ZONE PAVEMENT MARKING REMOVAL	SO FT	2256	2256				78300100	PAVEMENT MAR	KING REMOVAL			SQ FT	925	925		
70400100	TEMPORARY CONCRETE BARRIER	FOOT	575	575				78300200	RAISED REFLEC	CTIVE PAVEMENT M	WARKER REMOVAL		EACH	30	30		
												1.1.7.50 CTGG					
10600260	IMPACT ATTENUATORS, TEMPORARY (FULLY REDIRECTIVE, NARROW), TEST LEVEL :	5 EALH	4	4			* 8	81200130	CONDUIT EMBER	DUED IN STRUCTUR	RE, 2 1/2" DIA., GALV	ANIZED SIEEL	FOOT	6	6		
* 78000200	THERMOPLASTIC PAVEMENT MARKING - LINE 4"	FOOT	2076	2076			* 8	81200240	CONDUIT EMBEE	DDED IN STRUCTUR	RE, 2 1/2" DIA., PVC		FOOT	65	65		
* 78000500	THERMOPLASTIC PAVEMENT MARKING - LINE 8"	FOOT	415	415			• 8	81300550	JUNCTION BOX.	, STAINLESS STEEL	L. ATTACHED TO STRU	CTURE, 12" X 12" X (5" EACH	1	1		
* 78000600	THERMOPLASTIC PAVEMENT MARKING - LINE 12"	FOOT	165	165			• 8	81702140	ELECTRIC CABL	E IN CONDUIT. 60	OOV (XLP-TYPE USE) 1	/C NO. 4	FOOT	335	335		
• 78003100	PREFORMED PLASTIC PAVEMENT MARKING, TYPE B - LETTERS AND SYMBOLS	SO FT	437	437			• 8	81702400	ELECTRIC CABL	E IN CONDUIT, 60	DOV (XLP-TYPE USE) 3	-1/C NO. 2	FOOT	335	335		
• 78003120	PREFORMED PLASTIC PAVEMENT MARKING, TYPE B - LINE 5"	FOOT	365	365			• 8	89502300	REMOVE ELECT	RIC CABLE FROM C	CONDUIT		FOOT	670	670		
• 78003130	PREFORMED PLASTIC PAVEMENT MARKING, TYPE B - LINE 6"	FOOT	826	826			• X	×0326364	TEMPORARY AEI	RIAL CABLE WITH	MESSENGER WIRE		FOOT	260	260		
• 78003180	PREFORMED PLASTIC PAVEMENT MARKING, TYPE B - LINE 24"	FOOT	120	120		A STATE OF THE STA	X	x7011015	TRAFFIC CONTR	ROL AND PROTECT!	ION (EXPRESSWAYS)		L SUM	ı	0.7	0.15	0.15
SPECIALTY	(TEMS						* X	×8130125	REMOVE EXISTI	ING JUNCTION BOX	(EACH	**	1		
							• 7	Z0033028	MAINTENANCE C	OF LIGHTING SYSTE	FM		CAL MÓ	2	2		
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					,			Z0048665 (⁰ \	RAILROAD PROT	TECTIVE LIABILITY	Y INSURANCE		L SUM	1	1		
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W05,HSIP.500-82.dgn



EXISTING I-90/94 WESTBOUND TO CERMAK RD RAMP S-CURVE

STATION 602+17.00 TO STATION 609+50.00

EXISTING RAMP LEGEND:

- A HMA SURFACE COURSE
- B HMA SHOULDER
- C CONCRETE BARRIER WALL
- RETAINING WALL

GENERAL NOTE:


- THE CONTRACTOR SHALL FIELD VERIFY EXISTING DIMENSIONS AND PAVEMENT SLOPES BEFORE BEGINNING WORK.
- 2. REFER TO SHEET 16 FOR CONCRETE BARRIER WALL REMOVAL LIMITS.

MIXTURE TABLE

MIXTURE TYPE	AIR VOIDS	QMP
PAVEMENT RESURFACING/WIDENING		
I-90/94 WESTBOUND TO CERMAK RD RAMP		
POLYMERIZED HOT-MIX ASPHALT SURFACE COURSE (IL 9.5mm), MIX "F", N90	4.0% @ 90 Gyr.	QC/QA
QMP DESIGNATION: QUALITY CONTROL/QUALITY ASSURANCE (QC/QA)		

GENERAL NOTE:

- 1. THE "AC TYPE" FOR POLYMERIZED MIXTURES SHALL BE "SBS/SBR PG 76-22", FOR NON-POLYMERIZED HMA THE "AC TYPE" SHALL BE "PG 64-22" UNLESS MODIFIED BY THE DISTRICT ONE SPECIAL PROVISIONS.
- 2. FOR USE OF RECYCLED MATERIALS SEE DISTRICT ONE SPECIAL PROVISIONS.
- 3. QUALITY MANAGEMENT PROGRAM IDENTIFIES THE PARTICULAR QUALITY CONTROL SPECIFICATION THAT APPLIES TO THE HMA MIXTURE.

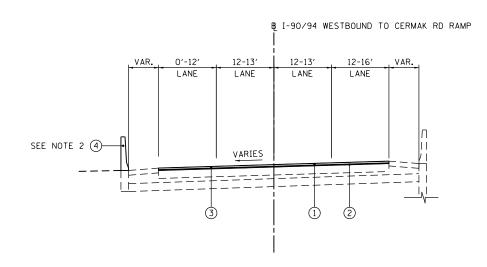

PROPOSED I-90/94 WESTBOUND TO CERMAK RD RAMP

STATION 602+17.00 TO STATION 609+50.00

PROPOSED RAMP LEGEND:

- 1 POLYMERIZED HOT-MIX ASPHALT SURFACE COURSE, MIX "F", N90 (40603595) (2")
- ② BITUMINOUS MATERIALS (PRIME COAT) (40600275)
- 3 HOT-MIX ASPHALT SURFACE REMOVAL, 2" (44000157)
- (4) CONCRETE STRUCTURES (50300300)

GENERAL NOTE:

1. REFER TO SHEET 16 FOR CONCRETE BARRIER WALL DETAILS AND LIMITS.

F	FILE NAME =	USER NAME = Steve	DESIGNED - SMS	REVISED -		TYPICAL SECTIONS	F.A. S	ECTION	COUNTY S	OTAL	SHEET
- 1	WO6_HSIP_typical01.dgn		DRAWN - SVJ	REVISED -	STATE OF ILLINOIS		VAR. 20	15-0081	VAR.	29	6
		PLOT SCALE = 100.0000 ' / in.	CHECKED - DGW	REVISED -	DEPARTMENT OF TRANSPORTATION	I-90/94 WESTBOUND TO CERMAK ROAD RAMP S-CURVE			CONTRACT I	NO. 67	2A62
- 1	Default	PLOT DATE = 5/12/2015	DATE -	REVISED -		SCALE: NTS SHEET 6 OF 29 SHEETS STA. TO STA.		ILLINOIS FED. AI	D PROJECT		

FILE NAME =	USER NAME = Steve	DESIGNED - SMS	KENIZED -	
W06_HSIP_schedule-01.dgn		DRAWN - SVJ	REVISED -	STATE OF ILLINOIS
	PLOT SCALE = 100.00000 '/ 10.	CHECKED - DGW	REVISED -	DEPARTMENT OF TRANSPORTATION
Default	PLOT DATE = 5/12/2015	DATE -	REVISED -	

STATE OF ILLINOIS	3
DEPARTMENT OF TRANSPO	PRTATION

l I							F.A. RTE.	SECTION	COUNTY	TOTAL SHEETS	SHEET NO.	
	SCHEDULE OF QUANTITIES					VAR.	2015-0081	VAR.	29	7		
							CONTRACT	NO. (62A62			
SCALE:	SHEET	7	OF	29	SHEETS	STA.	TO STA.		ILLINOIS FED. A	D PROJECT		

20101600	POTASSIUM FERTILIZER NUTRIENT				
FROM	ТО	TOTAL (POUND)			
I-90/94 AT ADDISON STREET COOK COUNTY					
115+60	117+05	RT	4.7		
I-90/94 EASTBOUND TO OHIO STREET EASTBOUND RAMP COOK COUNTY					
204+16	204+46	RT	4.3		
204+85 205+16		LT	4.7		
	9.0				
	14				

HOT-MIX ASPHALT PAVING SCHEDULE

I-90/94 WESTBOUND TO CERMAK RD RAMP S-CURVE COOK COUNTY

733

NITROGEN FERTILIZER NUTRIENT

OFFSET

RT

LT

PHOSPHORUS FERTILIZER NUTRIENT

OFFSET

LT

I-90/94 AT ADDISON STREET COOK COUNTY

I-90/94 EASTBOUND TO OHIO STREET EASTBOUND RAMP COOK COUNTY

I-90/94 AT ADDISON STREET

COOK COUNTY

I-90/94 EASTBOUND TO OHIO STREET EASTBOUND RAMP COOK COUNTY

LENGTH AVE. WIDTH

45

TOTALS

TOTAL

(POUND)

4.7

4.3

4.7

9.0

14

TOTAL (POUND)

4.7

4.3

4.7

9.0

14

FEET FEET

LOCATION

STATION TO STATION

602+17 TO 609+50

115+60 117+05

204+16 204+46

115+60 117+05

204+46

205+16

SUBTOTAL

TOTAL

205+16

SUBTOTAL TOTAL

204+85

20101500

FROM

204+16

204+85

20101400

FROM

21101013	101 30
FROM	ТО
	I-90/94 /
115+60	117+05
I-90/94 EAS	STBOUND TO
204+17	204+46
204+85	205+16
	SUBTO:
	TOTA

40600275

BITUMINOUS

MATERIALS

(PRIME COAT)

WEIGHT

POUND

1649

1649

20200100

FROM

115+60

204+16

204+85

21101600

FROM

203+32

203+25

AREA

SO YD

3665.00

3665.00

40600400

MIXTURE FOR

CRACKS, JOINTS,

WEIGHT

TON

6

6

TO

117+05

204+46

205+16

204+17

204+85

SUBTOTAL

TOTAL

40603595 POLYMERIZED HOT-MIX

ASPHALT SURFACE

WEIGHT

TONS

410

410

TOTAL

(CU YD)

40

8

8

16

60

TOTAL (SQ YD)

212

234

AND FLANGEWAYS COURSE, MIX "F", N90 (2"

EARTH EXCAVATION

OFFSET

RT

TOPSOIL FURNISH AND PLACE, VARIABLE

DEPTH

OFFSET

LT

-90/94 EASTBOUND TO OHIO STREET EASTBOUND RAMP

COOK COUNTY

I-90/94 AT ADDISON STREET

COOK COUNTY

I-90/94 EASTBOUND TO OHIO STREET EASTBOUND RAMP COOK COUNTY

21101615 TOPSOIL FURNISH AND PLACE, 4"					
FROM	ТО	TOTAL (SQ YD)			
I-90/94 AT ADDISON STREET COOK COUNTY					
115+60	250				
I-90/94 EASTBOUND TO OHIO STREET EASTBOUND RAMP					
204+17	204+46	RT	20		
204+85	205+16	LT	20		
	SUBTOTA	\L	40		
	TOTAL		290		

	TOTAL		446
			'
15	102501	IL FURNISH AND P	LACE, 4"
	то.	OFFCET	TOTAL
	ТО	OFFSET	(SQ YD)
		T ADDISON STREET	
	C00	OK COUNTY	
0	117+05	RT	250
EA:		OHIO STREET EAS	TBOUND RAMP
	CO(OK COUNTY	
7	204+46	RT	20
5	205+16	LT	20
	SUBTOTA	AL.	40
TOTAL 290			

25100630	25100630 EROSION CONTROL BLANKET					
FROM	ТО	OFFSET	TOTAL (SQ YD)			
I-90/94 AT ADDISON STREET COOK COUNTY						
115+60	115+60 117+05 RT					
I-90/94 EAS		OHIO STREET EAS OK COUNTY	TBOUND RAMP			
204+16	204+46	RT	392			
204+85 205+16		LT	414			
	SUBTOTAL 806					
	SUBTOTA	AL.	806			

25000210	SEEDING, CLASS 2A					
FROM	ТО	OFFSET	TOTAL (ACRE)			
I-90/94 AT ADDISON STREET COOK COUNTY						
115+60	117+05	RT	0.052227			
90/94 EASTBOUND TO OHIO STREET EASTBOUND RAMP COOK COUNTY						
204+16	204+46	RT	0.047934			
204+85	205+16	LT	0.052479			
	0.100413					
•	0.25					
			,			

25000210	SEEDING, CLASS 2A					
FROM	ТО	TOTAL (ACRE)				
I-90/94 AT ADDISON STREET COOK COUNTY						
115+60 117+05 RT 0.052227						
-90/94 EASTBOUND TO OHIO STREET EASTBOUND RAMP COOK COUNTY						
204+16	204+46	RT	0.047934			

FROM	ТО	OFFSET	TOTAL (ACRE)			
I-90/94 AT ADDISON STREET COOK COUNTY						
115+60	117+05	RT	0.052227			

FROM	ТО	OFFSET	TOTAL (ACRE)
115+60	0.052227		

FILE NAME = W06_HSIP_schedule-02.dan

USER NAME = Steve	DESIGNED	-	SMS	REVISED	-
	DRAWN	-	SVJ	REVISED	-
PLOT SCALE = 100.00000 '/ 10.	CHECKED	-	DGW	REVISED	-
PLOT DATE = 5/12/2015	DATE	-		REVISED	-

DEP

STATE	OF	ILLINOIS
PARTMENT	OF	TRANSPORTATION

COULT OF CHANTEE					F.A. RTE.	SECTION	COUNTY	TOTAL SHEETS	SHEET NO.		
SCHEDULE OF QUANTITIES				VAR.	2015-0081	VAR.	29	8			
									CONTRACT	NO. 6	2A62
SHEET	8	OF	29	SHEETS	STA.	TO STA.		ILLINOIS FED. AI	D PROJECT		

44000157	JUIST HUT-MIX ASPHALT SURFACE REMOVAL, 2					
FROM	FROM TO OFFSET					
I-90/94 WESTBOUND TO CERMAK RD RAMP S-CURVE COOK COUNTY						
602+17	609+50	LT / RT	3.665			
	3,665					

607+00	607+69.7	LT	9.3			
	TOTAL		14.5			
44000157 HOT-MIX ASPHALT SURFACE REMOVAL, 2"						
FROM	ТО	OFFSET	TOTAL (SQ YD)			
I-90/94 WESTBOUND TO CERMAK RD RAMP S-CURVE COOK COUNTY						
602+17	609+50	LT / RT	3.665			

607+00	607+69.7	LT	9.3			
	TOTAL		14.5			
44000157 HOT-MIX ASPHALT SURFACE REMOVAL, 2"						
FROM	ТО	OFFSET	TOTAL (SO YD)			
I-90/94 WESTBOUND TO CERMAK RD RAMP S-CURVE COOK COUNTY						
602+17	609+50	LT / RT	3.665			

44004250

ΤO

117+06

TOTAL

TOTAL

TOTAL

TO

204+47

205+29

SUBTOTAL

FROM

116+51

44213202

FROM

48101498

50102400

204+20

205+04

FROM

607+00 607+69.7

115+75 117+06

116+78 117+06

PAVED SHOULDER REMOVAL

OFFSET

TIE BARS 1"

OFFSET

AGGREGATE SHOULDERS, TYPE B 4"

OFFSET

RT

CONCRETE REMOVAL

OFFSET

I-90/94 AT ADDISON STREET COOK COUNTY

-90/94 EASTBOUND TO OHIO STREET EASTBOUND RAMP COOK COUNTY

I-90/94 WESTBOUND TO CERMAK RD RAMP S-CURVE COOK COUNTY

I-90/94 AT ADDISON STREET COOK COUNTY

I-90/94 WESTBOUND TO CERMAK RD RAMP S-CURVE COOK COUNTY

I-90/94 AT ADDISON STREET COOK COUNTY

TOTAL (SQ YD)

21

21

TOTAL

(EACH)

37

37

TOTAL (SQ YD)

94

94

(CU YD)

1.7

1.8

1.7

3.5

63500105	DELINEATORS (AMBER)					
FROM	ТО	OFFSET	TOTAL (EACH)			
1		UND TO US 45 RAI LL COUNTY	MP			
304+22	319+75	LT	40			
IL 83 N	IL 83 NORTHBOUND TO I-55 NORTHBOUND RAMP DUPAGE COUNTY					
404+41 419+14 LT 46						
	TOTAL 86					

63500105	С	DELINEATORS (AMBER)			
FROM	то	OFFSET	TOTAL (EACH)		
I-80 WESTBOUND TO US 45 RAMP WILL COUNTY					
304+22	319+75	LT	40		
IL 83 NORTHBOUND TO I-55 NORTHBOUND RAMP DUPAGE COUNTY					
404+41	46				
	86				

50300300	PROTECTIVE COAT				
FROM	ТО	OFFSET	TOTAL (SQ YD)		
I-90/94 WESTBOUND TO CERMAK RD RAMP S-CURVE COOK COUNTY					
607+00	607+69.7	LT	64.2		
TOTAL 65					

50300225

FROM

116+58

63100167

FROM

116+03

FROM

TO

TOTAL

607+00 607+69.7

50300300	PROTECTIVE COAT					
FROM	ТО	TOTAL (SQ YD)				
I-90/94 WESTBOUND TO CERMAK RD RAMP S-CURVE COOK COUNTY						
607+00 607+69.7 LT			64.2			
	TOTAL 65					
63100089 TRAFFIC BARRIER TERMINAL, TYPE 6B						

OFFSET

RT

TRAFFIC BARRIER TERMINAL, TYPE 1 (SPECIAL) TANGENT

RT

I-90/94 AT ADDISON STREET COOK COUNTY

I-90/94 AT ADDISON STREET COOK COUNTY

117+06

TO

116+58

TOTAL

TOTAL

50300300	PROTECTIVE COAT						
FROM	то	TOTAL (SQ YD)					
I-90/94 WESTBOUND TO CERMAK RD RAMP S-CURVE COOK COUNTY							
607+00	607+00 607+69.7 LT						
	TOTAL 65						
	·						

50300300	PROTECTIVE COAT			
FROM	то	OFFSET	TOTAL (SQ YD)	
I-90/94 WESTBOUND TO CERMAK RD RAMP S-CL COOK COUNTY				
607+00	607+69.7	LT	64.2	
TOTAL			C E	

CONCRETE STRUCTURES

OFFSET

LT

I-90/94 WESTBOUND TO CERMAK RD RAMP S-CURVE COOK COUNTY

TOTAL (CU YD)

9.3

9.3

TOTAL

(EACH)

TOTAL (EACH)

SCALE:

63500105	DELINEATORS (CRYSTAL)				
FROM	ТО	OFFSET	TOTAL (EACH)		
I	I-80 WESTBOUND TO US 45 RAMP WILL COUNTY				
303+56	319+75	RT	43		
IL 83 NORTHBOUND TO I-55 NORTHBOUND RAMP DUPAGE COUNTY					
403+53	419+83	RT	51		
1					

64200116	SHOULDER RUMBLE STRIPS, 16 INCH				
FROM	ТО	OFFSET	TOTAL (FOOT)		
103+45	118+56	EB LT	1,474		
103+45	107+40	EB RT	409		
109+30	118+10	EB RT	815		
103+45	113+08	WB LT	970		
116+50	118+80	WB LT	245		
103+45	118+56	WB RT	1,521		
103+45	118+50	EXPRESS LN-RT	1,480		
103+45	118+56	EXPRESS LN-LT	1,500		
	TOTAL		8,414		

64300260	IMPACT ATTENUATORS (FULLY REDIRECTIVE, NARROW), TEST LEVEL 3			
FROM	ТО	OFFSET	TOTAL (EACH)	
-90/94 EASTBOUND TO OHIO STREET EASTBOUND RAMP COOK COUNTY				
204+17	204+37	RT	1	
204+86	205+06	LT	1	
	2			

63500105	DELINEATORS (CRYSTAL)			
FROM	ТО	OFFSET	TOTAL (EACH)	
I-80 WESTBOUND TO US 45 RAMP WILL COUNTY				
303+56	319+75	RT	43	
IL 83 NORTHBOUND TO I-55 NORTHBOUND RAMP DUPAGE COUNTY				
403+53	419+83	RT	51	
TOTAL			94	

70300210	TEMPORARY PAVEMENT MARKING LETTERS AND SYMBOLS			
FROM	TO OFFSET TOTAL (SQ FT)			
I-90/94 WESTBOUND TO CERMAK RD RAMP S-CURVE COOK COUNTY				
608+48	608+80	RT / LT	291.2	
TOTAL 292				

NOTE: INCLUDES ONE APPLICATION AFTER MILLING AND ONE APPLICATION AFTER SURFACE COURSE.

70300220	TEMPORARY PAVEMENT MARKING - LINE 4" (YELLOW EDGE LINE)			
FROM	TO OFFSET TOTAL (FOOT)			
I-90/94 WESTBOUND TO CERMAK RD RAMP S-CURVE COOK COUNTY				
602+17	609+50	LT	1,480	
TOTAL			1,480	

NOTE: INCLUDES ONE APPLICATION AFTER MILLING AND ONE APPLICATION AFTER SURFACE COURSE.

70300220	TEMPORARY PAVEMENT MARKING - LINE 4" (WHITE EDGE LINE)			
FROM	ТО	OFFSET	TOTAL (FOOT)	
I-90/94 WESTBOUND TO CERMAK RD RAMP S-CURVE COOK COUNTY				
602+17	609+50	RT	1,480	
TOTAL			1,480	

NOTE: INCLUDES ONE APPLICATION AFTER MILLING AND ONE APPLICATION AFTER SURFACE COURSE.

70300230	TEMPORARY PAVEMENT MARKING - LINE 5" (WHITE LANE LINES, SKIP-DASH)			
FROM	TO OFFSET TOTAL (FOOT)			
I-90/94 WESTBOUND TO CERMAK RD RAMP S-CURVE COOK COUNTY				
602+17	640			
	640			

NOTE: INCLUDES ONE APPLICATION AFTER MILLING AND ONE APPLICATION AFTER SURFACE COURSE.

70300240	TEMPORARY PAVEMENT MARKING - LINE 6" (WHITE LANE LINES)			
FROM	ТО	OFFSET	TOTAL (FOOT)	
I-90/94 WESTBOUND TO CERMAK RD RAMP S-CURVE COOK COUNTY				
608+35	609+50	CL	230	
TOTAL 230				

NOTE: INCLUDES ONE APPLICATION AFTER MILLING AND ONE APPLICATION AFTER SURFACE COURSE.

70300250	TEMPORARY PAVEMENT MARKING - LINE 8" (WHITE GORE LINES)			
FROM	ТО	OFFSET	TOTAL (FOOT)	
I-90/94 WESTBOUND TO CERMAK RD RAMP S-CURVE COOK COUNTY				
602+17	604+21	RT	830	
TOTAL 830				
NATE INCLUDES ONE IDENTIFICATION LETER HIS INC.				

NOTE: INCLUDES ONE APPLICATION AFTER MILLING AND ONE APPLICATION AFTER SURFACE COURSE.

70300260	TEMPORARY PAVEMENT MARKING - LINE 12" (WHITE DIAGONAL LINES)			
FROM	TO OFFSET TOTAL (FOOT)			
I-90/94 WESTBOUND TO CERMAK RD RAMP S-CURVE COOK COUNTY				
602+17	603+56	RT	42	
TOTAL			42	

NOTE: INCLUDES ONE APPLICATION AFTER MILLING AND ONE APPLICATION AFTER SURFACE COURSE.

70301000	WORK ZON	NE PAVEMENT MARK	ING REMOVAL
FROM	ТО	OFFSET	TOTAL (SQ FT)
I-90/94		TO CERMAK RD RA	AMP S-CURVE
TEMPORARY	/ PAVEMENT	MARKING LETTERS	AND SYMBOLS
608+48	608+80	RT / LT	292.0
ТЕМІ		EMENT MARKING - OW EDGE LINE)	LINE 4"
602+17	609+50	LT	493.3
ТЕМІ		EMENT MARKING - TE EDGE LINE)	LINE 4"
602+17	609+50	RT	493.3
TEMI		EMENT MARKING - IE LINES, SKIP-DAS	
602+17	609+50	RT / LT	266.7
TEM		EMENT MARKING - E LANE LINES)	LINE 6"
608+35	609+50	CL	115.0
TEMI		EMENT MARKING - E GORE LINES)	LINE 8"
602+17	604+21	RT	553.3
TEMF		MENT MARKING - DIAGONAL LINES)	LINE 12''
602+17	603+56	RT	42.0
	TOTAL		2,256
NOTE THE		REMOVAL FROM	

NOTE: INCLUDES ONE REMOVAL FROM MILLED SURFACE AND ONE REMOVAL FROM SURFACE COURSE.

70400100	TEMF	PORARY CONCRETE	BARRIER		
FROM	ТО	TO OFFSET TOTAL (FOOT)			
		AT ADDISON STREE OOK COUNTY	Т		
115+14.31	117+19.93	RT	200		
I-90/94 E		O OHIO STREET EA OOK COUNTY	STBOUND RAMP		
203+57.86	204+43.35	RT	100		
203+55.91	205+20.17	LT	150		
SUBTOTAL 250			250		
I-90/94		TO CERMAK RD RA	MP S-CURVE		
606+33.13	607+47.96	LT	125		
	TOTAL		575		

70600260	IMPACT ATTENUATORS, TEMPORARY (FULLY REDIRECTIVE, NARROW), TEST LEVEL 3		
FROM	ТО	OFFSET	TOTAL (EACH)
		AT ADDISON STREE OOK COUNTY	Т
115+14.31		RT	1
I-90/94 EA		O OHIO STREET EA OOK COUNTY	STBOUND RAMP
204+57.86		RT	1
203+55.91		LT	1
	SUBTOTA	NL	2
I-90/94		TO CERMAK RD RA	AMP S-CURVE
606+33.13		LT	1
	TOTAL		4

78000600		PLASTIC PAVEMENT WHITE DIAGONAL SI	
FROM	ТО	OFFSET	TOTAL (FOOT)
I-90/94		TO CERMAK RD RA	MP S-CURVE
604+62	608+48	RT	72
602+17	603+56	RT	21
	•		
	TOTAL		93

78000600		PLASTIC PAVEMENT ELLOW DIAGONAL S	
FROM	ТО	OFFSET	TOTAL (FOOT)
I-90/94		TO CERMAK RD RA	MP S-CURVE
604+50	608+22	LT	72
	TOTAL		72

SCALE:

78003100		D PLASTIC PAVEM LETTERS AND SYN & ARROWS)	
FROM	ТО	OFFSET	TOTAL (SQ FT)
I-90/94		TO CERMAK RD RA	MP S-CURVE
608+48	608+80	RT / LT	145.6
610+09	610+41	RT / LT	145.6
611+69	612+01	RT / LT	145.6
	TOTAL	-	437

78000200	THERMOPLASTIC PAVEMENT MARKING - LINE 4" (YELLOW EDGE LINE)		
FROM	ТО	OFFSET	TOTAL (FOOT)
I-90/94 WESTBOUND TO CERMAK RD RAMP S-CURVE COOK COUNTY			
602+17	612+48	LT	1,038
	TOTAL		1,038

78000200	THERMOPLASTIC PAVEMENT MARKING - LINE 4" (WHITE EDGE LINE)		
FROM	ТО	OFFSET	TOTAL (FOOT)
I-90/94 WESTBOUND TO CERMAK RD RAMP S-CURVE COOK COUNTY			
602+17	612+48	RT	1,038
	TOTAL		1,038

78003120		D PLASTIC PAVEM - LINE 5'' (WHITE SKIP-DASH)	
FROM	ТО	OFFSET	TOTAL (FOOT)
I-90/94 WESTBOUND TO CERMAK RD RAMP S-CURVE COOK COUNTY			
602+17	612+48	RT / LT	365
	TOTAL		365

78003130	PREFORMED PLASTIC PAVEMENT MARKING, TYPE B - LINE 6" (WHITE LANE LINES)		
FROM	ТО	OFFSET	TOTAL (FOOT)
I-90/94 WESTBOUND TO CERMAK RD RAMP S-CURVE COOK COUNTY			
608+35	612+48	CL	826
TOTAL 826			

78000500	THERMOPLASTIC PAVEMENT MARKING - LINE 8" (WHITE GORE LINES)		
FROM	ТО	OFFSET	TOTAL (FOOT)
I-90/94 WESTBOUND TO CERMAK RD RAMP S-CURVE COOK COUNTY			
602+17	604+21	RT	415
	TOTAL		415

FILE NAME =
W06_HSIP_schedule-03.c

USER NAME = Steve	DESIGNED	-	SMS	REVISED -
	DRAWN	-	SVJ	REVISED -
PLOT SCALE = 100.0000 ' / in.	CHECKED	-	DGW	REVISED -
PLOT DATE = 5/12/2015	DATE	-		REVISED -

				F.A. RTE.	SECTION	COUNTY	TOTAL SHEETS	SHEET NO.
SCHEDULE OF QUANTITIES				VAR.	2015-008I	VAR.	29	9
						CONTRACT	NO. 6	2A62
SHEET	9 OF 29 S	SHEETS STA.	TO STA.		TILL INOTS FED. AT	D PROJECT		

FILE NAME = W06_HSIP_schedule-04.dgn

USER NAME = Steve	DESIGNED -	SMS	REVISED -
	DRAWN -	SVJ	REVISED -
PLOT SCALE = 100.0000 ' / in.	CHECKED -	DGW	REVISED -
PLOT DATE = 5/12/2015	DATE -		REVISED -

STATE OF ILLINOIS DEPARTMENT OF TRANSPORTATION

COUEDINE OF CHARITIES				F.A. RTE.	SECTION	COUNTY	TOTAL SHEETS	SHEET NO.		
SCHEDULE OF QUANTITIES					VAR.	2015-008I	VAR.	29	10	
								CONTRACT	NO. 6	2A62
SHEET	10 OF	29	SHEETS	STA.	TO STA.		ILLINOIS FED. A	ID PROJECT		

FROM

ENTIRE JOB SITE

	NEI EECTOR (CRTSTAE)			
FROM TO		OFFSET	TOTAL (EACH)	
I-90/94 EASTBOUND TO OHIO STREET EASTBOUND RAI				
204+42	213+44	RT	54	
I-90/94 WESTBOUND TO CERMAK RD RAMP S-CURVE COOK COUNTY				
	94			
			·	

I-90/94 AT ADDISON STREET COOK COUNTY						
103+45	118+20	RT	19			
103+45	118+30	LT	40			
	SUBTOTA	ÀL .	59			
I-90/94 EASTBOUND TO OHIO STREET EASTBOUND RAMP COOK COUNTY						
205+16	216+99	LT	64			
I-90/94		TO CERMAK RD RA DOK COUNTY	MP S-CURVE			
602+17	609+50	LT	50			
I-57 (S-CURVE NEAR 107TH STREET) COOK COUNTY						
702+02	739+14	RT	76			
713+08	752+54	LT	58			
	SUBTOTA	\L	134			
I-290 (S-CURVE NEAR KOSTNER AVENUE) COOK COUNTY						
801+84	829+52	RT	69			
806+00	829+52	LT	57			
	126					
	433					
78200100	MONODIRECTIONAL PRISMATIC BARRIER REFLECTOR (CRYSTAL)					

78100100	RAISED REFLECTIVE PAVEMENT MARKER				
FROM	ТО	OFFSET	TOTAL (EACH)		
I-90/94 WESTBOUND TO CERMAK RD RAMP S-CURVE COOK COUNTY					
602+37	608+00	RT / LT	38		
		38			
78200100	MONODIR	MONODIRECTIONAL PRISMATIC BARRIER REFLECTOR (AMBER)			
FROM	ТО	OFFSET	TOTAL (EACH)		
	I-90/94 AT ADDISON STREET COOK COUNTY				
103+45	118+20	RT	19		

78003180	PREFORMED PLASTIC PAVEMENT MARKING, TYPE B - LINE 24"				
FROM	ТО	OFFSET	TOTAL (FOOT)		
I-90/94 WESTBOUND TO CERMAK RD RAMP S-CURVE COOK COUNTY					
612+48	612+62	LT/RT	120		
	120				
·					

	78200530	BARRIER WALL MARKERS, TYPE C				
	FROM	ТО	OFFSET	TOTAL (FOOT)		
		ĪΤ				
	115+14.31	117+19.93	RT	9		
	I-90/94 EASTBOUND TO OHIO STREET EASTBOUND RA					
	203+57.86	204+43.35	RT	5		
	203+55.91	205+20.17	LT	7		
		SUBTOTA	AL.	12		
	I-90/94	AMP S-CURVE				
	606+33.13	607+47.96	LT	6		
		27				
_						
ΙF	REVISED -					

78201000	TERMINAL MARKER - DIRECT APPLIED				
FROM	ТО	OFFSET	TOTAL (EACH)		
I-90/94 AT ADDISON STREET COOK COUNTY					
116+03	116+03	RT	1		
	•				
	1				

	0				
78201000	TERMINA	CT APPLIED			
FROM	ТО	OFFSET	TOTAL (EACH)		
I-90/94 AT ADDISON STREET COOK COUNTY					
116+03	116+03	RT	1		
	1				

FROM	10	OFFSET	(EACH)		
I-90/94 AT ADDISON STREET COOK COUNTY					
116+03	117+06	RT	4		
I-57 (S-CURVE NEAR 107TH STREET) COOK COUNTY					
713+86	723+84	LT	4		
	8				
<u> </u>					
78201000	CT APPLIED				

TOTAL			19		
,					
78200410	GUA	RDRAIL MARKERS,	TYPE A		
FROM	ТО	TO OFFSET			
	I-90/94 AT ADDISON STREET COOK COUNTY				
116+03	117+06	RT	4		
I-57 (S-CURVE NEAR 107TH STREET) COOK COUNTY					
713+86	723+84	LT	4		
·					

78200200		BIDIRECTIONAL PRISMATIC BARRIER REFLECTOR (AMBER-CRYSTAL)			
FROM	ТО	TO OFFSET			
I-90/94 AT ADDISON STREET COOK COUNTY					
103+45	118+20	EXPRESS LN-RT	19		
TOTAL			19		

78200200	BIDIRE	BIDIRECTIONAL PRISMATIC BARRIER REFLECTOR (CRYSTAL)			
FROM	ТО	OFFSET	TOTAL (EACH)		
I-90/94 AT ADDISON STREET COOK COUNTY					
103+45	118+20	EXPRESS LN-RT	19		
103+45	118+50	EXPRESS LN-LT	40		
TOTAL 59					
		·	·		

81702140	ELECTRIC CABLE IN CONDUIT, 600V (XLP-TYPE USE) 1/C NO. 4			
FROM	ТО	OFFSET	TOTAL (FOOT)	
I-90/94	I-90/94 WESTBOUND TO CERMAK RD RAMP S-CURVE COOK COUNTY			
606+88 608+66 LT 23				
CONTINGENCY 100				
TOTAL 335				
ENGINEER TO APPROVE USE OF CONTINGENCY				

SCALE:

81702400	600V (XLP-TYPE USE) 3-1/C NO. 2			
FROM	ТО	OFFSET	TOTAL (FOOT)	
I-90/94 WESTBOUND TO CERMAK RD RAMP S-CURVE COOK COUNTY				
606+88	608+66	LT	235	
CONTINGENCY 100				
	335			
ENGINEER TO APPROVE USE OF CONTINGENCY				

8170	2400	ELECTRIC CABLE IN CONDUIT, 600V (XLP-TYPE USE) 3-1/C NO. 2			
FRO	MC	ТО	OFFSET	TOTAL (FOOT)	
I-	I-90/94 WESTBOUND TO CERMAK RD RAMP S-CURVE COOK COUNTY				
606	5+88	608+66	LT	235	
	CONTINGENCY 100				
	TOTAL 335				
	ENGIN	NEER TO APP	ROVE USE OF CON	TINGENCY	

	TOTAL 65				
81702400	ELECTRIC CABLE IN CONDUIT, 600V (XLP-TYPE USE) 3-1/C NO. 2				
FROM	ТО	OFFSET	TOTAL (FOOT)		
I-90/94 WESTBOUND TO CERMAK RD RAMP S-CURVE COOK COUNTY					
606+88	608+66	LT	235		
	100				

81200240	CONDUIT EMBEDDED IN STRUCTURE, 2 1/2" DIA., PVC			
FROM	TO OFFSET TOTAL (FOOT)			
I-90/94	WESTBOUND TO CERMAK RD RAMP S-CURVE COOK COUNTY			
607+07.30	607+69.70	LT	65	
TOTAL 65			65	

81200130	CONDUIT EMBEDDED IN STRUCTURE, 2 1/2" DIA., GALVANIZED STEEL				
FROM	ТО	TOTAL (FOOT)			
I-90/94	I-90/94 WESTBOUND TO CERMAK RD RAMP S-CURVE COOK COUNTY				
607+07.30		LT	6		
TOTAL 6					
-					

78300200	RAISED REFLECTIVE PAVEMENT MARKER REMOVAL			
FROM	TO OFFSET TOTAL (EACH)			
I-90/94	I-90/94 WESTBOUND TO CERMAK RD RAMP S-CURVE COOK COUNTY			
602+37	608+00	RT / LT	30	
	TOTAL 30			

8300100	PAVEMENT MARKING REMOVAL				
FROM	ТО	TOTAL (SQ FT)			
I-90/94 WESTBOUND TO CERMAK RD RAMP S-CURVE COOK COUNTY					
609+50	612+62	RT / LT	925		
TOTAL 925					

Z0048665	RAILROAD F	PROTECTIVE LIABIL	.ITY INSURANCE
FROM	ТО	OFFSET	TOTAL (L SUM)
I-90/94 WESTBOUND TO CERMAK RD RAMP S-CURVE COOK COUNTY			
ENTIRE	JOB SITE		1
	TOTAL		1

I-90/94	90/94 WESTBOUND TO CERMAK RD RAMP S-CURVE COOK COUNTY				
606+88.10	10 608+66.10 LT 260				
TOTAL 260					
Z0048665	RAILROAD F	PROTECTIVE LIABIL	.ITY INSURANCE		
FROM	TOTAL (L SUM)				

X0326364	TEMPORARY AERIAL CABLE WITH MESSENGER WIRE					
FROM	TO	TOTAL (FOOT)				
I-90/94 WESTBOUND TO CERMAK RD RAMP S-CURVE COOK COUNTY						
606+88.10 608+66.10 LT 260						
TOTAL 260						

X0326364	TEMP	BLE WITH E			
FROM	ТО	OFFSET	TOTAL (FOOT)		
I-90/94	WESTBOUND CO	AMP S-CURVE			
606+88.10	608+66.10	LT	260		
	TOTAL				

			_		
X0326364	TEMPORARY AERIAL CABLE WITH MESSENGER WIRE				
FROM	ТО	OFFSET	TOTAL (FOOT)		
I-90/94	WESTBOUND TO CERMAK RD RAMP S-CURV COOK COUNTY				
606+88.10	608+66.10 LT 260				

	2				
X0326364	ТЕМР	BLE WITH E			
FROM	ТО	OFFSET	TOTAL (FOOT)		
I-90/94	WESTBOUND TO CERMAK RD RAMP S-CUR'				
606+88.10	608+66 . 10 LT 260				
·	·	·			

81300550	JUNCTION BOX, STAINLESS STEEL, ATTACHED TO STRUCTURE, 12" X 12" X 6"				
FROM	TOTAL (EACH)				
I-90/94 WESTBOUND TO CERMAK RD RAMP S-CURVE COOK COUNTY					
607+07.30 607+07.30 LT 1					
TOTAL 1					
				70033028 MAINTENANCE OF LIGHTING SYSTEM	


OFFSET


I-90/94 WESTBOUND TO CERMAK RD RAMP S-CURVE COOK COUNTY


TOTAL (CAL MO)


89502300	REMOVE E	ELECTRIC CABLE F	ROM CONDUIT		
FROM	ТО	OFFSET	TOTAL (FOOT)		
I-90/94	WESTBOUND CO	AMP S-CURVE			
606+88	608+66	670			
	TOTAL				


X8130125	REMOVE EXISTING JUNCTION BOX				
FROM	ТО	TO OFFSET			
I-90/94	WESTBOUND CO	MP S-CURVE			
607+07.30	607+07.30	1			
	1				

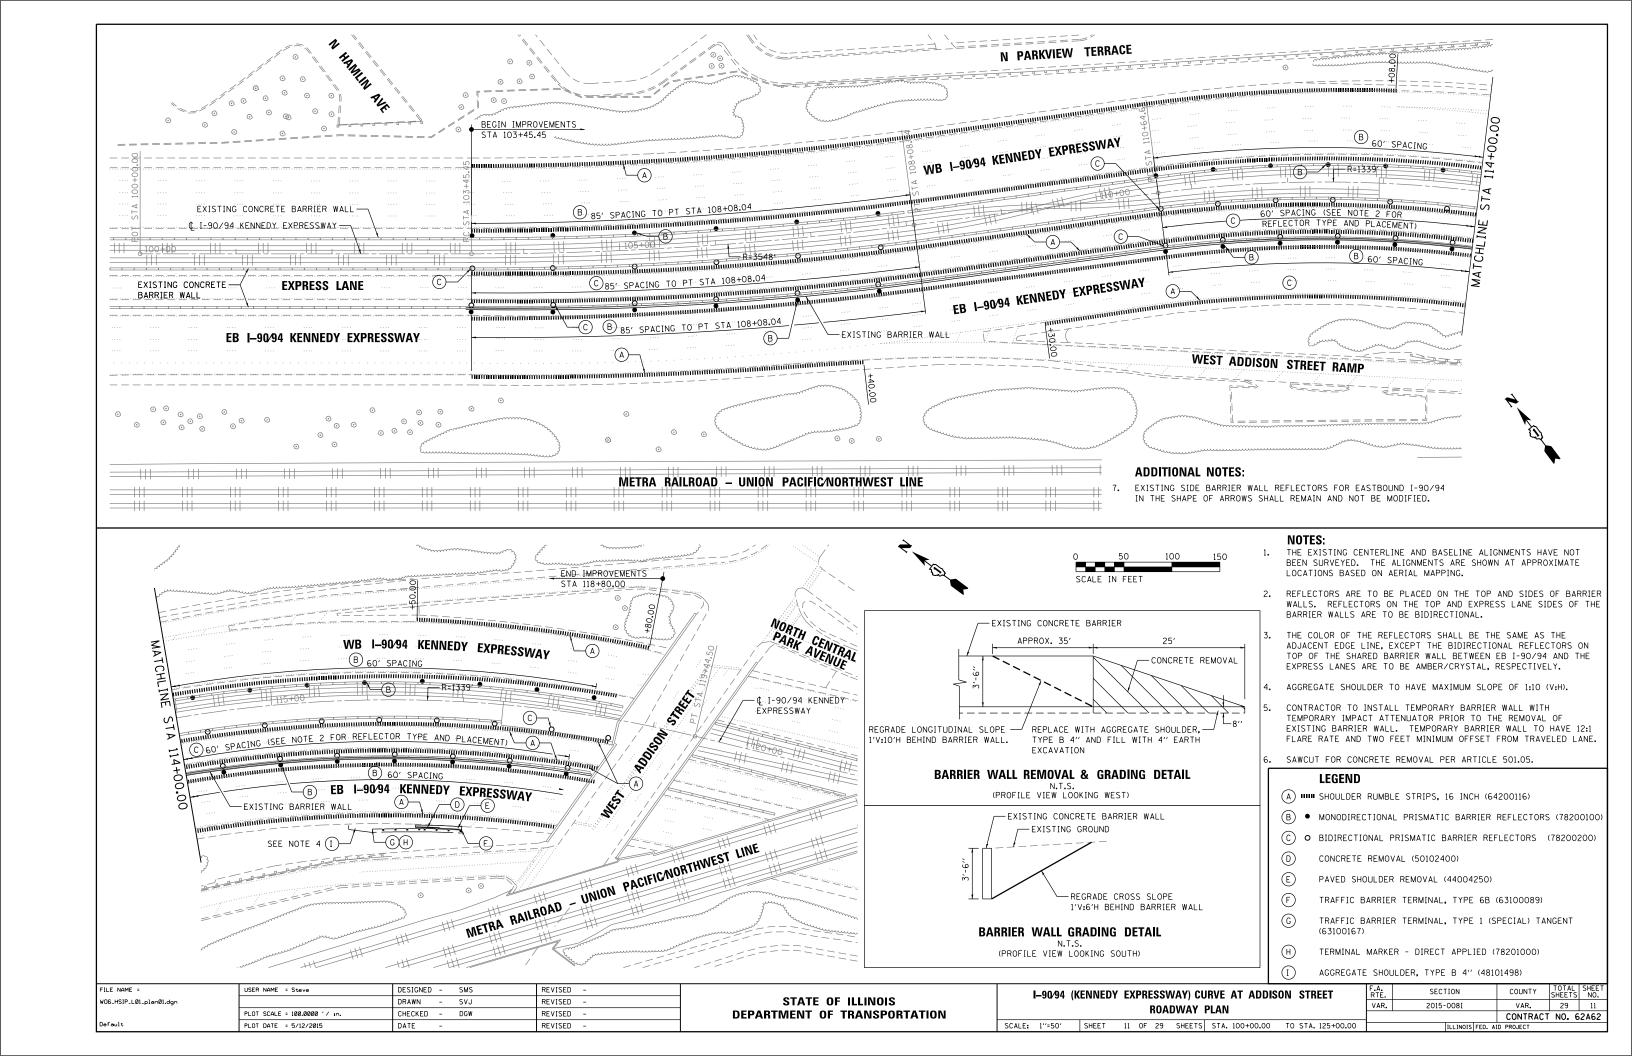


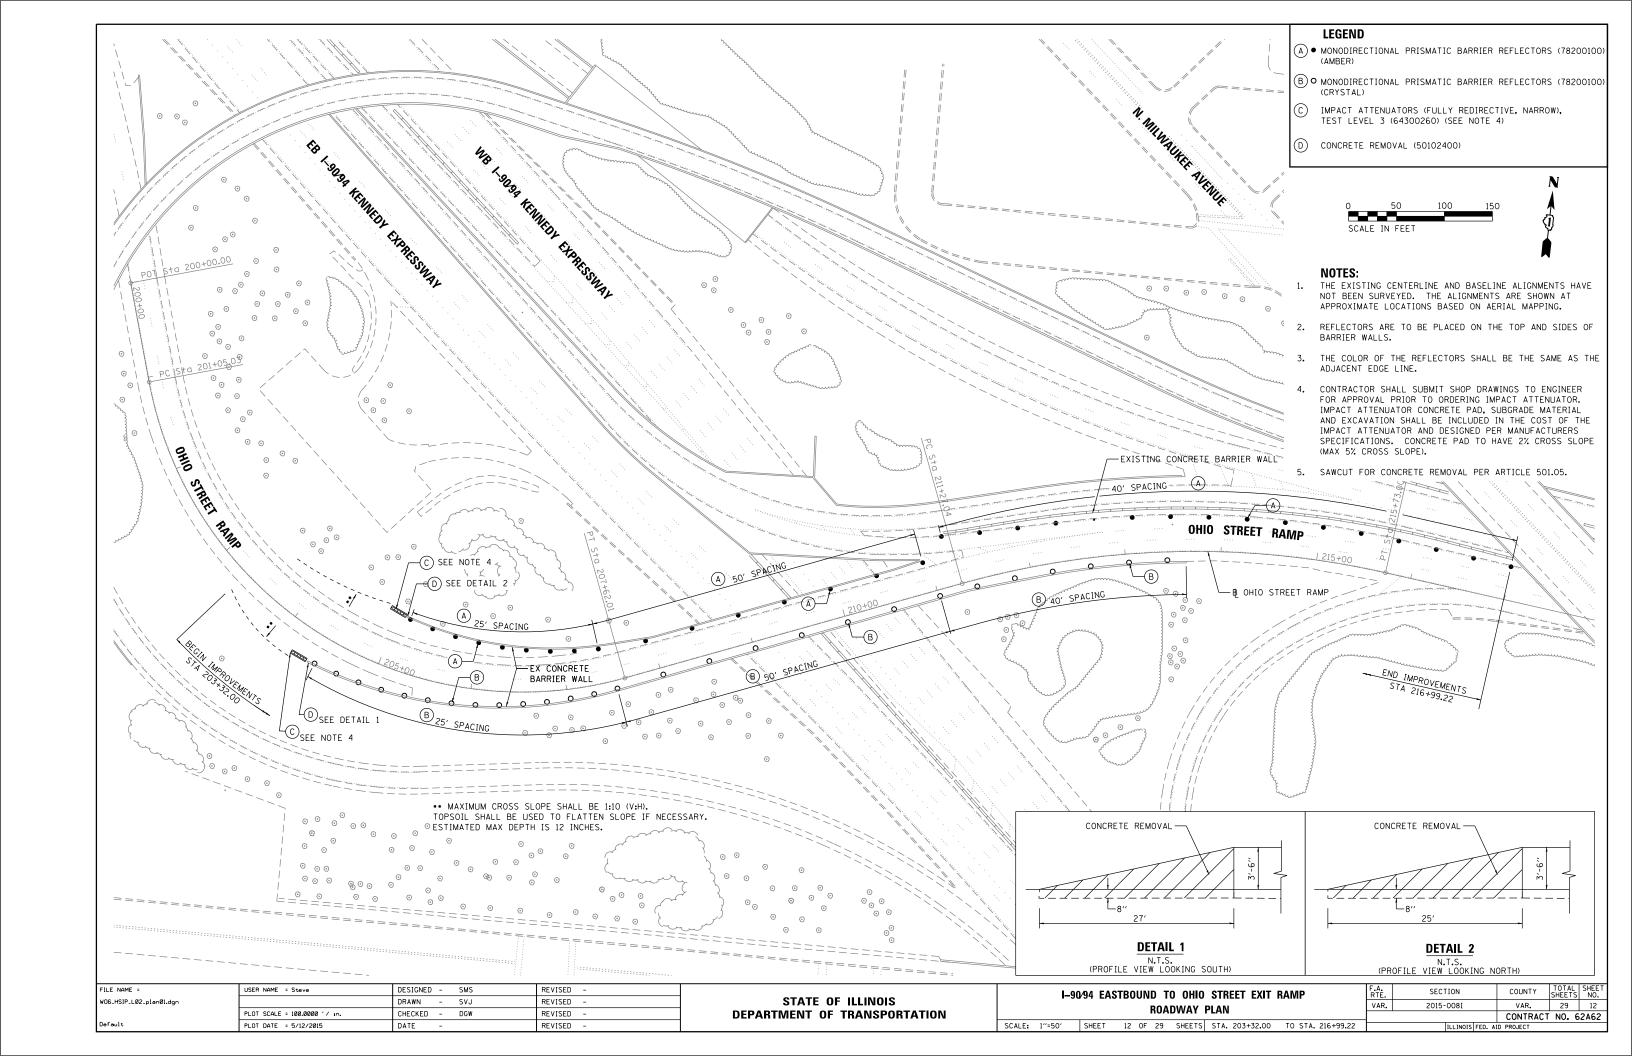

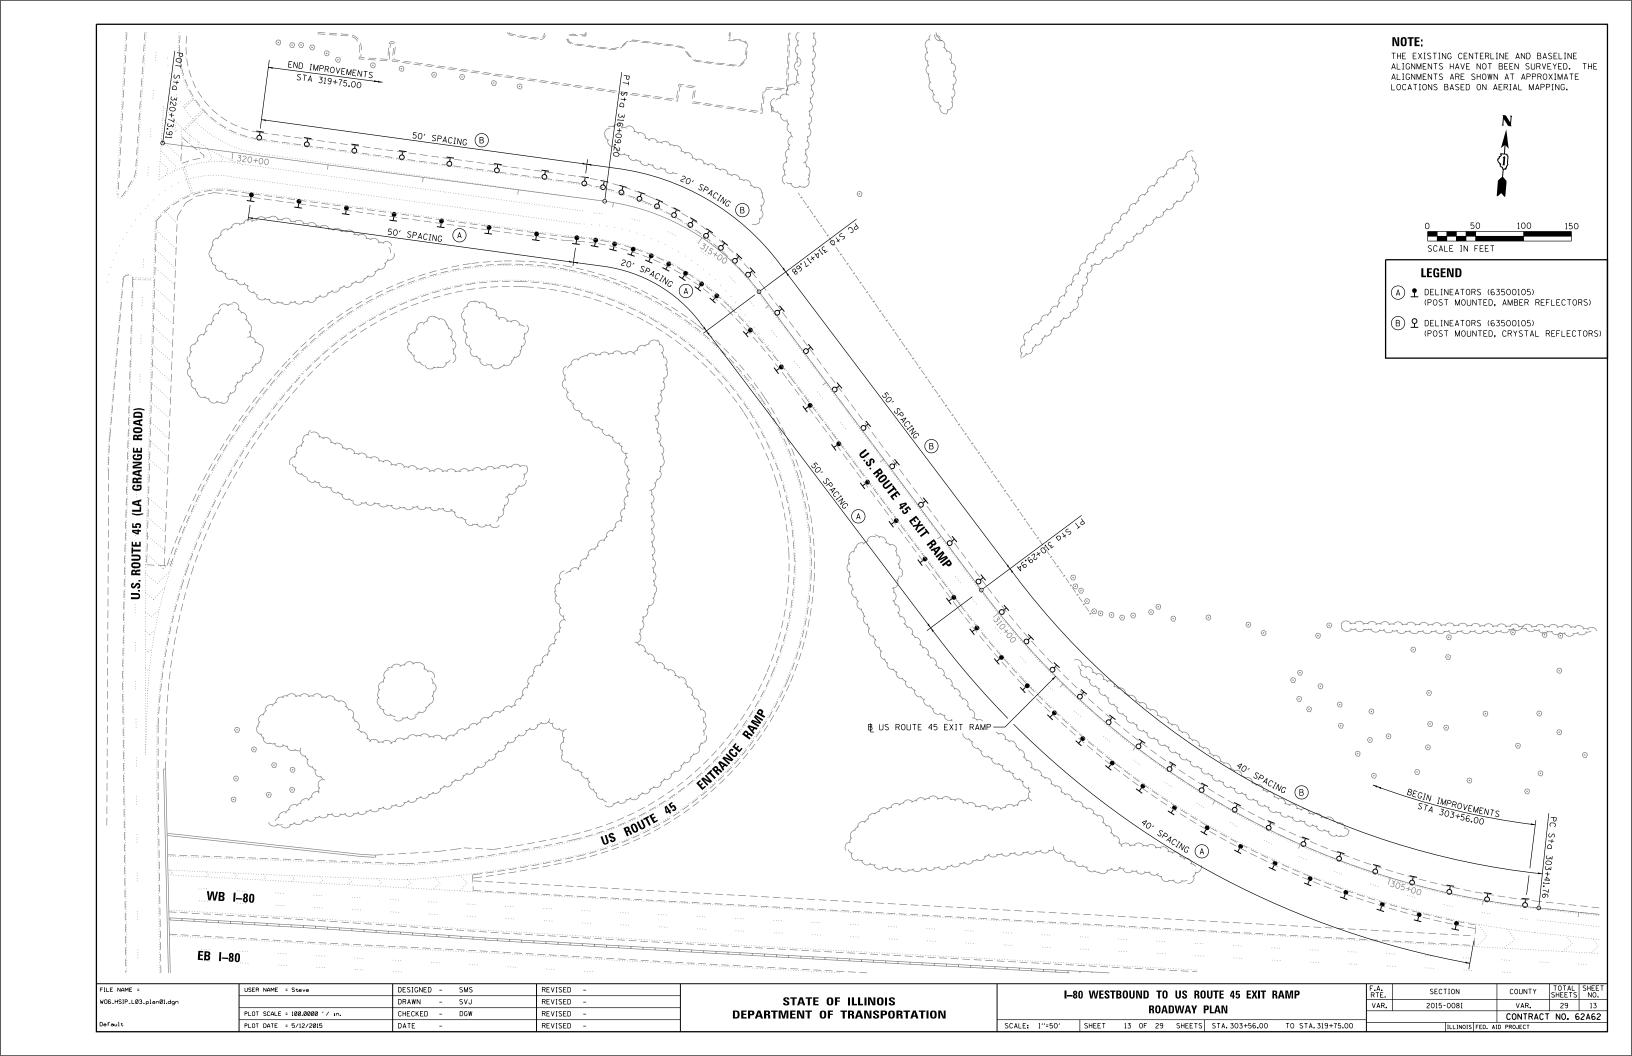


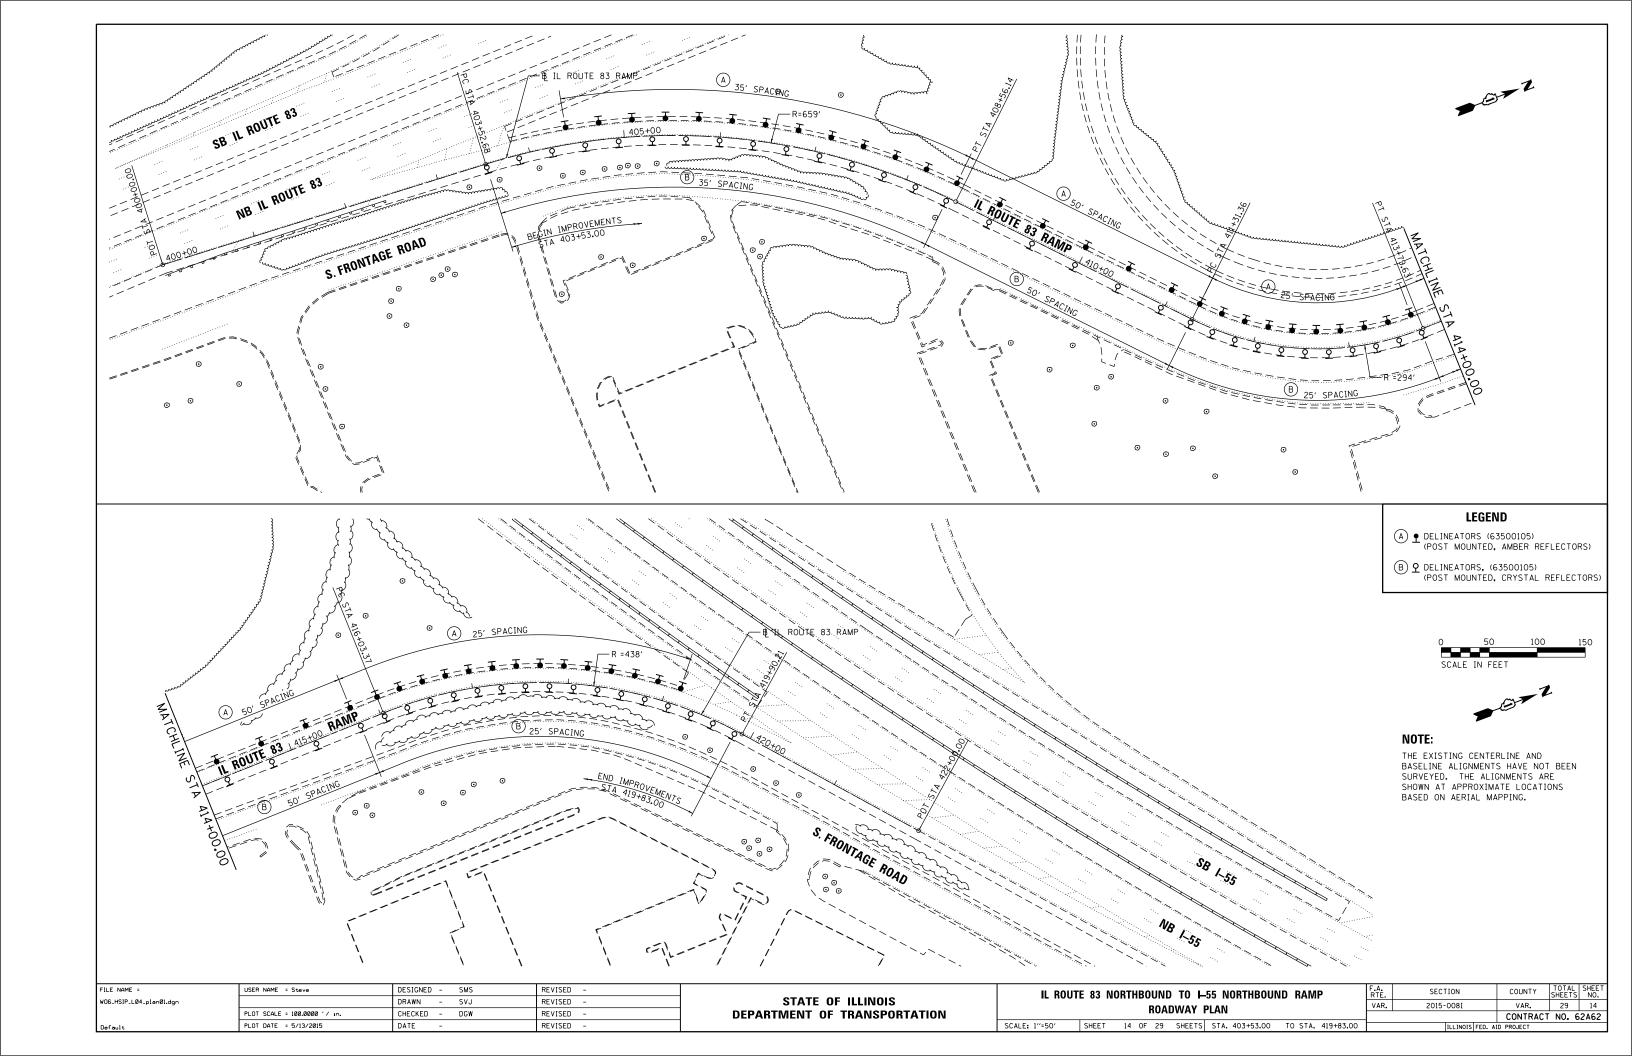

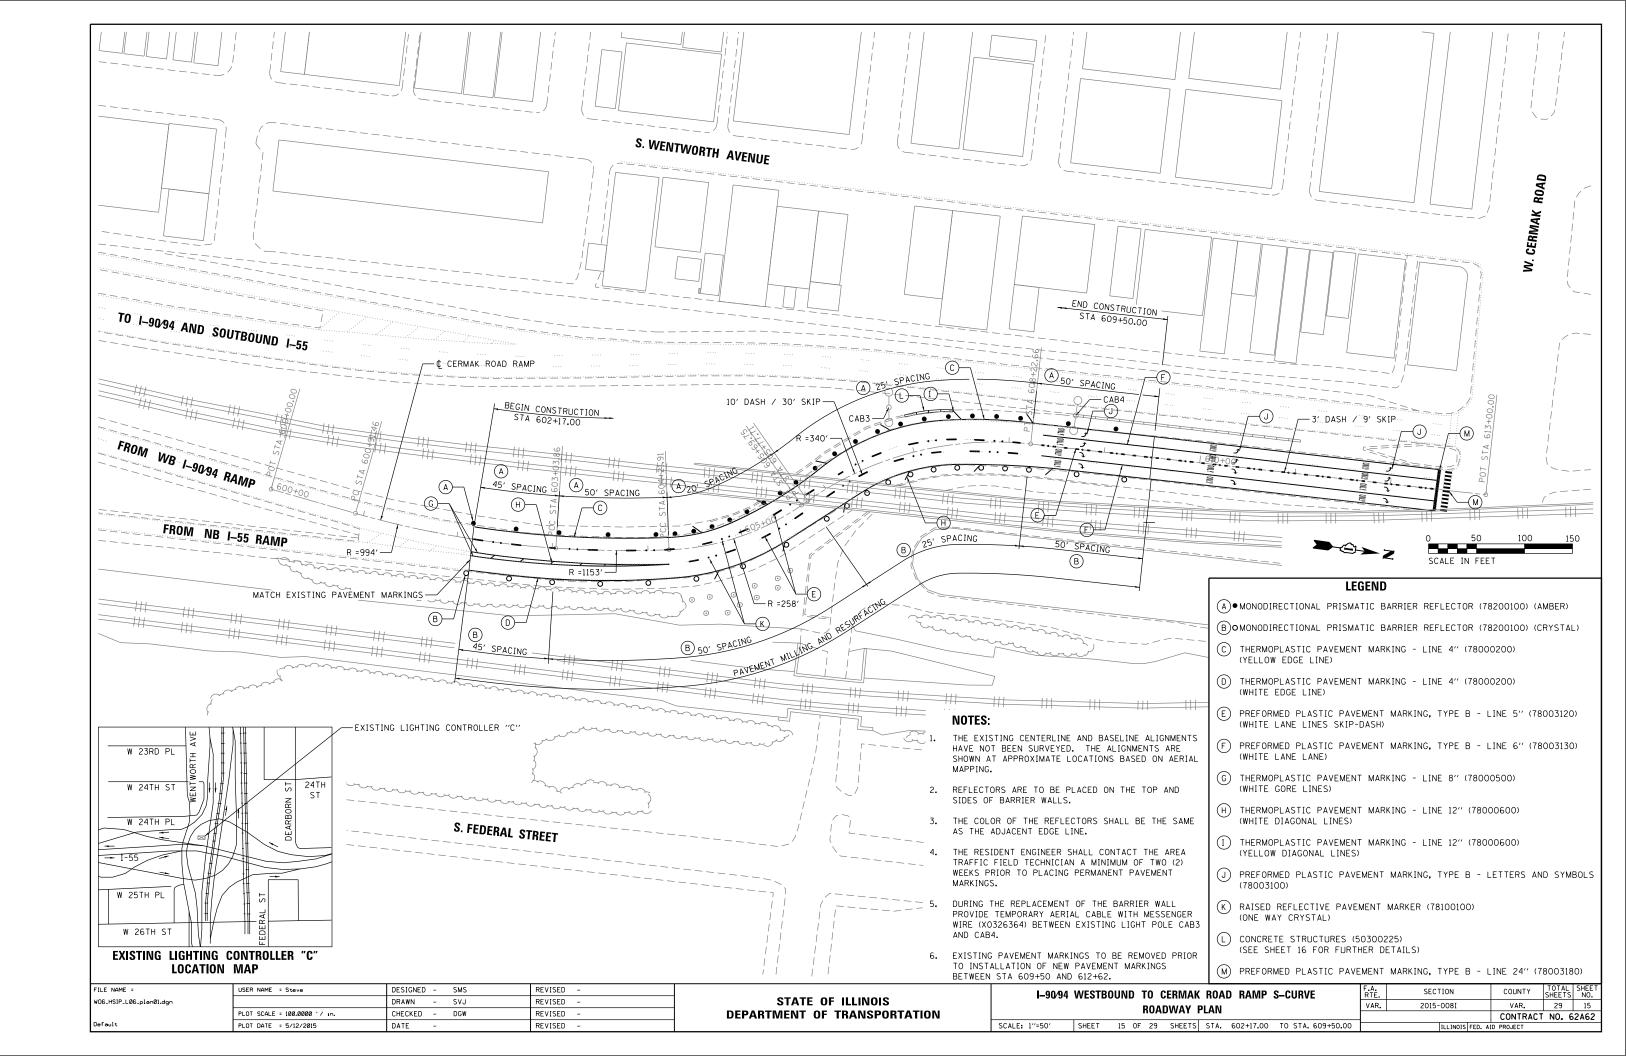

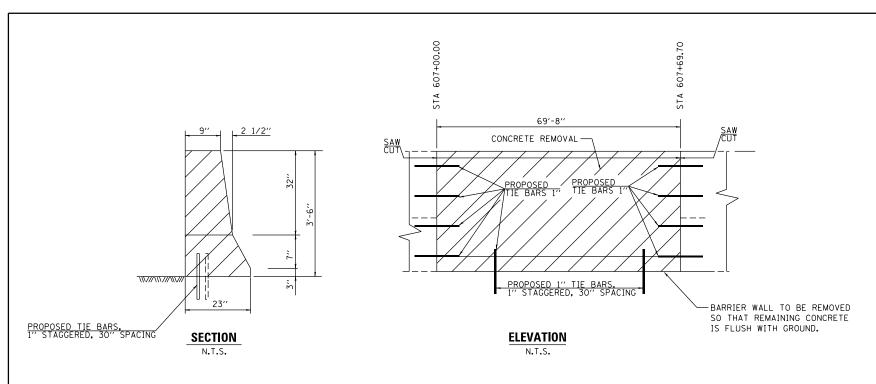



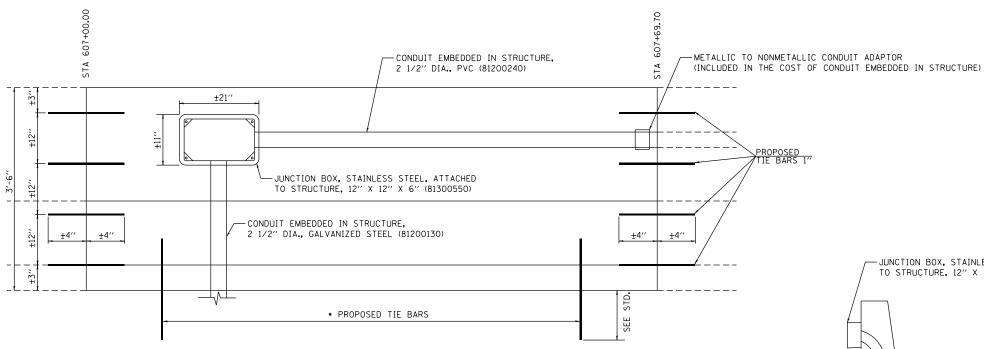

REVISED -

NOTES:

1. REPLACE THE ELECTRIC CABLE IN CONDUIT BETWEEN THE LIGHT POLES CAB3 AND CB4 (LABELED ON SHEET 15) WITH THE FOLLOWING:

ELECTRIC CABLE IN CONDUIT, 600V (XLP-TYPE USE) 3-1/C NO. 2 (81702400) ELECTRIC CABLE IN CONDUIT, 600V (XLP-TYPE USE) 1/C NO. 4 (81702140) •GROUND TO HAVE GREEN INSULATION.

- 2. CONTRACTOR TO MAINTAIN EXISTING LIGHTING THROUGHOUT THE LENGTH OF CONSTRUCTION. THIS WORK IS TO BE PAID FOR AS MAINTAIN EXISTING LIGHTING SYSTEM (Z0033028).
- 3. CONTRACTOR SHALL FIELD VERIFY EXISTING DIMENSIONS AND CONDUIT SIZES BEFORE BEGINNING WORK.
- 4. CONTRACTOR TO MARK THE LIMITS OF BARRIER WALL REMOVAL FOR ENGINEER APPROVAL PRIOR TO REMOVAL OPERATION.
- 5. BEFORE STARTING ANY BARRIER WALL REPAIR WORK, THE CONTRACTOR SHALL CONTACT MEADE ELECTRIC AT (773) 287-7600 (EXT. 2) TO REQUEST ELECTRIC LOCATES IN THE AREA.

DATE

BILL OF MATERIALS

-JUNCTION BOX, STAINLESS STEEL, ATTACHED TO STRUCTURE, 12" X 12" X 6" (81300550)

> -CHIP OUT CONCRETE TO EXPOSE CONDUIT TO PROVIDE CONNECTION. ANY CONDUIT

OWN EXPENSE.

DAMAGED WOULD BE REPLACED

BY THE CONTRACTOR AT THEIR


ITEM	UNIT	QUANTITY
CONCRETE REMOVAL	CU. YDS	9.3
CONCRETE STRUCTURES	CU. YDS	9.3
TIE BARS	EACH	37
SAW CUT	FOOT	7.2
PROTECTIVE COAT	SQ. YDS	64.2


FILE NAME =	USER NAME = Steve	DESIGNED - SMS	REVISED -
W06_HSIP_L06_plan02.dgn		DRAWN - SVJ	REVISED -
	PLOT SCALE = 100.0000 '/ in.	CHECKED - DGW	REVISED -


PLOT DATE = 5/12/2015


STATE OF ILLINOIS **DEPARTMENT OF TRANSPORTATION**

I-90/94 WESTBOUND TO CERMAK ROAD RAMP S-CI	URVE F.A.	SECTION	COUNTY	TOTAL SHEETS	SHEET NO.
ROADWAY PLAN	VAR.	2015-0081	VAR.	29	16
			CONTRACT	NO. 6	2A62
SCALE: NTS SHEET 16 OF 29 SHEETS STA. TO	STA.	ILLINOIS FED. A	D PROJECT		

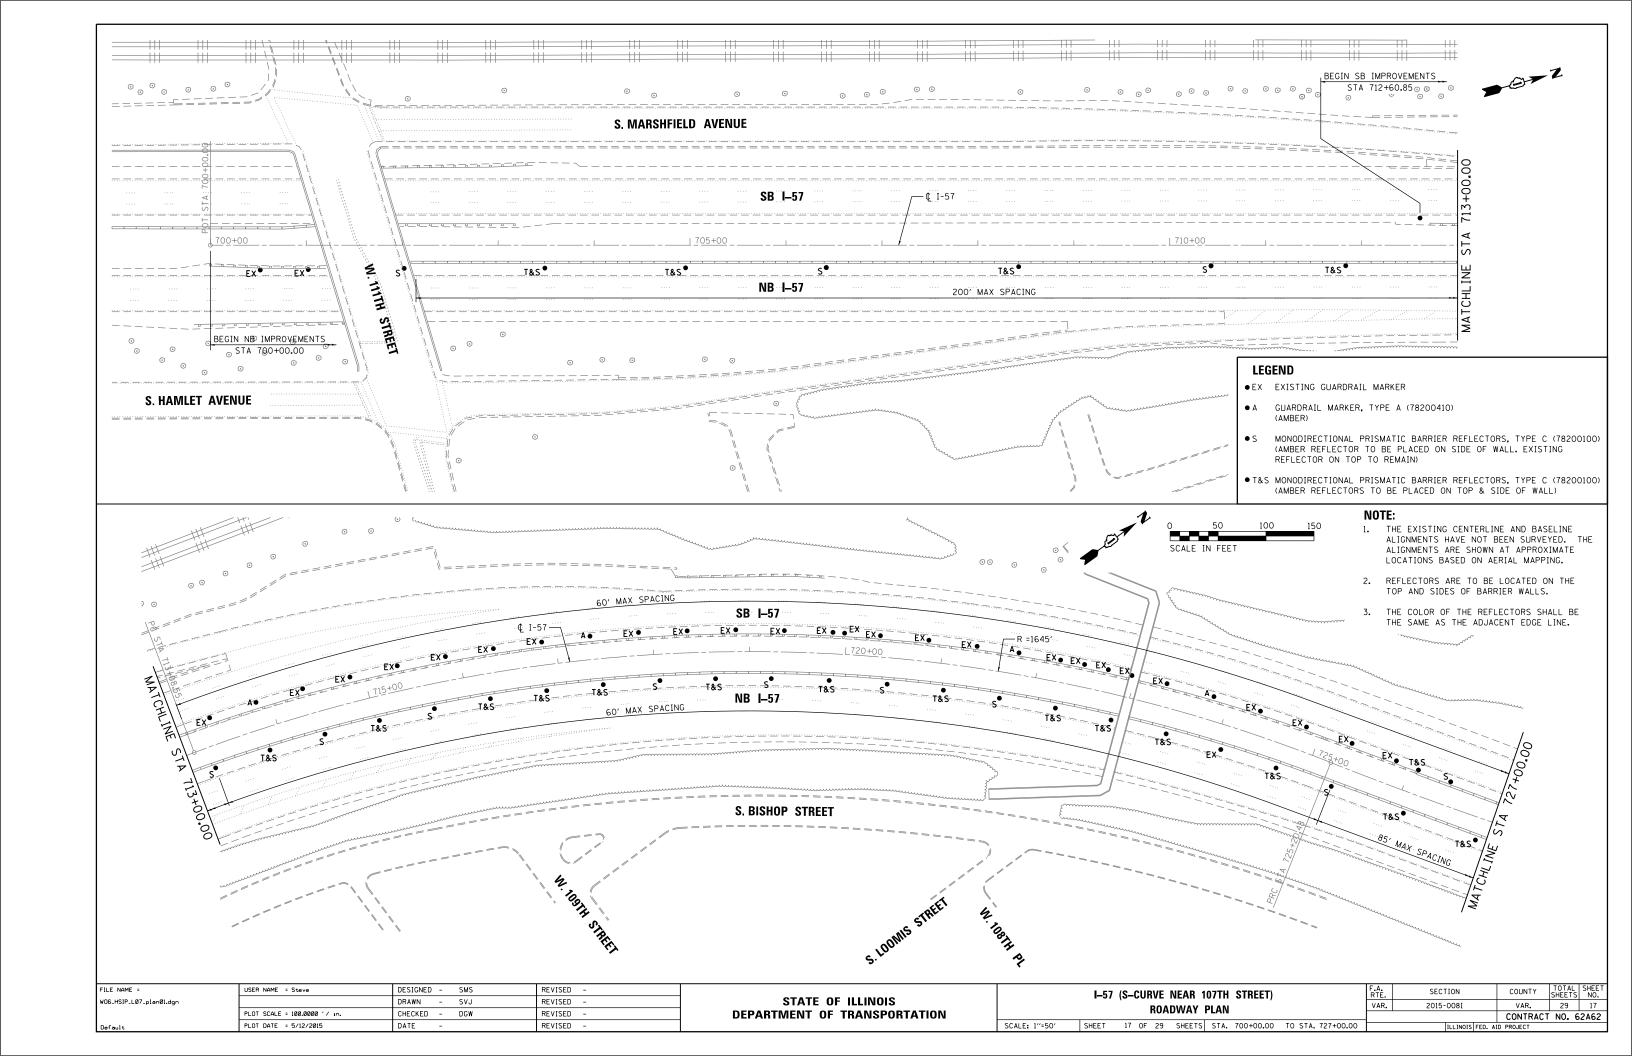


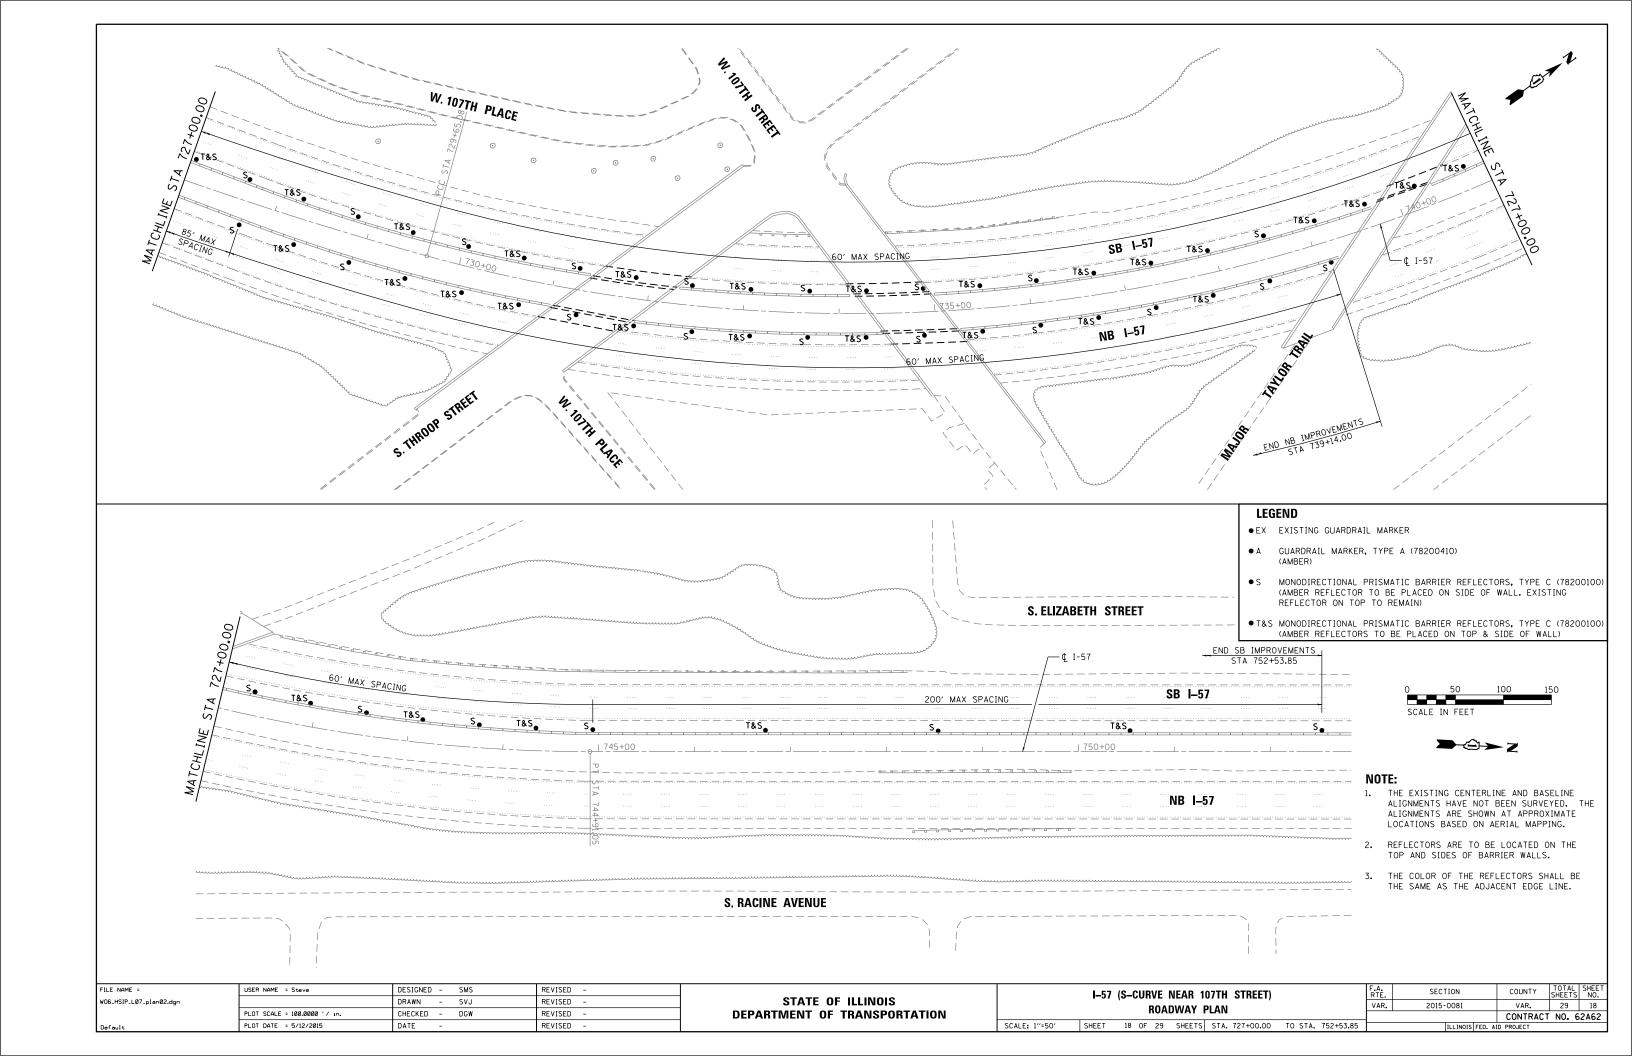

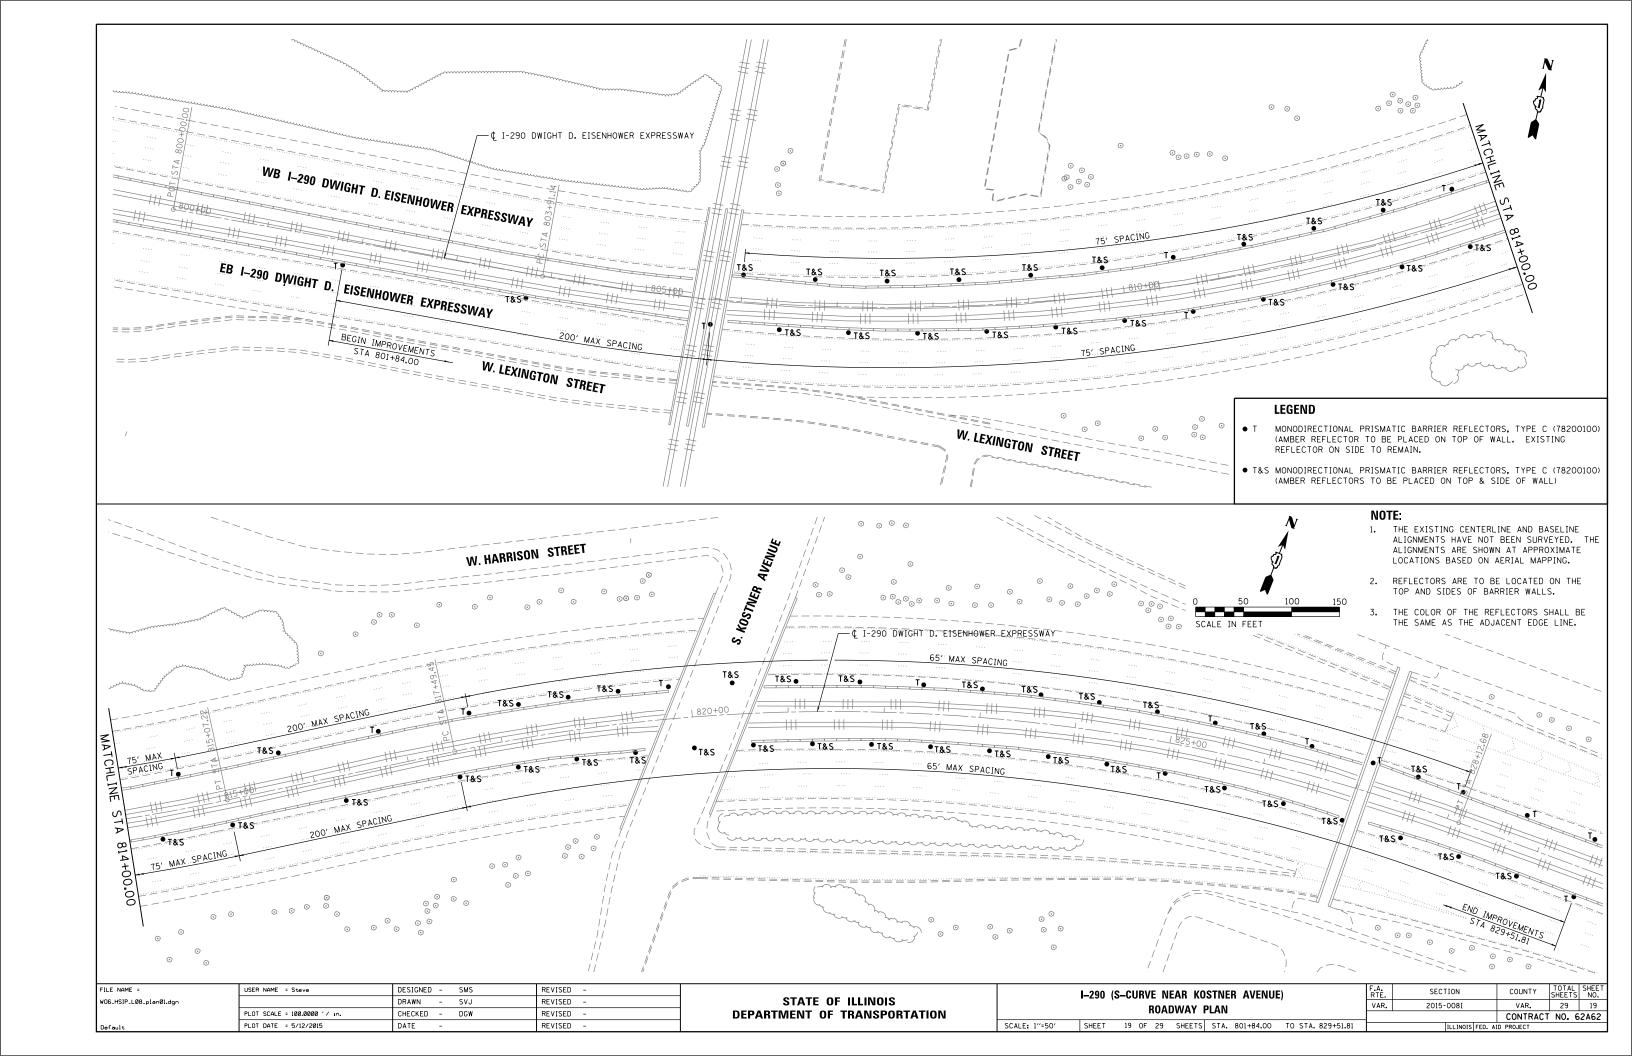

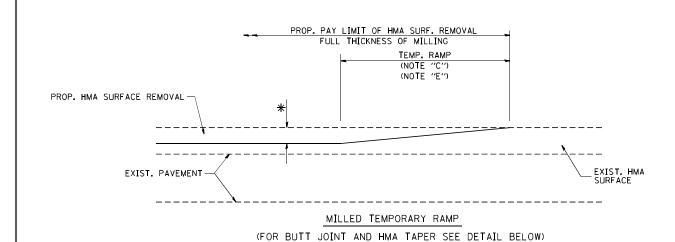


OPTION 1

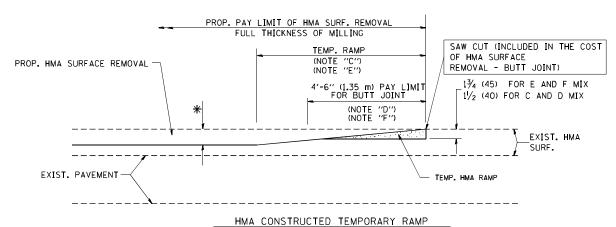

(FOR BUTT JOINT AND HMA TAPER SEE DETAIL BELOW)

OPTION 2

TYPICAL TEMPORARY RAMP

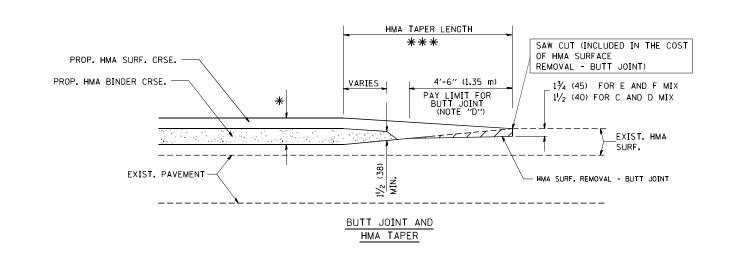



TYPICAL BUTT JOINT AND HMA TAPER FOR MILLING AND RESURFACING

STATE OF ILLINOIS
DEPARTMENT OF TRANSPORTATION

ALL DIMENSIONS ARE IN [NCHES (M]LLIMETERS) UNLESS

OTHERWISE SHOWN.

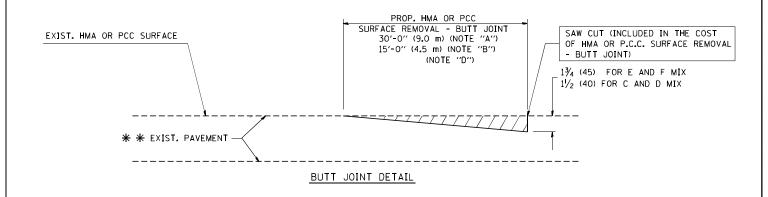

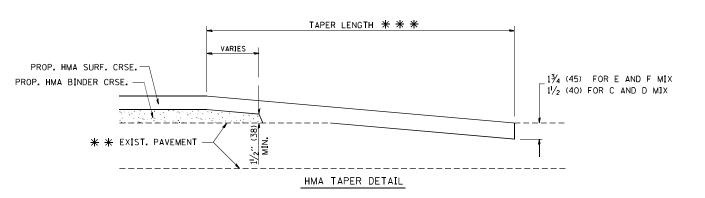

TYPICAL BUTT JOINT AND HMA TAPER FOR RESURFACING ONLY


* * PC CONCRETE, HMA OR HMA RESURFACED PAVEMENT.


NOTES

- A: MAINLINE ROADWAYS AND MAJOR SIDE ROADS.
- B: MINOR SIDE ROADS.
- C: THE TEMP. RAMP SHALL BE CONSTRUCTED IMMEDIATELY UPON REMOVAL OF THE EXISTING HMA SURFACE.
- D: THE BUTT JOINT SHALL BE CONSTRUCTED IMMEDIATELY PRIOR TO PLACING THE PROPOSED HMA COURSES.
- E: TAPER THE TEMP. RAMP AT A RATE OF 3'-0" (900 mm) PER 1 INCH (25 mm) OF MILLING THICKNESS.
- F: INSTALLATION AND REMOVAL OF THE 4'-6" (1.35 m) TEMP. RAMP IS INCLUDED IN COST OF HMA SURFACE REMOVAL BUTT JOINT
- G: SEE ARTICLE 406.08 AND 406.14 OF THE STANDARD SPECIFICATIONS FOR "HMA AND/OR PCC SURFACE REMOVAL, BUTT JOINT".
- * SEE TYPICAL SECTIONS FOR MILLING THICKNESS.
- ** * 20'-0" (6.1 m) PER 1 (25) RESURFACING (NOTE "A") 10'-0" (3.0 m) PER 1 (25) RESURFACING (NOTE "B")


BASIS OF PAYMENT:

THE BUTT JOINT WILL BE PAID FOR AT THE CONTRACT UNIT PRICE PER SQUARE YARD (SQUARE METER) FOR "HOT-MIX ASPHALT SURFACE REMOVAL - BUTT JOINT" OR FOR "PORTLAND CEMENT CONCRETE SURFACE REMOVAL- BUTT JOINT".

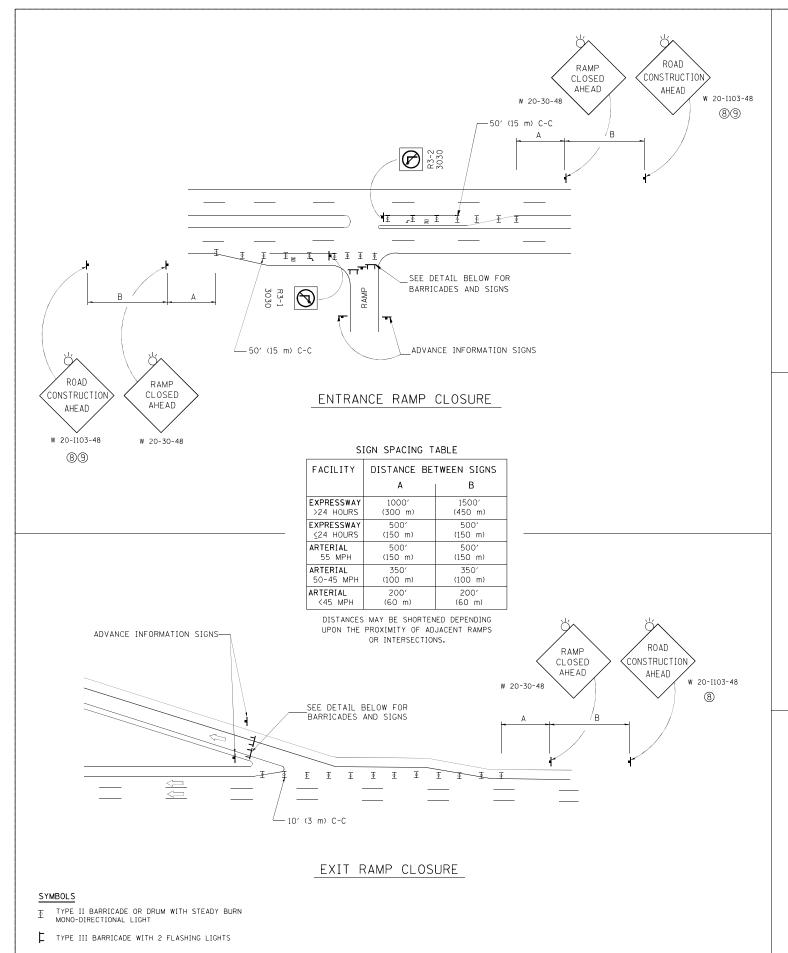

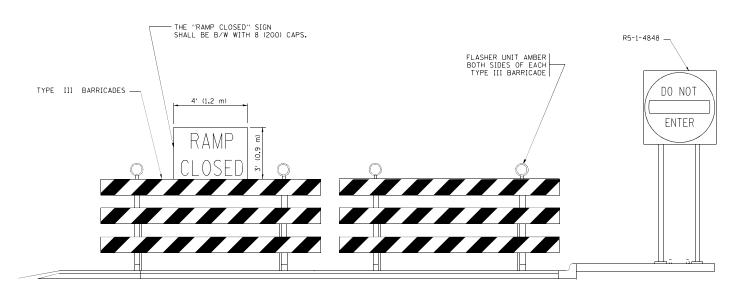


DETAIL FOR REQUIRED BARRICADES & SIGNS

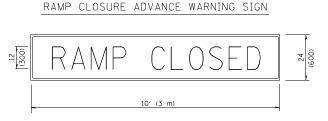

BLACK LEGEND ON ORANGE

BACKGROUND MOUNTED
DIAGONALLY
E MOD FONT
1 (25) BORDER
SIGNS ARE REQUIRED ON ALL THE EXIT

THESE SIGNS ARE REQUIRED ON ALL THE EXIT GUIDE SIGNS FOR EXIT RAMPS THAT WILL BE CLOSED FOR MORE THAN FOUR (4) CONSECUTIVE DAYS.

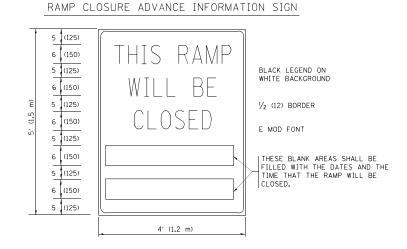

THESE SIGNS ARE REQUIRED ON BOTH SIDES OF THE RAMP, MINIMUM OF 1 WEEK IN ADVANCE OF THE CLOSURE.

THESE SIGNS SHALL BE FABRICATED AND PAID FOR ACCORDING TO THE TEMPORARY INFORMATION SIGNING SPECIAL PROVISION


GENERAL NOTES:


- ① CONES MAY BE SUBSTITUTED FOR DRUMS OR TYPE II
 BARRICADES DURING DAY OPERATIONS. CONES SHALL BE
 A MINIMUM OF 28 (700) HIGH.
- 2) STEADY BURN LIGHTS WILL NOT BE REQUIRED FOR DAY OPERATIONS.
- 3 A FLAGGER SHALL BE POSITIONED AT EACH CLOSED RAMP THAT IS OPEN TO CONSTRUCTION VEHICLES, PRECEEDED BY A W20-7 FLAGGER WARNING SIGN.
- 4 ALL ROUTE MARKERS AND TRAILBLAZER ASSEMBLIES WHICH DIRECT MOTORISTS TO A CLOSED ENTRANCE RAMP SHALL BE COVERED WHEN THE RAMP IS CLOSED FOR MORE THAN FOUR (4) DAYS.
- (5) THE SIGNING AND BARRICADING WHICH IS REQUIRED BY THIS DETAIL SHALL BE INCLUDED IN THE COST OF TRAFFIC CONTROL AND PROTECTION (EXPRESSWAYS).

- (6) AUTHORIZATION FROM THE DISTRICT'S BUREAU OF TRAFFIC IS REQUIRED FOR ALL RAMP CLOSURES.
- THE RAMP CLOSURE ADVANCE INFORMATION SIGNS SHALL BE ERECTED IF THE CLOSURE TIME EXCEEDS TWENTY-FOUR (24) HOURS. ADDITIONAL ADVANCE WARNING SIGNS ON EXIT GUIDE SIGNING WILL BE REQUIRED FOR EXIT RAMP CLOSURES THAT EXCEED FOUR (4) DAYS IN LENGTH
- (8) ROAD CONSTRUCTION AHEAD SIGNS MAY BE OMITTED WHEN THIS DETAIL IS USED IN CONJUNCTION WITH OTHER TRAFFIC CONTROL THAT ALREADY INCLUDES A ROAD CONSTRUCTION AHEAD SIGN.
- ARTERIAL ROAD CONSTRUCTION AHEAD SIGNS SHALL BE INSTALLED ON THE LEFT SIDE OF TRAFFIC IF THE MEDIAN IS MORE THAN 10 FT WIDE.

ALL DIMENSIONS ARE IN INCHES (MILLIMETERS)
UNLESS OTHERWISE SHOWN.


FILE NAME =	USER NAME = footemj	DESIGNED - DWS	REVISED - JAF 02-06		ENTRANCE AND EXIT RAMP	F.A	SECTION	COUNTY TOTAL SHEET
c:\pw_work\pwidot\footemj\d0108315\tc08	dgn	DRAWN -	REVISED - SPB 01-07	STATE OF ILLINOIS		VAR.	2015-008I	VAR. 29 21
	PLOT SCALE = 50.000 '/ in.	CHECKED -	REVISED - SPB 12-09	DEPARTMENT OF TRANSPORTATION	CLOSURE DETAILS		TC-08	CONTRACT NO. 62A62
	PLOT DATE = 7/8/2013	DATE - 02-83	REVISED - MD 06-13		SCALE: NONE SHEET NO. 1 OF 1 SHEETS STA. TO STA.	FED. ROAD	AD DIST. NO. 1 ILLINOIS FED	AID PROJECT

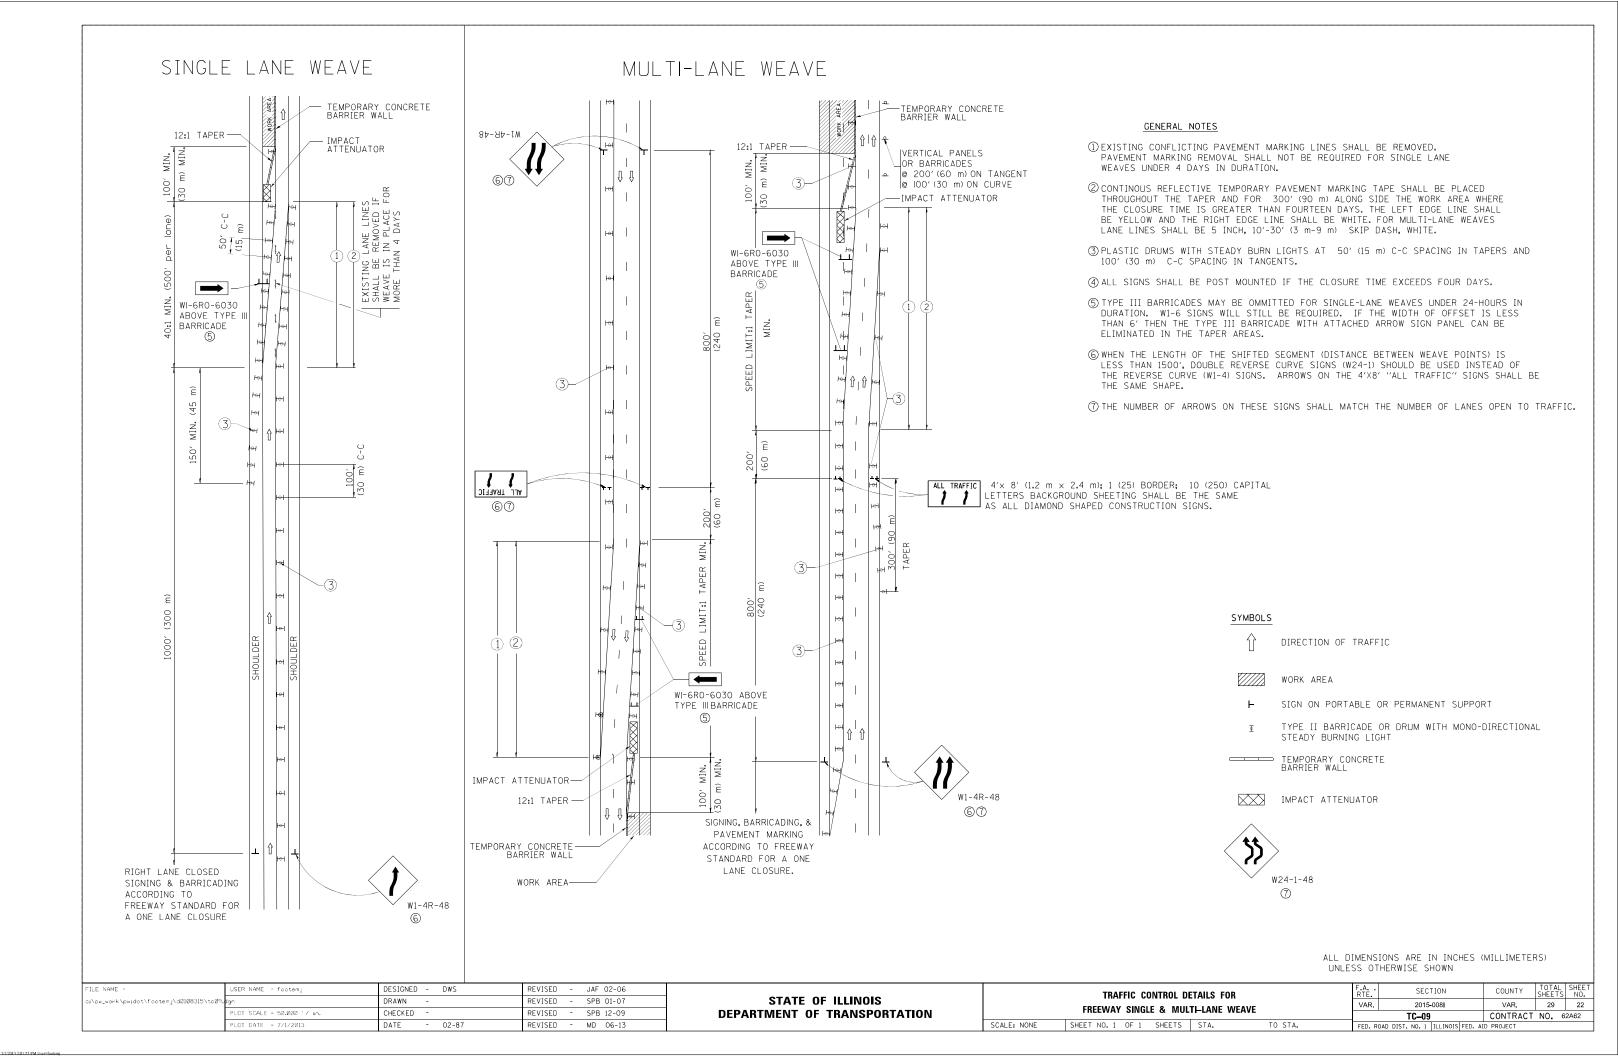


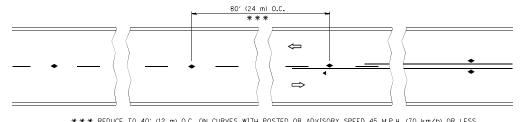

*** REDUCE TO 40' (12 m) O.C. ON CURVES WITH POSTED OR ADVISORY SPEED 45 M.P.H. (70 km/h) OR LESS.


TWO-LANE/TWO-WAY

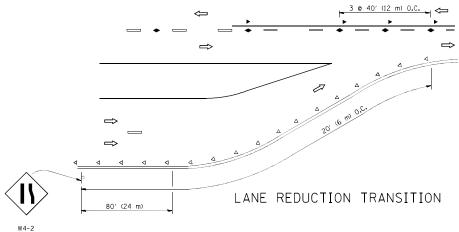

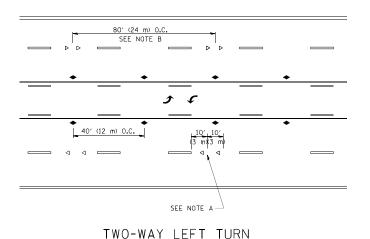

80' (24 m) 0.C. \Rightarrow \Rightarrow SEE NOTE A

MULTI-LANE/UNDIVIDED

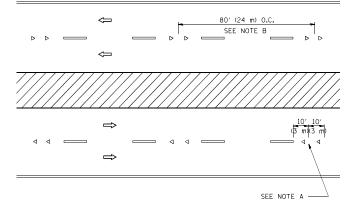

MULTI-LANE/DIVIDED

GENERAL NOTES

- 1. MARKERS USED WITH DASHED LINES SHALL BE CENTERED IN THE GAP BETWEEN SEGMENTS.
- 2. MARKERS USED ADJACENT TO SOLID LINES SHALL BE OFFSET 2 TO 3 (50 TO 75) TOWARD TRAFFIC AS SHOWN.
- 3. MARKERS THROUGH TANGENTS LESS THAN 500' (150 m) IN LENGTH BETWEEN CURVES SHALL BE INSTALLED AT THE LESSER OF THE TWO CURVE SPACINGS.

LANE MARKER NOTES

A. USE DOUBLE LANE LINE MARKERS SPACED AS SHOWN.

B. REDUCE TO 40' (12 m) O.C. ON CURVES WHERE ADVISORY SPEEDS ARE 10 M.P.H (20 km/h) LOWER THAN POSTED SPEEDS.

SYMBOLS

----- YELLOW STRIPE

── WHITE STRIPE

- ONE-WAY AMBER MARKER
- ONE-WAY CRYSTAL MARKER (₩/0)
- ◆ TWO-WAY AMBER MARKER

DESIGN NOTES


- 1. DOUBLE LANE LINE MARKERS SHALL BE USED UNLESS SPECIFIED OTHERWISE.
- 2. EXCEPT AS SHOWN ON THE LANE REDUCTION TRANSITION AND FREEWAY EXIT RAMP DETAIL, MARKERS ARE NOT TO BE SPECIFIED ON RIGHT EDGE LINES.
- 3. THE EXACT MARKER LIMITS, SPACING, AND COLOR SHALL BE INCLUDED IN THE PLANS WHEN STANDARD SPECIFICATIONS ARE NOT BEING USED.
- 4. MARKERS SHOULD NOT BE USED ALONGSIDE CURBS EXCEPT FOR EXTREMELY SHORT SECTIONS OF CURBS WHERE NOT MORE THAN TWO MARKERS WOULD BE


MINIMUM OF 3 W 3 @ 80' (24 m) O.C. — ___ 3 @ 80' (24 m) O.C. 3 @ 40' (12 m) 3 @ 40' (12 m) 40' (12 m) 0.C. \Leftrightarrow \Rightarrow \Rightarrow ◆ 40' (12 m) O.C. * SEE TWO-LANE/TWO-WAY WHERE MARKERS CONTINUE ** WHERE THE MEDIAN WIDTH IS 6' (2 m) OR LESS USE TWO-WAY MARKERS.


LEFT TURN


All dimensions are in inches (millimeters) unless otherwise shown.

FILE NAME =	USER NAME = leysa	DESIGNED -	REVISED - I. RAMMACHER OS	OTATE OF HUMOIO	TYPICAL APPLICATIONS	RTE.	SECTION	COUNTY SHEET	TS NO.
c:\pw_work\pwidot\leysa\d0108315\tcl1.dgn		DRAWN -	REVISED -T. RAMMACHER 03	12-99 STATE OF ILLINOIS	RAISED REFLECTIVE PAVEMENT MARKERS (SNOW-PLOW RESISTANT)	VAR.	2015-008	VAR. 29	23
	PLOT SCALE = 50,000 '/ IN,	CHECKED -	REVISED -T. RAMMACHER 01	06-00 DEPARTMENT OF TRANSPORTATION	KAISED KELLECTIVE PAVEMENT MAKKERS (SNUW-PLUVY KESISTANT)	,	TC-11	CONTRACT NO. 6	62A62
	PLOT DATE = 3/2/2011	DATE -	REVISED - C. JUCIUS 09	09-09	SCALE: NONE SHEET NO. 1 OF 1 SHEETS STA. TO STA.	FED. ROAD D	DIST. NO. 1 ILLINOIS FE	ED. AID PROJECT	-

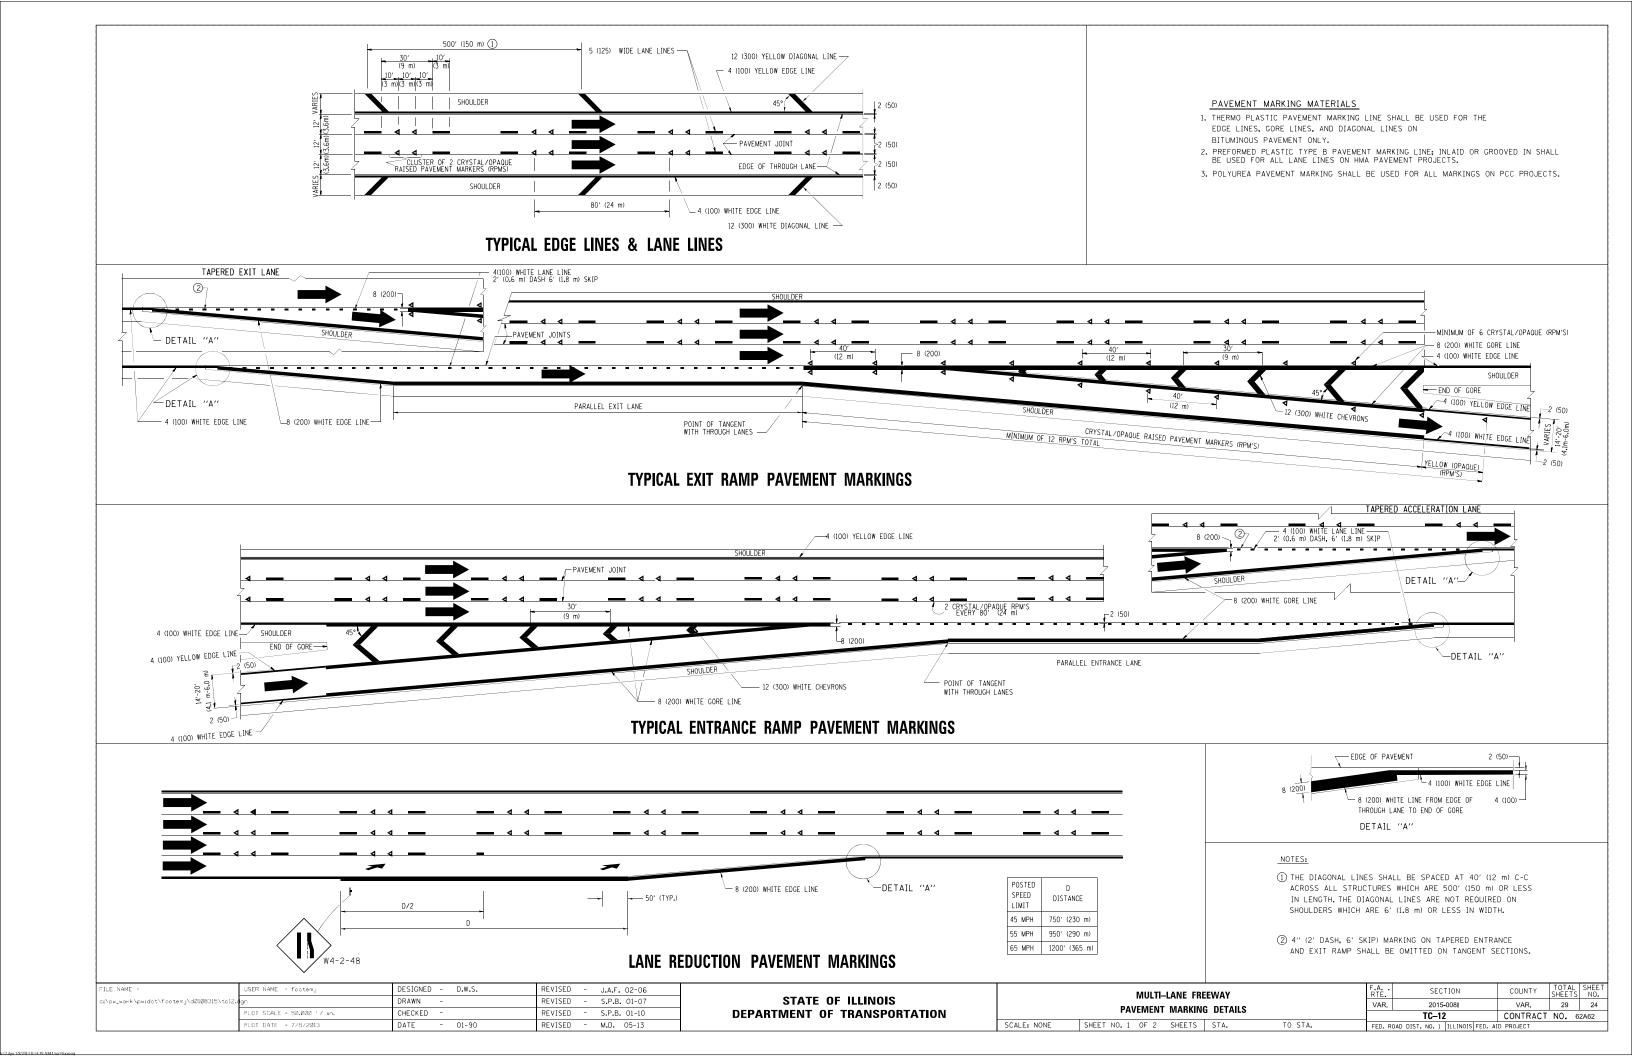


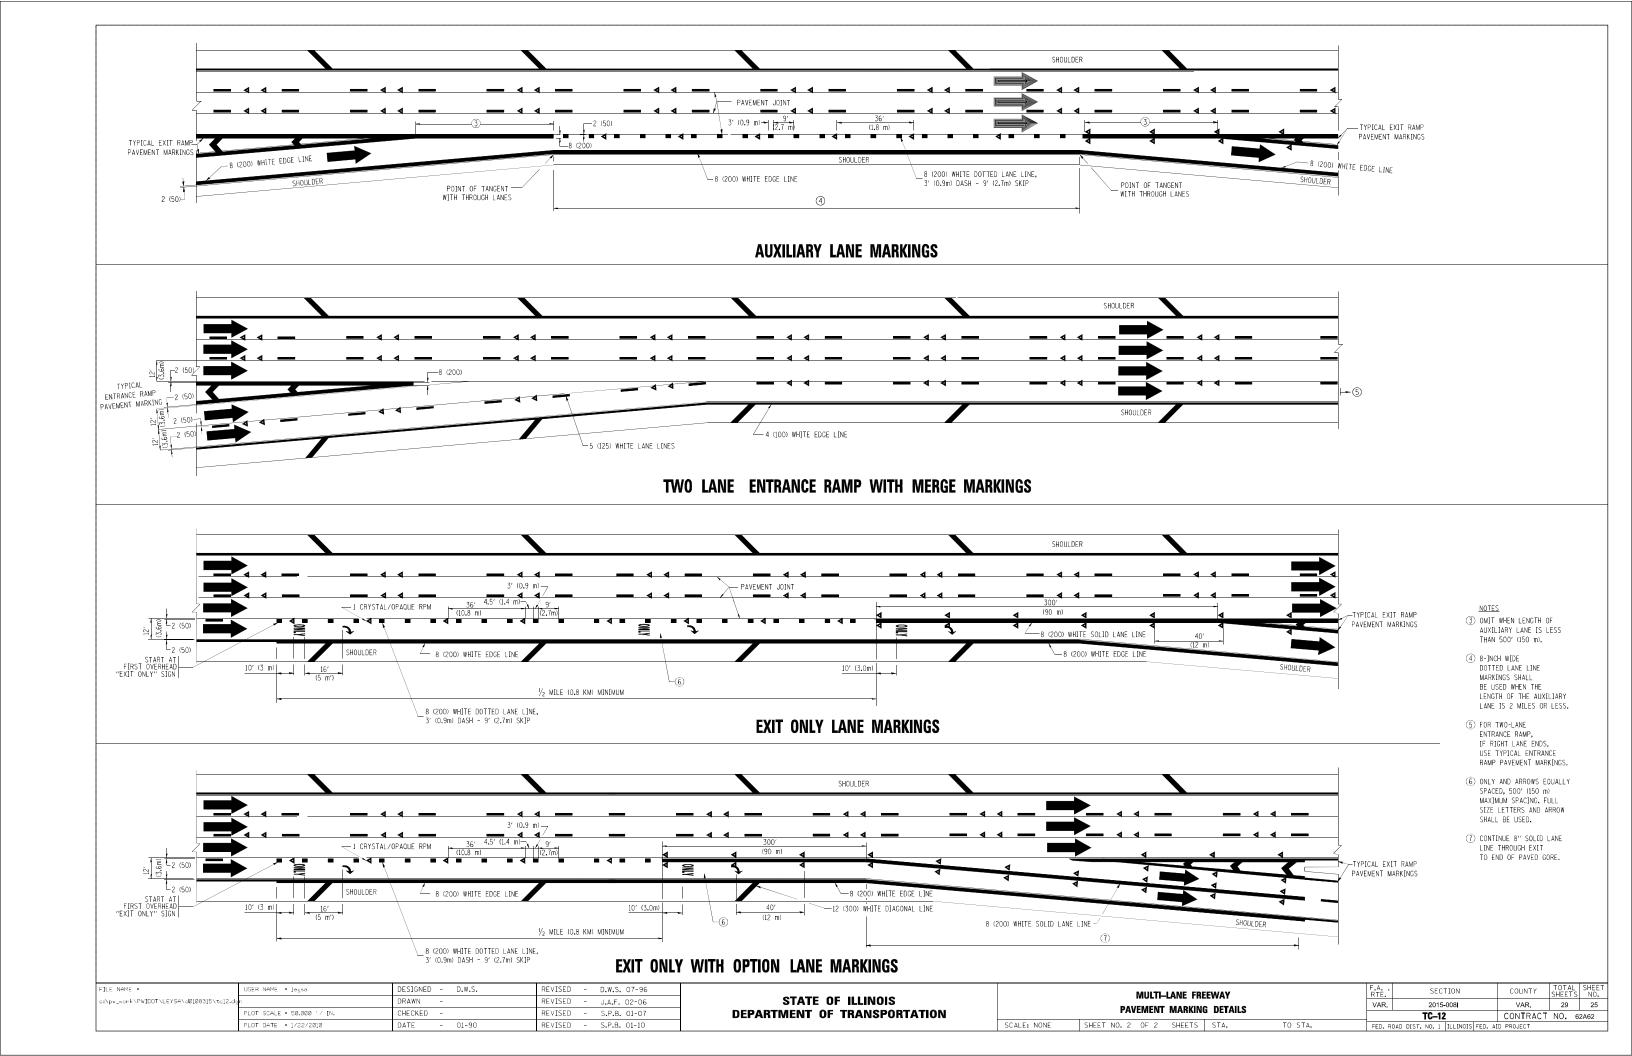

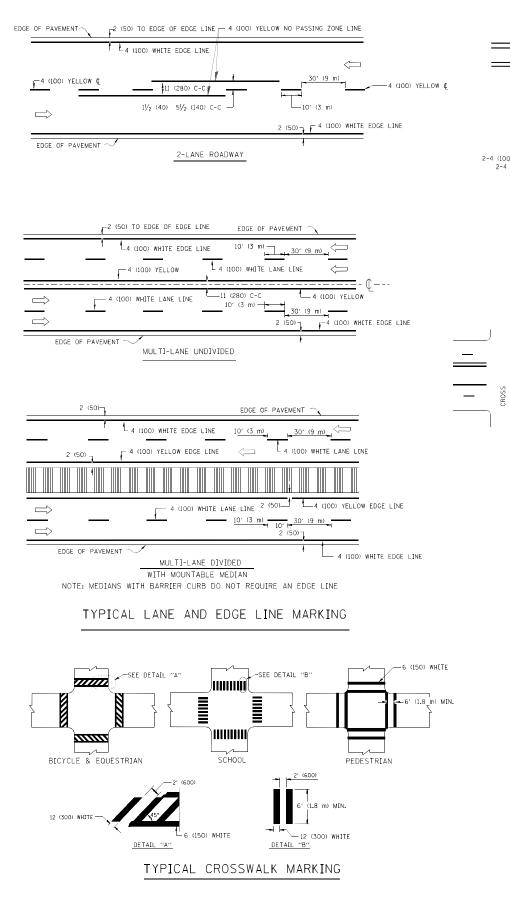


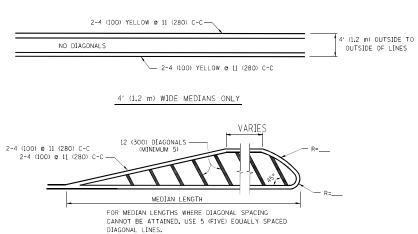

DIAGONAL LINE SPACING: 50' (15 m) C-C (LESS THAN 30MPH (50 km/h)) 75' (25 m) C-C 30MPH (50 km/h) TO 45MPH (70 km/h)) 150' (45 m) C-C (MORE THAN 45MPH (70 km/h))

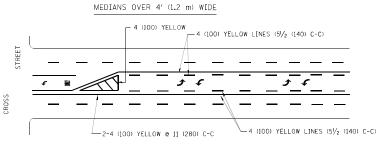


A MINIMUM OF TWO PAIRS OF TURN ARROWS SHALL BE USED, WHITE IN COLOR, ADDITIONAL PAIRS SHALL BE PLACED AT 200' (60 m) TO 300' (90 m) INTERVALS.

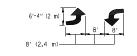

MEDIAN WITH TWO-WAY LEFT TURN LANE

TYPICAL PAINTED MEDIAN MARKING

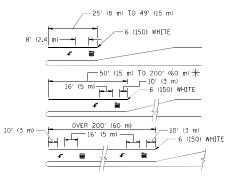


FULL SIZE LETTERS 8' (2.4 m) AND ARROWS SHALL BE USED. \P AREA = 15.6 SO. FT. (1.5 m²) \P AREA = 20.8 SO. FT. (1.9 m²)

* TURN LAMES IN EXCESS OF 400' (120 m) IN LENGTH MAY HAVE AN ADDITIONAL SET OF ARROW - "ONLY" INSTALLED MIDWAY BETWEEN THE OTHER TWO SETS OF ARROW - "ONLY".

TYPICAL LEFT (OR RIGHT) TURN LANE

TYPICAL TURN LANE MARKING

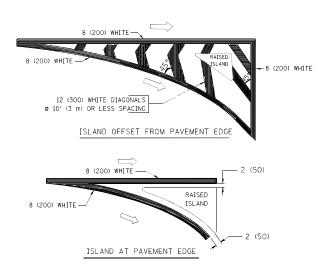

TYPICAL ISLAND MARKING

			T	1
TYPE OF MARKING	WIDTH OF LINE	PATTERN	COLOR	SPACING / REMARKS
CENTERLINE ON 2 LANE PAVEMENT	4 (100)	SKIP-DASH	YELLOW	10' (3 m) LINE WITH 30' (9 m) SPACE
CENTERLINE ON MULTI-LANE UNDIVIDED PAVEMENT	2 @ 4 (100)	SOLID	YELLOW	11 (280) C-C
NO PASSING ZONE LINES: FOR ONE DIRECTION FOR BOTH DIRECTIONS	4 (100) 2 @ 4 (100)	SOLID SOLID	YELLOW YELLOW	5½ (140) C-C FROM SKIP-DASH CENTERLINE 11 (280) C-C OMIT SKIP-DASH CENTERLINE BETWEEN
LANE LINES	4 (100) 5 (125) ON FREEWAYS	SKIP-DASH SKIP-DASH	WHITE WHITE	10' (3 m) LINE WITH 30' (9 m) SPACE
DOTTED LINES (EXTENSIONS OF CENTER, LANE OR TURN LANE MARKINGS)	SAME AS LINE BEING EXTENDED	SKIP-DASH	SAME AS LINE BEING EXTENDED	2' (600) LINE WITH 6' (1.8 m) SPACE
EDGE LINES	4 (100)	SOLID	YELLOW-LEFT WHITE-RIGHT	OUTLINE MOUNTABLE MEDIANS IN YELLOW: EDGE LINES ARE NOT USED NEXT TO BARRIER CURB
TURN LANE MARKINGS	6 (150) LINE; FULL SIZE LETTERS & SYMBOLS (8' (2.4m))	SOLID	WHITE	SEE TYPICAL TURN LANE MARKING DETAIL
TWO WAY LEFT TURN MARKING	2 @ 4 (100) EACH DIRECTION	SKIP-DASH AND SOLID	YELLOW	10' (3 m) LINE WITH 30' (9 m) SPACE FOR SKIP-DASH: 5½ (140) C-C BETWEEN SOLID LINE AND SKIP-DASH LINE
	8' (2.4m) LEFT ARROW	IN PAIRS	WHITE	SEE TYPICAL TWO-WAY LEFT TURN MARKING DETAIL
CROSSWALK LINES (PEDESTRIAN) A. DIAGONALS (BIKE & EQUESTRIAN) B. LONGITUDINAL BARS (SCHOOL)	2 @ 6 (150) 12 (300) @ 45° 12 (300) @ 90°	SOLID SOLID SOLID	WHITE WHITE WHITE	NOT LESS THAN 6' (1.8 m) APART 2' (600) APART 2' (600) APART SEE TYPICAL CROSSWALK MARKING DETAILS.
STOP LINES	24 (600)	SOLID	WHITE	PLACE 4' 11.2 m) IN ADVANCE OF AND PARALLEL TO CROSSMALK, IF PRESENT. OTHERWISE, PLACE AT DESIRED STOPPING POINT. PARALLEL TO CROSSROAD CENTERLINE, WHERE POSSIBLE
PAINTED MEDIANS	2 @ 4 (100) WITH 12 (300) DIAGONALS	SOLID	YELLOW: TWO WAY TRAFFIC	11 (280) C-C FOR THE DOUBLE LINE
	e 45° NO DIAGONALS USED FOR 4' (1.2 m) WIDE MEDIANS		WHITE: ONE WAY TRAFFIC	SEE TYPICAL PAINTED MEDIAN MARKING.
CORE MARKING AND CHANNELIZING LINES	8 (200) WITH 12 (300) DIAGONALS @ 45°	SOLID	WHITE	DIAGONALS: 15' (4.5 m) C-C (LESS THAN 30MPH (50 km/h)) 20' (6 m) C-C 30MPH (50 km/h) TO 45MPH (70 km/h)) 30' (9 m) C-C (OVER 45MPH (70 km/h))
RAILROAD CROSSING	24 (600) TRANSVERSE LINES; "RR" IS 6' (1.8 m) LETTERS; 16 (400) LINE FOR "X"	SOLID	WHITE	SEE STATE STANDARD 780001 AREA OF: "R"=3.6 SQ. FT. (0.33 m²) EACH "X"=54.0 SQ. FT. (5.0 m²)
SHOULDER DIAGONALS	12 (300) @ 45°	SOLID	WHITE - RIGHT YELLOW - LEFT	50' (15 m) C-C (LESS THAN 30MPH (50 km/h)) 75' (25 m) C-C (30 MPH (50 km/h) TO 45MPH (70 km/h)) 150' (45 m) C-C (0VER 45MPH (70 km/h))


FOR FURTHER DETAILS ON PAVEMENT MARKING REFER TO STANDARD SPECIFICATIONS FOR ROAD AND BRIDGE CONSTRUCTION AND STATE STANDARD 780001.

All dimensions are in inches (millimeters) unless otherwise shown.

FILE NAME =	USER NAME = drivakosgn	DESIGNED - EVERS	REVISED -T, RAMMACHER 10-27-94
c:\pw_work\pwidot\drivakosgn\d0108315\tc	I3.dgn	DRAWN -	REVISED -C. JUCIUS 09-09-09
	PLOT SCALE = 50,000 '/ IN,	CHECKED -	REVISED -
	PLOT DATE = 9/9/2009	DATE - 03-19-90	REVISED -


STATE OF ILLINOIS DEPARTMENT OF TRANSPORTATION

	DISTRICT O	F.A RTE.	SECTION	COUNTY TOTAL SHEET			
	TYPICAL PAVEMENT	VAR.	2015-008I	VAR.	29	26	
	TIFICAL PAVENIENT	TC-13 CONTRACT NO. 6					
SCALE: NONE	SHEET NO. 1 OF 1 SHEETS	FED. ROA	AD DIST. NO. 1 ILLINOIS FED. AI	D PROJECT			

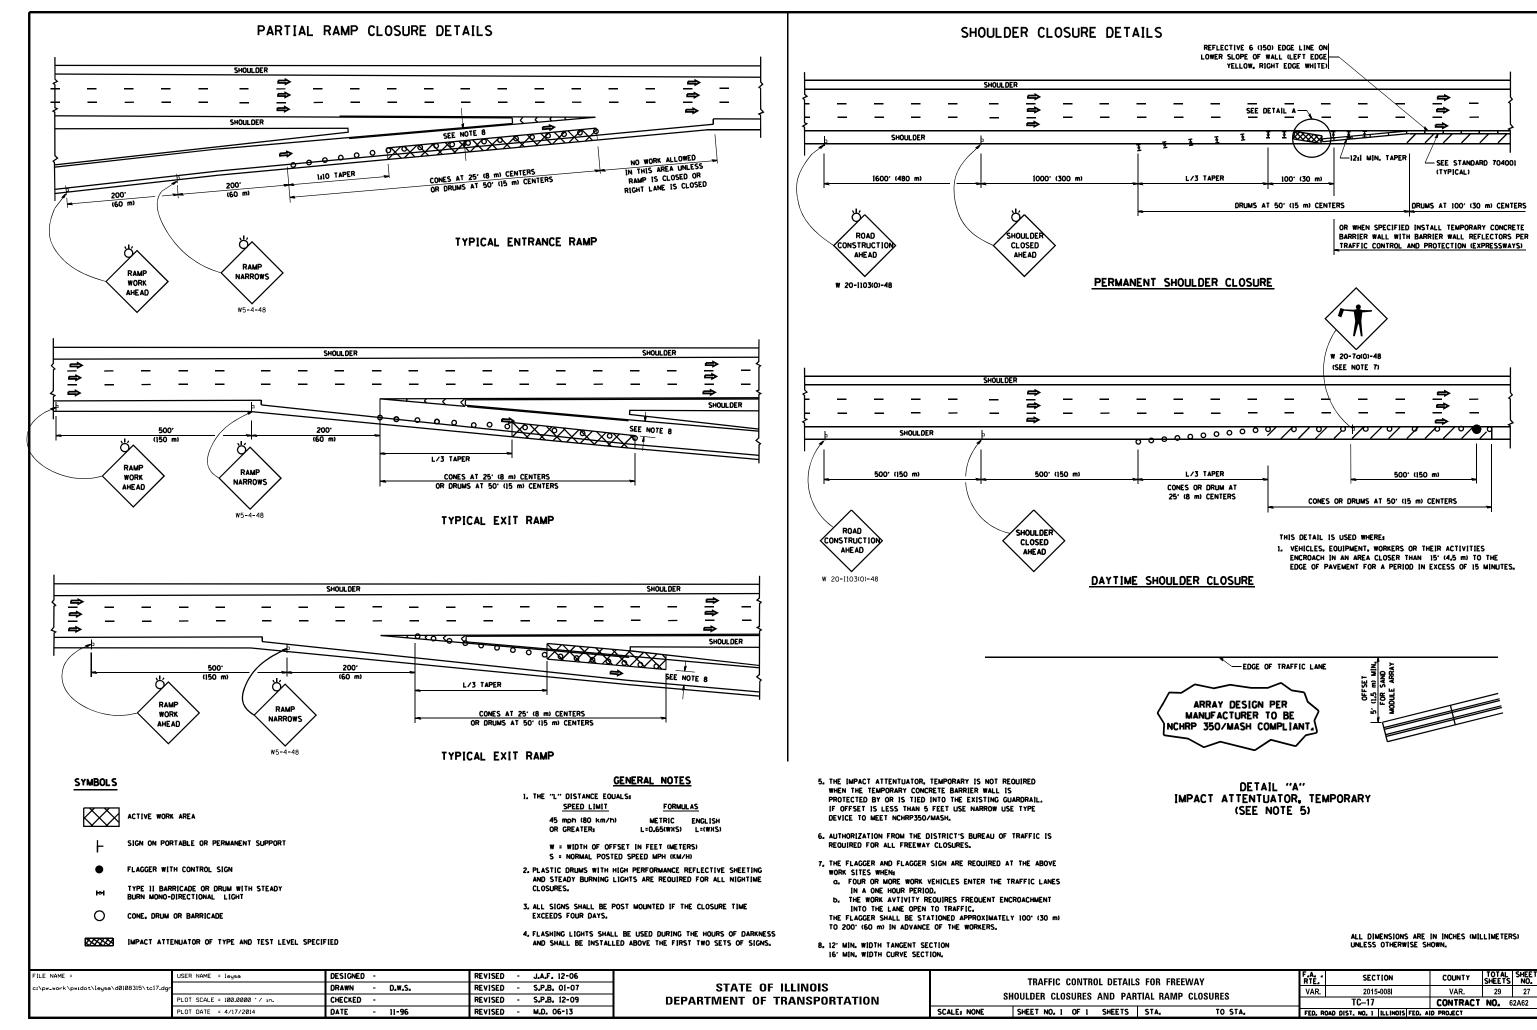


SIGNING FOR FLAGGING OPERATIONS AT WORK ZONE OPENINGS

WORK ZONE EXIT OPENING

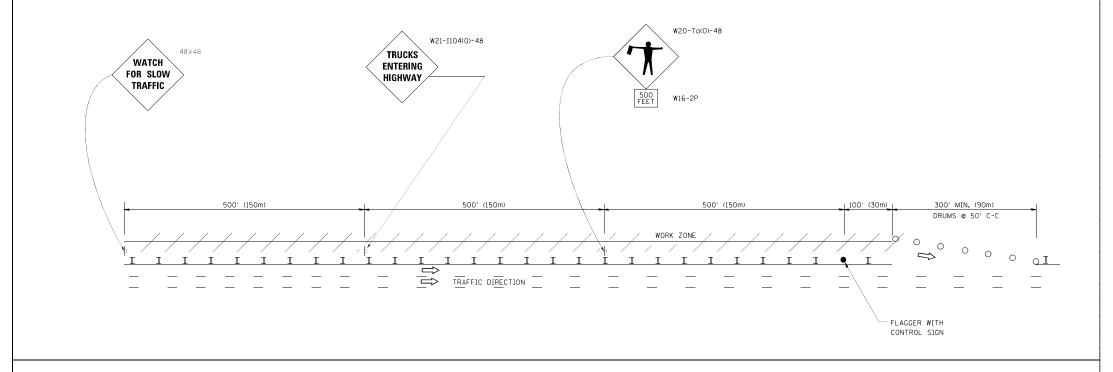


WORK ZONE ENTRY OPENING

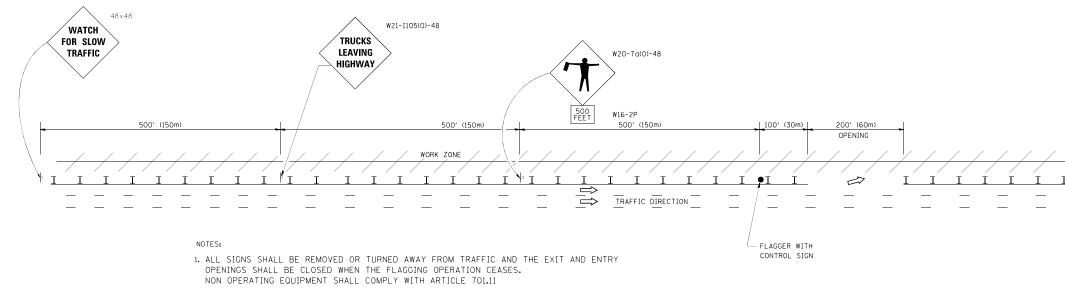

- 2. WORK ZONE OPENINGS SHALL BE A MINIMUM OF ONE HALF MILE APART AND A MINIMUM OF ONE QUARTER MILE FROM ALL ENTRANCE AND EXIT RAMPS.
- 3. EXITING THE WORK ZONE AT ANY PLACE OTHER THAN AT A WORK ZONE EXIT OPENING WILL BE PROHIBITED.
- 4. ALL VEHICLES SHALL ENTER THE WORK ZONE AT ENTRY OPENINGS, USING THEIR TURN SIGNALS TO WARN MOTORISTS
- 5. FLAGGERS SHALL NOT STOP TRAFFIC OR DIRECT TRAFFIC INTO AN ADJACENT LANE.

ALL DIMENSIONS ARE IN INCHES (MILLIMETERS) UNLESS OTHERWISE SHOWN

FILE NAME =	USER NAME = footemj	DESIGNED -	REVISED - J.A.F. 02-06	OTATE OF HAINOID	FR	REEWAY/EXPRESSWAY SIGNING FOR FLAGGING	OPERATIONS	F.A RTE.	SECTION	COUNTY	TOTAL SHEETS	SHEET NO.
c:\pw_work\pwidot\footemj\d0108315\tc	8.dgn	DRAWN -	REVISED - S.P.B. 01-07	STATE OF ILLINOIS	AT WORK ZONE OPENINGS ON FREEWAYS/EXPRESSWAYS		VAR.	2015-008	VAR.	29	28	
	PLOT DATE = 7/8/2013	DATE -	REVISED - S.P.B. 12-09 REVISED - M.D. 06-13	DEPARTMENT OF TRANSPORTATION	SCALE: NONE SHEET NO. 1 OF 1 SHEETS STA. TO STA.			FED. ROAD D	TC-18 DIST. NO. 1 ILLINOIS F	CONTRACT	T NO. 6	32A62

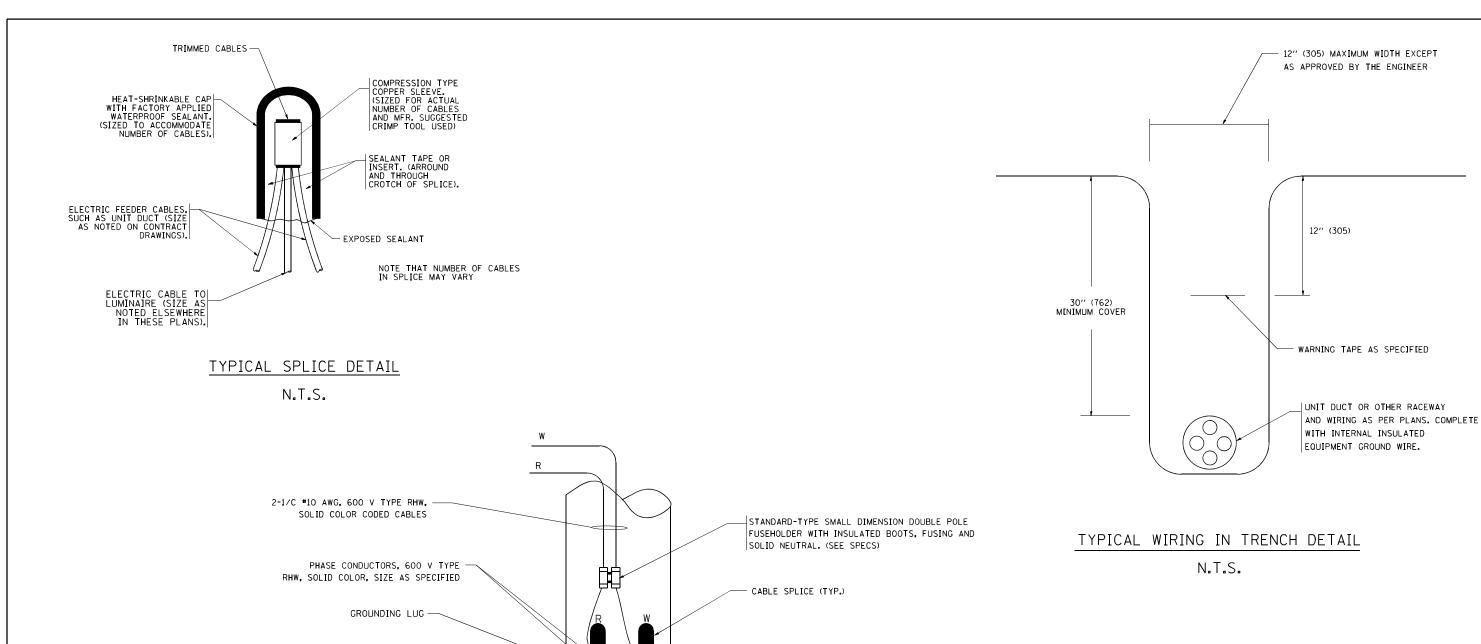

SPLICE GROUND WIRE AND PIGTAIL SAME SIZE

EXTENSION TO POLE GROUNDING LUG

INSULATED GROUND WIRE, 600 V TYPE RHW,
SOLID COLOR GREEN, SIZE AS SPECIFIED

POLE WIRING DETAIL

UNIT DUCT (TYP)

N.T.S.

FILE NAME =	USER NAME = gaglianobt	DESIGNED -	REVISED - 08-08-03		MISC. ELECTRICAL DETAILS	F.A.	SECTION	COUNTY SHEET NO.
W:\diststd\22×34\be702.dgn		DRAWN -	REVISED -	STATE OF ILLINOIS		VAR.	2015-008	VAR. 29 29
	PLOT SCALE = 50.000 '/ IN.	CHECKED -	REVISED -	DEPARTMENT OF TRANSPORTATION	SHEET A		BE-702	CONTRACT NO. 62A62
	PLOT DATE = 1/4/2008	DATE -	REVISED -		SCALE: NONE SHEET NO. 1 OF 1 SHEETS STA. TO STA.	FED. ROAD	DIST. NO. 1 [LLE	NOIS FED. AID PROJECT

POLE BASE