KANE

CONTRACT NO. 63744

0

0


ADT 37,000 (31,100) NORTH ON KIRK ROAD ADT 3,000 (2,100) WEST ON DOUGLAS ROAD POSTED SPEED LIMIT =

45 MPH NORTH ON KIRK ROAD 45 MPH SOUTH ON KIRK ROAD

30 MPH WEST ON DOUGLAS ROAD

FOR INDEX OF SHEETS, AND LIST OF IDOT HIGHWAY STANDARDS, SEE SHEET NO. 2

THIS PROJECT IS LOCATED IN THE VILLAGE OF BATAVIA

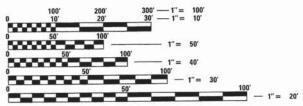

ENGINEERING SCALES. REDUCED SIZED PLANS WILL NOT CONFORM TO STANDARD SCALES. IN MAKING MEASUREMENTS

J.U.L.I.E. JOINT UTILITY LOCATION INFORMATION FOR EXCAVATION 1-800-892-0123

STATE OF ILLINOIS

DEPARTMENT OF TRANSPORTATION

DIVISION OF HIGHWAYS

PLANS FOR PROPOSED FEDERAL AID HIGHWAY

FAP 360 (CH 77-KIRK ROAD) AT DOUGLAS ROAD INTERSECTION IMPROVEMENT SECTION 08-00377-00-CH PROJECT CMM-9003(137) KANE COUNTY

3RD PM **RANGE 8 EAST** BATAVIA GENEVA TOWNSHIP **BEGIN PROJECT LOCATION MAP ©** INTERSECTION STA 93+57.00 SCALE 1" = 900 FEET STA 50 + 00.00

AUTHORITY OF THE STATE OF

PRINTED BY THE ILLINOIS

P.E. SEAL H.W. LOCHNER, INC. 225 W. WASHINGTON ST., 12TH FLOOR CHICAGO, IL 60606

LOCATION OF SECTION INDICATED THUS: -

(312) 372-3011

FAX: (312) 372-5974 **EXPIRES**

5/28/14 DATE

KANE COUNTY DIVISION OF TRANSPORTATION APPROVED COUNTY ENGINEER

STATE OF ILLINOIS DEPARTMENT OF TRANSPORTATION **DIVISION OF HIGHWAYS**

5.30 PASSED

DISTRICT 1 ENGINEER OF LOCAL ROADS & STREETS

RELEASING FOR BID BASED ON LIMITED

DEPUTY DIRECTOR OF HIGHWAYS, REGION 1 ENGINEER

PRINTED BY THE AUTHORITY OF THE STATE OF ILLINOIS

ON REDUCED PLANS, THE ABOVE SCALES MAY BE USED.

OR 811

CONTRACT NO. 63744

PROJECT LIMITS

STA 45 + 29.30

GROSS LENGTH = 1457.14 FEET (0.276 MILE) **NET LENGTH = 1457.14 FEET (0.276 MILE)**

C-91-164-09 **END PROJECT** STA 108 + 14.14

N.T.S.

INDEX OF SHEETS

TITLE SHEET
GENERAL NOTES & INDEX OF SHEETS
SUMMARY OF QUANTITIES
EXISTING TYPICAL
PROPOSED TYPICAL
SCHEDULE OF QUANTITIES
ALIGNMENT, TIES & BENCHMARKS
REMOVAL PLAN
KIRK ROAD PLAN AND PROFILE
DOUGLAS ROAD PLAN AND PROFILE
DETOUR PLAN
MOT GENERAL NOTES
MOT TYPICAL SECTION
CONSTRUCTION STAGING/MAINTENANCE OF TRAFFIC STAGE 1
CONSTRUCTION STAGING/MAINTENANCE OF TRAFFIC STAGE 2
EROSION AND SEDIMENT CONTROL
DRAINAGE AND UTILITY SHEETS
INTERSECTION DETAIL
PAVEMENT MARKING AND SIGNING
EROSION AND SEDIMENT CONTROL DETAILS
IDOT DISTRICT 1 DETAIL SHEETS
BATAVIA DETAIL SHEET
KIRK ROAD CROSS SECTION
DOUGLAS CROSS SECTIONS

LIST OF IDOT HIGHWAY STANDARDS

NUMBER	DESCRIPTION
000001-06	STANDARD SYMBOLS ABBREVIATIONS & PATTERNS
001001-02	AREAS OF REINFORCEMENT BARS
001006	DECIMAL OF AN INCH AND OF A FOOT
280001-07	TEMPORARY EROSION CONTROL SYSTEMS
424001-07	PERPENDICULAR CURB RAMPS FOR SIDEWALKS
424011-01	CORNER PARALLEL CURB RAMPS FOR SIDEWALKS
424026-01	ENTRANCE/ALLEY PEDESTRIAN CROSSING
442201-03	CLASS C AND D PATCHES
542301-03	PRECAST REINFORCED CONCRETE FLARED END SECTION
601001-04	SUB-SURFACE DRAINS
602001-02	CATCH BASIN TYPE A
602011-02	CATCH BASIN TYPE C
602301-04	INLET TYPE A
502401-03	MANHOLE TYPE A
602406-06	MANHOLE TYPE A 6' DIAMETER
602601-03	FLAT SLAB TOP, PRECAST REINFORCED CONCRETE
502701-02	MANHOLE STEPS
504011-04	FRAME AND GRATE TYPE 3V
504091-02	FRAME AND GRATE TYPE 24
506001-05	CONCRETE CURB TYPE B AND COMBINATION CONCRETE CURB AND GUTTER
701001-02	OFF-RD OPERATIONS, 2L, 2W, MORE THAN 15' AWAY
701006-05	OFF-RD OPERATIONS, 2L, 2W, 15' TO 24" FROM PAVEMENT EDGE
701011-04	OFF-RD MOVING OPERATIONS 2L, 2W, DAY ONLY
701301-04	LANE CLOSURE, 2L, 2W, SHORT TIME OPERATIONS
701311-03	LANE CLOSURE, 2L, 2W, SHORT TIME MOVING OPERATIONS, DAY ONLY
701326-04	LANE CLOSURE, 2L, 2W PAVEMENT WIDENING FOR SPEEDS >= 45 MPH
701426-06	LANE CLOSURE, MULTILANE, INTERMITTENT OR MOVING OPER., FOR SPEEDS >= 45 MPH
701501-06	URBAN LANE CLOSURE, 2L, 2W, UNDIVIDED
701606-09	URBAN LANE CLOSURE, MULTILANE, 2W WITH MOUNTABLE MEDIAN
701701-09	URBAN LANE CLOSURE, MULTILANE INTERSECTION
701901-03	TRAFFIC CONTROL DEVICES
720001-01	SIGN PANEL MOUNTING DETAILS
720006-04	SIGN PANEL ERECTION DETAILS
720011-01	METAL POSTS FOR SIGNS, MARKERS AND DELINEATORS
720021-02	SIGN PANELS, EXTRUDED ALUMINUM TYPE
728001-01	TELESCOPING STEEL SIGN SUPPORT
729001-01	APPLICATIONS OF TYPES A AND B METAL POSTS (FOR SIGNS & MARKERS)
731001-01	BASE FOR TELESCOPING STEEL SIGN SUPPORT
602306-03	INLET TYPE B

GENERAL NOTES

- 1. ALL CONSTRUCTION SHALL BE DONE IN ACCORDANCE WITH THE DETAILS, PLANS, AND THE SPECIAL PROVISIONS INCLUDED IN THE CONTRACT DOCUMENTS, AND THE LATEST EDITION OF THE FOLLOWING STATE OF ILLINOIS SPECIFICATIONS: "THE STANDARD SPECIFICATIONS FOR THE ROAD AND BRIDGE CONSTRUCTION" (REFERRED TO AS THE STANDARD SPECIFICATIONS), THE SUPPLEMENTAL STANDARD SPECIFICATIONS AND RECURRING SPECIAL PROVISIONS, THE MANUAL OF UNIFORM TRAFFIC CONTROL DEVICES FOR TRAFFIC CONTROL ITEMS.
- 2. THE LOCATIONS OF UTILITIES SHOWN ON THE PLANS ARE APPROXIMATE AND THE ENGINEER DOES NOT GUARANTEE THEIR ACCURACY. THE CONTRACTOR SHALL HAVE THE RESPECTIVE UTILITY COMPANIES FIELD LOCATE ALL THEIR FACILITIES PRIOR TO BEGINNING CONSTRUCTION. THE CONTRACTOR SHALL ALSO VERIFY THE DEPTHS OF THE EXISTING UTILITIES IF NECESSARY. ANY RELOCATION OR LOWERING OF THE UTILITIES SHALL BE COORDINATED BY THE CONTRACTOR.
- 3. THE CONTRACTOR SHALL CONTACT JULIE AT LEAST 48 HOURS PRIOR TO EXCAVATION TO DETERMINE WHICH UTILITIES ARE IN THE AREA.
- 4. THE CONTRACTOR SHALL BE RESPONSIBLE FOR THE PROTECTION OF ALL UNDERGROUND AND SURFACE UTILITIES INCLUDING THOSE THAT MAY NOT BE SHOWN ON THE PLANS. ANY UTILITY THAT IS DAMAGED DURING CONSTRUCTION SHALL BE REPAIRED OR REPLACED AT THE CONTRACTOR'S EXPENSE TO THE SATISFACTION OF THE ENGINEER.
- 5. THE CONTRACTOR SHALL PROTECT AND CAREFULLY PRESERVE ALL SECTION OR SUBSECTION MONUMENTS OR PROPERTY OR REFERENCE MARKERS UNTIL THE OWNERS, HIS/HER AGENTS OR AN AUTHORIZED SURVEYOR HAS WITNESSED OR OTHERWISE REFERENCED THEIR LOCATIONS.
- 6. EXISTING ASPHALT SIDEWALK TO REMAIN IN PLACE SHALL BE SAW CUT FULL DEPTH TO PROVIDE A NEAT VERTICAL FACE BETWEEN THE PROPOSED AND EXISTING AND SHALL BE INCLUDED IN THE PRICE OF SIDEWALK PAY ITEMS.
- 7. DURING CONSTRUCTION, THE CONTRACTOR SHALL INSURE POSITIVE SITE DRAINAGE AT THE CONCLUSION OF EACH DAY. ANY LOOSE MATERIAL DEPOSITED ON THE FLOW LINE OF GUTTERS, DRAINAGE STRUCTURES, DITCHES, ETC. SUCH THAT THE NATURAL FLOW LINE OF THE WATER IS OBSTRUCTED, SHALL BE REMOVED AT THE CLOSE OF EACH WORKING DAY BY THE RESPONSIBLE PARTY, AT THE CONCLUSION OF CONSTRUCTION OPERATIONS, ALL DRAINAGE STRUCTURES AND FLOW LINES SHALL BE FREE FROM DIRT AND DEBRIS. THIS WORK SHALL BE INCLUDED IN THE COST OF MOBILIZATION.
- 8. SEEDING SHALL NOT BE PERMITTED AT ANY TIME WHEN THE GROUND IS FROZEN, WET, OR IN AN UNTILLABLE CONDITION. LOCATIONS TO BE SEEDED WILL BE DETERMINED BY THE ENGINEER.
- 9. ONLY THOSE TREES DESIGNATED BY THE ENGINEER OR SHOWN ON THE PLANS SHALL BE REMOVED. ANY DAMAGE TO EXISTING TREES SHALL BE THE RESPONSIBILITY OF THE CONTRACTOR.
- 10. TEMPORARY ROADWAY AND SIDEWALK CLOSURES WILL BE PERMITTED ONLY WITH THE ENGINEER'S APPROVAL. REQUESTS FOR CLOSURES MUST BE SUBMITTED TO THE ENGINEER AT LEAST 72 HOURS BEFORE THE CLOSURE. TRAFFIC AND PEDESTRIAN CONTROL SHALL BE IN ACCORDANCE WITH IDOT STANDARDS.
- 11. THE CONTRACTOR SHALL COMPLY WITH ALL FEDERAL, STATE, AND LOCAL SAFETY REGULATIONS AS WELL AS THOSE SPECIFIED IN THE CONTRACT PLANS AND SPECIFICATIONS.
- 12. THE CONTRACTOR SHALL COMPLETE CLEAN UP AND RESTORATION OF THE ENTIRE PROJECT AREA AND APPROVED BY THE ENGINEER WITHIN 14 DAYS OF CONTRACT COMPLETION DATE.
- 13. EXISTING CONDITIONS WERE OBTAINED FROM THE BEST AVAILABLE INFORMATION. INFORMATION SHOWN IS NOT GUARANTEED ALL-INCLUSIVE OR CORRECT. THE CONTRACTOR IS TO VERIFY THE EXISTING CONDITIONS PRIOR TO CONSTRUCTION.
- 14. UPON COMPLETION OF THE PROJECT AND ACCEPTANCE BY THE ENGINEER, THE CONTRACTOR WILL SUBMIT ONE SET OF AS-BUILT DRAWINGS TO THE ENGINEER AS INCLUDED IN THE COST OF MOBILIZATION.
- 15. THE REMOVAL OF ALL EXISTING TRAFFIC SIGNS DESIGNATED ON THE PLANS AS WELL AS THE INSTALLATION OF ALL PROPOSED SIGNS SHALL BE PERFORMED BY KDOT. RAY JOHNSON (630) 406-7356. THE CONTRACTOR SHALL CONTACT THE ENGINEER AND KDOT A MINIMUM OF 48 HOURS PRIOR TO THE DESIRED DATE FOR THE REMOVAL/INSTALLATION OF ALL SIGNS.
- 16. THE CONTRACTOR SHALL ENSURE THAT MAILBOXES ALONG THE ROUTE ARE NOT DAMAGED DUE TO CONSTRUCTION ACTIVITIES, MAILBOXES THAT ARE DAMAGED AS A RESULT OF CONSTRUCTION ACTIVITIES SHALL BE REPLACED IN KIND AT NO EXPENSE TO THE OWNER.
- 17. TEN (10) FEET TRANSITIONS SHALL BE USED TO MATCH PROPOSED CURB AND GUTTER ITEMS OF WORK TO EXISTING CURBS AND GUTTERS IN THE FIELD, UNLESS OTHERWISE SHOWN. THE TRANSITIONS SHALL BE PAID FOR AT THE CONTRACT UNIT PRICE FOR THE PROPOSED ITEMS OF WORK SPECIFIED.
- 18. THE OFFSETS TO DRAINAGE STRUCTURES ARE TO THE EDGE OF PAVEMENT. THE RIM ELEVATIONS FOR DRAINAGE STRUCTURES LOCATED WITHIN CURB AND GUTTER ARE AT THE EDGE OF PAVEMENT. THE RIM ELEVATIONS & OFFSETS FOR DRAINAGE STRUCTURES LOCATED OUTSIDE THE CURB AND GUTTER ARE TO THE CENTER OF STRUCTURE.
- 19. A NOMINAL QUANTITY OF 20.4 TONS FOR MIXTURE FOR CRACKS, JOINTS, AND FLANGEWAYS IS ADDED TO THE SUMMARY OF QUANTITIES AS A PERCENTAGE OF THE LEVELING BINDER COURSE.

LIST OF IDOT DISTRICT 1 DETAIL SHEETS

NUMBER	DESCRIPTION
BD-01	DRIVEWAY DETAILS - DISTANCE BETWEEN R.O.W. AND CURB OR EDGE GREATER THAN OR EQUAL TO 15' (4.5m)
BD-07	STORM SEWER CONNECTION TO EXISTING SEWER
BD-22	PAVEMENT PATCHING FOR HMA SURFACED PAVEMENT
BD-32	BUTT JOINT AND HMA TAPER
TC-10	TRAFFIC CONTROL AND PROTECTION FOR SIDEROADS, INTERSECTIONS, AND DRIVEWAYS
TC-11	RAISED REFLECTIVE PAVEMENT MARKERS (SNOW PLOW RESISTANT)
TC-13	DISTRICT ONE TYPICAL PAVEMENT MARKINGS
TC-16	PAVEMENT MARKING LETTERS AND SYMBOLS FOR TRAFFIC STAGING
TC-22	ARTERIAL ROAD INFORMATION SIGN
TC-26	DRIVEWAY ENTRANCE SIGNING

FILE NAME =	USER NAME = _USER_	DESIGNED -	REVISED -								F.A.P.	SECTION	COUNTY	TOTAL	SHEET
Ts\5167-KirkDouglasPhase2\C:vil\Dgn\01Ge	neral\5167 Index Sht.dgn	DRAWN -	REVISED -	KANE COUNTY		INDEX 0	F SHEET	TS AND	GENERAL	NOTES				SHEETS	NO.
	PLOT SCALE = 100.0000 ' / in.	CHECKED -	REVISED -	DIVISION OF TRANSPORTATION							360	08-00377-00-CH	7117174		27744
	PLOT DATE = 5/28/2014	DATE -	REVISED -		SCALE: N.T.S.	SHEET NO.	OF	SHEETS	STA.	TO STA.		ILLINOIS FED.	SECTION COUNTY TOTAL SHEETS 08-00377-00-CH KANE 40 CONTRACT NO. 6 ILLINOIS FED. AID PROJECT)3144	

SP	CODE	ITEM	UNIT	TOTAL	ROADWAY	SAFTEY	LANDSCPN	TRAINE
SF.	NO.		1000000	TOTAL		0021	LANDSCPN 0031	0042
	20101000	TEMPORARY FENCE	FOOT	217	217			
	20100110	TREE REMOVAL (6 TO 15 UNITS DIAMETER)	UNIT	228			228	
	20100210	TREE REMOVAL (OVER 15 UNITS DIAMETER)	UNIT	47			47	
			- ONZ			-	71	-
_	20200100	FARTH EVOLVATION	011.1/0	1.700				-
	20200100	EARTH EXCAVATION	CU YD	1,380	1,380			
150								
	20201200	REMOVAL AND DISPOSAL OF UNSUITABLE MATERIAL	CU YD	25	25			
	20700220	POROUS GRANULAR EMBANKMENT	CU YD	103	103			
					V-200		-	-
	20800150	TRENCH BACKFILL	CII VD	77	77			-
	20000130	TRENCH DACKFILL	CU YD	33	33			
				-				
	21101505	TOPSOIL EXCAVATION AND PLACEMENT	CU YD	330	330			
*	25000210	SEEDING, CLASS 2A	ACRE	0.5			0.5	
*	25000400	NITROGEN FERTILIZER NUTRIENT	POUND	46			46	-
-			1 00110	10			76	-
	05000500	CHACDIAN IS FERTY TITO MITOTALIT						
*	25000500	PHOSPHORUS FERTILIZER NUTRIENT	POUND	46			46	
*	25000600	POTASSIUM FERTILIZER NUTRIENT	POUND	46			46	
*	25100115	MULCH, METHOD 2	ACRE	0.5			0.5	
							0.5	
*	25100630	EROSION CONTROL BLANKET	CO VD	0.440			0 1110	
**	23100630	EROSION CONTROL BLANKET	SQ YD	2,448			2,448	
	28000250	TEMPORARY EROSION CONTROL SEEDING	POUND	153	153			
	28000400	PERIMETER EROSION BARRIER	FOOT	1,994	1,994			
	28000510	INLET FILTERS	EACH	19	19			
_		ATTENDED 1 1 AND 1 TO 1 TO 1	LACIT	13	13			-
	70700100		-					-
-	30300106	AGGREGATE SUBGRADE IMPROVEMENT 6"	SQ YD	857	857			
	30300112	AGGREGATE SUBGRADE IMPROVEMENT 12"	SQ YD	1,832	1,832			
	35501316	HOT-MIX ASPHALT BASE COURSE, 8"	SQ YD	133	133			
	35600712	HOT-MIX ASPHALT BASE COURSE WIDENING, 9"	CO VD	1.707	1 707			
	33600712	HOT-MIX ASPHALT BASE COURSE WIDENING, 9	SQ YD	1,707	1,707			
	74.000.000							
	40600400	MIXTURE FOR CRACKS, JOINTS, AND FLANGEWAYS	TON	24	24			
	40600635	LEVELING BINDER (MACHINE METHOD), N70	TON	477	477			
							-	-
	40600982	HAT-MTY ACQUALT CUDEACE DEMOVAL - BUTT JOINT	CC VC	75	75			
_	40000382	HOT-MIX ASPHALT SURFACE REMOVAL - BUTT JOINT	SQ YD	75	75			
	40603090	HOT-MIX ASPHALT BINDER COURSE, IL-19.0, N90	TON	215	215			

• - SPECIALTY ITEM

Δ - 100% LOCAL COST

FILE NAME =	USER NAME = _USER_	DESIGNED -	REVISED -
T:\5167-K:rkDouglesPhase2\C:v:1\Dgn\020u	ntities\5167 SOO Shtidgn	DRAWN -	REVISED -
	PLOT SCALE = 100.0000 ' / in.	CHECKED -	REVISED -
	PLOT DATE = 5/29/2014	DATE -	REVISED -

SCALE:

			SUMMAR	Y OF	QUANTITIES			
_	SHEET	NO.	OF	SHEETS	STA.	TO	STA.	

	CODE	ITEM	UNIT	TOTAL	ROADWAY	SAFTEY	TION CODE	TRAINE
Р	NO.	1) EW	OIALI	TOTAL	0004	0021	LANDSCPNO 0031	0042
	40603335	HOT-MIX ASPHALT SURFACE COURSE, MIX "D", N50	TON	15	15			
	40603595	POLYMERIZED HOT-MIX ASPHALT SURFACE COURSE, MIX "F", N90	TON	1,279	1,279			
	40003333	FOLIMENTED NOT MIX ASTRACT SON ACE COUNSE, MIX F , NO	1011	1,1.10	1,0			
						16000000		
	42400200	PORTLAND CEMENT CONCRETE SIDEWALK 5 INCH	SQ FT	3,536		3,536		
	42400800	DETECTABLE WARNINGS	SQ FT	89		89		
_								
	44000100	ALVENEUE PERIODIC	SO VD	400	402			
_	44000100	PAVEMENT REMOVAL	SQ YD	402	402			
	44000200	DRIVEWAY PAVEMENT REMOVAL	SQ YD	118	118			
	44000500	COMBINATION CURB AND GUTTER REMOVAL	FOOT	3,185	3,185			
	11000300	COMBINATION COMBINED OF THE NEW YAR	1001	0,100	- CATOO		1897 N. 1999	
			-	100000000000000000000000000000000000000	170000000			
	44000600	SIDEWALK REMOVAL	SQ FT	3,658	3,658			
	44003100	MEDIAN REMOVAL	SQ FT	796	796			Jess-1-37
	44201337	CLASS C PATCHES, TYPE I, 9 INCH	SQ YD	28	28			
	44213200	SAW CUTS	FOOT	807	807			
	21			F77-78-5-78-5				
-	44700000	CTAYD DESIGNATIVE OBJECT CONTROL TREATMENT	FOOT	2 277	2 277			
	44300200	STRIP REFLECTIVE CRACK CONTROL TREATMENT	F001	2,233	2,233		-	
	50104400	CONCRETE HEADWALL REMOVAL	EACH	1	1			
	54213657	PRECAST REINFORCED CONCRETE FLARED END SECTIONS 12"	EACH	2	2			
	0 1210001	THEORY NEITH GROED GORGIETE FEMILE END SECTIONS IE						
			40000000		Jane 1			
	550A0050	STORM SEWERS, CLASS A, TYPE 1 12"	FOOT	128	128			
	550A0070	STORM SEWERS, CLASS A, TYPE 1 15"	FOOT	40	40			
200			1					
_			FOOT	70	70	-		-
	550A0410	STORM SEWERS, CLASS A, TYPE 2 24"	FOOT	32	32			
				san and the san			A CONTRACTOR	
	55100500	STORM SEWER REMOVAL 12"	FOOT	32	32			
-	55100700	STORM SEWER REMOVAL 15"	FOOT	38	38			
	22100100	SINUM SEMEN NEWAANT 13.	1001	30	50			
	56400500	FIRE HYDRANTS TO BE REMOVED	EACH	1	1			
v	56400820	FIRE HYDRANT WITH AUXILIARY VALVE AND VALVE BOX	EACH	1	1			
K	55,00020	THE THEORET HALL DEVIALATION THERE HAVE					-	-
			-		700			-
	60107600	PIPE UNDERDRAINS 4"	FOOT	127	127			
	60108100	PIPE UNDERDRAINS 4" (SPECIAL)	FOOT	10	10			
-				-				
	52000 00 00 00 00 00 00 00 00 00 00 00 00							
	60200310	CATCH BASINS, TYPE A, 4'-DIAMETER, TYPE 3V FRAME AND GRATE	EACH	1	1			
	60207115	CATCH BASINS, TYPE C, TYPE 3V FRAME AND GRATE	EACH	2	2			
	100000000000000000000000000000000000000	United the region of the control of	42770000000			-	_	

- SPECIALTY ITEM
 Δ - 100% LOCAL COST

FILE NAME =	USER NAME = _USER_	DESIGNED -	REVISED -
T:\5167-KirkDouglasPhase2\Civil\Dgn\02Qu	entities\5167 SOO Sht.dgn	DRAWN -	REVISED -
	PLOT SCALE = 100,00000 '/ in.	CHECKED -	REVISED -
	PLOT DATE = 5/29/2014	DATE -	REVISED -

KANE COUNTY
DIVISION OF TRANSPORTATION

SCALE:

S	UMM	ARY OF O	UANTITIES		F.A.P. RTE.	SECTION	COUNTY	TOTAL
					360	08-00377-00-CH	KANE	40
							CONTRAC	T NO. (
SHEET NO.	OF	SHEETS	STA.	TO STA.		ILLINOIS FED.	AID PROJECT	

	CODE	ITEM	UNIT	TOTAL			TION CODE	
	NO.			QUANTITY	0004	0021	LANDSCPNO 0031	0042
	60208240	CATCH BASINS, TYPE C, TYPE 24 FRAME AND GRATE	EACH	3	3			
	60218300	MANHOLES, TYPE A, 4'-DIAMETER, TYPE 1 FRAME, OPEN LID	EACH	1	1			
	60218400	MANHOLES, TYPE A, 4'-DIAMETER, TYPE 1 FRAME, CLOSED LID	EACH	1	1			
								tronens.
-	60221100	MANUALES TYPE A EX-DIAMETER TYPE I ERAME CLOSED LID	EACH	2	2			
-	60221100	MANHOLES, TYPE A, 5'-DIAMETER, TYPE 1 FRAME, CLOSED LID	LACH	- 2	2			
-	University of			1,000				
_	60237470	INLETS, TYPE A, TYPE 24 FRAME AND GRATE	EACH	2	2			
	60250200	CATCH BASINS TO BE ADJUSTED	EACH	2	2			
	60255500	MANHOLES TO BE ADJUSTED	EACH	4	4			
-	60260100	INLETS TO BE ADJUSTED	EACH	1	1			-
-	00200100	INCETS TO BE ADJUSTED	LACIT	1	-			-
-								
_	60265900	VALVE VAULTS TO BE ADJUSTED WITH NEW TYPE 1 FRAME, CLOSED LID	EACH	1	1			
	60500050	REMOVING CATCH BASINS	EACH	6	6			
	60500060	REMOVING INLETS	EACH	2	2			
-	60500080	REMOVING CATCH BASINS TO MAINTAIN FLOW	EACH	2	2		-	
-	00300000	REMOVING CATCH BASINS TO MAINTAIN FEOR	LACIT	-	2			-
-								
_	60600605	CONCRETE CURB, TYPE B	FOOT	57	57			
	60603800	COMBINATION CONCRETE CURB AND GUTTER, TYPE B-6.12	FOOT	1,895	1,895			
	60605000	COMBINATION CONCRETE CURB AND GUTTER, TYPE B-6.24	FOOT	1,101	1,101			
			1					
-	66900200	NON-SPECIAL WASTE DISPOSAL	CU YD	600	600		-	
-	00300200	NON-SPECIAL WASTE DISTOSAL	00 10	000	000		-	
-					-			-
	66900450	SPECIAL WASTE PLANS AND REPORTS	L SUM	1	1			
	66900530	SOIL DISPOSAL ANALYSIS	EACH	4	4			
	67100100	MOBILIZATION	L SUM	1	1			
	70106800	CHANGEABLE MESSAGE SIGN	CAL MO	9	9			
							-	-
	70700100	CHART TERM DAVENEYT MARKEN	FOOT	0.417	0.417	-	-	
-	10300100	SHORT TERM PAVEMENT MARKING	FOOT	2,417	2,417			-
_								
	70300210	TEMPORARY PAVEMENT MARKING LETTERS AND SYMBOLS	SQ FT	73	73			
	70300220	TEMPORARY PAVEMENT MARKING - LINE 4"	FOOT	13,487	13,487			
					-	-	-	
	70300240	TEMPORARY PAVEMENT MARKING - LINE 6"	FOOT	356	356			
	70300240	TEMPORARY PAVEMENT MARKING - LINE 6"	FOOT	356	356			
		TEMPORARY PAVEMENT MARKING - LINE 6" TEMPORARY PAVEMENT MARKING - LINE 24"	FOOT	356 18	356			

- SPECIALTY ITEM
 Δ - 100% LOCAL COST

| FILE NAME = USER NAME = USER_ DESIGNED - REVISED - Ti\5167-KirkDouglesPhese2\Civil\Dgn\020uentstase\5167-SD0-Sht.dgn DRAWN - REVISED - PLOT SCALE = 180.80000 '/ in. CHECKED - REVISED - PLOT DATE = 5/29/2814 DATE - REVISED - REVISED - CHECKED - CHECKED - REVISED - CHECKED -

KANE COUNTY
DIVISION OF TRANSPORTATION

SCALE:

>	CODE	ITEM	UNIT	TOTAL			LANDSCPNO 0031	TRAINEE
	NO.		CO ET	QUANTITY	Comment of the Commen	0021	0031	0042
	70301000	WORK ZONE PAVEMENT MARKING REMOVAL	SQ FT	5,588	5,588			
	78009000	MODIFIED URETHANE PAVEMENT MARKING - LETTERS AND SYMBOLS	SQ FT	328		328		
	78009004	MODIFIED URETHANE PAVEMENT MARKING - LINE 4"	FOOT	9,114		9,114		
	78009006	MODIFIED URETHANE PAVEMENT MARKING - LINE 6"	FOOT	1,589		1,589		
-	78009012	MODIFIED UPSTHANE PAVENENT MARVING LINE 10//	FOOT	445		445		
	18003012	MODIFIED URETHANE PAVEMENT MARKING - LINE 12"	1001	443		443		
_								
	78009024	MODIFIED URETHANE PAVEMENT MARKING - LINE 24"	FOOT	71		71		
	78100100	RAISED REFLECTIVE PAVEMENT MARKER	EACH	229		229		
	78300100	PAVEMENT MARKING REMOVAL	SQ FT	2,679		2,679		
	78300200	RAISED REFLECTIVE PAVEMENT MARKER REMOVAL	EACH	172		172		
_	16300200	RAISED REFLECTIVE PAVEMENT MARKER REMOVAL	EACH	112		112		
	A2002920	TREE, CELTIS OCCIDENTALIS (COMMON HACKBERRY), 2-1/2" CALIPER, BALLED AND BURLAPPED	EACH	6			6	
	A2005020	TREE, GYMNOCLADUS DIOICUS (KENTUCKY COFFEETREE), 2-1/2" CALIPER, BALLED AND BURLAPPED	EACH	2			2	
	A2006316	TREE, PRUNUS SEROTINA (BLACK CHERRY), 2" CALIPER, BALLED AND BURLAPPED	EACH	4			4	
	A2006420	TREE, QUERCUS ALBA (WHITE OAK), 2-1/2" CALIPER, BALLED AND BURLAPPED	EACH	8			8	
-	AZOOGAZO	TREE, QUENCUS ALDA (MITTE CAR), 2-1/2 CALIFER, BALLED AND BORLAFTED	LACIT					
_	A2007820	TREE, TILIA AMERICANA (AMERICAN LINDEN/ BASSWOOD), 2-1/2" CALIPER, BALLED AND BURLAPPED	EACH	3			3	
	X4060110	BITUMINOUS MATERIALS (PRIME COAT)	POUND	10,481	10,481			
	X4400100	PORTLAND CEMENT CONCRETE SURFACE REMOVAL (VARIABLE DEPTH)	SQ YD	733	733			
	X4401198	HOT-MIX ASPHALT SURFACE REMOVAL, VARIABLE DEPTH	SQ YD	10,536	10,536			
_	ATTOLISE	TOT MAN AGENTAL SON AGE TAMAGEE SELTIF		10,000	13/333			
	V5577000	ATARIA SENERA TA DE ALEMEN AFA	FOOT	710	710		-	
	X5537900	STORM SEWERS TO BE CLEANED 15"	FOOT	318	318	-		
				7 770				
	X6020074	INLETS, TYPE A, TYPE 3V FRAME AND GRATE	EACH	2	2			
	X6020075	INLETS, TYPE B, TYPE 3V FRAME AND GRATE	EACH	1	1			
Ī								
	X7010216	TRAFFIC CONTROL AND PROTECTION, (SPECIAL)	L SUM	1	1		j.	
	Server APAINTEE A							
-	70004030	FOLDED/FORMED PVC PIPELINER, 15 INCH	FOOT	318	318			
_	20004030	FOLDED/FORMED PVC PIPELINER, 15 INCH	F001	310	310			-
							-	
	Z0013798	CONSTRUCTION LAYOUT	L SUM	1	1			
	Z0076600	TRAINEES	HOUR	500				500
	Z0076604	TRAINEES TRAINING PROGRAM GRADUATE	HOUR	500				500
		THOMES THOMAS THEOLOGIC	,,,,,,,,,,	300				550

• - SPECIALTY ITEM Δ - 100% LOCAL COST

FILE NAME = USER NAME = _USER_ DESIGNED - REVISED - T:\5167-KirkDougleePhase2\Civil\Dgn\020uentstase\5167-S00_Sht.dgn DRAWN - REVISED - PLOT_SCALE = 100.0000 '/ in. CHECKED - REVISED - PLOT_DATE = 5/29/2014 DATE - REVISED -

KANE COUNTY
DIVISION OF TRANSPORTATION

SCALE:

SUMMARY OF QUANTITIES						F.A.P. RTE.	SECTION	COUNTY	TOTAL	SHEET NO.
						360	08-00377-00-CH	KANE	40	6
								CONTRACT	NO. 1	53744
SHEET	NO.	OF	SHEETS	STA.	TO STA.		ILLINOIS FED.	AID PROJECT		

VARIES 0'-12' RIGHT TURN THROUGH LANE LANE AUX LANE VARIES THROUGH LANE THROUGH LANE THROUGH LANE VARIES 3 4 **EXISTING TYPICAL SECTION** HMA SIDEWALK-KIRK ROAD STA 100+00 TO STA 108+14.14 EX ¢ 50' **EXISTING TYPICAL SECTION** HMA SIDEWALK-KIRK ROAD STA 93+57 TO STA 100+00 EX ¢ 12.8' **EXISTING TYPICAL SECTION** DOUGLAS ROAD STA 46+64 TO STA 49+50 EX ¢ -EX DRIVEWAY 12.8' -EX DEPRESSED CURB A (B) **EXISTING TYPICAL SECTION** DOUGLAS ROAD AT DRIVEWAY STA 45+29.30 TO STA 46+64

REVISED

KANE COUNTY

DIVISION OF TRANSPORTATION

REVISED

REVISED

REVISED

DESIGNED -

CHECKED

DRAWN

DATE

T:\5167-KirkDouglesPhase2\Civil\Dgn\03Ty

Secs\ExistingTypical.dgn

PLOT SCALE = 20.0000 1/ in.

PLOT DATE = 5/28/2014

EXISTING LEGEND:

- A 12" HMA PAVEMENT
- B B-6.12 CONCRETE CURB & GUTTER
- C PCC PAVEMENT

REMOVALS

- 1 SIDEWALK REMOVAL
- 2 HOT-MIX ASPHALT SURFACE REMOVAL, VARIABLE DEPTH
- 3 PORTLAND CEMENT CONCRETE SURFACE REMOVAL (VARIABLE DEPTH)

F.A.P. RTE. 360

SECTION

08-00377-00-CH

COUNTY TOTAL SHEET NO. KANE 40 7

CONTRACT NO. 63744

4 PAVEMENT REMOVAL


EXISTING TYPICAL SECTIONS

KIRK ROAD AND DOUGLAS ROAD

SHEET NO. OF SHEETS STA.


SCALE: N/A


5 CURB AND GUTTER REMOVAL

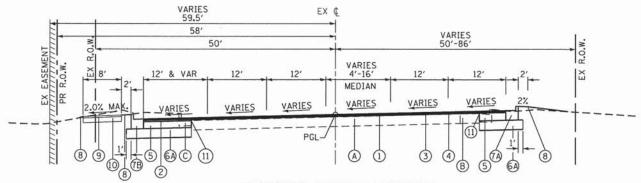

PROPOSED TYPICAL SECTION


KIRK ROAD STA 100+00 TO STA 108+14.14

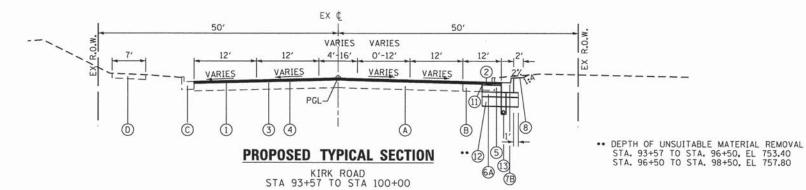

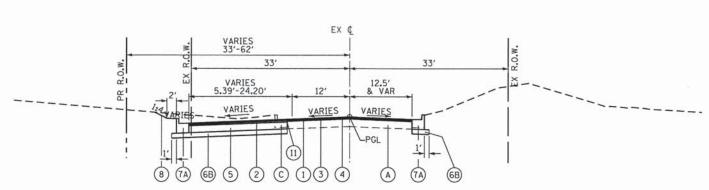

PROPOSED TYPICAL SECTION

DOUGLAS ROAD STA 46+64 TO STA 49+13.99

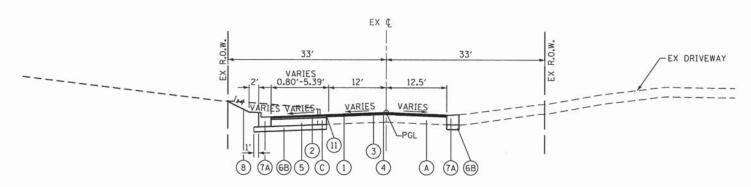

PROPOSED TYPICAL SECTION

DOUGLAS ROAD AT DRIVEWAY STA 45+29.30 TO STA 46+64

FILE NAME = USER NAME = _USER_	DESIGNED -	REVISED -	
Ts\5167-KirkDouglesPhese2\Civil\Dgn\03TypSecs\Proposed Typicals.d	gn DRAWN -	REVISED -	
PLOT SCALE = 20.0000 '	/ in. CHECKED -	REVISED -	
PLOT DATE = 5/28/2014	DATE -	REVISED -	

KANE COUNTY **DIVISION OF TRANSPORTATION**

LEGEND:

EXISTING CONDITION

- A HMA PAVEMENT
- B PCC PAVEMENT
- C CURB AND GUTTER
- D HMA SIDEWALK

PROPOSED CONDITION

- (1) POLYMERIZED HOT-MIX ASPHALT SURFACE COURSE, MIX "F", N90, 1 3/4 "
- 2 HOT-MIX ASPHALT BINDER COURSE, IL-19.0, N90, 2 1/4 "
- 3 LEVELING BINDER (MACHINE METHOD), N70, 3/4" MINIMUM (NOTE 1)
- 4 BITUMINOUS MATERIALS (PRIME COAT)
- 5 HOT-MIX ASPHALT BASE COURSE WIDENING, 9"
- 6A AGGREGATE SUBGRADE IMPROVEMENT, 12"
- 6B AGGREGATE SUBGRADE IMPROVEMENT, 6"
- (A) COMBINATION CONCRETE CURB AND GUTTER, TYPE B-6.12
- (7B) COMBINATION CONCRETE CURB AND GUTTER, TYPE B-6,24
- SEEDING CLASS 2A, EROSION CONTROL BLANKET, FERTILIZER NUITRIENTS, TOPSOIL EXCAVATION AND PLACEMENT
- 9 PCC SIDEWALK, 5 INCH
- 10 AGGREGATE FILL (INCLUDED IN PCC SIDEWALK, 5 INCH)
- (1) STRIP REFLECTIVE CRACK CONTROL TREATMENT
- (12) POROUS GRANULAR EMBANKMENT
- (13) PIPE UNDERDRAIN, 4" (NOTE 2)

NOTES:

1. WITHIN THE RESURFACING AREA. MILLING IS REQUIRED TO A DEPTH NEEDED TO ACCOMMODATE THE 1 3/4" SURFACE COURSE AND 3/4" LEVELING BINDER COURSE.

WHEN THE DIFFERENCE BETWEEN THE PROPOSED PGL AND THE EXISTING PROFILE IS GREATER THAN 2 $1/2^{\prime\prime}$. THE THICKNESS OF LEVELING BINDER SHALL BE THAT DIFFERENCE LESS THE 1 3/4" SURFACE COURSE.

- 2. INSTALL PIPE UNDERDRAIN 4" AT UNDERCUT LOCATIONS AS SHOWN ON THE DRAINAGE PLANS. PIPE UNDERDRAIN 4" SHALL BE OUTLETTED USING PIPE UNDERDRAIN 4" (SPECIAL) AT LOCATIONS SHOWN ON PLANS AND IN ACCORDANCE WITH IDOT HIGHWAY STD 601001.
- 3. ALL EXCAVATED MATERIAL ALONG KIRK ROAD THAT CANNOT BE USED AS EMBANKMENT SHALL BE CONSIDERED NON-SPECIAL WASTE DISPOSAL.

MIXTURE TYPE	AID WOIDS
MIXTURE TIPE	AIR VOIDS Ndes
PAVEMENT	e noes
POLYMERIZED HOT-MIX ASPHALT SURFACE COURSE, MIX "F", N90: 1 3/4"	4% @ 90 Gyr.
HOT-MIX ASPHALT BINDER COURSE, IL-19.0, N90; 2 1/4"	4% @ 90 Gyr.
LEVELING BINDER, N70; 3/4" MIN	4% @ 50 Gyr.
HOT-MIX ASPHALT BASE COURSE WIDENING (HMA BINDER IL-19 mm); 9" (3 LIFTS)	4% © 90 Gyr.
DRIVEWAY	
HOT-MIX ASPHALT SURFACE COURSE, MIX "D", N50 (IL 9.5 mm); 2"	4% @ 50 Gyr.
HOT-MIX ASPHALT BASE COURSE; MIX "D", N50; (IL-19 mm); 8" (3 LIFTS)	4% € 50 Gyr.

SCALE: N/A

THE UNIT WEIGHT USED TO CALCULATE ALL HOT-MIX ASPHALT SURFACE MIXTURE QUANTITIES IS 112 LBS/SQ YD/IN.

THE "AC TYPE" FOR POLYMERIZED HMA MIXES SHALL BE "SBS/SBR PG 76-22" AND THE "AC TYPE" FOR NON-POLYMERIZED HMA MIXES SHALL BE "PG 64-22" UNLESS MODIFIED BY DISTRICT ONE SPECIAL PROVISIONS. FOR "PERCENT RAP" SEE SPECIAL PROVISIONS.

	PRO	POSED	TYPICAL	SECTIONS	}	F.A.P. RTE.	SECTION	COUNTY	TOTAL	SHEET NO.
KIRK ROAD & DOUGLAS ROAD				1	360	08-00377-00-CH	KANE	40	8	
	KIIIK	IIOAD	a boo	GLAS HOAL	,			CONTRACT	NO.	63744
SHEET	NO.	OF	SHEETS	STA.	TO STA.		ILLINOIS FED.	AID PROJECT		-

REMOVAL SCHEDULE

LOCATION	TREE REMOVAL 6-15	TREE REMOVAL OVER 15	PAVEMENT REMOVAL	HMA SURFACE REMOVAL, VARIABLE DEPTH	PCC SURFACE REMOVAL (VARIABLE DEPTH)	COMBINATION CURB AND GUTTER REMOVAL	SIDEWALK REMOVAL	MEDIAN REMOVAL	PAVEMENT MARKING REMOVAL	SAWCUTS
STATION TO STATION	UNIT	UNIT	SQ YD	SQ YD	SQ YD	FOOT	SQ FT	SO FT	SQ FT	FOOT
KIRK ROAD										
93+57 TO 100+00			261	3972	426	832	158	796	1356	362
100+00 TO 108+14.14			35	5328	307	1419	3500		1323	296
DOUGLAS ROAD										
45+29.30 TO 50+00	228	47	6	1236		934				176
TOTALS	228	47	402	10536	733	3185	3658	796	2679	807

EROSION CONTROL AND SEEDING SCHEDULE

SEEDING CL 2A	NITROGEN FERTILIZER NUTRIENT	PHOSPHORUS FERTILIZER NUTRIENT	POTASSIUM FERTILIZER NUTRIENT	• MULCH, METHOD 2	EROSION CONTROL BLANKET	PERIMETER EROSION BARRIER	TEMPORARY EROSION SEEDING	INLET FILTERS
AC	POUND	POUND	POUND	AC	. SQ YD	FOOT	POUND	EACH
0.2	14	14	14	0.2	770	695	48	7
0,2	18	18	18	0.2	954	1299	60	9
0.1	14	14	14	0.1	724		45	3
0.5	46	46	46	0.5	2448	1994	153	19
	AC 0.2 0.2 0.1	CL 2A FERTILIZER NUTRIENT AC POUND 0.2 14 0.2 18 0.1 14	CL 2A FERTILIZER NUTRIENT FERTILIZER NUTRIENT AC POUND POUND 0.2 14 14 14 0.2 18 18 0.1 14 14	CL 2A FERTILIZER NUTRIENT FERTILIZER NUTRIENT FERTILIZER NUTRIENT AC POUND POUND POUND 0.2 14 14 14 0.2 18 18 18 0.1 14 14 14	CL 2A FERTILIZER NUTRIENT FERTILIZER NUTRIENT FERTILIZER NUTRIENT METHOD 2 AC POUND POUND POUND AC 0.2 14 14 14 0.2 0.2 18 18 18 0.2 0.1 14 14 14 0.1	CL 2A FERTILIZER NUTRIENT FERTILIZER NUTRIENT FERTILIZER NUTRIENT METHOD 2 CONTROL BLANKET AC POUND POUND POUND AC SO YD 0.2 14 14 14 0.2 770 0.2 18 18 18 0.2 954 0.1 14 14 14 0.1 724	CL 2A FERTILIZER NUTRIENT FERTILIZER NUTRIENT FERTILIZER NUTRIENT METHOD 2 CONTROL BLANKET EROSION BARRIER AC POUND POUND POUND AC SO YD FOOT 0.2 14 14 14 0.2 770 695 0.2 18 18 18 0.2 954 1299 0.1 14 14 14 0.1 724	CL 2A FERTILIZER NUTRIENT FERTILIZER NUTRIENT METHOD 2 DIAMET CONTROL BLANKET EROSION SEEDING AC POUND POUND AC SO YD FOOT POUND 0.2 14 14 14 0.2 770 695 48 0.2 18 18 18 0.2 954 1299 60 0.1 14 14 14 0.1 724 45

• FOR TEMPORARY STABILIZATION AS DIRECTED BY THE ENGINEER

PAVEMENT ITEM SCHEDULE

	HMA BASE COURSE WIDENING, 9"	HMA BC. IL-19.0. N90	POLYMERIZED HMA SC. MIX "F". N90	AGGREGATE SUBGRADE IMPROVEMENT 6"	AGGREGATE SUBGRADE IMPROVEMENT 12"	LEVELING BINDER (MACHINE METHOD), N70	BITUMINOUS MATERIALS (PRIME COAT)	STRIP REFLECTIVE CRACK CONTROL TREATMENT
LOCATION	SQ YD	TON	TON	SQ YD	SQ YD	TON	POUND	FOOT
STATION TO STATION								
KIRK ROAD				ven-e				
93+57 TO 100+00	216	27.3	448.5		519	184	2642	449
100+00 TO 108+14.14	891	112.2	647.9		1312	240	5380	1261
DOUGLAS ROAD			-				1	
45+29.30 TO 50+00	600	75.6	182.8	857		53	2459	523
TOTALS	1707	215.1	1279.2	857	1832	477	10481	2233

PAVEMENT MARKING SCHEDULE

	MODI	FIED URETHAN	E PAVEMENT M	ARKING		
	4"	6"	12"	24"	LTR & SYM	RAISED REFLECTIVE PAVEMENT
LOCATION						MARKERS
STATION TO STATION	FOOT	FOOT	FOOT	FOOT	SQ FT	EACH
KIRK ROAD						
93+57 TO 100+00	3700	359	132	37	73	89
100+00 TO 108+14.14			272		109	114
	3968	871				
DOUGLAS ROAD				=======================================		
45+29.30 TO 50+00	1446	351	41	34	36	26
TOTALS						
	9114	1589	445	71	328	229

DRIVEWAY ITEM SCHEDULE

MIX "D", N50	CSE, 8"	PAVEMEN' REMOVAL
TON	SQ YD	SQ YD
-		
15	133	118
15	133	118
	TON 15	N50 TON SO YD 15 133

ROADSIDE ITEM SCHEDULE

SIDEWALK 5 INCH	CONCRETE CURB, TYPE B	COMB CC&G, B-6.12	COMB CC&G, B-6.24
SQ FT	FOOT	FOOT	FOOT
193		125	673
343	57	876	428
		894	
3536	57	1895	1101
	5 INCH SO FT 193 343	SIDEWALK CURB, TYPE B SO FT FOOT 193 343 57	SIDEWALK CURB, TYPE B B-6.12 SO FT FOOT FOOT 193 125 343 57 876

FILE NAME =	USER NAME = _USER_	DESIGNED -	REVISED -	
Ti\5167-KirkDouglesPhase2\Civil\Dgn\020uentities\5167.SCHED OF QUANTITIES 1.dgn PLOT SCALE = 100.0000 ' / in.		DRAWN -	REVISED -	
		CHECKED -	REVISED -	
	PLOT DATE = 5/30/2014	DATE -	REVISED -	

1	KANE	COUNTY
DIVISION	OF	TRANSPORTATION

	OOUEDIUE.		TIES SUE		F.A.P. RTE.	SECTION	COUNTY	TOTAL	SHEET NO.
1	SCHEDULE (JF QUANT	IIIE2 2HFF	:1 1	360	08-00377-00-CH	KANE	40	9
							CONTRAC	T NO. 6	3744
SCALE:	SHEET NO. OF	SHEETS	STA.	TO STA.		ILLINOIS FED.	AID PROJECT		

MAINTENANCE OF TRAFFIC SCHEDULE

LOCATION	SHORT TERM PAVEMENT MARKING	TEMP PAVEMENT MARKING LETTER AND SYMBOLS	TEMP PAVEMENT MARKING- LINE 4"	TEMP PAVEMENT MARKING- LINE 6"	TEMP PAVEMENT MARKING- LINE 24"
STATION TO STATION	FOOT	SO FT	FOOT	FOOT	FOOT
STAGE 1	365	36	6141	190	18
STAGE 2	564	37	7347	167	
STAGE 3	564				
PRE-PERMANENT	924				
TOTALS	2417	73	13487	356	18

EARTHWORK SCHEDULE

	EARTH EXCAVATION	UNSUITABLE MATERIAL	EXCAVATION TO BE USED FOR EMBANKMENT ADJUSTED FOR SHRINKAGE •	EMBANKMENT	EARTH BALANCE WASTE (+) SHORTAGE (-)	NON-SPECIAL WASTE DISPOSAL= ALL WASTE + UNSUITABLE MATERIAL (KIRK ROAD ONLY)	POROUS GRANULAR EMBANKMENT	TOPSOIL EXCAVATION AND PLACEMENT
LOCATION								
STATION	CU YD	CU YD	CU YD	CU YD	CU YD	CU YD	CU YD	CU YD
Douglas Road								
45+29.30						VI. 11. 11. 11. 11. 11. 11. 11. 11. 11. 1		
46+00.00	11.3	0.0	9.6	4.3	5.3	0.0	0.0	4.0
47+00.00	31.2	0.0	26.5	10.8	15.7	0.0	0.0	11.1
48+00.00	67.7	0.0	57.5	11.8	45.8	0.0	0.0	16.8
49+00.00	128.7	0.0	109.4	9.4	100.0	0.0	0.0	25.2
49+60.00	99.9	0.0	84.9	5.6	79.4	0.0	0.0	19.0
Kirk Road								
93+50.00								
93+57.00	0.4	0.0	0.3	0.2	0.1	0.2	0.0	0.2
94+00.00	9.0	3.7	4.5	2.2	2.4	6.1	0.0	2.0
95+00.00	50.7	43.9	5.8	4.5	1.3	45.2	10.2	8.3
96+00.00	111.5	111.5	0.0	4.3	-4.3	107.2	51.5	13.8
97+00.00	84.0	77.0	5.9	2.1	3.8	80.8	41.3	9.2
98+00.00	17.7	10.4	6.2	1.9	4.3	14.6	0.0	3.2
99+00.00	17.0	9.3	6.6	3.9	2.7	12.0	0.0	3.7
100+00.00	18.4	0.0	15.7	25.9	-10.3	-10.3	0.0	1.7
101+00.00	39.6	0.0	33.7	27.9	5.8	5.8	0.0	3.5
102+00.00	112.5	0.0	95.6	9.1	86.6	86.6	0.0	16.0
103+00.00	184.2	0.0	156.5	26.6	130.0	130.0	0.0	37.0
104+00.00	151.8	0.0	129.0	46.3	82.7	82.7	0.0	43.0
105+00.00	102.5	0.0	87.1	50.1	37.0	37.0	0.0	36.7
106+00.00	70.8	0.0	60.2	48.5	11.7	11.7	0.0	30.9
107+00.00	36.2	0.0	30.8	39.9	-9.1	-9.1	0.0	23.5
108+00.00	27.5	0.0	23.4	23.2	0.1	0.1	0.0	16.9
108+14.14	2.9	0.0	2.5	2.4	0.1	0.1	0.0	1.7
108+20.00	0.6	0.0	0.5	0.6	-0.1	-0.1	0.0	0.3
TOTAL	1376.1	255.8	952.3	361.4	590.9	600.6	103	327.8
ADJUSTED	1380					600		330

- . ADJUSTED WITH SHRINKAGE FACTOR OF 15%
- .. ADJUSTED FOR ROUNDING

ALL EXCAVATED MATERIAL ALONG KIRK ROAD THAT CANNOT BE USED AS EMBANKMENT SHALL BE CONSIDERED "NON-SPECIAL WASTE DISPOSAL".


UNSUITABLE MATERIAL INCLUDES EXCAVATION OF MATERIALS TO THE DEPTH AND WIDTH AS NOTED IN THE TYPICAL SECTIONS AND AS DETERMINED IN THE FIELD AT THE TIME OF CONSTRUCTION DUE TO POOR SUBGRADE CONDITIONS. THE UNSUITABLE MATERIAL AREAS IDENTIFIED ON THE TYPICAL SECTIONS ARE WITHIN THE AREA OF "NON-SPECIAL WASTE DISPOSAL" AND SHALL BE HANDLED AND DISPOSED OF AS DESCRIBED IN THE CONTRACT SPECIAL PROVISION FOR REMOVAL AND DISPOSAL OF REGULATED SUBSTANCES.


A NOMINAL QUANTITY OF 25 CU YD FOR REMOVAL AND DISPOSAL OF UNSUITABLE MATERIAL IS INCLUDED FOR USE AS DIRECTED BY THE ENGINEER FOR USE IN AREAS NOT CONSIDERED AS "NON-SPECIAL WASTE DISPOSAL".


POROUS GRANULAR EMBANKMENT SUBGRADE (PGES) HAS BEEN PROVIDED FOR USE AT LOCATIONS OF SUBGRADE TREATMENT RECOMMENDATIONS AS SHOWN ON THE TYPICAL SECTIONS AND WILL BE PAID FOR AS 'POROUS GRANULAR EMBANKMENT'. THE ACTUAL NEED FOR REMOVAL AND REPLACEMENT WITH PGES SHALL BE DETERMINED IN THE FIELD AT THE TIME OF CONSTRUCTION. ALL POTENTIALLY UNSTABLE SOIL SHALL BE TESTED AND TREATED IN ACCORDANCE WITH ARTICLE 301.04 OF THE STANDARD SPECIFICATIONS AND THE GUIDELINES IN THE IDOT SUBGRADE STABILITY MANUAL (SSM).


EXISTING TOPSOIL DEPTH IS ESTIMATED TO BE 4". PROPOSED TOPSOIL SHALL BE MINIMUM THICKNESS OF 4" UNLESS OTHERWISE DIRECTED BY THE ENGINEER.


FILE NAME =	USER NAME = _USER_	DESIGNED -	REVISED -								F.A.P.	SECTION	COUNTY	TOTAL	SHEE
T:\5167-KirkDouglasPhase2\Civil\Dgn\020u	ntities\5167_SCHED OF QUANTITIES 2.dgn	DRAWN -	REVISED -	KANE COUNTY		SCHE	DULE OF	OUANT	ITIES SHEET	T 2	RIE.			SHEETS	NO.
	PLOT SCALE = 100.0000 ' / in.	CHECKED -	REVISED -	DIVISION OF TRANSPORTATION			7777 7				360	08-00377-00-CH	KANE	40 CT NO C	10
PLOT DATE = 5/30/2014	PLOT DATE = 5/30/2014	DATE -	REVISED -		SCALE:	SHEET NO.	OF	SHEETS	STA.	TO STA.		THE INOIS FED.	AID PROJECT	CT NO. 6) [44

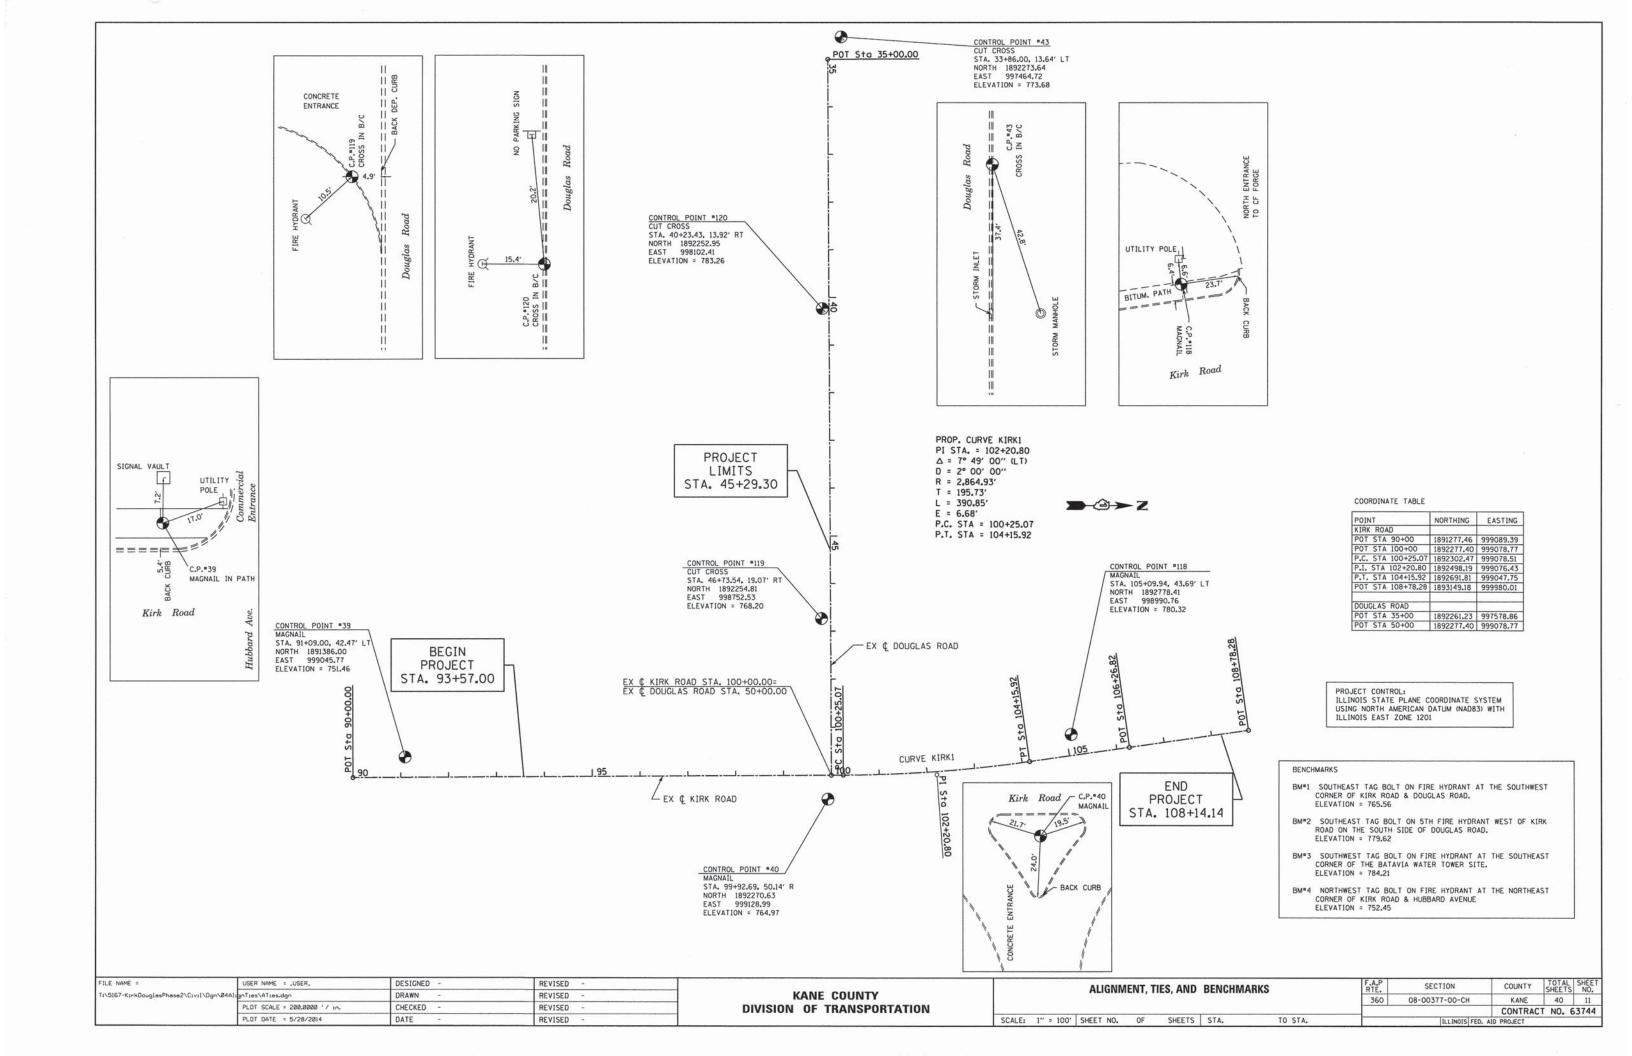

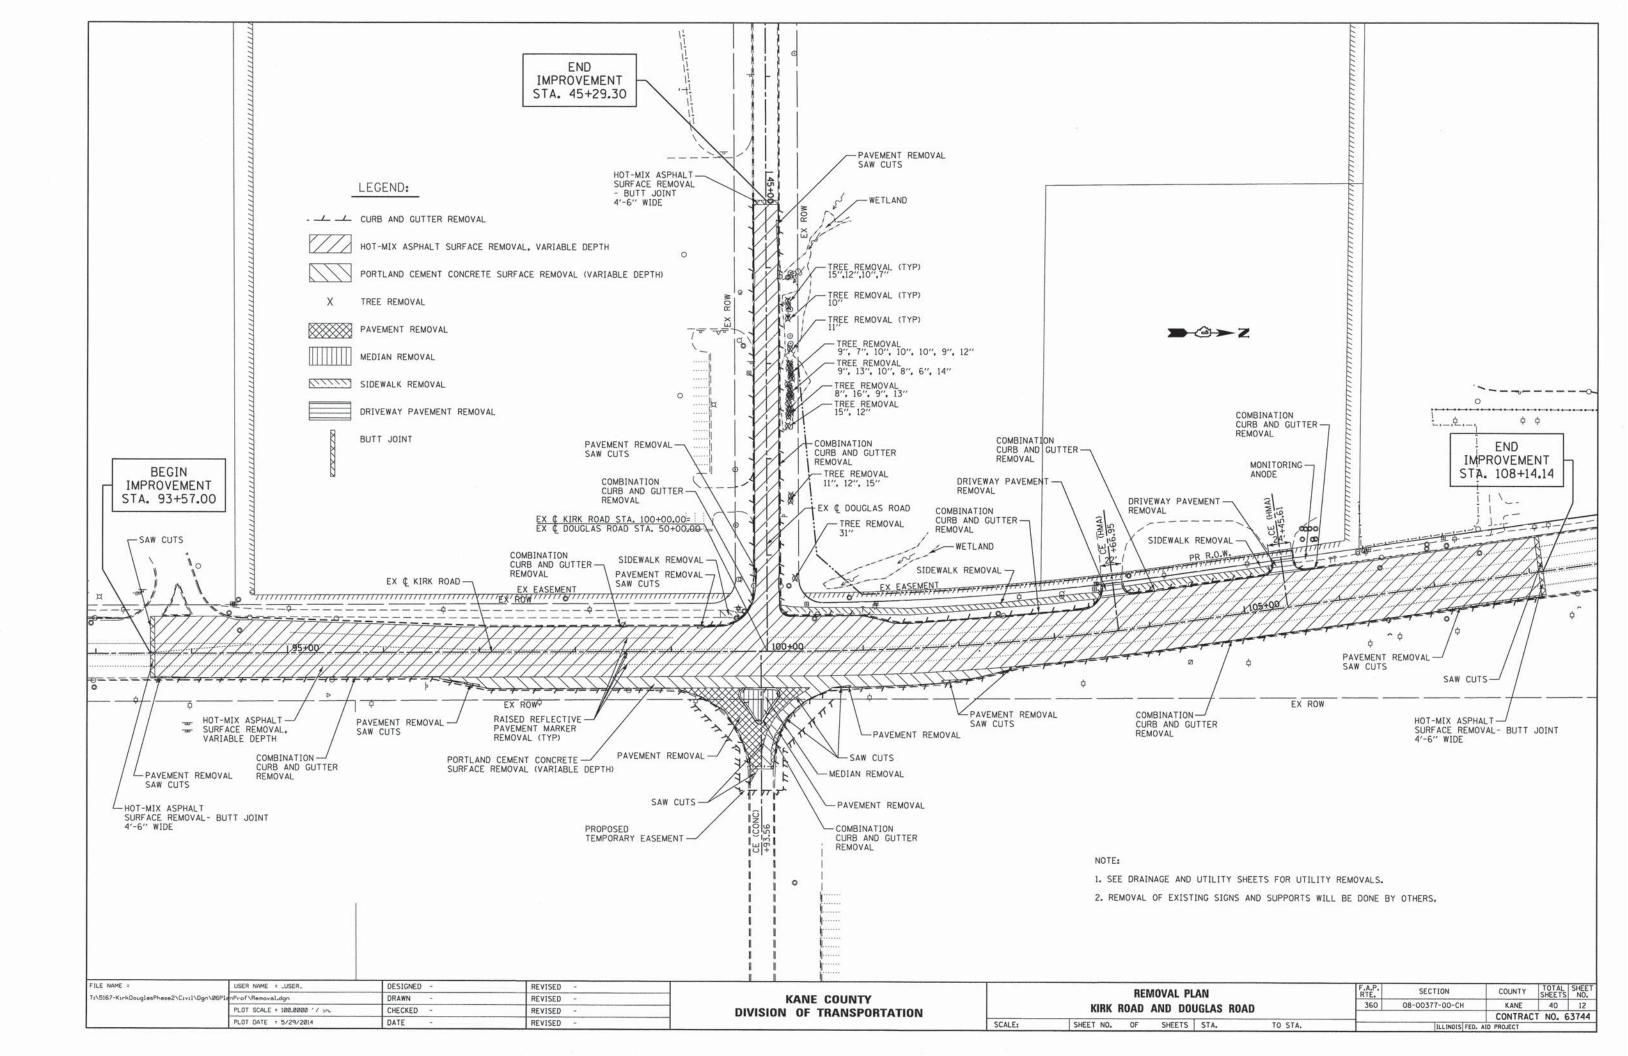

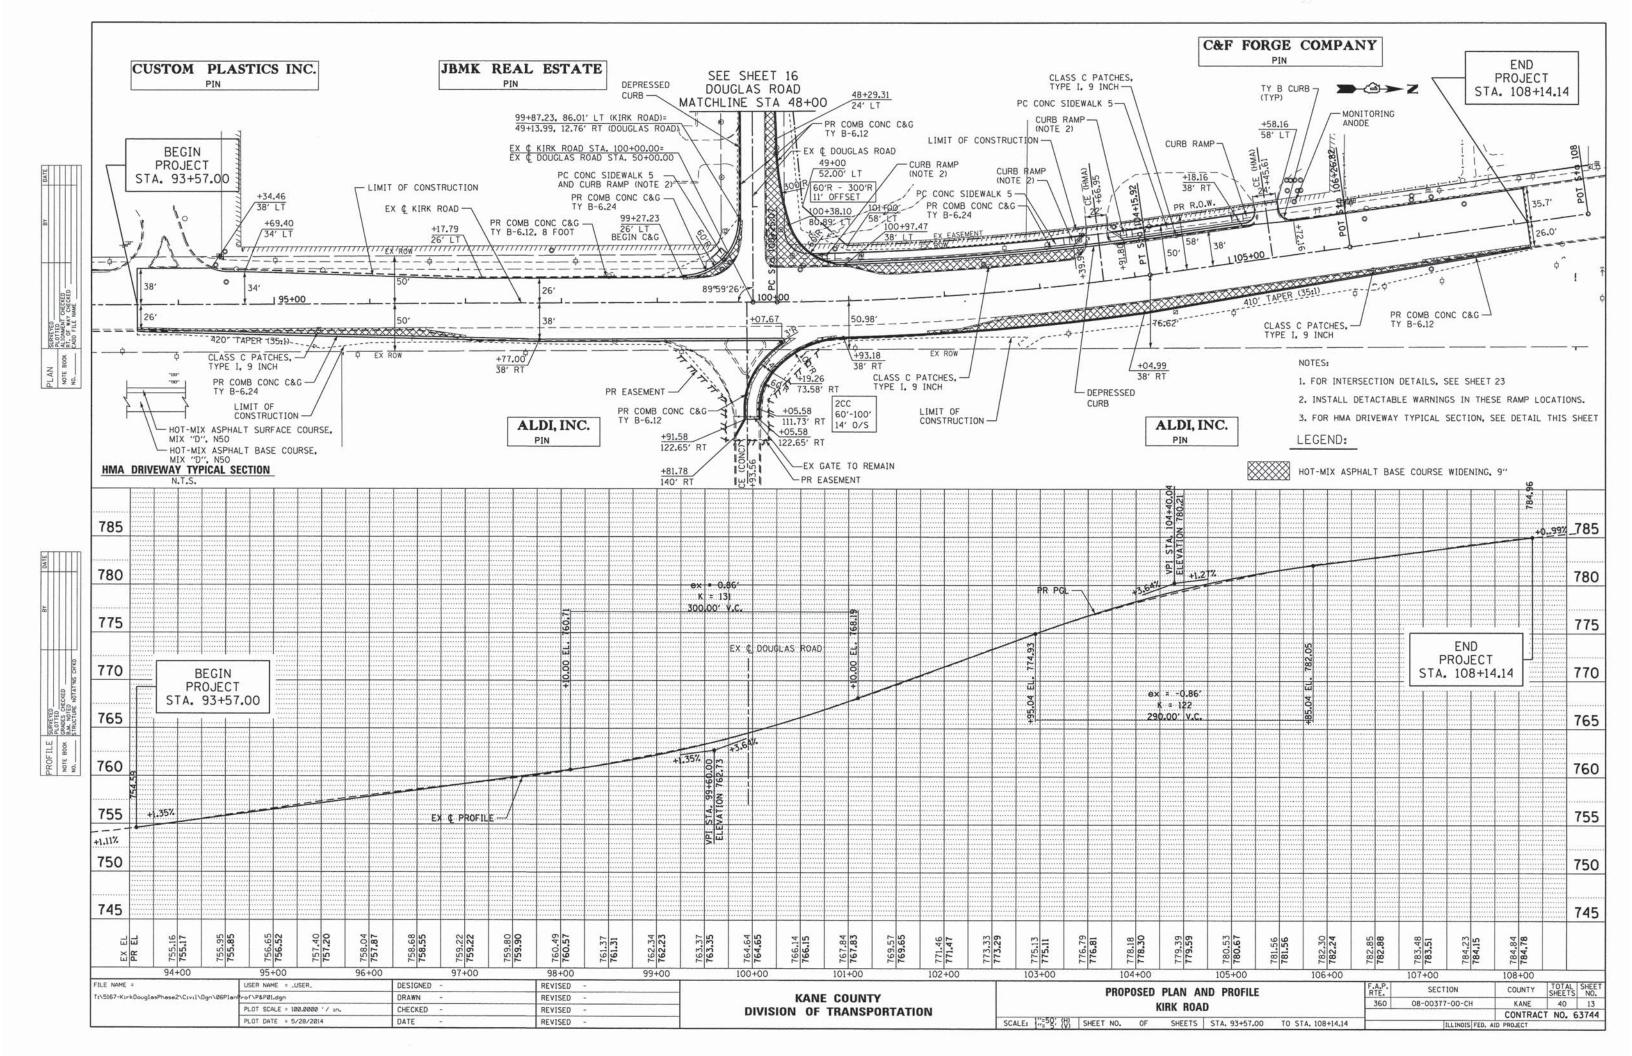

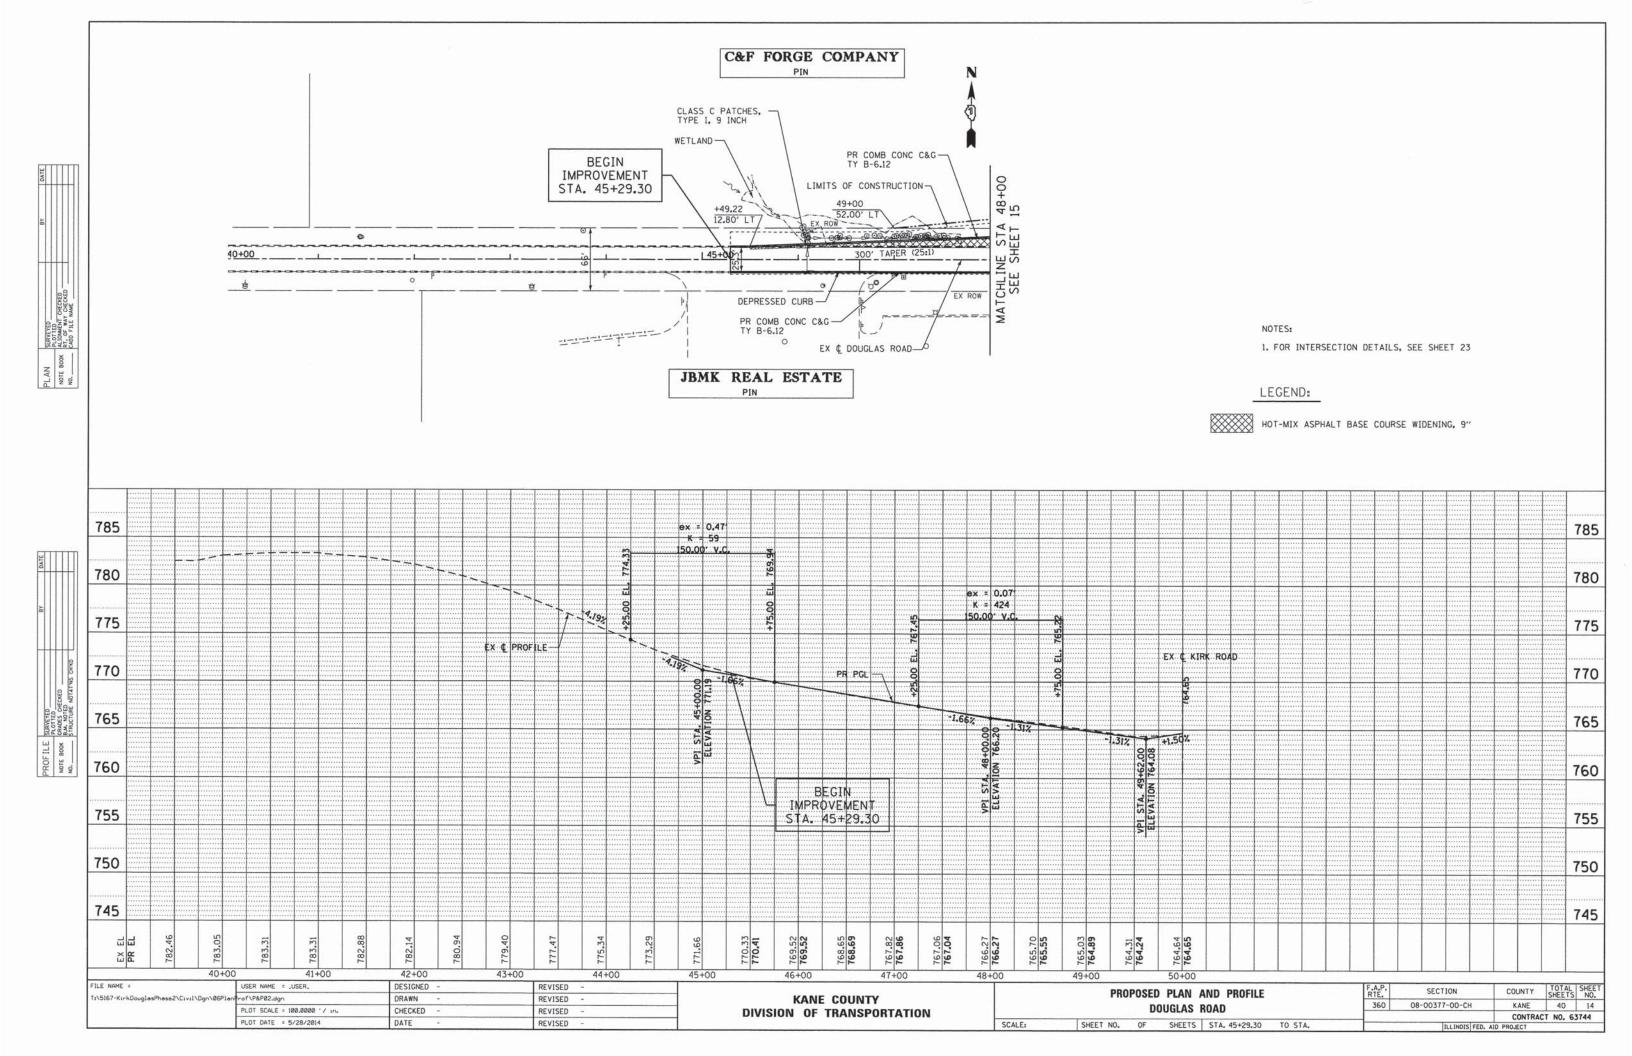


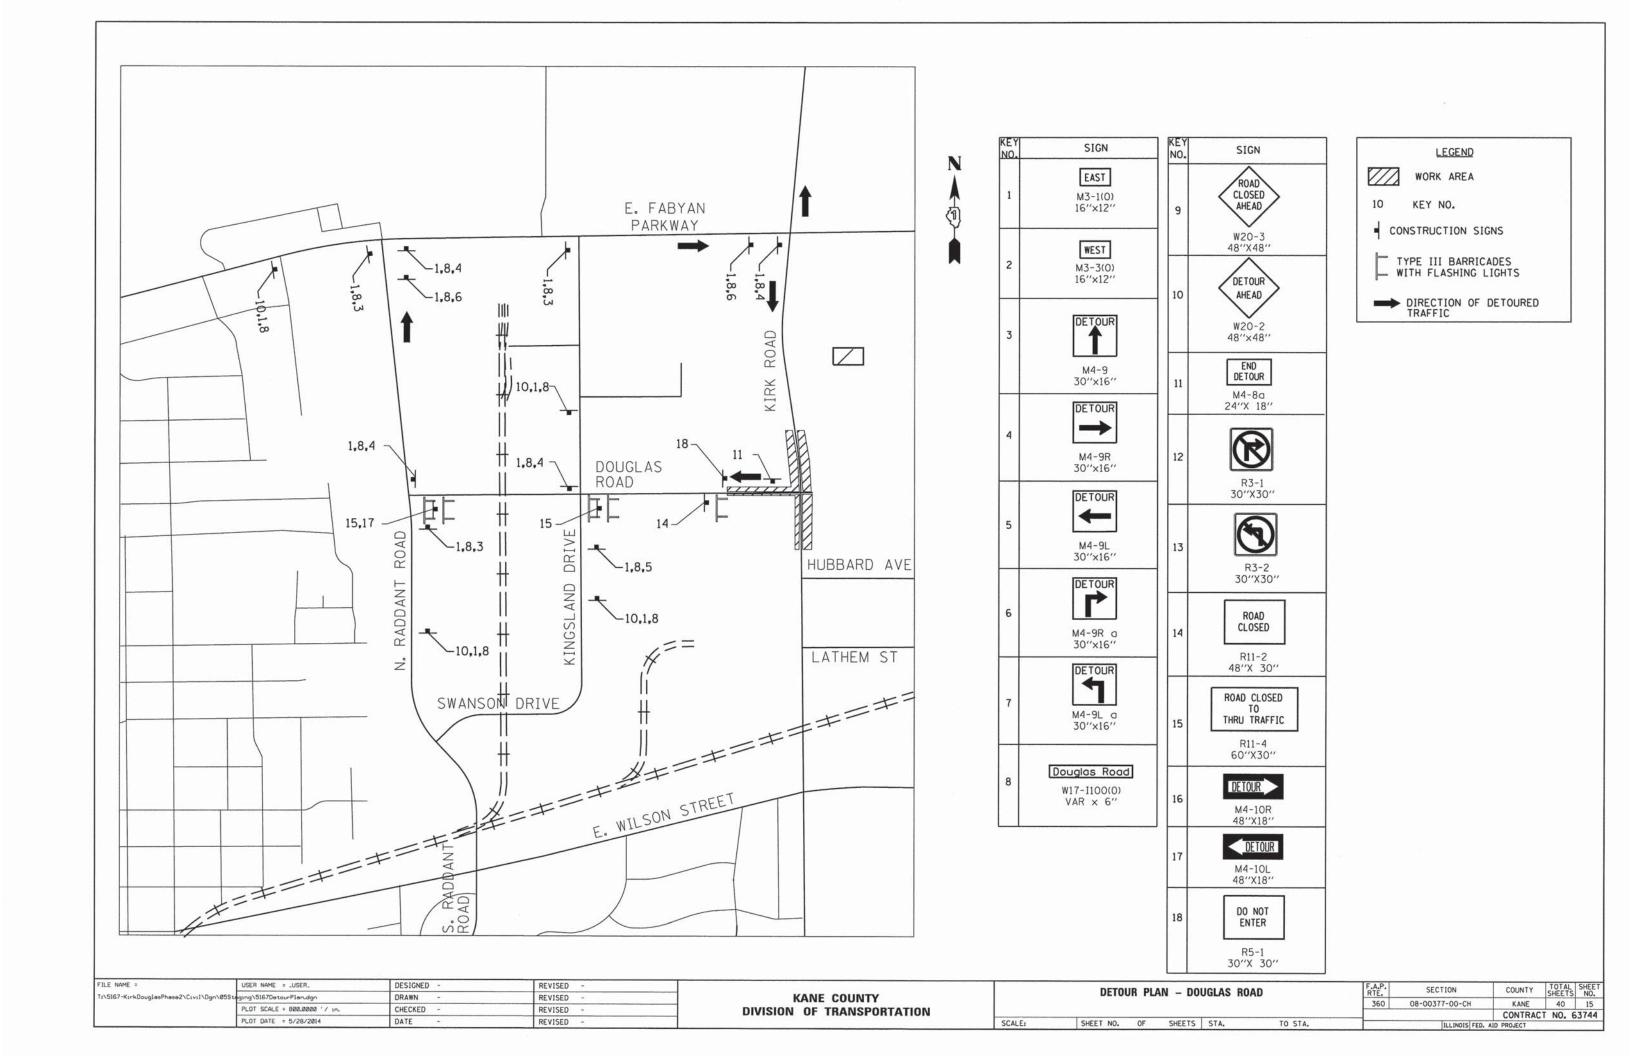

MAINTENANCE OF TRAFFIC GENERAL NOTES:

- 1. THE CONTRACTOR MUST MAINTAIN ACCESS TO ALL PRIVATE AND FIELD ENTRANCES DURING CONSTRUCTION.
- 2. IDOT STANDARDS LISTED ON SHEET 2 WILL BE USED FOR THE MAINTENANCE OF TRAFFIC.
- 3. ALL SIGNING MUST BE IN ACCORDANCE WITH THE APPLICABLE PROVISIONS OF THE IDOT'S "STANDARD SPECIFICATIONS FOR ROAD AND BRIDGE CONSTRUCTION" ADOPTED JANUARY 1, 2012. THE DETAILS IN THESE PLANS, AND THE LATEST EDITION OF THE IDOT'S "MANUAL ON UNIFORM TRAFFIC CONTROL DEVICES".
- 4. THE CONTRACTOR MUST BE RESPONSIBLE FOR ENSURING THAT ALL BARRICADES, SIGNS, LIGHTS AND OTHER TRAFFIC CONTROL DEVICES INSTALLED BY THE CONTRACTOR ARE IN PLACE AND OPERATING 24 HOURS EACH DAY DURING CONSTRUCTION.
- 5. AS A MINIMUM, ALL AMBER FLASHING LIGHTS THAT ARE REQUIRED MUST MEET THE REQUIREMENTS FOR TYPE A-LOW INTENSITY FLASHING LIGHTS IN ARTICLE 1084.01 OF THE STANDARD SPECIFICATIONS. ALL LIGHTS MUST OPERATE DURING HOURS OF DARKNESS. ONLY LIGHTS THAT HAVE BEEN APPROVED BY THE ILLINOIS DEPARTMENT OF TRANSPORTATION WILL BE USED.
- 6. PORTABLE/CHANGEABLE ELECTRONIC MESSAGE BOARDS SHALL BE USED IN ADVANCE OF THE PROJECT ACCORDING TO IDOT STANDARDS AND SHALL BE IN PLACE A MINIMUM OF 72 HOURS PRIOR TO COMMENCING THE WORK AND REMAIN THROUGHOUT THE ROADWAY CONSTRUCTION WORK.
- 7. THE KANE COUNTY DIVISION OF TRANSPORTATION MUST BE NOTIFIED A MINIMUM OF SEVEN (7) WORKING DAYS IN ADVANCE OF ANY CONSTRUCTION WITHIN THE COUNTY RIGHT-OF-WAY. CONTACT TOM SZABO AT (630) 208-3139.
- 8. EXCAVATION AND PAVEMENT WIDENING ON BOTH SIDES OF THE PAVEMENT AT ANY ONE LOCATION AT THE SAME TIME WILL NOT BE PERMITTED PER ARTICLE 701.18 OF THE IDOT SPECIFICATIONS.

FILE NAME =	USER NAME = _USER_	DESIGNED -	REVISED -			8.0	AINITENIA	NOT OF T	DAFFIO		F.A.P.	SECTION	COUNTY	TOT/	AL SHE	Ē
T:\5167-KirkDouglasPhase2\Civil\Dgn\05Sta	ging\5167StagingGeneralNotesi.dgn	DRAWN -	REVISED -	KANE COUNTY		IVI		NCE OF 1			RTE.	00 00777 00 00	KANE	SHEE	TS NO	<u>).</u>
j	PLOT SCALE = 20.0000 ' / in.	CHECKED -	REVISED -	DIVISION OF TRANSPORTATION			GENE	RAL NOTI	S		360	08-00377-00-CH	NAINE	40 40	637	1
	PLOT DATE = 5/28/2014	DATE -	REVISED -		SCALE: N/A	SHEET NO.	OF	SHEETS S	STA.	TO STA.		TILL INDIS FED.	AID PROJECT	ICT NO.	. 6314	4

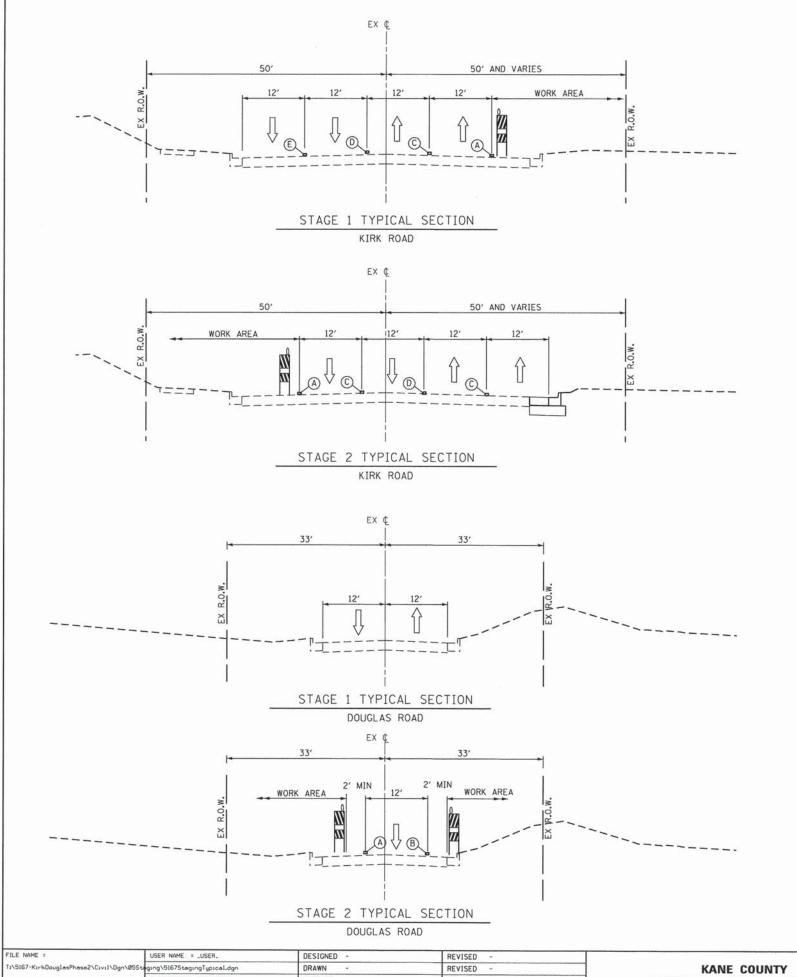

LEGEND:

DIRECTION OF TRAFFIC

TYPE II BARRICADES

(A) TEMPORARY PAVEMENT MARKING, EDGE LINE, WHITE

TEMPORARY PAVEMENT MARKING, EDGE LINE, YELLOW

TEMPORARY PAVEMENT MARKING, LANE LINE, WHITE

TEMPORARY PAVEMENT MARKING, CENTER LINE, YELLOW

EXISTING PAVEMENT MARKING

SUGGESTED STAGING:

KIRK ROAD

STAGE 1 CONSTRUCT ROADWAY WIDENING ON THE EAST SIDE OF KIRK ROAD.

TRAFFIC:

THE FOUR LANES OF TRAFFIC WILL BE SHIFTED TO THE WEST SIDE OF KIRK ROAD AS SHOWN ON THE PLANS.

CONSTRUCTION: CONSTRUCT ROADWAY WIDENING ON THE WEST SIDE OF KIRK ROAD.

TRAFFIC:

THE FOUR LANES OF TRAFFIC WILL BE SHIFTED TO THE EAST SIDE OF KIRK ROAD INCLUDING THE WIDENED PORTION OF KIRK ROAD AS SHOWN ON THE PLANS.

STAGE 3

CONSTRUCTION: CONSTRUCT ROADWAY RESURFACING ON KIRK ROAD.

TRAFFIC:

FOUR LANES OF TRAFFIC WILL BE OPEN ON KIRK ROAD. NECESSARY LANE CLOSURE WILL BE DONE IN ACCORDANCE WITH IDOT HIGHWAY STANDARD DRAWINGS.

SUGGESTED STAGING: DOUGLAS ROAD

STAGE 1

CONSTRUCTION: NO ROADWAY CONSTRUCTION DURING THIS STAGE.

TRAFFIC:

THE TWO LANES OF TRAFFIC WILL BE OPEN TO TRAFFIC.

STAGE 2 CONSTRUCTION:

CONSTRUCT ROADWAY WIDENING ON THE BOTH SIDES OF DOUGLAS ROAD, ONE SIDE AT A TIME. NO WORK WILL BE PERMITTED SIMULTANEOUSLY ON BOTH SIDES AT ANY TIME DURING CONSTRUCTION.

TRAFFIC:

ONLY THE WESTBOUND TRAFFIC WILL BE OPEN ON DOUGLAS ROAD. EASTBOUND TRAFFIC WILL BE DETOURED USING N. RADDANT ROAD, FABYAN PARKWAY AND KIRK ROAD.


STAGE 3 CONSTRUCTION:


CONSTRUCT ROADWAY RESURFACING ON DOUGLAS ROAD.


TRAFFIC:


ONLY THE WESTBOUND TRAFFIC WILL BE OPEN ON DOUGLAS ROAD. EASTBOUND TRAFFIC WILL BE DETOURED USING N. RADDANT ROAD, FABYAN PARKWAY AND KIRK ROAD.


FILE NAME =	USER NAME = "USER"	DESIGNED -	REVISED -			MAI	INTENDED OF TRAFFIC		F.A.P.	SECTION	COUNTY	TOTAL SHE
T:\5167-K:rkDouglasPhase2\C:v:1\Dgn\05St	eging\5167StagingTypical.dgn	DRAWN -	REVISED -	KANE COUNTY	MAINTENACE OF TRAFFIC TYPICAL SECTIONS		RIE.		KANE	SHEETS NO.		
	PLOT SCALE = 20.0000 ' / in.	CHECKED -	REVISED -	DIVISION OF TRANSPORTATION			TYPICAL SECTIONS		TYPICAL SECTIONS 360		08-00377-00-CH	MAINE
PLOT	LOT DATE = 5/28/2014 DATE - REVISED -		SCALE: N/A SHEET NO. OF SHEETS STA. TO STA.					ILL INOIS FED.	AID PROJECT	CT NO. 6374		

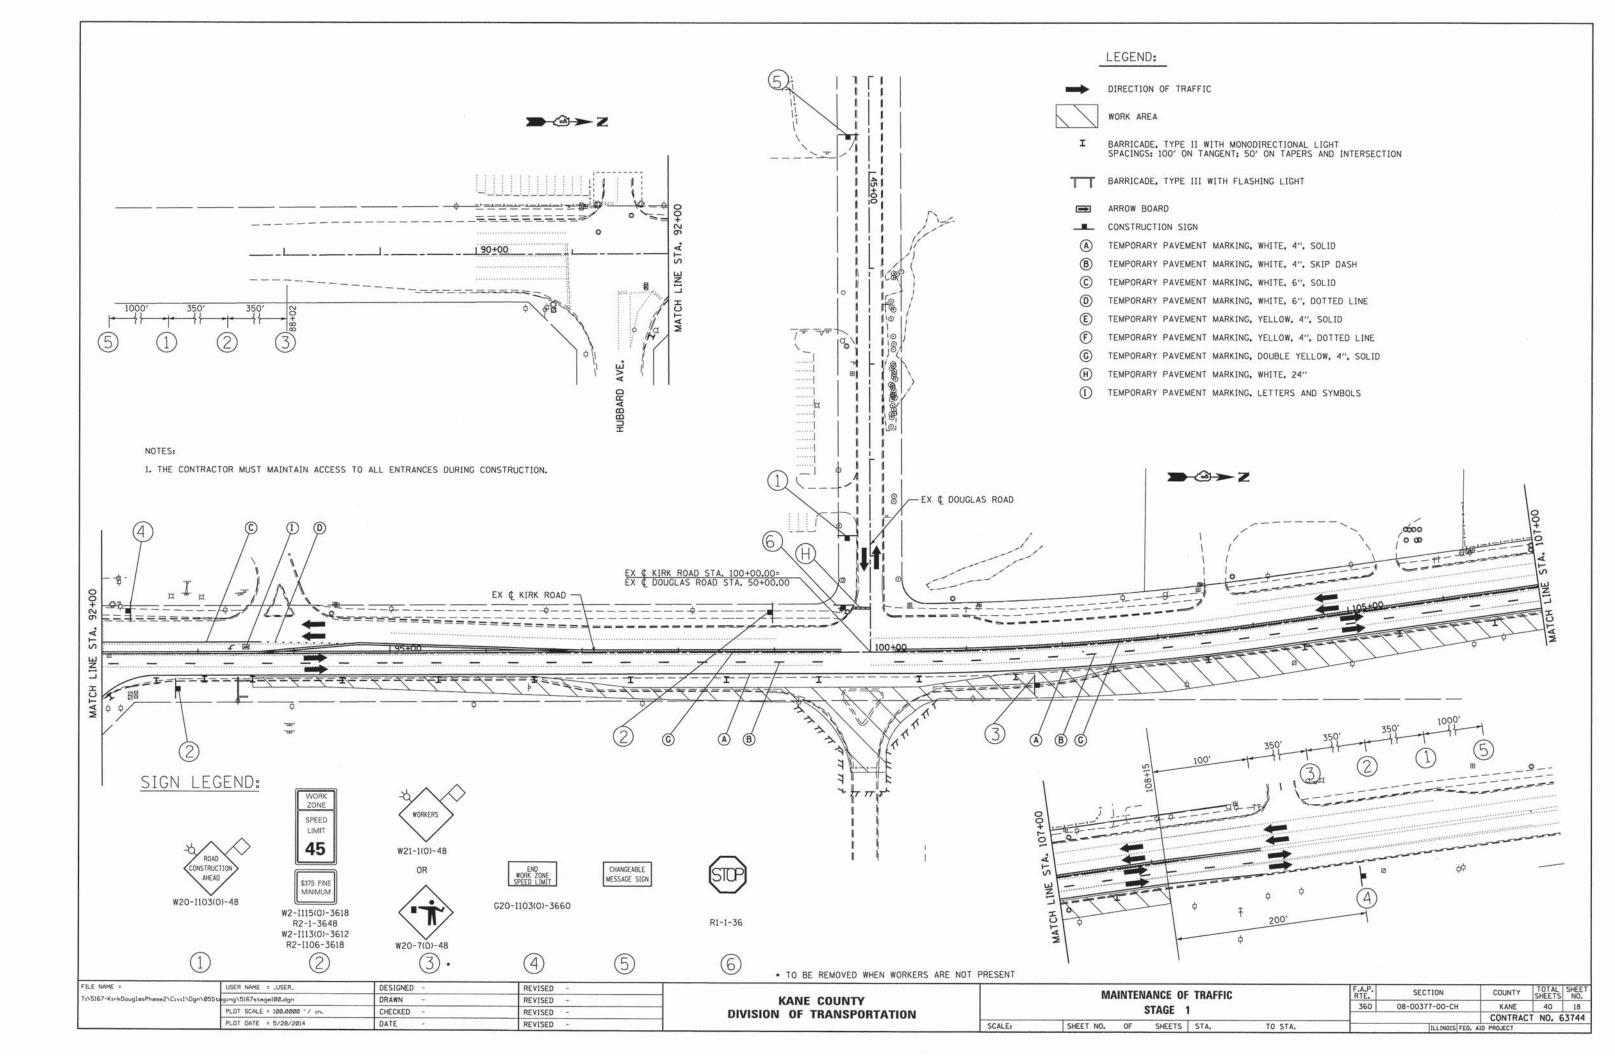

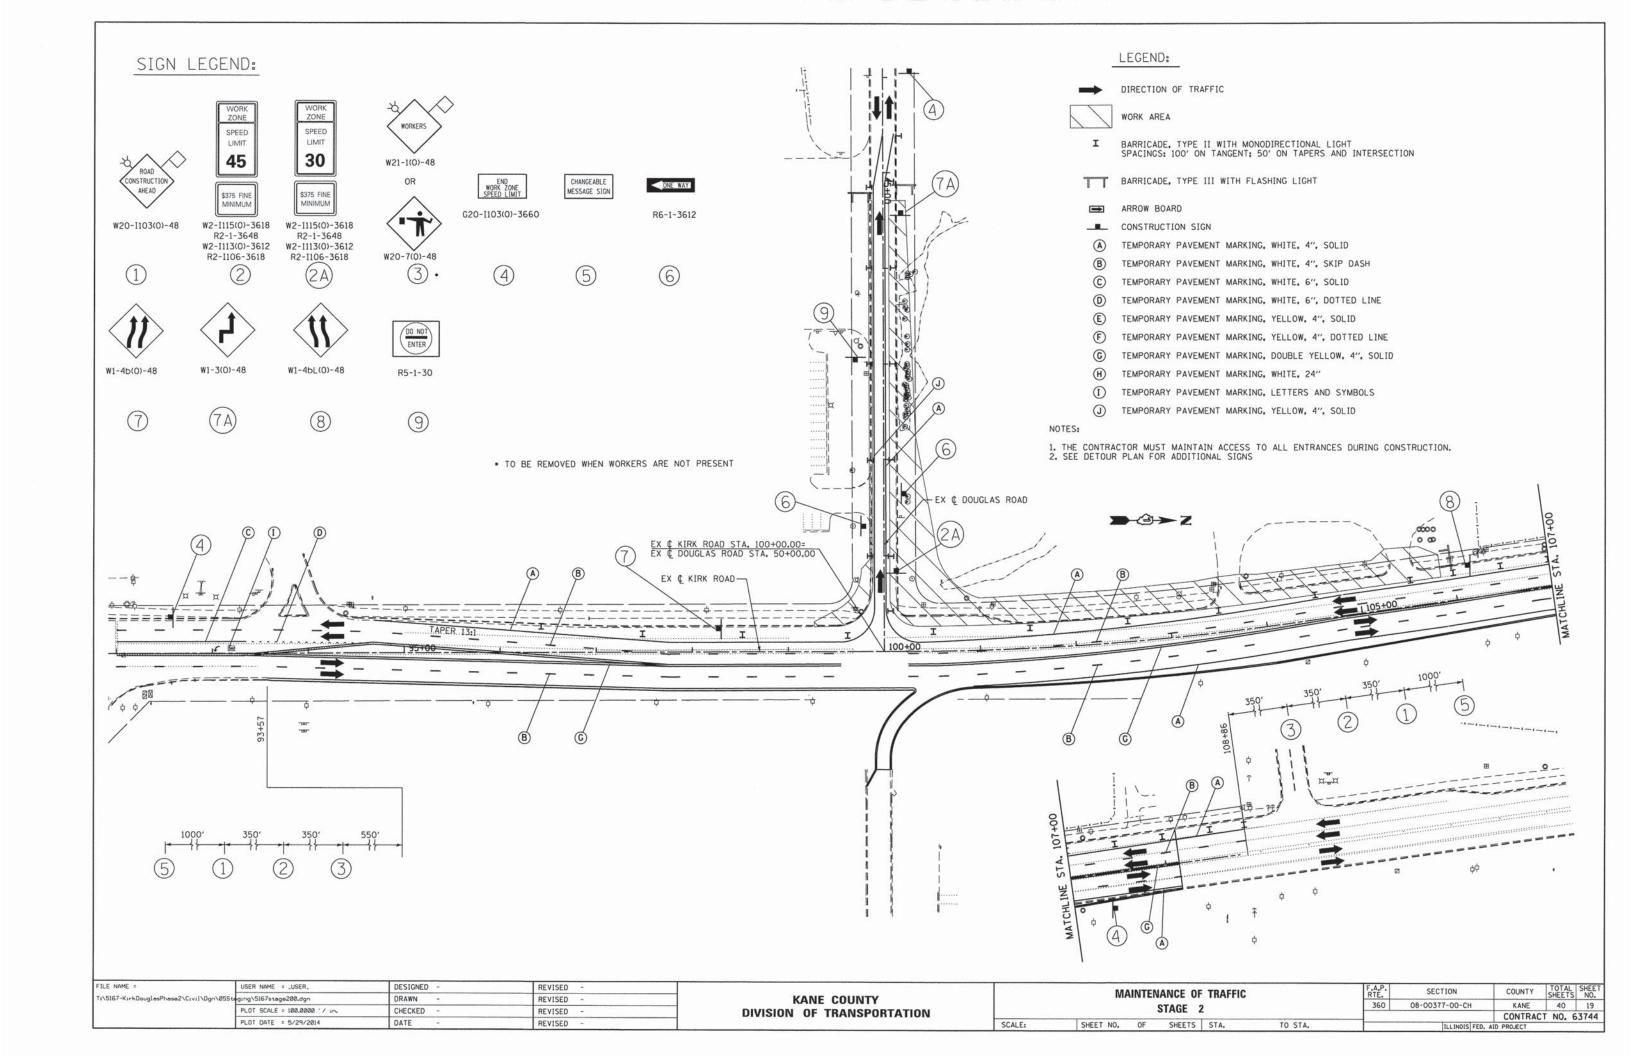


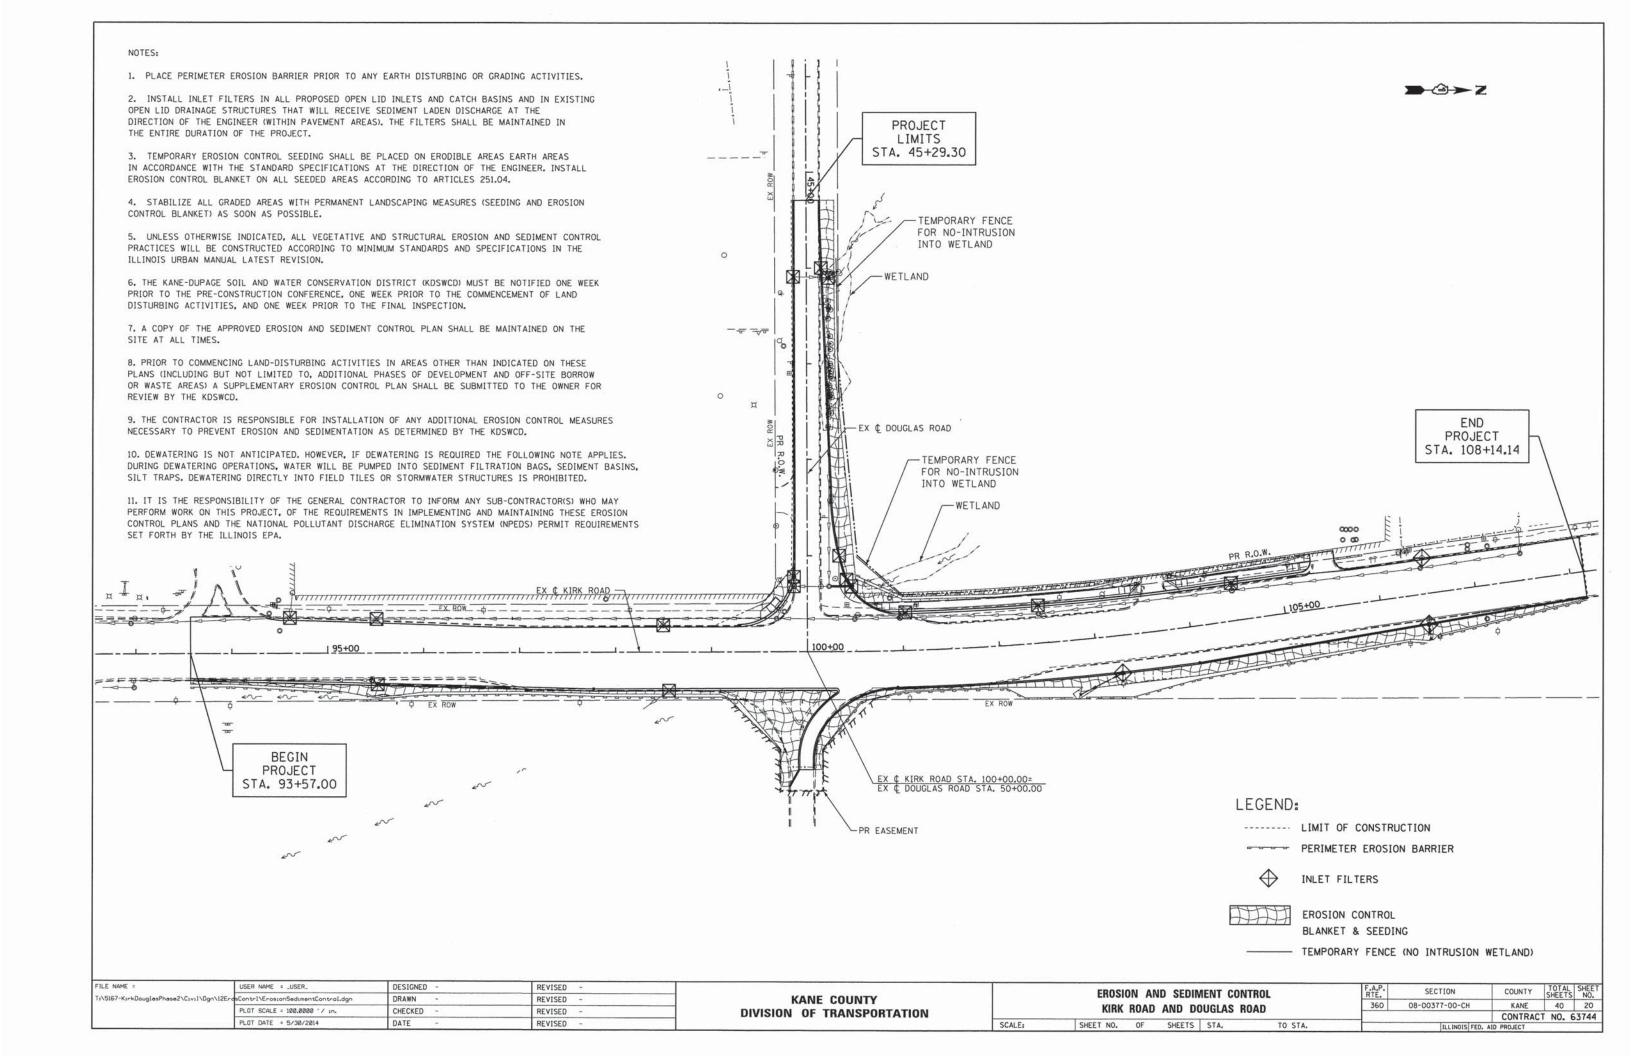


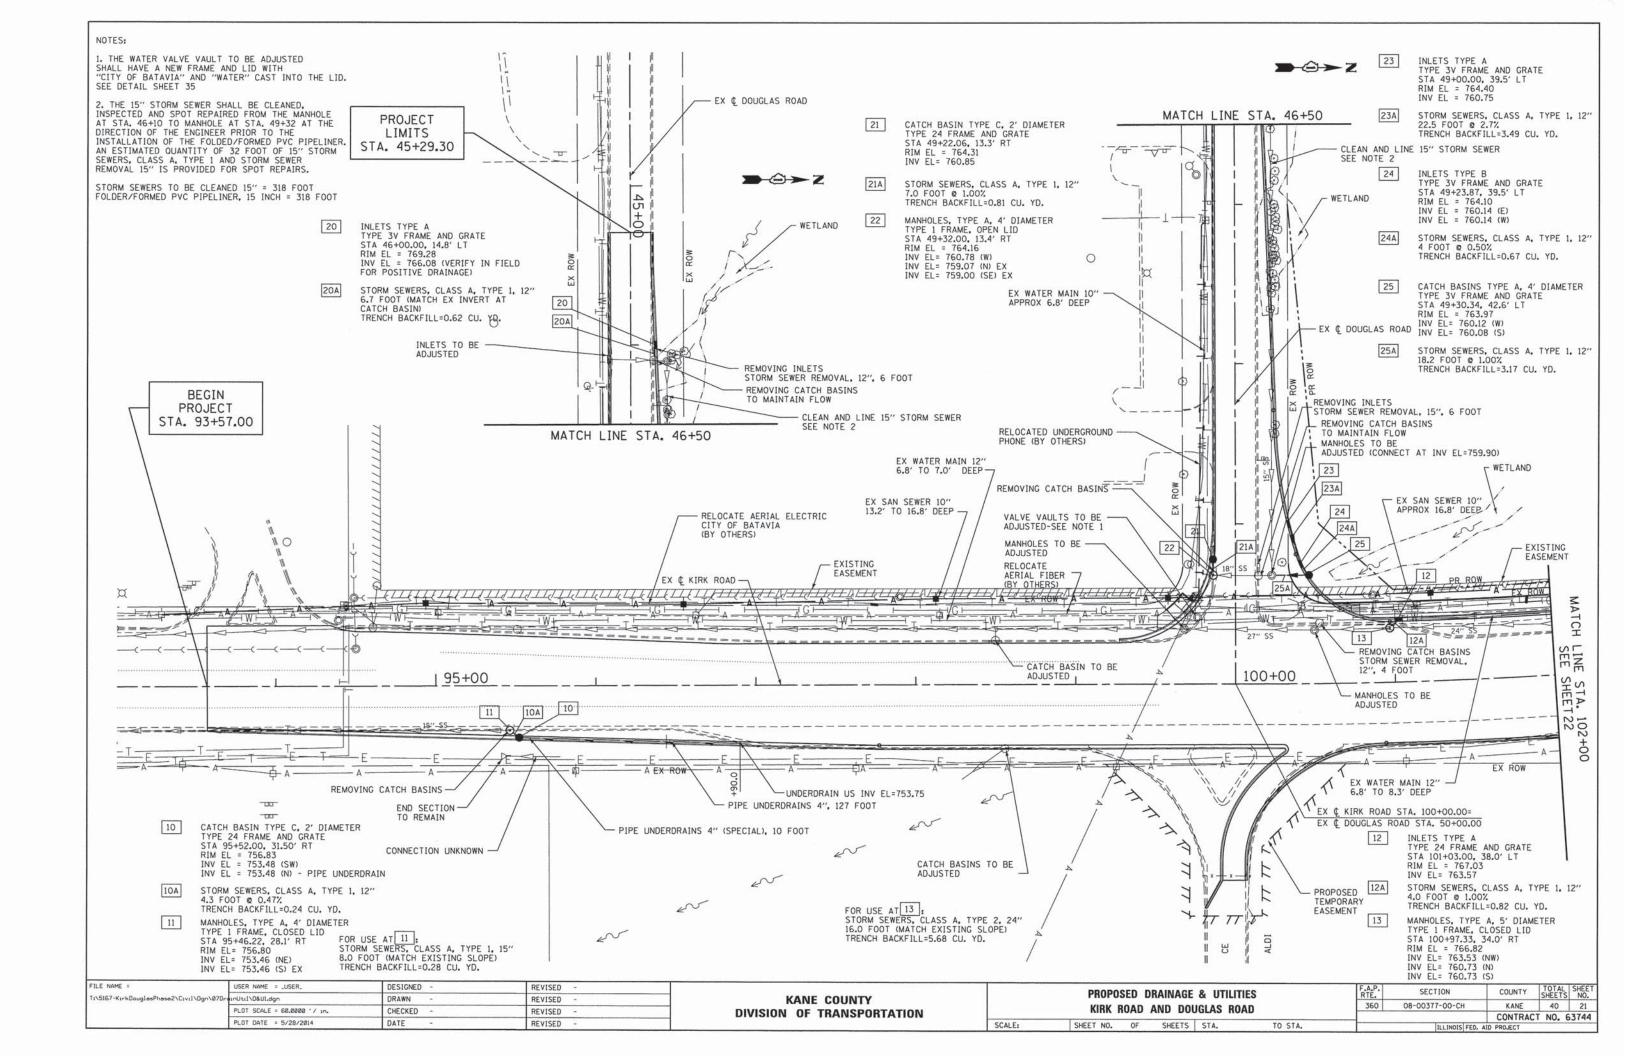


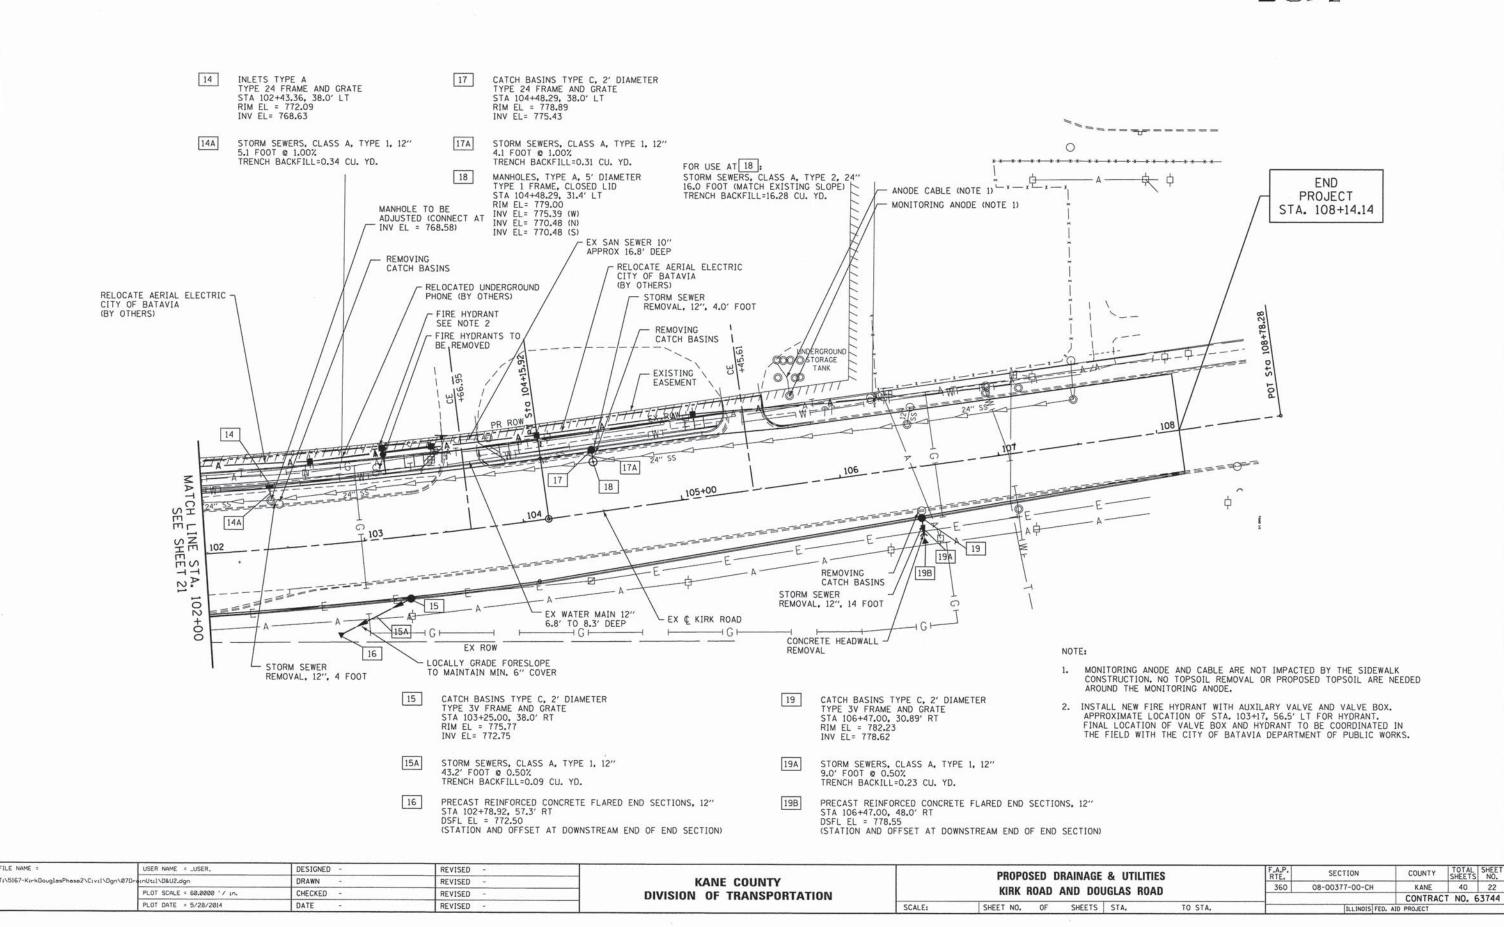



FILE NAME :

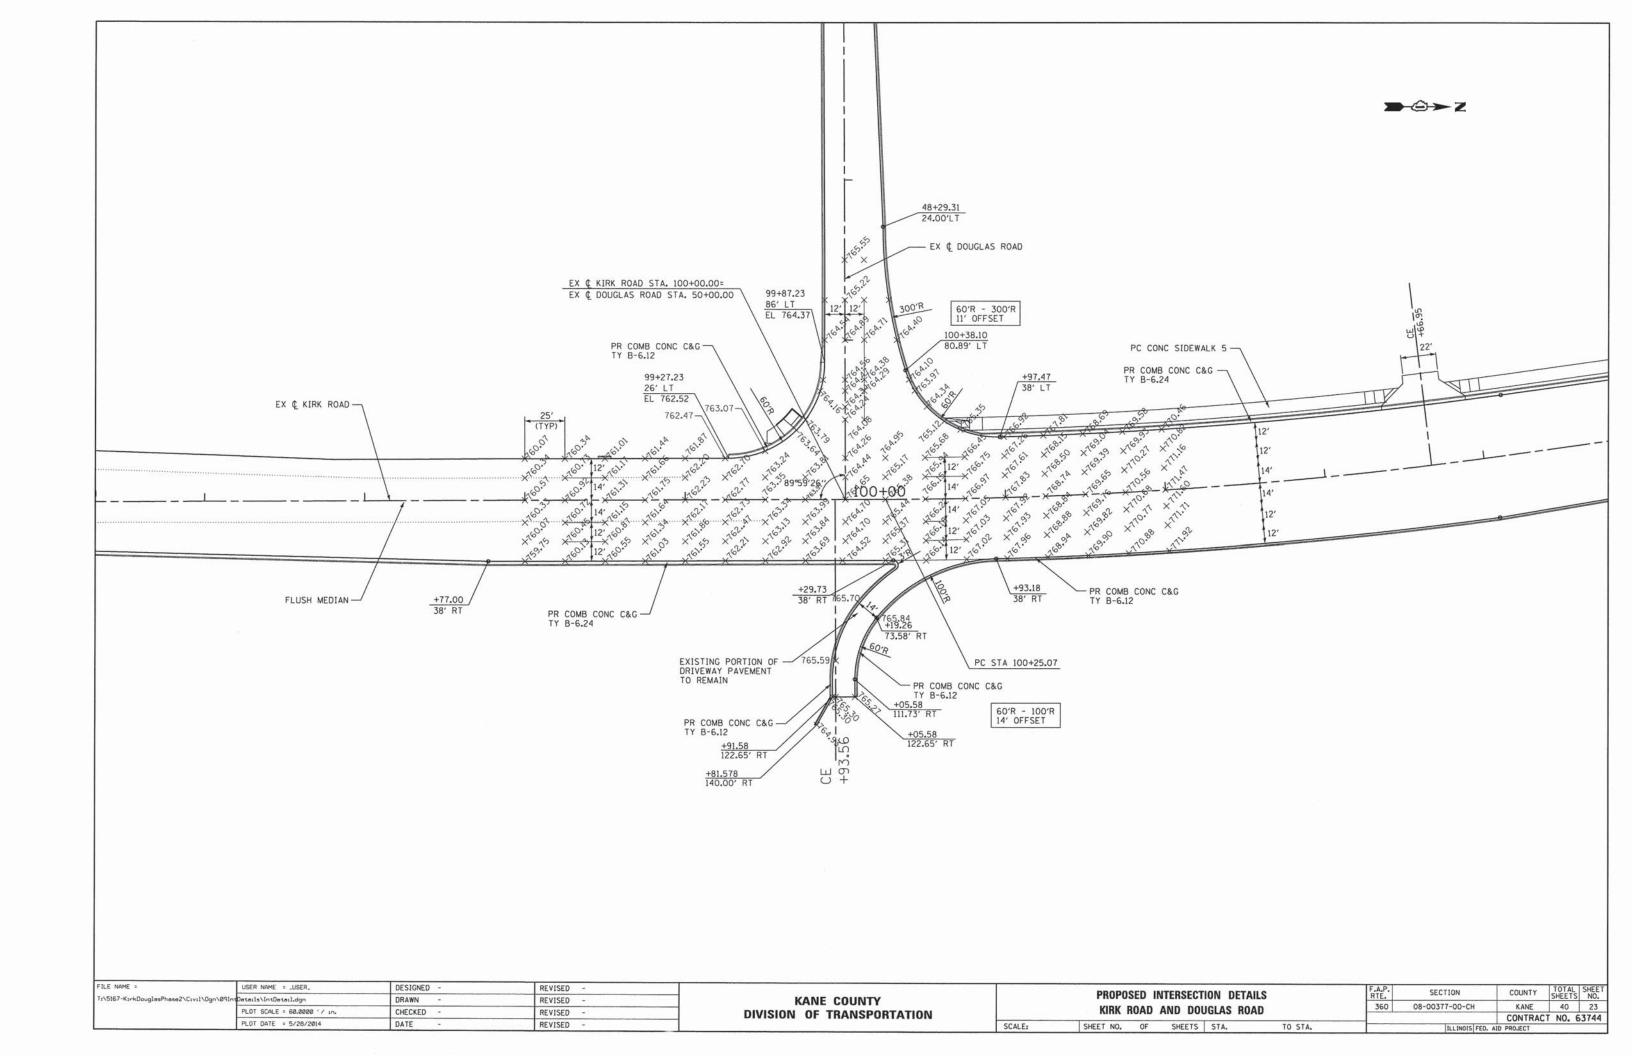

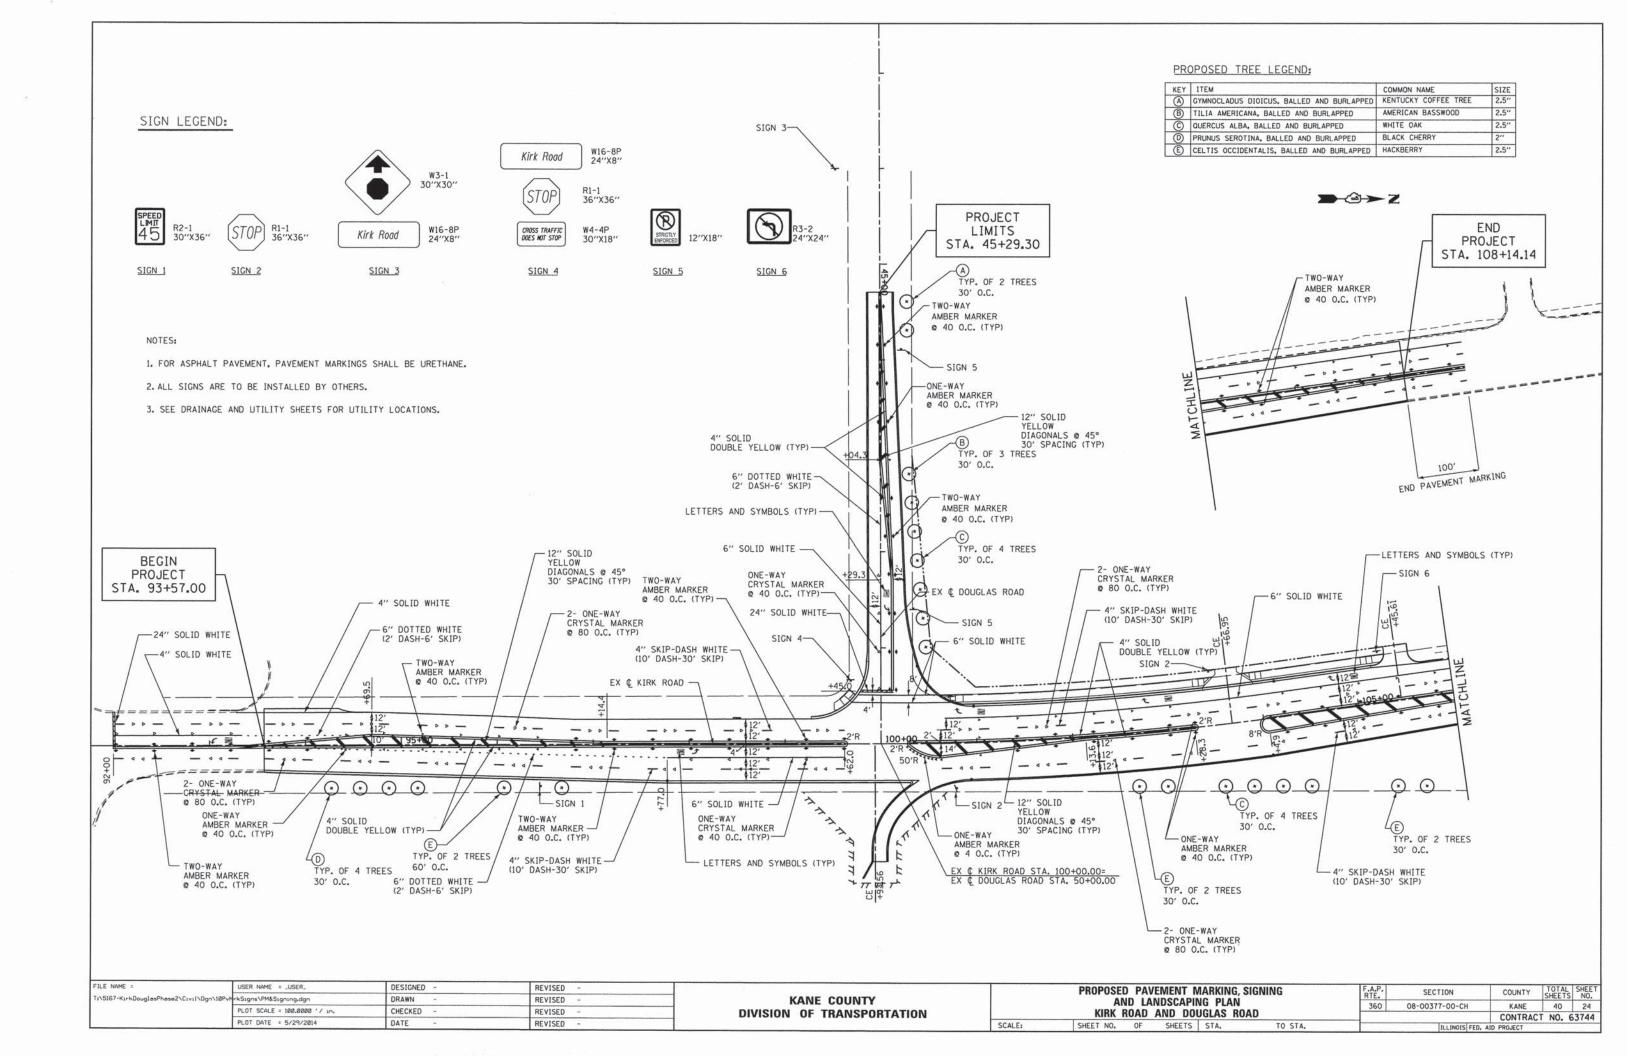

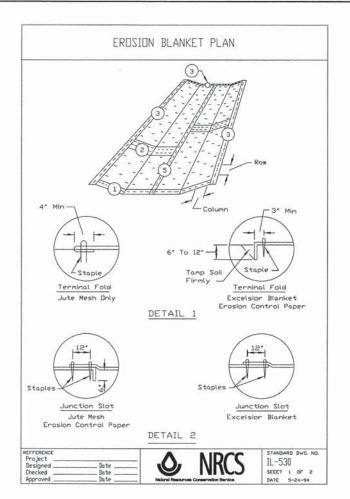

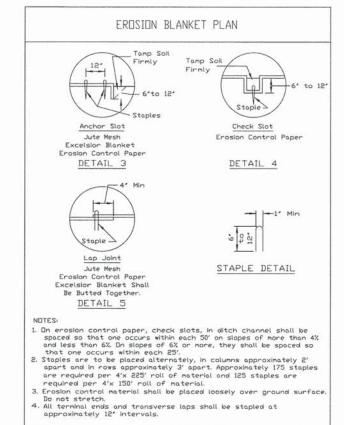

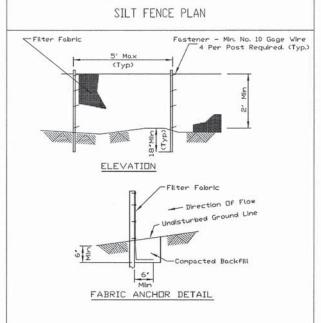

IL-530

SHEET 2 OF 2 DATE 3-1-95

- NOTES:


 1. Tenporary sediment fence shall be installed prior to any grading work in the area to be protected. They shall be maintained throughout the construction period and removed in conjunction with the final grading and site stabilization.
- and site stabilization.

 2. Filter fabric shall meet the requirements of material specification 592 Geotextile Table 1 or 2, Class I with equivalent opening size of at least 30 for nonwoven and 40 for woven.


 3. Fence posts shall be either standard steel post or wood post with a
- minimum cross-sectional area of 3.0 sq. in,

Project	STANDARD DWG. NO. IUM-620A
Designed Date	TUM-PCUA
Checked Date	SHEET 1 DF 2
Approved Date	DATE 3-16-12

SCALE:

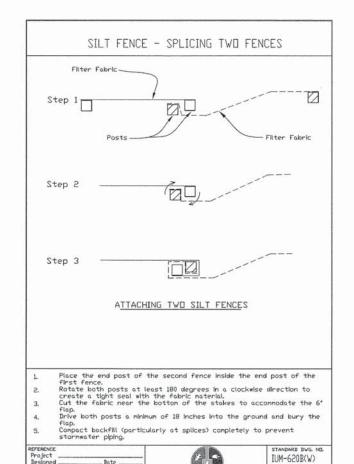



SHEET 1 DF 1 DATE 3-16-2012

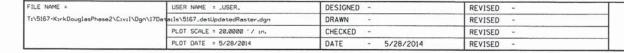

KANE COUNTY **DIVISION OF TRANSPORTATION**


					F.A.P. RTE.	SECTION	COUNTY	TOTAL	SHEE
EROSION AN	ID SE	DIMENT	CONTROL	DETAILS	360	08-00377-00-CH	KANE	40	25
							CONTRACT	NO.	63744
SHEET NO.	OF	SHEETS	STA.	TO STA.		TI I INOIS EED	AID PROJECT		-

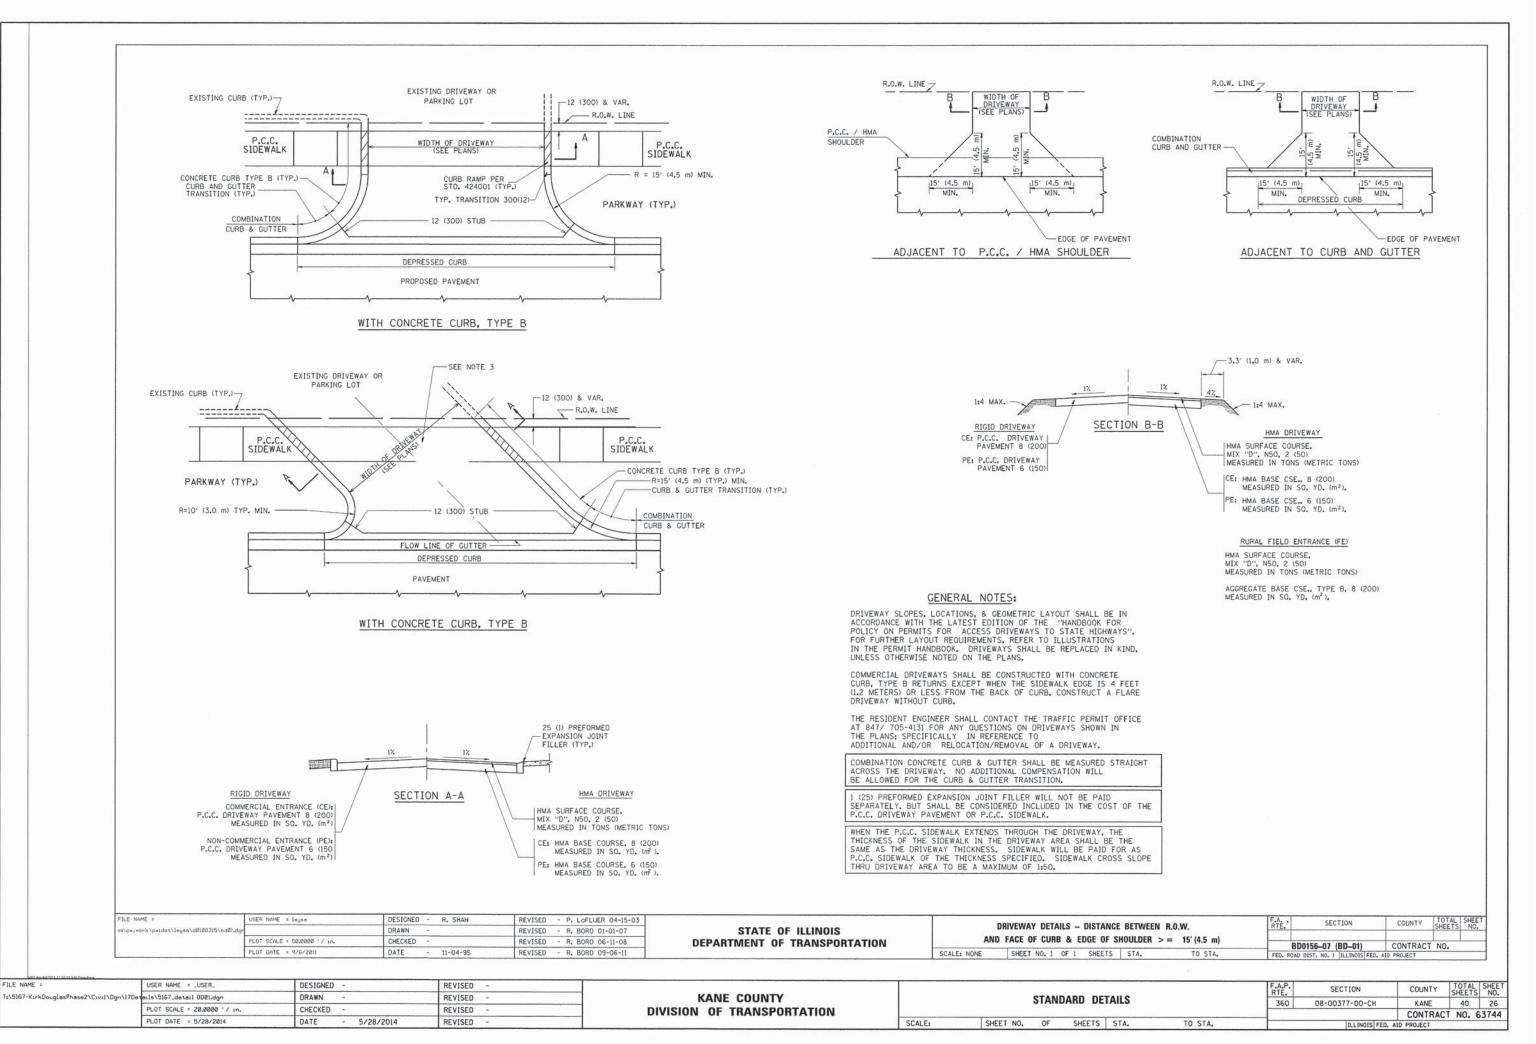


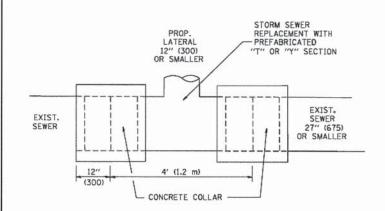


DETAIL "A"

LATERAL CONNECTION TO EXISTING SEWER OF 27" (675) OR SMALLER

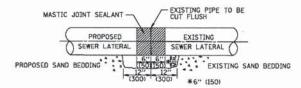

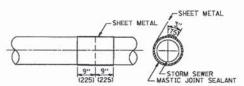

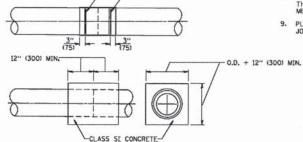


METAL BINDING

DETAIL "B"

CLASS SI CONCRETE COLLAR

CONSTRUCTION SEQUENCE

- CUT THE EXISTING END OF THE PIPE SO AS TO PRESENT A FLUSH BUTT JOINT. BRUSH AND CLEAN ALL PIPES.
- 2. APPLY THE MASTIC JOINT SEALANT TO THE FIRST 6" (150) OF EACH PIPE.
- BUTT THE PIPES TOGETHER LEAVING A MINIMUM OF 12' x 6' (300 x 150) DEEP EXCAVATION UNDER AND AROUND EACH PIPE END.
- 4. CUT A PIECE OF SHEET METAL GAGE NO. 19 1.1 (0.0418) 18" (450) WIDE BY THE OUTSIDE CIRCUMFERANCE OF THE PIPE PLUS 3" (75) LONG.
- WRAP THE SHEET METAL AROUND THE PIPES, 9" (225) ON EACH SIDE OF THE JOINT, STARTING AT THE TOP OF THE PIPE.
- LAP THE SHEET METAL AT LEAST 3" (75) AT THE TOP OF THE PIPE AND PLACE THE MASTIC JOINT SEALANT BETWEEN THE LAP.
- PLACE TWO METAL BANDS AROUND THE SHEET METAL AND TIGHTEN.
- WIPE OFF ANY EXCESS MASTIC JOINT SEALANT THAT OOZES OUT FROM BETWEEN THE SHEET METAL AND THE PIPES.
- PLACE CLASS SI CONCRETE AROUND THE JOINT.

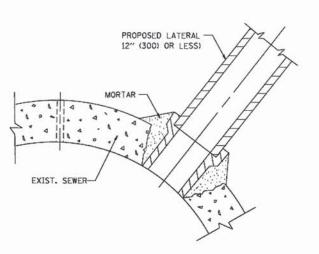

PROPOSED LATERAL
CONNECTION TO EXISTING SEWER
OF 30" (750) OR LARGER

NOTES

MATERIAL

MATERIAL USED FOR THE TEE OR WYE SECTION SHALL BE COMPATIBLE WITH THE EXISTING STORM SEWER OR THE PROPOSED STORM SEWER.

CONSTRUCTION METHODS

- 1. THIS WORK SHALL BE CONSTRUCTED IN CONFORMANCE WITH THE APPLICABLE PORTIONS OF SECTION 550 OF THE STANDARD SPECIFICATIONS.
- II. CONNECTION TO AN EXISTING STORM SEWER SHALL BE BY EITHER OF THE FOLLOWING METHODS: A) PROPOSED STORM SEWER CONNECTION TO EXISTING SEWER OF 27" (675) OR SMALLER SEE DETAIL "A" AND "B".
- B) PROPOSED STORM SEWER CONNECTION TO EXISTING SEWER OF 30" (750) OR LARGER SEE DETAIL "C".

IF THE EXISTING SEWER PIPE IS CRACKED, BROKEN OR OTHERWISE DAMAGED BY THE CONTRACTOR IN MAKING THE CIRCULAR OPENING, THE CONTRACTOR SHALL REPLACE THAT SECTION OF PIPE WITH PIPE EQUAL AND SIMILAR IN ALL RESPECTS TO THE PIPE IN THE EXISTING SEWER, IN A CAREFUL WORKMANLIKE MANNER, WITHOUT EXTRA COMPENSATION.

GENERAL

CARE MUST BE TAKEN TO PREVENT DEBRIS FROM ENTERING THE SEWER.
ALL DEBRIS WHICH ENTERS THE SEWER MUST BE REMOVED. THE SEWER MUST
BE LEFT CLEAN AND UNOBSTRUCTED UPON COMPLETION OF THE CONTRACT.

CARE MUST BE TAKEN TO PREVENT ANY PART OF THE NEW PIPE CONNECTION FROM PROJECTING INTO THE EXISTING SEWER.

BASIS OF PAYMENT

TEE OR WYE CONNECTIONS SHALL BE PAID FOR AT THE CONTRACT UNIT PRICE EACH FOR STORM SEWER TEE OR WYE OF THE TYPE AND SIZE SPECIFIED IN THE PLANS, THIS PRICE SHALL INCLUDE ALL EXCAVATION OF THE TERMCH, REMOVAL OF THE EXISTING STORM SEWER, FURNISHING AND INSTALLING THE SPECIFIED TEE OR WYE SECTION, FURNISHING AND INSTALLING THE REQUIRED CONCRETE COLLAR, AND ALL OTHER MATERIAL NECESSARY TO COMPLETE THIS WORK AS SHOWN AND SPECIFIED.

REMOVAL AND REINSTALLATION OF EXISTING STORM SEWER ADJACENT TO THE PROPOSED TEE OR WYE SECTION, FOR THE PURPOSE OF FACILITATING THE INSTALLATION OF THE TEE OR WYE SECTION, WILL NOT BE PAID FOR SEPARATELY BUT SHALL BE INCLUDED IN THE UNIT PRICE BID FOR THE WORK.


TRENCH BACKFILL, EXCAVATION IN ROCK AND REMOVAL AND REPLACEMENT OF UNSUITABLE MATERIAL BELOW PLAN BEDDING GRADE WILL BE PAID FOR SEPARATELY.

CONCRETE COLLAR FOR CONNECTING A PROPOSED STORM SEWER TO AN EXISTING STORM SEWER WILL NOT BE PAID PAID FOR SEPARATELY BUT SHALL BE INCLUDED IN THE COST OF THE PROPOSED STORM SEWER.

ALL DIMENSIONS ARE IN INCHES (MILLIMETERS) UNLESS OTHERWISE SHOWN.

FILE NAME =	USER NAME = gaglianobt	DESIGNED - M. DE YONG	REVISED - M. DE YONG 05-08-92					F.A	SECTION	COUNTY	TOTAL SHEET
W:\diststd\22x34\bd87.dgn		DRAWN -	REVISED - R. SHAH 09-09-94	STATE OF ILLINOIS		DETAIL OF STORM SEWER		RTE.	Scotton	Counti	SHEETS NO.
	PLOT SCALE = 50.000 '/ IN.	CHECKED -	REVISED - R. SHAH 10-25-94	DEPARTMENT OF TRANSPORTATION		CONNECTION TO EXISTING SEWER		-	TOTAL OF IND 11	CONTRACT	- 110
	PLOT DATE = 1/4/2888 D/	DATE - 07-25-90	REVISED - R. SHAH 06-12-96		SCALE: NONE	SHEET NO. 1 OF 1 SHEETS STA.	TO STA.	FED. ROAD	BD508-01 (BD-7) D DIST. NO. 1 JLLINOIS FED.	AID PROJECT	NU.

LE NAME =	USER NAME = _USER_	DESIGNED -	REVISED -								F.A.P.	SECTION	COUNTY	TOTAL	SHEE
\5167-KirkDouglasPhase2\Civil\Dgn\17Det	ails\5167_detail BDØ7.dgn	DRAWN -	REVISED -	KANE COUNTY			STANI	DARD DE	FTAILS		RTE.			SHEETS	NO
	PLOT SCALE = 20.0000 ' / in.	CHECKED -	REVISED -	DIVISION OF TRANSPORTATION			VIAIN	טאווט טו	LIMILO		360	08-00377-00-CH	KANE	10	27
PLO*	PLOT DATE = 5/28/2014	DATE - 5/28/2014	REVISED -	DIVIDION OF THANKS OF THAT	SCALE:	CUEET NO	OF	SHEETS	CTA	TO STA.			AID PROJECT	ACT NO.	3/4

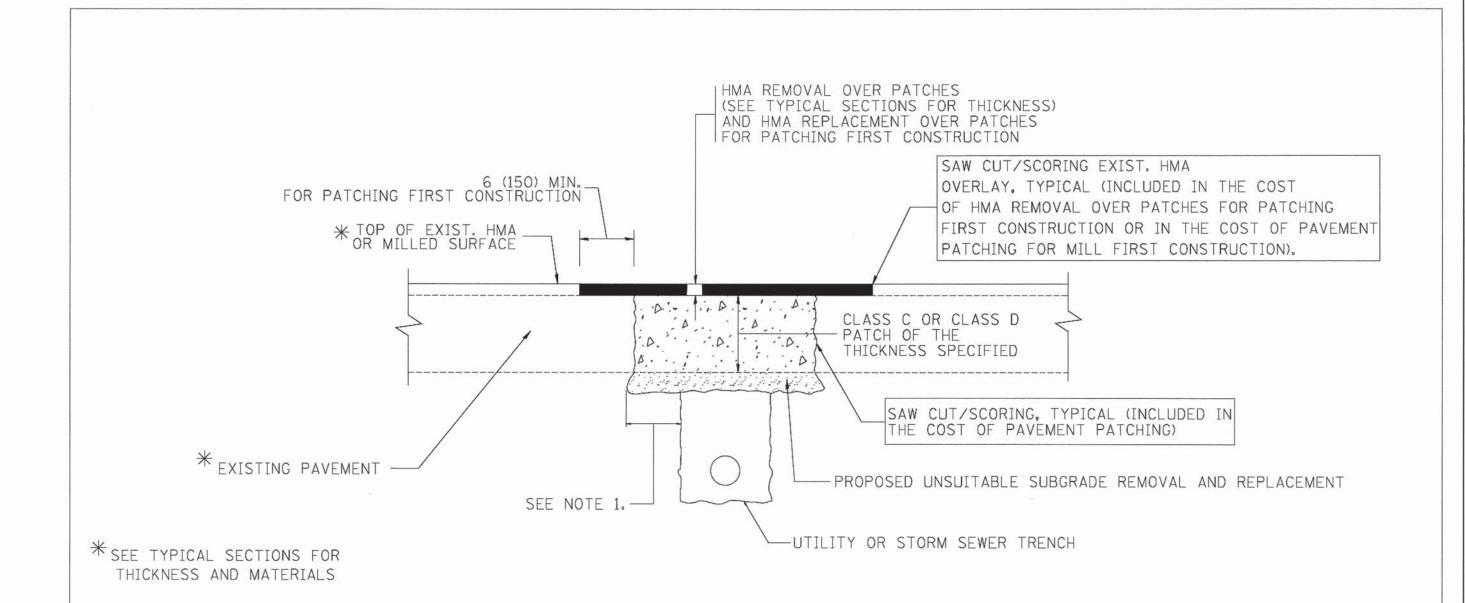

NOTES:

- 1. THE WIDTH OF THE FULL DEPTH PATCH OVER A TRENCH SHALL BE 12 (300) WIDER ON EACH SIDE OF THE TRENCH.
- 2. FOR METHOD OF MEASUREMENT AND BASIS OF PAYMENT, SEE RECURRING SPECIAL PROVISION "PATCHING WITH HOT-MIX ASPHALT OVERLAY REMOVAL".

SEQUENCE OF CONSTRUCTION (PATCHING FIRST)

- 1. REMOVE THE EXISTING HMA MATERIAL OVER THE AREA TO BE PATCHED.
- 2. REMOVE AND REPLACE WITH CLASS C OR D PATCH.
- 3. REPLACE HMA MATERIAL OVER THE AREA TO BE PATCHED.


SEQUENCE OF CONSTRUCTION (MILLING FIRST)


- 1. MILL HMA FIRST IF THERE IS AT LEAST 41/2 INCHES OR MORE OF HMA MATERIAL ON TOP OF THE EXISTING PAVEMENT OR IF THE PAVEMENT IS FULL DEPTH HMA. A MINIMUM OF 2 INCHES OF HMA MATERIAL SHALL BE IN PLACE AFTER MILLING.
- 2. REMOVE AND REPLACE WITH FULL DEPTH CLASS D PATCHES TO TOP OF MILLED SURFACE.


ALL DIMENSIONS ARE IN INCHES (MILLIMETERS) UNLESS OTHERWISE SHOWN.

Ftt	LE NAME =	USER NAME = bouerd1	DESIGNED - R. SHAH	REVISED - A. ABBAS 04-27-98			DAUGHGER DAYAUMA CAR		F.A.	SECTION	COUNTY	SHEETS NO.
c:	\projects\diststd22x34\bd22.dgn		DRAWN -	REVISED - R. BORO 01-01-07	STATE OF ILLINOIS		PAVEMENT PATCHING FOR		RIE.		-	SHEETS NO.
		PLOT SCALE = 58.008 1/ IN.	CHECKED -	REVISED - R. BORO 09-04-07	DEPARTMENT OF TRANSPORTATION		HMA SURFACED PAVEMENT		\vdash	BD400-04 (BD-22)	CONTRACT	NO
		PLOT DATE = 10/27/2008	DATE - 10-25-94	REVISED - K. ENG 10-27-08		SCALE: NONE	SHEET NO. 1 OF 1 SHEETS STA.	TO STA.	FED. RO	AD DIST. NO. 1 LLINOIS FED. A		NO.


FILE NAME =	USER NAME = _USER_	DESIGNED -	REVISED -								F.A.P.	SECTION	COUNTY	TOTAL	SHEET
T:\5167-K:rkDouglasPhase2\C:v:l\Dgn\17De	ails\5167_detail BD22.dgn	DRAWN -	REVISED -	KANE COUNTY			STAND	ARD D	ETAILS		360	08-00377-00-СН	KANF	SHEE 13	20
H	PLOT SCALE = 20.0000 ' / in.	CHECKED -	REVISED -	DIVISION OF TRANSPORTATION							360	06-00311-00-CH	CONTRA	CT NO	63744
	PLOT DATE = 5/28/2014 DATE - 5/28/2014 REVISED -		SCALE:	SHEET NO.	OF	SHEETS	STA.	TO STA.		ILLINOIS FED	AID PROJECT	C1 140.	ררונט		

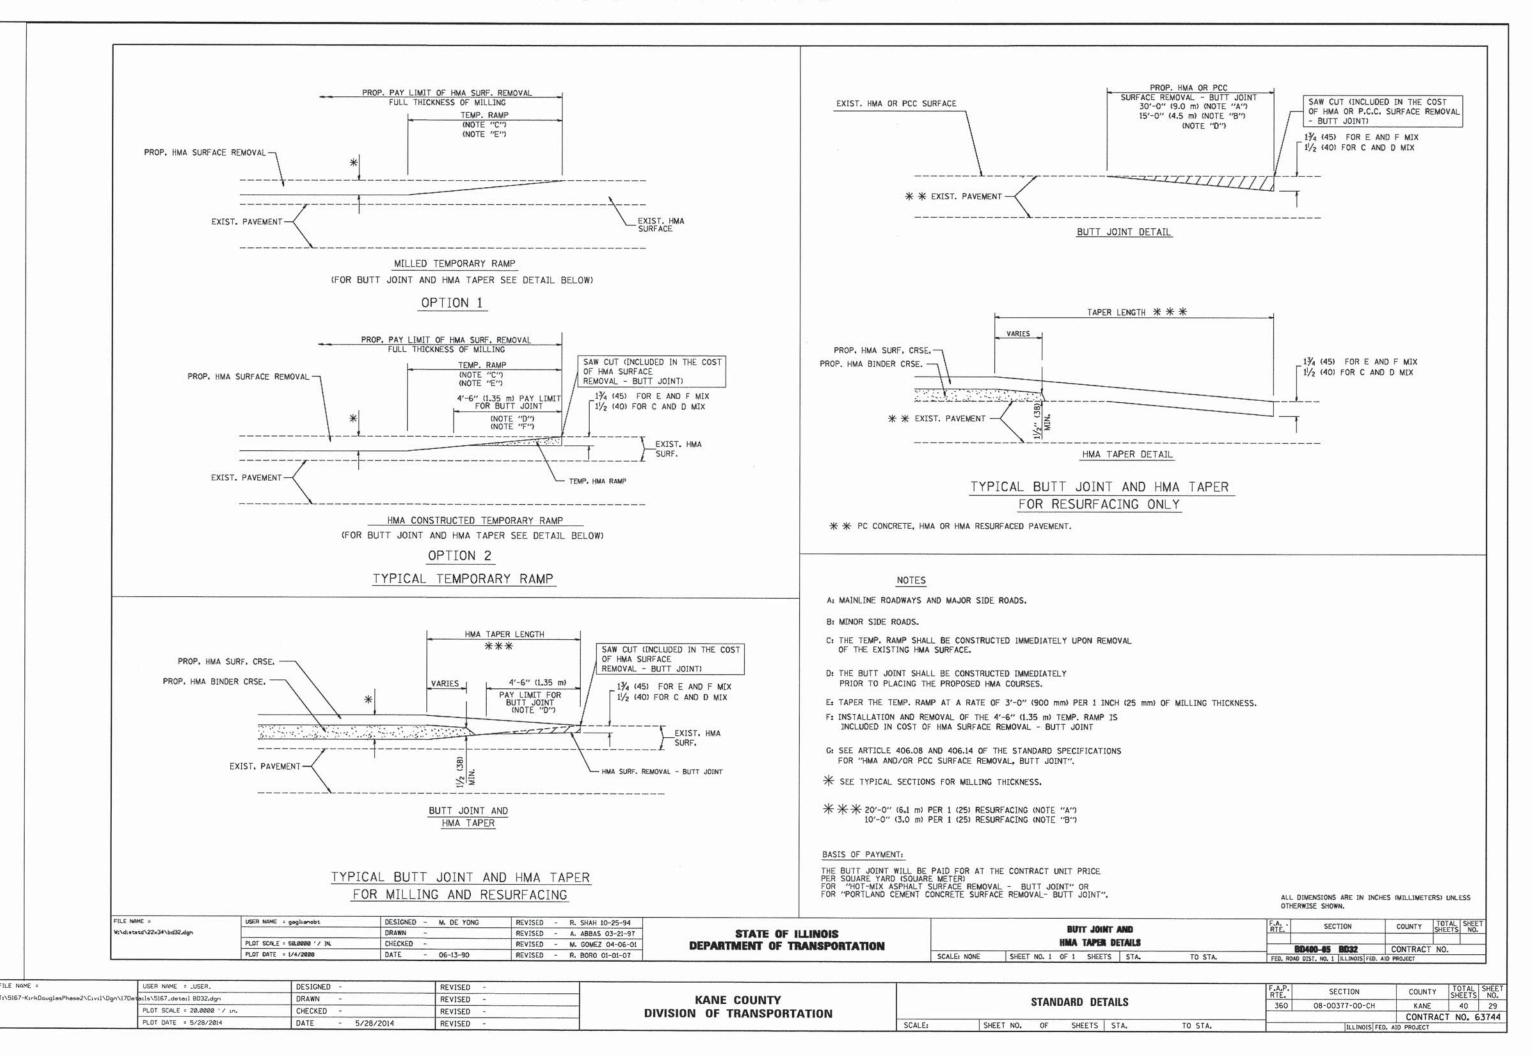


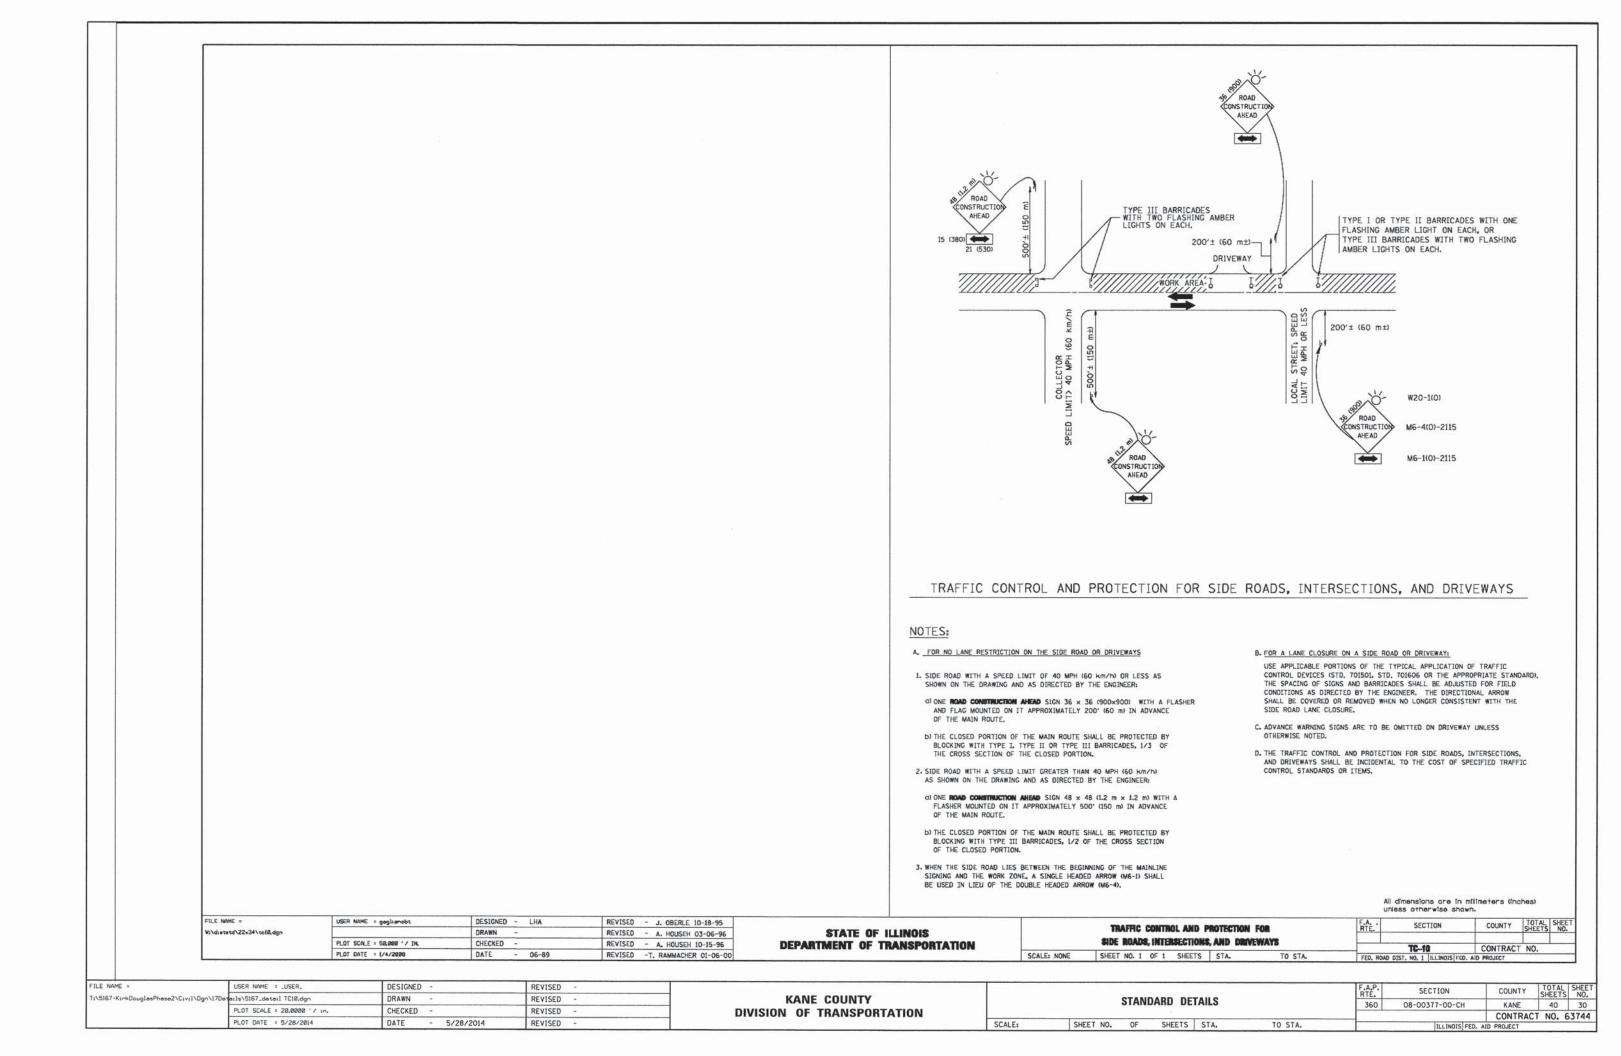


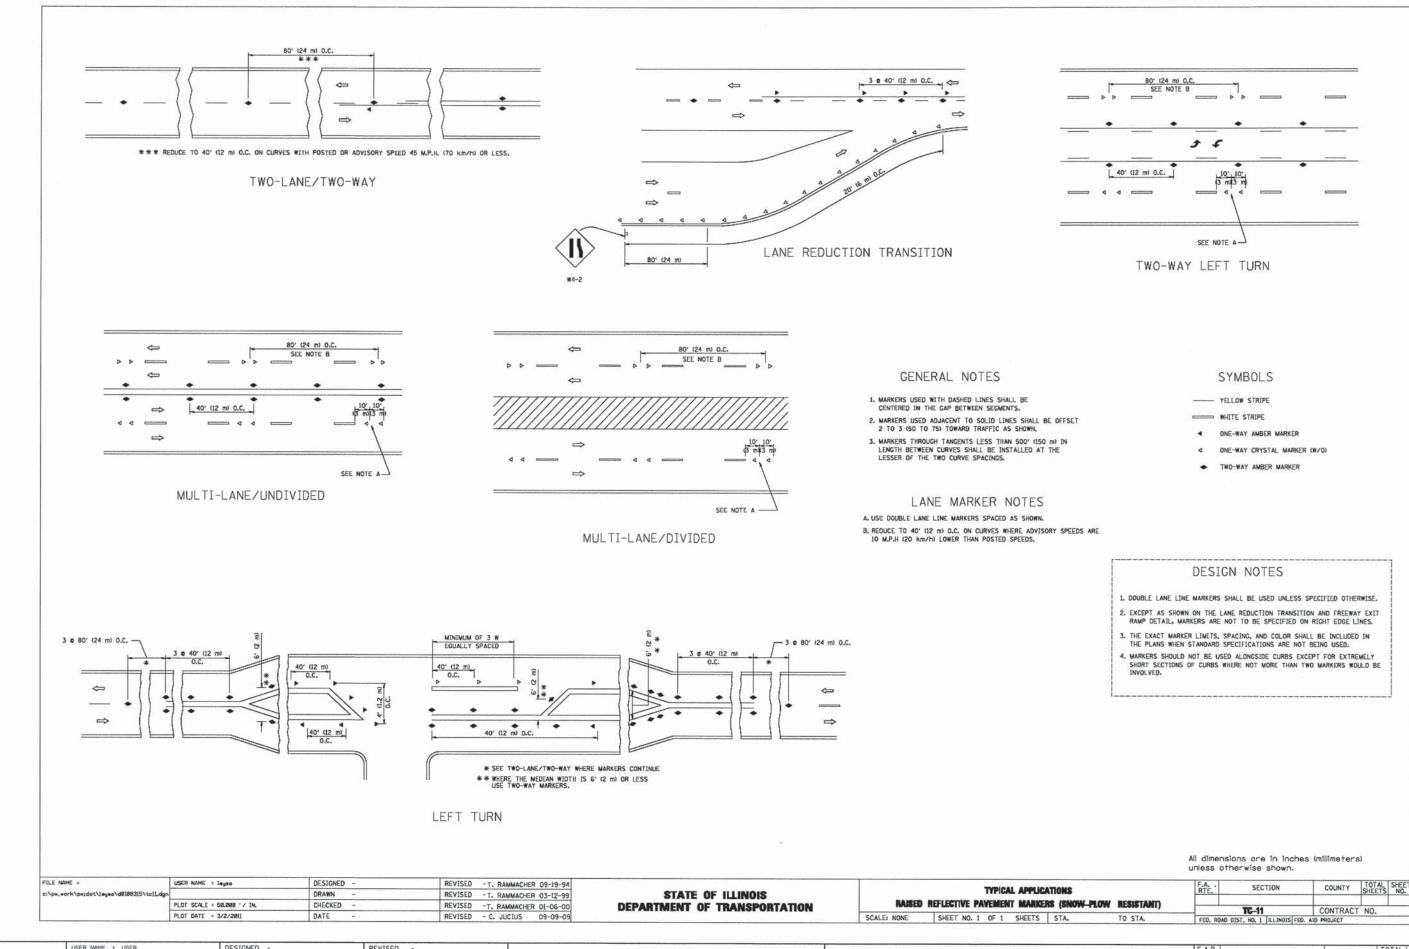

FILE NAME = USER NAME = _USER_ DESIGNED -REVISED -SECTION COUNTY Tr\5167-KirkDoug ails\5167_detail TC11.dgr DRAWN REVISED KANE COUNTY STANDARD DETAILS 360 08-00377-00-CH KANE 40 31 PLOT SCALE = 20.0000 '/ in. CHECKED REVISED **DIVISION OF TRANSPORTATION** CONTRACT NO. 63744 PLOT DATE = 5/28/2014 DATE - 5/28/2014 REVISED SCALE: SHEET NO. OF SHEETS STA. TO STA.

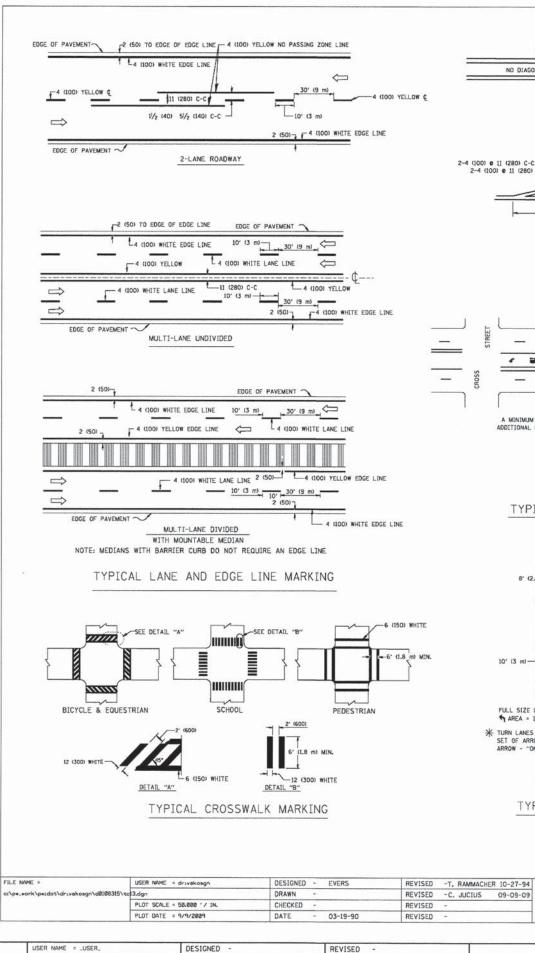

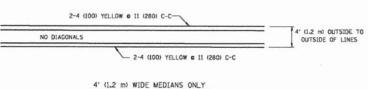

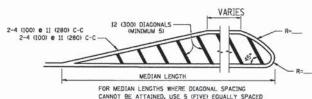

DIAGONAL LINES.

DIAGONAL LINE SPACING: 50' (15 m) C-C (LESS THAN 30MPH (50 km/h)) 75' (25 m) C-C 30MPH (50 km/h) TO 45MPH (70 km/h)) 150' (45 m) C-C (MORE THAN 45MPH (70 km/h))


MEDIANS OVER 4' (1.2 m) WIDE -4 (100) YELLOW LINES (51/2 (140) C-C) 4 (100) YELLOW LINES (51/2 (140) C-C) -2-4 (100) YELLOW 0 11 (280) C-C

A MINIMUM OF TWO PAIRS OF TURN ARROWS SHALL BE USED, WHITE IN COLOR. ADDITIONAL PAIRS SHALL BE PLACED AT 200' (60 m) TO 300' (90 m) INTERVALS.



MEDIAN WITH TWO-WAY LEFT TURN LANE

TYPICAL PAINTED MEDIAN MARKING

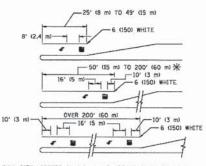


FULL SIZE LETTERS 8' (2.4 m) AND ARROWS SHALL BE USED.


AREA = 15.6 SO. FT. (1.5 m²)

* TURN LANES IN EXCESS OF 400' (120 m) IN LENGTH MAY HAVE AN ADDITIONAL SET OF ARROW - "ONLY" INSTALLED MIDWAY BETWEEN THE OTHER TWO SETS OF ARROW - "ONLY".

TYPICAL LEFT (OR RIGHT) TURN LANE

TYPICAL TURN LANE MARKING

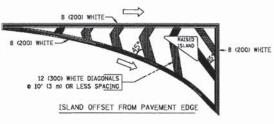

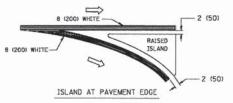

TYPICAL ISLAND MARKING

TYPE OF MARKING	WIDTH OF LINE	PATTERN	COLOR	SPACING / REMARKS
CENTERLINE ON 2 LANE PAVEMENT	4 (100)	SKIP-DASH	YELLOW	10' (3 m) LINE WITH 30' (9 m) SPACE
CENTERLINE ON MULTI-LANE UNDIVIDED PAVEMENT	2 e 4 (100)	SOLID	YELLOW	11 (580) C-C
NO PASSING ZONE LINES: FOR ONE DIRECTION FOR BOTH DIRECTIONS	4 (100) 2 e 4 (100)	SOLID SOLID	AETFOM AETFOM	5/2 (140) C-C FROM SKIP-DASH CENTERLINE 11 (280) C-C OMIT SKIP-DASH CENTERLINE BETWEEN
LANE LINES	4 (100) 5 (125) ON FREEWAYS	SKIP-DASH SKIP-DASH	WHITE WHITE	10' (3 m) LINE WITH 30' (9 m) SPACE
DOTTED LINES (EXTENSIONS OF CENTER, LANE OR TURN LANE MARKINGS)	SAME AS LINE BEING EXTENDED	SKIP-DASH	SAME AS LINE BEING EXTENDED	2' (600) LINE WITH 6' (I.8 m) SPACE
EDGE LINES	4 (100)	SOLID	YELLOW-LEFT WHITE-RIGHT	OUTLINE MOUNTABLE MEDIANS IN YELLOW: EDGE LINES ARE NOT USED NEXT TO BARRIER CURB
TURN LANE MARKINGS	6 (150) LINE; FULL SIZE LETTERS & SYMBOLS (8' (2.4m))	SOLID	WHITE	SEE TYPICAL TURN LANE MARKING DETAIL
TWO WAY LEFT TURN MARKING	2 e 4 (100) EACH DIRECTION	SKIP-DASH AND SOLID	YELLOW	10' (3 m) LINE WITH 30' (9 m) SPACE FOR SKIP-DASH; 5/2 (140) C-C BETWEEN SOLID LINE AND SKIP-DASH LINE
	8' (2.4m) LEFT ARROW	IN PAIRS	WHITE	SEE TYPICAL TWO-WAY LEFT TURN MARKING DETAIL
CROSSWALK LINES (PEDESTRIAN) A. DIAGONALS (BIKE & EQUESTRIAN) B. LONGITUDINAL BARS (SCHOOL)	2 @ 6 (150) 12 (300) @ 45° 12 (300) @ 90°	SOLID SOLID	WHITE WHITE WHITE	NOT LESS THAN 6' (L8 m) APART 2' (500) APART 2' (500) APART SEE TYPICAL CROSSWALK MARKING DETAILS.
STOP LINES	24 (600)	SOLID	WHITE	PLACE 4' (1.2 h) IN ADVANCE OF AND PARALLEL TO CROSSMALK, IF PRESENT. OTHERNISE, PLACE AT DESIRED STOPPING POINT. PARALLEL TO CROSSROAD CENTERLINE, WHERE POSSIBLE
PAINTED MEDIANS	2 © 4 (100) WITH 12 (300) DIAGONALS © 45° NO DIAGONALS USED FOR 4' (1.2 m) WIDE MEDIANS	SOLID	YELLOW: TWO WAY TRAFFIC WHITE: ONE WAY TRAFFIC	11 (260) C-C FOR THE DOUBLE LINE SEE TYPICAL PAINTED MEDIAN MARKING.
GORE MARKING AND CHANNELIZING LINES	8 (200) WITH 12 (300) DIAGONALS @ 45*	SOLID	WHITE	DIAGONALS= 15' (4,5 m) C-C (LESS THAN 30MPH (50 km/h)) 20' (6 m) C-C 30MPH (50 km/h) TO 45MPH (70 km/h)) 30' (9 m) C-C (0VER 45MPH (70 km/h))
RAILROAD CROSSING	24 (600) TRANSVERSE LINES; "RR" IS 6' (1.8 m) LETTERS; 16 (400) LINE FOR "X"	SOLID	WHITE	SEE STATE STANDARD 780001 AREA OF: "R"=3.6 SO. FT. (0.33 m²) EACH "X"=54.0 SO. FT. (5.0 m²)
SHOULDER DIAGONALS	12 (300) e 45°	SOLID	WHITE - RIGHT YELLOW - LEFT	50' (15 m) C-C (LESS THAN 30MPH (50 km/h)) 75' (25 m) C-C (30 MPH (50 km/h) T0 45MPH (70 km/h) 150' (45 m) C-C (0VER 45MPH (70 km/h))

FOR FURTHER DETAILS ON PAVEMENT MARKING REFER TO STANDARD SPECIFICATIONS FOR ROAD AND BRIDGE CONSTRUCTION AND STATE STANDARD 780CO1.


All dimensions are in inches (millimeters) unless otherwise shown.

FILE NAME *	USER NAME = dravakosgn	DESIGNED - EVERS	REVISED -T. RAMMACHER 10-27-
a:\pw_work\pwi	dot\dr.vakosgn\d8188315\tcl3.dgn	DRAWN -	REVISED -C. JUCIUS 09-09-
	PLOT SCALE = 50.000 ' / IN.	CHECKED -	REVISED -
	PLOT DATE = 9/9/2009	DATE - 03-19-90	REVISED -

STATE	E OI	ILLINOIS
DEPARTMENT	0F	TRANSPORTATION

	Di	ISTRICT OF	NE		F.A RTE.	SECTION	COUNTY	TOTAL	SHEET NO.
	TYPICAL P.	AVEMENT	MARKINGS			TC-13	CONTRACT	r NO.	
SCALE: NONE	SHEET NO. 1 OF 1	SHEETS	STA.	TO STA.	FED. ROAD	DIST. NO. 1 ILLINOIS FE		1101	

FILE NAME =	USER NAME = _USER_	DESIGNED -	REVISED -		Prince in the second						F.A.P.	SECTION	COUNTY	TOTAL	SHEET
T:\5167-KirkDouglasPhase2\Civil\Dgn\17Det	ails\5167_detail TC13.dgn	DRAWN -	REVISED -	KANE COUNTY			STAND	ARD DE	ZILAT		RTE.			SHEETS	NO.
	PLOT SCALE = 20.0000 ' / in.	CHECKED -	REVISED -	DIVISION OF TRANSPORTATION			0171111	ALID DE	THIE		360	08-00377-00-CH	CONTRAC	40 T	32
and the second s	PLOT DATE = 5/28/2014	DATE - 5/28/2014	REVISED -		SCALE:	SHEET NO.	OF	SHEETS	STA.	TO STA.		ILLINOIS FED. A		1 NU. 6	3144

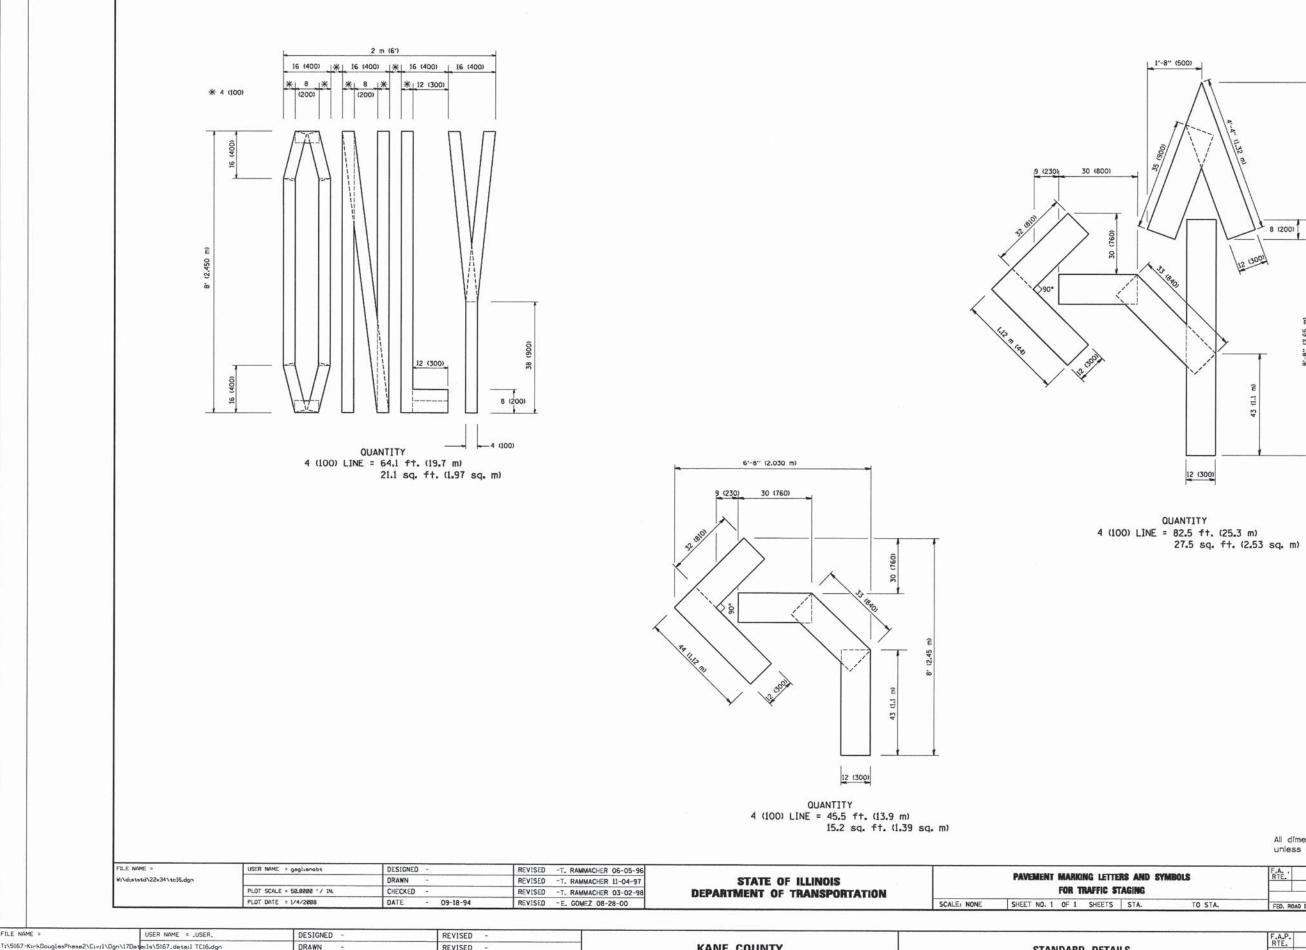

KANE COUNTY

DIVISION OF TRANSPORTATION

FILE NAME =

ails\5167_detail TC16.dgn

PLOT SCALE = 20.0000 '/ in.

PLOT DATE = 5/28/2014

DRAWN

DATE

CHECKED

- 5/28/2014

REVISED

REVISED

REVISED

COUNTY TOTAL SHEET NO.

KANE 40 33 SECTION STANDARD DETAILS 360 08-00377-00-CH CONTRACT NO. 63744 SCALE: SHEET NO. OF SHEETS STA. TO STA.


All dimensions are in inches (millimeters)

CONTRACT NO.

unless otherwise shown.

TC-16 CONTR.
FED. ROAD DIST. NO. 1 | ILLINOIS | FED. AID PROJECT

8 (200)

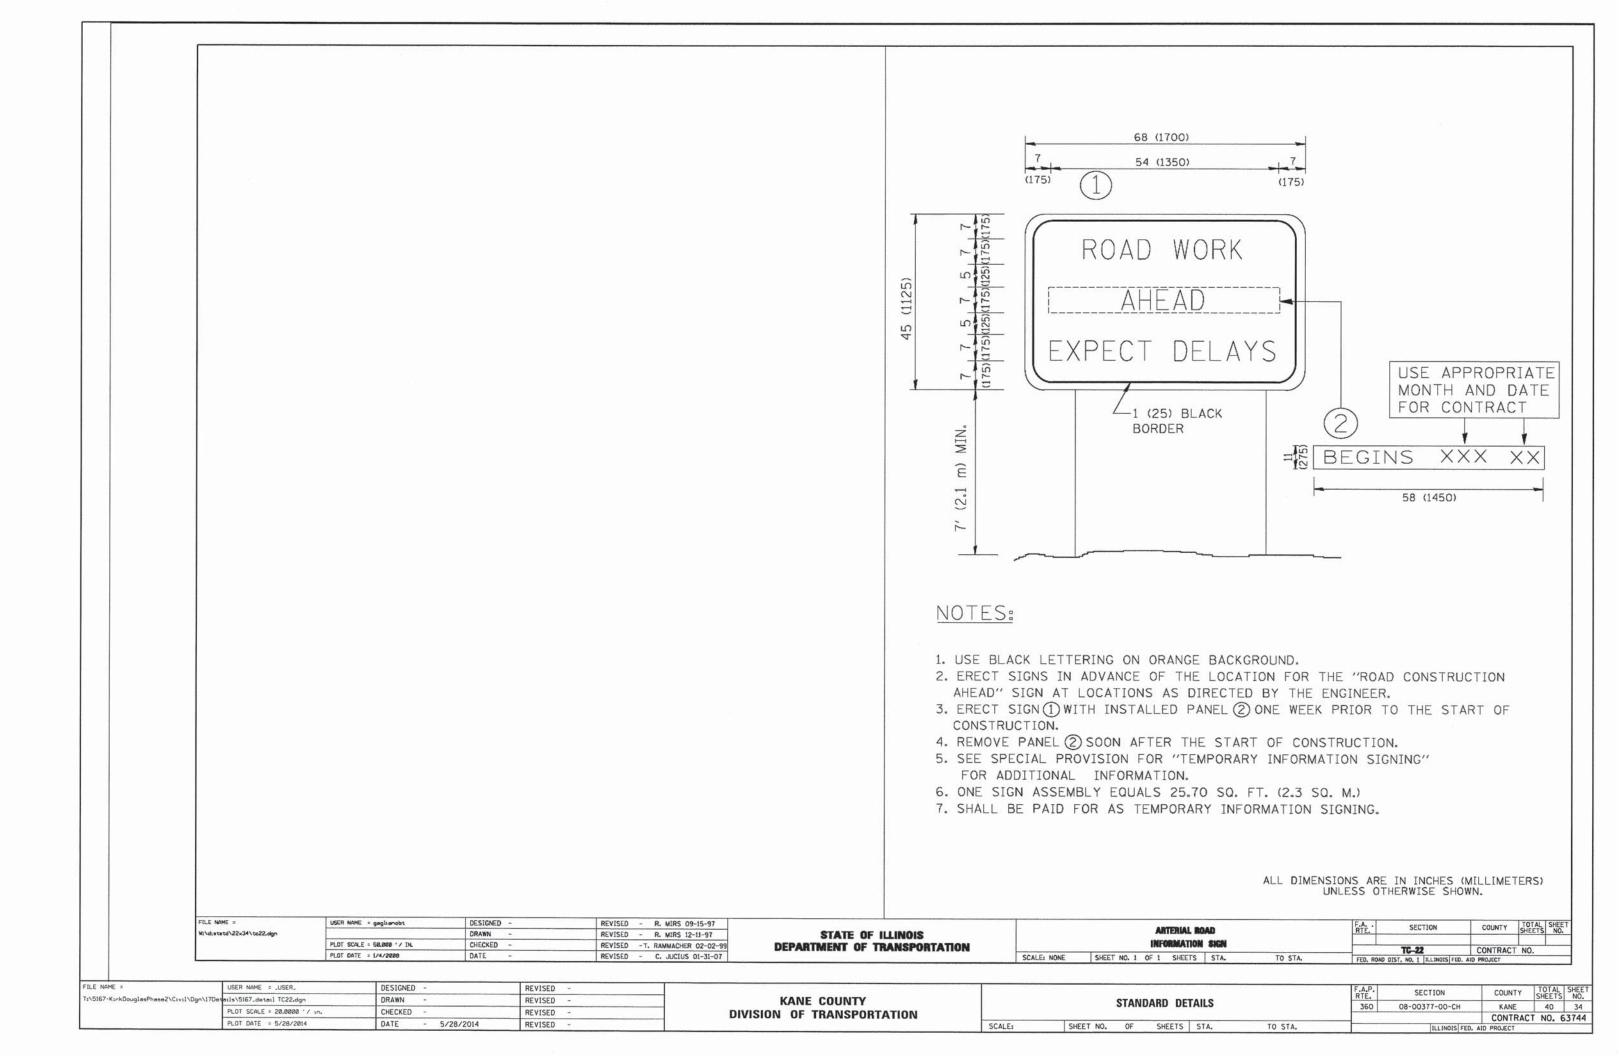




3.0" RADIUS, 0.5" BORDER, WHITE ON GREEN; REFLECTORIZED "DRIVEWAY" D; "ENTRANCE" D; STANDARD ARROW CUSTOM 12.0" × 5.0"


NOTES:

- 1. HALF OF THE SIGNS WILL REQUIRE A LEFT HAND FACING ARROW.
- 2. TWO SIGNS SHALL BE USED AT EACH COMMERCIAL ENTRANCE PLACED BACK-TO-BACK: ONE WITH A RIGHT HAND ARROW (SHOWN) SHALL BE PLACED ON THE NEAR RIGHT SIDE THE DRIVEWAY AND ONE WITH A LEFT HAND ARROW SHALL BE PLACED ON THE FAR LEFT SIDE OF THE DRIVEWAY.
- 3. SIGNS TO BE PAID FOR AS ITEM "TEMPORARY INFORMATION SIGNING".

FILE NAME =	USER NAME = goglianobi	DESIGNED -	REVISED - C. JUCIUS 02-15-07			DRIVEWAY ENTRANCE SIGNING		F.A.	SECTION	COUNTY	TOTAL SHEET
#:\diststd\22x34\to26.dgn	·	DRAWN -	REVISED -	STATE OF ILLINOIS		Pettares ratement defrained		1			- Inc. 13 1101
1	PLOT SCALE = 50.088 */ IN.	CHECKED -	REVISED -	DEPARTMENT OF TRANSPORTATION					TC-26	CONTRACT	T NO.
	PLOT DATE = L/4/2888	DATE -	REVISED -		SCALE: NONE	SHEET NO. 1 OF 1 SHEETS STA.	TO STA.	FED. RO	AD DIST. NO. 1 HLENOIS FED.		

FILE NAME =	USER NAME = _USER_	DESIGNED -	REVISED -				F.A.P.	SECTION		TOTAL SHEET
7:\5167-KirkDouglasPhase2\Civil\Dgn\17Det	tails\5167.detail TC26.dgn	DRAWN -	REVISED -	KANE COUNTY	44	STANDARD DETAILS				40 34A
1	PLOT SCALE = 20.0000 ' / in.	CHECKED -	REVISED -	DIVISION OF TRANSPORTATION					CONTRACT I	NO. 63744
1	PLOT DATE = 6/18/2014	DATE - 6/18/2014	REVISED -		SCALE:	SHEET NO. OF SHEETS STA. TO STA.		ILLINDIS FEI	D. AID PROJECT	

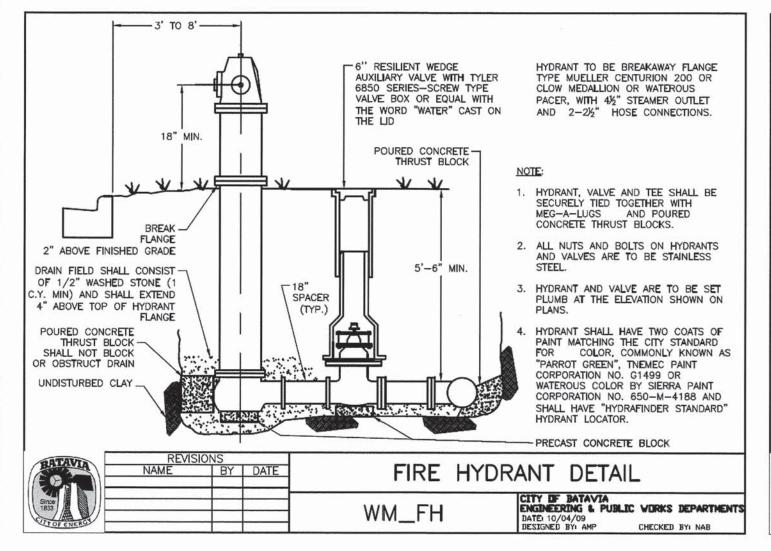

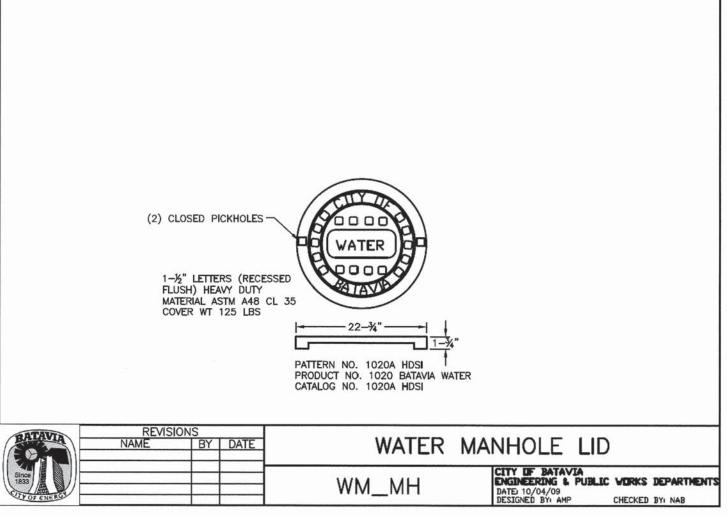

FILE NAME =	USER NAME = _USER_	DESIGNED -	REVISED -	
T:\5167-KirkDouglasPhase2\Civil\Dgn\17Det	ails\Batavia\5167_detail Batavia.dgn	DRAWN -	REVISED -	
	PLOT SCALE = 20.0000 ' / in.	CHECKED -	REVISED -	
	PLOT DATE = 5/28/2014	DATE - 5/28/2014	REVISED -	

KANE COUNTY
DIVISION OF TRANSPORTATION

					F.A.P. RTE.	SECTION	COUNTY	TOTAL	SHEET NO.
	S	TANDARD D	ETAILS		360	08-00377-00-CH	KANE	40	35
							CONTRACT	NO.	63744
SCALE:	SHEET NO.	OF SHEETS	STA.	TO STA.		ILLINOIS FED.	AID PROJECT		

