08-01-2025 LETTING ITEM 063

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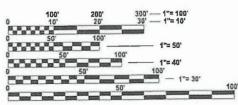
FOR INDEX OF SHEETS, SEE SHEET NO. 2 FOR INDEX OF HIGHWAY STANDARDS, SEE SHEET NO. 2 STATE OF ILLINOIS DEPARTMENT OF TRANSPORTATION

PROPOSED HIGHWAY PLANS

F.A.P. ROUTE VARIOUS SECTION 22-00182-01-TL PROJECT IVXF(925) TRAFFIC SIGNAL IMPROVEMENTS AT SIX INTERSECTIONS DEKALB COUNTY

C-93-018-25






FULL SIZE PLANS HAVE BEEN PREPARED USING STANDARD ENGINEERING SCALES. REDUCED SIZED PLANS WILL NOT CONFORM TO STANDARD SCALES. IN MAKING MEASUREMENTS ON REDUCED PLANS, THE ABOVE SCALES MAY BE USED.

J.U.L.I.E. JOINT UTILITY LOCATION INFORMATION FOR EXCAVATION 1-800-892-0123 OR 811

CONTRACT NO. 87864

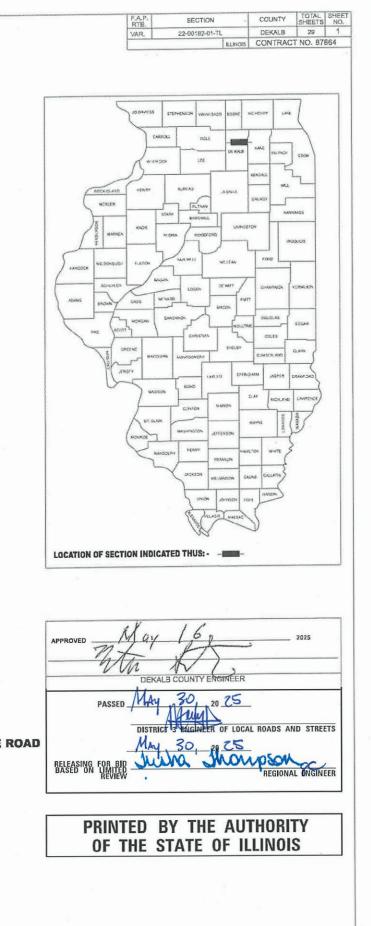

INDEX OF SHEETS

- 1 COVER SHEET
- 2 INDEX OF SHEETS, LISTING OF APPLICABLE STANDARDS, GENERAL NOTES
- 3 SIGNAGE DETAILS
- 4-8 SUMMARY OF QUANTITIES
- 9-10 ADA GRADING DETAILS
- 11-12 TRAFFIC SIGNAL PLANS IL ROUTE 64 (STATE STREET) AT SACRAMENTO STREET 13-14 TRAFFIC SIGNAL PLANS - IL ROUTE 64 & 23 (STATE STREET) AT CALIFORNIA STREF
- 13-14 TRAFFIC SIGNAL PLANS IL ROUTE 64 & 23 (STATE STREET) AT CALIFORNIA STREET 15-16 TRAFFIC SIGNAL PLANS - IL ROUTE 64 & 23 (STATE STREET) AT SOMONUAK STREET
- 15-16 TRAFFIC SIGNAL PLANS IL ROUTE 64 & 23 (STATE STREET) AT SOMONUAR STREET 17-18 TRAFFIC SIGNAL PLANS - IL ROUTE 23 (MAIN STREET) AT IL ROUTE 64 (STATE STREET)
- 19-21 TRAFFIC SIGNAL PLANS IL ROUTE 23 (MAIN STREET) AT IL ROUTE 64 (ST 19-21 TRAFFIC SIGNAL PLANS - PEACE ROAD AT BARBER GREENE ROAD
- 22-24 TRAFFIC SIGNAL PLANS ANNIE GLIDDEN ROAD AT DRESSER ROAD
- 25-27 IDOT DISTRICT THREE DETAILS
- 28-29 ADDITIONAL DETAILS

HIGHWAY STANDARDS

- 000001-08 STANDARD SYMBOLS, ABBREVIATIONS AND PATTERNS
- 424001-12 PERPENDICULAR CURB RAMPS FOR SIDEWALKS
- 424011-05 CORNER PARALLEL CURB RAMPS FOR SIDEWALKS
- 606001-08 CONCRETE CURB TYPE B AND COMBINATION CONCRETE CURB AND GUTTER
- 701006-05 OFF-RD OPERATIONS, 2L, 2W, 15' (4.5M) TO 24" (600MM) FROM PAVEMENT EDGE
- 701301-04 LANE CLOSURE, 2L, 2W, SHORT TIME OPERATIONS
- 701421-08
 LANE CLOSURE, MULTILANE, DAY OPERATIONS ONLY, FOR SPEEDS > 45 MPH TO 55 MPH

 701701-10
 URBAN LANE CLOSURE, MULTILANE INTERSECTION
- 701701-10 ORBAN LANE CLOSORE, MOLTILANE INTERSECTI 701801-06 SIDEWALK, CORNER OR CROSSWALK CLOSURE
- 701901-00 SIDEWALK, CONNER OR CROS
- 720001-01 SIGN PANEL MOUNTING DETAILS
- 720016-04 MAST ARM MOUNTED STREET NAME SIGNS
- 780001-05 TYPICAL PAVEMENT MARKINGS
- 814001-03 HANDHOLES
- 814006-03 DOUBLE HANDHOLES
- 857001-01 STANDARD PHASE DESIGNATION DIAGRAMS AND PHASE SEQUENCES
- 862001-01 UNINTERRUPTABLE POWER SUPPLY (UPS)
- 873001-02 TRAFFIC SIGNAL GROUNDING AND BONDING
- 876001-04 PEDESTRIAN PUSH BUTTON POST
- 878001-11 CONCRETE FOUNDATION DETAILS
- 880006-01 TRAFFIC SIGNAL MOUNTING DETAILS

DISTRICT DETAILS

- 606-4 REINFORCEMENT DETAIL FOR COMBINATION CURB AND GUTTER
- 720-8 TEMPORARY INFORMATION SIGNING
- 780-10 URBAN PAVEMENT MARKING
- 780-3 TYPICAL SPACING DETAIL FOR CROSSWALKS AND STOP BARS
- 888-1 ACCESSIBLE PEDESTRAIN SIGNALS

GENERAL NOTES

1. EXCEPT AS NOTED ON THE PLANS, PAVEMENT GRADES SHOWN ARE AT THE TOP OF PAVEMENT SURFACES.

2. ALL EXCAVATED MATERIAL WITHIN THE IDOT RIGHT OF WAY, WHICH INCLUDES DIGGING OR GRADING OF ANY SOIL OR FILL MATERIAL, WITH THE EXCEPTION OF AGGREGATE FILLS, MUST BE INCORPORATED WITHIN THE IDOT RIGHT OF WAY.

3. THE FINISHED EARTHWORK SHALL HAVE A VEGETATION SUSTAINING SOIL COVERING THE TOP FOUR INCHES (100 MILLIMETERS) IN AREAS TO BE SEEDED OR SODDED. THE VEGETATION SUSTAINING SOIL REQUIRED WILL NOT BE PAID FOR SEPERATELY BUT WILL BE INCLUDED IN THE COST OF "PORTLAND CEMENT CONCRETE SIDEWALK 5 INCH".

4. THE CONTRACTOR'S ATTENTION IS DIRECTED TO THE PRESENCE OF DEPARTMENT-OWNED UNDERGROUND ELECTRICAL CABLE WITHIN THE LIMITS OF THE PROPOSED IMPROVEMENT. THE CONTRACTOR SHALL REQUEST THE ILLINOIS DEPARTMENT OF TRANSPORTATION IN OTTAWA (815-434-8417) TO LOCATE THE UNDERGROUND FACILITIES, PROVIDING A MINIMUM OF 72 HOURS NOTICE. THE DEPARTMENT IS NOT A MEMBER OF THE JOINT UTILITY LOCATING INFORMATION FOR EXCAVATORS (JULIE) SYSTEM.

5. ALL DAMAGE TO DEPARTMENT OWNED UNDERGROUND FACILITIES, CAUSED BY THE CONTRACTOR SHALL BE REPAIRED TO THE SATISFACTION OF THE ENGINEER AND AT NO EXPENSE TO THE DEPARTMENT. THIS SHALL INCLUDE ALL TEMPORARY REPAIRS REQUIRED TO KEEP THE FACILITY OPERATIONAL WHILE MATERIAL IS BEING OBTAINED TO MAKE PERMANENT REPAIRS. SPLICING OF ELECTRIC CABLE WILL NOT BE ALLOWED. ELECTRIC CABLE SHALL BE REPLACED FROM POLE TO POLE OR CONTROLLER.

6. THE TRAFFIC SECTION AT THE ILLNOIS DEPARTMENT OF TRANSPORTATION, DISTRICT 3, SHALL BE NOTIFIED AT 815-434-5806 AT LEAST 72 HOURS PRIOR TO TURNING ON ANY FLASHER OR CONTROLLER UNITS.

7. THE CONTRACTOR SHALL BE RESPONSIBLE FOR PROTECTING UTILITY PROPERTY DURING CONSTRUCTION OPEATIONS AS OUTLINED IN ARTICLE 107.31 OF THE STANDARD SPECIFICATIONS, A MINIMUM OF 48 HOURS ADAVANCE NOTICE IS REQUIRED FOR NON-EMERGENCY WORK. THE JULIE NUMBER IS 800-892-0123. THE MEMBERS OF JULIE WITHIN THE LIMITS OF IMPROVEMENTS ARE:

COMED	DNA COMMUNICATIONS
KISHWAUKEE WATER RECLAMATION	NICOR GAS
WINDSTREAM KDL / McLEOD USA	

8. ALL TRAFFIC SIGNAL HEADS SHALL BE 12-INCH POLYCARBONATE.

9. A 1/4" DIAMETER CONTINUOUS RODENT RESISTENT NYLON ROPE SHALL BE FURNISHED AND LEFT IN THE PLACE IN ALL CONDUITS BETWEEN HANDHOLES AND FOUNDATIONS OR CONTROLLER. THIS COST SHALL BE INCLUDED WITH THE COST OF THE CONDUIT PAY ITEM.

10. THE CONTRACTOR SHALL ARRANGE FOR A FACTORY OR SUPPLIER REPRESENTATIVE TO BE PRESENT AT THE INTERSECTIONS WHEN THE SIGNAL IS TURNED ON. COST TO BE INCLUDED WITH THE TRAFFIC SIGNAL CONTROLLER PAY ITEM.

11. NO ADDITIONAL COMPENSATION WILL BE ALLOWED FOR PLACING CONDUIT ATA GREAT THAN 2' MINIMUM DEPTH TO AVOID OBSTUCLES SUCH AS UNDEGROUND UTILITIES.

12. THE ELECTRICAL CONDUCTORS FOR ALL TRAFFIC SIGNAL HEADS SHALL BE SOLID, SOFT COPPER.

13. ALL THREADS OF BOLTS USED IN THE ASSEMBLY OF THE TRAFFIC SIGNAL COMPONENTS SHALL BE COATED WITH A NON-LEAD BASED ANIT-SEIZE COMPOUND, SIMILAR TO LEAD PLATE, PRIOR TO ASSEMBLY.

14. ALL HARDWARE SHALL BE TIGHTENED AND WELL SECURED, CABLES SHALL BE NEATLY WOUND IN HANDHOLES, CABLES SHALL BE NEATLY TRAINED IN THE CONTROLLER CABINET.

15. ALL TRAFFIC SIGNAL WIRING SHALL EXTEND FROM CONTROLLER TO SIGNAL. SPLICES IN JUNCTION BOXES WILL NOT BE ALLOWED.

16. ALL GROUNDING MATERIALS FOR CONCRETE FOUNDATIONS SHALL REFER TO SECTION 807 OF THE STANDARD SPECIFICATIONS.


17. ALL VEHICLE AND PEDESTRIAN SIGNAL HEDS SHALL HAVE POLYCARBONATE BLACK HOUSING AND STEEL OR ALUMINUM BRACKETS.

I Notes and Details-1 [Sheet] ORD_Projects\6085.900 Dekalt

	USER NAME = zwallsten	DESIGNED - RJH	REVISED -		INDEX	OF SHEET	S, LIST C)F APPL	ICABLE S	STANDARDS, AND	F.A.P. RTE	SECTION	COUNTY	TOTAL SHEET SHEETS NO.
GEWALT HAMILTON Associates, inc.		DRAWN - AMK	REVISED -		GEN	ERAL NOT	ÉS - TR	AFFIC S	IGNAL IM	IPROVEMENTS	VAR.	22-00182-01-TL	DEKALB	29 2
A SSOCIATES, INC.	PLOT SCALE = 0.16666633 '/In. PLOT DATE = 5/16/2025	CHECKED - RJH DATE - 05.16.2025	REVISED -	DEPARTMENT OF TRANSPORTATION	SCALE: N.T.S.	SHEET 1	OF 1	SHEETS	S STA.	TO STA.				T NO. 87864
												ILLINGIO I LD. A	DIROLOI	

HMA MIXTURE REQUIREMENT TABLE

LOCATIONS:	ENTIRE PROJECT
MIXTURE USE(S):	HMA INCIDENTAL
BINDER GRADE (PG):	PG 64-22
DESIGN AIR VOIDS:	4% @ N50
MIXTURE COMPOSITION (MIXTURE GRADATION)	IL 9.5
FRICTION AGGREGATE:	MIXTURE C
MIXTURE WEIGHT:	112.0 LBS/SY/IN
QUALITY MANAGEMENT PROGRAM:	QCQA
SUBLOT SIZE:	NA
DENSITY TEST METHOD:	SATISFACTION OF ENGINEER
MATERIAL TRANSFER DEVICE (REQUIRED)	NO

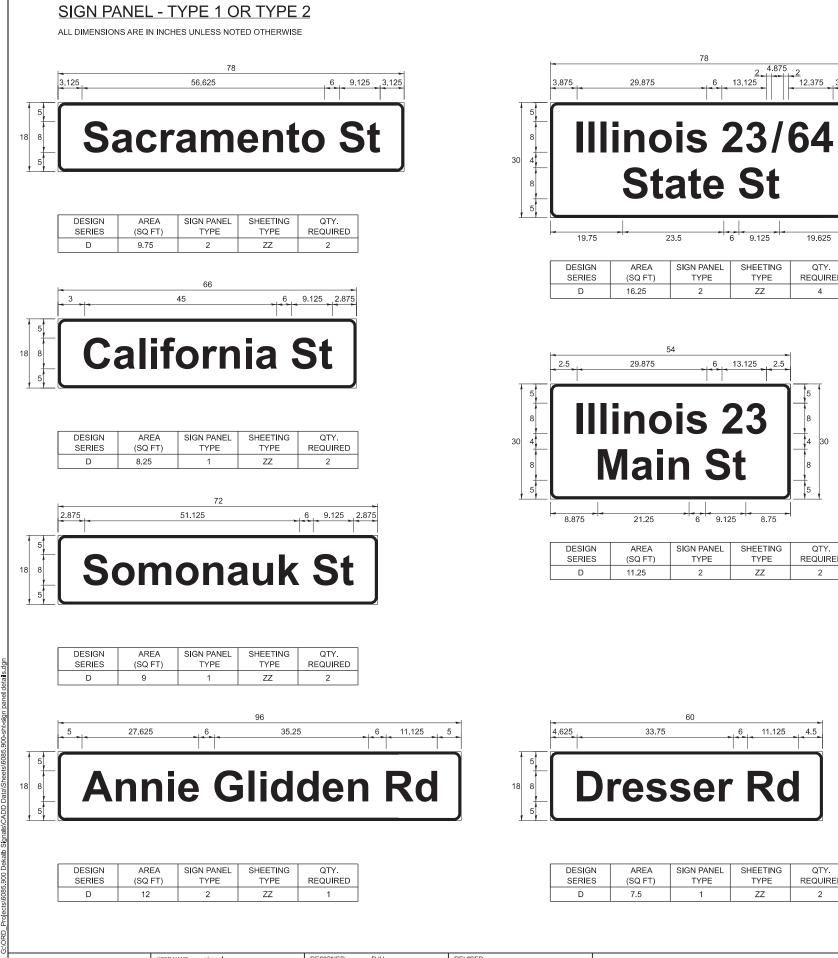

LOCATIONTYPE	SIZE	QUANTITY	REMOVE SIGN PANEL	SIGN PANEL TYPE 1	SIGN PANEL TYPE 2
	INCHES	EACH	EACH	SQ FT	SQ FT
ILLINOIS 23 / 64 (STATE S	STREET) AT	SACRAME	NTO STREET		
NORTHBOUND MAST ARM					
ILLINOIS 23 / 64 STATE STREET - STREET NAME SIGN	78 X 30	1			16.25
STATE STREET EXISTING STREET NAME SIGN			1		
WESTBOUND MAST ARM SACRAMENTO STREET - STREET NAME SIGN	78 X 18	1			9.75
SACRAMENTO STREET EXISTING STREET NAME SIGN	70 / 10	1	1		5.75
SOUTHBOUND MAST ARM					
ILLINOIS 23 / 64 STATE STREET - STREET NAME SIGN	78 X 30	1			16.25
STATE STREET EXISTING STREET NAME SIGN			1		
EASTBOUND MAST ARM					
SACRAMENTO STREET - STREET NAME SIGN	78 X 18	1			9.75
SACRAMENTO STREET EXISTING STREET NAME SIGN	10/(10		1		0.10
ILLINOIS 23 / 64 (STATE	STREET) A	TCALIFOR	NIA STREET		
	00.1/ 40				
CALIFORNIA STREET - STREET NAME SIGN CALIFORNIA STREET EXISTING STREET NAME SIGN	66 X 18	1	1	8.25	
CALIFORNIA STREET EXISTING STREET NAME SIGN			1		
EASTBOUND MAST ARM					
CALIFORNIA STREET - STREET NAME SIGN	66 X 18	1		8.25	
CALIFORNIA STREET EXISTING STREET NAME SIGN			1		
		TCOMONIA			
ILLINOIS 23 / 64 (STATE WESTBOUND MAST ARM	SIREEI)A	I SOMONA	UKSIREEI		
SOMONAUK STREET - STREET NAME SIGN	72 X 18	1		9	
SOMONAUK STREET EXISTING STREET NAME SIGN			1	-	
	70.1/ 40				
SOMONAUK STREET - STREET NAME SIGN SOMONAUK STREET EXISTING STREET NAME SIGN	72 X 18	1	1	9	
SOMONAUR STREET EXISTING STREET NAME SIGN			1		
ILLINOIS 23 / 64 (STATE S	TREET) AT	Illinois 23 (N	IAIN STREET)		1
NORTHBOUND MAST ARM					
ILLINOIS 23 / 64 STATE STREET - STREET NAME SIGN	78 X 30	1			16.25
STATE STREET EXISTING STREET NAME SIGN	00 X 00		1	7 -	
LEFT TURN YIELD ON GREEN (R10-12)	30 X 36	1		7.5	
NORTHWEST QUADRANT POST					
LEFT TURN YIELD ON GREEN (R10-12)	30 X 36	1		7.5	
WESTBOUND MAST ARM					
	54 X 30	1	4		11.25
MAIN STREET EXISTING STREET NAME SIGN			1		
SOUTHBOUND MAST ARM					
ILLINOIS 23 / 64 STATE STREET - STREET NAME SIGN	78 X 30	1			16.25
STATE STREET EXISTING STREET NAME SIGN			1		
EASTBOUND MAST ARM ILLINOIS 23 MAIN STREET - STREET NAME SIGN	54 X 30	1			11.25
MAIN STREET EXISTING STREET NAME SIGN	J + A 30	1	1		11.20
ANNIE GLIDDEN	ROAD AT	DRESSER R	OAD		
DRESSER ROAD - STREET NAME SIGN	60 X 18	1		7.5	
WESTBOUND MAST ARM					
	06 V 49	1			12
ANNIE GLIDDEN ROAD - STREET NAME SIGN	96 X 18				
ANNIE GLIDDEN ROAD - STREET NAME SIGN	96 X 18				
ANNIE GLIDDEN ROAD - STREET NAME SIGN SOUTHBOUND MAST ARM DRESSER ROAD - STREET NAME SIGN	90 X 18	1		7.5	

PLOT SCALE = 0.166666633'/In. CHECKED R.H. REVISED DEPARTMENT OF TRANSPORTATION TRAFFIC SIGNAL IMPROVEMENTS. PLOT DATE = 5/15/2025 DATE 05.16.2025 REVISED SCALE: N.T.S. SHEET 1 OF 1 SHEETS	USER NAME = akopel	DESIGNED - <u>RJH</u> DRAWN - <u>AMK</u>	REVISED	STATE OF ILLINOIS	TRAFE			GE DETA
PLOT DATE = 5/15/2025 DATE - 05.16.2025 REVISED	PLOT SCALE = 0.16666633 ' / In.		REVISED _	DEPARTMENT OF TRANSPORTATION	IKAFF	IC SIGNAL I	MPROVI	IMENIS
	PLOT DATE = 5/15/2025	DATE _ 05.16.2025	REVISED -		SCALE: <u>N.T.S</u> .	SHEET 1	OF <u>1</u>	SHEETS

78

State St

SIGN PANEL

TYPE

2

23.5

Main St

6 9.125

SIGN PANEL

TYPE

2

60

SIGN PANEL

TYPE

1

33.75

AREA

(SQ FT)

7.5

8.75

SHEETING

TYPE

ZZ

6 11.125 4.5

SHEETING

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QTY.

REQUIRED

2

ARFA

(SQ FT)

29.875

21.25

AREA

(SQ FT)

11.25

16.25

6 9.125

SHEETING

TYPE

ZZ

6 13.125 2.5

29.875

<u>2</u> 4.875 <u>2</u> 13.125 <u>12.375 3.875</u>

19 625

QTY.

REQUIRED

4

QTY.

REQUIRED

2

TAILS	F.A. <u>P</u> . RTE	SECT	COUNTY	TOTAL SHEETS	SHEET NO.		
TS - VARIOUS LOCATIONS	VAR.	22-0018	22-00182-01-TL			<u>2</u> 9	_3
TS - VARIOUS LOCATIONS					CONTRACT	NO. <u>878</u>	364
S STA TO STA			ILLINOIS	FED. AI	PROJECT		
	•	•					

		SUMMARY OF QUANTITIES			IL ROUTE 23-64 (STATE STREET) AT SACRAMENTO STREET	IL ROUTE 23-64 (STATE STREET) AT CALIFORNIA STREET	IL ROUTE 23-64 (STATE STREET) AT SOMONAUK STREET	IL. ROUTE 64 (STATE STREET) AT IL ROUTE 23 (MAIN STREET)	PEACE ROAD AT BARBER GREENE ROAD	ANNIE GLIDDEN ROAD AT DRESSER ROAD
*	CODE NO.	ITEM	UNIT	TOTAL QUANTITY				<u>[</u>		
*	28000510	INLET FILTERS	EACH	1						1
*	35101600	AGGREGATE BASE COURSE, TYPE B 4"								
-	33101600	AGGREGATE BASE COURSE, TYPE B 4	SQ YD	63						63
*	40800050	INCIDENTAL HOT-MIX ASPHALT SURFACING	TON	1						1
*	42400200	PORTLAND CEMENT CONCRETE SIDEWALK 5 INCH	SQ FT	440						
	42400200		SQP1	412						412
*	42400800	DETECTABLE WARNINGS	SQ FT	44						44
*	44000100	PAVEMENT REMOVAL	SQYD	12						42
			3010	12						12
*	44000500	COMBINATION CURB AND GUTTER REMOVAL	FOOT	59	······································					59
*	44000600	SIDEWALK REMOVAL	SQ FT	393			******			393
*	60603900	COMBINATION CONCRETE CURB AND GUTTER, TYPE B-6.12 (ABUTTING EXISTING PAVEMENT)	FOOT	59						59
*	66900200	NON-SPECIAL WASTE DISPOSAL	CU YD	1				1		
*	66900530	SOIL DISPOSAL ANALYSIS	EACH	1				1		
*	66901001	REGULATED SUBSTANCES PRE-COSTRUCTION PLAN	LSUM	1				1		
*	66901003	REGULATED SUBSTANCES FINAL CONSTRUCTION REPORT	LSUM	1				1		
*	66901006	REGULATED SUBSTANCES MONITORING	CAL DA	1				1		
	67100100	MOBILIZATION	LSUM	1				*****		
	70100310	TRAFFIC CONTROL AND PROTECTION, STANDARD 701421	LSUM	1						
~	* SPECIALTY IT	ТЕМ								
	1 4 3 miles	USER NAME = skopel DESIGNED		STATE OF ILLIN		TRAFFIC SIG	SUMMARY OF QUANT NAL IMPROVEMENTS - V		F.A.P. SECTION RTE. VAR. 22-00182-01	

		SUMMARY OF QUANTITIES			IL ROUTE 23-64 (STATE STREET) AT SACRAMENTO STREET	IL ROUTE 23-64 (STATE STREET) AT CALIFORNIA STREET	IL ROUTE 23-64 (STATE STREET) AT SOMONAUK STREET	IL ROUTE 64 (STATE STREET) AT IL ROUTE 23 (MAIN STREET)	PEACE ROAD AT BARBER GREENE ROAD	ANNIE GLIDDEN ROAD AT DRESSER ROAD
*	CODE NO.	ITEM	UNIT	TOTAL QUANTITY						
	70102635	TRAFFIC CONTROL AND PROTECTION, STANDARD 701701	LSUM	1						-
	70102640	TRAFFIC CONTROL AND PROTECTION, STANDARD 701801	LSUM	1						
	72000100	SIGN PANEL - TYPE 1	SQ FT	64.5		16.5	18	15	· · · · · · · · · · · · · · · · · · ·	15
	72000200	SIGN PANEL - TYPE 2	SQ FT	119	52		······································	55	· · · · · · · · · · · · · · · · · · ·	12
	78000400	THERMOPLASTIC PAVEMENT MARKING - LINE 6"	FOOT	244						244
-	78300202	PAVEMENT MARKING REMOVAL - WATER BLASTING	SQ FT	65	12076-		·····			65
	81028200	UNDERGROUND CONDUIT, GALVANIZED STEEL, 2" DIA.	FOOT	216					216	****************
	81028240	UNDERGROUND CONDUIT, GALVANIZED STEEL, 4" DIA.	FOOT	10					10	
	81028350	UNDERGROUND CONDUIT, PVC, 2" DIA.	FOOT	36		****				36
	81028370	UNDERGROUND CONDUIT, PVC, 3" DIA.	FOOT	72	1		*********			72
	81400100	HANDHOLE	EACH	2					1	1
	81702110	ELECTRIC CABLE IN CONDUIT, 600V (XLP-TYPE USE) 1/C NO. 10	FOOT	404					404	
	85000200	MAINTENANCE OF EXISTING TRAFFIC SIGNAL INSTALLATION	EACH	6	1	1	1	1	1	1
	86200200	UNINTERRUPTABLE POWER SUPPLY, STANDARD	EACH	1				····	1	·····
	87301215	ELECTRIC CABLE IN CONDUIT, SIGNAL NO. 14 2C	FOOT	1,310					773	537
	87301225	ELECTRIC CABLE IN CONDUIT, SIGNAL NO. 14 3C	FOOT	1,613					1,056	557

* SPECIALTY ITEM

6035

SOQ-02 [Sheet] #E: GNORD Proj

	USER NAME = akopel	DESIGNED -	RJH	REVISED -		,	211	Idita ISV		
		DRAWN -	ZCW	REVISED -	STATE OF ILLINOIS			MMARY		ANTIT
	PLOT SCALE = 0,16866633*/ /n,	CHECKED -	RJH	REVISED -	DEPARTMENT OF TRANSPORTATION	TRAFFI	C SIGNAL I	MPROVI	EMENT	s - Vai
······	PLOT DATE = 5/15/2025	DATE -	05.16.2025	REVISED .		SCALE; N.T.S.	SHEET 2	OF 5	SHEETS	STA.

TITIES		FAP. RTE.	SECTION	COUNTY	TOTAL SHEETS	SHEET NO.	
VARIOUS LOCATIONS		VAR.	22-00182-01-TL	DEKALB	29	5	
			CONTRACT NO. 87864				
TA.	TO STA.		ILLINOIS FED. AI	DPROJECT			

		SUMMARY OF QUANTITIES			IL ROUTE 23-64 (STATE STREET) AT SACRAMENTO STREET	IL ROUTE 23-64 (STATE STREET) AT CALIFORNIA STREET	IL ROUTE 23-64 (STATE STREET) AT SOMONAUK STREET	IL ROUTE 64 (STATE STREET) AT IL ROUTE 23 (MAIN STREET)	PEACE ROAD AT BARBER GREENE ROAD	ANNIE GLIDDEI ROAD AT DRESSER ROAI
c	ODE NO.	ITEM	UNIT	TOTAL QUANTITY						
1	87301245	ELECTRIC CABLE IN CONDUIT, SIGNAL NO. 14 5C	FOOT	881					664	217
{{	87301255	ELECTRIC CABLE IN CONDUIT, SIGNAL NO. 14 7C	FOOT	3,331				1,095	2,236	
1	37301805	ELECTRIC CABLE IN CONDUIT, SERVICE, NO. 6 2 C	FOOT	544					544	
8	37301900	ELECTRIC CABLE IN CONDUIT, EQUIPMENT GROUNDING CONDUCTOR, NO. 6 1C	FOOT	682					550	132
	7500500									
8	37502500	TRAFFIC SIGNAL POST, GALVANIZED STEEL 16 FT.	EACH	1	-					1
8	37800100	CONCRETE FOUNDATION, TYPE A	FOOT	4						4
<u>ع</u>	37800150	CONCRETE FOUNDATION, TYPE C	FOOT	4					4	
3	37900200	DRILL EXISTING HANDHOLE	EACH	5					2	3
£	8040070	SIGNAL HEAD, POLYCARBONATE, LED, 1-FACE, 3-SECTION, BRACKET MOUNTED	EACH	1						1
	8040090	SIGNAL HEAD, POLYCARBONATE, LED, 1-FACE, 3-SECTION, MAST ARM MOUNTED	EACH	3		· · · · · · · · · · · · · · · · · · ·			3	********
8	8040150	SIGNAL HEAD, POLYCARBONATE, LED, 1-FACE, 5-SECTION, BRACKET MOUNTED	EACH	9				3	6	
8	8040160	SIGNAL HEAD, POLYCARBONATE, LED, 1-FACE, 5-SECTION, MAST ARM MOUNTED	EACH	11				3	8	
8	8102825	PEDESTRIAN SIGNAL HEAD, POLYCARBONATE, LED, 1-FACE, BRACKET MOUNTED WITH COUNT DOWN TIMER	EACH	8					4	4
8	8600100	DETECTOR LOOP, TYPE I	FOOT	108						108
8	9501410	RELOCATE EXISTING EMERGENCY VEHICLE PRIORITY SYSTEM, PHASING UNIT	EACH	2				1	1	
8	9502200	MODIFY EXISTING CONTROLLER	EACH	1				· · · · · · · · · · · · · · · · · · ·		1
					-		······			

MODEL: SOO-03 [She FILE NAME: GAORD

USER NAME = akopel	DESIGNED -	rjh	REVISED -			e111	MMADV		
	DRAWN -	ZCW	REVISED -	STATE OF ILLINOIS			MMARY		
PLOT SCALE = 0.16666633*/ In.	CHECKED -	RJH	REVISED -	DEPARTMENT OF TRANSPORTATION	TRAFF	IC SIGNAL II	MPROVE	IMENTS	AV - د
 PLOT DATE = 5/15/2025	DATE -	05.16.2025	REVISED -		SCALE: N.T.S.	SHEET 3	OF 5	SHEETS	STA.

TITIES	F.A.P. RTE	SECTION	COUNTY	TOTAL SHEETS	SHEET NO.
VARIOUS LOCATIONS	VAR,	22-00182-01-TL	DEKALB	29	6
VARIOUS LOCATIONS			CONTRACT	F NO. 87	364
STA. TO STA.			D PROJECT		

		SUMMARY OF QUANTITIES			IL ROUTE 23-64 (STATE STREET) AT SACRAMENTO STREET	IL ROUTE 23-64 (STATE STREET) AT CALIFORNIA STREET	IL ROUTE 23-64 (STATE STREET) AT SOMONAUK STREET
*	CODE NO.	ITEM	UNIT	TOTAL QUANTITY			
	89502300	REMOVE ELECTRICAL CABLE FROM CONDUIT	FOOT	7,933			
	89502350	REMOVE AND REINSTALL ELECTRIC CABLE FROM CONDUIT	FOOT	2,548	· · · · · · · · · · · · · · · · · · ·		
	89502375	REMOVE EXISTING TRAFFIC SIGNAL EQUIPMENT	EACH	2			
	89502380	REMOVE EXISTING HANDHOLE	EACH	1			· · · · · · · · · · · · · · · · · · ·
	89502385	REMOVE EXISTING CONCRETE FOUNDATION	EACH	2			
	X0320050	CONSTRUCTION LAYOUT (SPECIAL)	LSUM	1			
	X0324085	EMERGENCY VEHICLE PRIORITY SYSTEM LINE SENSOR CABLE, NO. 20 3/C	FOOT	262			
	X1400367	PEDESTRIAN SIGNAL POST, 10 FT.	EACH	1			· · · · · · · · · · · · · · · · · · ·
	X1400378	PEDESTRIAN SIGNAL POST, 5 FT.	EACH	2			······
	X1400437	GPS CLOCK SYNC UNIT	EACH	4	1	1	11
	X7200061	TEMPORARY INFORMATION SIGNING	SQFT	77			
_	X7240195	REMOVE EXISTING SIGN PANEL	EACH	8	4	2	2
	X8100863	INTERCEPT EXISTING CONDUIT	EACH	2			
	X8570226	FULL-ACTUATED CONTROLLER AND TYPE IV CABINET (SPECIAL)	EACH	1		· · · · · · · · · · · · · · · · · · ·	
	X8570235	FULL-ACTUATED CONTROLLER AND TYPE SUPER R CABINET (SPECIAL)	EACH	1	1		
_	X8760200	ACCESSIBLE PEDESTRIAN SIGNALS	EACH	8			

* SPECIALTY ITEM

10DEL: SOC-04 [Sheet] ILE NAME: G:10RD Proje

USER NAME = mvasak	DESIGNED -	RJH	REVISED -			14		07 011	
	DRAWN -	ZCW	REVISED -	STATE OF ILLINOIS			JMMARY		
PLOT SCALE = 0.18866633 '/ kt.	CHECKED -	rjh	REVISED -	DEPARTMENT OF TRANSPORTATION	TRAFF	IC SIGNAL	IMPROV	EMENT	3 - VAR
PLOT DATE = 5/20/2025	DATE -	05.20.2025	REVISED -		SCALE: N.T.S.	SHEET 4	OF 5	SHEETS	STA.

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IL ROUTE 64 (STATE STREET) AT IL ROUTE 23 (MAIN STREET)	PEACE ROAD AT BARBER GREENE ROAD	ANNIE GLIDDEN ROAD AT DRESSER ROAD
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TITIES	}	FAP. RTE.	SECTION	COUNTY	TOTAL SHEETS	SHEET NO.		
VADIO	US LOCATIONS	VAR.	22-00182-01-TL	DEKALB	29	7		
VANIO	US LUCATIONS		CONTRACT NO. 87864					
TA.	TO STA.		ILLINOIS FED. AI	DPROJECT				


		SUMMARY OF QUANTITIES		IL ROUTE 23-64 (STATE STREET) AT SACRAMENTO STREET	IL ROUTE 23-64 (STATE STREET) AT T CALIFORNIA STREET	IL ROUTE 23-64 (STATE STREET) AT SOMONAUK STREET	IL ROUTE 64 (STATE STREET) AT IL ROUTE 23 (MAIN STREET)	PEACE ROAD AT BARBER GREENE ROAD	ANNIE GLIDDEN ROAD AT DRESSER ROAD	
*	CODE NO.	ITEM	UNIT	TOTAL QUANTITY						
	X8780012	CONCRETE FOUNDATION, TYPE A 12-INCH DIAMETER	FOOT	12					4	8
	X8780402	MODIFY EXISTING TYPE "D" FOUNDATION	EACH	1				1		Viiiiiiiiiiiiiiiiiiiiiiiiiiiiiiiiiiiii
	X8820014	TRAFFIC SIGNAL BACKPLATE, LOUVERED, FORMED PLASTIC, SPECIAL	EACH	34	-			17	17	
,	X8860100		EACH	1						1
	X8891001	VIDEO VEHICLE DETECTION SYSTEM	EACH	4	1	1	1	1		
	X8891301	VIDEO AND RADAR HYBRID DETECTION SYSTEM	EACH	1					1	
	20073509	PERMANENT TRAFFIC SIGNAL TIMING	EACH	2			· · · · · · · · · · · · · · · · · · ·	1		1
-	XX005800	RELOCATE EXISTING UPS BATTERY BACK-UP SYSTEM	EACH	1				1		

* SPECIALTY ITEM


NODEL: SOQ-05 [Sheet] FLE NAME: 0:0RD Proje


USER NAME = zwallsten	DESIGNED - DRAWN -	RJH 2CW	REVISED - REVISED -	STATE OF ILLINOIS			MMARY		
PLOT SCALE = 0.18666633 */ In.	CHECKED -	RJH	REVISED -	DEPARTMENT OF TRANSPORTATION	TRAFF	IC SIGNAL I	IMPROV	EMENT	S - VA
PLOT DATE = 6/9/2025	DATE -	05.20.2025	REVISED -		SCALE: N.T.S.	SHEET 5	OF 5	SHEETS	STA

TITIES		FAP. RTE.	SECTION	COUNTY	TOTAL SHEETS	SHEET NO.
VARIOUS L	OCATIONS	VAR.	22-00182-01-TL	DEKALB	29	8
VARIOUS L	JUNIO			CONTRACT	NO. 878	364
STA.	TO STA.		ILUNOIS FED. AI	OPROJECT		

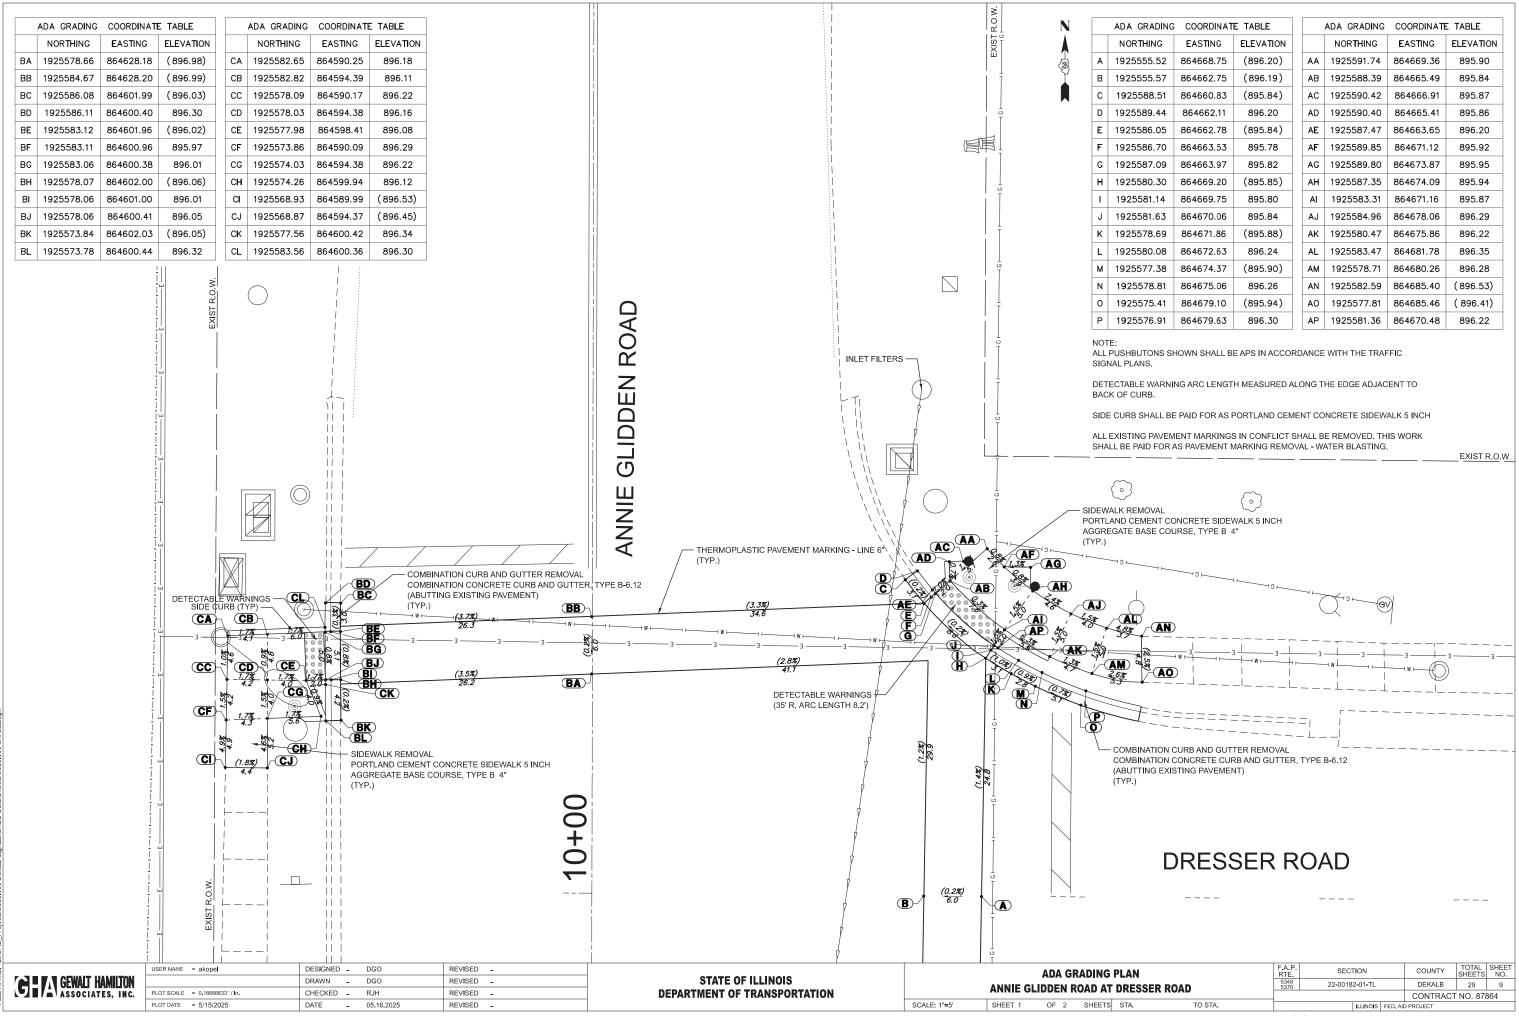

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NORTHING	EASTING	ELEVATION			NORTHING	EASTING	ELEVATIO
1925555.52	864668.75	(896.20)	1	AA	1925591.74	864669.36	895.90
1925555.57	864662.75	(896.19)		AB	1925588.39	864665.49	895.84
1925588.51	864660.83	(895.84)		AC	1925590.42	864666.91	895.87
1925589.44	864662.11	896.20		AD	1925590.40	864665.41	895.86
1925586.05	864662.78	(895.84)	1	AE	1925587.47	864663.65	896.20
1925586.70	864663.53	895.78		AF	1925589.85	864671.12	895.92
1925587.09	864663.97	895.82	1	AG	1925589.80	864673.87	895.95
1925580.30	864669.20	(895.85)		AH	1925587.35	864674.09	895.94
1925581.14	864669.75	895.80		AI	1925583.31	864671.16	895.87
1925581.63	864670.06	895.84	1	AJ	1925584.96	864678.06	896.29
1925578.69	864671.86	(895.88)		AK	1925580.47	864675.86	896.22
1925580.08	864672.63	896.24	1	AL	1925583.47	864681.78	896.35
1925577.38	864674.37	(895.90)	1	АМ	1925578.71	864680.26	896.28
1925578.81	864675.06	896.26	1	AN	1925582.59	864685.40	(896.53)
1925575.41	864679.10	(895.94)	1	AO	1925577.81	864685.46	(896.41)
1925576.91	864679.63	896.30	1	AP	1925581.36	864670.48	896.22

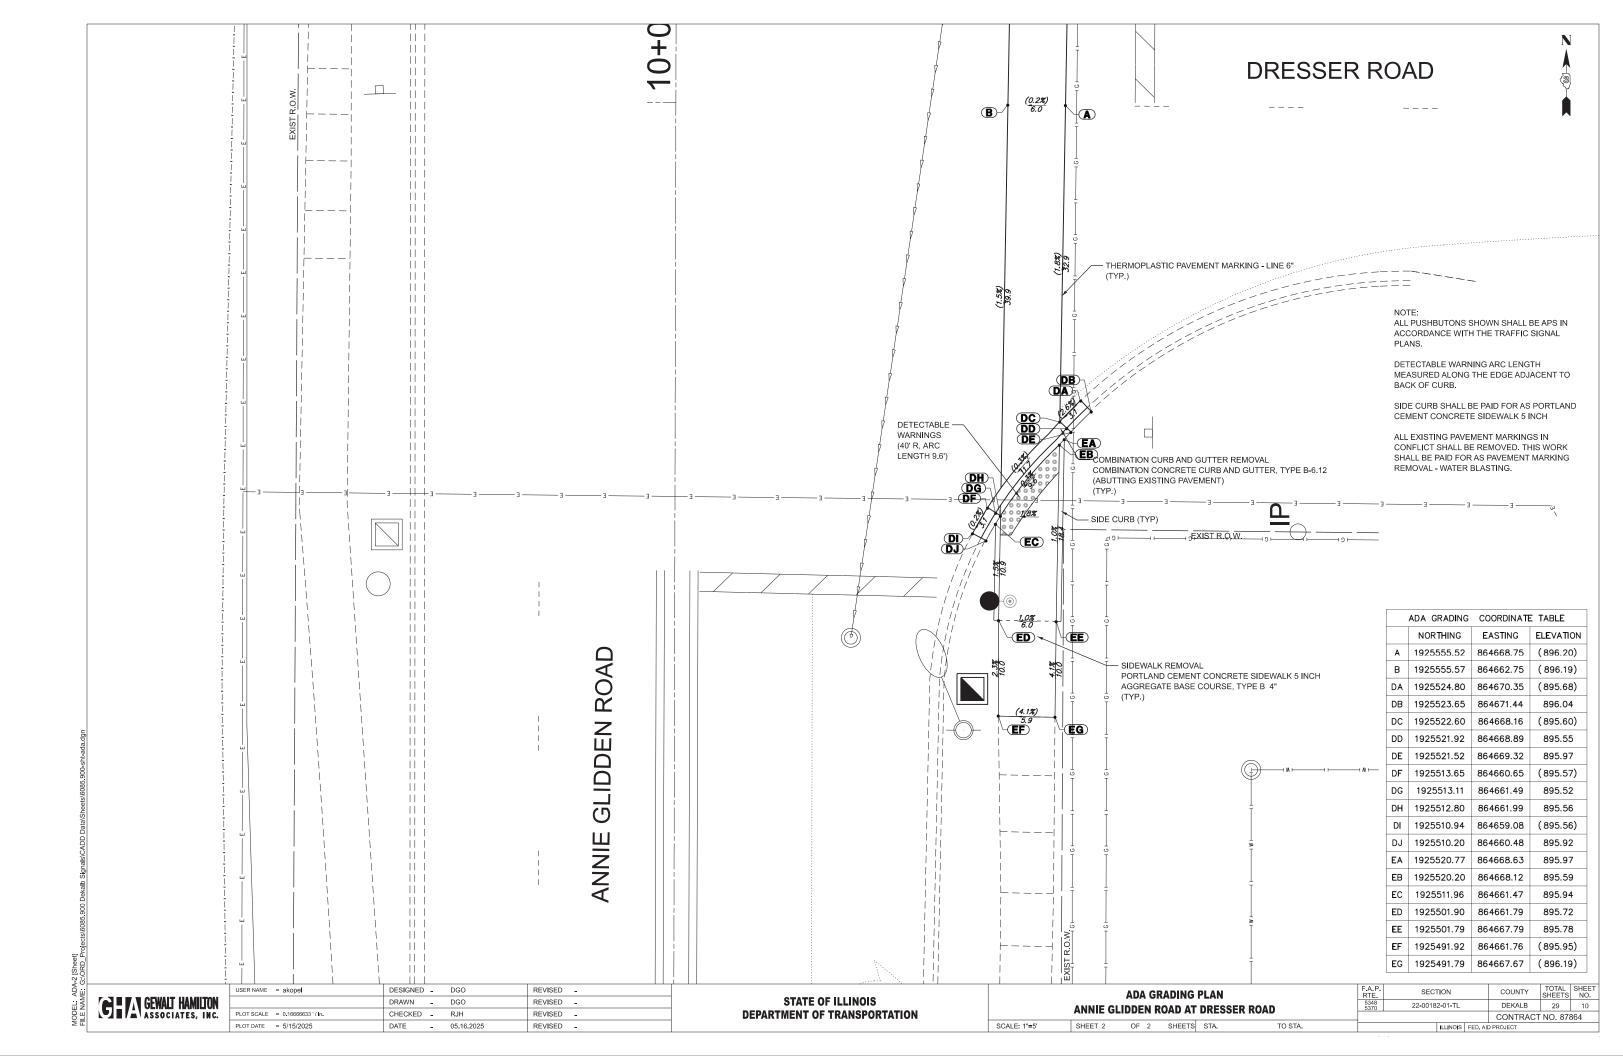

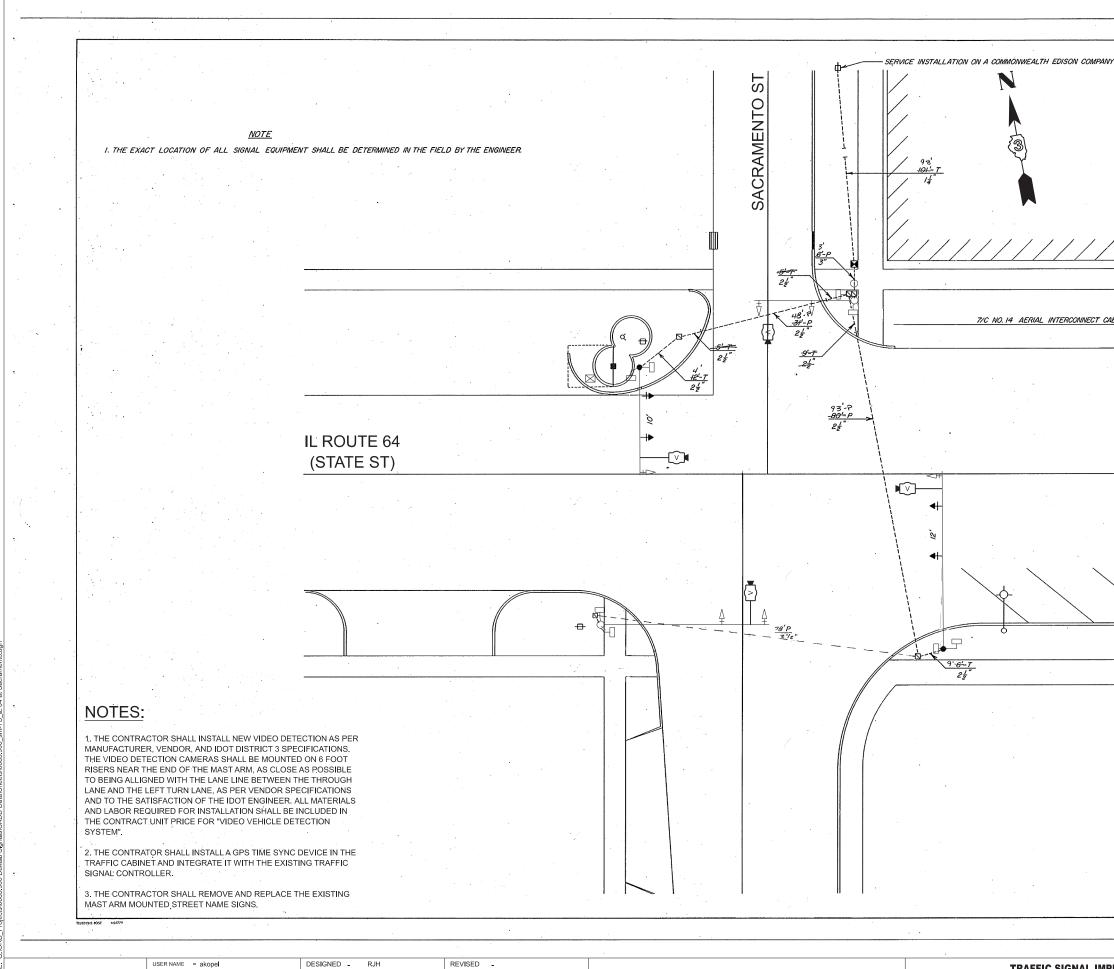

GERAGEWALT HAMILTON ASSOCIATES, INC.

PLOT SCALE = 0.16666633 '/ In.

PLOT DATE = 5/15/2025

DRAWN - AMK

CHECKED - RJH

DATE

- 05.16.2025

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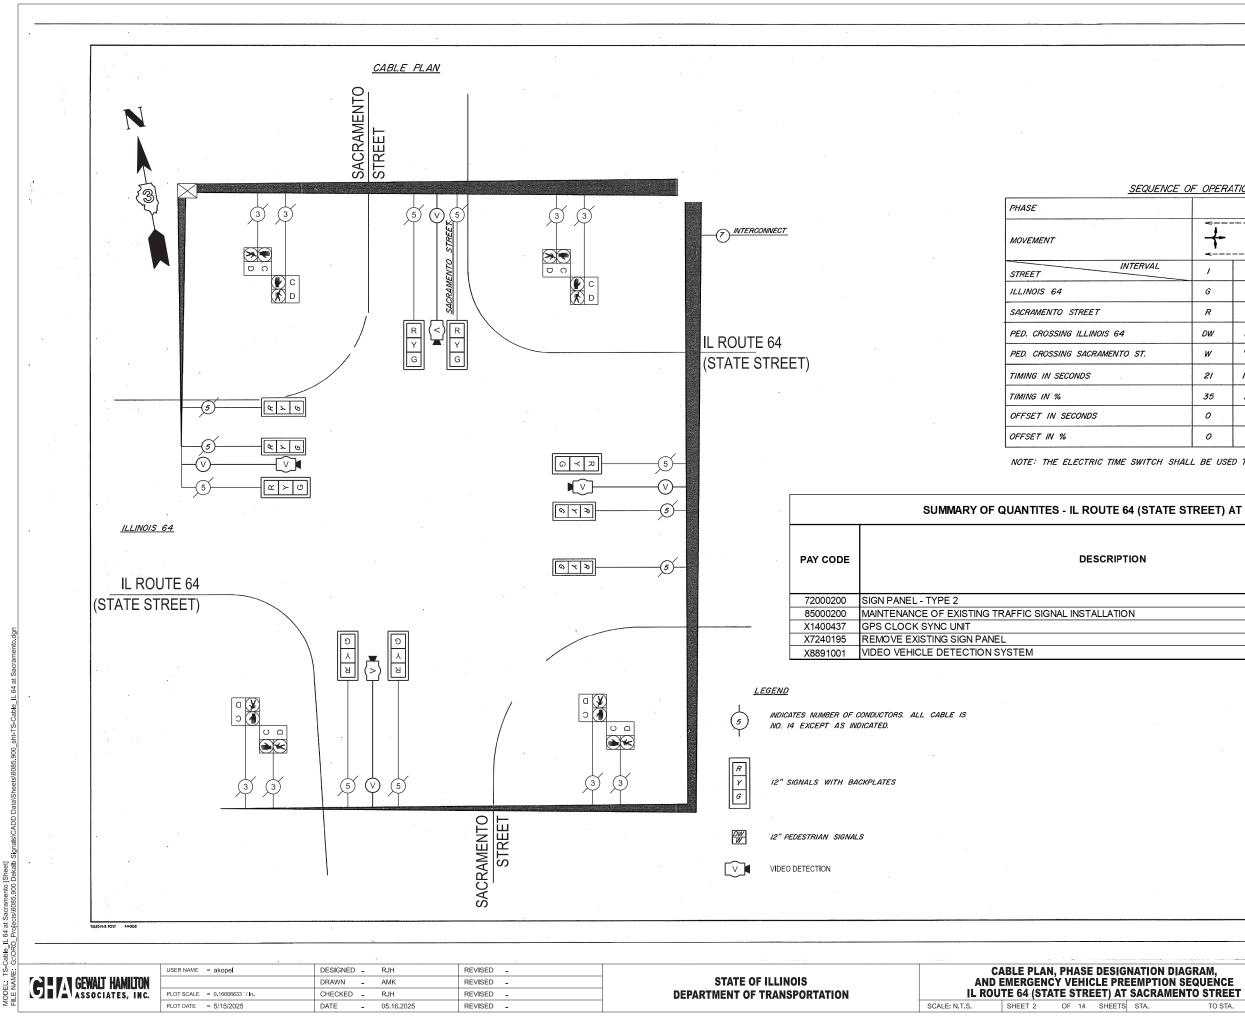
TRAFFIC SIGNAL IM STATE OF ILLINOIS IL ROUTE 64 (STATE STREET) AT SACRAMENTO STREET DEPARTMENT OF TRANSPORTATION SCALE: N.T.S.

SHEET 1 OF 14 SHEETS STA.

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POLE			ROUTE NO.	SEC.	~~~~~~~~~~~~~~~~~~~~~~~~~~~~~~~~~~~~~~~	WITY	TOT	AL SH	EET NO.		
			FA 17	18CS- TS		ALB					
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	● ▶		SIGNAL	HEAD	AND	POST	WITH	BACKF	LATE		
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<u> </u>			HANDHO	DLE							
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	A.T.S.	477	CHED TO	0 070							
•	<i>н.т.з.</i>	ALIA	CHED TO	5/160	CIURE			. •			
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			CHECI					CALE /	" = 10'		
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ROVEMENTS		F.A.P. RTE.		SECTIO	ON		COL	JNTY	TOT/ SHEE		SHE

TO STA.

CONTRACT NO. 87864 ILLINOIS FED AID PROJECT



ROUTE NO.	SEC.	COL	YTN	TOTAL SHEETS	SHEET NO.
FA 17	18CS - TS	DEK	ALB		
FED. ROAD	DIST. NO. 7	ILLINOIS	PROJECT		

SEQUENCE (OF OPER.	<u>ATION</u>					
		A			В	•	
	+		+	A V	-++-	A I V	FLASH
INTERVAL	1	2	3	4	5	6	
	G	G	Y	R	R	R	Y
	R	R	IR	G	G	Y	R
4	DW	DW	DW	W	FLA. DW	DW	DARK
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×	21	16.8	3.0	7.2	9.0	3.0	60
	35	28	5	12	15	5	100
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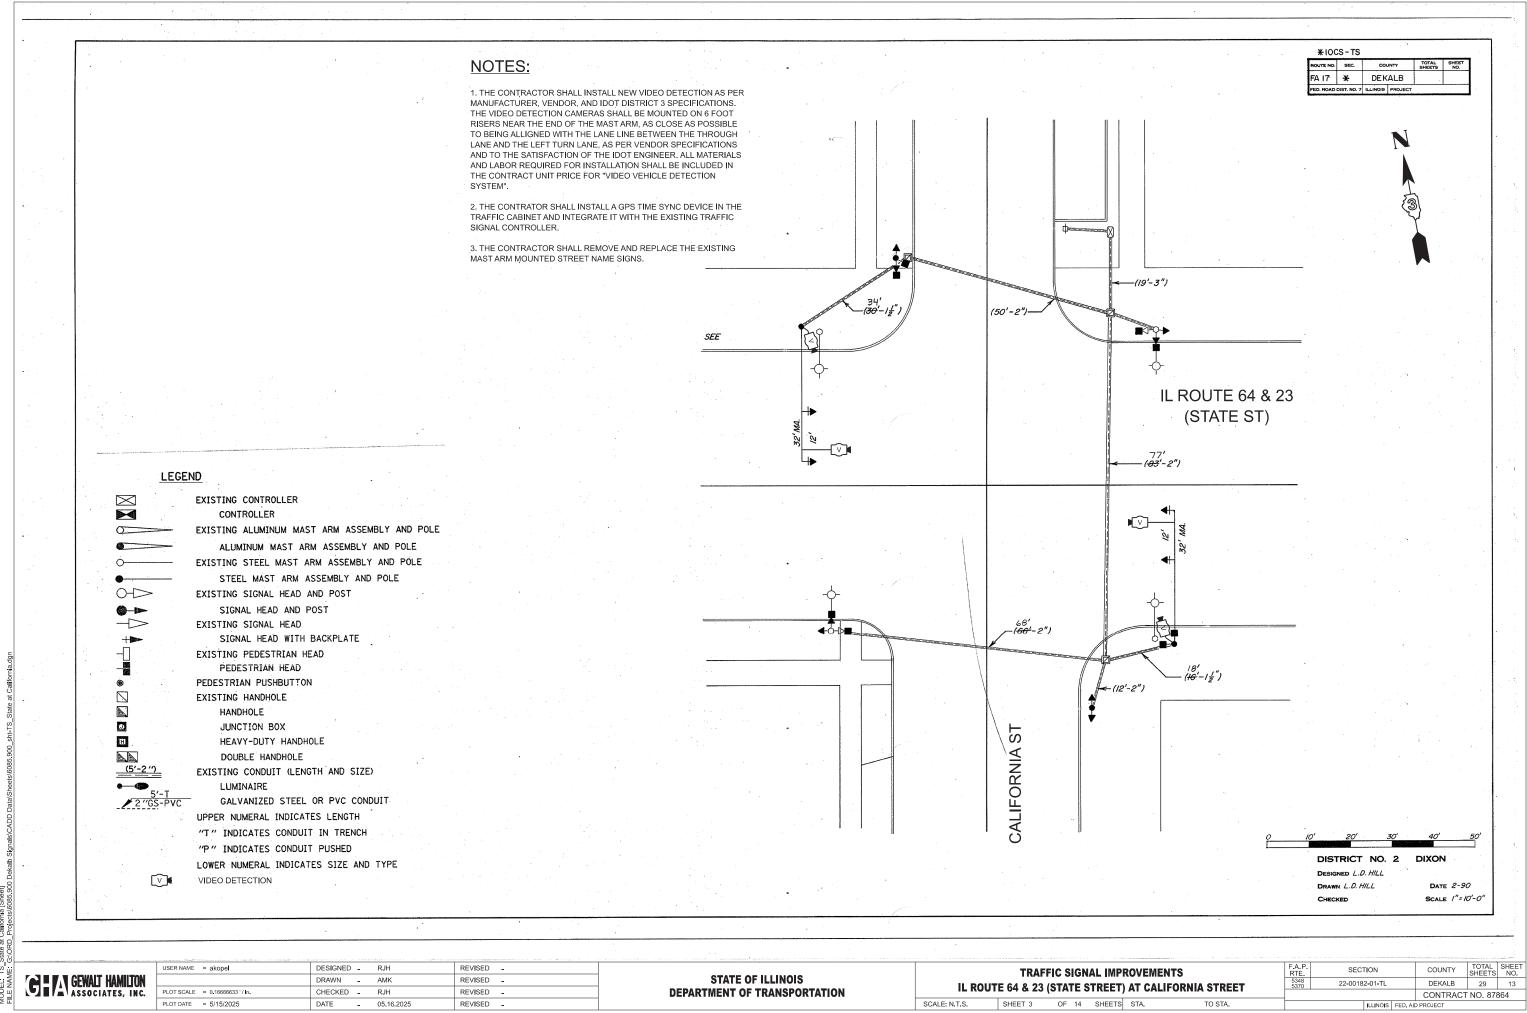
NOTE: THE ELECTRIC TIME SWITCH SHALL BE USED TO PUT THE SIGNALS ON FLASH.

64 (STATE STREET) AT SACRAMENTO STREET					
UNIT	IL ROUTE 64 (STATE STREET) AT SACRAMENTO STREET				
SQ FT	52				
EACH	1				
EACH	1				
EACH	4				
EACH	1				
	UNIT SQ FT EACH EACH EACH				


DISTRICT NO. 2	DIXON
DESIGNED	
DRAWN L.D. HILL	DATE
CHECKED	SCALE

DATE

F.A.P. RTE 5348 5370 COUNTYTOTAL
SHEETSSHEET
NO.DEKALB2912 SECTION 22-00182-01-TL CONTRACT NO. 87864 TO STA. ILLINOIS FED. AID PROJECT



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	USER NAME = akopel	DESIGNED - RJH	REVISED -		
GEWALT HAMILTON		DRAWN - AMK	REVISED -	STATE OF ILLINOIS	
GEN GEWALT HAMILTON ASSOCIATES, INC.	PLOT SCALE = 0.16666633 ' / In.	CHECKED - RJH	REVISED -	DEPARTMENT OF TRANSPORTATION	
	PLOT DATE = 5/15/2025	DATE _ 05.16.2025	REVISED -		SCALE: N

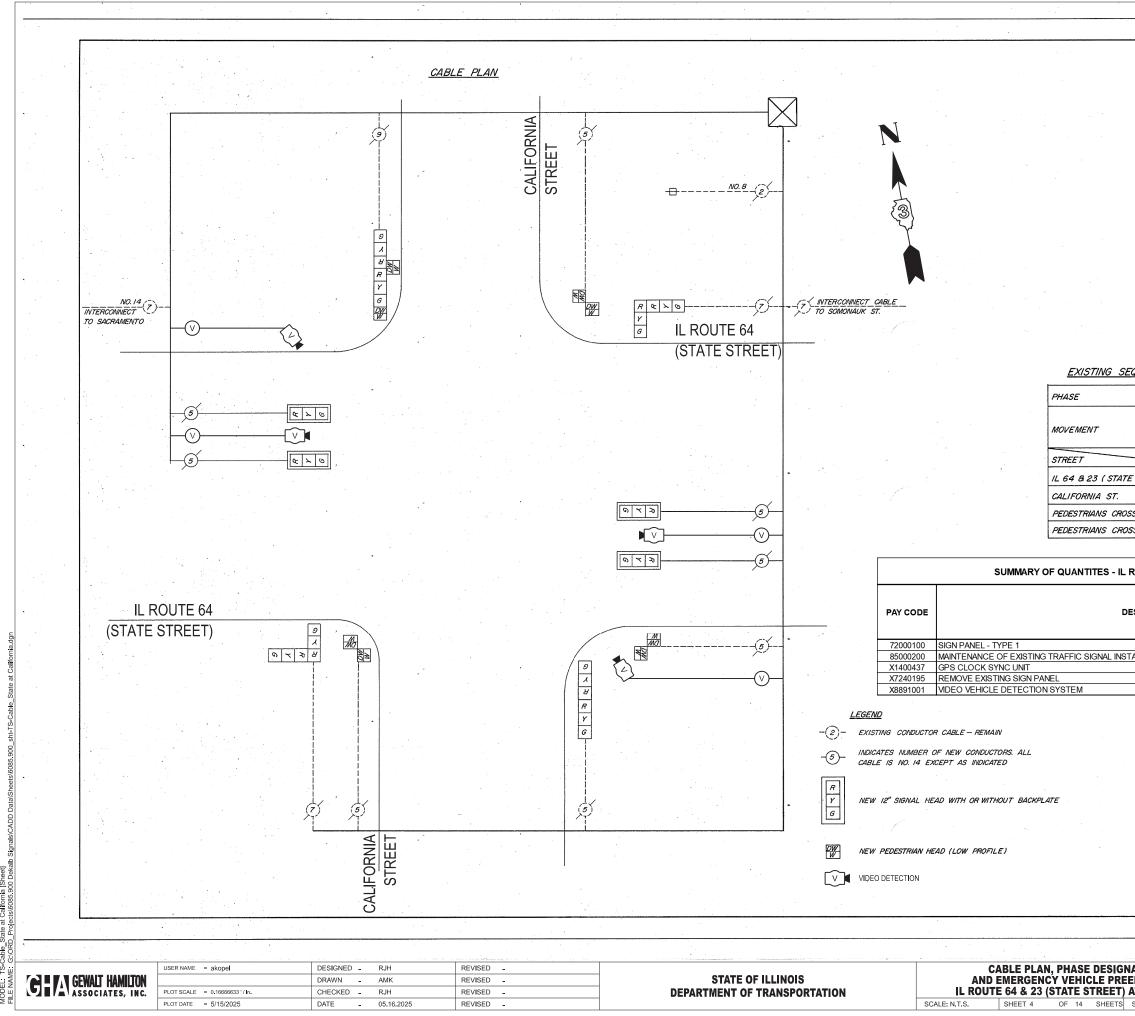

ROUTE NO.	SEC.	COUNTY	TOTAL	SHEET NO.
			SHEETS	NO.
FA 17	*	DE KALB		

EXISTING SEQUENCE OF OPERATION

		Ą			В		FLA.
		+	+	A	4	. 4	
INTERVAL	1.	2	3	4	5	6	
TATE ST.)	G	G	Y	R	R	R	R
	R	R	R	G	G	Y	R
ROSSING CALIFORNIA	w	FLA DW	DW	DW		DW	DARK
ROSSING STATE	DW	DW	DW	W	FLA. DW	DW	DARK

SUMMARY OF QUANTITES - IL ROUTE 64 (STATE STREET) AT CALIFORNIA STREET


DESCRIPTION	UNIT	IL ROUTE 64 (STATE STREET) AT CALIFORNIA STREET
	SQ FT	16.5
INSTALLATION	EACH	1
	EACH	1
	EACH	2
	FACH	1

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DESIGNED L.D. HILL DRAWN L.D. HILL CHECKED ----- 2 DIXON

DATE 8-90 SCALE -

HEET NO.
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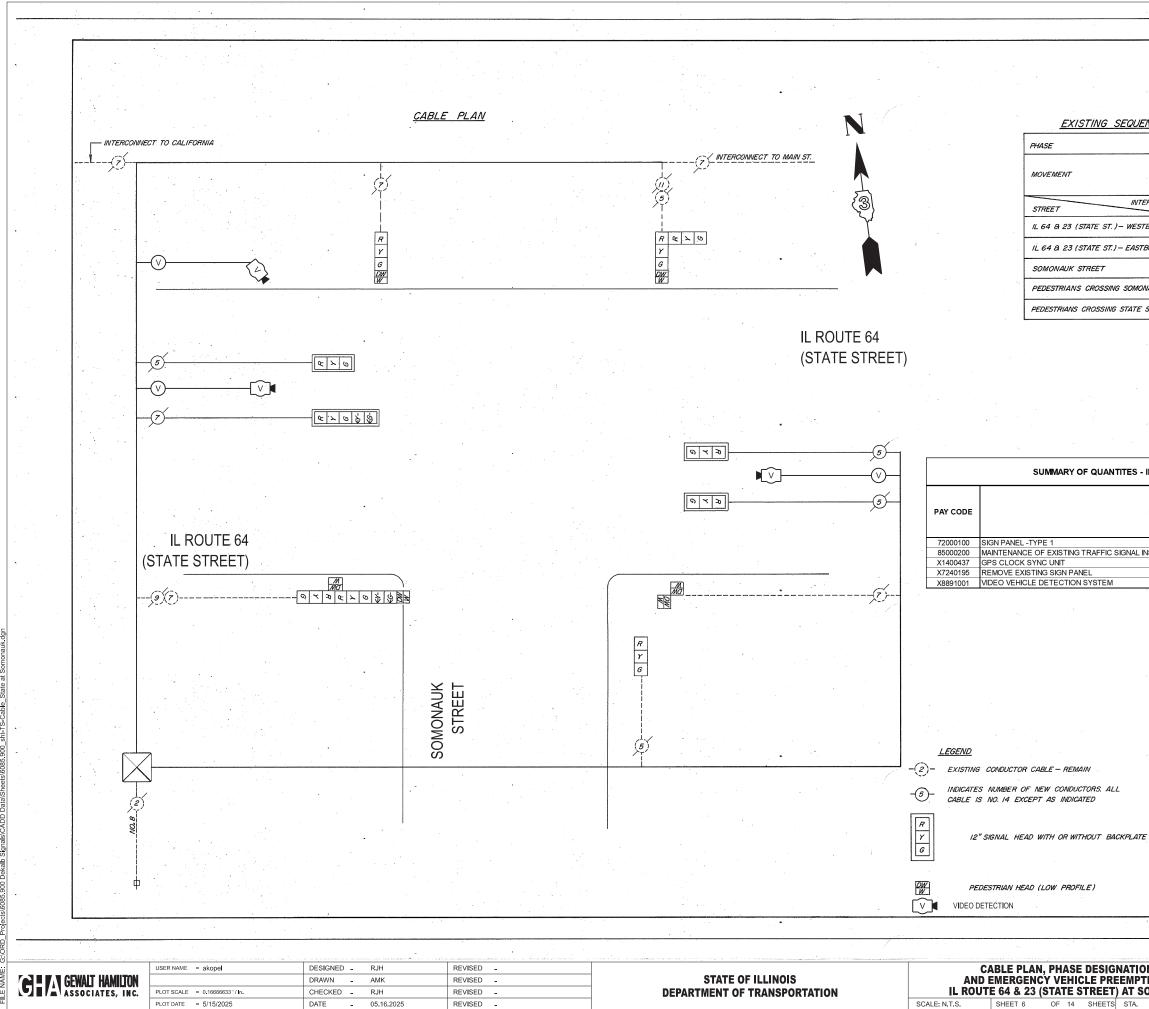


•	the second s			
	USER NAME = akopel	DESIGNED - RJH	REVISED -	
GEWALT HAMILTON		DRAWN - AMK	REVISED -	STATE OF ILLINOIS
ASSOCIATES, INC.	PLOT SCALE = 0.16666633 ' / In.	CHECKED - RJH	REVISED -	DEPARTMENT OF TRANSPORTATION
	PLOT DATE = 5/15/2025	DATE - 05.16.2025	REVISED -	

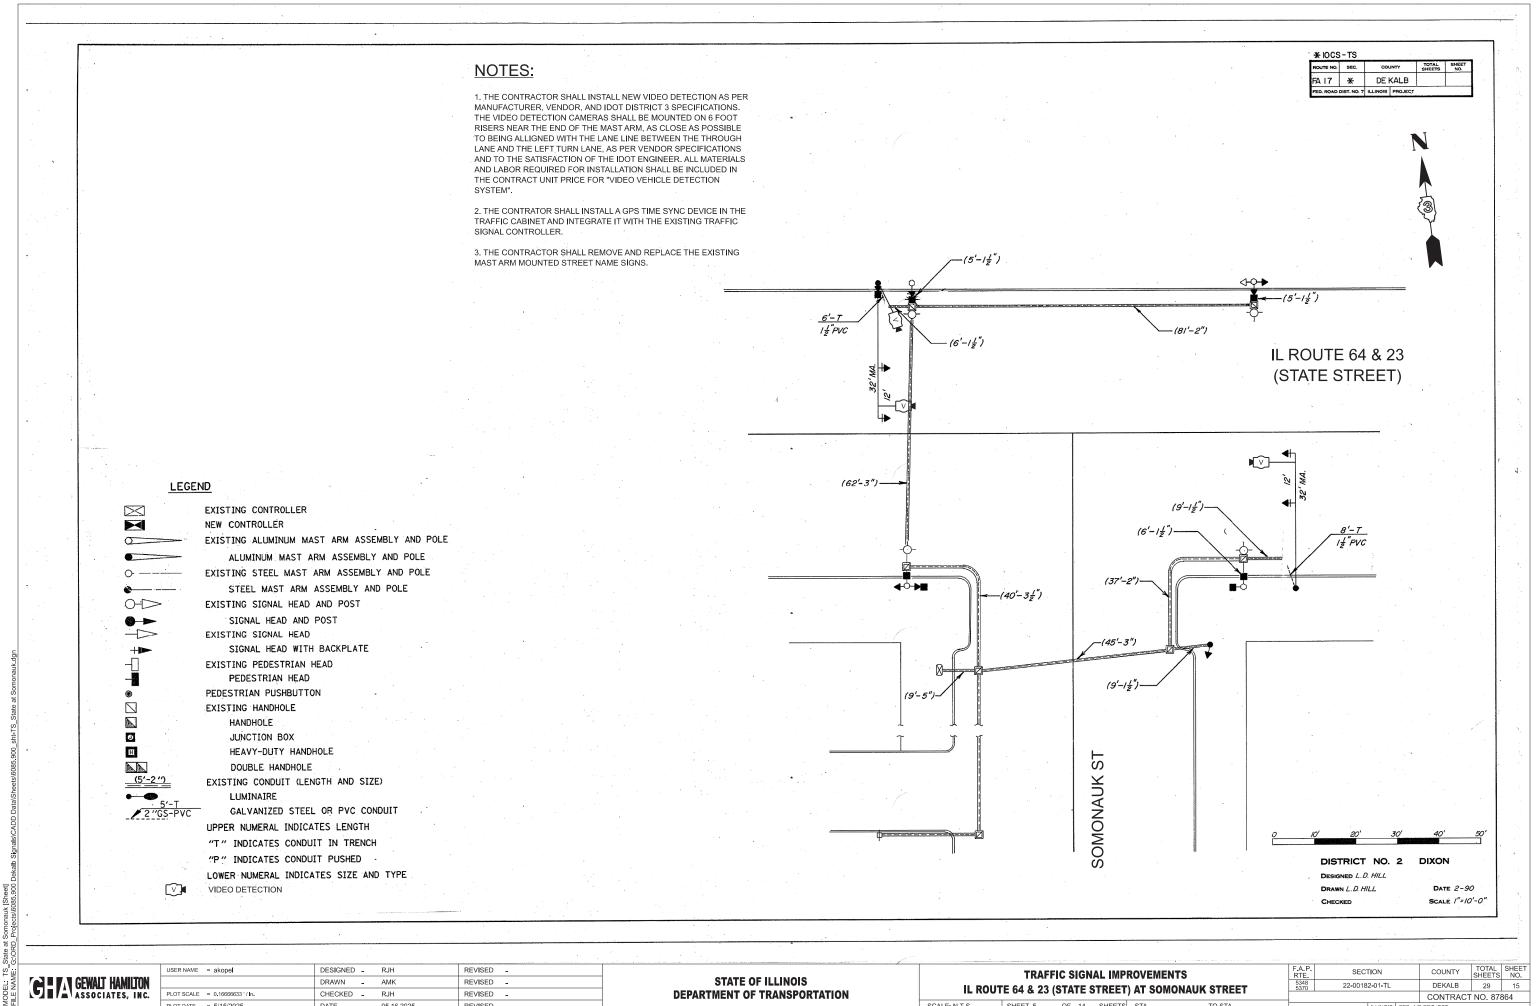TRAFFIC SIGNAL IMP IL ROUTE 64 & 23 (STATE STREET

SCALE: N.T.S. SHEET 5 OF 14 SHEETS

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וכ	ROVEMEN	TS	F.A.P. RTE	SEC	TION		COUNTY	TOTAL SHEETS	SHEET NO.
Т) AT SOMO	ONAUK STREET	5348 5370	22-0018	2 - 01 - TL		DEKALB	29	15
			_				CONTRACT	NO. 878	364
S	STA.	TO STA.			ILLINOIS	FED. AI	D PROJECT		




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ROUTE NO.	SEC.	COUNTY	TOTAL SHEETS	SHEET NO.
FA 17	*	DE KALB		

EXISTING SEQUENCE OF OPERATION

		4		B			FLA.		
	TT								
INTERVAL	/	2	3	4 ‡	5	6	7	8	
T.)— WESTBOUND	G €G-	G €Y-	G	G	Y	R	R	R	R
T.) – EASTBOUND	R	R	G	G	Y	R	R	R	R
	R	R	R	R	R	G	G	Y	R
ING SOMONAUK ST	DW	DW	w	FLA. DW	DW	DW	DW	DW	DARK
NG STATE ST.	DW	DW	DW	DW	DW	W	FLA. DW	DW	DARK

ANTITES - IL ROUTE 64 (STATE STREET) AT SOMONAUK STREET									
DESCRIPTION	UNIT	IL ROUTE 64 (STATE STREET) AT SOMONAUK STREET							
	SQ FT	18							
IC SIGNAL INSTALLATION	EACH	1							
	EACH	1							
	EACH	2							
M	EACH	1							


				DISTRICT DESIGNED L. DRAWN L.D.	D. HILL			-90	
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	NATION DIA		F.A.P. RTE.	SECT	TION		COUNTY	TOTAL SHEETS	SHEE NO.
	EEMPTION S		5348 5370	22-0018	2-01-TL		DEKALB	29	16
) AT SOMON	AUK STREET					CONTRA	CT NO. 878	364
s	STA.	TO STA.			ILLINOIS	EED AID	PROJECT		

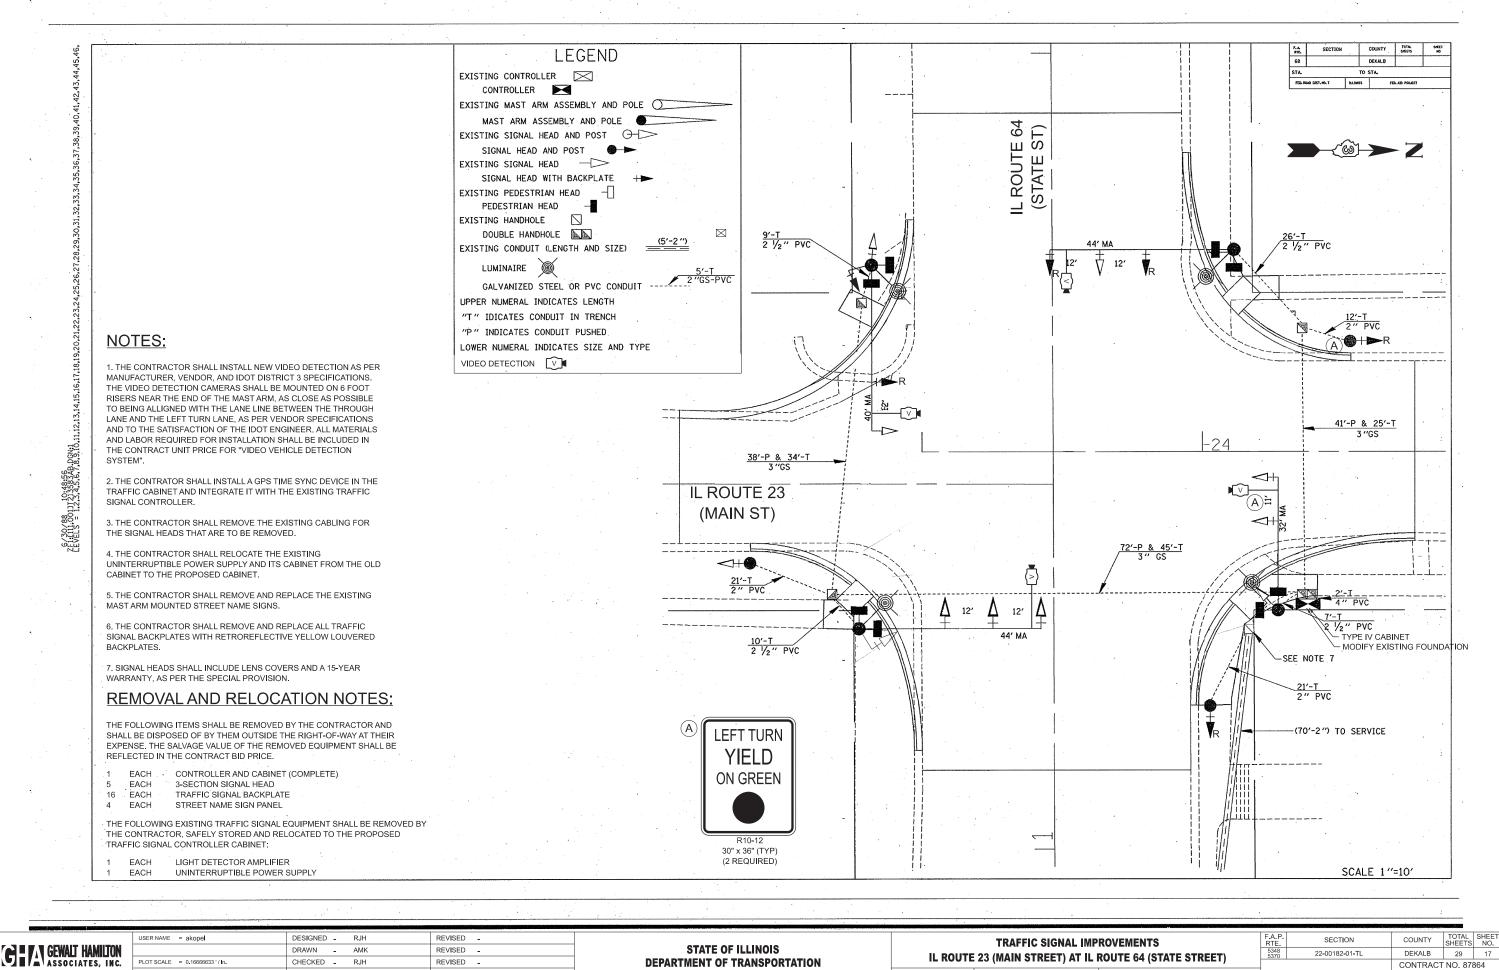

CHECKED - RJH REVISED -**DEPARTMENT OF TRANSPORTATION** SCALE: N.T.S. SHEET 7 OF 14 SHEETS STA. PLOT DATE = 5/15/2025 DATE -05.16.2025 REVISED -

TO STA

ILLINOIS FED. AID PROJEC

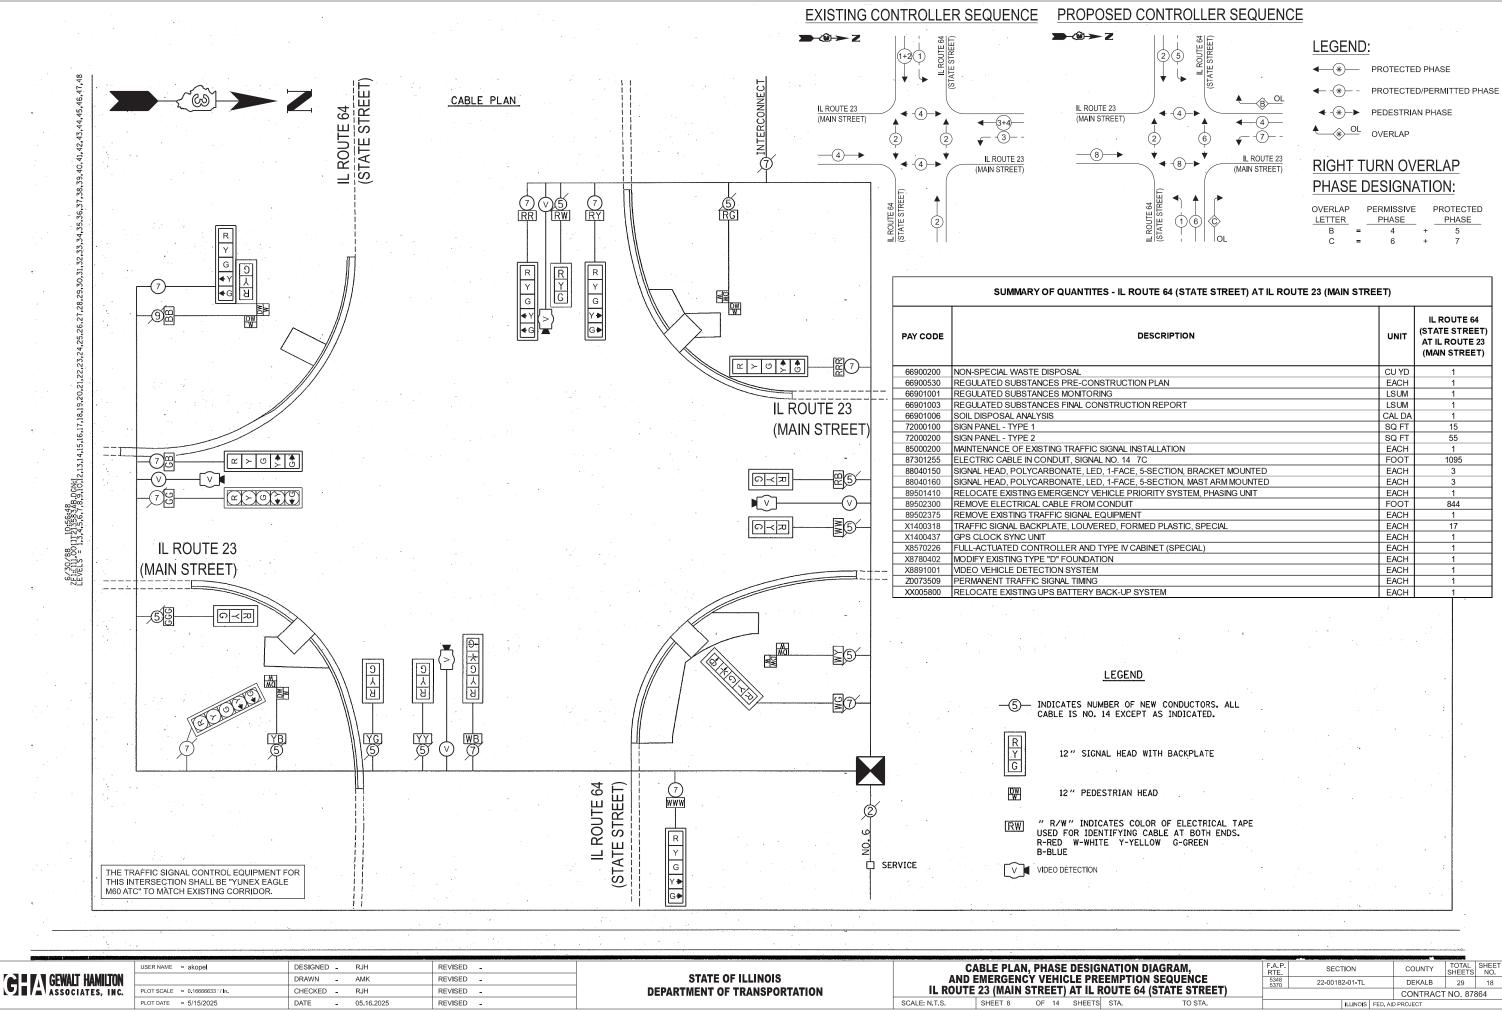



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Project

TES - IL ROUTE 64 (STATE STREET) AT IL ROUTE 23 (MAIN STREI	ET)	
DESCRIPTION	UNIT	IL ROUTE 64 (STATE STREET) AT IL ROUTE 23 (MAIN STREET)
	CU YD	1
DNSTRUCTION PLAN	EACH	1
RING	LSUM	1
ONSTRUCTION REPORT	LSUM	1
	CAL DA	1
	SQ FT	15
	SQ FT	55
IC SIGNAL INSTALLATION	EACH	1
VAL NO. 14 7C	FOOT	1095
ED, 1-FACE, 5-SECTION, BRACKET MOUNTED	EACH	3
ED, 1-FACE, 5-SECTION, MAST ARM MOUNTED	EACH	3
VEHICLE PRIORITY SYSTEM, PHASING UNIT	EACH	1
M CONDUIT	FOOT	844
. EQUIPMENT	EACH	1
/ERED, FORMED PLASTIC, SPECIAL	EACH	17
	EACH	1
D TYPE IV CABINET (SPECIAL)	EACH	1
ATION	EACH	1
M	EACH	1
G	EACH	1
Y BACK-UP SYSTEM	EACH	1

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			 . *		
			NAMES OF TAXABLE PARTY OF TAXABLE		
GNATION DIAGRAM,	F.A.P. RTE	SECTION	COUNTY	TOTAL SHEETS	SHEET NO.
	5348 5370	22-00182-01-TL	DEKALB	29	18
ROUTE 64 (STATE STREET)			CONTRACT	NO. 878	364




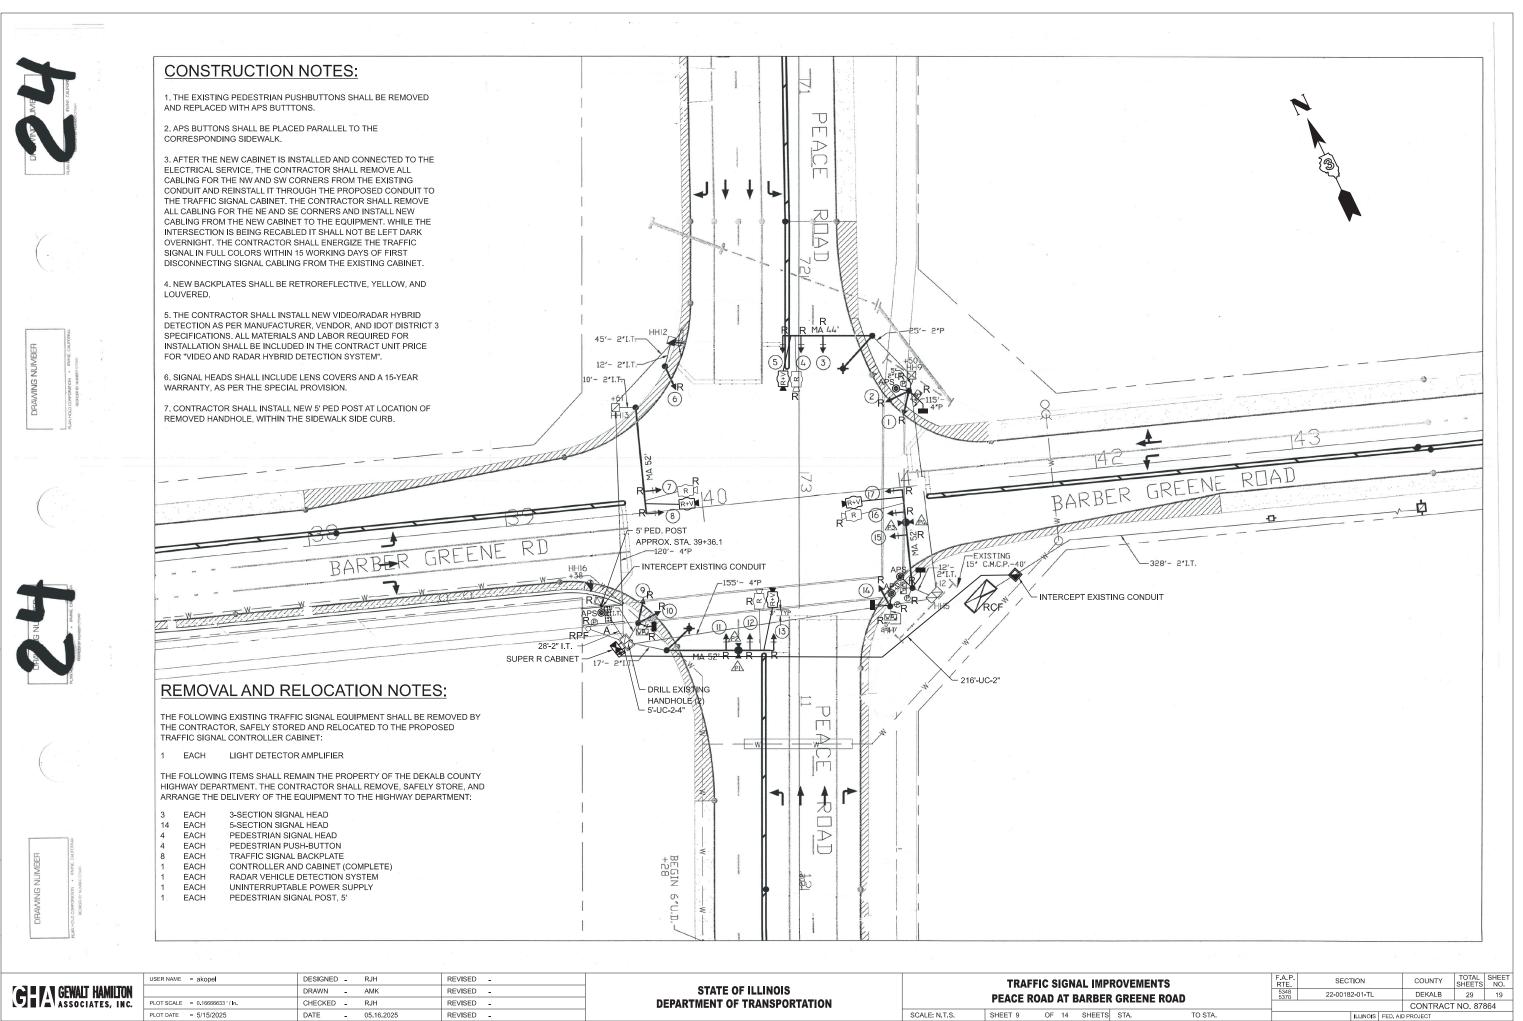

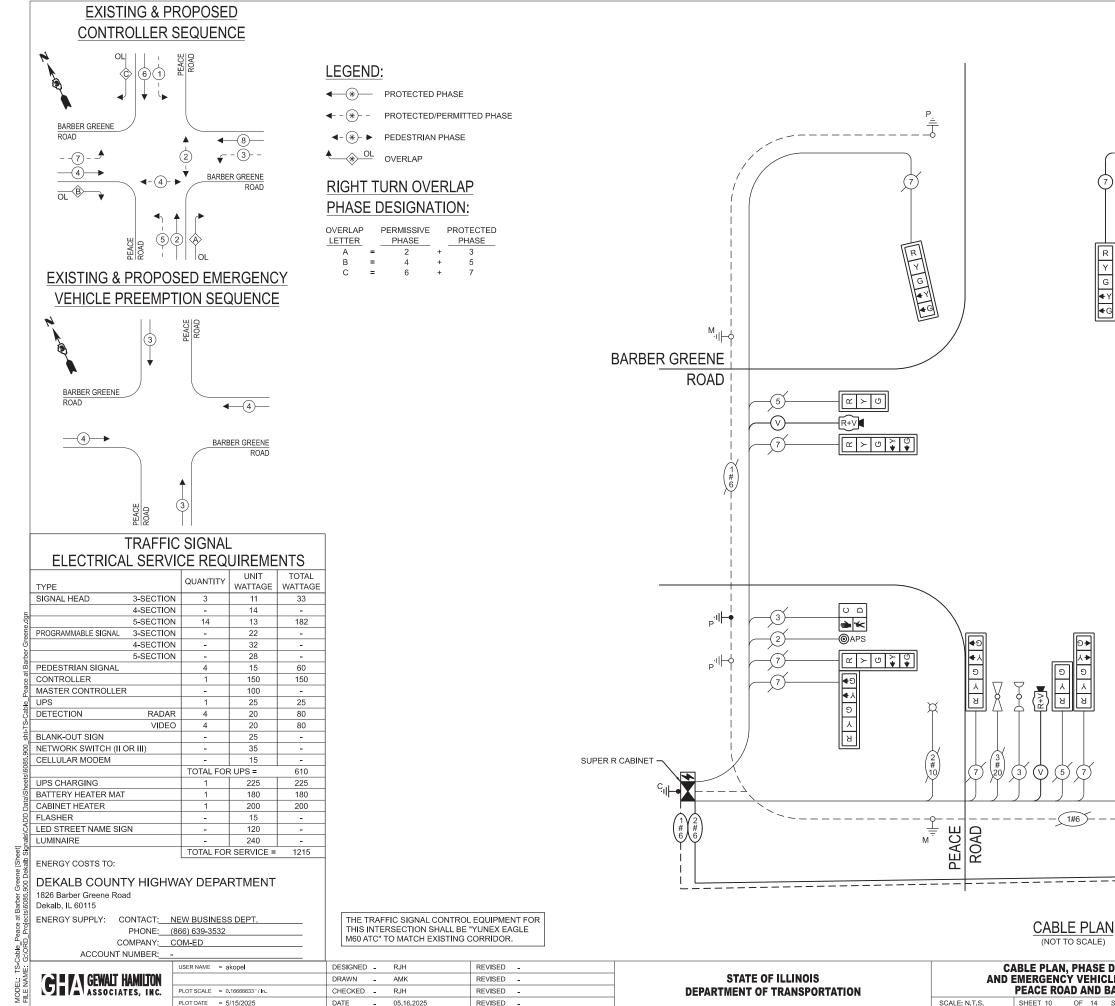SHEET 10 OF 14 SHEETS STA.


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	SUMMARY OF QUANTITES - PEACE ROAD AT BARBER GREENE ROAD		
PAY CODE	DESCRIPTION	UNIT	PEACE ROAD AT BARBER GREENE ROAD
81028200	UNDERGROUND CONDUIT, GALVANIZED STEEL, 2" DIA.	FOOT	216
81028240	UNDERGROUND CONDUIT, GALVANIZED STEEL 4" DIA	FOOT	10
81400100	HANDHOLE	EACH	1
81702110	ELECTRIC CABLE IN CONDUIT, 600V (XLP-TYPE USE) 1/C NO. 10	FOOT	404
85000200	MAINTENANCE OF EXISTING TRAFFIC SIGNAL INSTALLATION	EACH	1
86200200	UNINTERRUPTABLE POWER SUPPLY, STANDARD	EACH	1
87301215	ELECTRIC CABLE IN CONDUIT, SIGNAL NO. 14 2C	FOOT	773
87301225	ELECTRIC CABLE IN CONDUIT, SIGNAL NO. 14 3C	FOOT	1056
87301245	ELECTRIC CABLE IN CONDUIT, SIGNAL NO. 14 5C	FOOT	664
87301255	ELECTRIC CABLE IN CONDUIT, SIGNAL NO. 14 7C	FOOT	2236
87301805	ELECTRIC CABLE IN CONDUIT, SERVICE, NO. 6 2 C	FOOT	544
87301900	ELECTRIC CABLE IN CONDUIT, EQUIPMENT GROUNDING CONDUCTOR, NO. 6 1C	FOOT	550
87800150	CONCRETE FOUNDATION, TYPE C	FOOT	4
87900200	DRILL EXISTING HANDHOLE	EACH	2
88040090	SIGNAL HEAD, POLYCARBONATE, LED, 1-FACE, 3-SECTION, MAST ARM MOUNTED	EACH	3
88040150	SIGNAL HEAD, POLYCARBONATE, LED, 1-FACE, 5-SECTION, BRACKET MOUNTED	EACH	6
88040160	SIGNAL HEAD, POLYCARBONATE, LED, 1-FACE, 5-SECTION, MAST ARM MOUNTED	EACH	8
88102825	PEDESTRIAN SIGNAL HEAD, POLYCARBONATE, LED, 1-FACE, BRACKET MOUNTED WITH COUNT DOWN TIMER	EACH	4
89501410	RELOCATE EXISTING EMERGENCY VEHICLE PRIORITY SYSTEM, PHASING UNIT	EACH	1
89502300	REMOVE ELECTRIC CABLE FROM CONDUIT	FOOT	7089
89502350	REMOVE AND REINSTALL ELECTRIC CABLE FROM CONDUIT	FOOT	2548
89502375	REMOVE EXISTING TRAFFIC SIGNAL EQUIPMENT	EACH	1
89502380	REMOVE EXISTING HANDHOLE	EACH	1
89502385	REMOVE EXISTING CONCRETE FOUNDATION	EACH	2
X0324085	EMERGENCY VEHICLE PRIORITY SYSTEM LINE SENSOR CABLE, NO. 20 3/C	FOOT	262
X1400318	TRAFFIC SIGNAL BACKPLATE, LOUVERED, FORMED PLASTIC, SPECIAL	EACH	17
X1400378	PEDESTRIAN SIGNAL POST, 5 FT	EACH	1
X1400483	VIDEO AND RADAR HYBRID DETECTION SYSTEM	EACH	1
X8100863	INTERCEPT EXISTING CONDUIT	EACH	2
X8570235	FULL-ACTUATED CONTROLLER AND TYPE SUPER R CABINET (SPECIAL)	EACH	1
x8760200	ACCESSIBLE PEDESTRIAN SIGNALS	EACH	4
X8780012	CONCRETE FOUNDATION, TYPE A 12-INCH DIAMETER	EACH	4

USER NAME = akopel	DESIGNED - <u>RJH</u>	REVISED			SCHEDULE OF QUANTITIES	F.A.P.	SECTION	COUNTY TOTAL SHEET
	DRAWN - <u>AMK</u>	REVISED	STATE OF ILLINOIS		PEACE ROAD AT BARBER GREENE ROAD	5348	22-00182-01-TL	DEKALB 29 21
PLOT SCALE = 0.16666633 ' / In.	CHECKED - <u>RJH</u>	REVISED	DEPARTMENT OF TRANSPORTATION		PEACE RUAD AT BARBER GREENE RUAD	3310		CONTRACT NO. 87864
PLOT DATE = 5/16/2025	DATE _ <u>05.16.</u> 2025	REVISED _		SCALE: <u>N.T.S</u> .	SHEET 11 OF 14 SHEETS STA. TO STA.		ILLINOIS FED. AI	D PROJECT

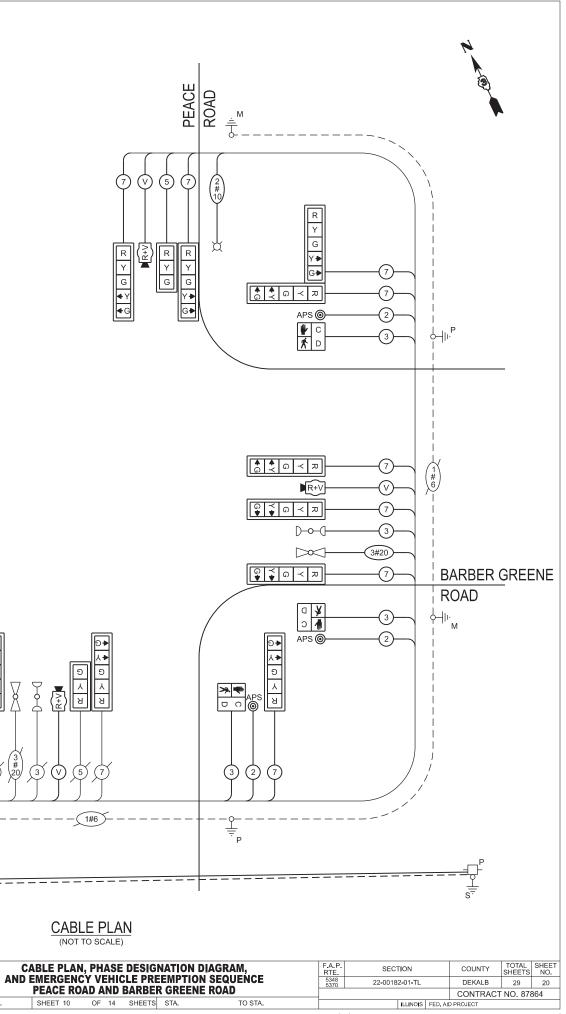

	USER NAME = akopel	DESIGNED - RJH	REVISED -			TRAFFIC SIGNAL IMPR
CAR - VAN GEWALT HAMILTON		DRAWN - AMK	REVISED -	STATE OF ILLINOIS		
ASSOCIATES, INC.	PLOT SCALE = 0.16666633 '/ In.	CHECKED - RJH	REVISED -	DEPARTMENT OF TRANSPORTATION		ANNIE GLIDDEN ROAD AT
	PLOT DATE = 5/15/2025	DATE - 05.16.2025	REVISED -		SCALE: 1"=20'	SHEET 12 OF 14 SHEETS

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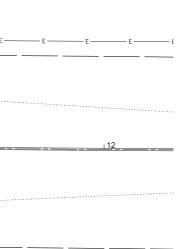
RELOCATE ITEM

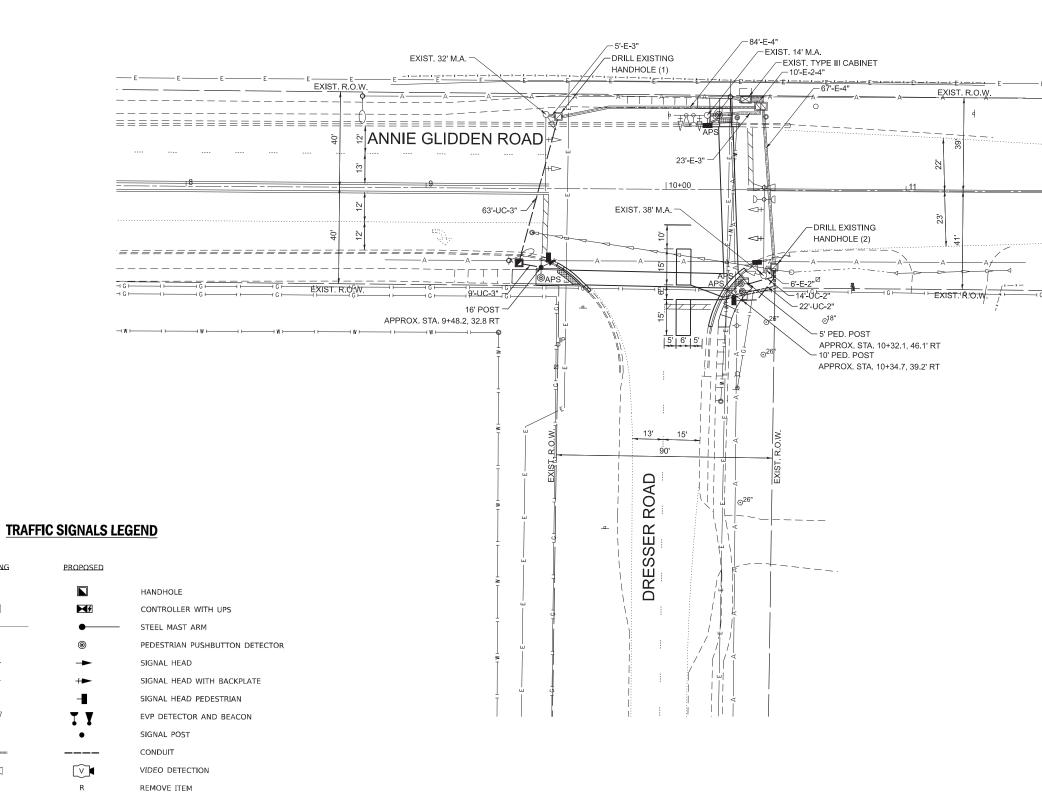ABANDON ITEM

MAST ARM POLE AND FOUNDATION TO BE REMOVED

SIGNAL POST AND FOUNDATION TO BE REMOVED

ACCESSIBLE PEDESTRIAN PUSH BUTTON




NOTES:

1. ALL PEDESTRIAN PUSHBUTTONS SHALL BE APS.

2. APS BUTTONS SHALL BE PLACED PARALLEL TO THE CORRESPONDING SIDEWALK.


3. THIS LOCATION HAS BEEN DESIGNED TO BE ADA COMPLIANT, ANY DEVIATION FROM THIS PLAN FOR THE POSTS THAT HAVE PEDESTRIAN EQUIPMENT WILL HAVE TO BE APPROVED BY THE ENGINEER TO ENSURE ADA COMPLIANCE.

PROVEMENTS		SECTION			COUNTY	TOTAL SHEETS	SHEET NO.		
T DRESSER ROAD		22-00182-01-TL			DEKALB	29	22		
I DRESSER ROAD					CONTRACT NO. 87864				
S STA. TO STA.			ILLINOIS	FED. All	AID PROJECT				

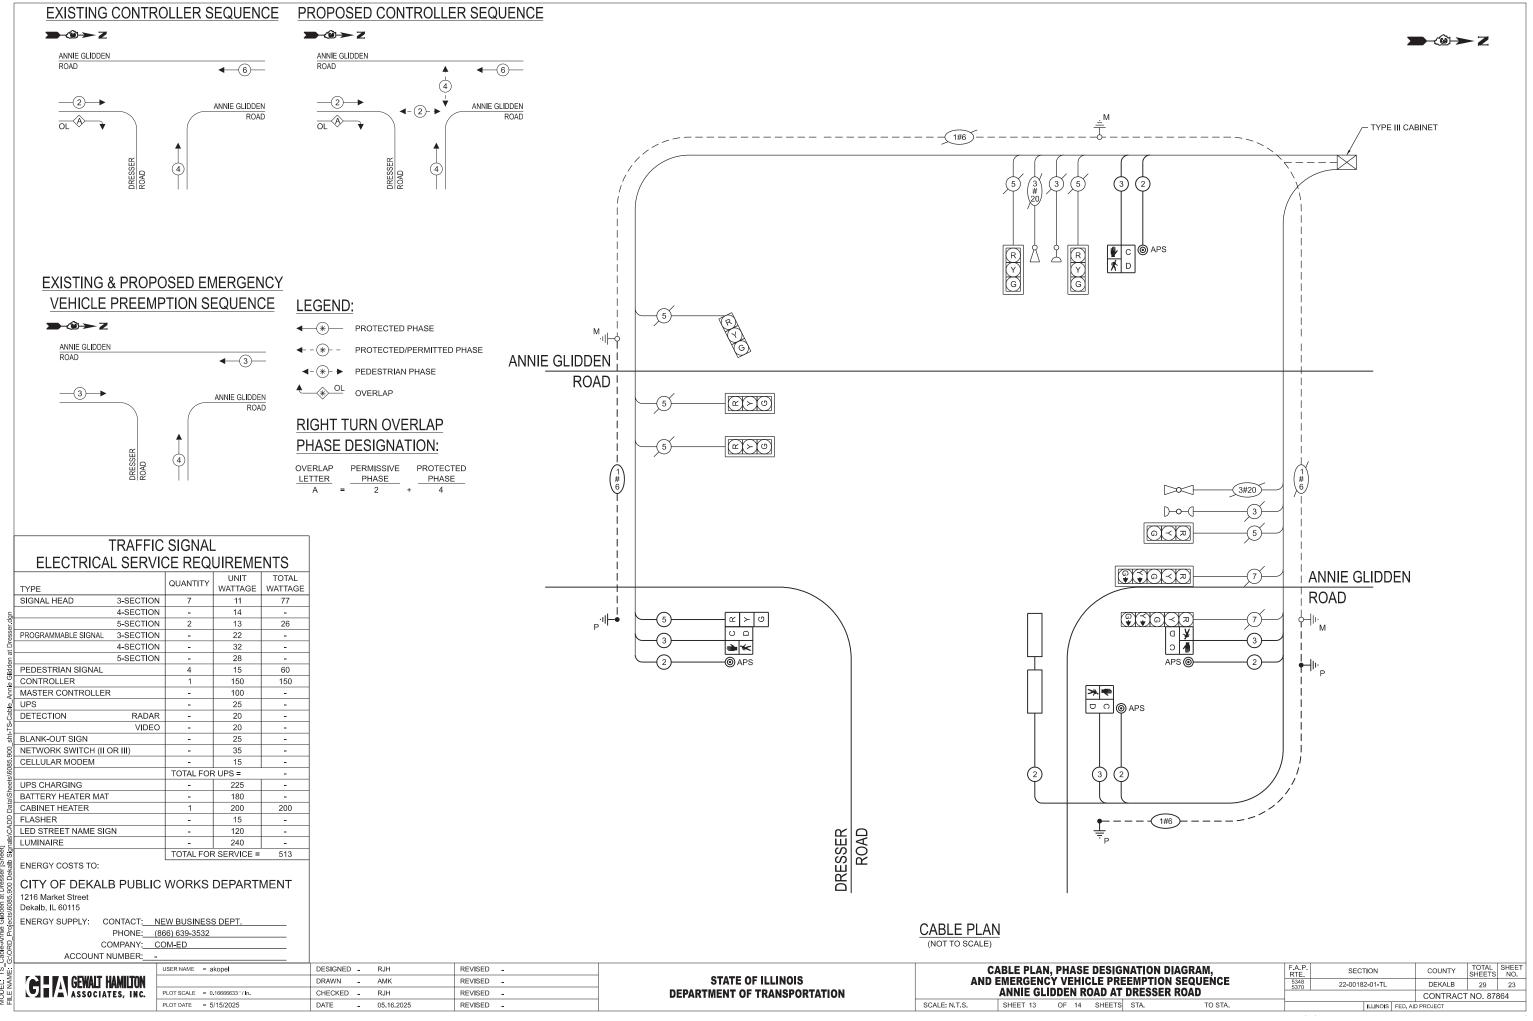

	SUMMARY OF QUANTITES - ANNIE GLIDDEN ROAD AR DRESSER ROAD		
PAY CODE	DESCRIPTION	UNIT	ANNIE GLIDDEN ROAD AT DRESSER ROAD
72000100	SIGN PANEL - TYPE 1	SQ FT	15
72000200	SIGN PANEL - TYPE 2	SQ FT	12
81028350	UNDERGROUND CONDUIT, PVC, 2" DIA.	FOOT	36
81028370	UNDERGROUND CONDUIT, PVC, 3" DIA.	FOOT	72
81400100	HANDHOLE	EACH	1
85000200	MAINTENANCE OF EXISTING TRAFFIC SIGNAL INSTALLATION	EACH	1
87301215	ELECTRIC CABLE IN CONDUIT, SIGNAL NO. 14 2C	FOOT	537
87301225	ELECTRIC CABLE IN CONDUIT, SIGNAL NO. 14 3C	FOOT	557
87301245	ELECTRIC CABLE IN CONDUIT, SIGNAL NO. 14 5C	FOOT	217
87301900	ELECTRIC CABLE IN CONDUIT, EQUIPMENT GROUNDING CONDUCTOR, NO. 6 1C	FOOT	132
87502500	TRAFFIC SIGNAL POST, GALVANIZED STEEL 16 FT.	EACH	1
87800100	CONCRETE FOUNDATION, TYPE A	FOOT	4
87900200	DRILL EXISTING HANDHOLE	EACH	3
88040070	SIGNAL HEAD, POLYCARBONATE, LED, 1-FACE, 3-SECTION, BRACKET MOUNTED	EACH	1
88102825	PEDESTRIAN SIGNAL HEAD, POLYCARBONATE, LED, 1-FACE, BRACKET MOUNTED WITH COUNT DOWN TIMER	EACH	4
88600100	DETECTOR LOOP, TYPE I	FOOT	108
89502200	MODIFY EXISTING CONTROLLER	EACH	1
X1400367	PEDESTRIAN SIGNAL POST, 10 FT.	EACH	1
X1400378	PEDESTRIAN SIGNAL POST, 5 FT.	EACH	1
X8760200	ACCESSIBLE PEDESTRIAN SIGNALS	EACH	4
X8780012	CONCRETE FOUNDATION, TYPE A 12-INCH DIAMETER	FOOT	8
X8860100	LOOP DETECTOR TESTING	EACH	1
Z0073509	PERMANENT TRAFFIC SIGNAL TIMING	EACH	1


	USER NAME = zwallsten DESIGNED - RJH REVISED -						SCHEDULE OF QUANTITIES						SECTION	COUNTY	TOTAL SHEET SHEETS NO.
CENTERAL HAMILTON ASSOCIATES, INC. PLOT SCALE = 0.166666633		DRAWN -	AMK	REVISED -	STATE OF ILLINOIS		ANNIE GLIDDEN ROAD AT DRESSER ROAD						22-00182-01-TL	DEKALB	29 24
ASSOCIATES, INC.	PLOT SCALE = 0.16666633 ' / In.	CHECKED -	RJH	REVISED -	DEPARTMENT OF TRANSPORTATION	ANNIE GLIDDEN KOAD AT DRESSER KOAD		5370		CONTRAC	CT NO. 87864				
	PLOT DATE = 6/9/2025	DATE -	05.16.2025	REVISED -	Si	SCALE: N.T.S. SHEET 14 OF 14 SHEETS STA. TO STA.							ILLINOIS FED.		

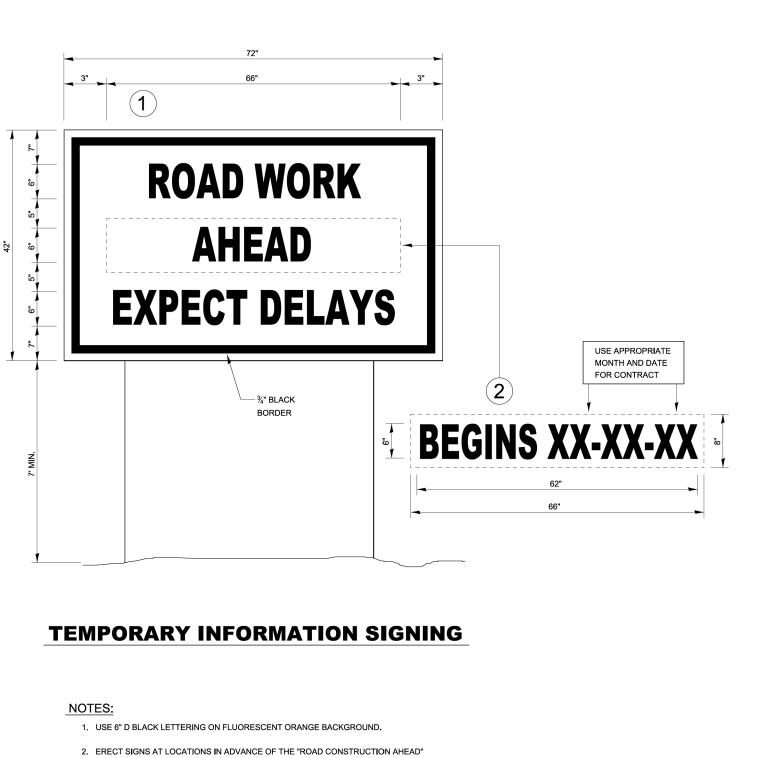

- SIGNS AS DIRECTED BY THE ENGINEER.
- 3. ERECT SIGN () WITH INSTALLED PANEL (2) A MINIMUM OF ONE WEEK PRIOR TO THE START OF THE LANE CLOSURE.
- 4. REMOVE PANEL (2) ON THAT DATE.
- 5. SEE SPECIAL PROVISION "TEMPORARY INFORMATION SIGNING" FOR ADDITIONAL INFORMATION.
- 6. WILL BE PAID FOR PER SQ FT AS "TEMPORARY INFORMATION SIGNING". EACH SIGN = 21 SQ FT AND THE DATE PANEL WILL NOT BE MEASURED SEPARATELY FOR PAYMENT.

с ы		USER NAME = anthony.grunstad	DESIGNED -	REVISED -								F.A.P.	SECTION	COUNTY	TOTAL	SHEET
NAN NAN	GERAGEWALT HAMILTON ASSOCIATES, INC.		DRAWN -	REVISED -	STATE OF ILLINOIS		IDC	OT DIST	FRICT 3	B DETAILS			22-00182-01-TL	DEKALB	29	25
8	Associates, Inc.	PLOT SCALE = 50.000 ' / in.	CHECKED -	REVISED -	DEPARTMENT OF TRANSPORTATION									CONTRAC	T NO.87	7864
≥╙		PLOT DATE = 10/6/23	DATE -	REVISED -		SCALE:	SHEET	OF	SHEETS	STA.	TO STA.		ILLINOIS FED	AID PROJECT		

* VARIES - SEE STANDARD 606001

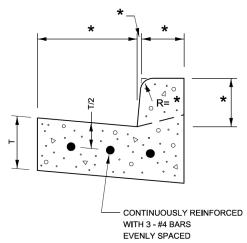

REINFORCEMENT DETAIL FOR **COMBINATION CONCRETE CURB AND GUTTER**


606-4

720-8

APS PUSHBUTTON PLACEMENT DETAILS

FIGURE 1: APS PUSHBUTTON LOCATION AREAS - INTERSECTION CORNER

FIGURE 2: APS PUSHBUTTON LOCATION AREAS - CORNER ISLAND

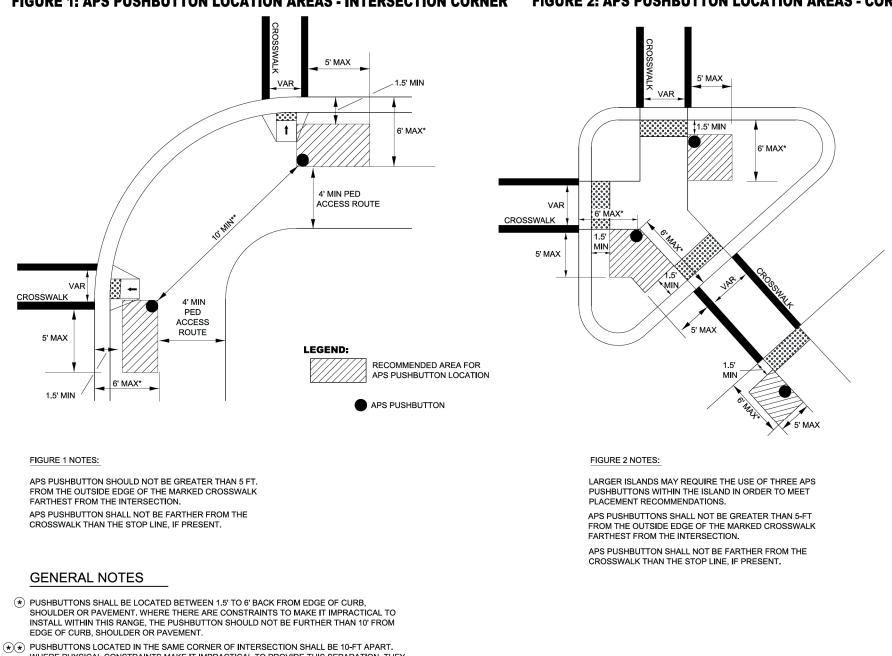

WHERE PHYSICAL CONSTRAINTS MAKE IT IMPRACTICAL TO PROVIDE THIS SEPARATION, THEY MAY BE PLACED CLOSED TOGETHER OR MOUNTED ON THE SAME POST. IN THIS CASE, EACH APS PUSHBUTTON SHALL BE PROVIDED WITH A SPEECH WALK MESSAGE FOR THE WALKING PERSON INDICATION AND A SPEECH PUSHBUTTON INFORMATION MESSAGE

VERTICAL HEIGHT OF THE APS PUSHBUTTONS SHALL BE LOCATED BETWEEN 30" TO 42" (36" PREFERRED) ABOVE THE PATHWAY ELEVATION. SEE HWY STND 876001

PUSHBUTTONS SHALL BE LOCATED WITHIN TEN (10) INCHES OF THE PEDESTRIAN ACCESS ROUTE. WHEN REQUIRED, EXTENSIONS SHALL BE INSTALLED TO COMPLY WITH THIS REQUIREMENT. THE COST OF INSTALLING THE EXTENSION SHALL BE CONSIDERED AS INCLUDED IN THE COST OF THE ACCESSIBLE PEDESTRIAN SIGNAL

SEE ACCESSIBLE PEDESTRIAN SIGNALS (BDE) SPECIAL PROVISION FOR REQUIREMENTS NOT SHOWN IN THIS DETAIL.

FOUNDATIONS FOR PEDESTRIAN POSTS SHALL NOT PROTRUDE MORE THAN 4 INCHES ABOVE THE FINISHED GRADE / SIDEWALK


APS PUSHBUTTON INSTALLATIONS AT LOCATIONS WITH RAILROAD INTERCONNECTION OR EMERGENCY VEHICLE PREEMPTION SHALL INCLUDE AN ADDITIONAL SPEECH MESSAGE STATING "WALK TIME SHORTENED WHEN TRAIN APPROACHES" OR "WALK TIME SHORTENED WHEN EMERGENCY VEHICLE APPROACHES" TO NOTIFY PEDESTRIANS OF TRUNCATED CLEARANCE TIMES DUE TO PREEMPTION".

G

						000	′ •
GEM GEWALT HAMILTON Associates, inc.	USER NAME = anthony.grunstad	DESIGNED -	REVISED			F.A. <u>P.</u> BTE SECTION	COUNTY TOTAL SHEET
	DRAWN REVISED	REVISED	STATE OF ILLINOIS	ACCESSIBLE PEDESTRIAN SIGNALS	22-00182-01-TL	DEKALB 29 26	
	PLOT SCALE = 50.000 ' / in.	CHECKED -	REVISED	DEPARTMENT OF TRANSPORTATION		/	CONTRACT NO.87864
	PLOT DATE = 10/6/23	DATE	REVISED		SCALE: SHEET OF SHEETS STA TO STA	ILLINOIS FED. A	ID PROJECT

APS PUSHBUTTON SIGNING OPTIONS


AT INTERSECTIONS WITH PEDESTRIAN SIGNALS

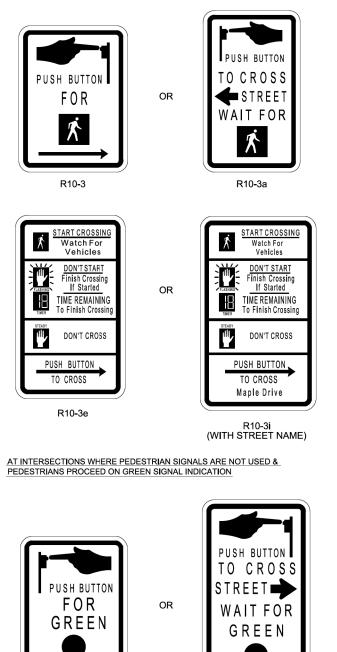


R10-4



DESIGNER NOTE:
*INCLUDE ON DETAIL NEW INSTALLATIONS WHERE APS PUSHBUTTONS ARE
NEEDED.
*ADD HIGHWAY STANDARD 876001.
*ADD ACCESSIBLE PEDESTRIAN SIGNALS SPECIAL PROVISION (BDE) AND
PAY ITEM ACCESSIBLE PEDESTRIAN SIGNALS (EACH).
*ADD PEDESTRIAN PUSH BUTTON POST PAY ITEM (EACH)
*CONSULT WITH TRAFFIC SIGNALS SECTION FOR CONCURRENCE ON PED
BUTTONS LOCATIONS & ADDITIONAL ELECTRICAL PAY ITEMS, PED HEADS,
ETC. AS NEEDED.
888-1

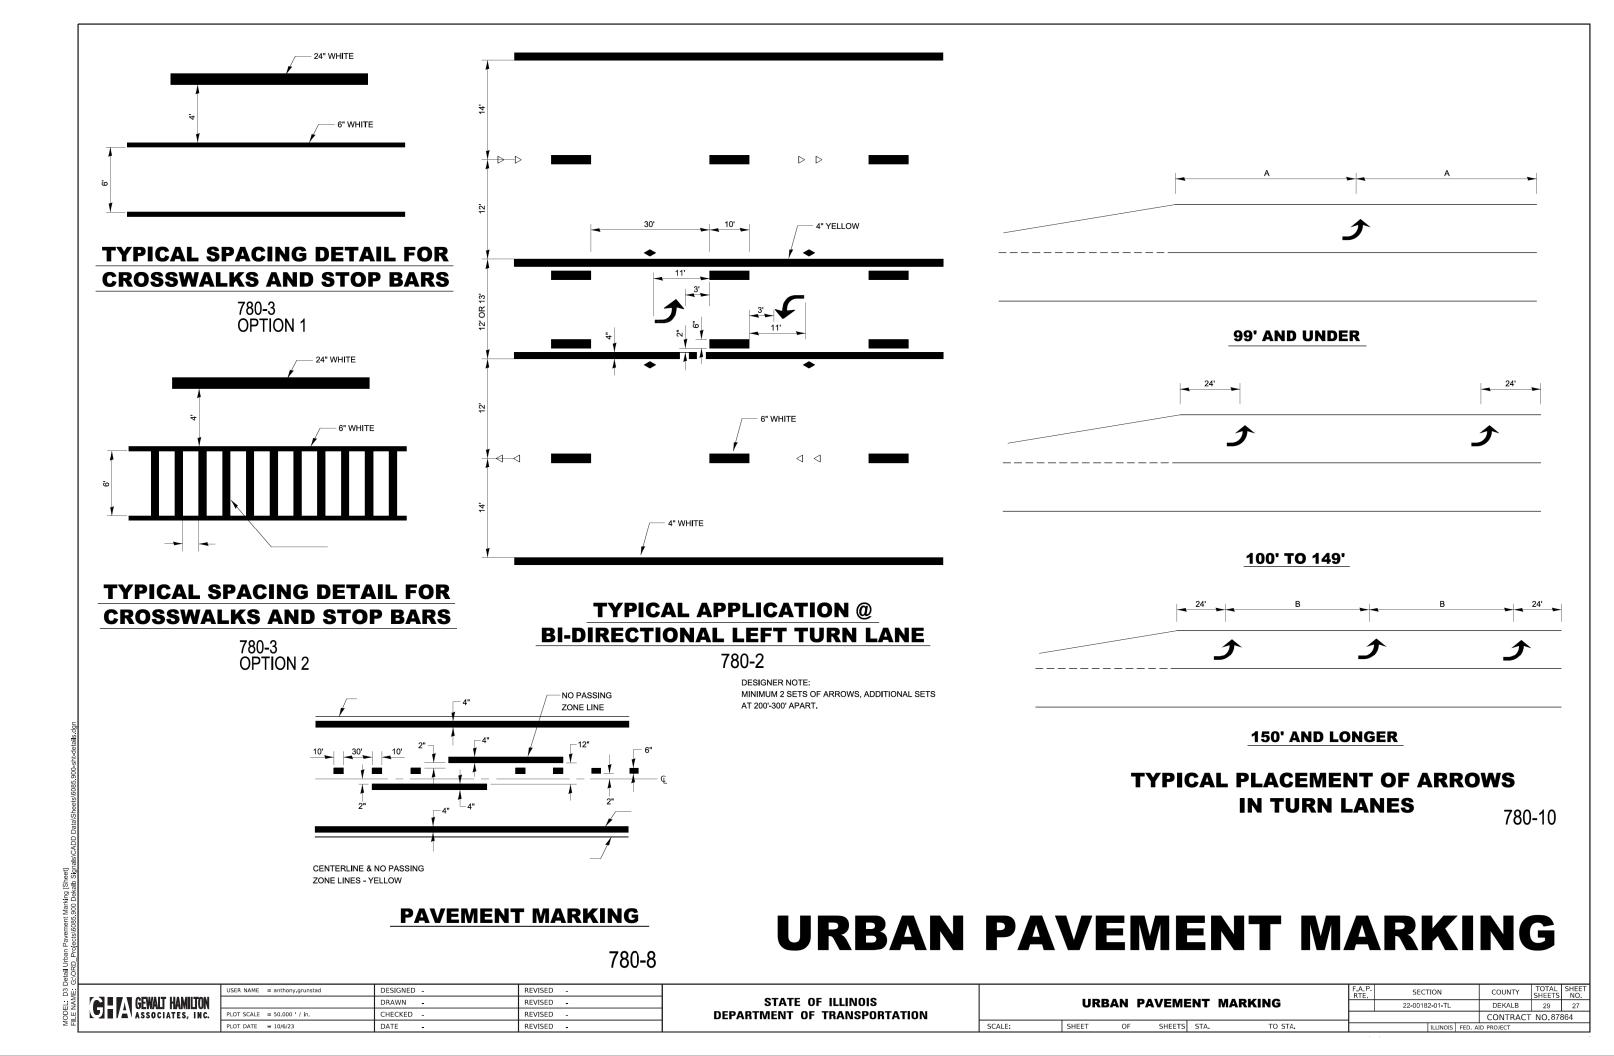

USER NAME = akopel	DESIGNED -	REVISED -						P II AT		F.A.P. RTF	SECTION	COUNTY	TOTAL S	HEET
	DRAWN -	REVISED -	STATE OF ILLINOIS	ADDITIONAL DETAILS						KIL.	22-00182-01-TL	DEKALB	29	28
PLOT SCALE = 0.16666633 '/ In.	CHECKED _	REVISED -	DEPARTMENT OF TRANSPORTATION									CONTRACT	NO. 8786	54
PLOT DATE = 5/13/2025	DATE -	REVISED _		SCALE:	SHEET	OF	SHEETS	STA.	TO STA.	ILLINOIS FED. AID PROJECT				

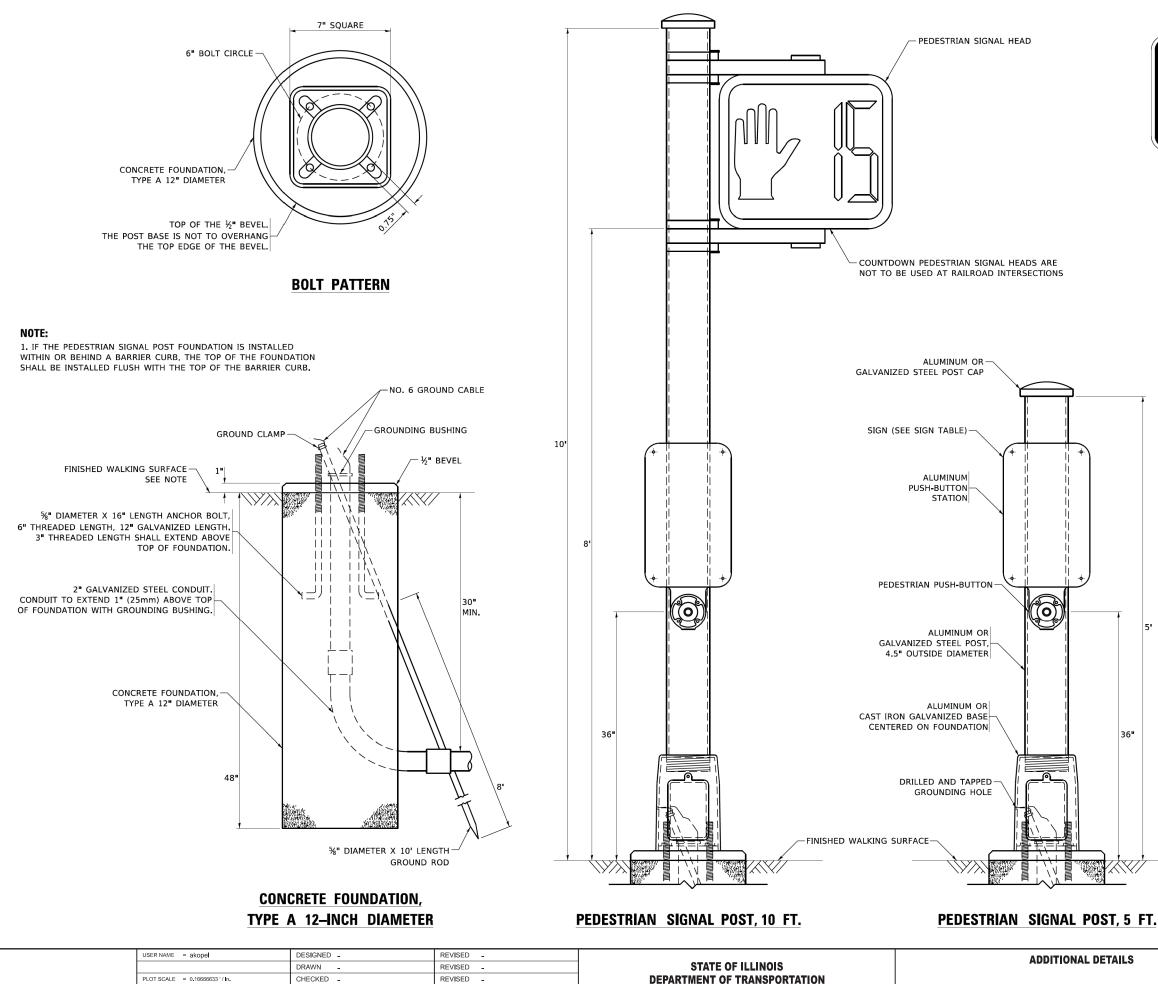

PLOT DATE = 5/13/2025

DATE

REVISED -DEPARTMENT OF TRANSPORTATION SCALE: SHEET OF SHEETS REVISED -



R10-3b



R10-3d




R10-3e

SIGN TABLE

SIGN	DIMENSIONS
R10-3b (RAILROAD ONLY)	9" X 12"
R10-3d (RAILROAD ONLY)	9" X 12"
R10-3e	9" X 12"

NOTES:

- 1. THE SIGN PANELS SHALL BE TYPE AP SHEETING.
- 2. THE ARROW ON SIGNS FOR PUSH-BUTTONS SERVING TWO DIRECTIONS ON THE SAME PHASE SHALL BE BI-DIRECTIONAL.
- 3. THE SIGN FOR DUAL-CALL PUSH-BUTTONS SHALL HAVE NO ARROW.

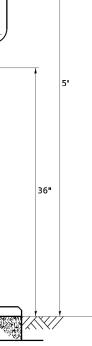

DE	TAILS		F.A.P. RTE	SECT	ION		COUNTY	TOTAL SHEETS	SHEET NO.
			22-0018	2-01-TL		DEKALB	29	29	
							CONTRACT	NO. 878	364
TS	STA.	TO STA.			ILLINOIS	FED. All	PROJECT		
			•	•					