






**LEGENDS**

-  INLET FILTER
-  PERIMETER EROSION BARRIER
-  TEMPORARY EROSION CONTROL SEEDING AND MULCH, METHOD 2



FILE PATH = p:\388035\pmt\escomon\me\local\AECOM\01\Documents\01\Americas\Transportation\6269938\_Circle\Phase\_1\1000\_CAD\005\_Roadway\Sheets\60W25-sht-Eros-02

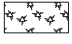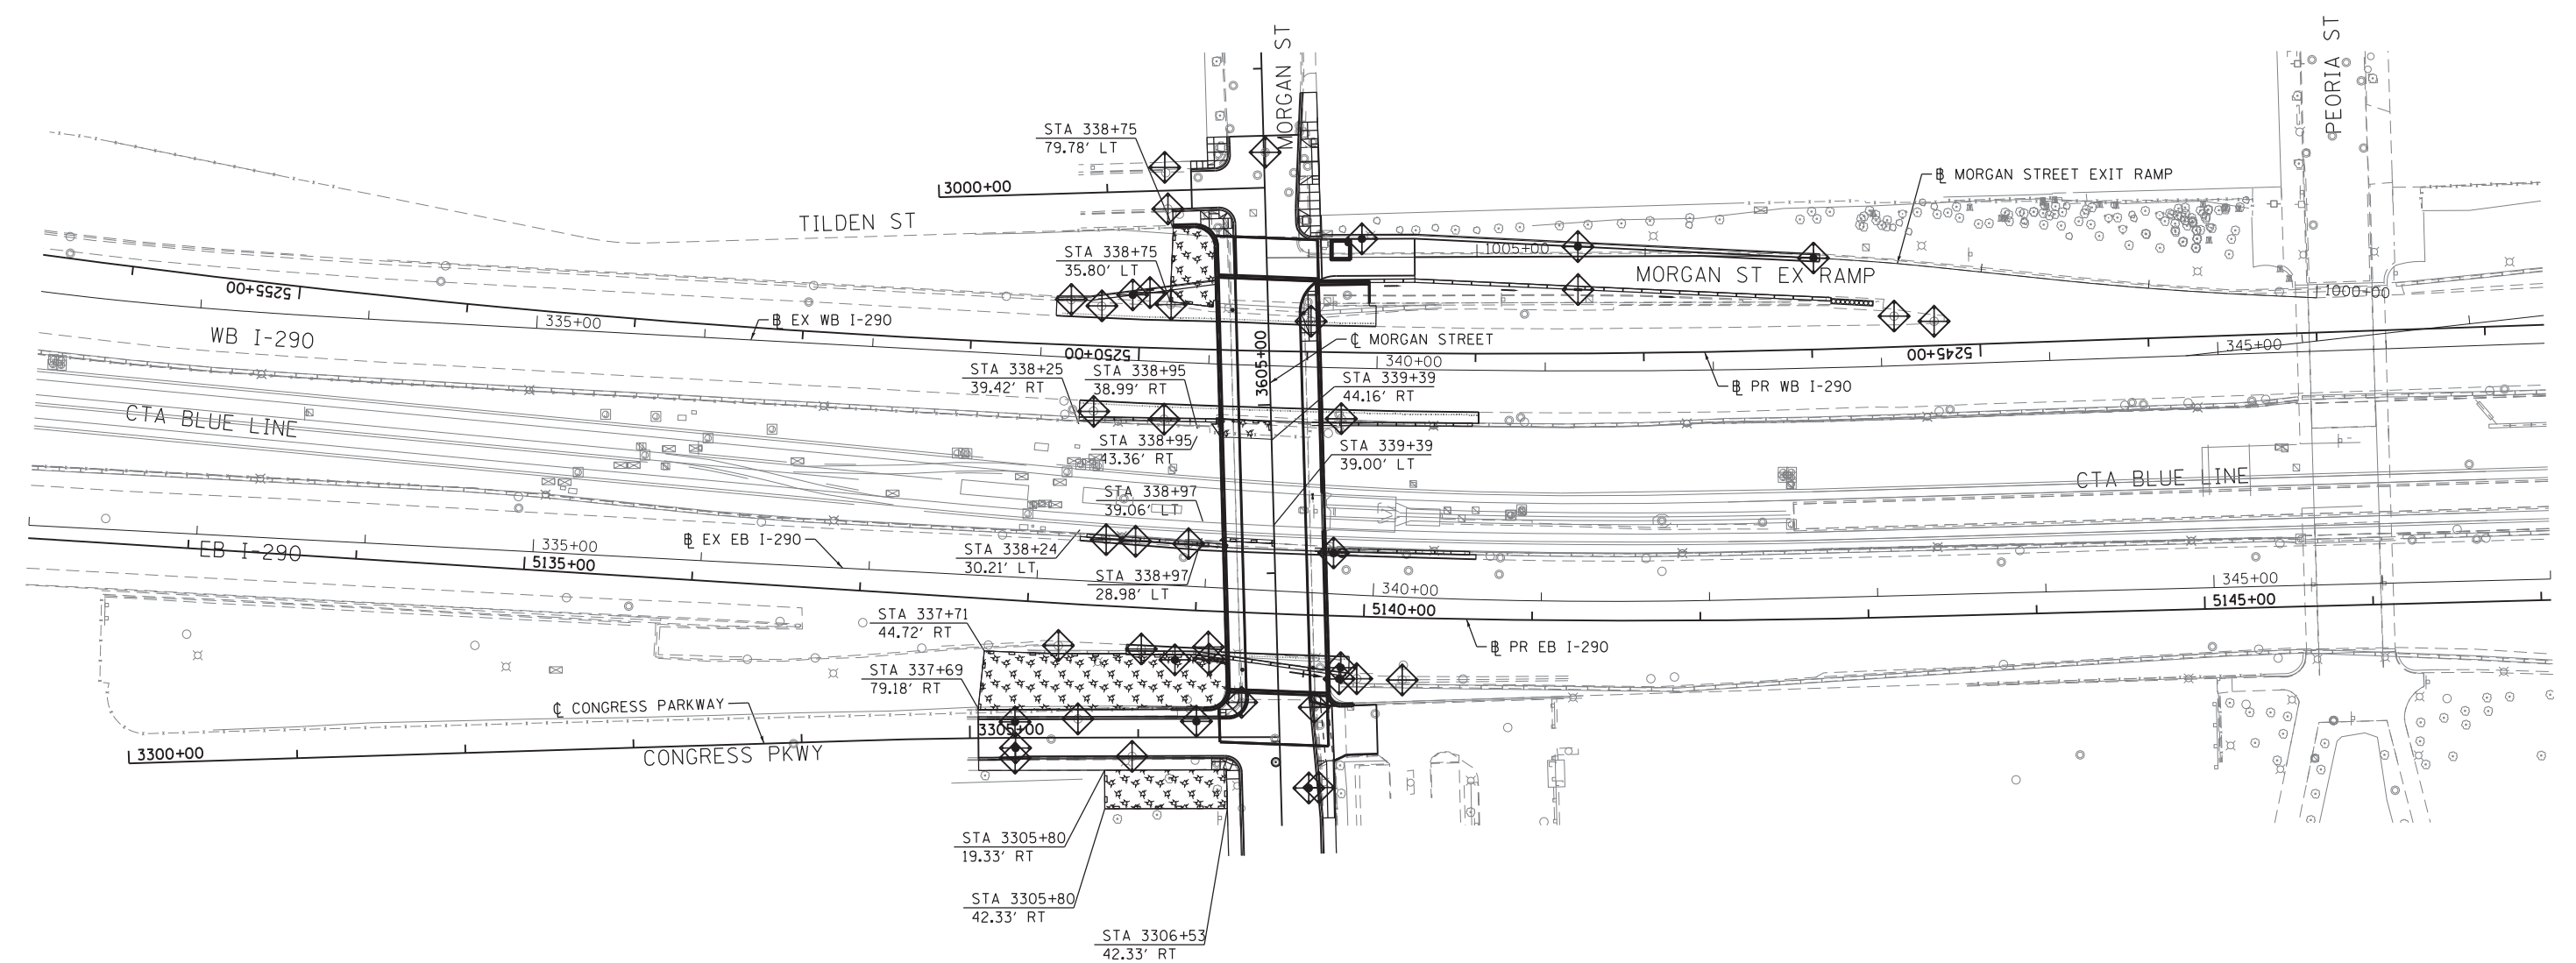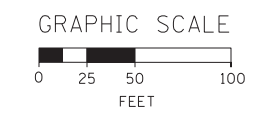

D160W25-sht-Eros-02  
 USER NAME = chitua  
 PLOT SCALE = 50.0000' / in.  
 PLOT DATE = 6/14/2013

DESIGNED - OPS	REVISED -
DRAWN - OPS	REVISED -
CHECKED - DBM	REVISED -
DATE - 6/17/2013	REVISED -

**STATE OF ILLINOIS  
 DEPARTMENT OF TRANSPORTATION**

**EROSION AND SEDIMENTATION CONTROL PLAN  
 STAGE 2**

SCALE: 1" = 50' SHEET 2 OF 3 SHEETS STA. TO STA.

F.A.I. RTE.	SECTION	COUNTY	TOTAL SHEETS	SHEET NO.
90/94/290	2013-007R	COOK	317	80
CONTRACT NO. 60W25				
ILLINOIS FED. AID PROJECT				