# STATE OF ILLINOIS DEPARTMENT OF TRANSPORTATION

FOR INDEX OF SHEETS, SEE SHEET NO. 2 FOR LIST OF HIGHWAY STANDARDS, SEE SHEET NO. 2

PROJECT LOCATED IN THE CITY OF CHICAGO

TRAFFIC DATA
MICHIGAN AVE.
ADT: 7,500
POSTED SPEED: 30 MPH
DESIGN DESIGNATION: MINOR ARTERIAL

I-55
ADT: 129,000
POSTED SPEED: 45 MPH
DESIGN DESIGNATION: INTERSTATE

## PROPOSED HIGHWAY PLANS

FAU 2911 – MICHIGAN AVENUE OVER I-55 SECTION FAU 2911 22 BJ PROJECT NO: HBFP-RG6J(998) BRIDGE DECK OVERLAY AND JOINT REPAIR COOK COUNTY

APPLY TO SHEETS: 1-25, 40-53

0

0

SCHOOL STORM

HUGH E. REGAN

HNTB NO.: 062072743 DATE SIGNED: 426/2024 EXP. DATE: 11/30/2025 APPLY TO SHEETS: 26-39

LUKE C. MARTIN

GKF IIC

LUKE C. MARTIN GKE, LLC NO.: 081007429 DATE SIGNED: 4/26/2024 EXP. DATE: 11/30/2024

M B S'

188' 288' 380' 1" = 100'

10' 28' 38' 1" = 18'

58' 100' 1" = 50'

100' 1" = 40'

0 58' 100' - 1" = 30'


6 56' 100' - 1" = 20'

FULL SIZE PLANS HAVE BEEN PREPARED USING STANDARD ENGINEERING SCALES. REDUCED SIZED PLANS WILL NOT CONFORM TO STANDARD SCALES. IN MAKING MEASUREMENTS ON REDUCED PLANS, THE ABOVE SCALES MAY BE USED.

J.U.L.E. JOINT UTILITY LOCATION INFORMATION FOR EXCAVATORS 1–800–892–0123 OR 811

PROJECT ENGINEER: PRAVEEN KAINI (847) 705-4237
PROJECT MANAGER: JEAN ALAIN MIDY (847) 221-3056

C-91-358-22 R 14 E

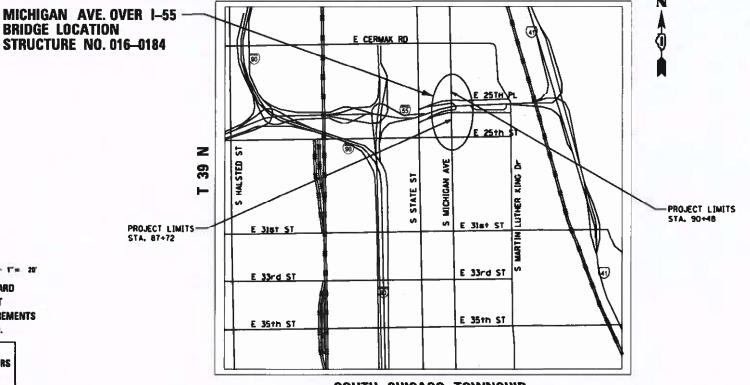

SOUTH CHICAGO TOWNSHIP

#### PROJECT LENGTH

GROSS LENGTH = 276 FT. = 0.05 MILE NET LENGTH = 276 FT. = 0.05 MILE

**CONTRACT NO. 62T49** 

D-91-304-22





HNTB



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#### **GENERAL NOTES**

- BEFORE STARTING ANY EXCAVATION, THE CONTRACTOR SHALL CALL JULIE AT (800) 892-0123 OR 811 TO DETERMINE WHICH UTILITIES ARE WITHIN THE AREA. 48 HOUR NOTIFICATION IS REQUIRED.
- THE CONTRACTOR SHALL COORDINATE CONSTRUCTION ACTIVITIES WITH UTILITY COMPANIES AS REQUIRED.
- 3. THE CONTRACTOR WILL NOT BE ALLOWED TO SET UP A YARD OR FIELD OFFICE ON STATE PROPERTY WITHOUT WRITTEN PERMISSION FROM THE DEPARTMENT.
- 4. WHEN ARTIFICIAL LIGHTING IS UTILIZED IN NIGHT OPERATIONS THE CONTRACTOR SHALL EXERCISE THE UTMOST PRECAUTIONS IN PREVENTING ADVERSE VISIBILITY TO THE MOTORING PUBLIC AND ADJACENT RESIDENTIAL AREAS.
- 5. THE ALIGNMENTS AND SUPPORTING DATA SHOWN IN THE PLANS WERE DEVELOPED THROUGH AERIAL PHOTOGRAPHY AND IS NOT THE RESULT OF A GROUND SURVEY. THEREFORE, THE ALIGNMENTS AND SUPPORTING DATA SHOWN IN THE PLANS ARE FOR REFERENCE PURPOSES ONLY. THE RELATIVE ACCURACY OF THE INFORMATION IS UNKNOWN AND CANNOT BE GUARANTEED. THE CONTRACTOR MAY BE REQUIRED TO ADJUST LAYOUT TO MATCH ACTUAL FIELD CONDITIONS AND THE INTENT OF THE PLANS.
- 6. THE CONTRACTOR SHALL SWEEP AND CLEAN THE PAVEMENT SURFACE, PER ARTICLE 107.15 OF THE STANDARD SPECIFICATIONS AND AS DIRECTED BY THE ENGINEER.
- 7. BEFORE BEGINNING ANY WORK, THE CONTRACTOR SHALL RETAIN AND RECORD (FOR FUTURE REFERENCES), ALL EXISTING PAVEMENT MARKING LINES IN ORDER THAT THESE LOCATIONS CAN BE RE-ESTABLISHED FOR STRIPING. EXACT LOCATIONS OF ALL STRIPING SHALL BE AS DIRECTED BY THE ENGINEER.
- 8. THE CONTRACTOR SHALL PROTECT EXISTING UTILITIES AND SHALL BRACE AND SUPPORT THE UTILITIES PROPERLY IN ORDER TO PREVENT SETTLEMENT, DISPLACEMENT, OR DAMAGE TO THE UTILITIES. THE PROTECTION OF THE UTILITIES AS SPECIFIED HEREIN WILL NOT BE PAID FOR SEPARATELY, BUT SHALL BE CONSIDERED INCLUDED IN THE CONTRACT
- 9. THE CONTRACTOR SHALL TAKE CARE IN REMOVING OR EXCAVATING NEAR ALL EXISTING ITEMS WHICH WILL REMAIN. ANY DAMAGE DONE TO EXISTING ITEMS BY THE CONTRACTOR SHALL BE REPAIRED AT THE CONTRACTOR'S EXPENSE.
- 10. THE CONTRACTOR IS RESPONSIBLE FOR MAINTAINING DRAINAGE THROUGHOUT THE CONSTRUCTION OF THIS PROJECT. THIS WORK WILL NOT BE PAID FOR SEPARATELY AND SHALL BE CONSIDERED INCLUDED IN THE COST OF THE CONTRACT.
- 11. NO WORK SHALL COMMENCE UNTIL TRAFFIC CONTROL REQUIREMENTS ARE MET.
- 12. IT SHALL BE THE CONTRACTOR'S RESPONSIBILITY TO VERIFY ALL DIMENSIONS AND CONDITIONS EXISTING IN THE FIELD PRIOR TO ORDERING MATERIALS AND BEGINNING CONSTRUCTION.
- 13. COORDINATION WITH IDOT BUREAU OF TRAFFIC EXPRESSWAYS WILL BE REQUIRED FOR TRAFFIC CONTROL ON SB 1-55. IN THE SB DIRECTION, FULL RAMP CLOSURES FROM LAKE SHORE DRIVE TO 1-55 IS PERMITTED AND WILL BE PER 2-LANE CLOSURE ALLOWABLE HOURS.
- 14. TWO WEEKS PRIOR TO PLACEMENT OF PERMANENT PAVEMENT MARKINGS ON IDOT ARTERIAL ROADS, THE ENGINEER SHALL CONTACT PATRICE HARRIS, AREA TRAFFIC FIELD TECHNICIAN AT Patrice.Harris@illinois.gov.
- 15. THE CONTRACTOR SHALL CONTACT KALPANA KANNAN-HOSADURGA, THE DISTRICT ONE TRAFFIC CONTROL SUPERVISOR, AT Kalpana.Kannan-Hosadurga@illinois.gov A MINIMUM OF 72 HOURS IN ADVANCE OF BEGINNING WORK.
- 16. THE CONTRACTOR SHALL CONTACT THE DISTRICT ONE EXPRESSWAYS TRAFFIC CONTROL SUPERVISOR, CARLOS MUNOZ, AT Carlos.Munoz@illinois.gov A MINIMUM OF 72 HOURS IN ADVANCE OF BEGINNING WORK
- 17. THE CONTRACTOR SHALL REQUEST AND GAIN APPROVAL FROM THE ILLINOIS DEPARTMENT OF TRANSPORTATION EXPRESSWAY TRAFFIC OPERATIONS ENGINEER AT WWW.IDOTLCS.COM TWENTY-FOUR (24) HOURS IN ADVANCE OF ALL DAILY LANE, RAMP, AND SHOULDER CLOSURES AND 7 DAYS IN ADVANCE OF ALL PERMANENT AND WEEKEND CLOSURES ON ALL FREEWAYS AND/OR EXPRESSWAYS IN DISTRICT ONE.
- 18. THE CTA REQUIRES THAT NO TWO CONSECUTIVE BUS STOPS IN ONE DIRECTION OF TRAVEL ARE ELIMINATED AT THE SAME TIME. THE CONTRACTOR SHALL SUBSTAGE WORK AS NECESSARY OR PROVIDE TEMPORARY ADA COMPLIANT PEDESTRIAN ACCESS THROUGH THE WORK ZONE TO AN EXISTING OR TEMPORARILY RELOCATED BUS STOP.
- 19. CTA TRAFFIC PLANNING MUST BE NOTIFIED AT LEAST 2 WEEKS IN ADVANCE OF THE TIME CONSTRUCTION WILL COMMENCE, AND IN ADVANCE OF ANY IMPACT TO BUS STOPS OR BUS OPERATIONS. TRAFFIC.PLANNING@TRANSITCHICAGO.COM.
- 20. IF CTA BUS STOP SIGNS ARE TO BE IMPACTED BY CONSTRUCTION, SIGNS & POLES ARE TO BE REMOVED/REINSTALLED BY CTA FORCES.

#### INDEX OF SHEETS

1	COVER SHEET
2	GENERAL NOTES, INDEX OF SHEETS, STANDARD DRAWINGS
3 <b>-</b> 6	SUMMARY OF QUANTITIES
7	SCHEDULE OF QUANTITIES
8	REMOVAL AND PROPOSED PLAN
9	ROADWAY DETAILS
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11 - 15	DETOUR ROUTE
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18 - 19	MOT STAGING PLANS
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26 - 39	STRUCTURAL PLANS
40 - 53	D1 HIGHWAY STANDARDS

#### **IDOT STANDARD DRAWINGS**

STANDARD NUMBERS	DESCRIPTION
000001-08	STANDARD SYMBOLS, ABBREVIATIONS AND PATTERNS
280001-07	TEMPORARY EROSION CONTROL SYSTEMS
442201-03	CLASS C AND D PATCHES
606001-08	CONCRETE CURB TYPE B AND COMBINATION CONCRETE CURB AND GUTTER
701101-05	OFF ROAD OPERATIONS, MULTILANE, 15' TO (4.5 m) TO 24" (600 mm)
	FROM PAVEMENT EDGE
701106-02	OFF ROAD OPERATIONS, MULTILANE, MORE THAN 15' (4.5 m) AWAY
701301-04	LANE CLOSURE, 2L, 2W, SHORT TIME OPERATIONS
701311-03	LANE CLOSURE, 2L, 2W, MOVING OPERATIONS - DAY ONLY
701400-12	APPROACH TO LANE CLOSURE, FREEWAY/EXPRESSWAY
701401-13	LANE CLOSURE, FREEWAY/EXPRESSWAY
701411-09	LANE CLOSURE, MULTILANE, AT ENTRANCE OR EXIT RAMP, FOR SPEEDS
	>= 45 MPH
701427-05	LANE CLOSURE, MULTILANE, INTERMITTENT OR MOVING
	OPER., FOR SPEEDS <= 40 MPH
701428-01	TRAFFIC CONTROL SETUP AND REMOVAL FREEWAY/EXPRESSWAY
701446-11	TWO LANE CLOSURE, FREEWAY/EXPRESSWAY
701501-06	URBAN LANE CLOSURE, 2L, 2W, UNDIVIDED
701601-09	URBAN LANE CLOSURE, MULTILANE, 1W OR 2W WITH NON TRAVERSABLE
	MEDIAN
701602-10	URBAN LANE CLOSURE, MULTILANE, 2W WITH BIDIRECTIONAL LEFT TURN
701606 10	LANE
701606-10	URBAN SINGLE LANE CLOSURE, MULTILANE, 2W WITH MOUNTABLE MEDIAN
701611-01	URBAN HALF ROAD CLOSURE, MULTILANE, 2W WITH MOUNTABLE MEDIAN
701701-10	URBAN LANE CLOSURE, MULTILANE INTERSECTION
701801-06	SIDEWALK, CORNER OR CROSSWALK CLOSURE
701901-09 704001-08	TRAFFIC CONTROL DEVICES
/04001-08	TEMPORARY CONCRETE BARRIER

#### DISTRICT 1 STANDARD DRAWINGS

STANDARD NUMBERS	DESCRIPTION
BD <b>-</b> 32	BUTT JOINT AND HMA TAPER DETAILS
BM-20	PRUNING FOR SAFETY AND EQUIPMENT CLEARANCE
TC-08	ENTRANCE AND EXIT RAMP CLOSURE DETAILS
TC-09	TRAFFIC CONTROL DETAILS FOR FREEWAY SINGLE AND MULTI-LANE WEAVE
TC-10	TRAFFIC CONTROL AND PROTECTION FOR SIDE ROAD, INTERSECTIONS, AND
	DRIVEWAYS
TC-14	TRAFFIC CONTROL AND PROTECTION AT TURN BAYS (TO REMAIN OPEN TO
	TRAFFIC)
TC-16	SHORT TERM PAVEMENT MARKING LETTERS AND SYMBOLS
TC-17	TRAFFIC CONTROL DETAILS FOR FREEWAY SHOULDER CLOSURES AND
	PARTIAL RAMP CLOSURES
TC-21	DETOUR SIGNING FOR CLOSING STATE HIGHWAYS
TC-22	ARTERIAL ROAD INFORMATION SIGN
TC-24	CITY OF CHICAGO TYPICAL PAVEMENT MARKINGS
TC-26	DRIVEWAY ENTRANCE SIGNING

SCALE:

		GE	NERAL NO	TES		F.A.U. RTE	SECT	ПОИ	COUNTY	TOTAL SHEETS	SHEET NO.
INI	DEX DE	CHEETS	AND STA	MDVBD	DRAWINGS	2911	FAU 291	1 22 BJ	соок	53	2
1141	DLX OI V	JIILLIJ	AIND SIA	INDAILD	DIIAWINGS				CONTRACT	NO. 62	2T49
	SHEET	OF	SHEETS	STA.	TO STA.			ILLINOIS FED. A	ID PROJECT		

				CONSTRUCTION CODE
				80% FED/20% STATE
CODE			TOTAL	BRIDGE REHABILITATION 0059
NO.	ITEM	UNIT	QUANTITY	URBAN
				SN. 016-0184
40600290	BITUMINOUS MATERIALS (TACK COAT)	POUND	186	186
40504050		T01/	2.5	2.5
40604062	HOT-MIX ASPHALT SURFACE COURSE, IL-9.5, MIX "D", N70	TON	35	35
40600985	PORTLAND CEMENT CONCRETE SURFACE REMOVAL - BUTT JOINT	SQ YD	414	414
42400300	PORTLAND CEMENT CONCRETE SIDEWALK 6 INCH	SQ FT	240.0	240.0
44000600	SIDEWALK REMOVAL	SQ FT	240	240
44201201	CLASS C DATGUES TYPE I C INCH	60. VD	F.4	F.4
44201301	CLASS C PATCHES, TYPE I, 6 INCH	SQ YD	54	54
44213200	SAW CUTS	FOOT	272	272
50102400	CONCRETE REMOVAL	CU YD	21.9	21.9
30102400	CONCRETE REMOVAL	CO ID	21,9	21.9
50157300	PROTECTIVE SHIELD	SQ YD	1,888	1,888
50300255	CONCRETE SUPERSTRUCTURE	CU YD	23.7	23.7
30300233	CONCRETE SOFERSTROCTORE	CO 1B	2317	23.7
50300260	BRIDGE DECK GROOVING	SQ YD	1,510	1,510
50300300	PROTECTIVE COAT	SQ YD	1,543	1,543
30300300		39 10	1,545	1,373
50800205	REINFORCEMENT BARS, EPOXY COATED	POUND	2,830	2,830
50800515	BAR SPLICERS	EACH	44	44
3333313		2,1011		

GARZA KARHOFF ENGINEERING, LLC
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	USER NAME = Michael.Czerpak	DESIGNED - MAC	REVISED -
		DRAWN - MAC	REVISED -
	PLOT SCALE = 2.0000 / in.	CHECKED - AMB	REVISED -
2	PLOT DATE = 5/6/2024	DATE - 04/26/2024	REVISED -

SCALE:

							F.A.U. RTE	SECTION			COUNTY	TOTAL SHEETS	
	SUMMARY OF QUANTITIES		2911	FAU 2911 22	BJ		соок	53	3				
											CONTRACT	F NO. 63	2T49
SHEET	1	OF	4	SHEETS	STA.	TO STA.		ILLINO	IS F	FED. AI	D PROJECT		

CONSTRUCTION CODE

				00% FED/20% STATE
CODE	ITEM	UNIT	TOTAL	BRIDGE REHABILITATION 0059
NO.			QUANTITY	URBAN SN. 016-0184
				311. 010-0184
52000110	PREFORMED JOINT STRIP SEAL	FOOT	161	161
58700300	CONCRETE SEALER	SQ FT	237	237
67100100	MODILIZATION		1	1
6/100100	MOBILIZATION	L SUM	1	1
70107025	CHANGEABLE MESSAGE SIGN	CAL DA	182	182
70300150	SHORT TERM PAVEMENT MARKING REMOVAL	SQ FT	1,760	1,760
70307100	TEMPORARY PAVEMENT MARKING LETTERS AND SYMBOLS - TYPE IV TAPE	SQ FT	39	39
-				
70307120	TEMPORARY PAVEMENT MARKING - LINE 4" - TYPE IV TAPE	FOOT	4,299	4,299
/030/130	TEMPORARY PAVEMENT MARKING - LINE 6" - TYPE IV TAPE	FOOT	112	112
70307210	TEMPORARY PAVEMENT MARKING - LINE 24"- TYPE IV TAPE	FOOT	110	110
70400100	TEMPORARY CONCRETE BARRIER	FOOT	450.0	450.0
70400200	RELOCATE TEMPORARY CONCRETE BARRIER	FOOT	450.0	450.0
70600241	IMPACT ATTENUATORS, TEMPORARY (NON- REDIRECTIVE, NARROW), TEST LEVEL 2	EACH	4	4
ļ				
70600341	IMPACT ATTENHATORS DELOCATE (NON DEDIRECTIVE NARROW). TEST LEVEL 2	E A C. I.	A	Α.
70600341	IMPACT ATTENUATORS, RELOCATE (NON- REDIRECTIVE, NARROW), TEST LEVEL 2	EACH	4	4
78000200	THERMOPLASTIC PAVEMENT MARKING - LINE 4"	FOOT	1,560	1,560
. 5555255	THE T	1001	1,550	1,300
	1	1	1	f.

**★** SPECIALTY ITEM



	USER NAME = Michael.Czerpak	DESIGNED - MAC	REVISED -
		DRAWN - MAC	REVISED -
	PLOT SCALE = 2.0000 / in.	CHECKED - AMB	REVISED -
	PLOT DATE = 5/6/2024	DATE - 04/26/2024	REVISED -
7			

SCALE:

						F.A.U. RTE	SECTION	COUNTY	TOTAL SHEETS	SHEET NO.
SUMMARY OF QUANTITIES				2911	FAU 2911 22 BJ	соок	53	4		
								CONTRAC	F NO. 63	2T49
SHEET	2	OF 4	SHEETS	STA.	TO STA.		ILLINOIS FE	D. AID PROJECT		

CONSTRUCTION CODE 80% FED/20% STATE

				80% FED/20% STATE	
				BRIDGE REHABILITATIO	
CODE	ITCM	11017	TOTAL	0059	
NO.	ITEM	UNIT	QUANTITY		
				SN. 016-0184	
78000400	THERMOPLASTIC PAVEMENT MARKING - LINE 6"	FOOT	670	670	
78000600	THERMOPLASTIC PAVEMENT MARKING - LINE 12"	FOOT	140	140	
78000650	THERMOPLASTIC PAVEMENT MARKING - LINE 24"	FOOT	130	130	
78004620	PREFORMED PLASTIC PAVEMENT MARKING, TYPE D - STANDARD - LINE 4"	FOOT	110	110	
78000000	MODIFIED LIBETHANE DAVEMENT MARKING LETTERS AND SVAROUS	50.57	77	7.7	
78009000	MODIFIED URETHANE PAVEMENT MARKING - LETTERS AND SYMBOLS	SQ FT	77	77	
78009004	MODIFIED URETHANE PAVEMENT MARKING - LINE 4"	FOOT	428	428	
78009006	MODIFIED URETHANE PAVEMENT MARKING - LINE 6"	FOOT	158	158	
78011025	GROOVING FOR RECESSED PAVEMENT MARKING 5"	FOOT	1,450	1,450	
78011035	GROOVING FOR RECESSED PAVEMENT MARKING 7"	FOOT	597	597	
78300202	PAVEMENT MARKING REMOVAL - WATER BLASTING	SQ FT	1,331	1,331	
K1004595	PRUNING FOR SAFETY AND EQUIPMENT CLEARANCE	L SUM	1	1	
X0322215	CLEANING BRIDGE SCUPPERS AND DOWNSPOUTS	EACH	4	4	
	CLEANING BRIDGE SCOTTERS AND DOWNSTOOTS	LACII	4	4	
X0326766	CLEAN & RESEAL RELIEF JOINT	FOOT	125	125	
X4400503		FOOT	120	120	

**★** SPECIALTY ITEM



	USER NAME = Michael.Czerpak	DESIGNED - MAC	REVISED -
		DRAWN - MAC	REVISED -
	PLOT SCALE = 2.0000 / in.	CHECKED - AMB	REVISED -
	PLOT DATE = 5/6/2024	DATE - 04/26/2024	REVISED -
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### STATE OF ILLINOIS DEPARTMENT OF TRANSPORTATION

SCALE:

							F.A.U. RTE	SECTION	COUNTY	TOTAL SHEETS	SHEET NO.
SUMMARY OF QUANTITIES					2911	FAU 2911 22 BJ	соок	53	5		
									CONTRAC	T NO. 6	2T49
SHEET	3	OF	4	SHEETS	STA.	TO STA.		ILLINOIS FE	D. AID PROJECT		

CONSTRUCTION CODE

				80% FED/20% STATE
CODE NO.	ITEM	UNIT	TOTAL QUANTITY	BRIDGE REHABILITATION 0059 URBAN SN. 016-0184
X6700407	ENGINEER'S FIELD OFFICE, TYPE A (D1)	CAL MO	6	6
X7010216	TRAFFIC CONTROL AND PROTECTION, (SPECIAL)	L SUM	1	1
X7011015	TRAFFIC CONTROL AND PROTECTION (EXPRESSWAYS)	L SUM	1	1
Z0006012	BRIDGE DECK LATEX CONCRETE OVERLAY, 2 1/4 INCHES	SQ YD	1,510	1,510
Z0012130	BRIDGE DECK SCARIFICATION 3/4"	SQ YD	1,510	1,510
Z0012754	STRUCTURAL REPAIR OF CONCRETE (DEPTH EQUAL TO OR LESS THAN 5 INCHES)	SQ FT	237	237
Z0016001	DECK SLAB REPAIR (FULL DEPTH, TYPE I)	SQ YD	1	1
Z0018051	DRAINAGE SCUPPERS TO BE ADJUSTED	EACH	4	4
Z0030850	TEMPORARY INFORMATION SIGNING	SQ FT	52	52
X6640638	TEMPORARY CONSTRUCTION FENCE	FOOT	292	292
X0325488	TRAFFIC SIGNAL TIMING OPTIMIZATION	L SUM	1	1

GARZA KARHOFF ENGINEERING, LLC
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	USER NAME = Michael.Czerpak	DESIGNED - MAC	REVISED =
		DRAWN MAC	REVISED -
F	PLOT SCALE = 2.0000 / in.	CHECKED AMB	REVISED =
	PLOT DATE = 5/6/2024	DATE 04/26/2024	REVISED +

SCALE:

CUMMANA DV OF CUMMITTIES						F.A.U. RTE.	SECTION	COUNTY TOTAL SHEET SHEETS NO.		
	SUMMARY OF QUANTITIES  SHEET 4 OF 4 SHEETS STA. TO STA.	•	2911	FAU 2911 22 BJ	соок	53	6			
								CONTRACT	NO. 62	2T49
SHEET	4	OF 4	SHEETS	STA.	TO STA.			D PROJECT		

CONSTRUCTION CODE

			PAVEMEN	NT AND REMOVAL SCHEE	DULE		
	LOCA	TION		HOT-MIX ASPHALT SURFACE COURSE, IL- 9.5, MIX "D", N70	PORTLAND CEMENT CONCRETE SURFACE REMOVAL - BUTT JOINT	CLASS C PATCHES, TYPE II, GINCH	COMBINATION CURB AND GUTTER REMOVAL AND REPLACEMENT GREATER THAN 10 FEET
				40604062	40600985	44201305	X4400503
				(TON)	(SQ YD)	(SQ YD)	(FOOT)
FROM	OFFSET	ТО	OFFSET				
87+72.00	S APPROACH	88+02.00	S APPROACH	17.36	206.67		
90+18.00	N APPROACH	90+48.00	N APPROACH	17.36	206.67		
87+72.00	LT	88+02.00	LT			13.33	
87+72.00	RT	88+02.00	RT			13.33	
90+18.00	RT	90+48.00	RT			13.33	
90+18.00	RT	90+48.00	RT			13.33	
87+69.00	LT	87+99.00	LT				30
87+75.00	RT	88+05.00	RT				30
90+15.00	LT	90+45.00	LT				30
90+21.00	RT	90+51.00	RT				30
			TOTAL	34.72	413.34	53.32	120
			USE	35	414	54	120

PERMANENT PAVEMENT MAKRKING SCHEDULE										
	THERMOPLASTIC PAVEMENT MARKING -	PREFORMED PLASTIC PAVEMENT MARKING,		MODIFIED URETHANE PAVEMENT MARKING -			GROOVING FOR RECESSED PAVEMENT			
LOCATION	LINE 4"	LINE 6"	LINE 12"	LINE 24"	TYPE D - LINE 4"	LETTERS AND SYMBOLS	LINE 4"	LINE 6"	MARKING 5"	MARKING 7"
	78000200	78000400	78000600	78000650	78004620	78009000	78009004	78009006	78011025	78011035
	(FOOT)	(FOOT)	(FOOT)	(FOOT)	(FOOT)	(FOOT)	(FOOT)	(FOOT)	(FOOT)	(FOOT)
SHEET 10	1560	670	140	130	110	77	428	158	1450	597
TOTAL	1560	670	140	130	110	77	428	158	1450	597


	TEMPOR	ARY PAVEMENT MAKRK	ING SCHEDULE	
LOCATION	TEMPORARY PAVEMENT MARKING LETTERS AND SYMBOLS - TYPE IV TAPE		TEMPORARY PAVEMENT MARKING - LINE 6" - TYPE IV TAPE	
	70307100	70307120	70307130	70307210
	(SQ FT)	(FOOT)	(FOOT)	(FOOT)
STAGE 1	39	2023	112	55
STAGE 2		2276		55
TOTAL	39	4299	112	110

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TILL CALL	GARZA KARHOFF	ŀ
1111	ENGINEERING, LLC	ŀ

USER NAME = Michael.Czerpak	DESIGNED	-	MAC	REVISED	-
	DRAWN	-	MAC	REVISED	-
PLOT SCALE = 0.2000 / in	CHECKED	-	AMB	REVISED	-
PLOT DATE = 4/26/2024	DATE	-	04/26/2024	REVISED	-

MICHIGAN AVE OVER I-55	F.A.U. SECTION			COUNTY	TOTAL SHEETS	SHEET NO.	
SCHEDULES OF QUANTITIES	2911	911 FAU 2911 22 BJ			COOK	53	7
SUILDOLLS OF GOARTIFIES					CONTRAC	T NO. 63	2T49
SCALE: N.T.S.   SHEET 1 OF 1 SHEETS STA. TO STA.			ILLINOIS	FED. AI	D PROJECT		


#### REMOVAL AND PROPOSED LEGEND

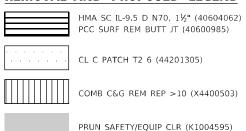


- SEE ROADWAY DETAILS FOR PAVEMENT OVERLAY AT BRIDGE APPROACH PAVEMENT
- \*\* CONTRACTOR TO VERIFY PATCHING LOCATIONS AS DIRECTED BY
- \*\*\* IDOT DISTRICT 1 STANDARD BM-20

HOT-MIX ASPHALT MIXTURE REQUIREMENTS		
MIXTURE TYPE	AIR VOIDS @ NODES	QMP
HMA OVERLAY & BUTT JOINT		
HOT-MIX ASPHALT SURFACE COURSE, IL-9.5, MIX "D", N70, 1½"	4% @ 70 GYR	QC/QA
QMP DESIGNATIONS: QUALITY CONTROL/QUALITY ASSURANCE (QC/QA)		

NOTES
1. THE UNIT WEIGHT USED TO CALCULATE ALL HMA SURFACE MIXTURE QUANTITIES IS 112 LBS/SQ YD/IN.
2. THE "AC TYPE" FOR POLYMERIZED HMA MIXES SHALL BE "SBS/SBR PG 76-22" AND FOR NON-POLYMERIZED HMA THE "AC TYPE" SHALL BE "PG 64-22" UNLESS MODIFIED BY RECLAIMED MATERIALS SPECIFICATIONS.

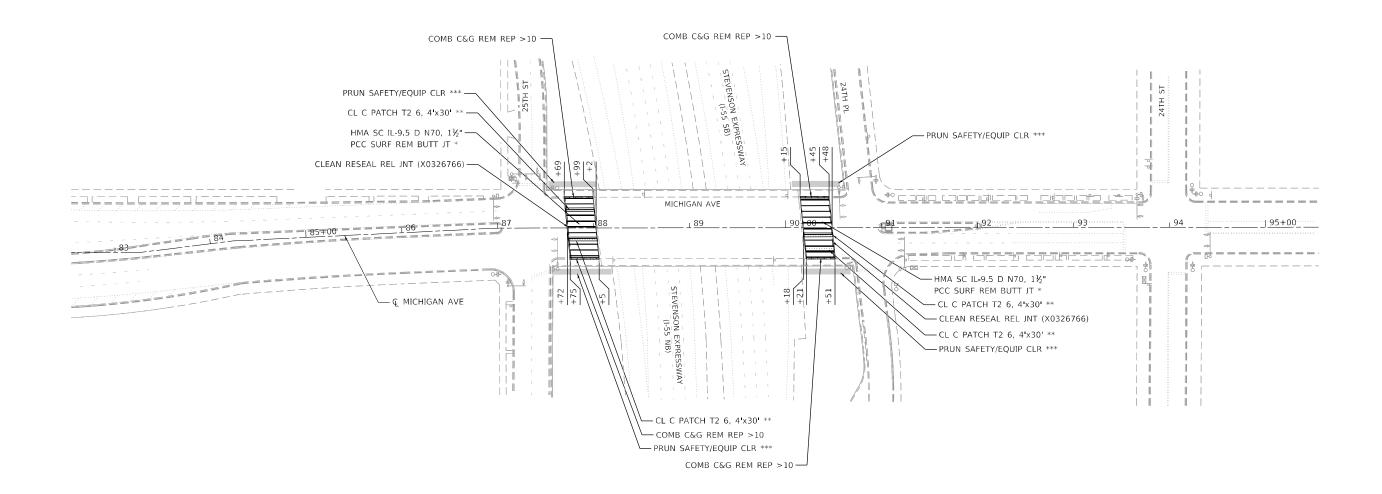

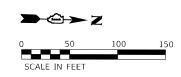


GARZA KARHOFF	
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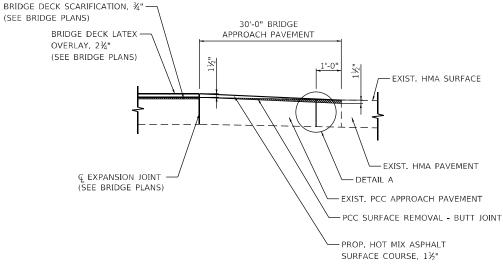
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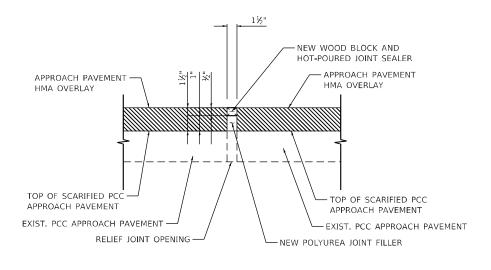
STATE OF ILLINOIS **DEPARTMENT OF TRANSPORTATION** 

MICHIGAN AVE OVER 1-55 REMOVAL AND PROPOSED PLAN									
SCALE: 1" = 50'	SHEET 1	OF	1	SHEETS	STA.	87+72	TO STA. 90+48		

F.A.U. RTE	SECTION		COUNTY	TOTAL SHEETS	SHEET NO.
2911	FAU 2911 22 B.	ı	соок	53	8
		CONTRACT	NO. 62	2T49	
	ILLINOIS	ID PROJECT			





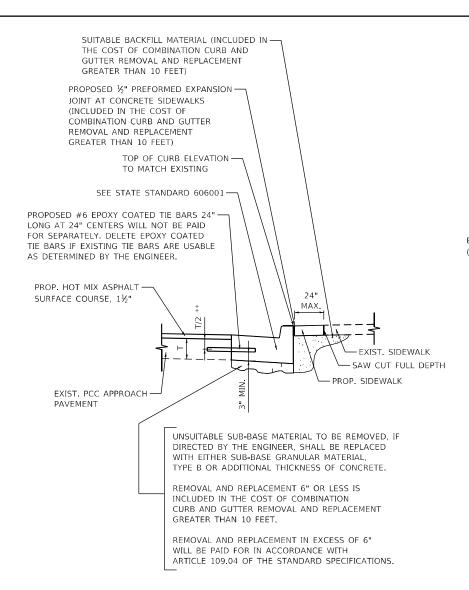

### COMBINATION CURB AND GUTTER REMOVAL AND REPLACEMENT GREATER THAN 10 FEET

\*\* 3" MINIMUM FROM TOP AND BOTTOM OF THE CONCRETE PAVEMENT OR BASE COURSE.

#### DETAIL NOTES

- COMB. CURB AND GUTTER REPLACEMENT SHALL MATCH THE SHAPE OF THE EXISTING CURB AND GUTTER UNLESS OTHERWISE SPECIFIED.
- LONGITUDINAL BARS, IF ENCOUNTERED IN THE EXISTING CURB AND GUTTER, ARE NOT TO BE REPLACED. CUTTING AND REMOVING LONGITUDINAL BARS SHALL BE INCLUDED IN THE COST OF COMBINATION CURB AND GUTTER REMOVAL AND REPLACEMENT GREATER THAN 10 FEET.
- THE REMOVAL AND REPLACEMENT OF THE EXISTING CURB AND GUTTER SHALL BE DONE IN ACCORDANCE WITH THE APPLICABLE PORTIONS OF SECTION 440 AND 606 OF THE STANDARD SPECIFICATIONS.
- 4. SIDEWALK SHALL BE REPLACED IN KIND AND AS DIRECTED BY THE ENGINEER.

### PAVEMENT OVERLAY AT BRIDGE APPROACH PAVEMENT

### DETAIL A CLEAN AND RESEAL RELIEF JOINT

#### DETAIL NOTES

- 1. SCARIFY APPROACH PAVEMENT AND RELIEF JOINT
- 2. PLACE POLYUREA JOINT FILLER AND WOOD BLOCK IN JOINT
- 3. PLACE HMA OVERLAY
- 4. AFTER HMA OVERLAY HAS COOLED, REMOVE WOOD BOCK AND PLACE HOT-POURED JOINT SEALER

GARZA KARHOFF ENGINEERING, LLC
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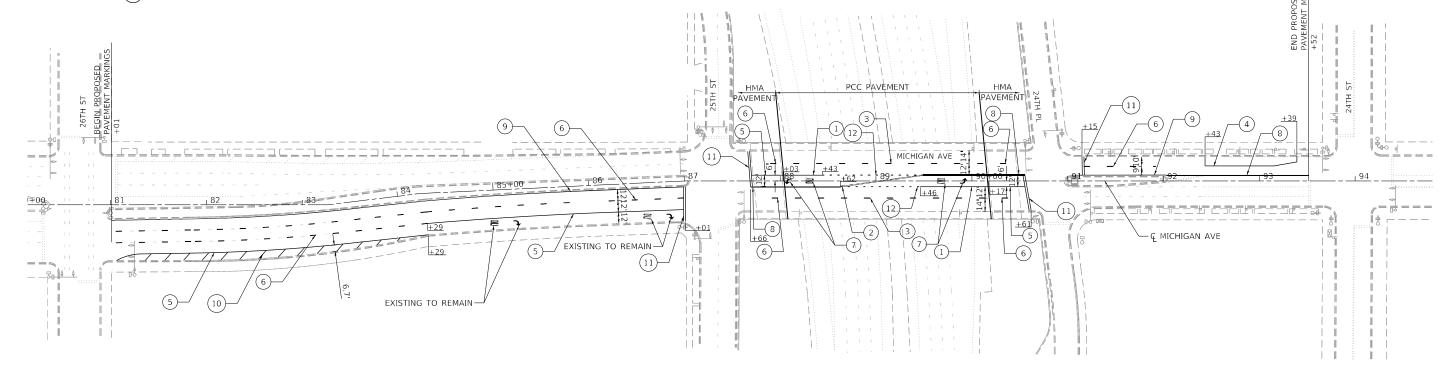
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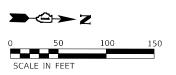
STATE OF ILLINOIS
DEPARTMENT OF TRANSPORTATION

MICHIGAN AVE OVER I–55									
ROADWAY DETAILS									
	SHEET :	1	OF	1	SHEETS	STA.	TO STA.		



- 1) MODIFIED URETHANE PAVEMENT MARKING, LINE 6" (WHITE EDGE LINES)
- 2) MODIFIED URETHANE PAVEMENT MARKING, DOUBLE, LINE 4" (YELLOW SOLID 2 @ 8")
- (3) PREFORMED PLASTIC PAVEMENT MARKING, TYPE D, STANDARD, LINE 4" (6' DASH, 18' SKIP) (1.5" BLACK, 4" WHITE, 1.5" BLACK)
- (4) THERMOPLASTIC PAVEMENT MARKING, STANDARD, LINE 4" (WHITE EDGE LINES)
- 5 THERMOPLASTIC PAVEMENT MARKING, STANDARD, LINE 6" (WHITE EDGE LINE)
- (6) THERMOPLASTIC PAVEMENT MARKING, STANDARD, LINE 4" (WHITE 6' DASH, 18' SKIP)
- (7) MODIFIED URETHANE PAVEMENT MARKING, LETTERS AND SYMBOLS
- (8) THERMOPLASTIC PAVEMENT MARKING, DOUBLE, LINE 4" (YELLOW SOLID 2 @ 8")
- (9) THERMOPLASTIC PAVEMENT MARKING, STANDARD, LINE 4" (YELLOW EDGE LINES)
- (10) THERMOPLASTIC PAVEMENT MARKING, STANDARD, LINE 12" (WHITE GORE MARKING)
- (11) THERMOPLASTIC PAVEMENT MARKINGS, STANDARD, LINE 24" (WHITE STOP BAR)
- (12) MODIFIED URETHANE PAVEMENT MARKING, LINE 6" (WHITE 2' DASH, 6' SKIP)








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STATE C	F ILLINOIS
DEPARTMENT OF	TRANSPORTATION

MICHIGAN AVE OVER I-55										
PROPOSED PAVEMENT MARKINGS										
SCALE: 1" = 50'	SHEET 1	OF	1	SHEETS	STA. 8	4+05	TO STA.	105+00		

F.A.B.	SECT	TION	COUNTY	TOTAL	SHEE	
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2911	FAU 291	.1 22 BJ		COOK	53	10
			CONTRACT	NO. 62	2T49	
		D PROJECT				

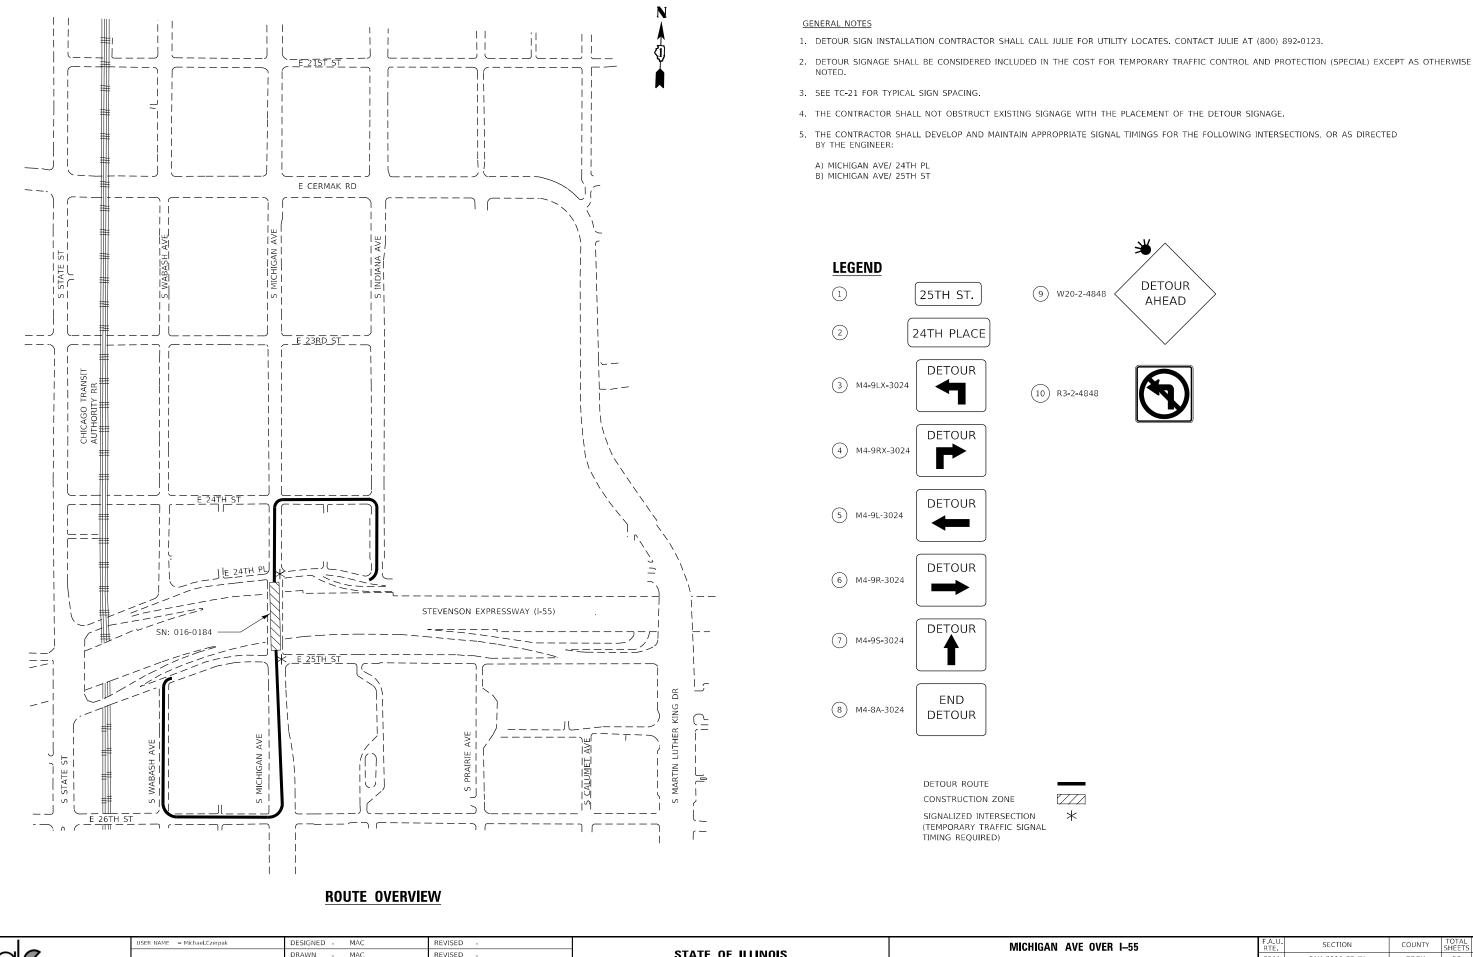

FILE NAME: D9130422

GARZA KARHOFF ENGINEERING, LLC

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PLOT DATE = 4/26/2024

CHECKED

DATE

AMB

04/26/2024

REVISED

REVISED


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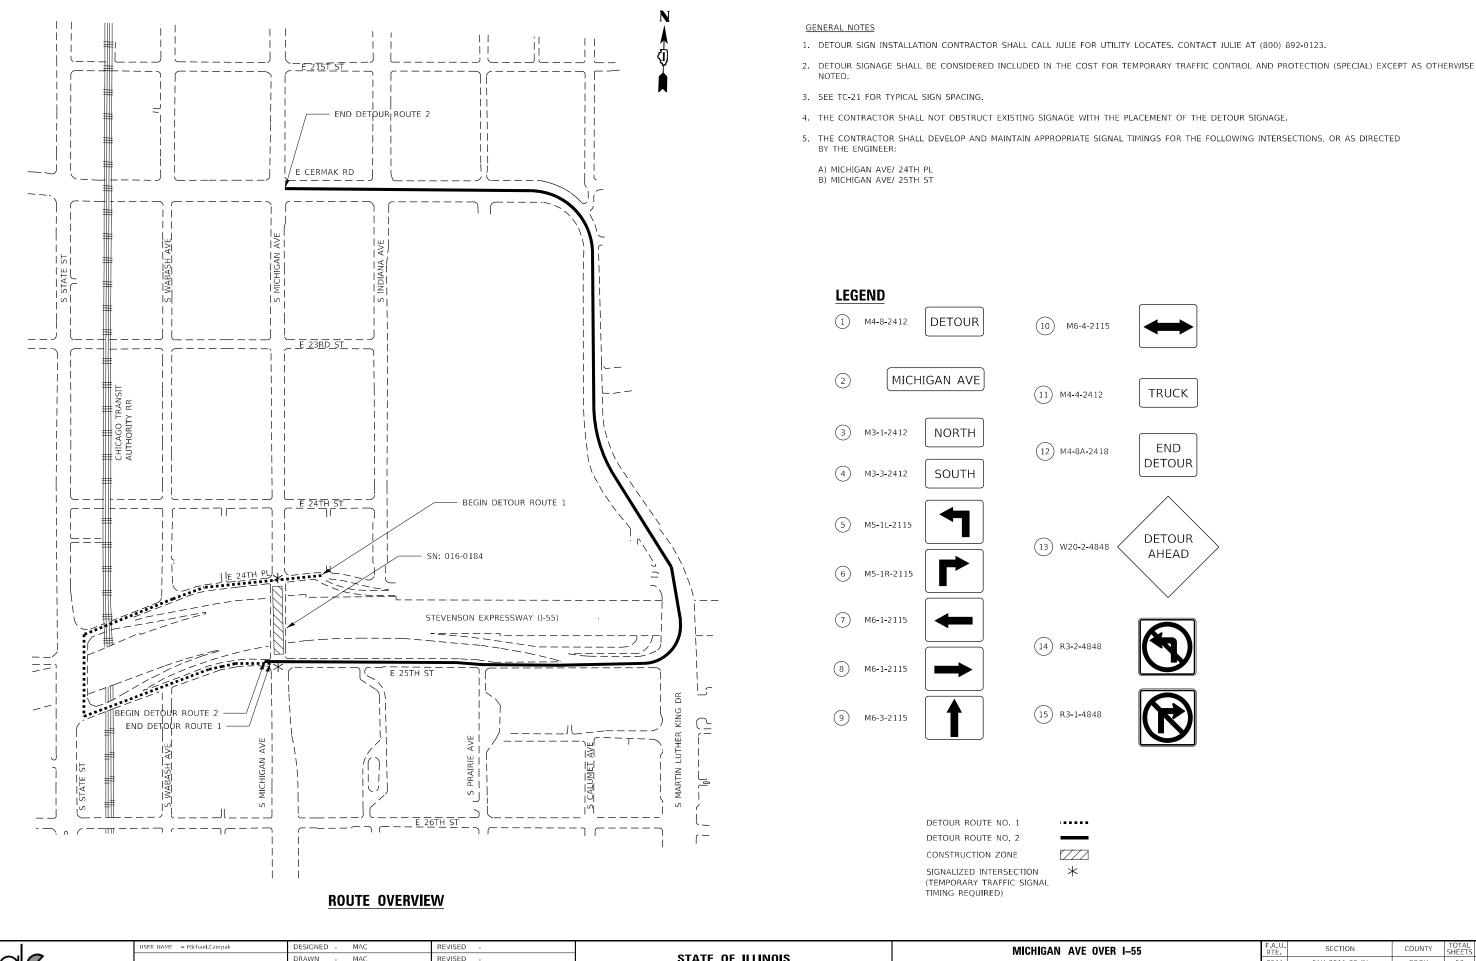
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MICHIGAN AVE OVER I-55
DETOUR ROUTE OVERVIEW

SHEET 1 OF 1 SHEETS STA. TO STA.

F.A. U. SECTION COUNTY TOTAL SHEETS NO. 2911 FAU 2911 22 BJ COOK 53 11. CONTRACT NO. 62T49



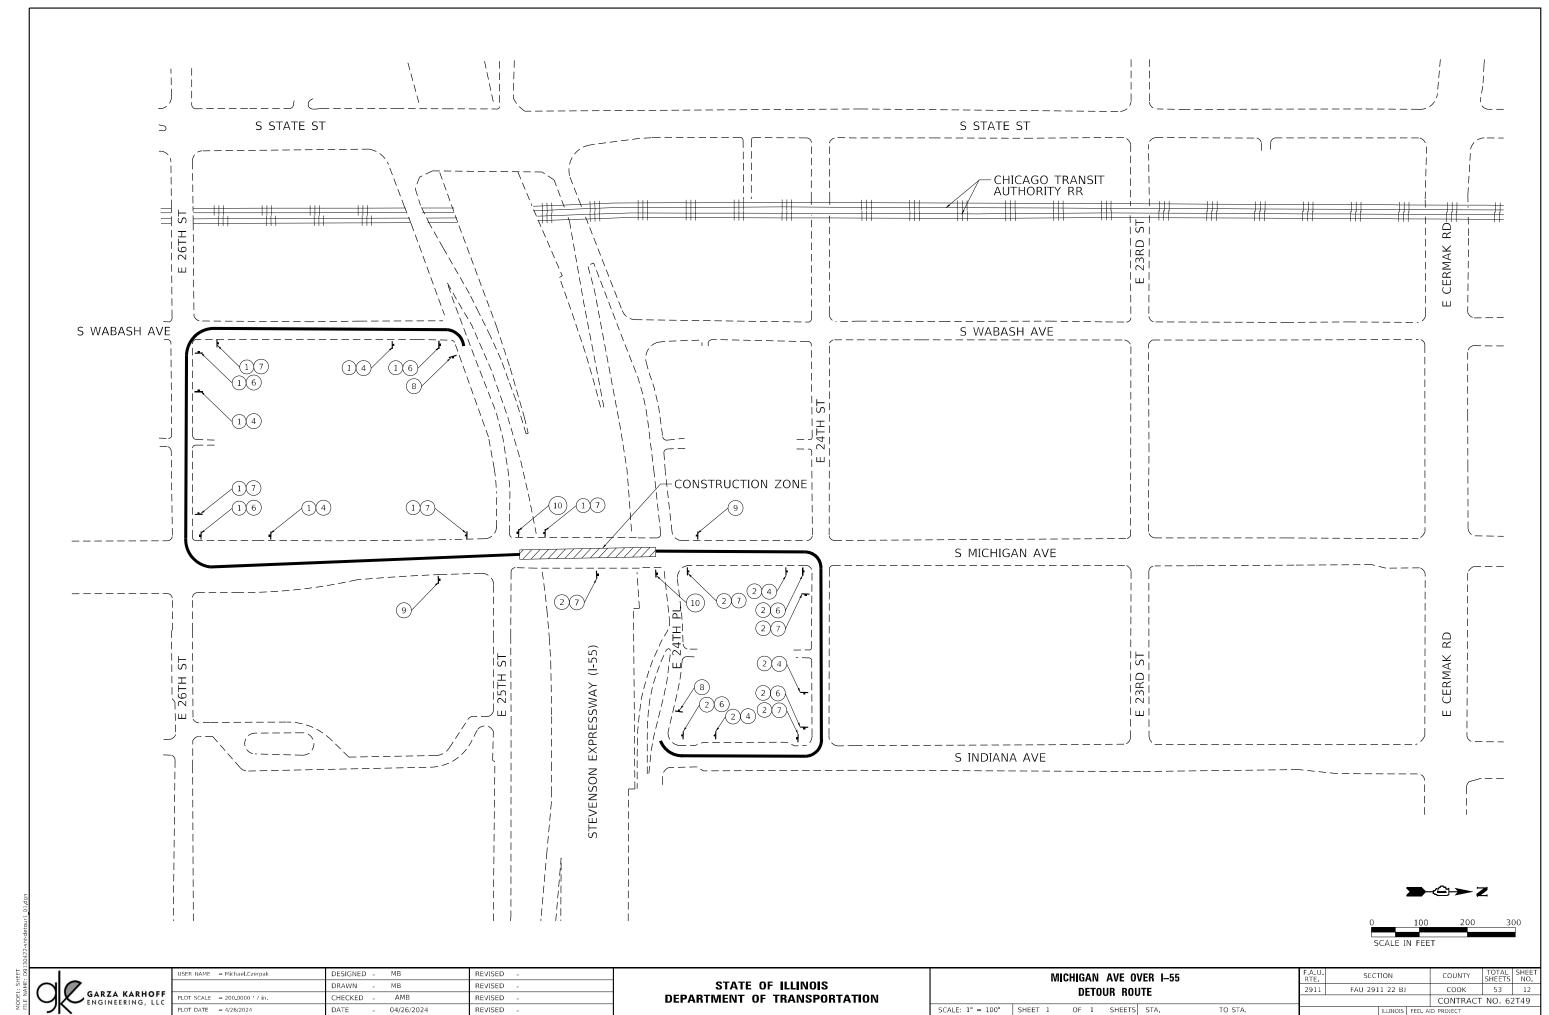

GARZA KARHOFF ENGINEERING, LLC

PLOT SCALE = 200.0000 / in.

PLOT DATE = 4/26/2024

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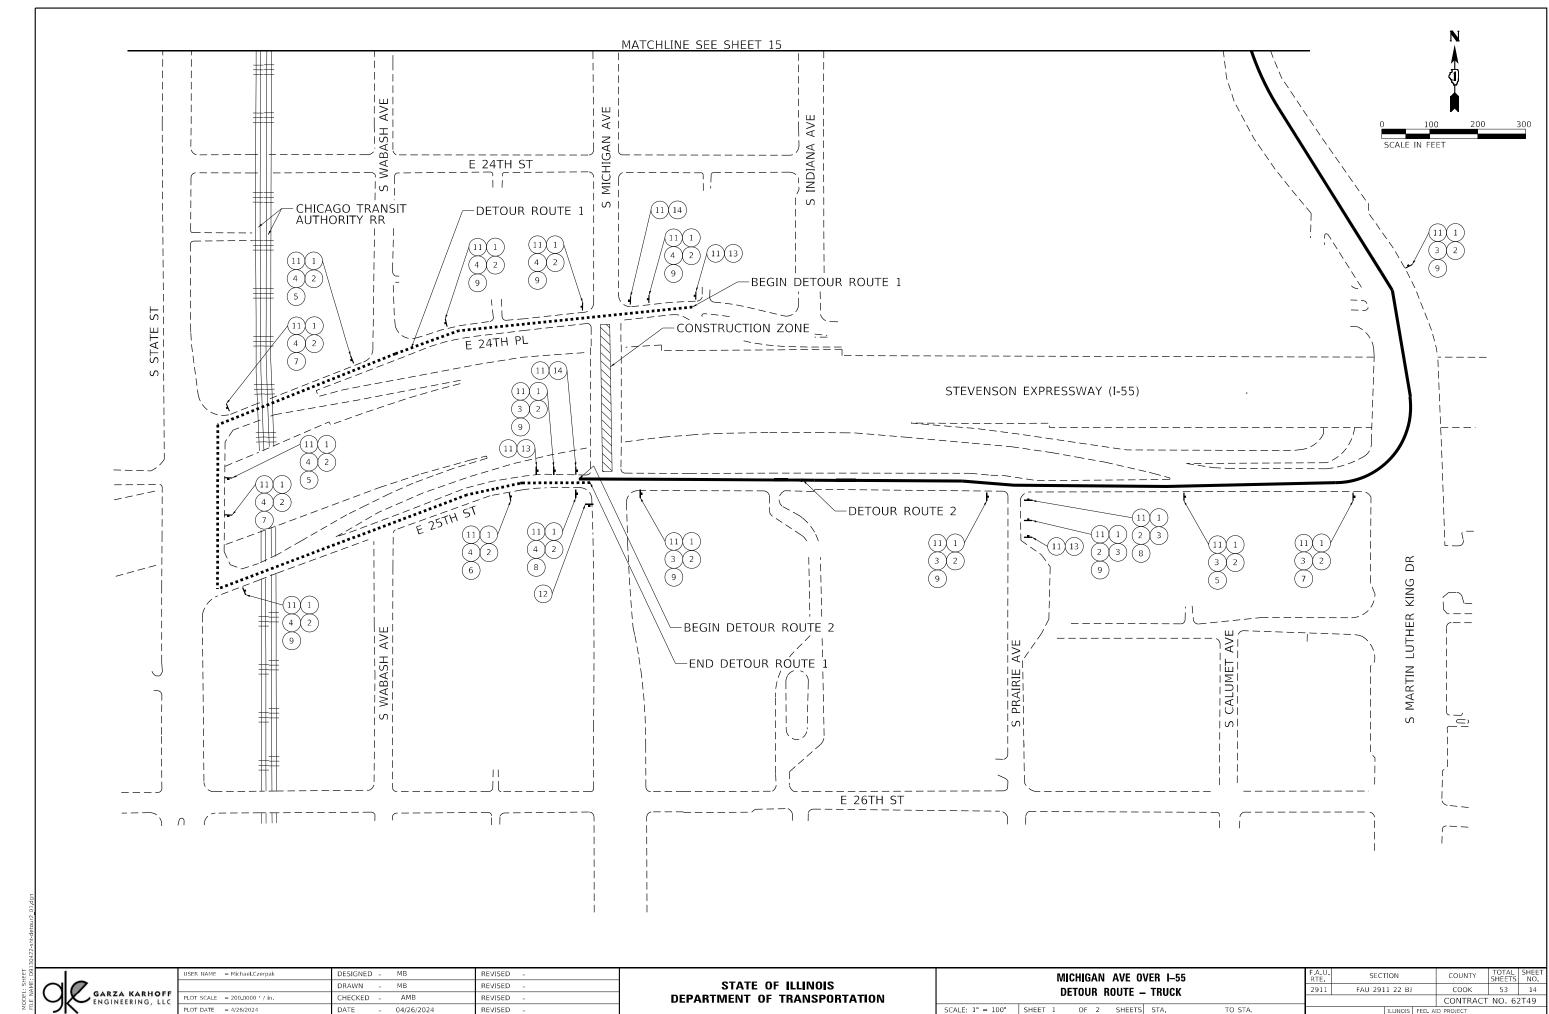
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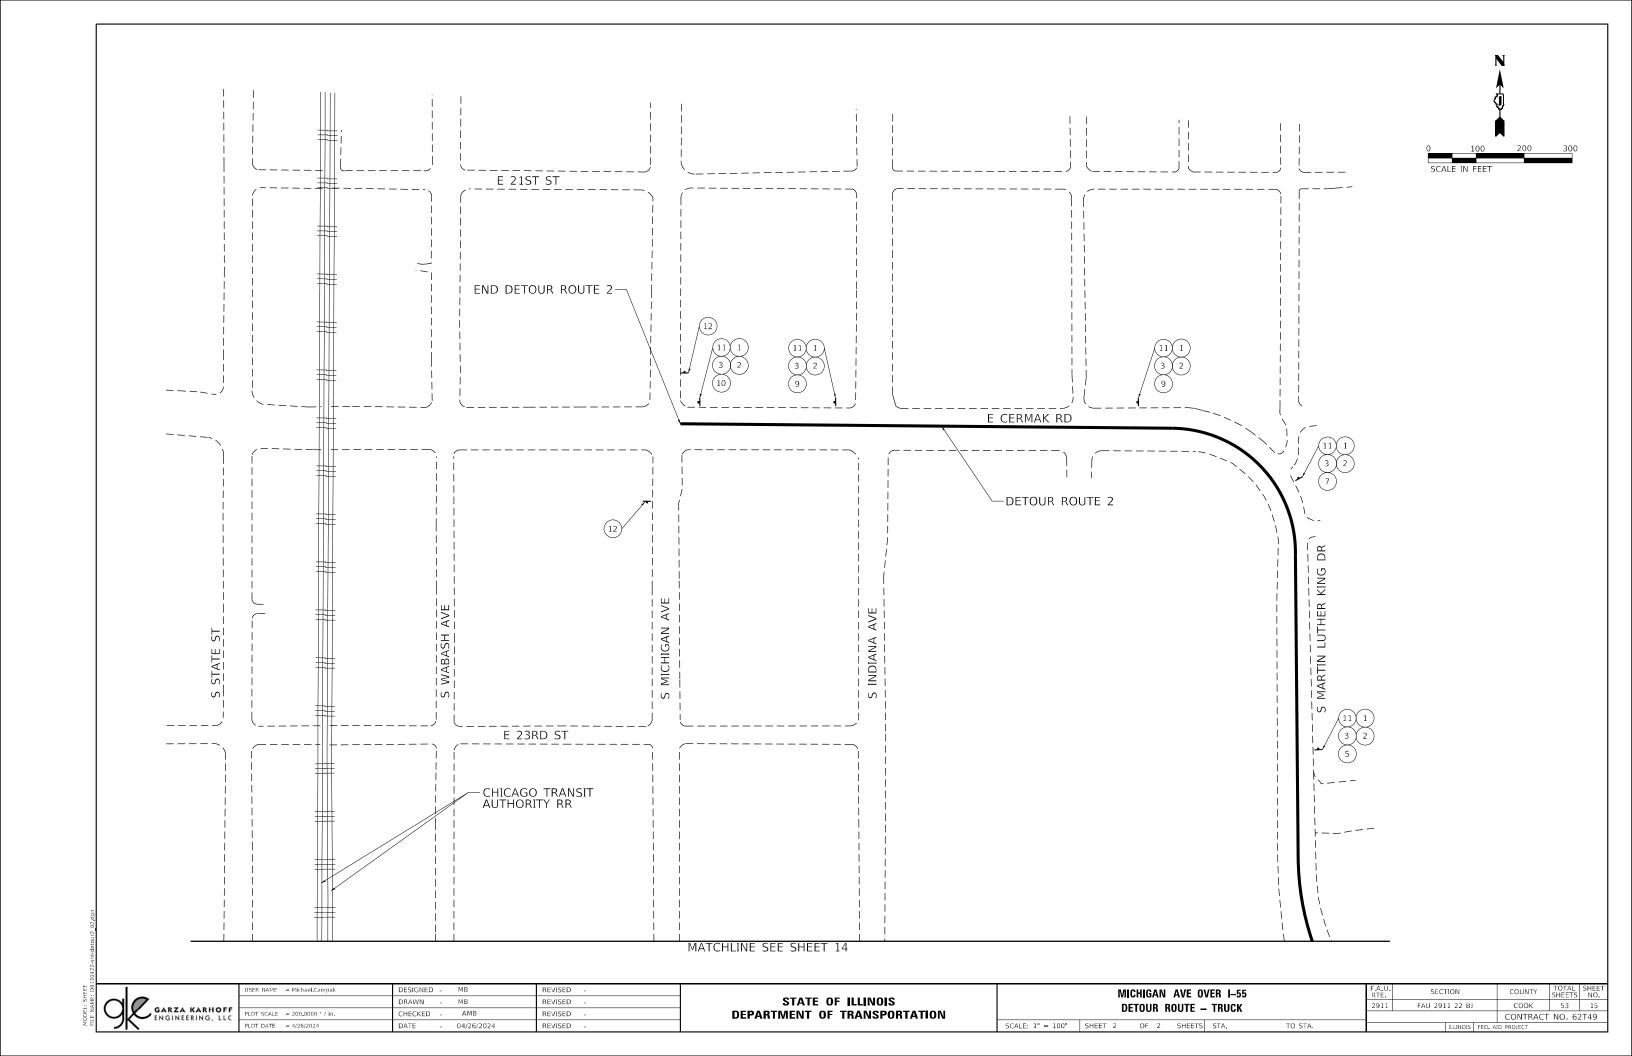
STATE OF ILLINOIS DEPARTMENT OF TRANSPORTATION MICHIGAN AVE OVER I-55
DETOUR ROUTE OVERVIEW - TRUCKS

SHEET 1 OF 1 SHEETS STA.

SCALE: NTS



SCALE: 1" = 100' SHEET 1 OF 2 SHEETS STA.



#### MAINTENANCE OF TRAFFIC GENERAL NOTES

- ALL "ROAD CONSTRUCTION AHEAD" WARNING SIGNS SHALL BE EQUIPPED WITH TYPE A MONO-DIRECTIONAL FLASHING LIGHT.
- 2. CHANGEABLE MESSAGE SIGNS SHALL BE INSTALLED TWO WEEKS PRIOR TO ALL ROAD CLOSURE, TRAFFIC STAGE CHANGES, AND NEW TRAFFIC SIGNAL TURN-ON EVENTS ON EACH APPROACH OF THE EFFECTED ROADWAY TO WARN MOTORISTS OF THE UPCOMING EVENT. THE SIGNS SHALL BE REMOVED TWO WEEKS THEREAFTER UNLESS THE SIGNS ARE NEEDED AGAIN FOR A SUBSEQUENT FUTURE EVENT THAT WILL OCCUR WITHIN TWO WEEKS ON THE SAME APPROACH OF THE EFFECTED ROADWAY. THE SIGN LOCATIONS SHALL BE (DETERMINED BY THE ENGINEER) PLACED AS DIRECTED BY THE ENGINEER.
- SIDEWALK CLOSURES AT 24TH PLACE AND 25TH STREET SHALL FOLLOW HIGHWAY STANDARD 701801-06.
- 4. THE CONTRACTOR SHALL REQUEST AND GAIN APPROVAL FROM THE ILLINOIS DEPARTMENT OF TRANSPORTATION'S EXPRESSWAY TRAFFIC OPERATIONS ENGINEER AT WWW.IDOTLCS.COM TWENTY-FOUR (24) HOURS IN ADVANCE OF ALL DAILY LANE, RAMP, AND SHOULDER CLOSURES AND 7 DAYS IN ADVANCE OF ALL PERMANENT AND WEEKEND CLOSURES ON ALL FREEWAYS AND/OR EXPRESSWAYS IN DISTRICT ONE.
- 5. UNLESS SPECIFIED IN THE CONTRACT PLANS, ALL TRAFFIC LANES SHALL BE KEPT OPEN TO TRAFFIC DURING PEAK TRAFFIC VOLUME HOURS AS DEFINED IN THE CONTRACT SPECIAL PROVISION FOR KEEPING THE EXPRESSWAY OPEN TO TRAFFIC.
- 6. THE CONTRACTOR WILL BE ALLOWED TO IMPLEMENT TEMPORARY LANE CLOSURES, TEMPORARY SHOULDER CLOSURES, TEMPORARY RAMP CLOSURES (FULL OR PARTIAL) ACCORDING TO THE APPLICABLE IDOT HIGHWAY STANDARDS AND DISTRICT ONE DETAILS, AND PER THE ALLOWABLE HOURS IN THE CONTRACT SPECIAL PROVISION FOR KEEPING THE EXPRESSWAY OPEN TO TRAFFIC. TRAFFIC CONTROL AND PROTECTION FOR TEMPORARY LANE AND SHOULDER CLOSURES SHALL BE IN ACCORDANCE WITH THE APPLICABLE HIGHWAY STANDARD OR DISTRICT DETAIL FOR THE PROPOSED WORK.
- 7. A MAINTENANCE OF TRAFFIC PLAN SHALL BE SUBMITTED TO THE DISTRICT ONE EXPRESSWAY TRAFFIC CONTROL SUPERVISORS 14 DAYS IN ADVANCE OF ANY STAGES OR FULL EXPRESSWAY CLOSURES. THE MAINTENANCE OF TRAFFIC PLAN SHALL INCLUDE, BUT NOT BE LIMITED TO, LANE AND RAMP CLOSURES, EXISTING GEOMETRICS, AND EQUIPMENT AND MATERIAL LOCATION.
- 8. ALL EXISTING PAVEMENT MARKINGS IN CONFLICT WITH THE PAVEMENT MARKING TAPE, TYPE IV (AND/OR MODIFIED URETHANE) USED FOR STAGING SHALL BE REMOVED. THIS WORK SHALL BE PAID FOR AS "PAVEMENT MARKING REMOVAL-WATER BLASTING."
- 9. PAVEMENT MARKING TAPE, TYPE IV (AND/OR TYPE III) SHOWN ON THE PLANS FOR ANY CONSTRUCTION STAGE THAT THE CONTRACTOR PROPOSES TO EXTEND OVER THE WINTER PERIOD SHALL MEAN MODIFIED URETHANE PAVEMENT MARKING AND WILL BE PAID FOR THEIR RESPECTIVE CONTRACT UNIT PRICE.
- 10. THE "ROAD CONSTRUCTION AHEAD" SIGNS SHALL REMAIN INSTALLED UNTIL THE COMPLETION OF THE PROJECT OR WHEN NO ROADWAY HAZARDS REMAIN WITHIN THE WORK ZONE.
- 11. CONTRACTOR SHALL COORDINATE WITH CHICAGO DEPARTMENT OF TRANSPORTATION (CDOT) FOR DEVELOPMENT AND MAINTENANCE OF TEMPORARY TRAFFIC SIGNAL TIMING. CONTRACTOR SHALL CONTACT YADOLLAH MONTAZERY AT YADOLLAH.MONTAZERY@CITYOFCHICAGO.ORG.

#### SUGGESTED STAGING AND TRAFFIC CONTROL

#### STAGE 1

INSTALL TEMPORARY SIGNING, STRIPING AND OTHER TRAFFIC CONTROL DEVICES NECESSARY FOR THE STAGE 1 TRAFFIC CONFIGURATION, INCLUDING ANY NECESSARY MODIFICATIONS TO THE EXISTING GROUND MOUNTED AND OVERHEAD SIGNS.

#### TRAFFIC CONTROL:

- TRAFFIC WILL BE REDUCED TO ONE NORTHBOUND LANE AND ONE SOUTHBOUND LANE.
- THE NORTHBOUND LANE AND THE SOUTHBOUND LANE WILL BE MAINTAINED THROUGHOUT THE CONTRACT LIMITS WITH A SHIFT TO THE OUTER LANES OCCURING AT THE BRIDGE STRUCTURE TO ACCOMMODATE THE WORK ZONES.
- TRAFFIC CONTROL ON I-55 FOR BRIDGE ABUTMENT AND PIER PATCHING SHALL FOLLOW IDOT HIGHWAY STANDARDS AND IDOT DISTRICT ONE STANDARDS.

#### CONSTRUCTION

- BRIDGE DECK SCARIFICATION.
- 2. INSTALL LATEX OVERLAY OVER BRIDGE DECK.
- GROOVE BRIDGE DECK.
- RECONSTRUCT DECK JOINTS AT EACH ABUTMENT WITH PREFORMED JOINT STRIP SEAL.
- REPAIR APPROACH PAVEMENT.
- 5. INSTALL HMA OVERLAY OVER APPROACH PAVEMENT.
- CLEAN AND RESEAL RELIEF JOINTS AT THE END OF APPROACH PAVEMENT CONNECTORS.
- 8. APPLY CONCRETE SEALER TO PARAPETS, SIDEWALK, AND BRIDGE DECK.
- 9. BRIDGE ABUTMENT AND PIER PATCHING.

#### STAGE 2

INSTALL TEMPORARY SIGNING, STRIPING AND OTHER TRAFFIC CONTROL DEVICES NECESSARY FOR THE STAGE 2 TRAFFIC CONFIGURATION, INCLUDING ANY NECESSARY MODIFICATIONS TO THE EXISTING GROUND MOUNTED AND OVERHEAD SIGNS.

#### TRAFFIC CONTROL:


- TRAFFIC WILL REMAIN AS ONE NORTHBOUND LANE AND ONE SOUTHBOUND LANE.
- 2. THE NORTHBOUND LANE AND THE SOUTHBOUND LANE WILL BE MAINTAINED THROUGHOUT THE CONTRACT LIMITS WITH A SHIFT TO THE INNER LANES OCCURING AT THE BRIDGE STRUCTURE TO ACCOMMODATE THE WORK ZONES.
- TRAFFIC CONTROL ON I-55 FOR BRIDGE ABUTMENT AND PIER PATCHING SHALL FOLLOW IDOT HIGHWAY STANDARDS AND IDOT DISTRICT ONE STANDARDS.

#### CONSTRUCTION

- 1. BRIDGE DECK SCARIFICATION.
- 2. CLEAN AND ADJUST SCUPPERS.
- 3. INSTALL LATEX OVERLAY OVER BRIDGE DECK.
- I. GROOVE BRIDGE DECK.
- RECONSTRUCT DECK JOINTS AT EACH ABUTMENT WITH PREFORMED JOINT STRIP SEAL.
- 6. REPAIR APPROACH PAVEMENT.
- 7. INSTALL HMA OVERLAY OVER APPROACH PAVEMENT.
- CLEAN AND RESEAL RELIEF JOINTS AT THE END OF APPROACH PAVEMENT CONNECTORS.
- 9. APPLY CONCRETE SEALER TO PARAPETS, SIDEWALK, AND BRIDGE DECK.
- 10. BRIDGE ABUTMENT AND PIER PATCHING.




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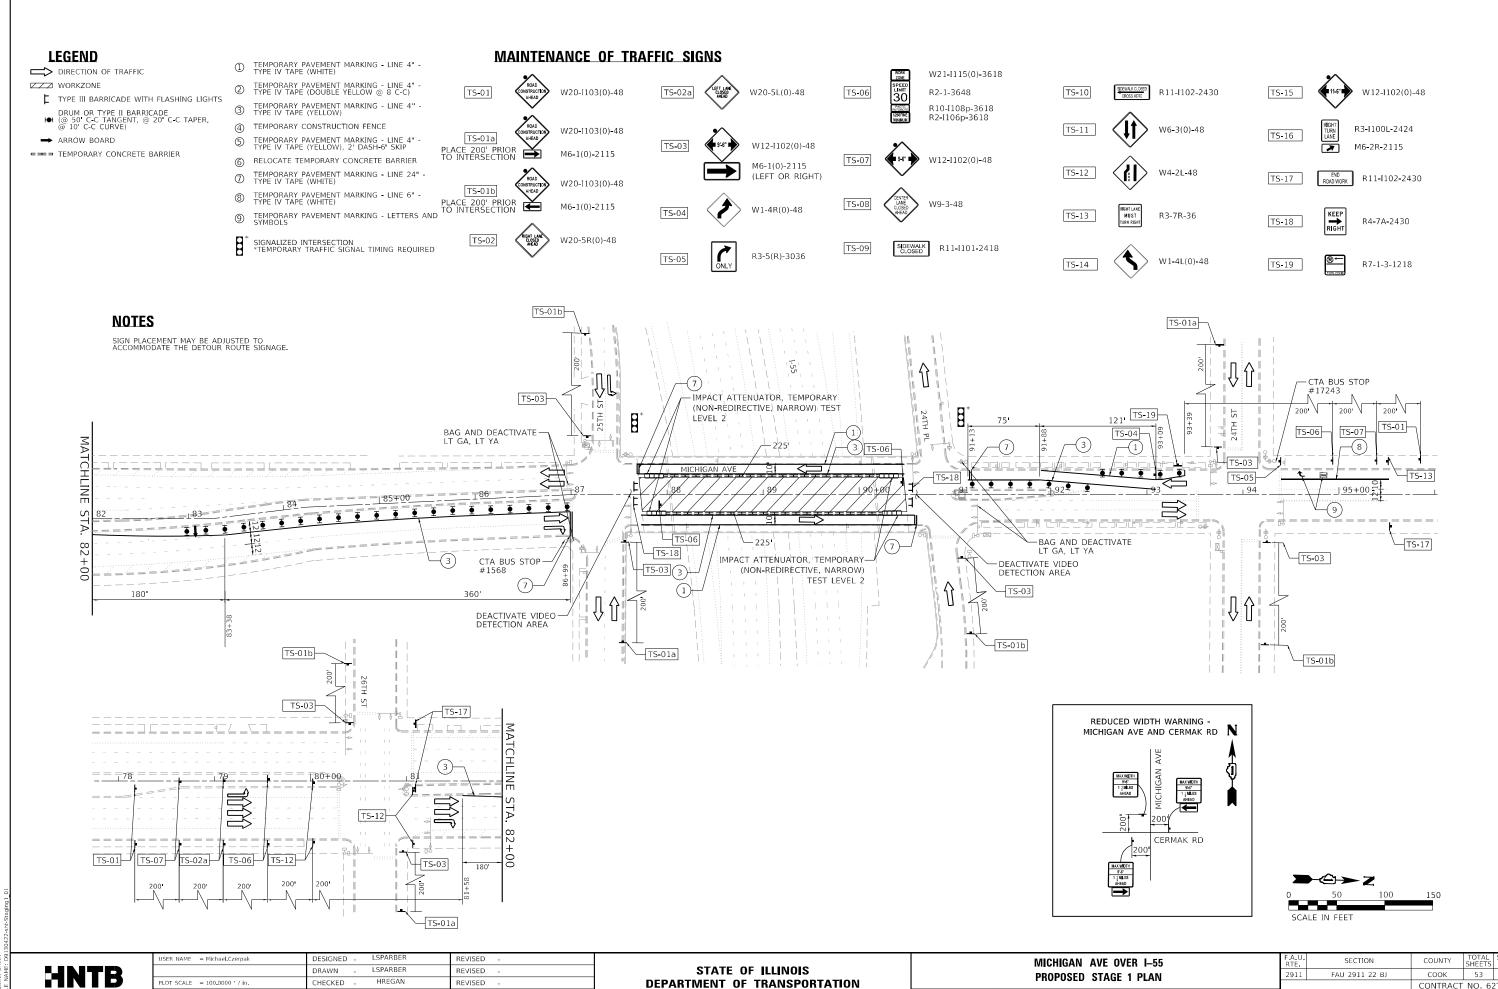
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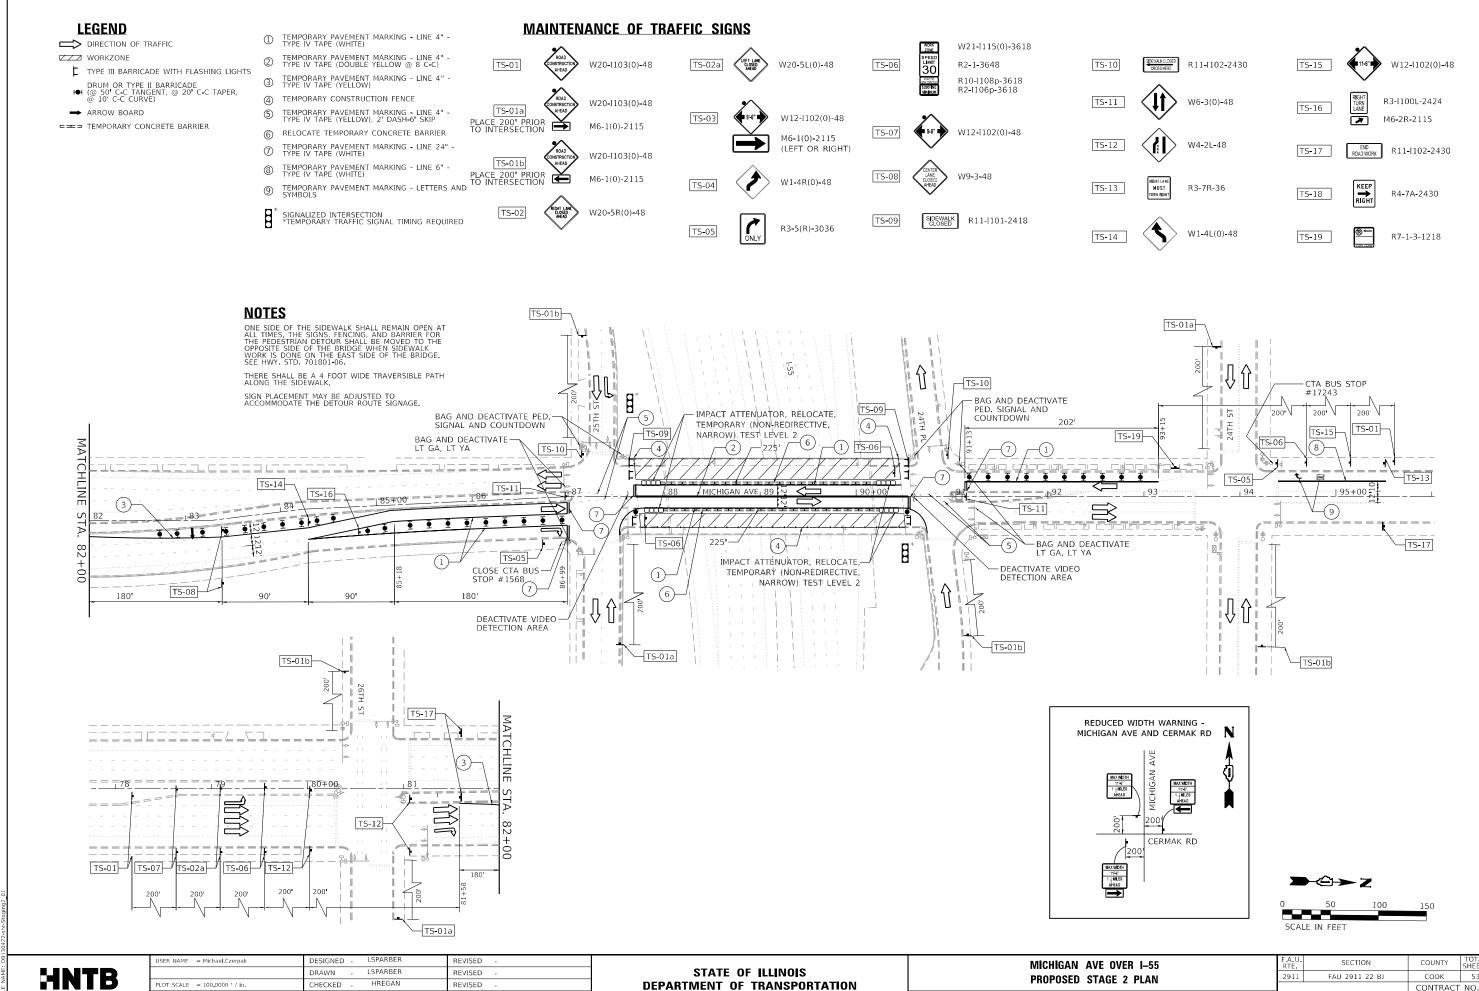


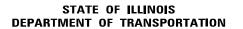HECKED REVISED DATE - 11/10/2023

**DEPARTMENT OF TRANSPORTATION** 

TO STA. 105+00

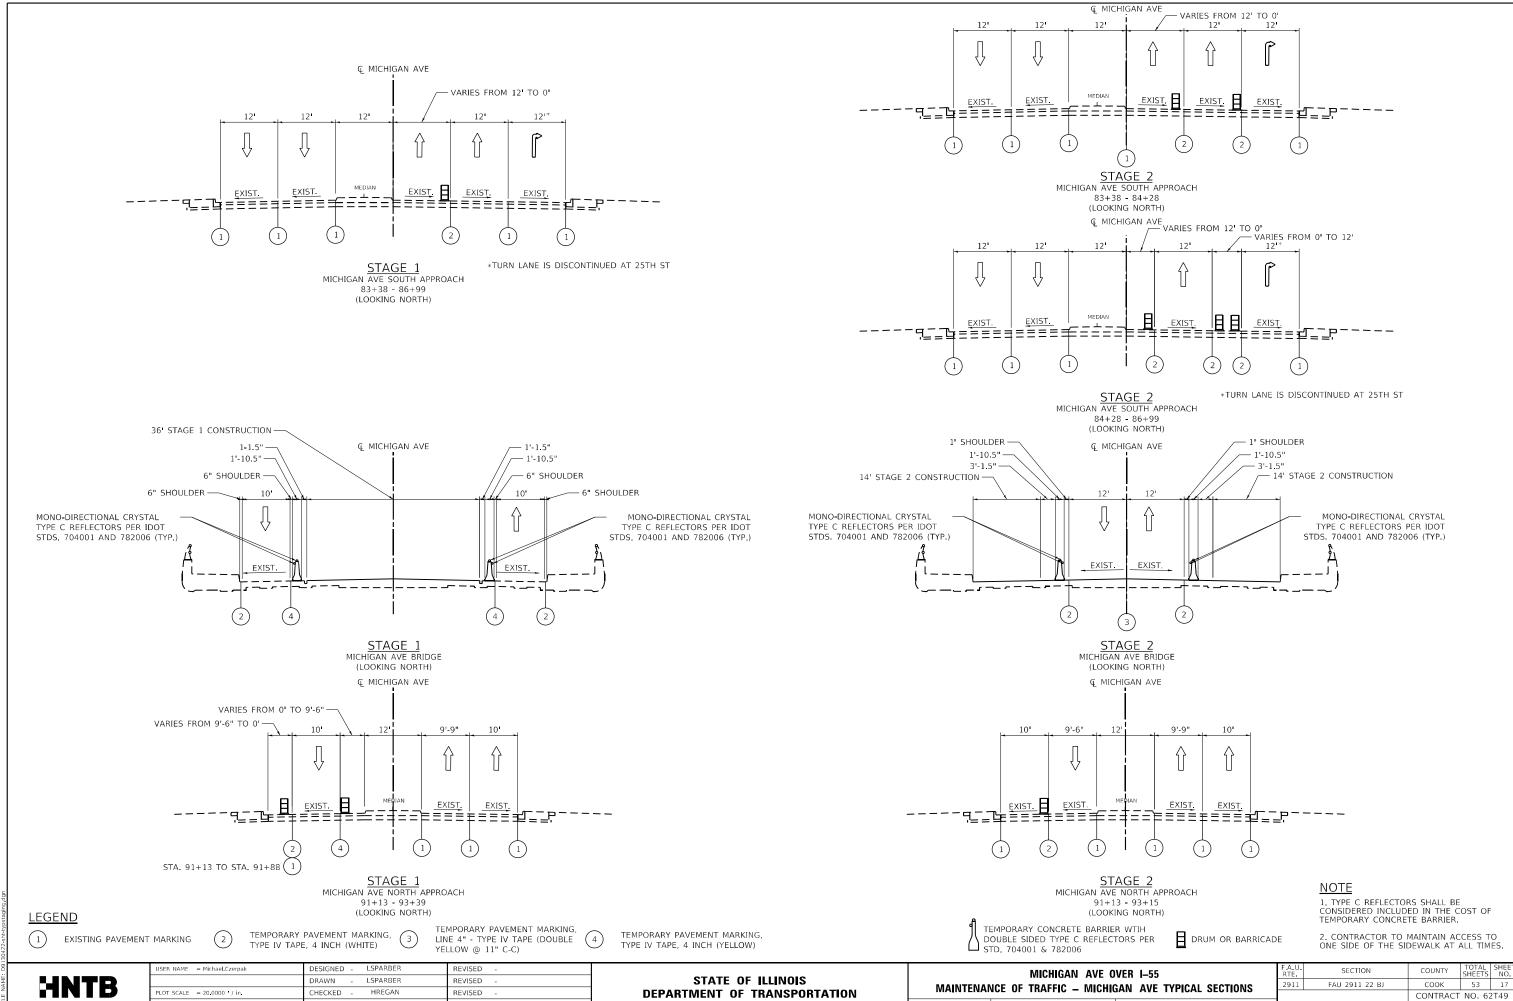53 18 CONTRACT NO. 62T49





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**DEPARTMENT OF TRANSPORTATION** 

PROPOSED STAGE 2 PLAN SCALE: 1" = 50' SHEET 1 OF 1 SHEETS STA. 84+05 TO STA. 105+00

53 19 CONTRACT NO. 62T49



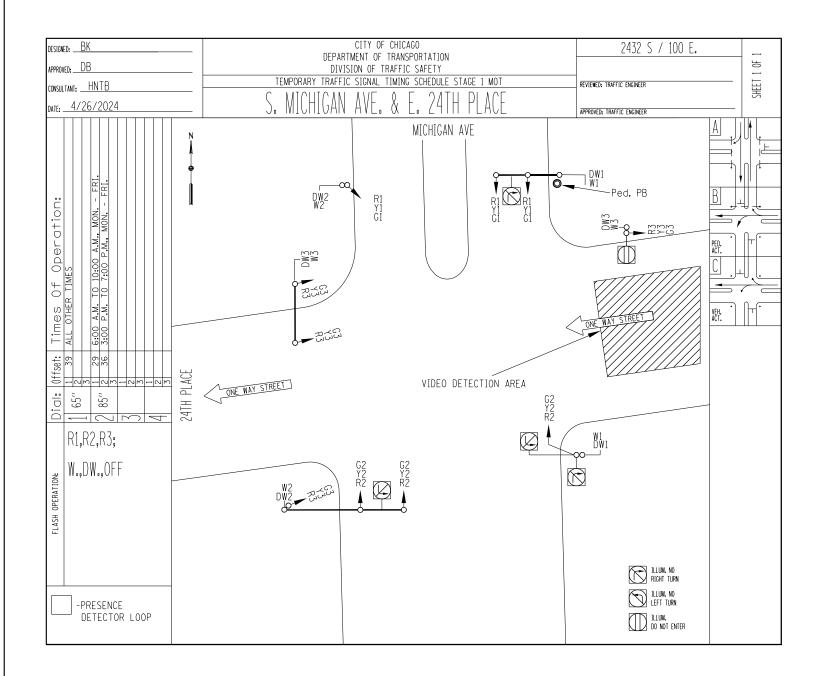

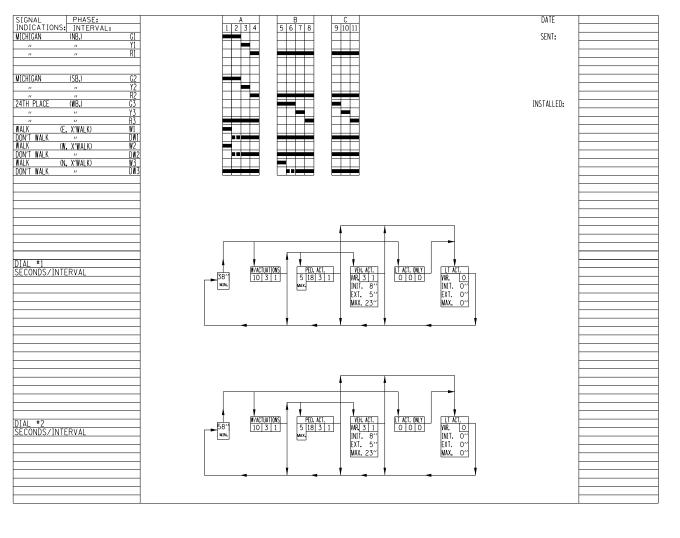HNTB

USER NAME = Michael.Czerpak	DESIGNED - LSPARBER	REVISED -
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STATE OF ILLINOIS DEPARTMENT OF TRANSPORTATION

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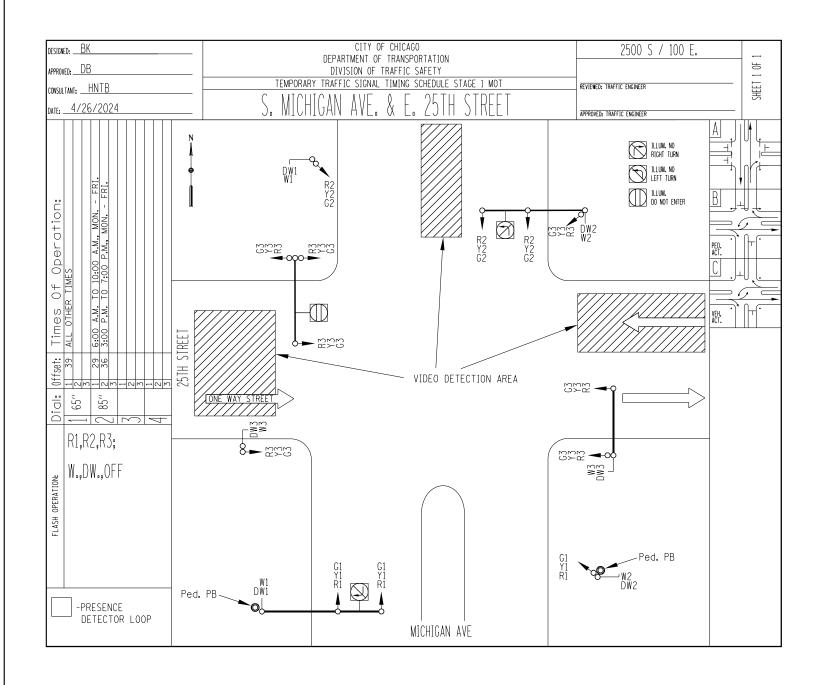
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SCHEMAT	FIC AND	SIGNAL	TIMING	SCHEDULE	- 24TH PLACE	2911	1
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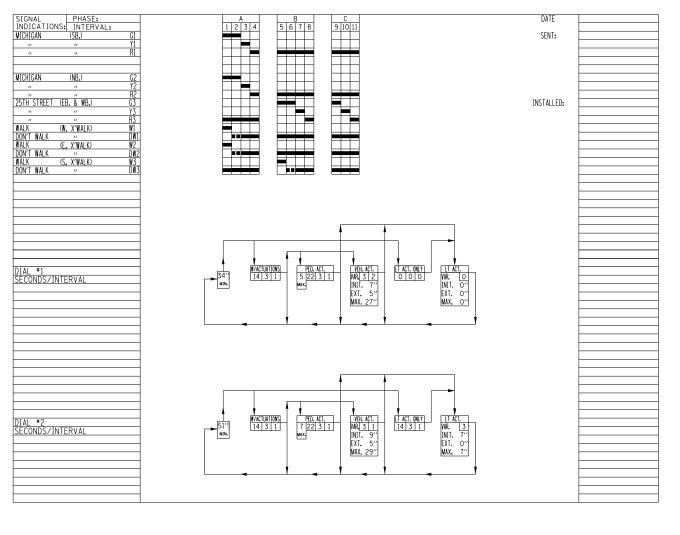
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11 FAU 2911 22 BJ COOK 53 20

CONTRACT NO. 62T49

| ILLINOIS | FED. AID PROJECT





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STATE OF ILLINOIS DEPARTMENT OF TRANSPORTATION

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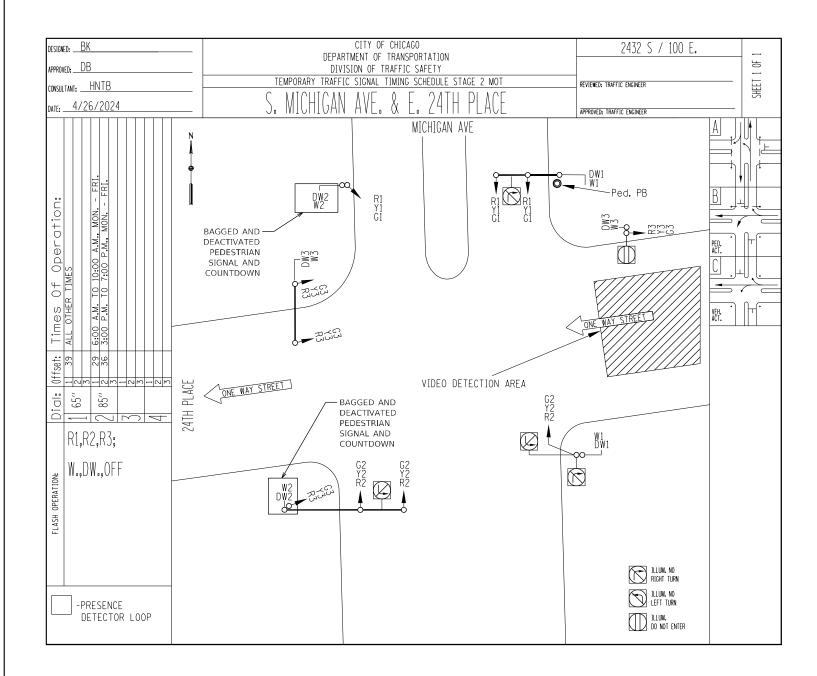
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SCHEMAT	TC AND	SIGNAL	TIMING 9	CHEDIII	E – 25TH STREET	2911	
JUILINA	IC AND	SIGNAL	THAILING C	JUILLUUL	L - 23111 3111LL1		
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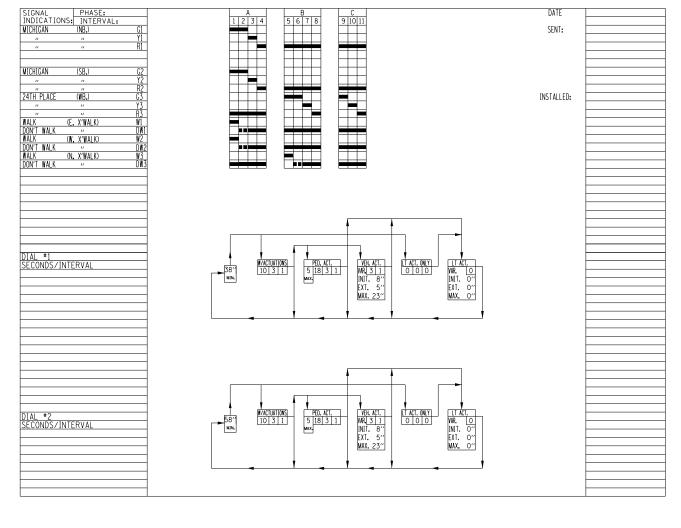
U. SECTION COUNTY SHEETS NO.

11 FAU 2911 22 BJ COOK 53 21

CONTRACT NO. 62T49

ILLINOIS FED. AID PROJECT





CONTRACTOR TO FLIP THE BAGGING AND DEACTIVATING OF THE PEDESTRIAN SIGNAL AND COUNTDOWN WHEN THE EAST SIDEWALK IS CLOSED FOR CONSTRUCTION.

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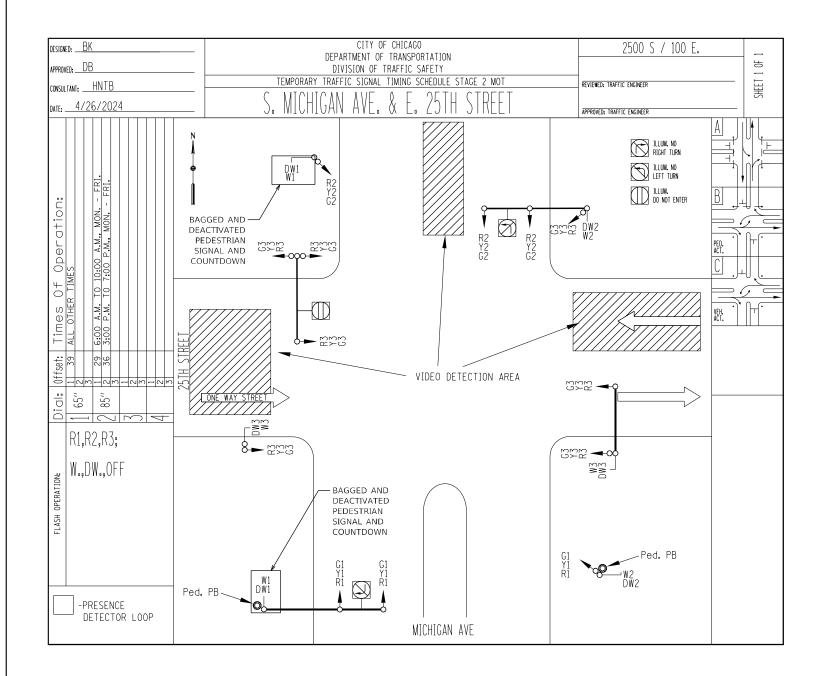
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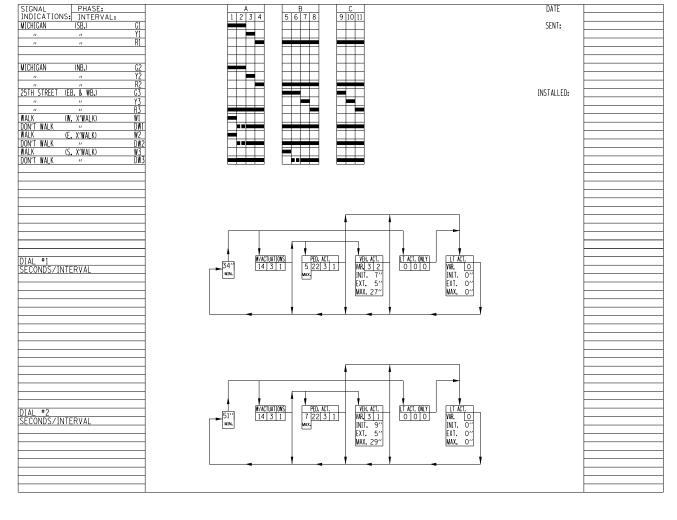
STATE OF ILLINOIS **DEPARTMENT OF TRANSPORTATION** 

SCALE:

STAGE 2	MOT -	TEMPOR	ARY TRA	FFIC SIG	NAL EQUIPMENT		F.A.L RTE
<b>SCHEMA</b> 1	TIC AND	SIGNAL	TIMING	SCHEDUL	.E – 24TH PLACE		291
	SHEET	OF	SHEETS	STA.	TO STA.	$\dashv$	

SECTION COUNTY FAU 2911 22 BJ COOK 53 22 CONTRACT NO. 62T49





CONTRACTOR TO FLIP THE BAGGING AND DEACTIVATING OF THE PEDESTRIAN SIGNAL AND COUNTDOWN WHEN THE EAST SIDEWALK IS CLOSED FOR CONSTRUCTION.

**HNTB** 


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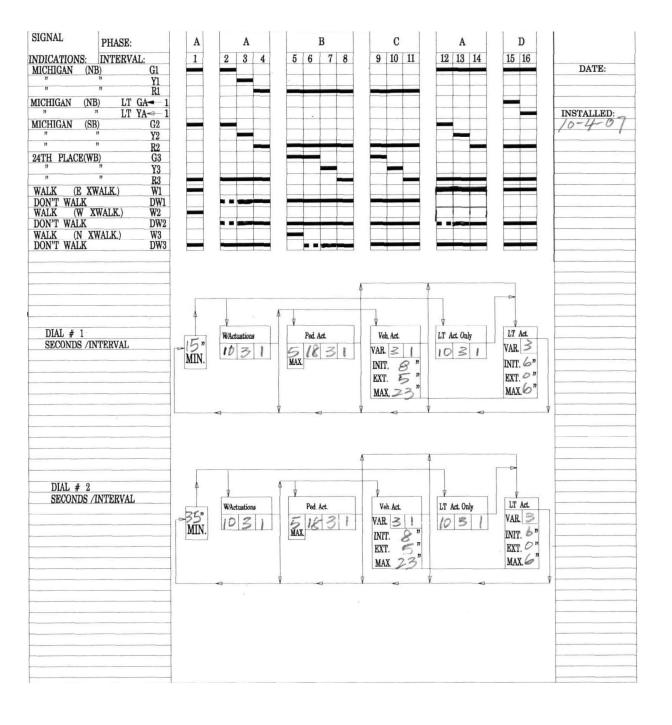
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DEPARTMENT	OF	TRANSPORT	ATION

SCALE:

STAGE 2	MOT -	TEMPOR	ARY TRA	FFIC S	IGNAL EQUIPMENT	F.A.U. RTE	SE
SCHEMAT	IC AND	SIGNAL	TIMING S	SCHEDU	ILE – 25TH STREET	2911	FAU 2
E:	SHEET	OF	SHEETS	STA.	TO STA.		

F.A.U. RTE.	SECT	10N		COUNTY	TOTAL SHEETS	SHEET NO.
2911	FAU 2911 22 BJ			COOK	53	23
			CONTRACT	NO. 62	2T49	
		ILLINOIS	FED. A	D PROJECT		



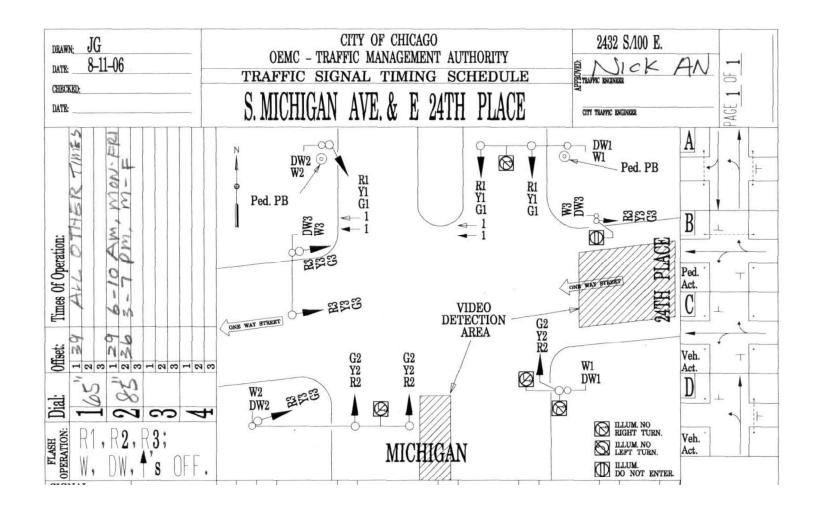

NOTE:

TRAFFIC SIGNAL TIME TO BE RETURNED TO EXISTNIG CONDITION UPON COMPLETION OF CONSTRUCTION.


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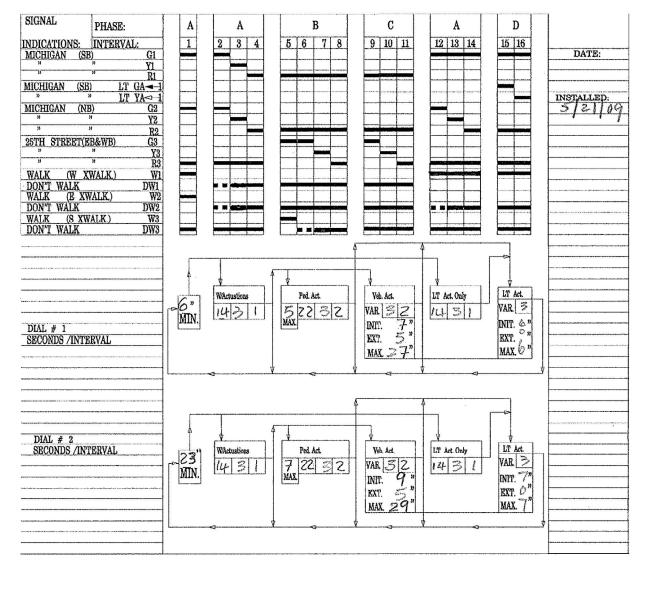
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PLOT DATE = 4/26/2024	DATE - 11/10/2023	REVISED -

STATE OF ILLINOIS
DEPARTMENT OF TRANSPORTATION

	EXISTING TRAFFIC SIGNAL EQUIPMENT					
	SCHEMAT	IC AND	SIGNAL	TIMING	SCHEDU	ILE – 24TH PLACE
SCALE:		SHEET	OF	SHEETS	STA.	TO STA.

F.A.U. RTE	SECT	ПОИ		COUNTY	TOTAL SHEETS	SHEET NO.
2911	FAU 291	1 22 BJ		соок	53	24
				CONTRACT	NO. 62	2T49
		ILLINOIS	FED. A	ID PROJECT		



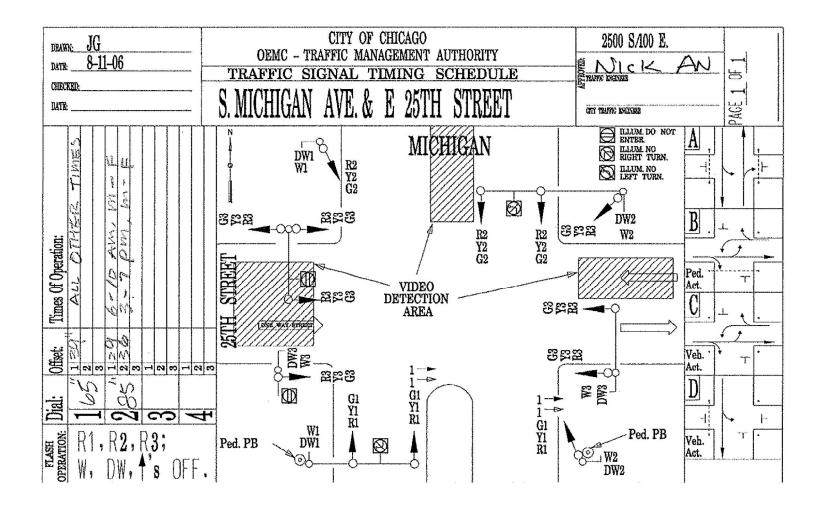

NOTE:

TRAFFIC SIGNAL TIME TO BE RETURNED TO EXISTNIG CONDITION UPON COMPLETION OF CONSTRUCTION.

HNTB

USER NAME = Michael.Czerpak	DESIGNED - LSPARBER	REVISED -
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PLOT DATE = 4/26/2024	DATE - 11/10/2023	REVISED -

STATE OF ILLINOIS
DEPARTMENT OF TRANSPORTATION

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FALU. SECTION COUNTY TOTAL SHEETS NO. 2911 FAU 2911 22 BJ COOK 53 25


| CONTRACT NO. 62T49 | ILLINOIS FED. AID PROJECT

Benchmark: Brass monument stamped "TOMKD" in asphalt pavement in center of directional island SE corner of 24th place and Michigan Avenue. EL. +15.2

Existing Structure: The original 1966 bridge superstructure was a two-span, continuous composite, wide flange beam with reinforced concrete deck, and the original substructure had two abutments, wingwalls, and one multiple column pier supported by drilled caissons. The existing SB pier and west wingwall caissons were reused from the 1966 bridge structure. The entire superstructure, abutments, wingwalls, and NB pier were remove to construct the existing 1993 bridge structure. The existing two span continuous steel structure number 016-0184 was reconstructed in 1993 carrying Michigan Avenue over the 1-55 (Stevenson Expressway) and is located in Chicago, IL, Cook County. The out-to-out width of the structure is 80'-0" and back-to-back of abutments is 215'-1014". The present width accomodates five lanes (two 12'-0" lanes in each direction and one shared 12'-0" turning lane), 2'-0" shoulders, and 7'-0" sidewalks on both sides.

One lane of traffic in each direction and one sidewalk shall be maintained at all times using staged construction.

No Salvage

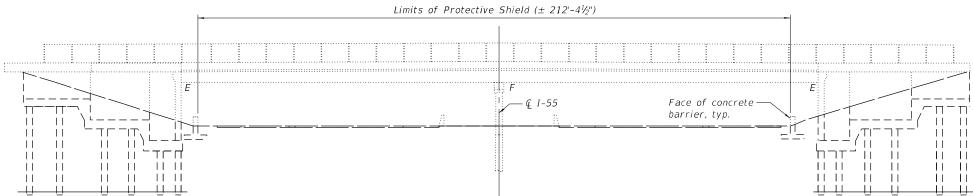

#### DESIGN SPECIFICATIONS

2002 AASHTO Standard Specifications for Highway Bridges

#### DESIGN STRESSES


#### FIELD UNITS

f'c = 4,000 psi (Superstructure)f'c = 3,500 psi (Substructure)fy = 60,000 psi (Reinforcement)

#### SCOPE OF WORK

- 1. Install Protective Shield.
- 2. Scarify and Overlay bridge deck.
- 3. Reconstruct the expansion joints at each abutment.
- 4. Adjust drain scuppers.
- 5. Repair substructure elements in abutments and pier.

#### ELEVATION

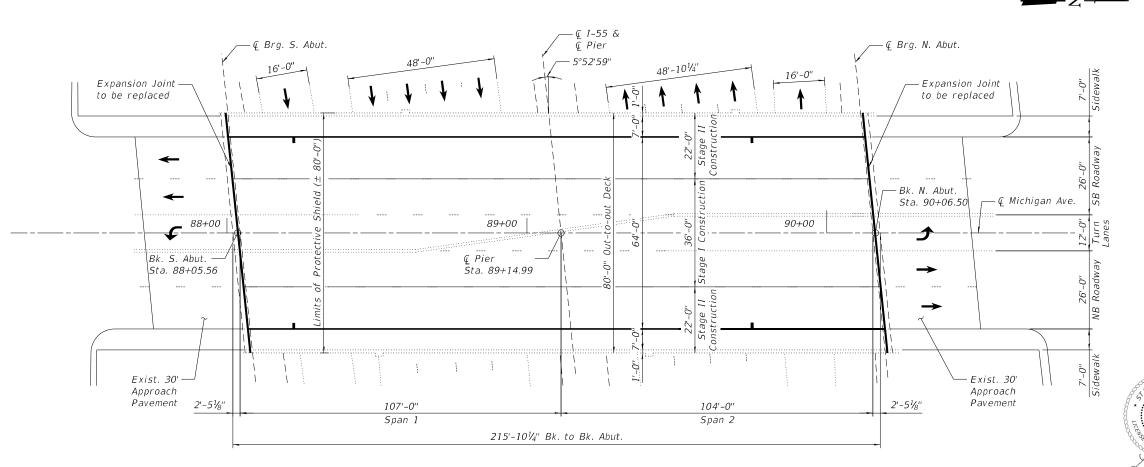

Range 14E, 3rd P.M. — Project Location LOCATION SKETCH

GENERAL PLAN AND ELEVATION F.A.I. RT. 55 (STEVENSON) MICHIGAN AVE. OVER 1-55 SECTION FAI 55 SW-1818.2-2B COOK COUNTY STATION 89+14.99

PLAN

GARZA KARHOFF
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	USER NAME =	DESIGNED - JJM	REVISED -
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	PLOT DATE =	CHECKED - LM	REVISED -

STATE OF ILLINOIS
DEPARTMENT OF TRANSPORTATION

	GENERAL PLAN AND ELEVATION						
STRUCTURE NO. 016-0184							
	SHEET 1	OF	1/1	SHEETS			

Expires: 11/30/2024

- A.U. RTE	SECTION		COUNTY	TOTAL SHEETS	SHE
2911	FAU 2911 22 BJ	соок	53	26	
			CONTRA	CT NO. 6	52T49
	ILLINOIS	FED. A	D PROJECT		

STRUCTURE NO. 016-0184

#### GENERAL NOTES

- 1. Reinforcement bars designated (E) shall be epoxy coated.
- 2. Prior to pouring the new concrete deck, all heavy or loose rust, loose mill scale, and other loose or potentially detrimental foreign material shall be removed from the surfaces in contact with concrete. Tightly adhered paint may remain unless otherwise noted. Removal shall be accomplished by methods that will not damage the steel and the cost will be included in Concrete Removal
- 3. Plan dimensions and details relative to existing structure have been taken from existing plans are subject to nominal construction variations. The Contractor shall field verify existing dimensions and details affecting new construction and make necessary approved adjustments prior to construction or ordering of materials. Such variations shall not be cause for additional compensation for a change in scope of the work, however, the Contractor will be paid for the quantity actually furnished at the unit price bid for the work.
- 4. Existing reinforcement bars extending into the removal area shall be cleaned, straightened, and incorporated into the new construction. Any reinforcement bars that are damaged during concrete removal shall be replaced with an approved bar splicer or anchorage system at the contractor's expense.
- 5. Concrete Sealer shall be applied to the areas of concrete repair at each abutment and pier. All surfaces to be sealed shall be cleaned thoroughly prior to sealer application.
- 6. The Contractor shall exercise care during removal of existing joints to ensure that the slab, beams and diaphragms' integrity will not be detrimentally impacted. The Contractor shall repair any damage(s) to the slab, beams and diaphragms caused by his operation as directed by the Engineer at no additional cost to the Department.
- 7. Protective Coat shall be applied to the reconstructed top and inside face of the bridge parapets, sidewalks, joint, and new concrete overlay areas, per Section 503.19 of the Standard Specifications.
- 8. Joint openings shall be adjusted according to Article 520.04 of the Std. Specs. when the deck is poured at an ambient temperature other than 50°F.

#### INDEX OF SHEETS

- 1. General Plan and Elevation
- 2. General Data
- 3. Construction Staging
- 4. Temporary Concrete Barrier
- 5. Deck Repair and Overlay Plan
- 6. Drainage Scupper Adjustment Details 7-8. Abutment Expansion Joint Replacement
- 9-11. Preformed Joint Strip Seal Sidewalk
- 12-13. Substructure Repair Details
- 14. Bar Splicer Assembly and Mechanical Splicer Details

#### TOTAL BILL OF MATERIAL


ITEM	UNIT	SUPER	SUB	TOTAL
Concrete Removal	Cu Yd	21.9		21.9
Protective Shield	Sq Yd	1,888		1,888
Concrete Superstructure	Cu Yd	23.7		23.7
Bridge Deck Grooving	Sq Yd	1,510		1,510
Protective Coat	Sq Yd	1,543		1,543
Reinforcement Bars, Epoxy Coated	Pound	2,830		2,830
Bar Splicers	Each	44		44
Preformed Joint Strip Seal	Foot	161		161
Concrete Sealer	Sq Ft		237	237
Cleaning Bridge Scuppers And Downspouts	Each	4		4
Bridge Deck Latex Concrete Overlay, 2 1/4 Inches	Sq Yd	1,510		1,510
Bridge Deck Scarification 3/4"	Sq Yd	1,510		1,510
Structural Repair Of Concrete (Depth Equal To Or Less Than 5 Inches)	Sq Ft		237	237
Deck Slab Repair (Full Depth, Type I)	Sq Yd	1		1
Drainage Scuppers To Be Adjusted	Each	4		4

GARZA KARHOFF ENGINEERING, LLC

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STATE OF ILLINOIS
DEPARTMENT OF TRANSPORTATION

GENERAL DATA	F.A.U. RTE	SEC <sup>-</sup>	ПОИ		COUNTY	TOTAL SHEETS
STRUCTURE NO. 016-0184	2911	FAU 291	1 22 BJ		соок	53
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SHEET 2 OF 14 SHEETS			ILLINOIS	FED AL	D PROJECT	

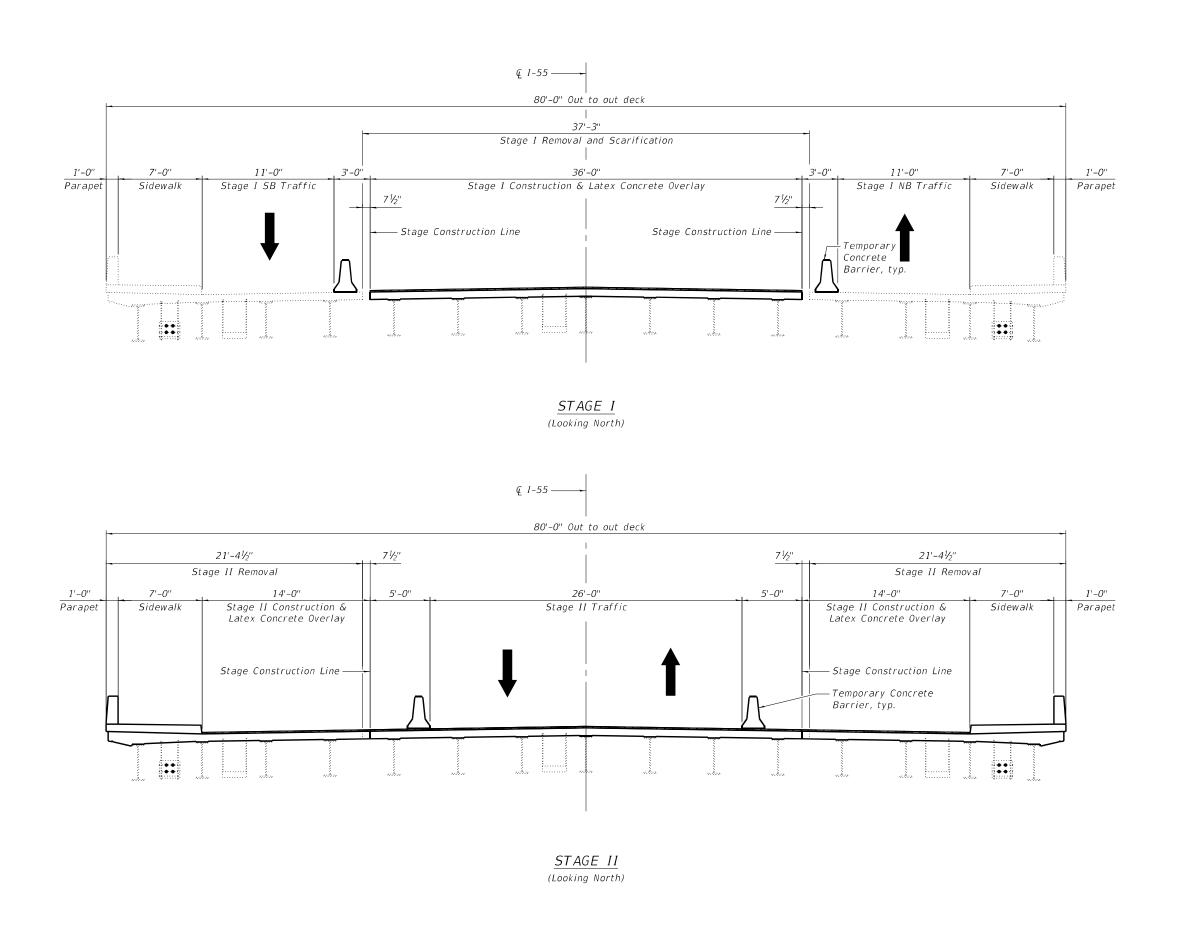

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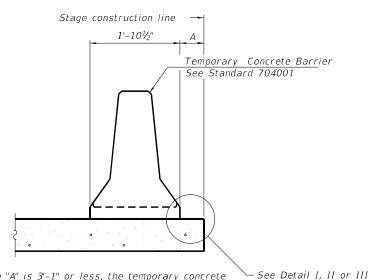
STATE OF ILLINOIS DEPARTMENT OF TRANSPORTATION CONSTRUCTION STAGING
STRUCTURE NO. 016-0184

SHEET 3 OF 14 SHEETS

 
 F.A.U. RTE.
 SECTION
 COUNTY SHEETS
 TOTAL NO.
 SHEETS NO.

 2911
 FAU 2911 22 BJ
 COOK
 53
 28

 CONTRACT NO. 62T49



When "A" is 3'-1" or less, the temporary concrete barrier shall be restrained to the new slab according to Detail I, II or III. No restraint is required when "A" is greater than 3'-1".

1'-101/2" Temporary Concrete Barrier See Standard 704001 6" min. min. Drill 3-11/4" Ø Holes in existing slab for 1" Ø restraining pins. Traffic side only. Cost of restraining pins are included with Temporary Concrete Barrier. No restraint is required when "A" is greater than 3'-1".

\*When hot-mix asphalt wearing surface is present, embedment shall be 3" plus the wearing surface depth.

— Stage removal line


EXISTING DECK BEAM


#### NEW SLAB OR NEW DECK BEAM

#### SECTIONS THRU SLAB OR DECK BEAM

— Stage removal line

EXISTING SLAB

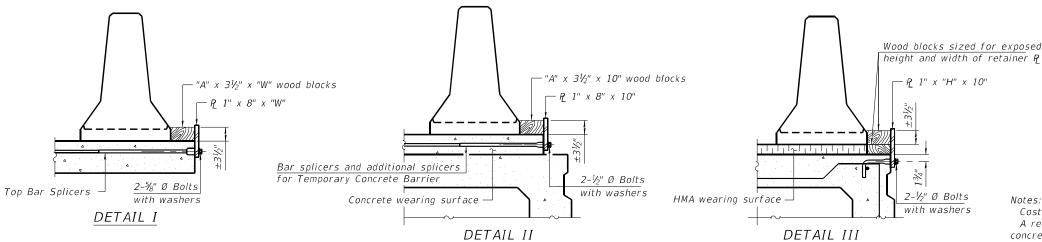

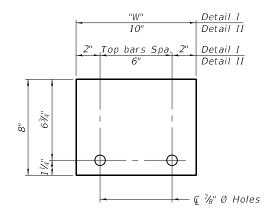


STEEL RETAINER P 1" x 8" x "W"

(Detail I and II)


#### RAILING CRITERIA

NCHRP 350 Test Level Railing Weight (plf) 440

R-27 5-15-2023

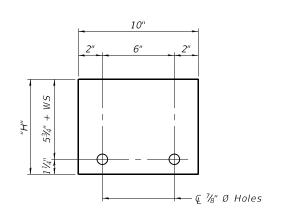

STEEL RETAINER P 1" x "H" x 10"

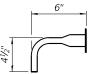

RESTRAINING PIN

#### BAR SPLICER FOR #4 BAR - DETAIL III

#### Notes:

Cost of retainer assembly is included with Temporary Concrete Barrier. A retainer assembly shall be located at the approximate  $\square$  of each temporary concrete barrier.

The retainer plate shall not be removed until the concrete on the adjacent stage is ready to be poured. For Detail III applications the retainer plate shall not be removed until just prior to placing the adjacent beam.

When the 'A' dimension is less than  $1\frac{1}{2}$ ", the wood block shall be omitted and the barrier shall be placed in direct contact with the steel retainer plate. For deck beam applications the minimum required 'A' distance is 6" to accommodate the shear key clamping device.

Detail I - Installation for a new bridge deck or bridge slab.

US Std.  $1\frac{1}{16}$ " I.D.  $\times$   $2\frac{1}{2}$ " O.D. x approx. 8 gauge thick washer

1" Ø pin -

- Detail II Installation for a new deck beam with an initial concrete wearing surface. Additional bar splicers shall be provided at 6'-0" centers and paired with the bar splicers of the concrete wearing surface reinforcement to accommodate the installation of the retainer assemblies. The cost of the additional bar splicers is included with the concrete wearing surface.
- Detail III Installation for a new deck beam with no initial wearing surface or with an initial hot-mix asphalt (HMA) wearing surface present. The deck beam directly beneath the temporary concrete barrier shall be fabricated with bar splicer inserts in the side of the beam, as detailed, to accommodate the installation of the retainer assemblies. A pair of bar splicers, 6" apart, shall be placed at 6'-0" centers along the length of the beam. The cost of the bar splicers is included with the deck beam.


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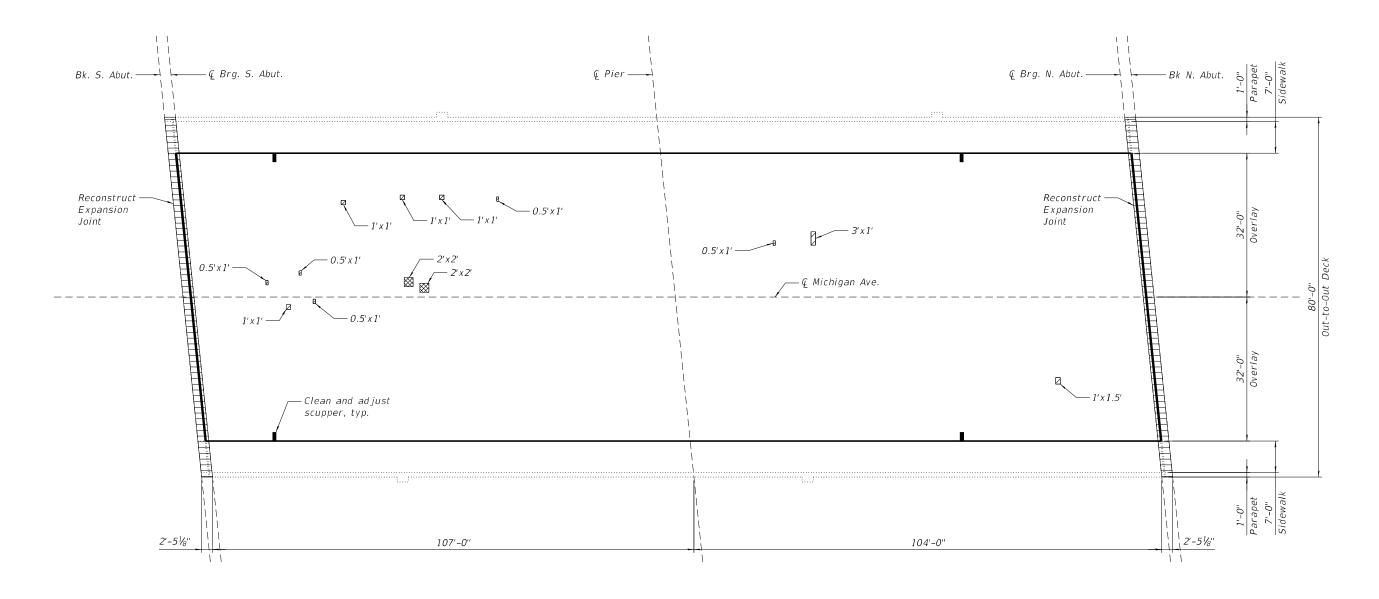
**STATE OF ILLINOIS DEPARTMENT OF TRANSPORTATION**  TEMPORARY CONCRETE BARRIER SECTION 2911 FAU 2911 22 BJ COOK 53 29 **STRUCTURE NO. 016-0184** CONTRACT NO. 62T49 SHEET 4 OF 14 SHEETS

#### <u>NOTES</u>

- 1. Deck slab repair areas are estimated based on an inspection conducted by IDOT and a visual inpsection conducted in September 2023. Actual repair areas and locations shall be determined in the field by the Engineer and noted in the As-Built Plans.
- 2. Areas of Deck Slab Repair (Partial Depth) will not be measured for payment and shall be included with the cost of Bridge Deck Latex Concrete Overlay.

  3. For Details on Expansion Joint Removal and Replacement, see sheet 7 and 8 of 14.
- 4. For Drainage Scupper Adjustment details, see sheet 6 of 14.



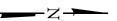

LEGEND

Expansion Joint Reconstruction



Deck Slab Repair (Partial Depth) (For Information Only)



Deck Slab Repair (Full Depth)

### BILL OF MATERIAL


Item	Unit	Total
Bridge Deck Latex Concrete Overlay, 2 1/4" Inches	Sq Yd	1,510
Bridge Deck Scarification 3/4"	Sq Yd	1,510
Deck Slab Repair (Full Depth, Type I)	Sq Yd	1

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PLAN

DECK REPAIR AND OVERLAY PLAN	F.A.U. RTE	SECTION	COUNTY	TOTAL SHEETS	SHEET NO.
STRUCTURE NO. 016-0184	2911	FAU 2911 22 BJ	соок	53	30
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SHEET 5 OF 14 SHEETS		LUBIOTO FED AL	D DDO IECT		-



#### GENERAL NOTES

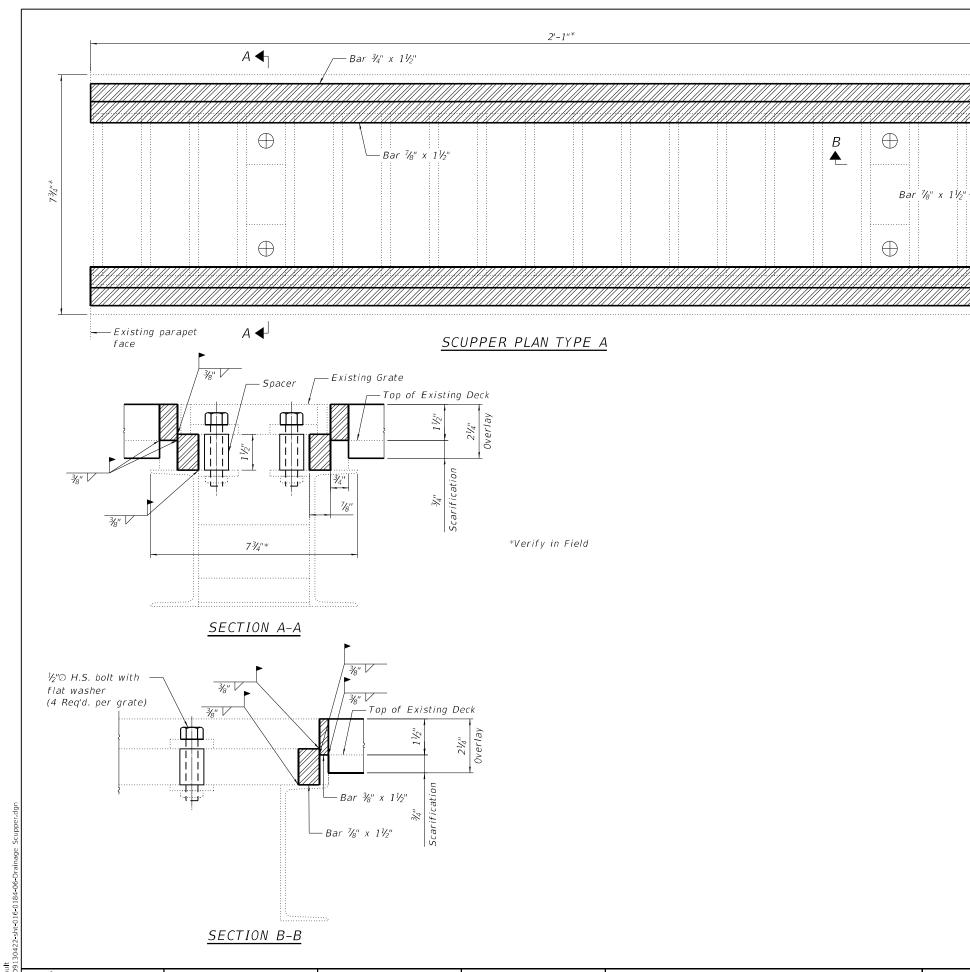All structural steel shall conform to AASHTO Classification M-270 Gr. 36. The adjusting scupper ring shall be galvanized.

Bolts shall be ½"Ø, AASHTO M164 Type I, mechanically galvanized. The contractor shall ensure that no damage is done to

existing grates to be reused.

Shop plans for proposed adjusting scupper ring shall be submitted for approval prior to fabrication.

#### BILL OF MATERIAL

Drainage Scuppers to be Adjusted Each 4 Cleaning Bridge Scuppers and Downspouts Each 4	Item	Unit	Total
Cleaning Bridge Scuppers and Downspouts   Each   4	Drainage Scuppers to be Adjusted	Each	4
	Cleaning Bridge Scuppers and Downspouts	Each	4

GARZA KARHOFF ENGINEERING, LLC


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STATE OF ILLINOIS **DEPARTMENT OF TRANSPORTATION**  DRAINAGE SCUPPER ADJUSTMENT DETAILS **STRUCTURE NO. 016-0184** SHEET 6 OF 14 SHEETS

LEGEND

Adjusting Scupper Ring

SECTION FAU 2911 22 BJ COOK 53 31 2911 CONTRACT NO. 62T49

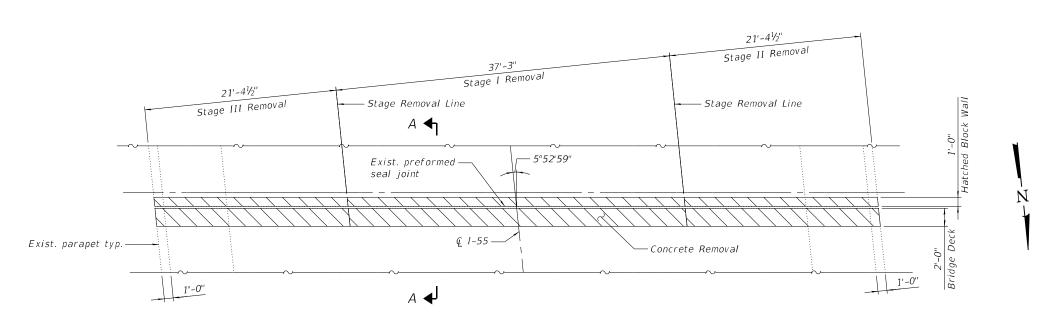

#### BILL OF MATERIAL

Bar	No.	Size	Length	Shape
a(E)	14	#5	35'-8"	
a1(E) 16 #5			21'-8"	
a2(E)	12	#5	20'-3"	
c(E)	20	#5	2'-5"	へ
c1(E)	20	#5	7'-6"	
d(E)	12	#4	4'-5"	Ļ
d1(E)	12	#6	4'-4"	L
d2(E)	16	#4	2'-0"	П
h(E)	8	#6	35'-8"	
h1(E)	16	#6	21'-8"	
x(E)	134	#5	2'-10"	
	Item		Unit	Total
Concrete Removal			Cu Yd	21.9
Concrete Superstructure			Cu Yd	23.7
Reinforcement Bars, Epoxy Coated			Pound	2,830

101/2"

 $BAR \ d1(E)$ 

**BAR** d2(E)

1'-0"


 $BAR \ d(E)$ 

#### JOINT REMOVAL PLAN

(South Abutment shown, North Abutment similar)

#### MINIMUM BAR LAP

#5 bar = 3'-1" #6 bar = 3'-7"

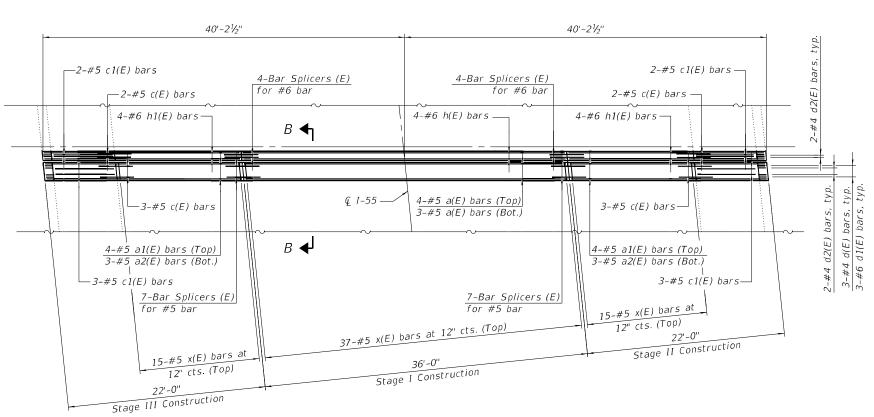

### NOTES:

1. Removal and disposal of existing expansion joint shall be included with the cost of Concrete Removal.

 $BAR \ c(E)$ 

2. The North and South Abutment Preformed Joint Strip Seal shall be per the details labeled (FOR SKEWS  $\leq 30^{\circ}$ ) on Sheet 9 of 14 thru 11 of 14.

#### JOINT RECONSTRUCTION PLAN

(South Abutment shown, North Abutment similar)


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				CONTRA	CT NO. 6	32T49
2911	FAU 291	11 22 BJ		соок	53	32
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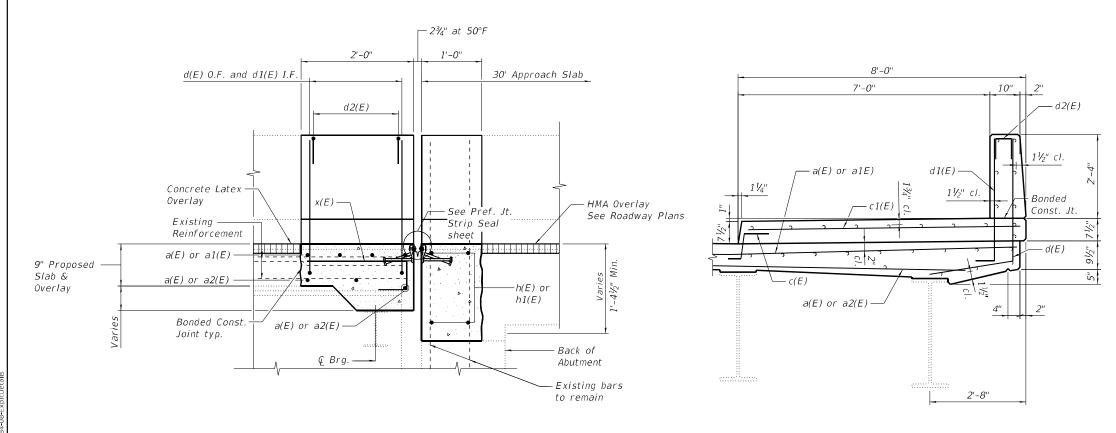
BAR x(E)

09130422-sht-016-0184-07-ExpJtPlan



#### SECTION A-A

EXISTING SECTION THRU PARAPET

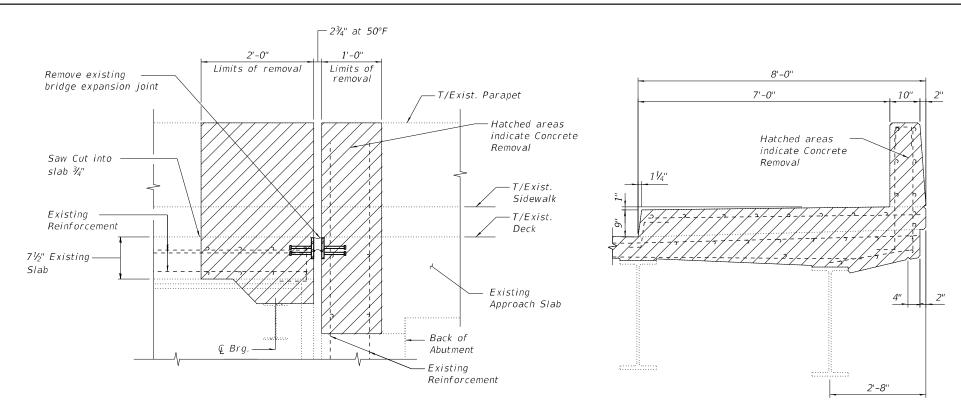

SECTION B-B


PROPOSED SECTION THRU PARAPET

1	U
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STATE OF ILLINOIS
DEPARTMENT OF TRANSPORTATION


ABUTMENT EXPANSION JOINT REPLACEMENT STRUCTURE NO. 016-0184		SECTION	COUNTY	TOTAL SHEETS	SHEET NO.
		FAU 2911 22 BJ	соок	53	33
			CONTRA	CT NO. 6	32T49
SHEET 8 OF 14 SHEETS		ILLINOIS EED A	D DBO JECT		



Top of locking

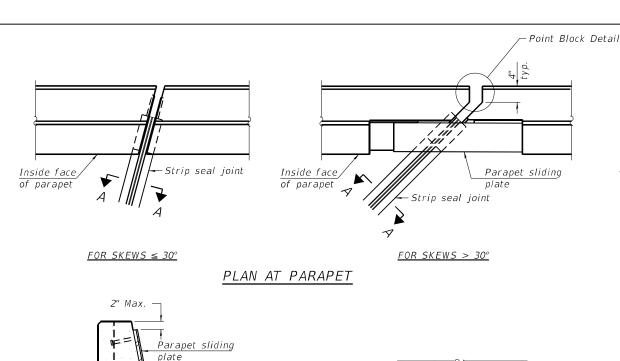Top of deck

edge rail

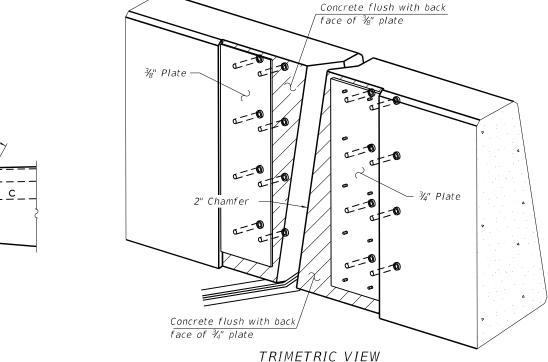

(Showing embedded plates only)

1'-0"

Min. lap

¾" Ø Countersunk bolts

(10 per side 39" parapet)

(12 per side 44" parapet)

SECTION B-B

1/2" Parapet sliding plate

¾" Embedded plate,

full depth

Notes: (8 per side 39" parapet) (10 per side 44" parapet)

\* ¾" Ø x 6" Studs

° 🗖 ¾" Embedded plate

i full deptho

6"

1'-0"

<u>Direction</u> of traffic

The strip seal shall be made continuous and shall have a minimum thickness of  $\frac{1}{4}$ ". The configuration of the strip seal shall match the configuration of the locking edge rails. Open or "webbed" strip seal gland configurations are not permitted. The gland shall be sized for a maximum rated movement of 4 inches.

The locking edge rails depicted are configured for typical applications and are conceptual only. The actual configuration of the locking edge rails and matching strip seal may vary from manufacturer to manufacturer provided they fit the application and meet the minimum anchorage shown. Flanged edge rails, however, will not be allowed. Locking edge rails may exceed the 4½" maximum depth provided the anchorage system is revised according to the manufacturer's recommendation.

The manufacturer's recommended installation methods shall be followed.

All steel components shall be galvanized after fabrication according to Article 520.03 of the Standard Specifications.

The Maximum space between locking edge rail segments shall be  $\frac{3}{16}$ " and sealed with a suitable sealant; however, any rail joint within 10' measured perpendicular to the face of the curb or parapet shall be welded as shown in the locking edge rail splice detail.

The top surface of sidewalk sliding plates shall have a raised pattern according to ASTM A786.

Cost of parapet sliding plates, sidewalk sliding plates, embedded plates, anchorage studs, and expansion anchors included with Preformed Joint Strip Seal.

39" constant slope barrier shown, 44" constant slope barrier similar as noted.

The concrete opening below the strip seal will vary based on the locking edge rail chosen by the Contractor. Deck and parapet lengths shown elsewhere in the plans are dimensioned to the concrete opening, not the joint opening, and are based on the rolled locking edge rail. If the Contractor elects to use a different locking edge rail, dimensional adjustments may be required. One exception to this would be the strip seal joint at the end of the precast bridge approach slab. For these cases the pavement connector length shall be adjusted, not the length of the bridge approach slab.

### Locking edge rail at 50° F Top of concrete -Strip seal at 50° F

for holding the proper joint opening based on the temperature during the deck pour. Place to miss studs. All rods shall be burned, or sawed SHOWING ROLLED RAIL JOINT off flush with the plates after concrete is set.

JJM

### SHOWING WELDED RAIL JOINT


Locking edge rail

Top of concrete

### 3/4" <u>ROLLED</u> WELDED RAIL (EXTRUDED) RAIL

### LOCKING EDGE RAILS

\*\* Back gouge not required if complete joint penetration is verified by mock-up.

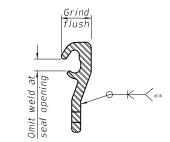

#### LOCKING EDGE RAIL SPLICE

The inside of the locking edge rail groove shall be free of weld residue. Rolled rail shown, welded rail similar.

#### BILL OF MATERIAL

Item	Unit	Total
Preformed Joint Strip Seal	Foot	161

#### SECTION A-A

\* Granular or solid flux filled headed studs conforming to Article 1006.32 of the Std. Specs., automatically end welded.

 $\frac{3}{8}$ " Ø threaded rods in  $\frac{7}{16}$ " Ø holes at  $\pm 4$ '-0" cts.

\*  $\frac{1}{8}$ " Ø x 6" studs @ 6" cts. (alternate angled/bent studs with horizontal studs)

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REVISED

DETAIL A

(Sheet 1 of 3)

STATE OF ILLINOIS	
DEPARTMENT OF TRANSPORTATION	

17/8"

at 50° F

-Strip seal

at 50° F

SECTION COUNTY PREFORMED JOINT STRIP SEAL - SIDEWALK 2911 FAU 2911 22 BJ COOK 53 34 **STRUCTURE NO. 016-0184** CONTRACT NO. 62T49 SHEET 9 OF 14 SHEETS

*EJ-SS-S* 

В

5/8" Ø x 6" Studs

Detail A -

E :

6" cts.,

except as shown in plan view.)


SECTION AT PARAPET (Skews > 30° shown. Skews ≤ 30° similar


Inside Face


of Parapet


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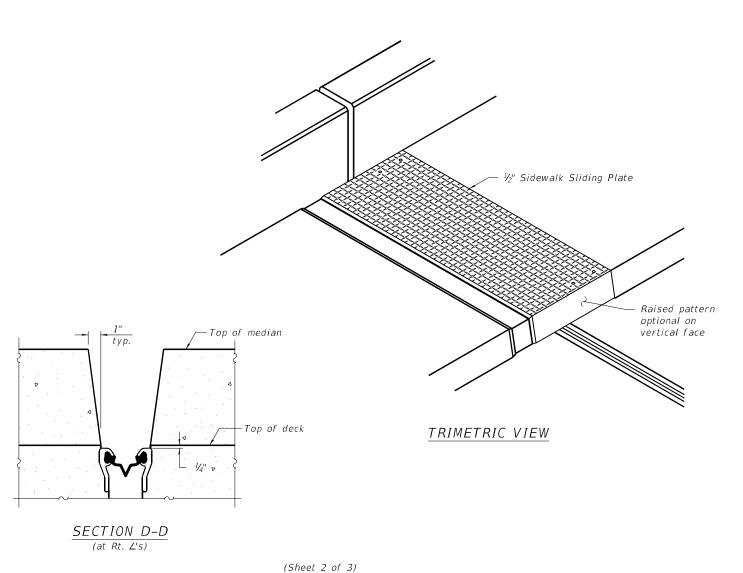




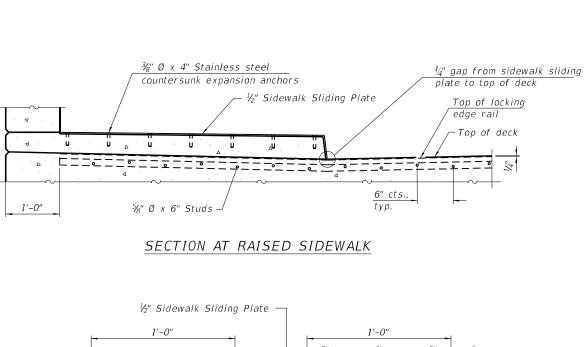

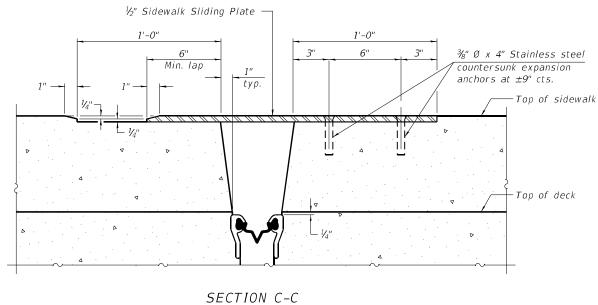

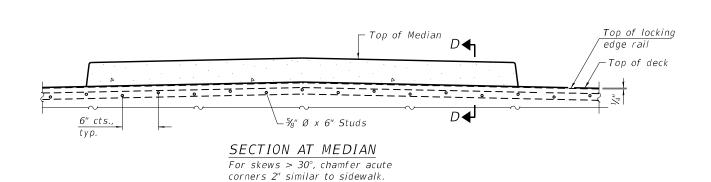PLAN AT RAISED SIDEWALK

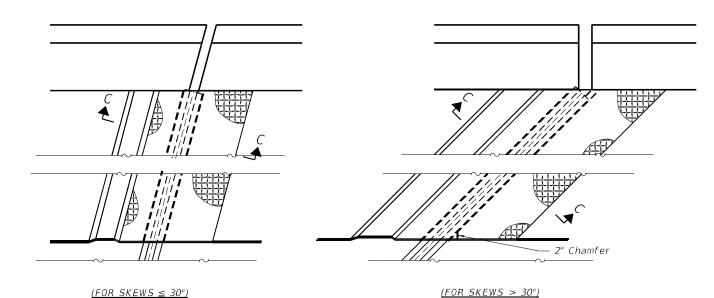

*EJ-SS-S* 5-15-2023

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ENGINEERING, LLC

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STATE OF ILLINOIS
DEPARTMENT OF TRANSPORTATION


 PREFORMED JOINT STRIP SEAL - SIDEWALK
 F.A.U. RTE.
 SECTION
 COUNTY SHEETS
 SHEETS NO.

 STRUCTURE NO. 016-0184
 2911
 FAU 2911 22 BJ
 CONTRACT NO. 62T49

 SHEET 10
 OF 14
 SHEETS
 BLLINOIS FED. AD PROJECT

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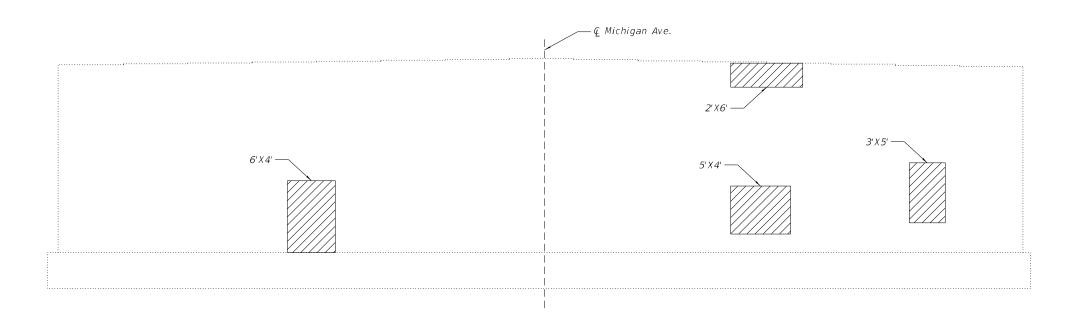
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STATE OF ILLINOIS
DEPARTMENT OF TRANSPORTATION


 ED JOINT :			SEAL - SIDEWALK 16-0184	(
SHEET 11	OF	14	SHEETS	

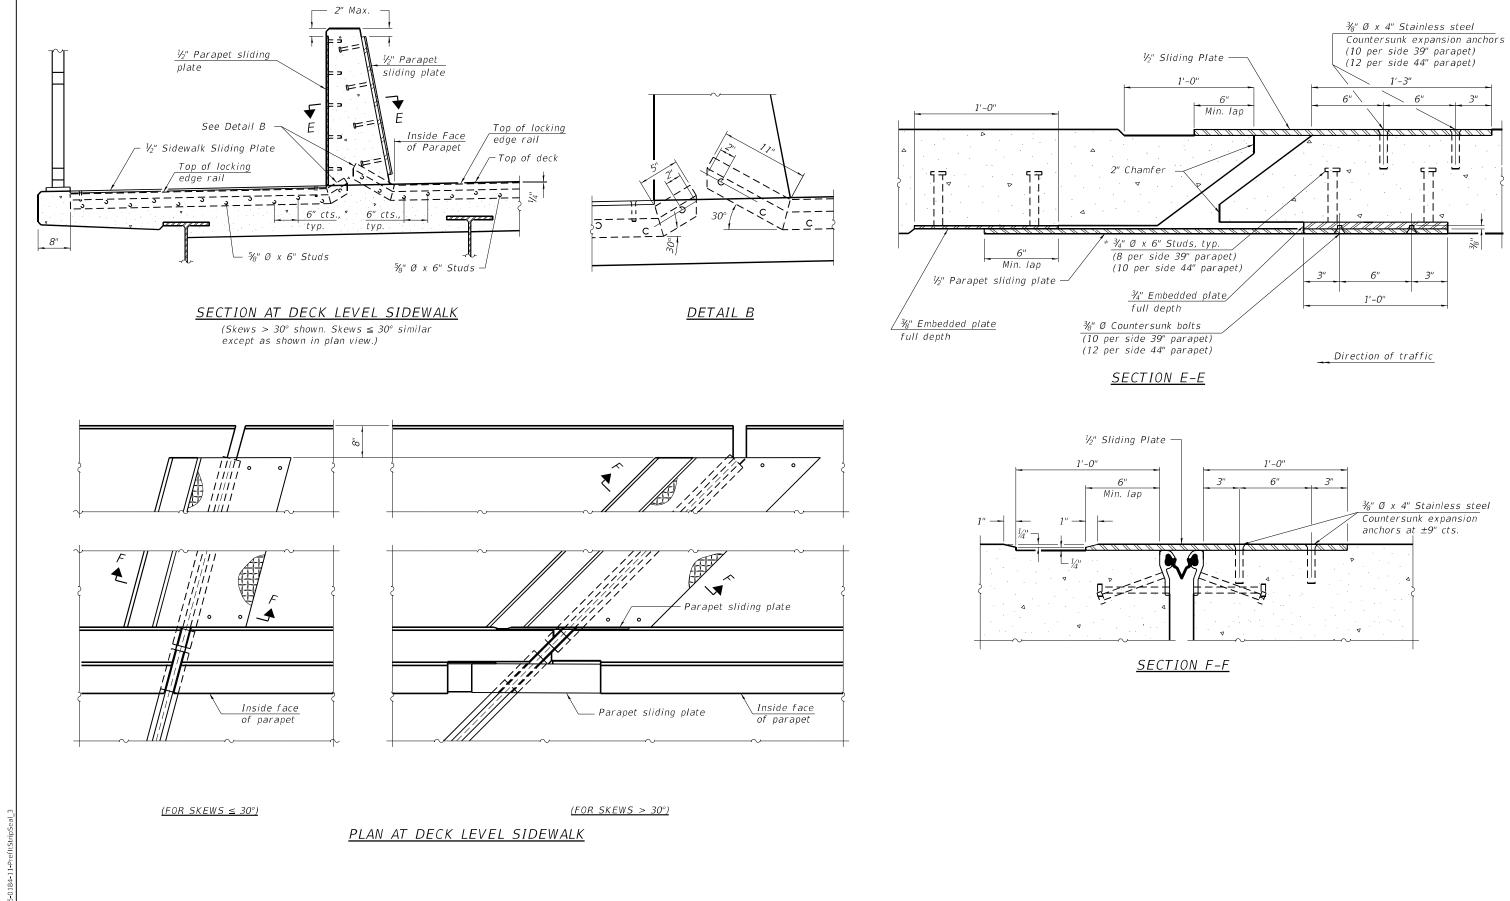(Sheet 3 of 3)



# NORTH ABUTMENT ELEVATION

(Looking North)

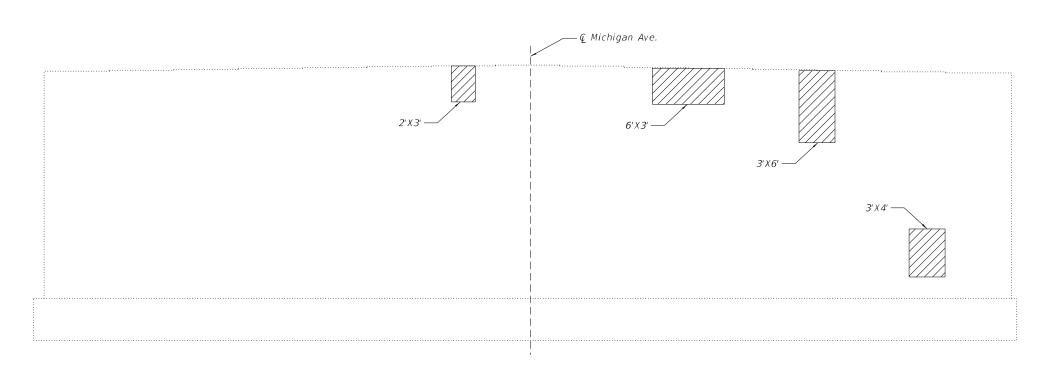

### NOTE

1. See sheet 13 of 14 for Bill of Material.

# <u>LEGEND</u>



Structural Repair of Concrete (Depth Equal to or Less than 5 Inches)

SOUTH ABUTMENT ELEVATION (Looking South)


(Sheet 1 of 2)

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ż	GARZA KARHOFF ENGINEERING, LLC	
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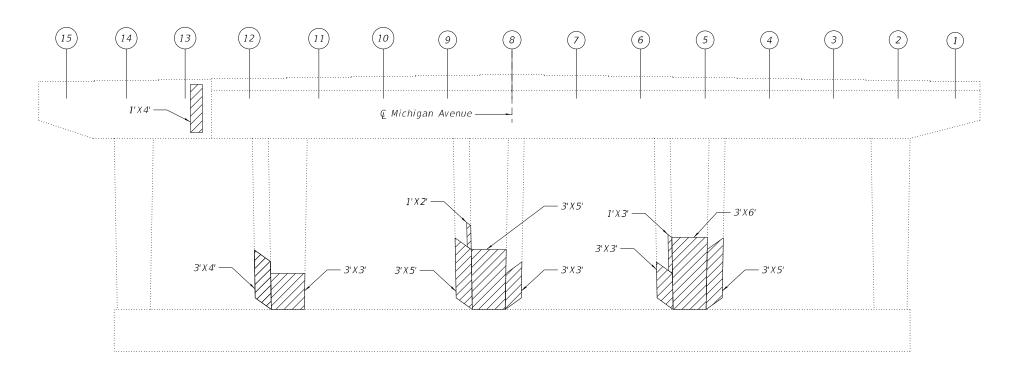
SUBSTRUCTURE REPAIR DETAILS STRUCTURE NO. 016-0184								
SHEET 12	OF	14	SHEETS					

F.A.U. RTE	SECTION	COUNTY	TOTAL SHEETS	SHEET NO.
2911	FAU 2911 22 BJ	соок	53	37
		CONTRA	CT NO. (	32T49
	ILLINOIS FED. A	ID PROJECT		



# PIER SOUTH FACE

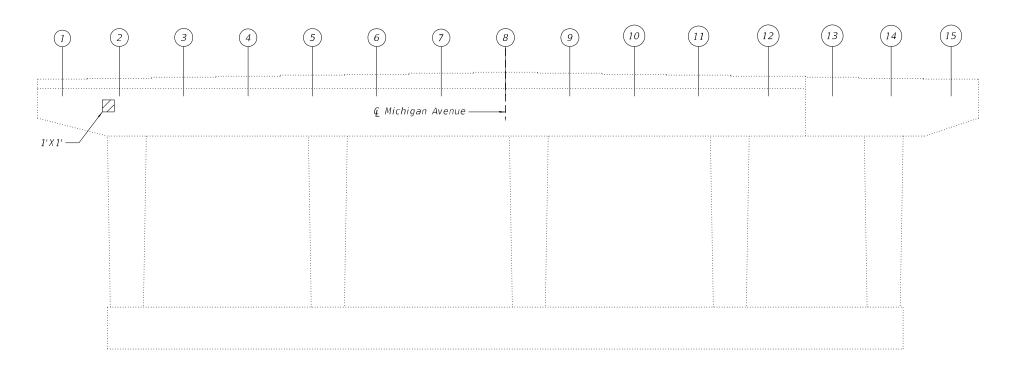(Looking North)



PIER NORTH FACE
(Looking South)

# LEGEND



Structural Repair of Concrete (Depth Equal to or Less than 5 Inches)

### BILL OF MATERIAL

Item	Unit	Total
Concrete Sealer	Sq Ft	237
Structural Repair of Concrete (Depth Equal to or Less than 5 Inches)	Sq Ft	237

(Sheet 2 of 2)



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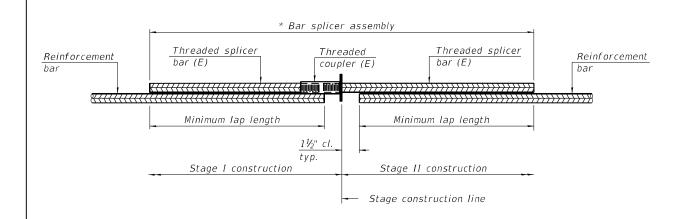
STATE OF ILLINOIS DEPARTMENT OF TRANSPORTATION

SUBSTRUCTUF STRUCTUR			
SHEET 13	OF ·	14	SHEETS

 
 FAU. RTE.
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 COUNTY
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 SHEETS NO.

 2911
 FAU 2911 22 BJ
 COOK
 53
 38

 COUNTRACT NO. 62T49




#### STANDARD BAR SPLICER ASSEMBLY PLAN

Only bar splicer assemblies as presented on the approved QPL list may be used.

Threaded splicer bar length = min. lap length +  $1\frac{1}{2}$ " + thread length

\* Epoxy not required on Bar Splicer Assembly components used in conjunction with black bars.

Location	Bar	No. assemblies	Minimum
Location	size	required	lap length
S. Abut	#5	14	3'-1"
S. Abut	#6	8	3'-7"
N. Abut	#5	14	3'-1"
N. Abut	#6	8	3'-7"

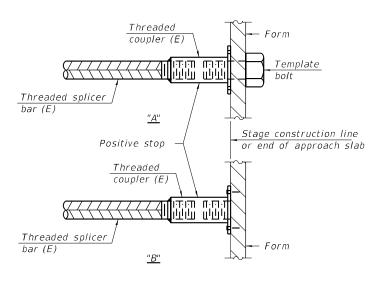

### INSTALLATION AND SETTING METHODS

"A" : Set bar splicer assembly by means of a template bolt

"B": Set bar splicer assembly by nailing to wood forms or cementing to steel forms. (E): Indicates epoxy coating.

Stage line if applicable Stage I construction | Stage II construction Mechanical splicer (E) Reinforcement bar — Reinforcement bar

### STANDARD MECHANICAL SPLICER

Location	Bar size	No. assemblies required

Notes:

Splicer bars shall be deformed with threaded ends and have a minimum 60 ksi yield strength.


All reinforcement shall be lapped and tied to the splicer bars. Bar splicer assemblies shall be epoxy coated according to the requirements

for reinforcement bars. See Section 508 of the Standard Specifications. See approved list of bar splicer assemblies and mechanical splicers for alternatives.

BSD-1

5-15-2023

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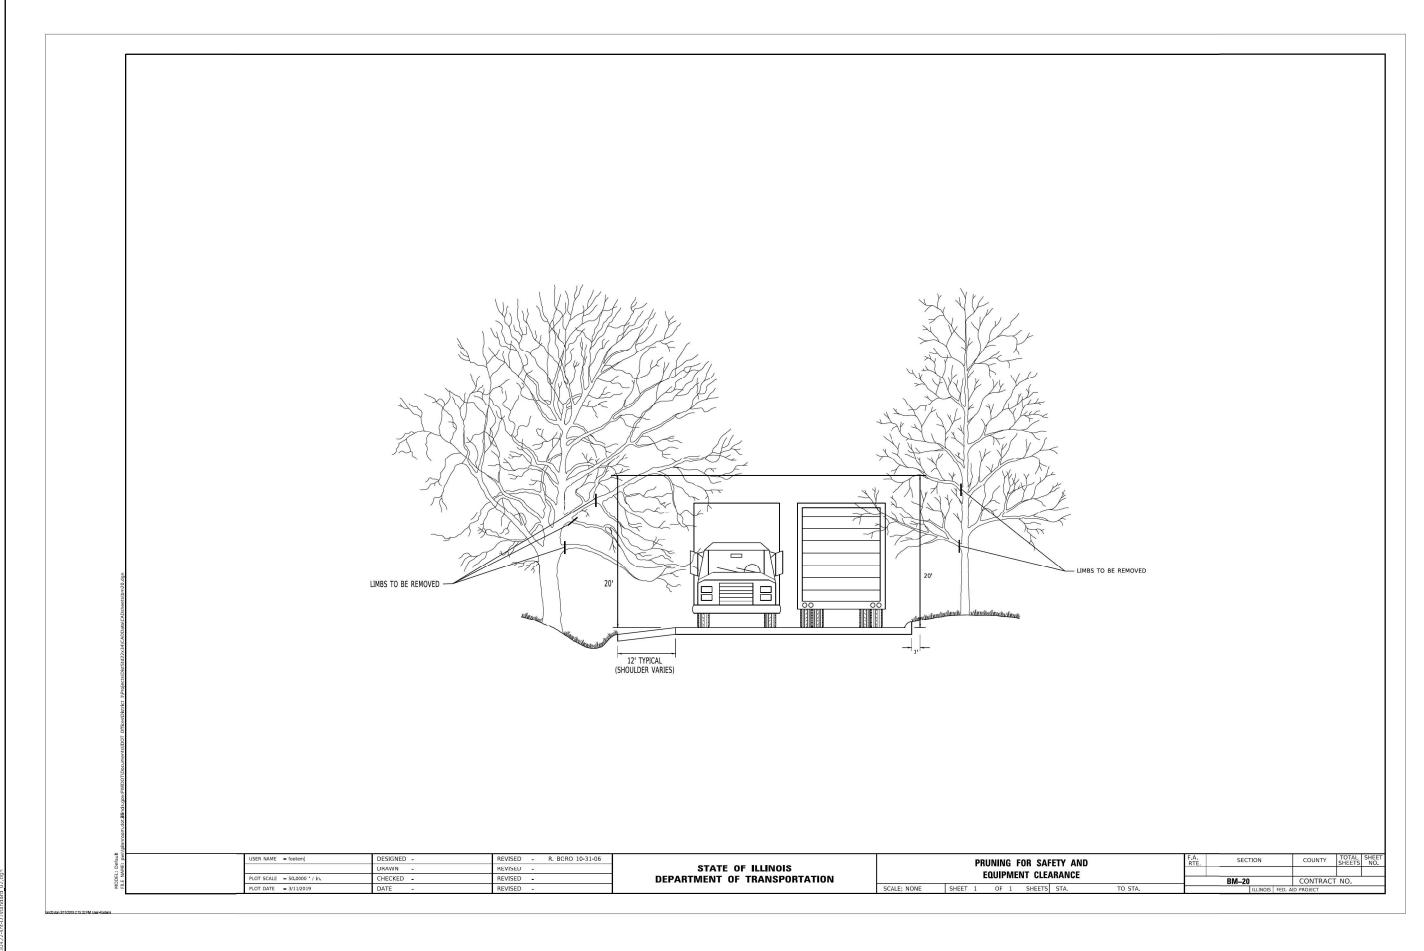

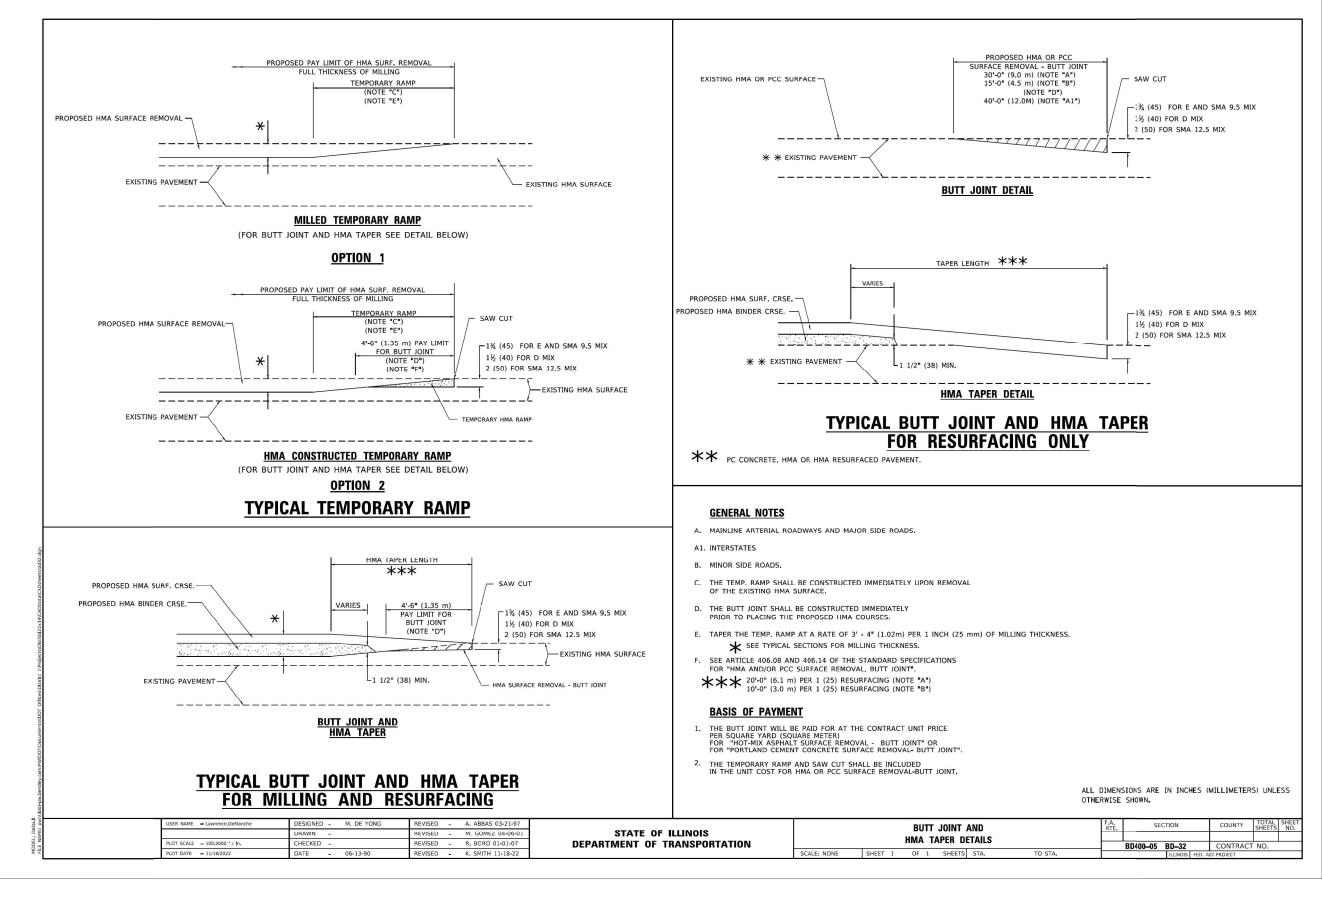
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STATE OF ILLINOIS
DEPARTMENT OF TRANSPORTATION

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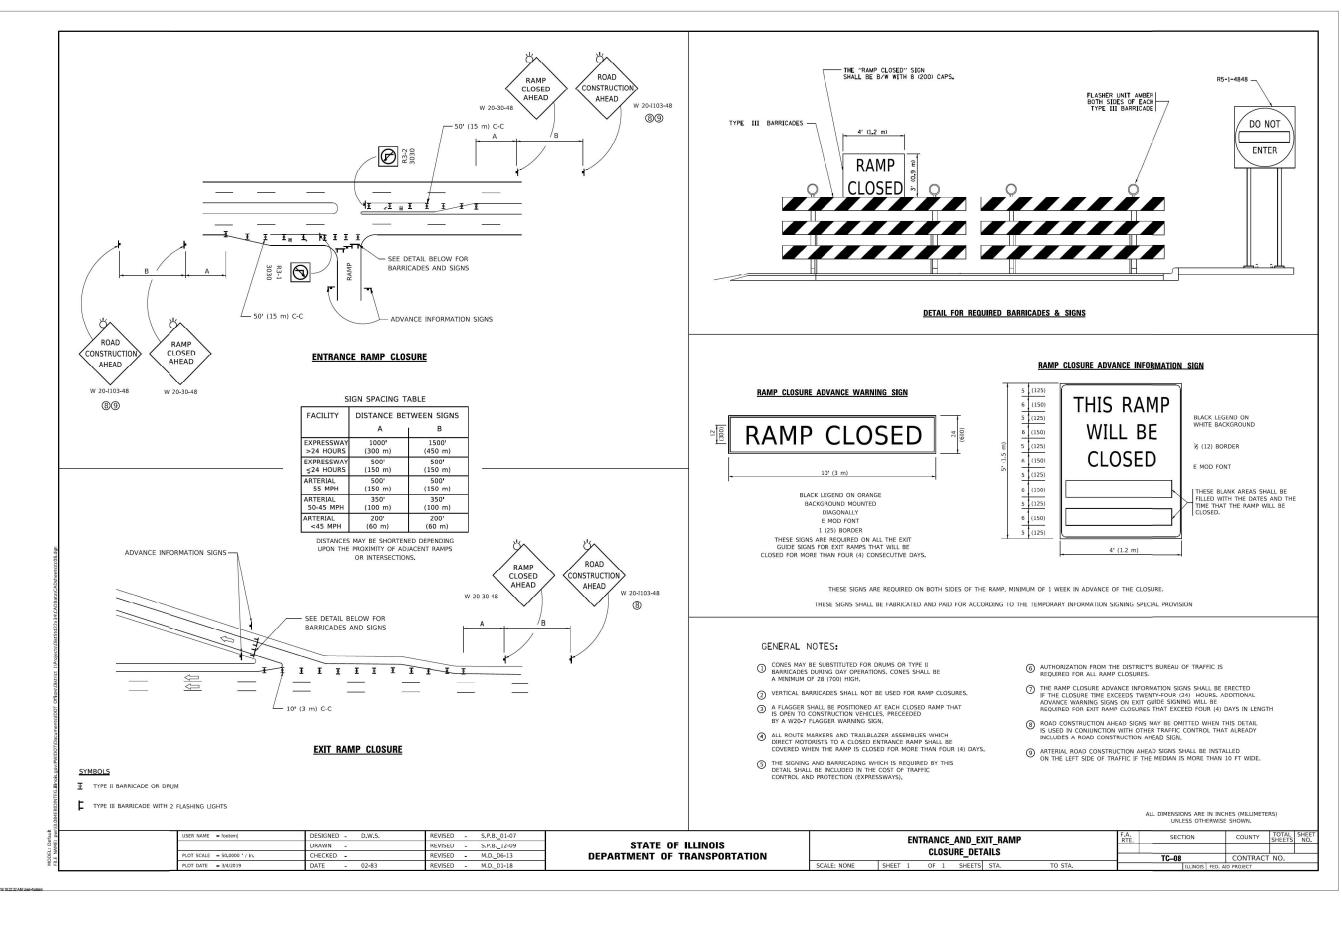
BUTT JOINT AND HMA TAPER DETAILS		F.A.U. RTE	RTE. SECTION		COUNTY	TOTAL SHEETS	SHEET NO.				
		2911	FAU 2911 22 BJ			соок	53	40			
	IIIVIA IA	I LII DI	INILO						CONTRAC*	T NO. 62	2T49
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	PRUNING FOR SAFETY AND							F.A.U. RTE	SECTI	ON		COUNTY	TOTAL SHEETS	SHEET NO.	
								2911	FAU 2911	22 BJ		COOK	53	41	
												CONTRACT	NO. 62	2T49	
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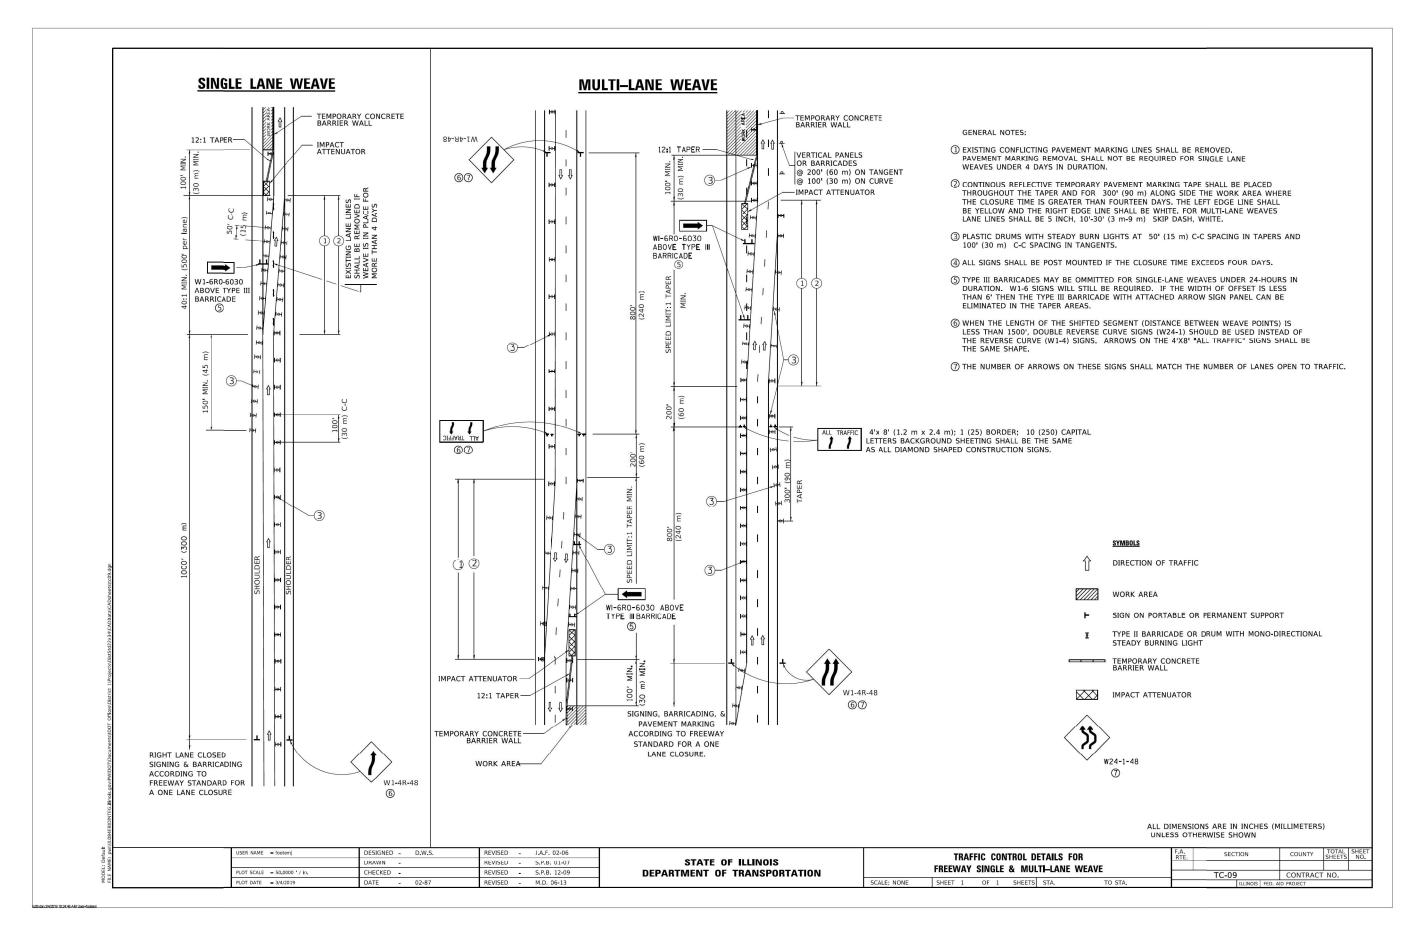


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DEPARTMENT OF TRANSPORTATION

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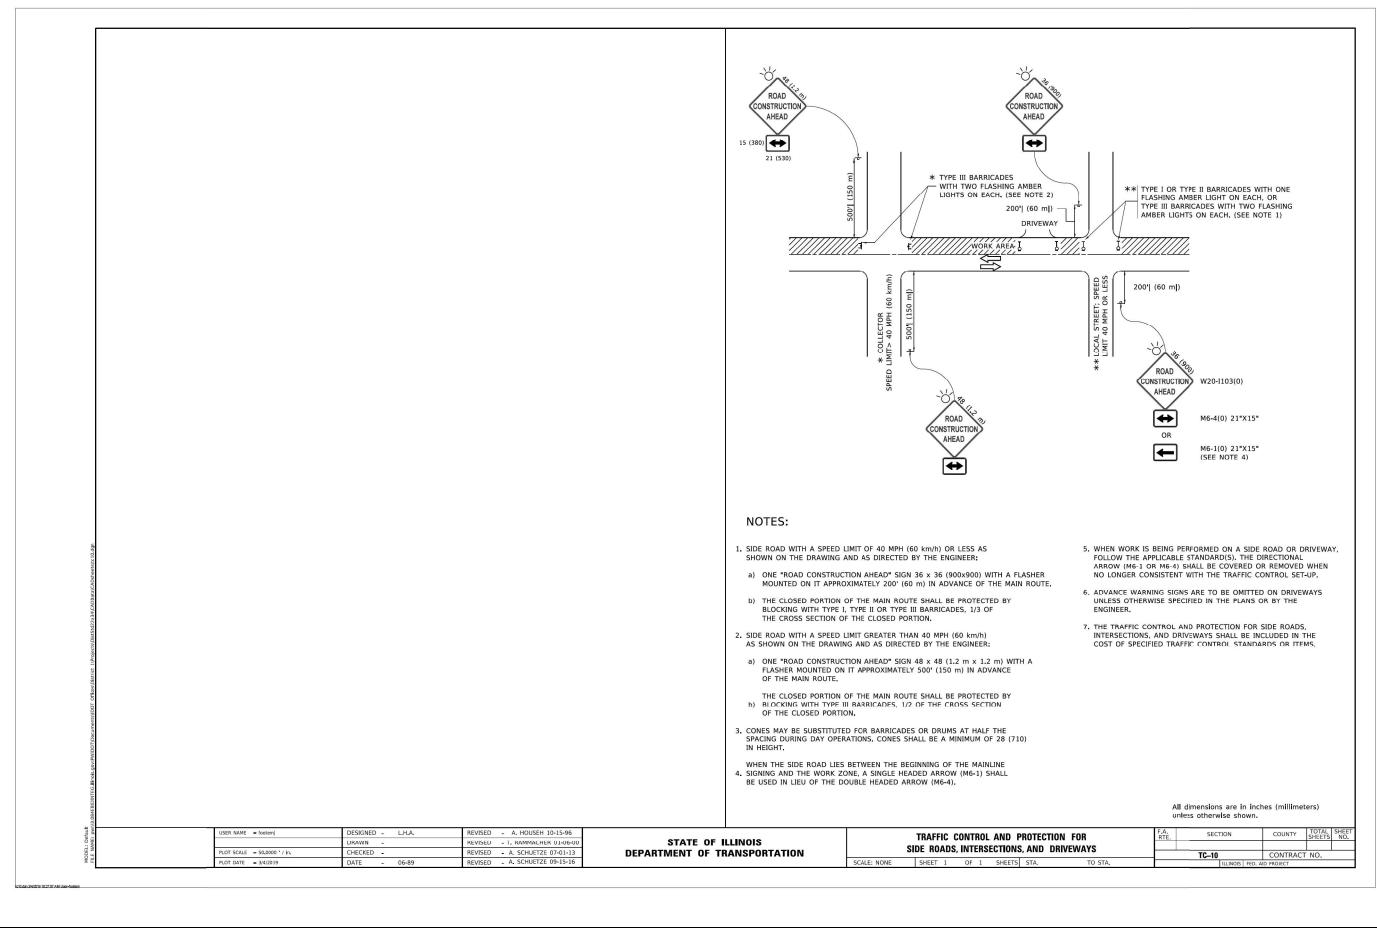


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STATE OF ILLINOIS
DEPARTMENT OF TRANSPORTATION

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2911	FAU 2911 22 BJ		COOK	53	43
			CONTRACT	NO. 62	2T49
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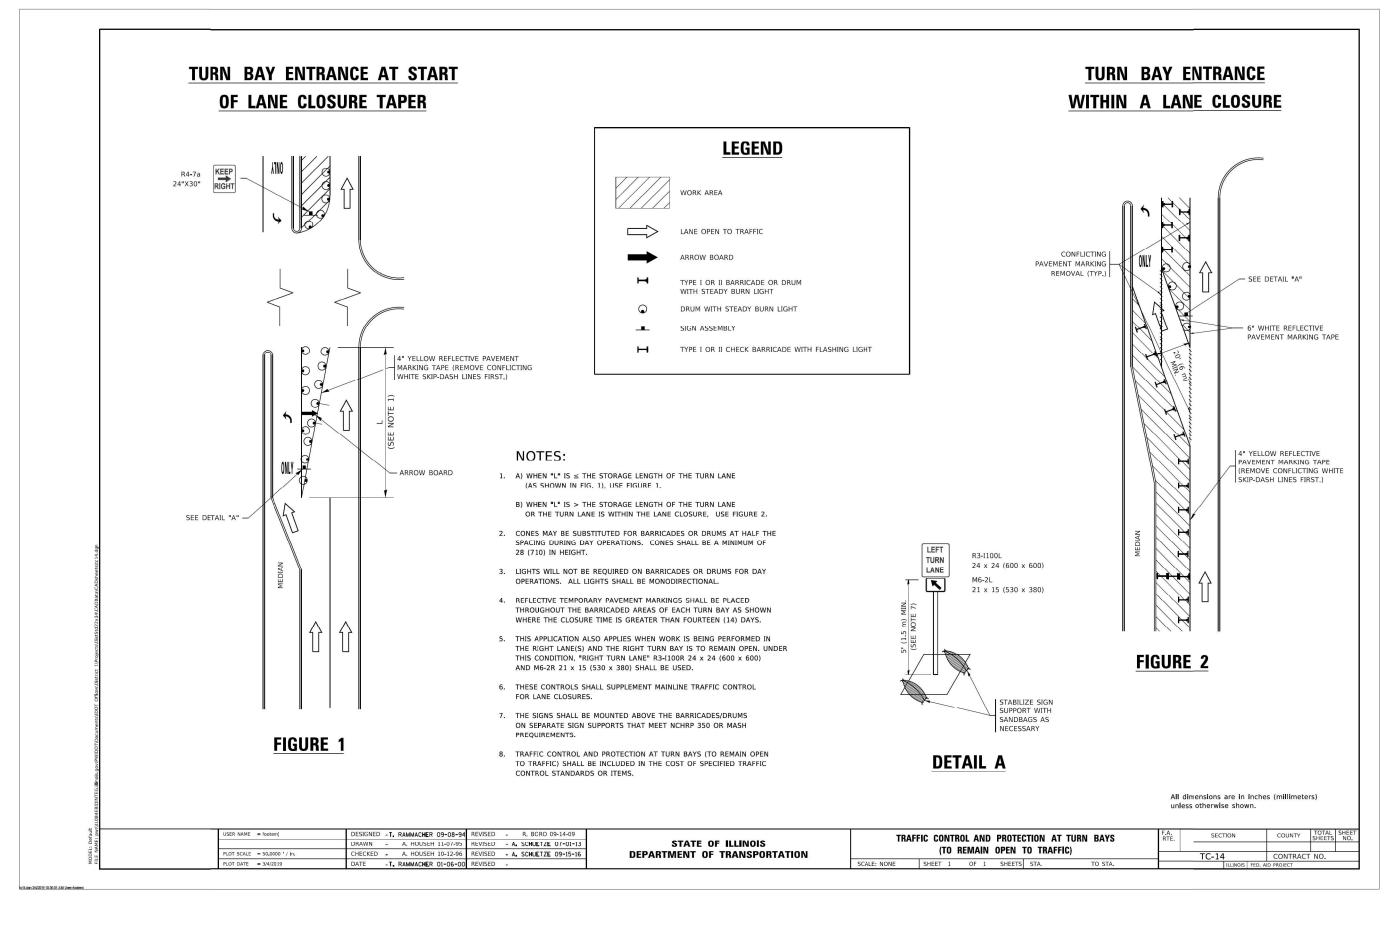


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STATE OF ILLINOIS
DEPARTMENT OF TRANSPORTATION

TRAFFIC CONTROL AND PROTECTION FOR SIDE ROADS, INTERSECTIONS, AND DRIVEWAYS							
	SHEET	5	OF	14	SHEETS	STA.	TO STA.

F.A.U. RTE	SECT	ПОИ	COUNTY	TOTAL SHEETS	SHE NC	
2911	FAU 291	1 22 BJ		соок	53	44
				CONTRACT	NO. 62	2T49
		ILLINOIS	FED. A	ID PROJECT		



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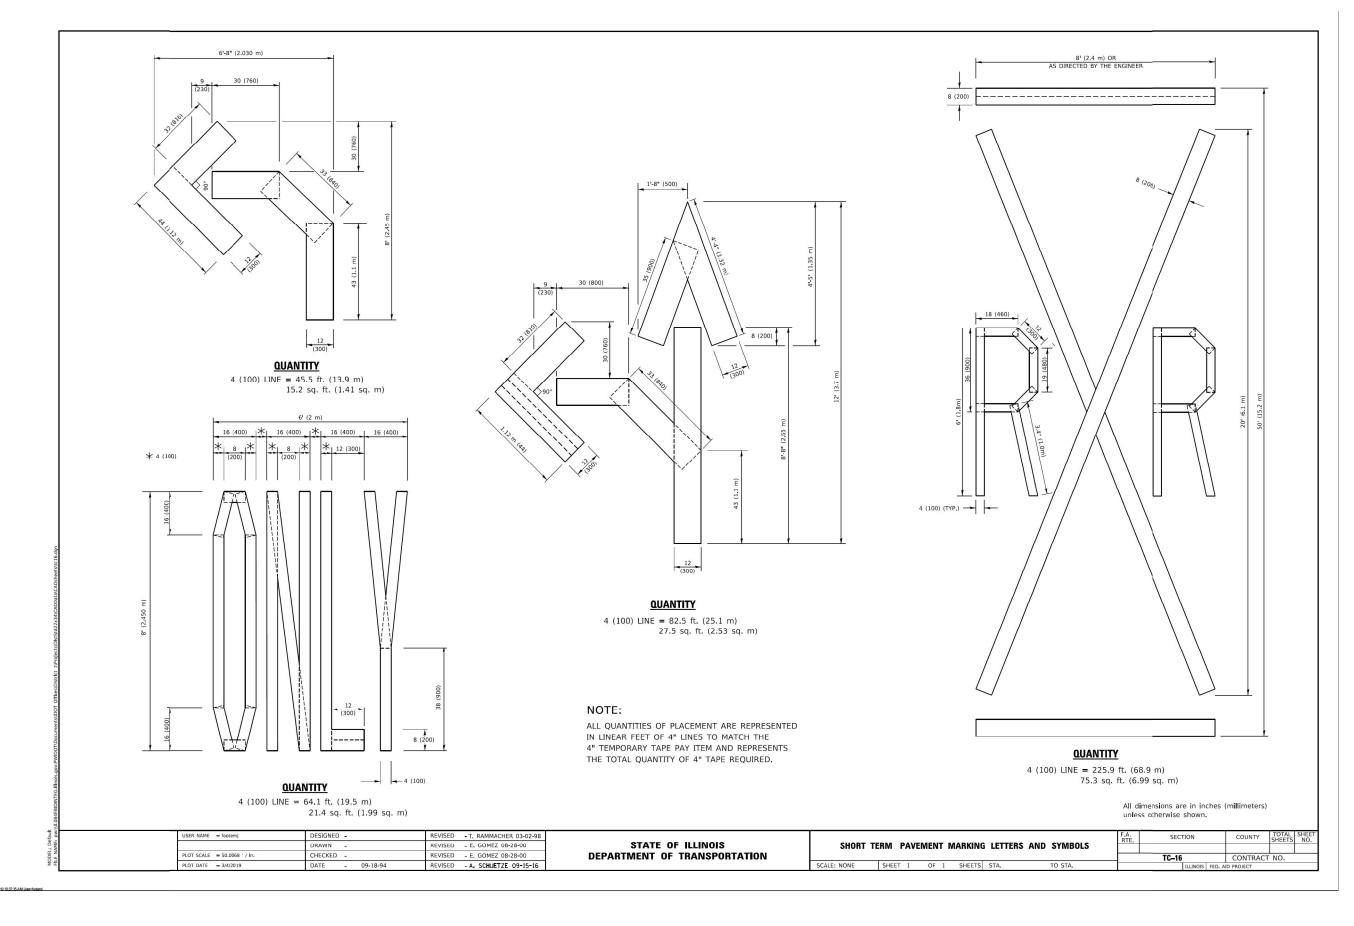
STATE OF ILLINOIS
DEPARTMENT OF TRANSPORTATION

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(TO REMAIN OPEN TO TRAFFIC)										
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 2911
 FAU 2911 22 BJ
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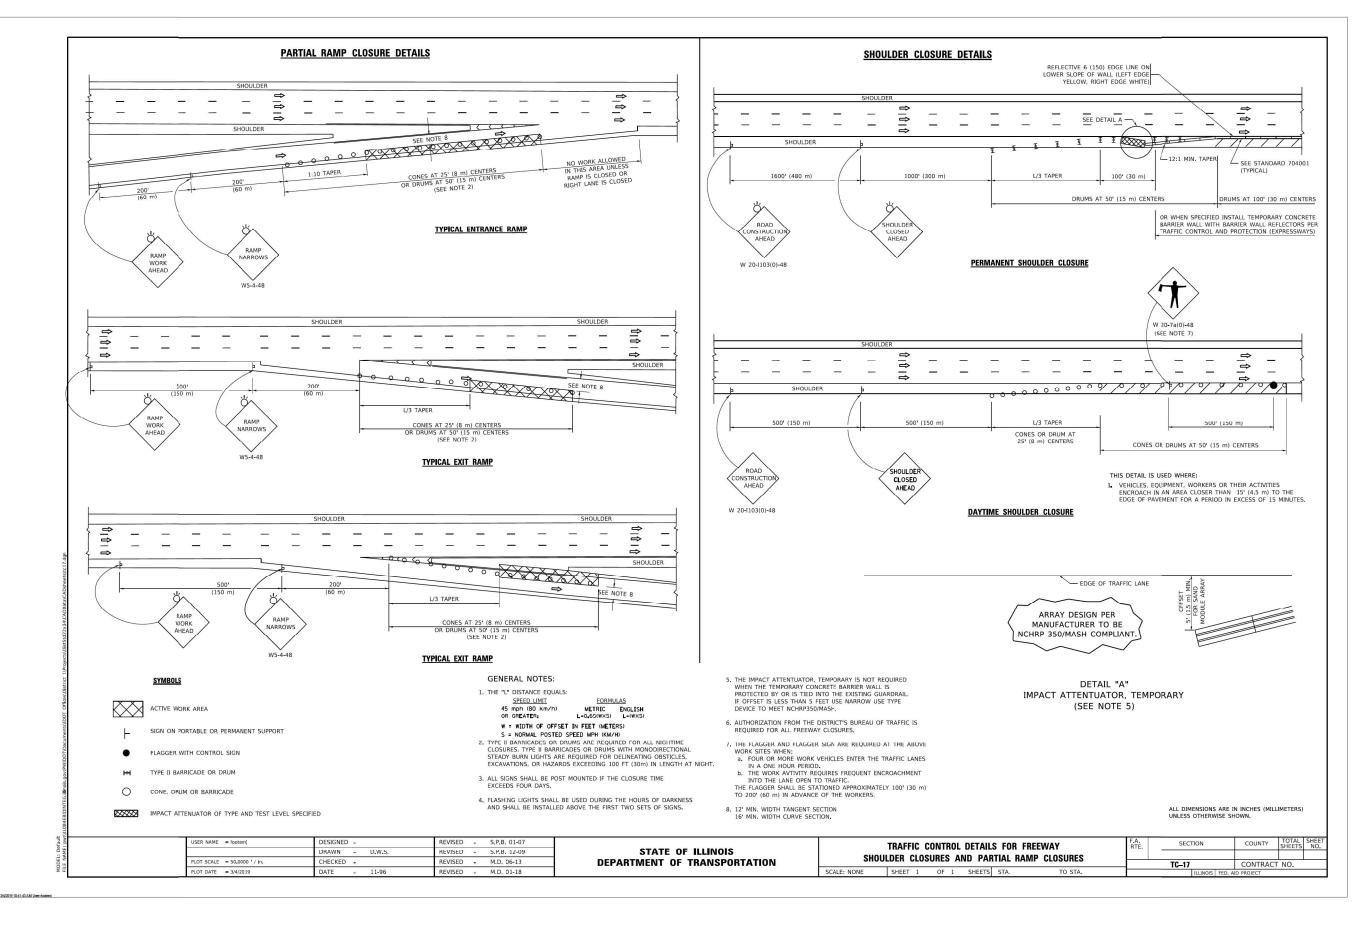
 CONTRACT NO. 62T49



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STATE OF ILLINOIS
DEPARTMENT OF TRANSPORTATION


	SHORT TERM PAVEMENT MARKING	F.A.U. RTE	SECTION	COUNTY	TOTAL SHEETS	SHEET NO.
	LETTERS AND SYMBOLS	2911	FAU 2911 22 BJ	соок	53	46
	LETTENS AND STWDOLS			CONTRACT	NO. 62	2T49
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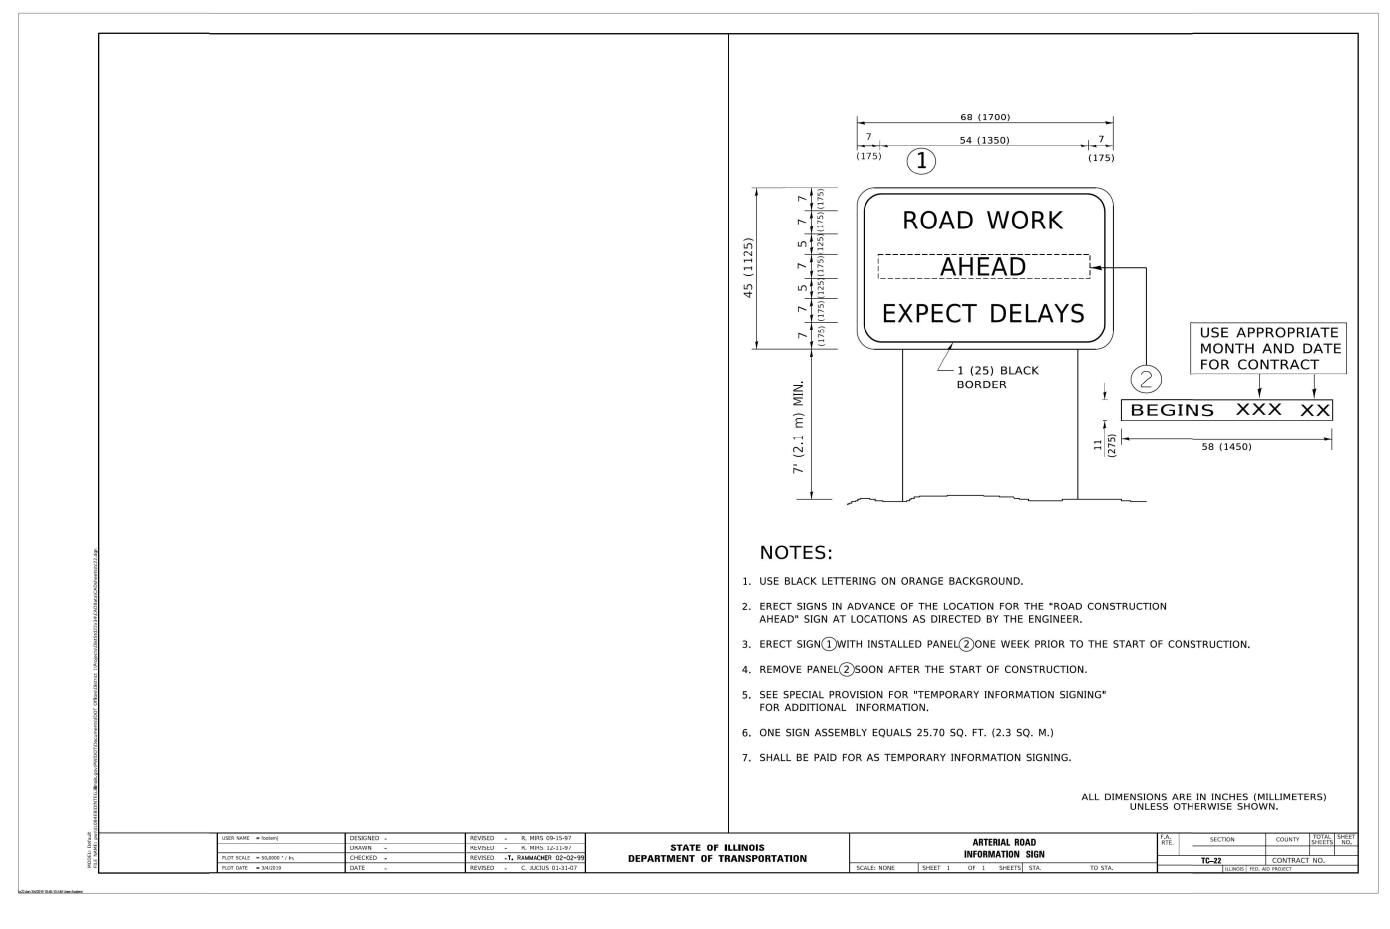
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STATE OF ILLINOIS	
<b>DEPARTMENT OF TRANSPORTATION</b>	

	TRAFFIC CONTROL DETAILS FOR FREEWAY	F.A.U. RTE	SECTION	COUNTY	TOTAL SHEETS	SHEET NO.
CHUIII	DER CLOSURES AND PARTIAL RAMP CLOSURES	2911	FAU 2911 22 BJ	соок	53	47
311001	DEN CECCONES AND I ANTIAL MAIN CECCONES			CONTRACT	NO. 62	2T49
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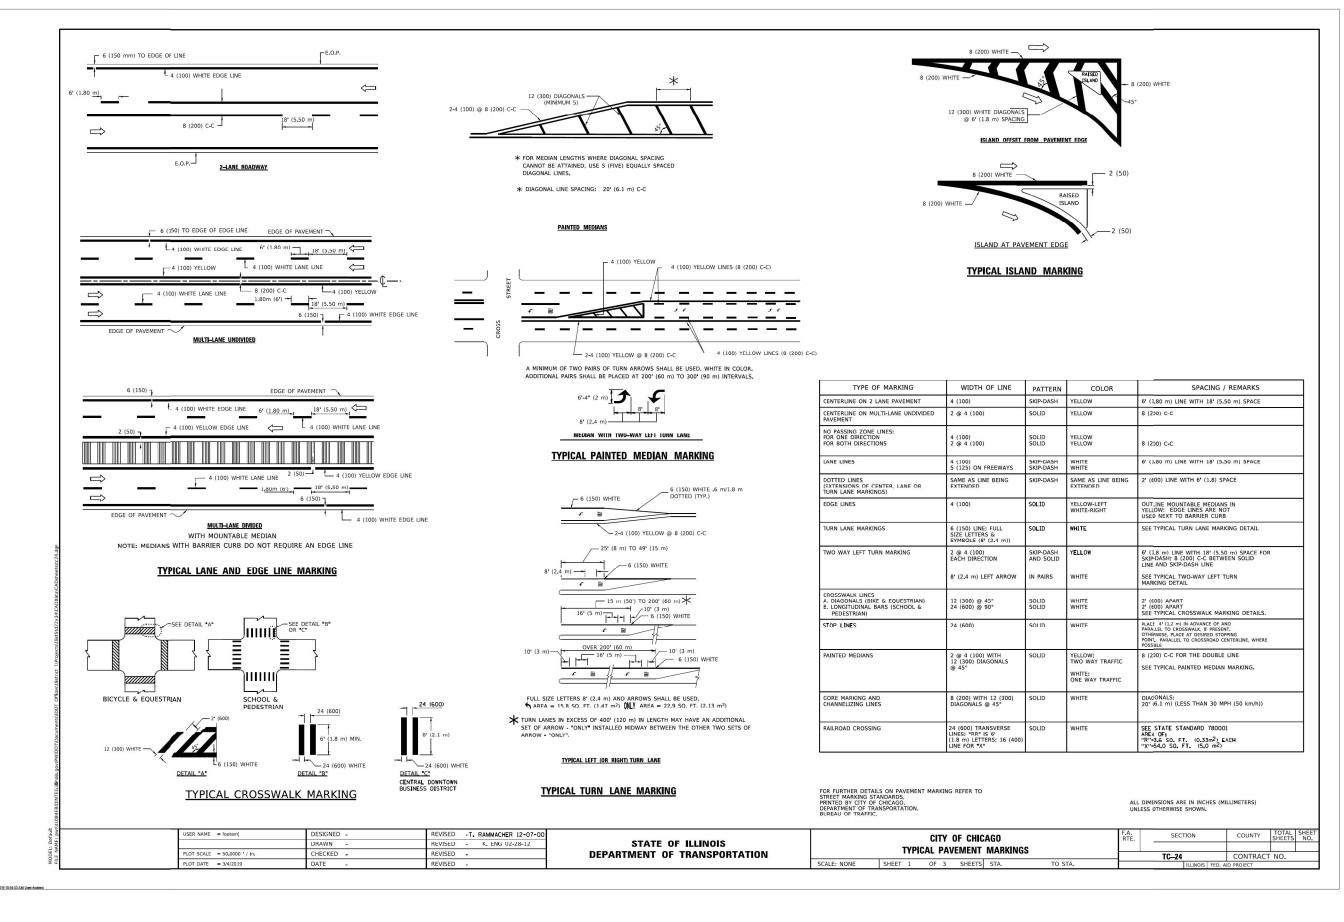
STATE OF ILLINOIS
DEPARTMENT OF TRANSPORTATION



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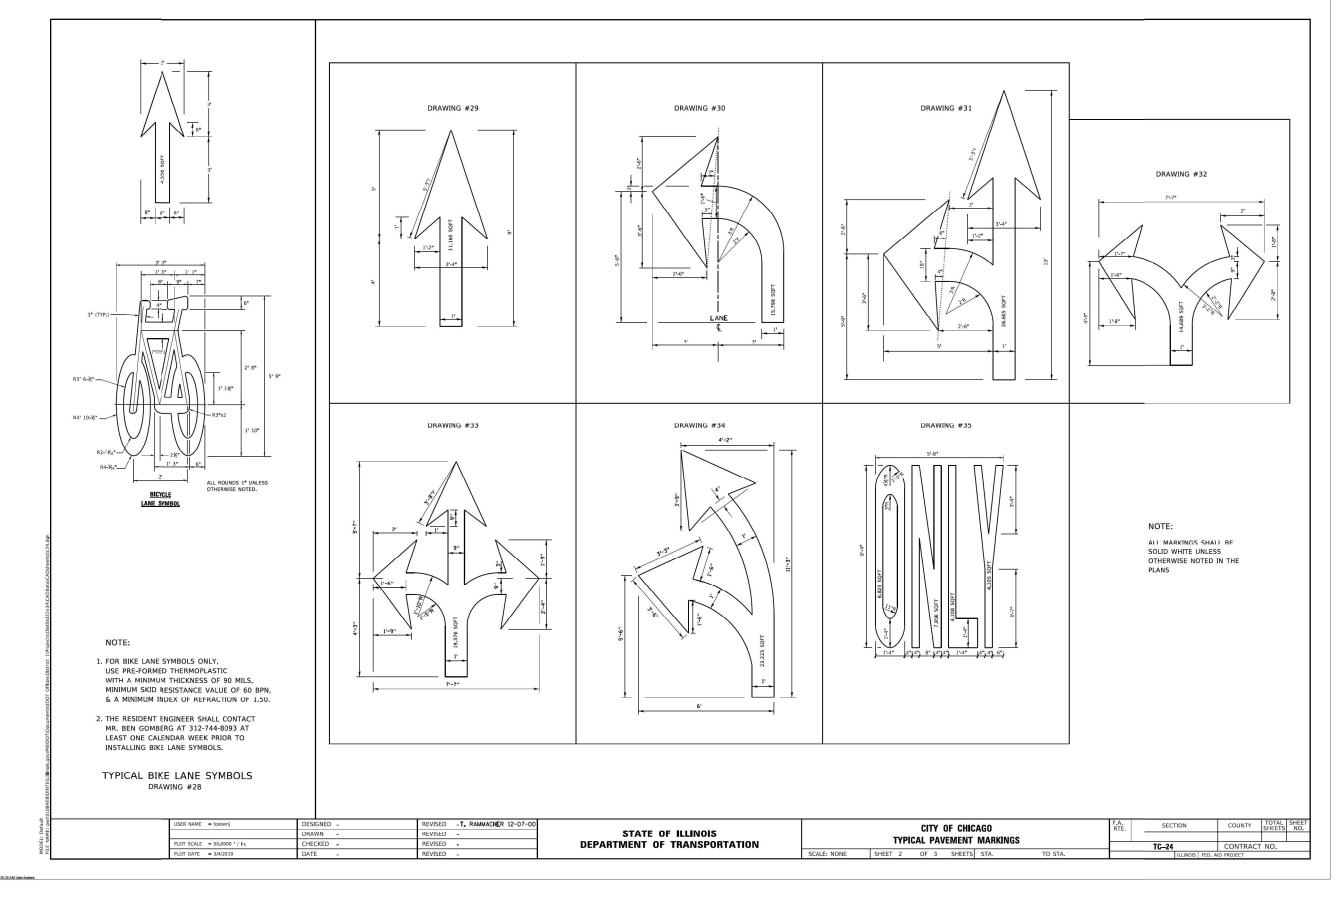
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	ARTERIAL ROAD					F.A.U. RTE	SECTION	COUNTY	TOTAL SHEETS	SHEET NO.	
	INFORMATION SIGN					2911	FAU 2911 22 BJ	соок	53	49	
	INFUNIVIATION SIGN								CONTRACT	NO. 62	2T49
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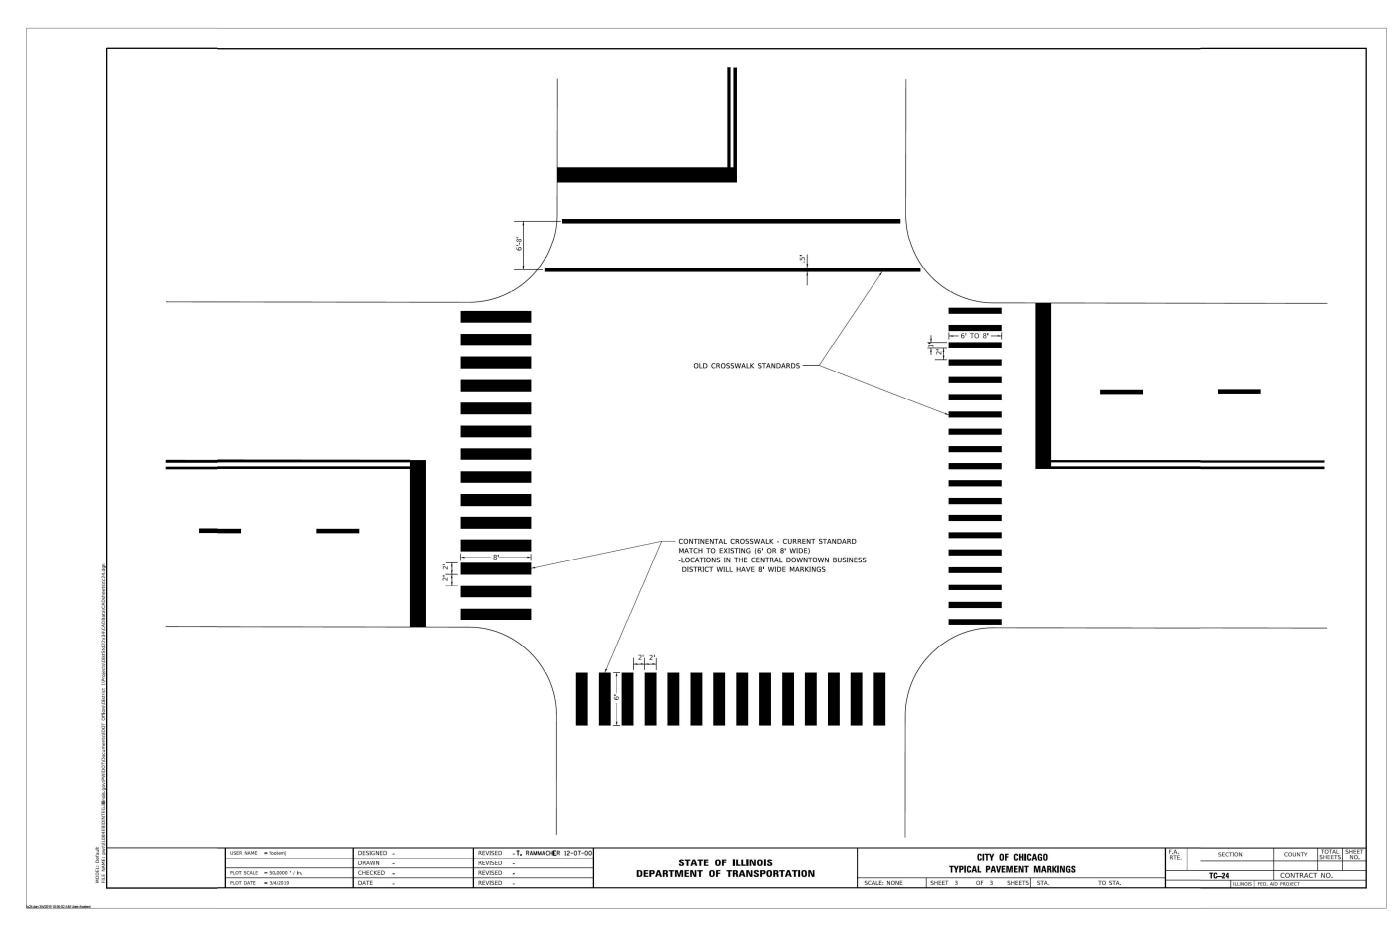


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	TYPICAL PAVEMENT MARKINGS		2911	FAU 291	1 22 BJ		COOK	53	50
ITFICAL FAVEINENT INANNINGS							CONTRAC	F NO. 6:	2T49
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CITY OF CHICAGO	F.A.U. RTE	SECTION	COUNTY	TOTAL SHEETS	SHEET NO.
TYPICAL PAVEMENT MARKINGS	2911	FAU 2911 22 BJ	COOK	53	51
III JOAL I AVENIENI INIAIINJINGO			CONTRAC	F NO. 62	2T49
SHEET 12 OF 14 SHEETS STA. TO STA.		ILLINOIS FED. A	D PROJECT		

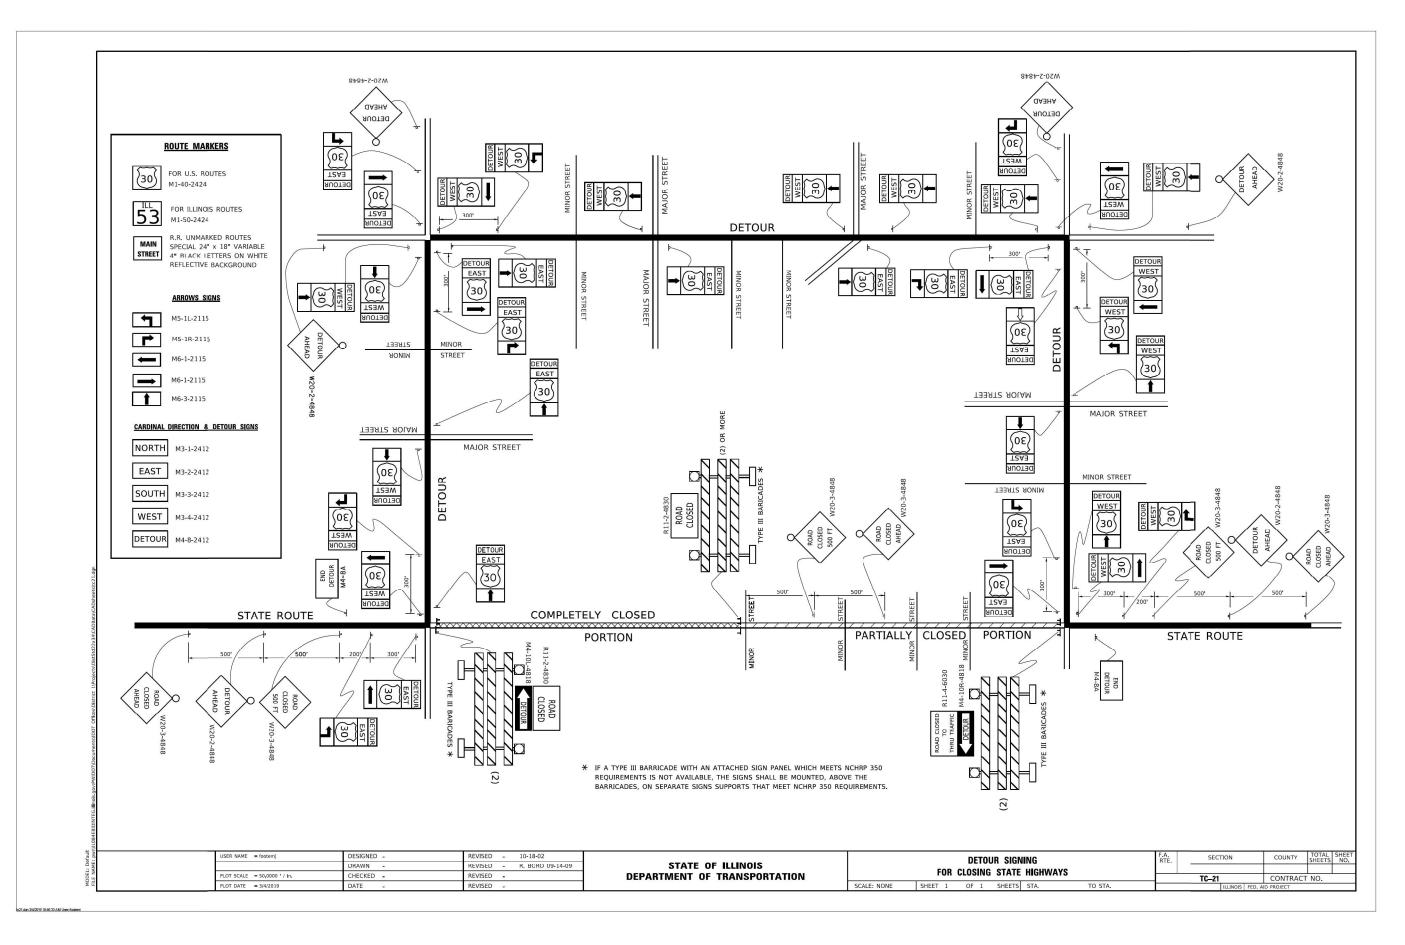

STATE OF ILLINOIS
DEPARTMENT OF TRANSPORTATION


CITY OF CHICAGO
TYPICAL PAVEMENT MARKINGS

SCALE: N.T.S. SHEET 13 OF 14 SHEETS STA. TO STA.

F.A.U. SECTION COUNTY TOTAL SHEETS NO.

2911 FAU 2911 22 BJ COOK 53 52

CONTRACT NO. 62T49

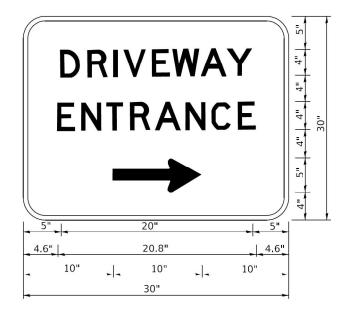

3.0" RADIUS, 0.5" BORDER, WHITE ON GREEN; REFLECTORIZED "DRIVEWAY" D; "ENTRANCE" D; STANDARD ARROW CUSTOM 12.0" x 5.0"

#### NOTES:

- 1. HALF OF THE SIGNS WILL REQUIRE A LEFT HAND FACING ARROW.
- 2. TWO SIGNS SHALL BE USED AT EACH COMMERCIAL ENTRANCE PLACED BACK-TO-BACK: ONE WITH A RIGHT HAND ARROW (SHOWN) SHALL BE PLACED ON THE NEAR RIGHT SIDE THE DRIVEWAY AND ONE WITH A LEFT HAND ARROW SHALL BE PLACED ON THE FAR LEFT SIDE OF THE DRIVEWAY.
- 3. SIGNS TO BE PAID FOR AS ITEM "TEMPORARY INFORMATION SIGNING".

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STATE OF ILLINOIS
DEPARTMENT OF TRANSPORTATION

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GARZA KARHOFF ENGINEERING, LLC
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STATE	OF ILLINOIS	
DEPARTMENT O	F TRANSPORTATION	V

I									F.A.U. RTE		SECTION	COUNTY	TOTAL SHEETS	SHEET NO.
I	DRIVEWAY ENTRANCE SIGNING							2911		FAU 2911 22 BJ	соок	53	53	
										CONTRACT	NO. 62	2T49		
l	SCALE: N.T.S.	SHEET	14	OF	14	SHEETS	STA.	TO STA.		ILLINOIS FED. AID PROJECT				