

GENERAL NOTES:

- 1. CONTRACTOR TO CONTAIN FUEL AND HAZARDOUS WASTE AND PROVIDE CONTAINMENT CELL(S) FOR ANY MATERIALS BROUGHT TO THE SITE.
- 2. THE CONTRACTOR SHALL PROVIDE TRAFFIC CONTROL IN THE FORM OF FLAGMEN, BARRICADES, ETC. AS REQUIRED BY MANUAL ON UNIFORM TRAFFIC CONTROL DEVICES.
- 3. CONTRACTOR TO SEED ALL GRASS AREAS DISTURBED BY THIS CONSTRUCTION UNLESS OTHERWISE NOTED. CONTRACTOR TO MAINTAIN SEED FOR A 30 DAY PERIOD FROM SEEDING. BACKFILL, FINISH GRADE AND SEED BEHIND NEW ROADS AND SIDEWALK WITH CLEAN MATERIAL. PROVIDE SMOOTH TRANSITION WITH EXISTING GRADES.
- 4. GAS, ELECTRIC, TELECOMMUNICATION, AND WATER LINES TO BE RELOCATED BY OTHERS. CONTRACTOR SHALL COORDINATE HIS EFFORTS WITH THE UTILITY COMPANIES. EXACT DISTANCES AND LOCATIONS OF UTILITIES TO BE RELOCATED HAVE NOT YET BEEN DETERMINED.
- 5. THE EXISTING UTILITY LOCATIONS SHOWN ON THESE PLANS WERE COMPILED FROM THE BEST AVAILABLE RECORDS. CONTRACTORS SHALL COORDINATE WITH THE VARIOUS UTILITY COMPANIES TO ESTABLISH EXACT LOCATIONS AND DEPTHS PRIOR TO EXCAVATING. CONTRACTOR SHALL BE RESPONSIBLE FOR PROTECTING AND SUPPORTING ALL UTILITIES DURING CONSTRUCTION OPERATIONS. CONTRACTOR SHALL CONTACT THE JOINT UTILITY LOCATING INFORMATION FOR EXCAVATORS (JULIE) AT 1-800-892-0123 FOR LOCATING THE VARIOUS UTILITIES DURING CONSTRUCTION.
- 6. ALL BUSINESSES SHALL HAVE ACCESS AT ALL TIMES.
- 7. THE ILLINOIS NGS DATA SHEET DESIGNATION #D-284 WAS USED FOR ELEVATIONAL BENCHMARK AND STATE PLANE COORDINATE LOCATION. ELEVATION = 430.35.
- 8. PROPOSED PAVEMENT MARKINGS SHOULD MATCH LOCATIONS OF EXISTING MARKINGS.
- 9. FOR NON-EMERGENCY CONTACT INFORMATION FOR THE VILLAGE OF SAUGET POLICE CALL 1-618-332-6500, AND FOR SAUGET FIRE DEPARTMENT CALL 1-618-332-6600 THAT MAY BE AFFECTED DURING LANE CLOSURES.

COMMITMENTS:

NONE

EMERGENCY CONTACTS:

MR. MIKE WILLIAMS PUBLIC WORKS DIRECTOR 618-337-4683 (WORK) 618-779-0449 (MOBILE CHIEF JAMES JONES CHIEF OF POLICE 618-332-6500 (WORK) CHIEF ROGER THORNTON FIRE CHIEF 618-332-6700 (WORK) ILLINOIS-AMERICAN WATER CO 100 N WATER WORKS DR BELLEVILLE, IL 62223 (618) 236-1180

AMEREN ILLINOIS (GAS) 1050 WEST BOULEVARD P.O. BOX 428 BELLEVILLE, IL 62222-0428 (618) 236-4301

AT&T (COMMUNICATIONS) 1420 FRONTAGE RD O'FALLON, IL 63369 (618) 624-4004

EXPLORER PIPELINE 1355 ROBBINS RD HARTFORD, IL 62048 (618) 251-0262 (918) 493-5100 (COMPANY)



CALL "JULIE" TO HAVE LOCATIONS MARKED IN THE FIELD AND "IDOT" FOR UNDERGROUND LOCATES WITHIN THE RIGHT-OF-WAY. SUBSCRIBING UTILITES REQUIRE 48 HOURS NOTICE PRIOR TO CONSTRUCTION. BEFORE YOU DIG

FILE NAME =	USER NAME = cro	DESIGNED - MJS	REVISED -		QUEENY AVE. & FALLING SPRINGS INTERSECTION IMPROVEMENTS	RTE	SECTION	COUNTY TOTAL SHEET
T:\Clients\SAUGET\7313-17-1 CMAQ Grant A 7313-17-1 FINAL COVER SHEET.dwg	pp — Queeny & Falling Springs Signalization\CIVI	LOORAWNI - CRO	REVISED -	STATE OF ILLINOIS	GENERAL NOTES / UTLITIES	9225 1	17-00013-01-PV	ST. CLAIR 30 2
7515-17-1 FINAL COVER SHEET.dwg	PLOT SCALE = 1"=20'	CHECKED - TPW	REVISED -	DEPARTMENT OF TRANSPORTATION				CONTRACT NO. 97819
	PLOT DATE = May 10, 2024 - 9:33AM	DATE - 5-10-2024	REVISED -		SCALE: SHEET NO. 1 OF 1 SHEETS STA. TO STA.		ILLINOIS	

UTILITY INFORMATION

AMEREN UE (ELECTRIC) 500 EAST BROADWAY EAST ST. LOUIS, IL 62201 (618) 482–2213 VILLAGE OF CAHOKIA (SANITARY) 2525 MOUSETTE LN. SAUGET, IL 62206 (618) 337–3302 CHARTER COMMUNICATIONS

SPECTRUM (BURIED FIBER) 13545 BARRETT PKWY. BALLWIN, MO 63021 (314) 858–3536

AMERICAN BOTTOMS KELLY SMITH 1 AMERICAN BOTTOMS RD SAUGET, IL 62201 (618) 337-1710

INNDUSTRIAL GAS PRODUCTS, INC 2300 FALLING SPRINGS ROAD SAUGET, IL 62201 (618) 337-1030



3110090	SUBBASE GR	RANULAR MATERIAL, TYPE A 10"			SQ YD	1,613	
3110090	SUBBASE GR	RANULAR MATERIAL, TYPE A 10"			SQ YD	1,613	
3550131	6 HOT-MIX ASP	HALT BASE COURSE, 8"			SQ YD	1,613	
4060027	5 BITUMINOUS	MATERIALS (PRIME COAT)			POUND	403	
4060029	BITUMINOUS	MATERIALS (TACK COAT)			POUND	93	
		R CRACKS, JOINTS, AND FLANGEWAYS	2		TON	0.5	
40604064	4 HOT-MIX ASP	'HALT SURFACE COURSE, IL-9.5, MIX "E	л", N90		TON	181	
40800050	INCIDENTAL I	HOT-MIX ASPHALT SURFACING			TON	5	
42400100	PORTLAND C	EMENT CONCRETE SIDEWALK 4 INCH			SQ FT	1190	
4240080		WARNINGS			SQ FT	16	
4400010	PAVEMENT F	REMOVAL			SQ YD	2	
4400050		N CURB AND GUTTER REMOVAL			FOOT	266	
4400060	SIDEWALK R	EMOVAL			SQ FT	1,423	
		JLDER REMOVAL					
					SQ YD	1,063	
4820302	9 HOT-MIX ASP	'HALT SHOULDERS, 8"			SQ YD	1,094	
6025550	MANHOLES 1	TO BE ADJUSTED			EACH	1	
6060500		N CONCRETE CURB AND GUTTER, TYP	E B-6.24		FOOT	251	
6300000	1 STEEL BEAM	I GUARDRAIL, TYPE A, 6 FOOT POSTS			FOOT	104	
6310004	1 TRAFFIC BAF	RRIER TERMINAL, TYPE 1B			EACH	4	
6710010		N			LSUM	1	
7010702	5 CHANGEABI	E MESSAGE SIGN			CAL DA	40	
				-			
		1 PAVEMENT MARKING			FOOT	1,757	
70300150	SHORT TERM	1 PAVEMENT MARKING REMOVAL			SQ FT	389	
7200010	SIGN PANEL	- TYPE 1			SQ FT	72	
ME =		USER NAME = cro pp — Queeny & Falling Sprirgs Signalization\CIVIL	DESIGNED - CRO		REVISED -	·	s


	CODE NO.	ITEM
*	72400100	REMOVE SIGN PANEL ASSEMBLY - TYPE A
*	72400500	RELOCATE SIGN PANEL ASSEMBLY - TYPE A
*	72400710	RELOCATE SIGN PANEL - TYPE 1
*		NETAL DOOT, THE A
Ŧ	72900100	METAL POST - TYPE A
*	79001100	PAINT PAVEMENT MARKING- LETTERS AND SYMBOLS
	78001100	PAINT PAVEMENT MARKING- LETTERS AND STMBOLS
*	78001110	PAINT PAVEMENT MARKING LINE 4"
*	78001140	PAINT PAVEMENT MARKING LINE 8"
*	78001150	PAINT PAVEMENT MARKING LINE 12"
	70001130	
*	78001180	PAINT PAVEMENT MARKING LINE 24"
*	78200005	GUARDRAIL REFLECTORS, TYPE A
	X0327771	SAW CUTS AND SEAL NEW JOINTS
	7.0021111	
	X7010216	TRAFFIC CONTROL & PROTECTION, (SPECIAL)
	20013798	
	XX009536	GAS MARKER POST REMOVAL


* SPECIALTY ITEMS

STATE OF ILLINOIS PARTMENT OF TRANSPORTATION

	CONSTRUCTIO	N CODE
	CMAQ FUN	IDS
	UNIT	TOTAL
	EACH	12
	EACH	14
	SQ FT	65
	FOOT	11
S	SQ FT	94
.0	SQ FI	94
	FOOT	3,513
	FOOT	1,477
	FOOT	73
	1001	
	FOOT	69
	EACH	10
	FOOT	1,501
	1001	1,001
	L SUM	1
	L SUM	1
	EACH	2


IN	ITERSECT	ION IMPROVEMENTS	RTE.	SECTION	COUNTY	TOTAL SHEETS	SHEET NO.
U/	ANTITIES		9225	17-00013-01-PV	st. Clair	30	3
				-	CONTRACT	NO. 97	819
	STA.	TO STA.		ILLINOIS			

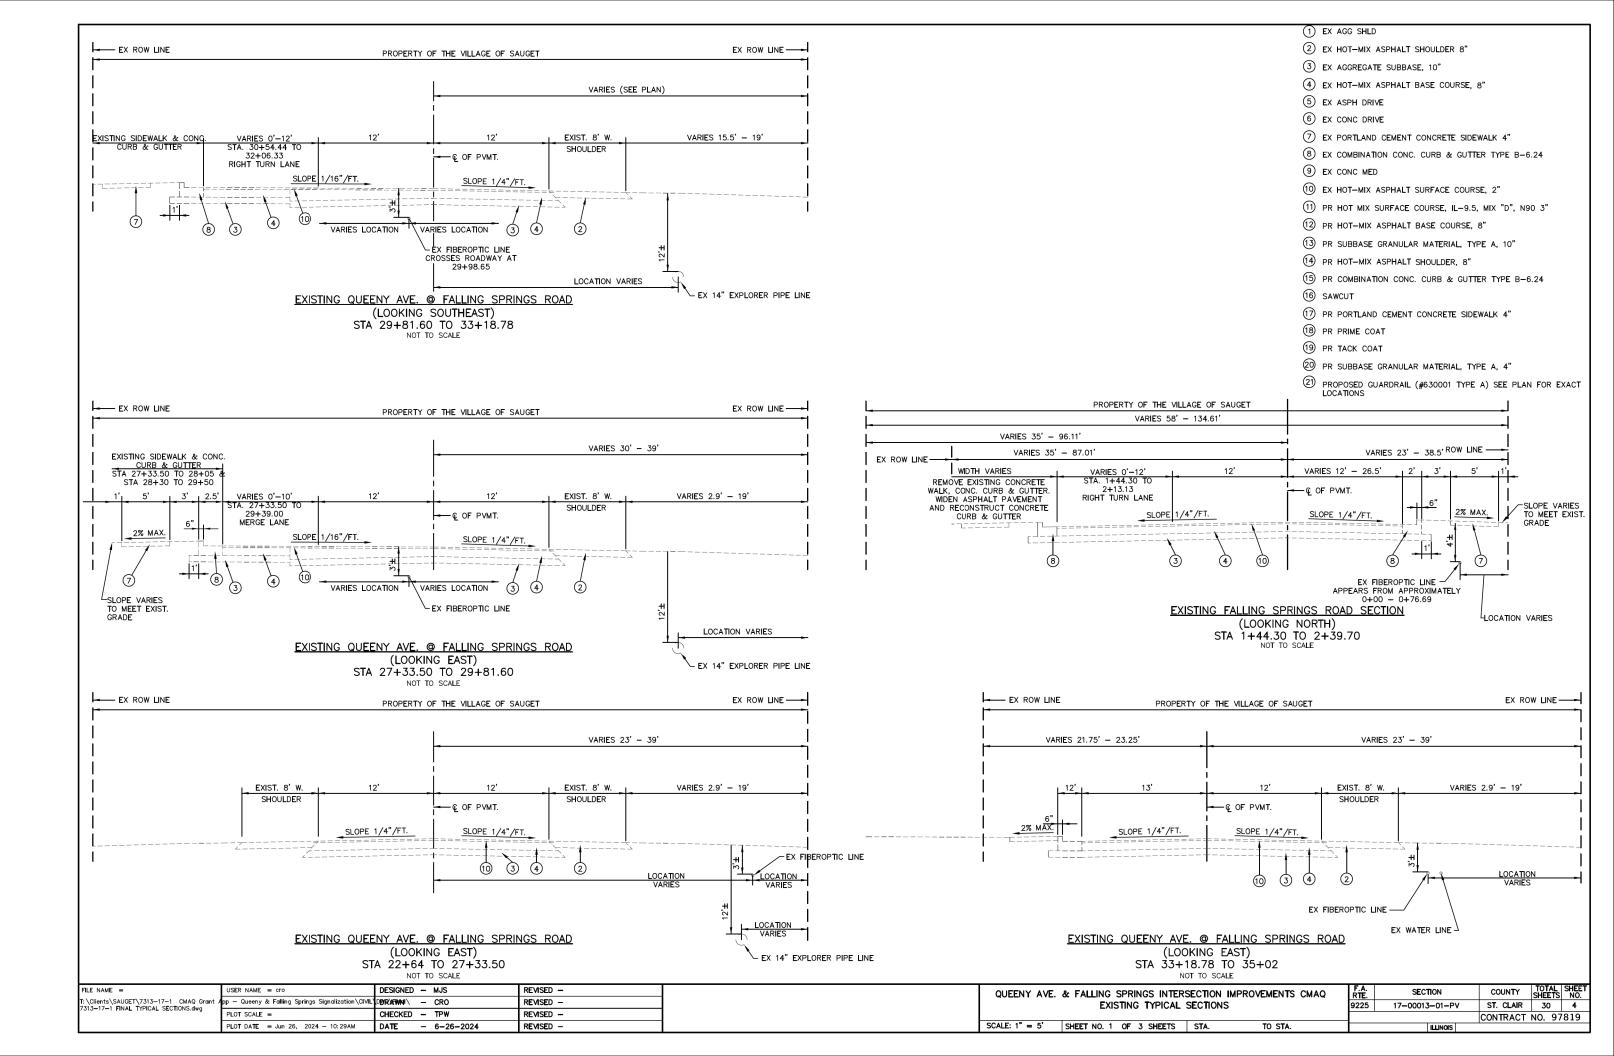

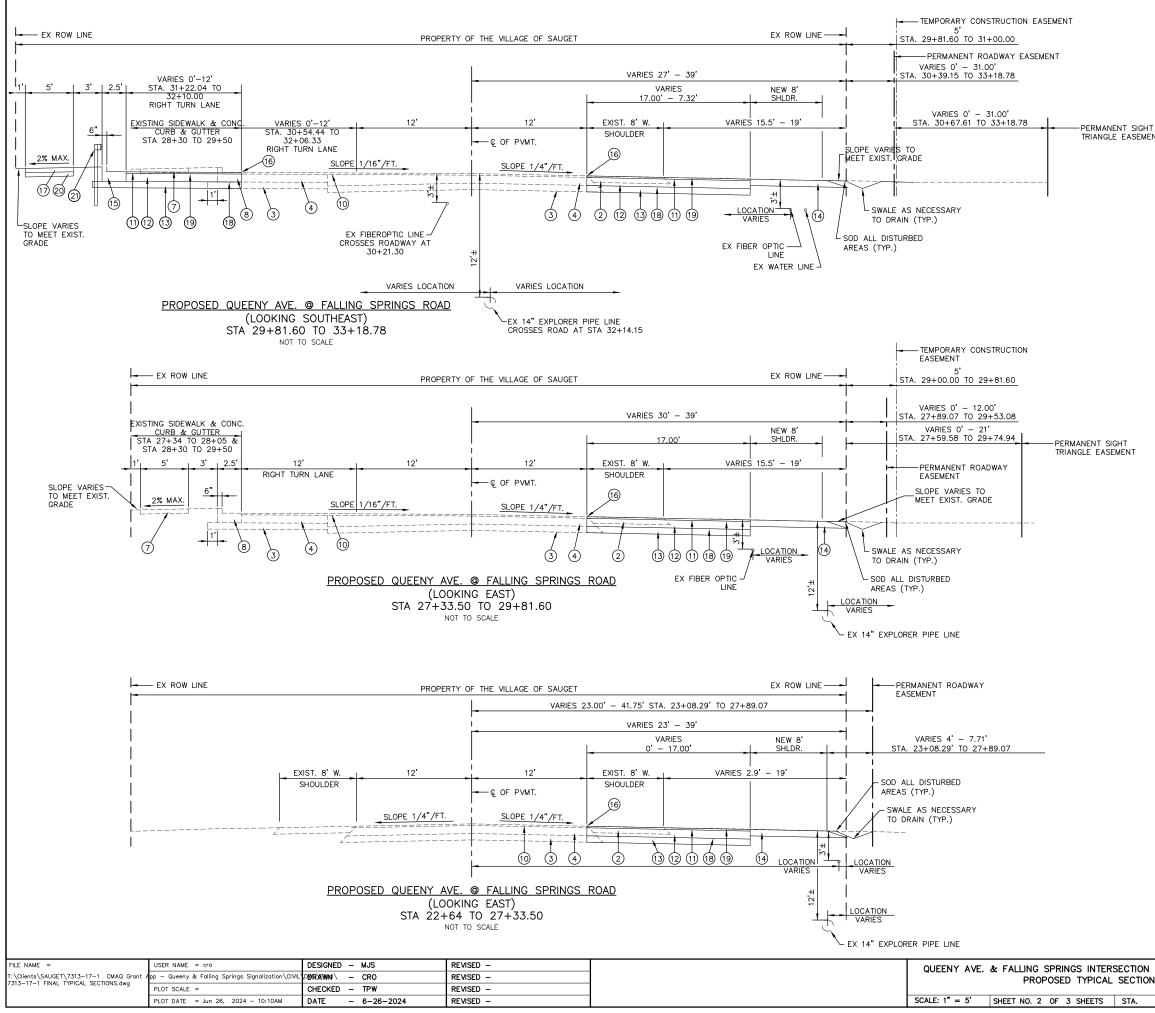

- (1) EX AGG SHLD
- (2) EX HOT-MIX ASPHALT SHOULDER 8"
- (3) EX AGGREGATE SUBBASE, 10"
- (4) EX HOT-MIX ASPHALT BASE COURSE, 8"
- 5 EX ASPH DRIVE
- (6) EX CONC DRIVE
- TRIANGLE EASEMENT
- (7) EX PORTLAND CEMENT CONCRETE SIDEWALK 4"
- (8) EX COMBINATION CONC. CURB & GUTTER TYPE B-6.24
- (9) EX CONC MED
- (10) EX HOT-MIX ASPHALT SURFACE COURSE, 2"
- (1) PR HOT MIX SURFACE COURSE, IL-9.5, MIX "D", N90 3"
- (12) PR HOT-MIX ASPHALT BASE COURSE, 8"
- $(\overline{13})$ pr subbase granular material, type A, 10"
- (14) PR HOT-MIX ASPHALT SHOULDER, 8"
- (15) PR COMBINATION CONC. CURB & GUTTER TYPE B-6.24
- (16) SAWCUT
- (7) PR PORTLAND CEMENT CONCRETE SIDEWALK 4"
- (18) PR PRIME COAT
- (19) PR TACK COAT
- 20 PR SUBBASE GRANULAR MATERIAL, TYPE A, 4"
- (2) PROPOSED GUARDRAIL (#630001 TYPE A) SEE PLAN FOR EXACT LOCATIONS

RS	SECTION IMPROVI	EMENTS CMAQ	F.A. RTE.	SECT	TION	С	OUNTY	TOTAL SHEETS	SHEET NO.
L	SECTIONS		9225	17-00013	3–01–PV	ST	. CLAIR	30	5
_						CON	ITRACT	NO. 97	819
	STA.	TO STA.			ILLINOIS				

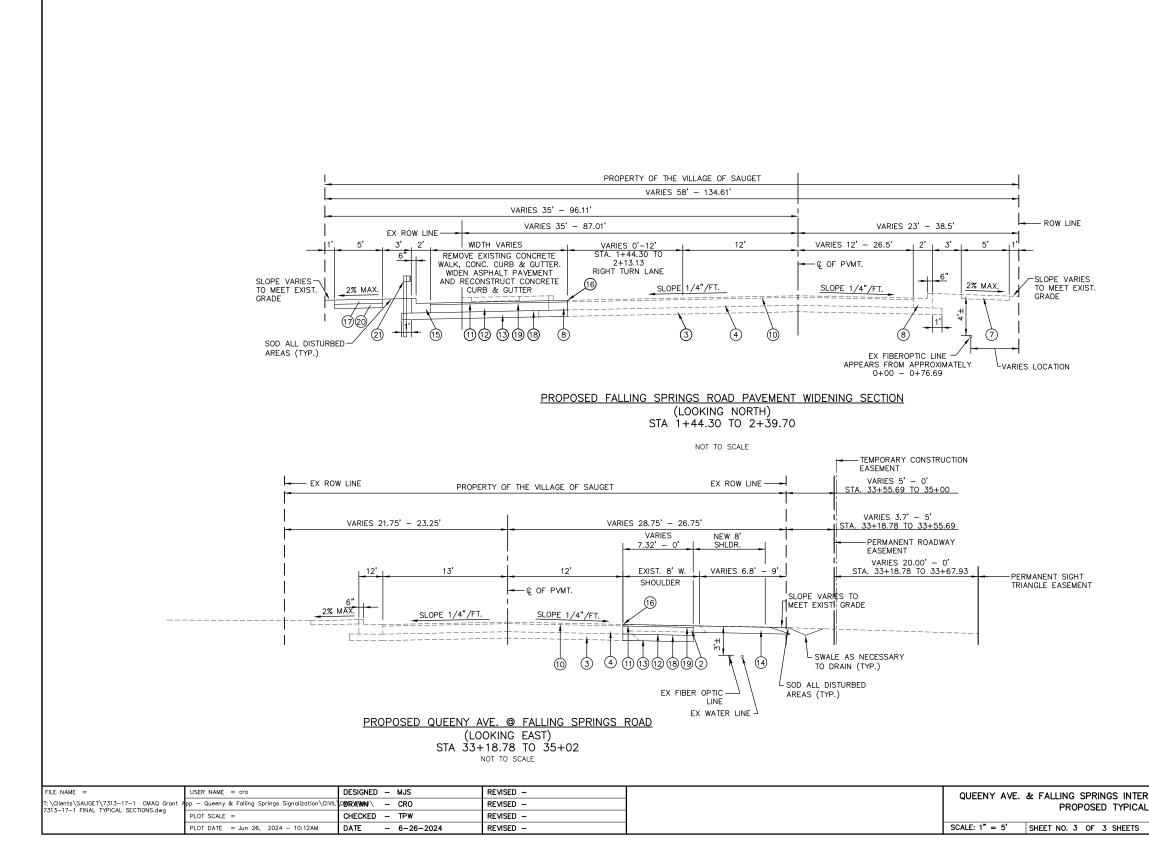

- 1) EX AGG SHLD
- 2 EX HOT-MIX ASPHALT SHOULDER 8"
- (3) EX AGGREGATE SUBBASE, 10"
- (4) EX HOT-MIX ASPHALT BASE COURSE, 8"
- 5 EX ASPH DRIVE
- 6 EX CONC DRIVE
- 7 EX PORTLAND CEMENT CONCRETE SIDEWALK 4"
- 8 EX COMBINATION CONC. CURB & GUTTER TYPE B-6.24
- 9 EX CONC MED
- (1) EX HOT-MIX ASPHALT SURFACE COURSE, 2"
- (1) PR HOT MIX SURFACE COURSE, IL-9.5, MIX "D", N90 3"
- 12 PR HOT-MIX ASPHALT BASE COURSE, 8"
- (13) PR SUBBASE GRANULAR MATERIAL, TYPE A, 10"
- (14) PR HOT-MIX ASPHALT SHOULDER, 8"
- (15) PR COMBINATION CONC. CURB & GUTTER TYPE B-6.24
- 16 SAWCUT
- 17 PR PORTLAND CEMENT CONCRETE SIDEWALK 4"
- (18) PR PRIME COAT
- (19) PR TACK COAT
- 20 PR SUBBASE GRANULAR MATERIAL, TYPE A, 4"
- PROPOSED GUARDRAIL (#630001 TYPE A) SEE PLAN FOR EXACT LOCATIONS

R	SECTION IMPR	OVEMENTS	CMAQ	F.A. RTE.	SECT	TION		COUNT	Y	TOTAL SHEETS	SHEET NO.
L	SECTIONS			9225	17-00013	5-01-PV	'	ST. CLA	٨IR	30	6
								CONTRA	СТ	NO. 97	819
	STA.	TO STA.				ILLINOIS					

					PAVE	MENT SCHE	DULE									
STATION	STATION	SUBBASE GRANULAR MATERIAL, TYPE A 4"	SUBBASE GRANULAR MATERIAL, TYPE A 10"	HOT-MIX ASPHALT BASE COURSE, 8"	BITUMINOUS MATERIALS (PRIME COAT)	BITUMINOUS MATERIALS (TACK COAT)	HOT-MIX ASPHALT SURFACE COURSE, IL-9.5, MIX "D", N90	HOT-MIX ASPHALT SHOULDERS, 8"	MIXTURE FOR CRACKS, JOINTS, AND FLANGEWAYS	PAVED SHOULDER REMOVAL	PAVEMENT REMOVAL	SAW CUTS AND SEAL NEW JOINTS	COMBINATION CURB AND GUTTER REMOVAL	COMBINATION CONCRETE CURB AND GUTTER, TYPE B-6.24	CEMENT CONCRETE	DETECTABLI WARNINGS
		SQ YD	SQ YD	SQ YD	POUND	POUND	TON	SQ YD	TON	SQ YD	SQ YD	FOOT	FOOT	FOOT	SQ FT	SQ FT
					(QUEENY AVE										
22+64.00	27+50.00	0.00	504.64	504.64	126.16	25.23	56.77	422.90	0.17	427.43		490.20				
27+50.00	33+00.00	83.69	958.16	958.16	239.54	47.91	107.79	469.40	0.17	465.24		687.92	152.29	146.18	753.20	8.00
33+00.00	35+02.00	0.00	89.47	89.47	22.37	4.47	10.07	202.04	0.17	170.38		209.05				
SUB TOTAL		83.69	1552.27	1552.27	388.07	77.61	174.63	1094.34	0.50	1063.05	0.00	1387.17	152.29	146.18	753.20	8.00
					FALLI	NG SPRINGS	ROAD									
0+50.00	3+00.00	48.51	60.62	60.62	15.15	15.15	6.82				1.93	114.00	113.31	104.40	436.62	8.00
SUB TOTAL		48.51	60.62	60.62	15.15	15.15	6.82	0.00	0.00	0.00	1.93	114.00	113.31	104.40	436.62	8.00
TOTAL	-	133	1613	1613	403	93	181	1094	0.50	1063	2	1501	266	251	1190	16
based on 135 l	. CU FTcompacted															
					05 1 00/0057	051 00/0057										
				112 LB/ SQ YD/ IN	.25 LBS/SQFT	.05 LBS/SQFT										

			PAVEM	ENT MARKING	GS SCHEDU	LE		
		PAINT PAVEMENT MARKING LINE 4"		PAINT PAVEMENT MARKING LINE 4"	PAINT PAVEMENT MARKING LINE 8"	PAINT PAVEMENT MARKING LINE 12"	PAINT PAVEMENT MARKING LINE 24"	PAINT PAVEMENT MARKING- LETTERS AND SYMBOLS
		WHITE (EDGE LINE)	WHITE (LANE LINE)	DOUBLE YELLOW (CENTERLINE)	WHITE (CHEVRONS)	WHITE (CROSSWALKS)	WHITE (STOP BARS)	WHITE (LEFT TURN ARROW SYMBOLS)
STATION	STATION	FOOT	FOOT	FOOT	FOOT	FOOT	FOOT	SQ FT
				QUEENY A	VE.			
22+64.00	27+50.00	478		915	734			
27+50.00	33+00.00	511	108	897	640.22	9.23	55	62.4
33+00.00	35+02.00	201		403	103			
SUB TOTAL		1 1 90	108	2215	1477	9	55	62
				ALLING SPRING	SS ROAD			
+50.00	3+00.00					64	14	31.2
SUB TOTAL		0	0	0	0	64	14	31
тот	TAL	1190	108	2215	1477	73	69	94
τοτ	AL 4"		3513					

			QUIREMENTS		
BINDER CSE	BASE CSE	SURFACE	SURFACING	SHOULDERS < 2.25"	SHOULDERS ≥ 2.25"
PG 64-22	PG 64-22				
0	0	0	0	0	0
4.0% @ Ndes=90	4.0% @ Ndes=90	4.0% @ Ndes=90	4.0% @ Ndes=90	4.0% @ Ndes=30	4.0% @ Ndes=30
IL 19.0	IL 19.0	IL 9.5	IL 9.5	IL 9.5L	IL 19.0L
MIXTURE "B"	MIXTURE "B"	MIXTURE "D"	MIXTURE "D"		

STATION	ТО	STATION	SIDE	STEEL BEAM GUARDRAIL, TYPE A, 6 FOOT POSTS	TRAFFIC BARRIER TERMINAL, TYPE 1B	GUARDRAIL REFLECTORS, TYPE A					
				FOOT	EACH	EACH					
	QUEEN	Y AVE.									
31+48.00		32+16.00	LT.	75	2	6					
	FALLING SPR	RINGS ROA	D								
1+88.40		2+13.88	RT.	29	2	4					
TOTAL				104	4	10					

	EROS	SION SCH	EDULE	
STATION	STATION	TEMPORARY DITCH CHECKS	PERIMETER EROSION BARRIER	INLET AND PIPE PROTECTION
		FOOT	FOOT	EACH
		QUEENY AV	/E.	
22+64.00	27+50.00	5	430	
27+50.00	33+00.00	5	622	
33+00.00	35+02.00	5	520	2
SUB TOTAL		15	1572	2
	FALLI	NG SPRING	S ROAD	
21+60.00	27+50.00		48	2
SUB TOTAL			48	2
TOTAL		15	1621	4

R NAME = cro	DESIGNED - CRO	REVISED -		OUFENY A	VE. & FALLING SPRINGS INT
Queeny & Falling Springs Signalization\CIVIL	DØRAWNI – CRO	REVISED -	STATE OF ILLINOIS	QUELITY /	SCHEDULE OF QUA
T SCALE = NTS	CHECKED - MJS	REVISED -	DEPARTMENT OF TRANSPORTATION		
T DATE = Jun 26, 2024 - 10:51AM	DATE - 6-26-2024	REVISED -		SCALE: NTS	SHEET NO. 1 OF 2 SHEETS

0.25 17

TEMPORARY SEEDING PROVIDED AS 100 LB/ACRES, AREA BASED UPON 2 X ACRES FOR SEEDING CLASS 2A, QUANTITY IS TO BE INSTALLED AT THE

SEEDING SCHEDULE

NITROGEN

POUND

QUEENY AVE.

8.41

FALLING SPRINGS ROAD

0.75

PHOSPHORU POTASSIUM

POUND

4.40

8.41

3.02

0.75

0.75

17

FERTILIZER NUTRIENT NUTRIENT NUTRIENT

POUND

8.41

15.83 15.83 15.83

0.75

4.40 4.40

3.02 3.02

0.75 0.75

17 17

MULCH, METHOD 3

ACRE

0.04

0.08

0.03

0.16

0.01

0.01

0.25

TEMPORARY

EROSION

SEEDING

POUND

8.41

3.02

15.83

0.75

0.75

4.40

SEEDING.

CLASS 2A

ACRE

0.04

0.16

0.08

0.03

0.01

0.01

STATION

SUB TOTAL

SUB TOTAL

TOTAL

STATION

22+64.0027+50.0027+50.0033+00.00

33+00.00 35+02.00

21+60.00 27+50.00

			CUT	FILL	
STATION	то	STATION	EARTH EXCAVATION	FURNISHED EXCAVATION (FILL)	EARTH EMBANKMENT (FILL) ADJUSTED FOF SHRINKAGE/ COMPACATION
			CU YD	CU YD	CU YD
		QUE	ENY AVE.		
22+64.00		27+50.00	328.4	5.0	5.9
27+50.00		33+00.00	639.8	0.2	0.3
33+00.00		35+02.00	24.5	0.3	0.3
SUB TOTAL			992.78	5.48	6.52
		FALLING	SPRINGS RO	AD	
+50.00		3+00.00	59.3	11	12.8
SUB TOTAL			59.33	10.73	12.77
		TOTAL	1052	16	19

FILE NAME =	USER NAME = cro	DESIGNED - CRO	REVISED -	
T:\Clients\SAUGET\7313—17—1 CMAQ Grant A 7313—17—1 SUMMARY OF QUANTITIES.dwg	pp — Queeny & Falling Springs Signalization\CIVIL	Didraiwn - Cro	REVISED -	STATE OF ILLINOI
7515-17-1 SOMMART OF GOANTHES.dwg	PLOT SCALE = NTS	CHECKED - MJS	REVISED -	DEPARTMENT OF TRANSPO
	PLOT DATE = Jun 26, 2024 - 10:51AM	DATE - 6-26-2024	REVISED -	


E S	SIDEWALK REMOVAL
	SQ FT
	799.04
	799.04
	623.75
	623.75
	1423


	UTILITY ADJUSTMENT												
			MANHOLES	GAS MARKER									
STATION	OFFSET		TO BE	POST									
			ADJUSTED	REMOVAL									
			EACH	EACH									
	QUE	EN	Y AVE.										
24+97.50	30.00' RT.			1									
31+69.75	22.50' RT.			1									
34+97.60	15.19' RT		1										
TOTAL			1	2									


IN	TERSECT	ION IMPROVEMENTS	RTE.	SECTION	COUNTY	TOTAL SHEETS	SHEET NO.
QU	ANTITIES		9225	17-00013-01-PV	ST. CLAIR	30	7
					CONTRACT	NO. 97	819
S	STA.	TO STA.		ILLINOIS	•		


						SIGN PANEL										
				TRAF	FIC CON	TROL DEVIC	ES SCHE	DULE								
STATION	OFFSET (FT)	STOP SIGN (R1-1) REMOVE, STORE, AND REUSE	Interstate 255 (3 DIGITS) (M1-1) REMOVE, STORE, AND REUSE	TO (M4-5) REMOVE, STORE, AND REUSE	TO DOWNTOWN AIRPORT SIGN (D1-1) (REMOVE, STORE, AND REUSE)	VILLAGE HALL DIRECTIONAL SIGN (D1-1) (REMOVE, STORE, AND REUSE)	DIRECTIONAL ARROW SIGN (M6-1) REMOVE, STORE, AND REUSE	AIRPORT AHEAD (1-5)	ST. LOUIS DOWNTOWN AIRPORT SIGN REMOVE, STORE, AND REUSE	GCS BALLPARK ARROW (SIGN) ROMOVE, STORE & REUSE	RIGHT CURVE ARROW (W1-2R) REMOVE, STORE & REUSE	LEFT CURVE ARROW (W1-2L)	BUS STOP SIGN (R7-107a) REMOVE, STORE & REUSE)	ROAD WORK AHEAD (W20-I)	END OF ROAD WORK (G20-2)	SIDEWA CLOSE (R9-9)
	SQ FT	9.0	5.00	2.00	12.00	4.00	2.00	4.00	6.00	2.00	4.00	4.00	2.50	9.00	4.50	3.50
								QUEEN	VYAVE.							
21+64	LT./RT.													1	1	
25+88	21.81' RT.										1					
26+07	26.44' RT.								L	1						+
26+95 28+22	26.40' RT. 26.60' RT.		1	1			1	1	1							
28+22	26.60' RT. 31.20' RT.		1	1	1	1	1									
30+03	38.00' RT.				1	1				1						
30+70	40.00' RT.							1	1							
31+00	32.5' LT.														1	1
31+09	40.00' RT.												1			
32+22	39.16' LT.	1														
32+45	77' LT.															1
32+60	85' LT.													1		
34+50 36+00	16.25' LT. LT./RT.											1		1	1	
36+00	SUB-TOTAL	1	1	1	1	1	1	2	2	2	1	1	1	3	2	2
	30B-TOTAL					1			PRINGS RD.	2	1		1	3	2	2
1+00	24' LT.						<u>г</u> /			1					1	1
2+33	32.78' LT.															,
2+50	73' RT.													1		
3+00	24' LT.															1
3+50	24' LT.													1		1
	SUB-TOTAL	0	0	0	0	0	0	0	0	0	0	0	0	2	0	2
			-		-	-	-		-		-		_	-		
	SIGNS (NEW) SIGNS (REUSE)	0	0	0	0	0	0	0	0	0	0	1	0	5	2	4
	L NEW (SQ FT)	1	1	1	1	1	1	2	2	2	1	0 4	1	45	9	14
	REUSE (SQ FT)	9	5	2	12	4	2	8	12	4	4	4 0	3	45 0	0	0
	GNS (NEW)	12														
	SNS (REUSE)	12														
	(1.200.2)															
	REMOVESIGN				12	EACH										
R	ELOCA TE SIGN				14	EACH										
	REL	OCATE SIGN P	ANEL - TYPE 1		65	SQ FT										
		SIGN P	ANEL - TYPE 1		72	SQ FT										
		METAL F	POST - TYPE A		11	FOOT										


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T:\Clients\SAUGET\7313-17-1 CMAQ Grant A	pp — Queeny & Falling Springs Signalization\CIVIL	DØRAWNI – CRO	REVISED -	STATE OF ILLINOIS	SCHEDULE OF QUANTITIES			17-00013-01-PV	ST. CLAIR	30 8
7515-17-1 Sommart of QoAlthies.owg	PLOT SCALE = NTS	CHECKED - MJS	REVISED -	DEPARTMENT OF TRANSPORTATION					CONTRACT	NO. 97819
	PLOT DATE = May 10, 2024 - 10:19AM	DATE - 5-10-2024	REVISED -		SCALE: NTS	SHEET NO. 2 OF 2 SHEETS STA. TO STA.		ILLINOIS	1	

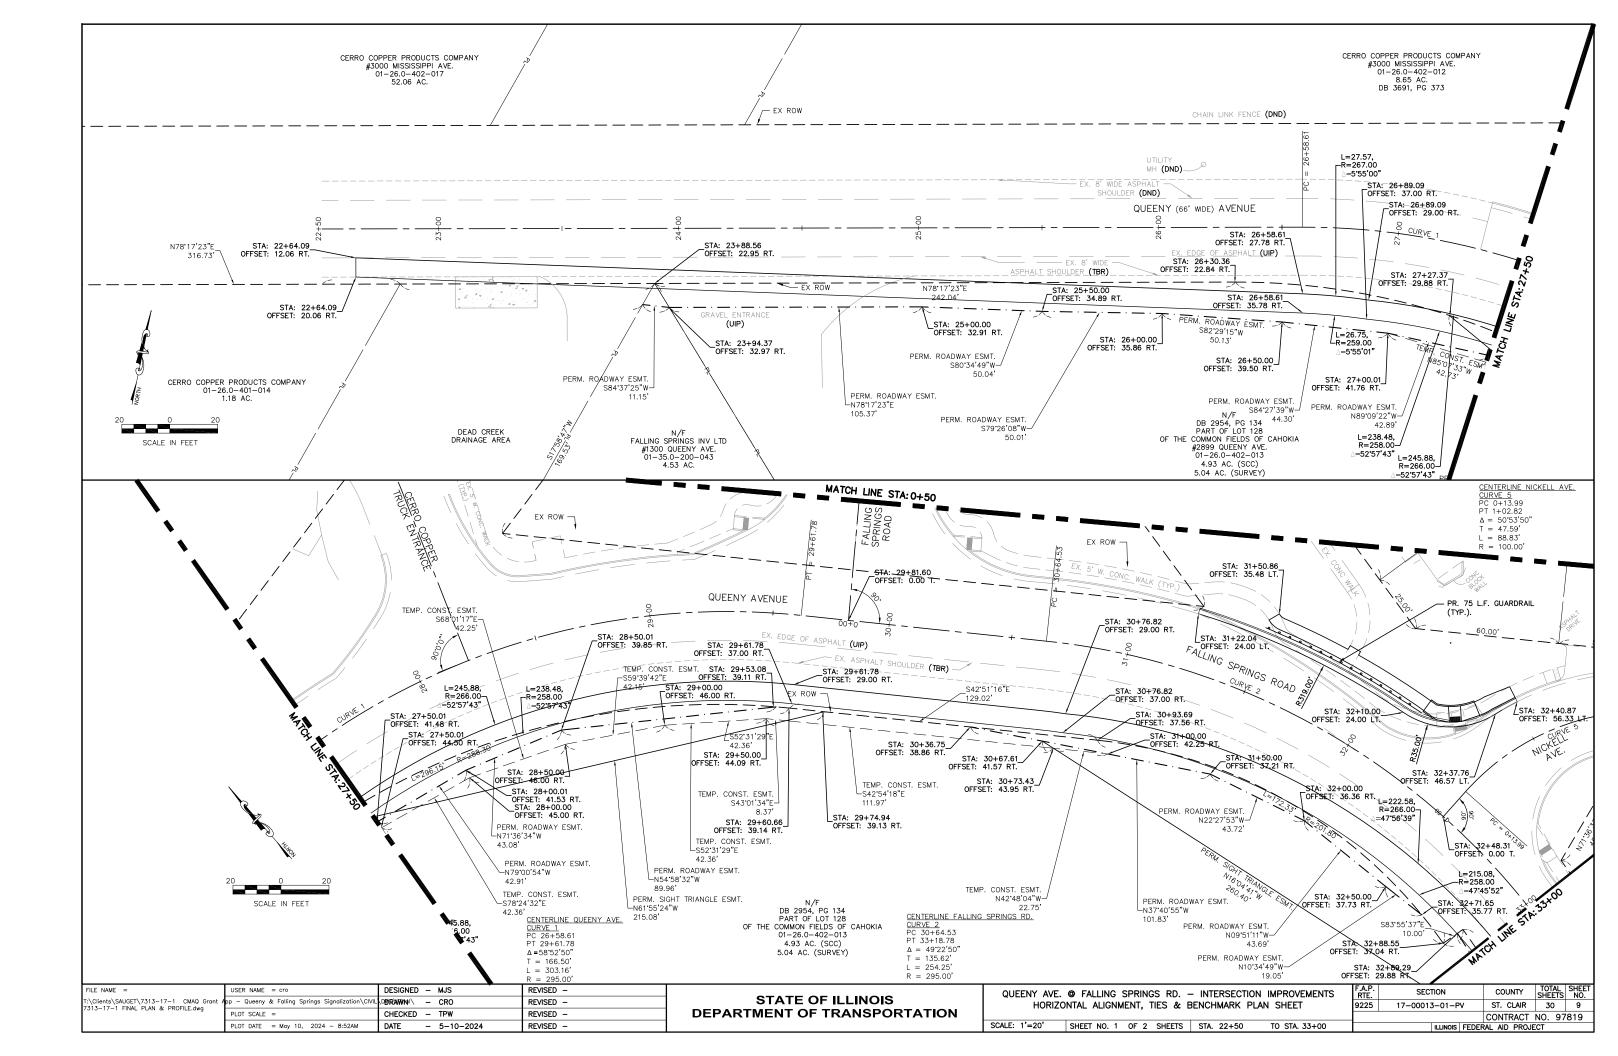


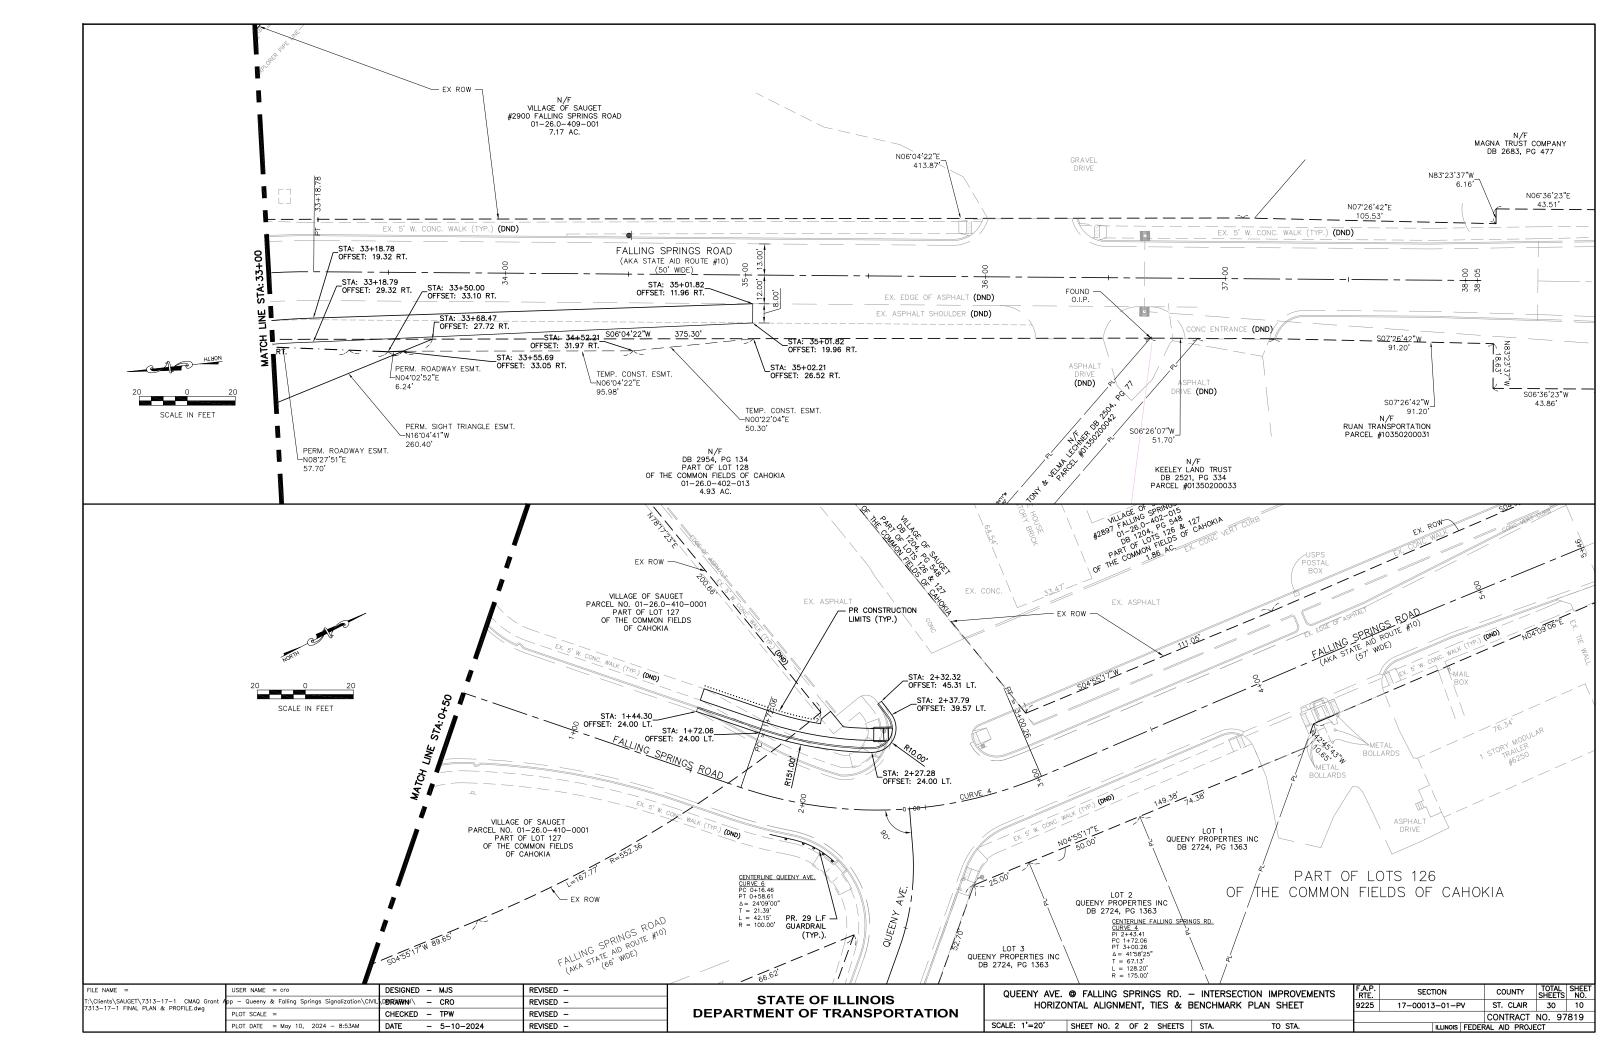

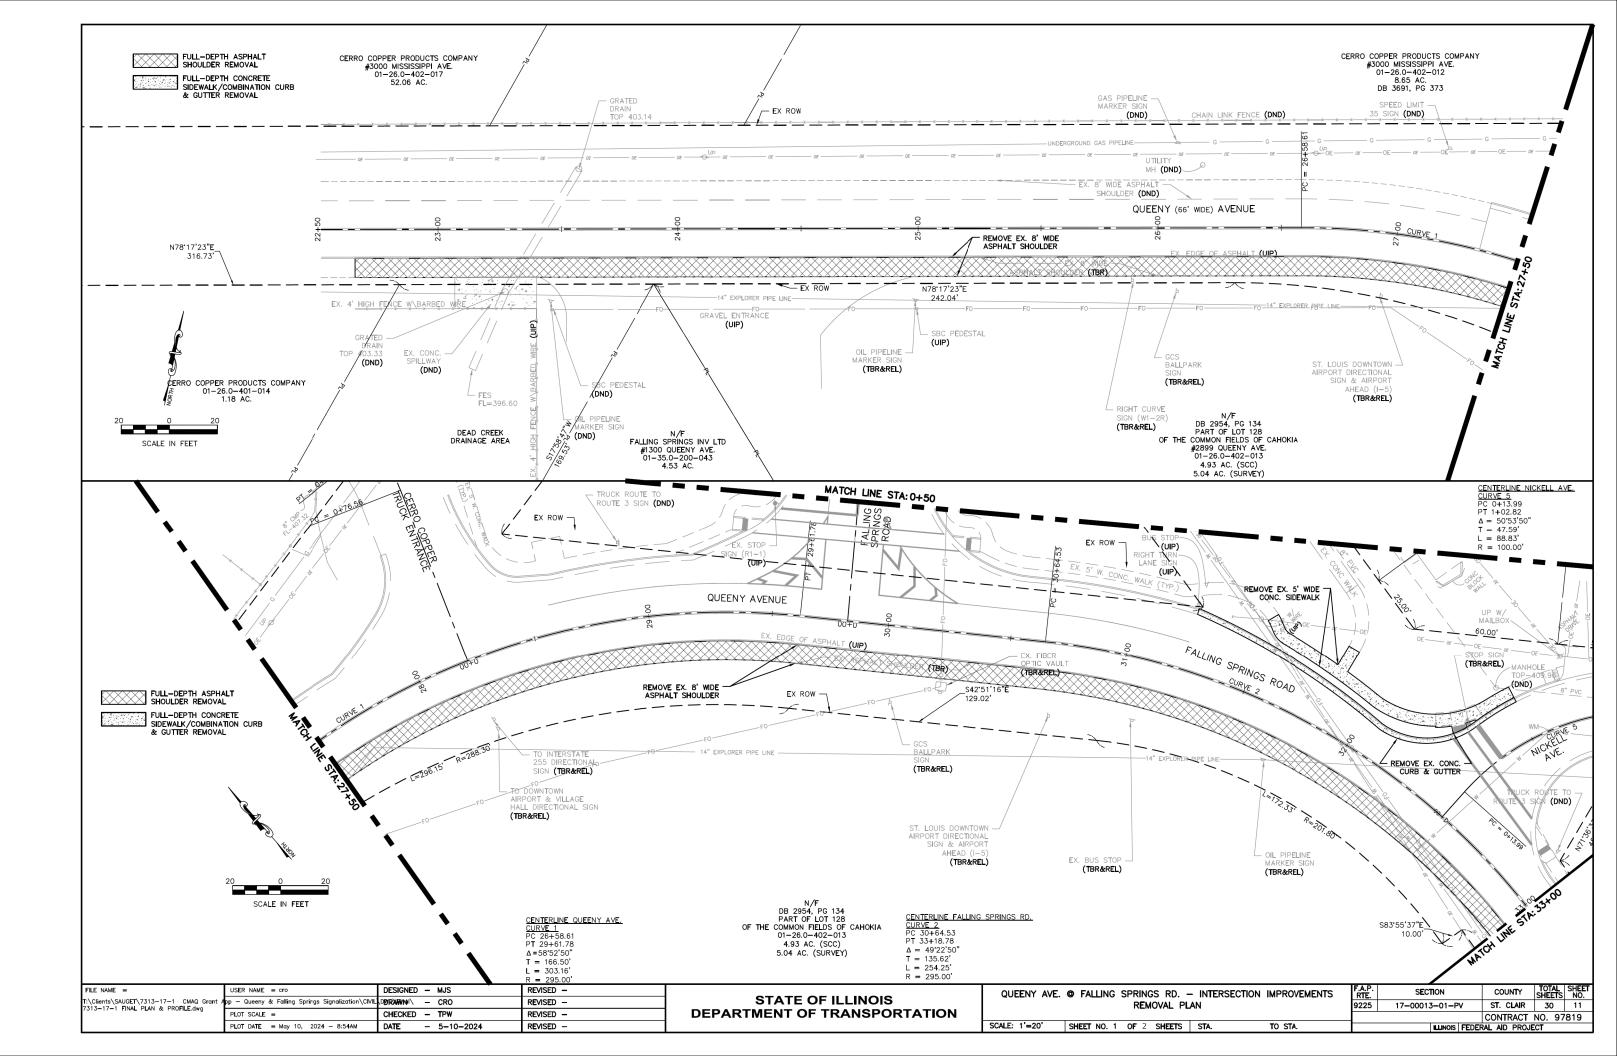


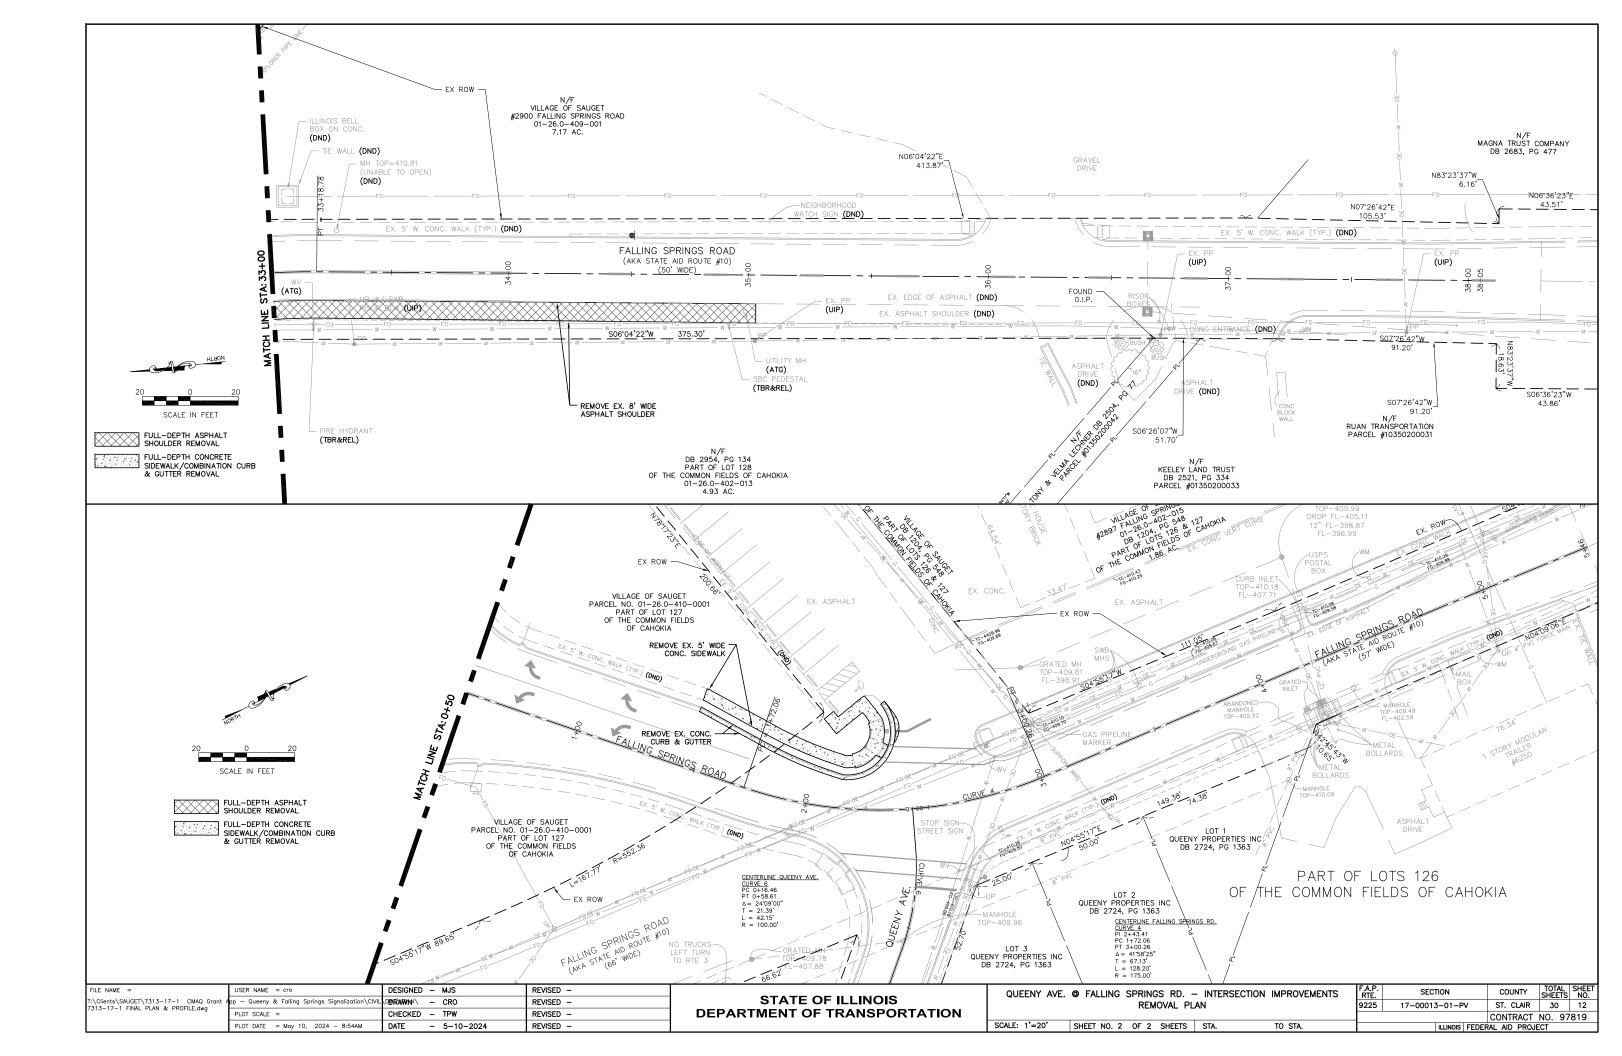

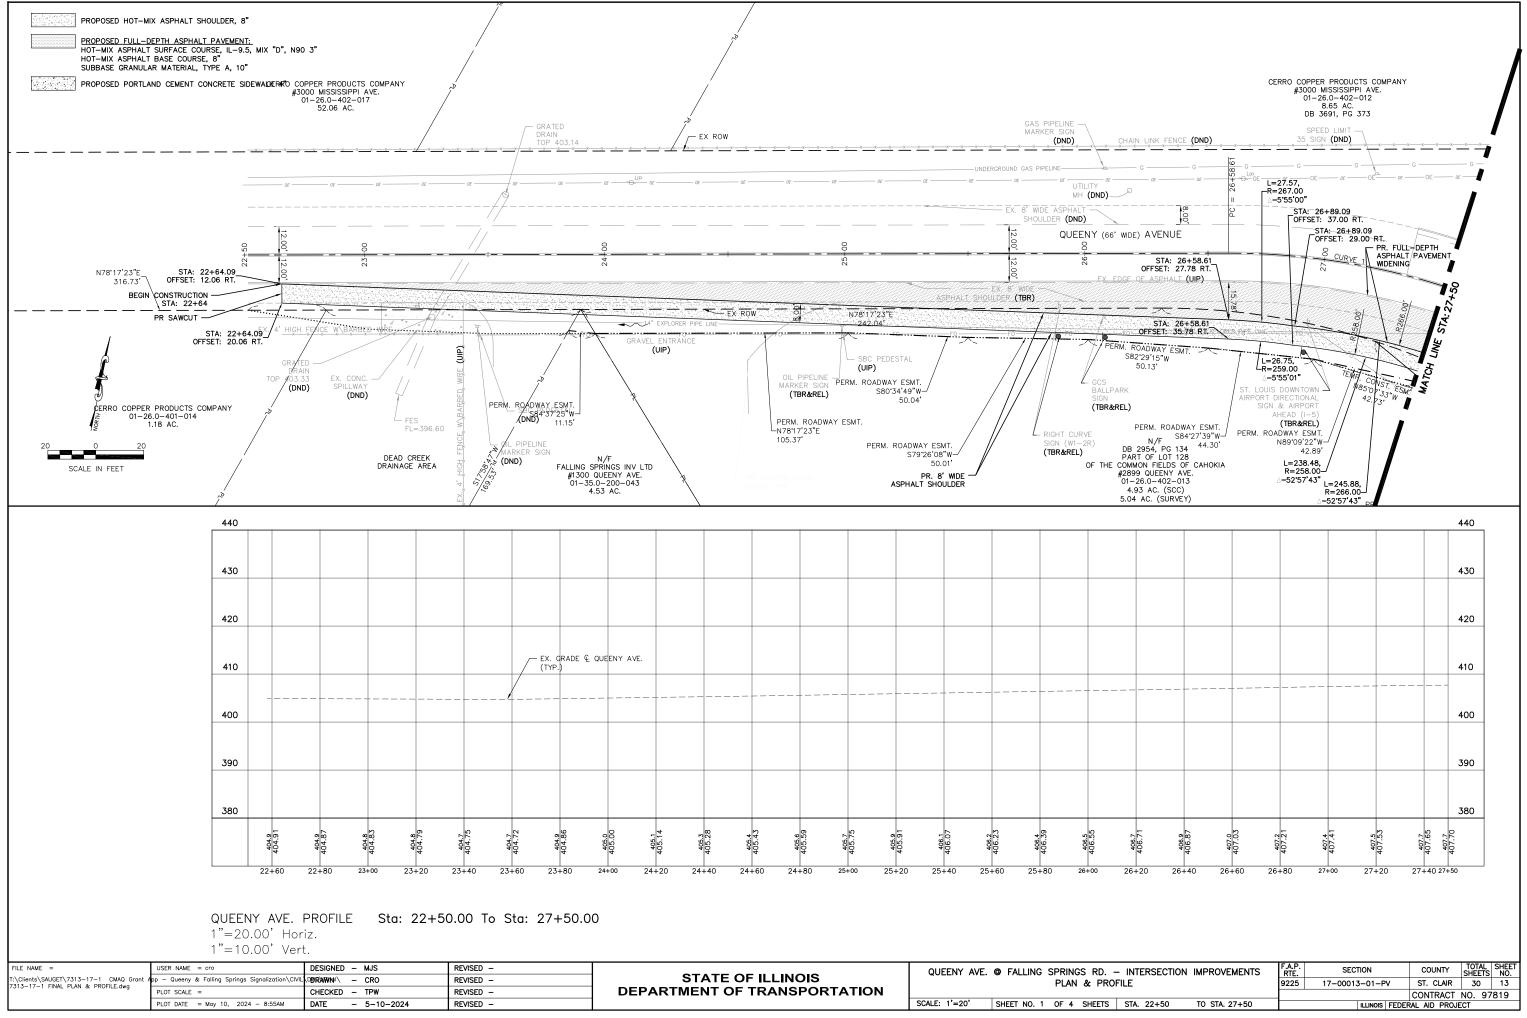


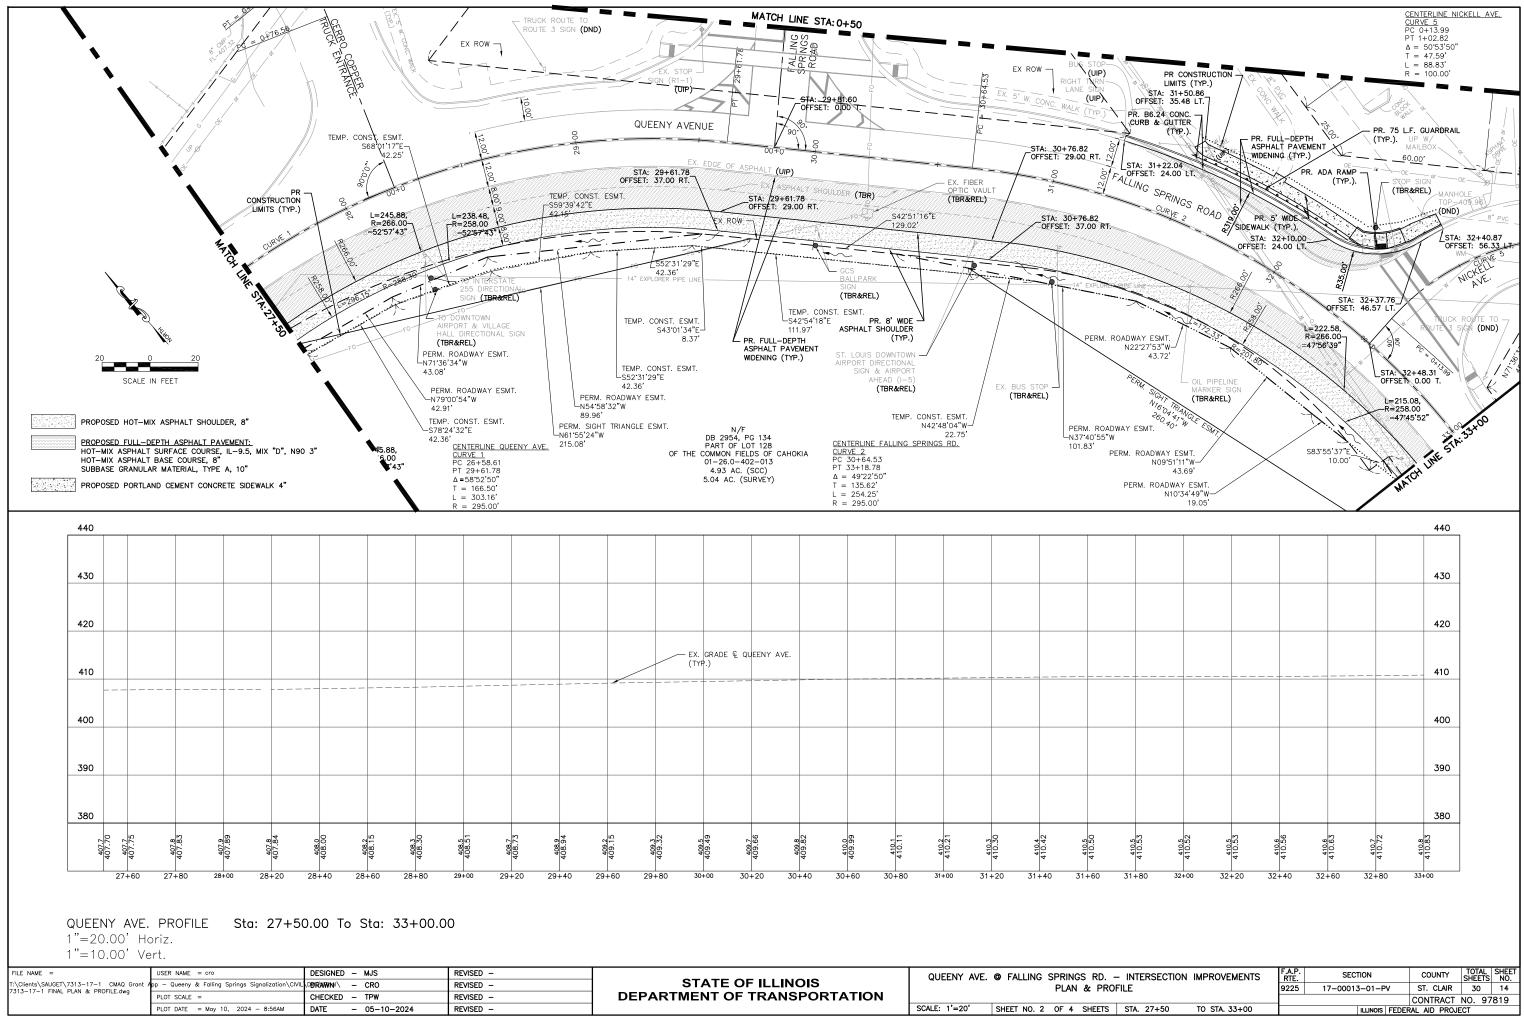


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T:\Clients\SAUGET\7313-17-1 CMAQ Grant A 7313-17-1 FINAL PLAN & PROFILE.dwg	pp — Queeny & Falling Springs Signalization\CIVIL	DØRAWINI – CRO	REVISED -	STATE OF ILLINOIS	PLAN & PROFI
7313-17-1 FINAL PLAN & PROFILE.dwg	PLOT SCALE =	CHECKED - TPW	REVISED -	DEPARTMENT OF TRANSPORTATION	
	PLOT DATE = May 10, 2024 - 8:56AM	DATE - 05-10-2024	REVISED -		SCALE: 1'=20' SHEET NO. 2 OF 4 SHEETS

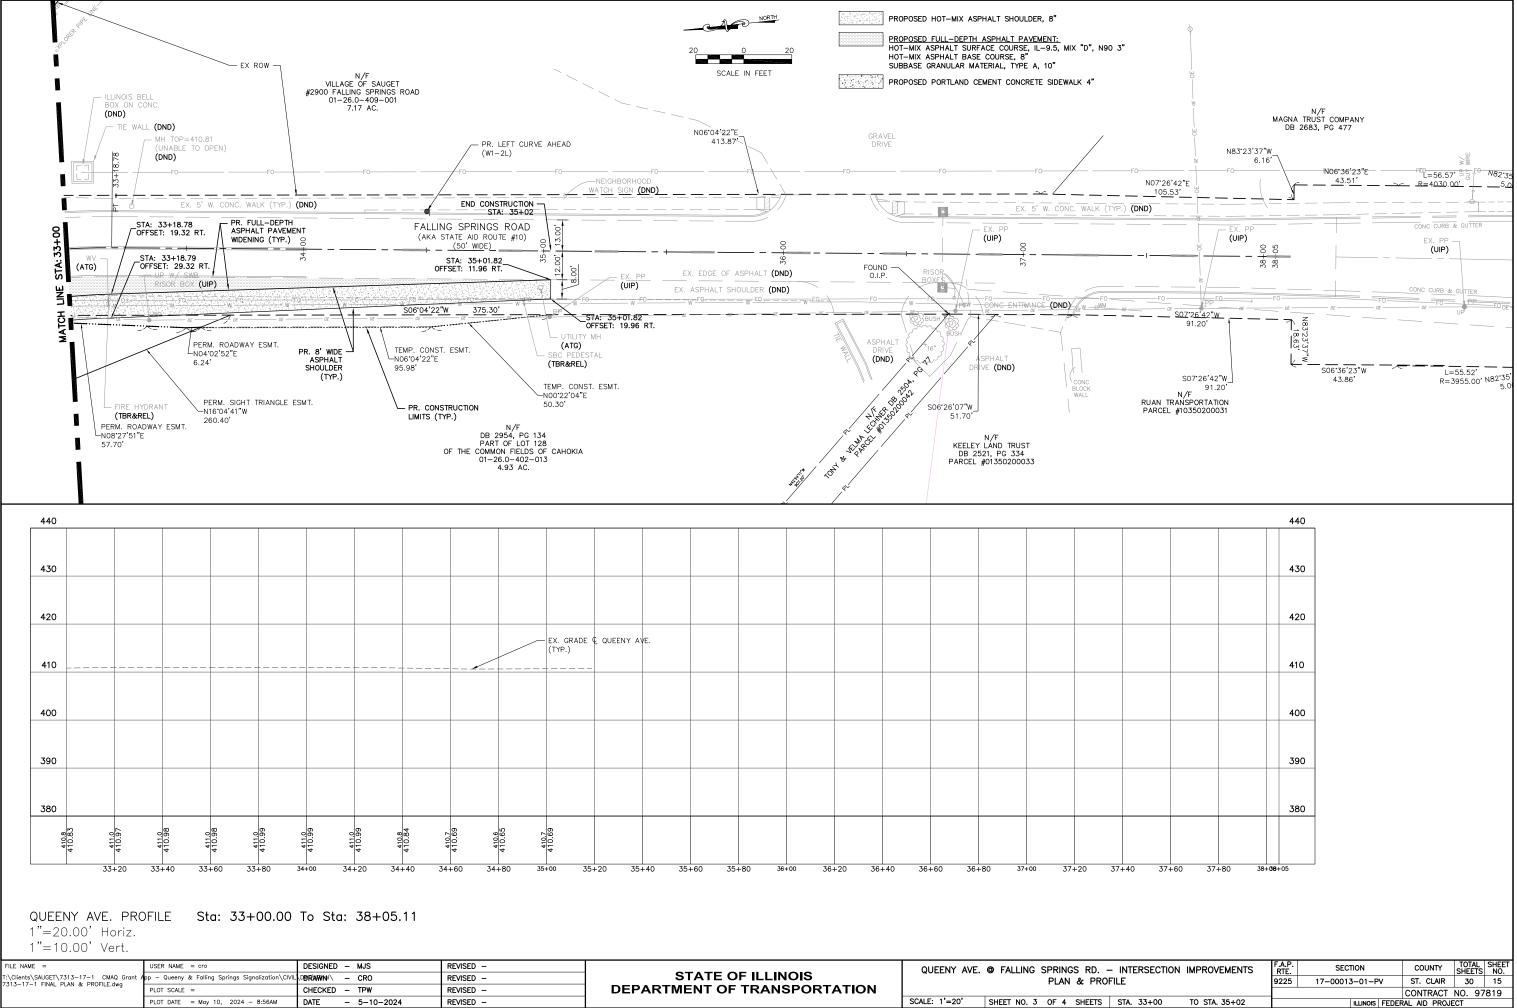


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7313-17-1 FINAL PLAN & PROFILE.dwg	PLOT SCALE =	CHECKED - TPW	REVISED -	DEPARTMENT OF TRANSPORTATION		
	PLOT DATE = May 10, 2024 - 8:56AM	DATE - 5-10-2024	REVISED -		SCALE: 1'=20'	SHEET NO. 3 OF 4 SHEETS

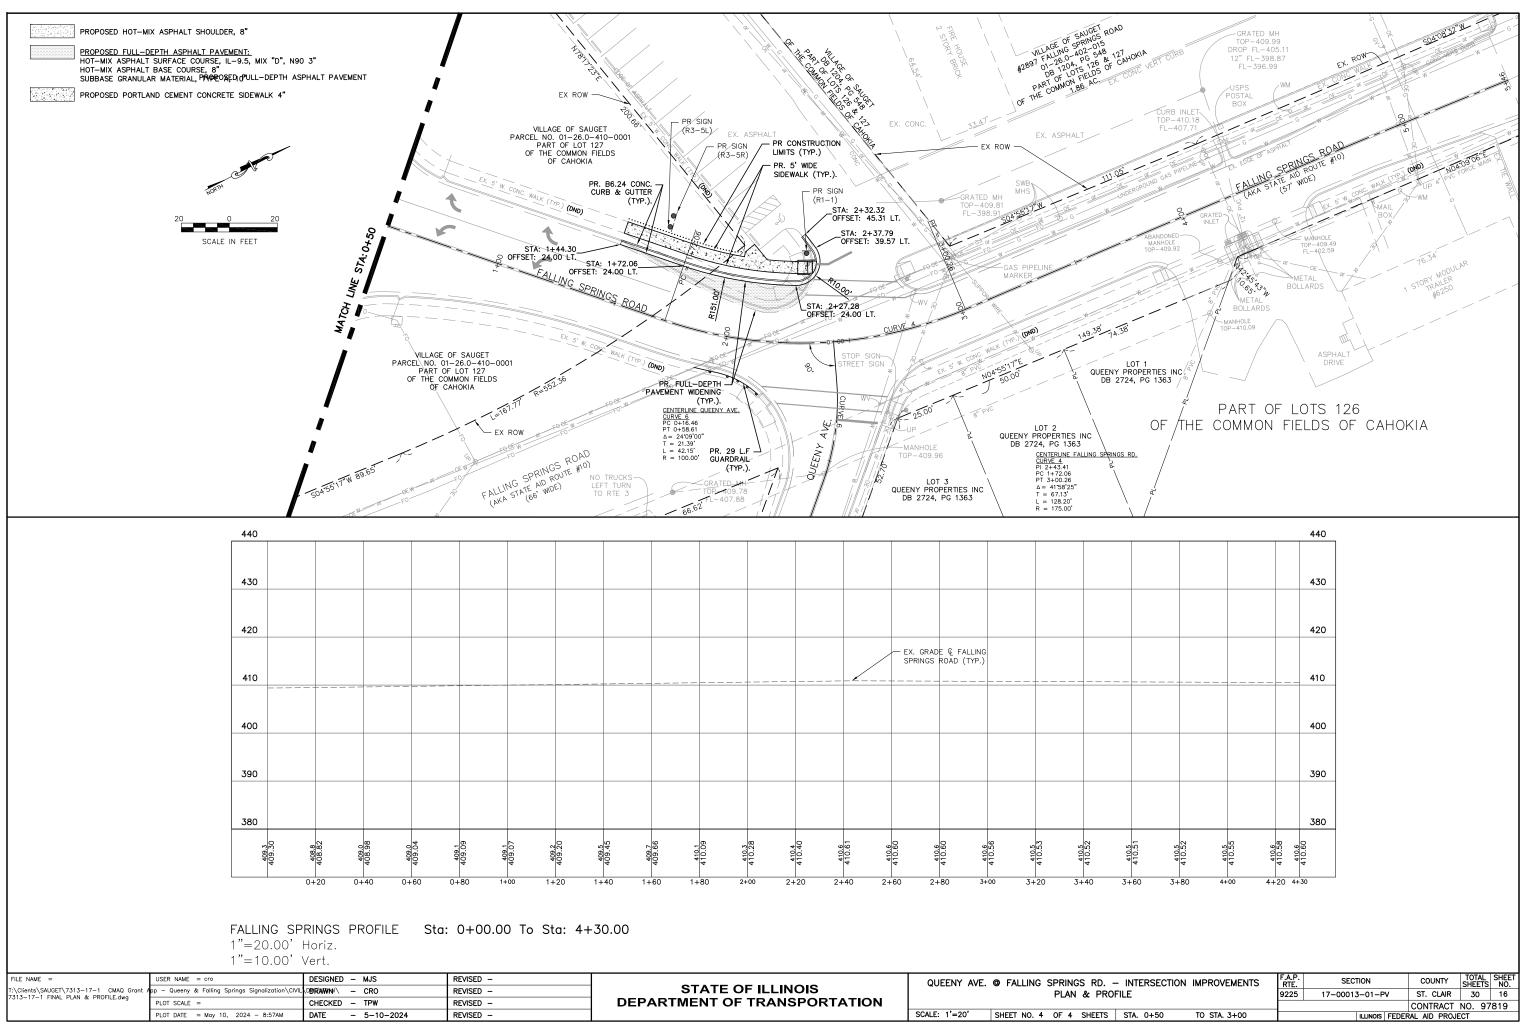

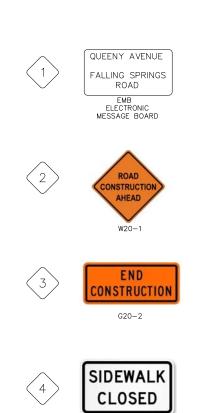

R9-9

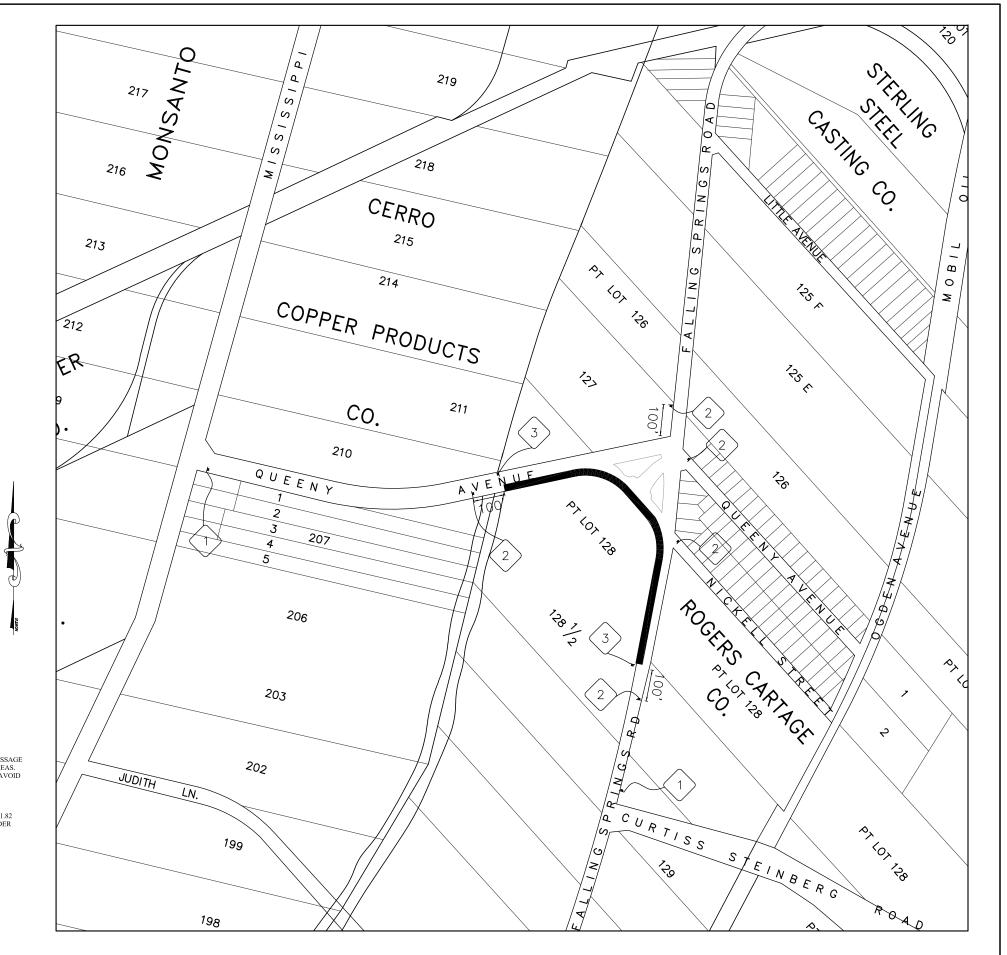

PHASE 1


INSTALL WARNING SIGNS FOR CONSTRUCTION, CHANGEABLE MESSAGE BOARDS AND CHANNELIZERS IN ADVANCE OF CONSTRUCTION AREAS. INSTALL EROSION CONTROL AT THE EARLIEST OPPORTUNITY TO AVOID EROSION CAUSED BY RAINFALL. UTILITY RELOCATIONS (BY OTHERS).

Ø


NORTH

QUEENY/FALLING SPRINGS AVENUE SAWCUT AND REMOVE EX. SHOULDERS FROM STA. 22+64 TO 35+01.82 CONSTRUCT PROPOSED PAVEMENT WIDENING AND NEW SHOULDER FROM 5TA. 22+64 TO 35+01.82 INSTALL TEMPORARY STRIPING.

FILE NAME =	USER NAME = cro	DESIGNED - MJS	REVISED -		QUEENY AVE.	© FALLING SPRINGS RD INTERSECTION IMPROVEMENT	F.A.P.	SECTION	COUNTY TOTAL SHE
T:\Clients\SAUGET\7313-17-1 CMAQ Grant 7313-17-1 Traffic Control.dwg	pp — Queeny & Falling Springs Signalization\CIVIL	DORAWNI - CRO	REVISED -	STATE OF ILLINOIS	QOLL	PHASE I - TRAFFIC CONTROL & STAGING	9225	17-00013-01-PV	ST. CLAIR 30 17
7515-17-1 Hane control.awg	PLOT SCALE =	CHECKED - TPW	REVISED -	DEPARTMENT OF TRANSPORTATION					CONTRACT NO. 97819
	PLOT DATE = May 10, 2024 - 9:35AM	DATE - 5-10-2024	REVISED -		SCALE: N/A	SHEET NO. 1 OF 3 SHEETS STA. TO STA.		ILLINOIS FEDE	RAL AID PROJECT

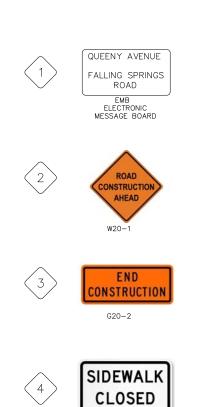

R9-9

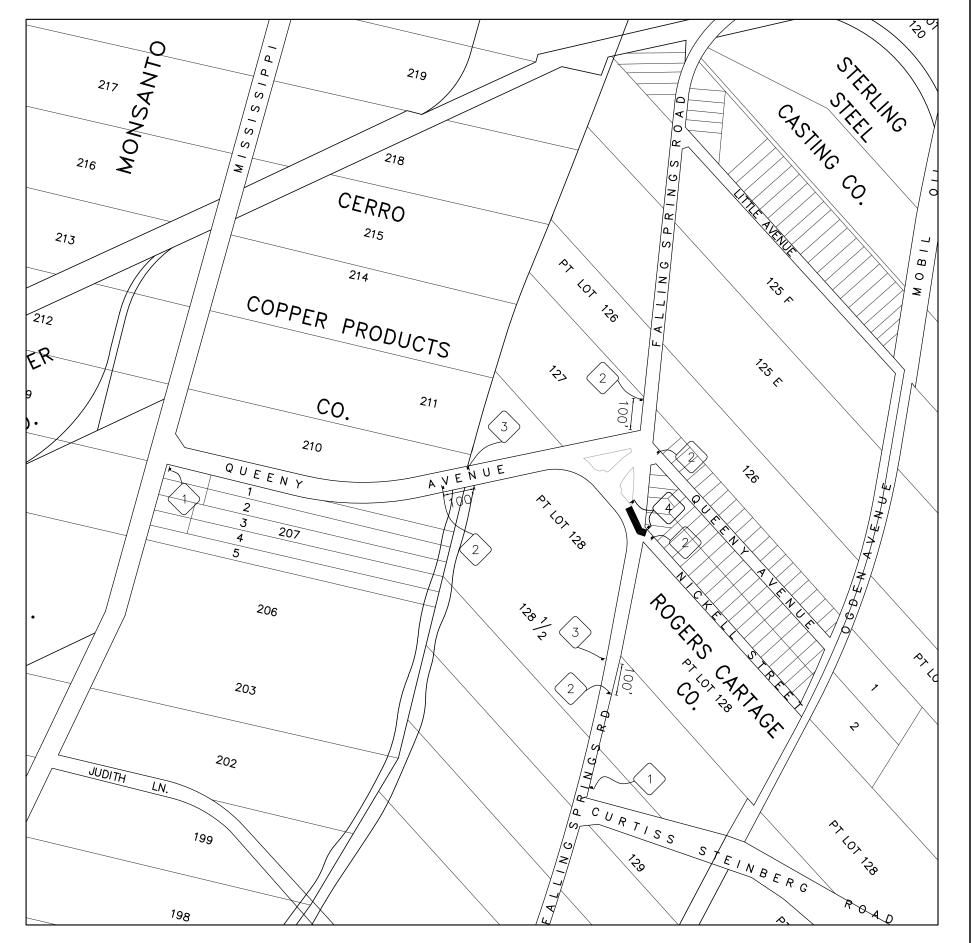

FILE NAME =	USER NAME = cro	DESIGNED - MJS	REVISED -		QUEENY AVE.	. @ FALLING SPRINGS RD INTERSECTION IMPROVEMEN	IS F.A.P.	SECTION	COUNTY TOTAL SHEET
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VSTS-TV-T Hame control.dwg	PLOT SCALE =	CHECKED - TPW	REVISED -	DEPARTMENT OF TRANSPORTATION					CONTRACT NO. 97819
	PLOT DATE = May 10, 2024 - 9:36AM	DATE - 5-10-2024	REVISED -		SCALE: N/A	SHEET NO. 2 OF 3 SHEETS STA. TO STA.		ILLINOIS FEDE	RAL AID PROJECT

PHASE 2


RELOCATE WARNING SIGNS FOR CONSTRUCTION, CHANGEABLE MESSAGE BOARDS AND CHANNELIZERS IN ADVANCE OF CONSTRUCTION AREAS. INSTALL EROSION CONTROL AT THE EARLIEST OPPORTUNITY TO AVOID EROSION CAUSED BY RAINFALL. UTILITY RELOCATIONS (BY OTHERS).

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IORTH I

FALLING SPRINGS AVENUE SAWCUT AND REMOVE EX. PAVEMENT, SIDEWALK AND CURB & GUTTER FROM STA. 31+22 TO 32+40.87. CONSTRUCT NEW PAVEMENT WIDENING, SIDEWALK, ADA RAMP AND CURB & GUTTER FROM STA. 31+22 TO 32+40.87. FINISH FINAL GRADING AND SEED AND MULCH APPLICATION TO BE

INSTALLED. INSTALL FINAL STRIPING.

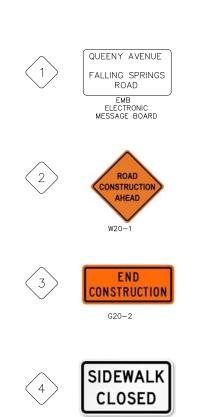


R9-9




RELOCATE WARNING SIGNS FOR CONSTRUCTION, CHANGEABLE MESSAGE BOARDS AND CHANNELIZERS IN ADVANCE OF CONSTRUCTION AREAS. INSTALL EROSION CONTROL AT THE EARLIEST OPPORTUNITY TO AVOID EROSION CAUSED BY BAINFALL. UTILITY RELOCATIONS (BY OTHERS).


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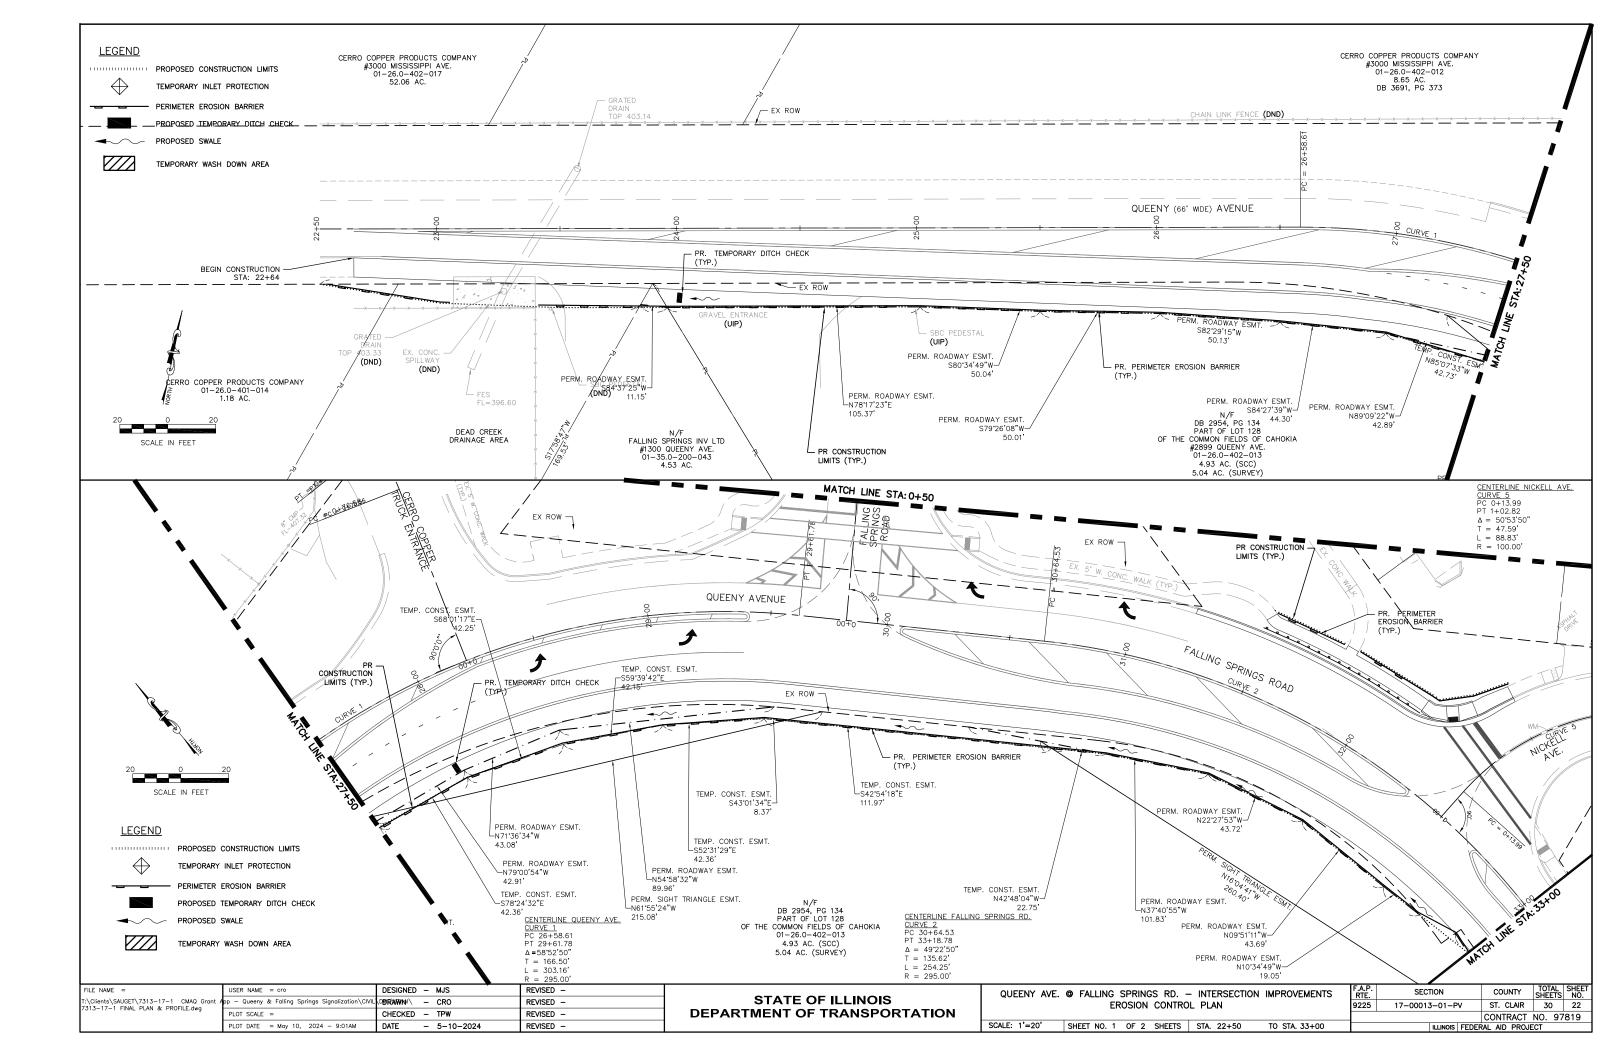
FALLING SPRINGS AVENUE SAWCUT AND REMOVE EX. PAVEMENT, SIDEWALK AND CURB & GUTTER FROM STA. 1+44,30 TO 2+40,87. CONSTRUCT NEW PAVEMENT WIDENING, SIDEWALK, ADA RAMP AND CURB & GUTTER FROM STA. 1+443,30 TO 2+40,87. FINISH FINAL GRADING AND SEED AND MULCH APPLICATION TO BE INSTALLED. INSTALL FINAL STRIPING.

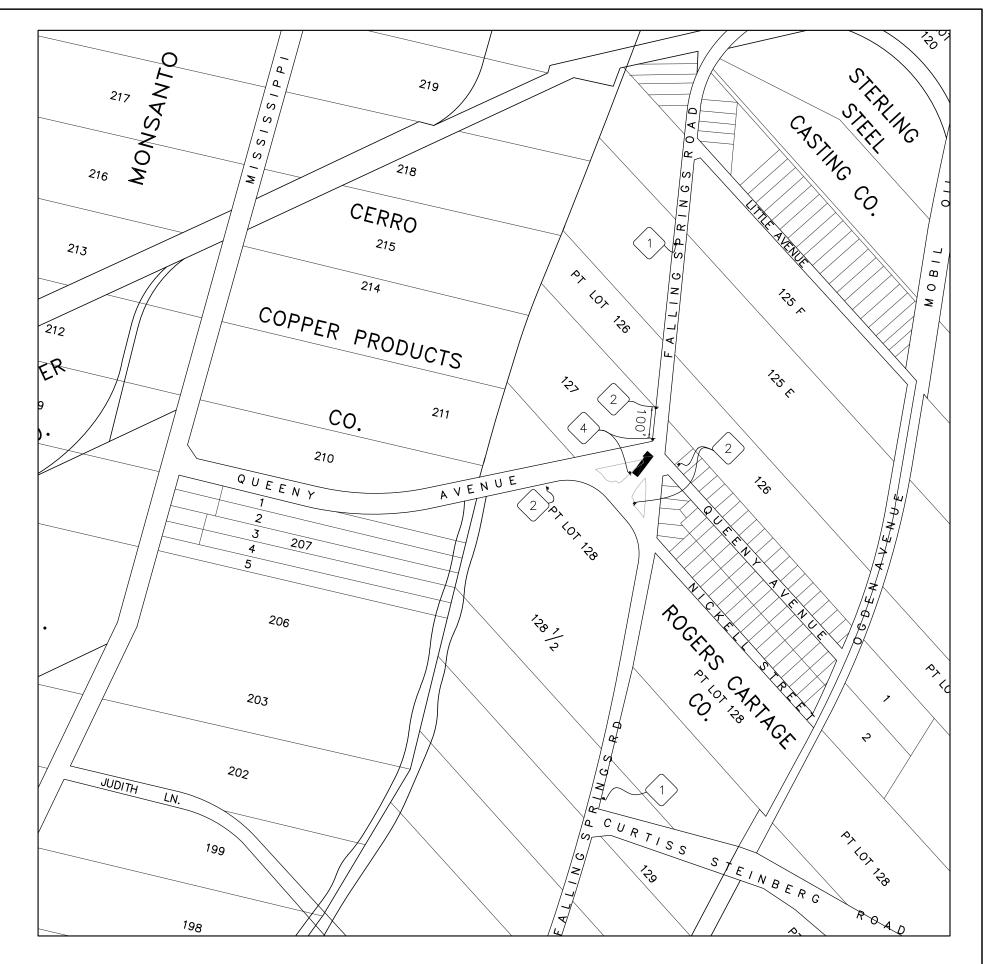



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/31	5-17-1 Hame control.awg	PLOT SCALE =	CHECKED - TPW	REVISED -	DEPARTMENT OF TRANSPORTATION					CONTRACT	NO. 97819	
		PLOT DATE = May 10, 2024 - 9:37AM	DATE - 5-10-2024	REVISED -		SCALE: N/A	SHEET NO. 3 OF 3 SHEETS	STA. TO STA.		ILLINOIS FEDEF		




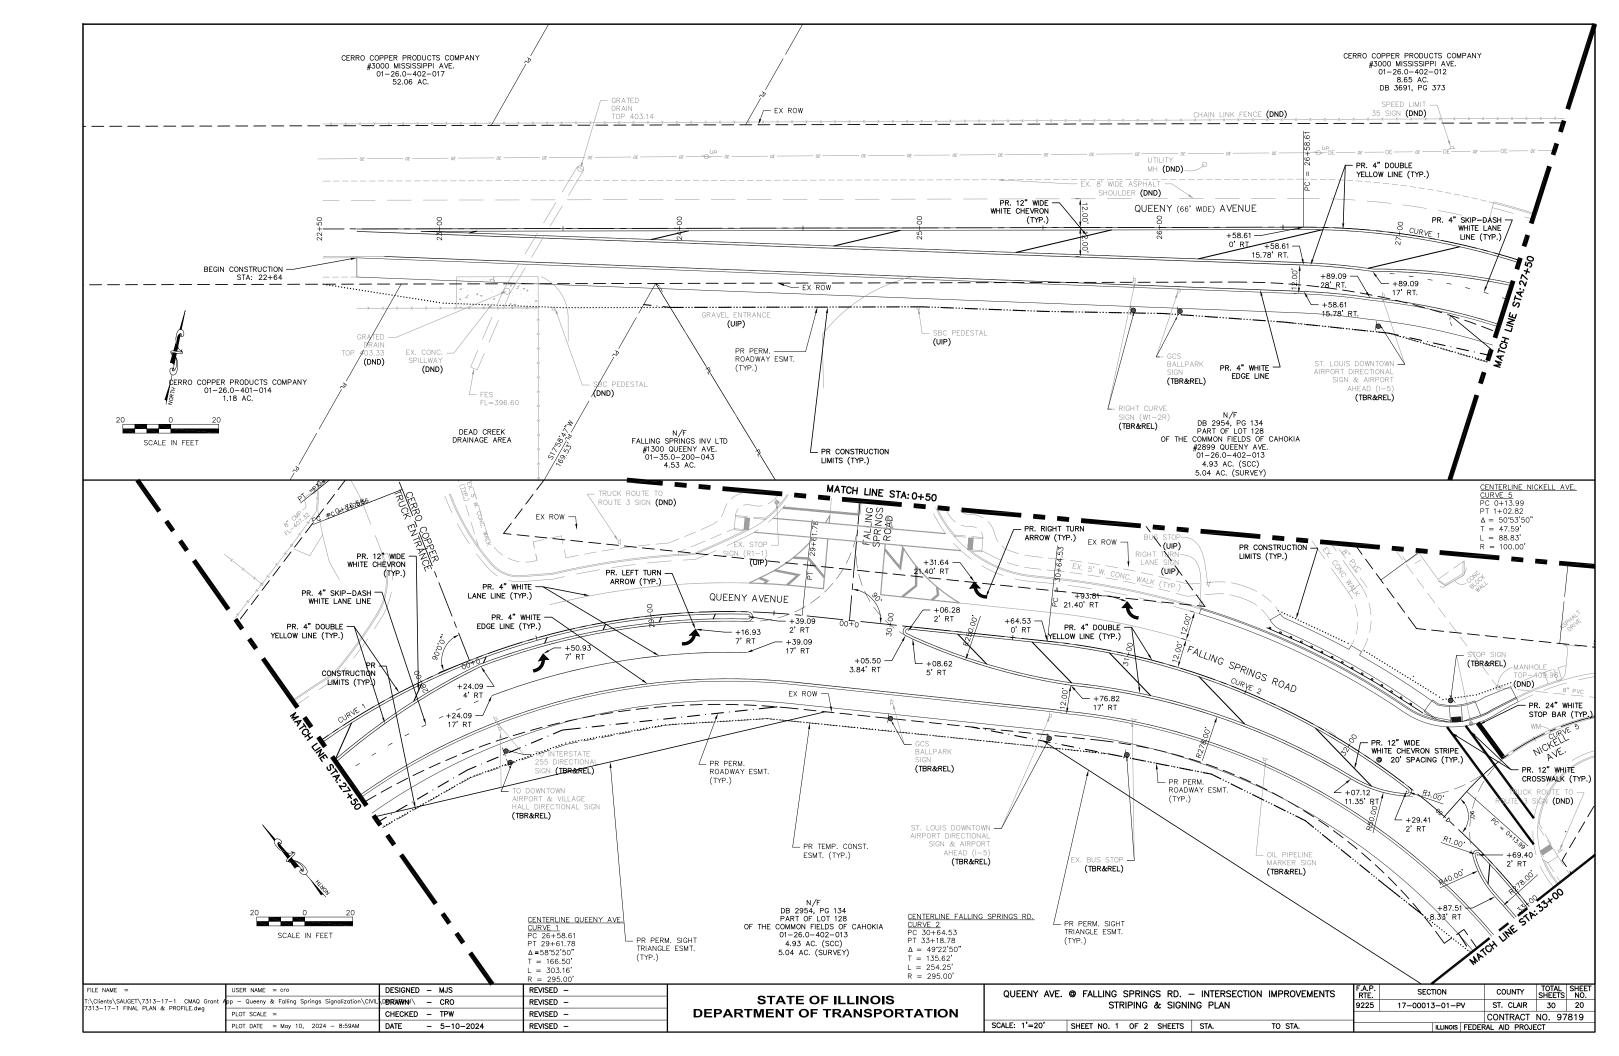


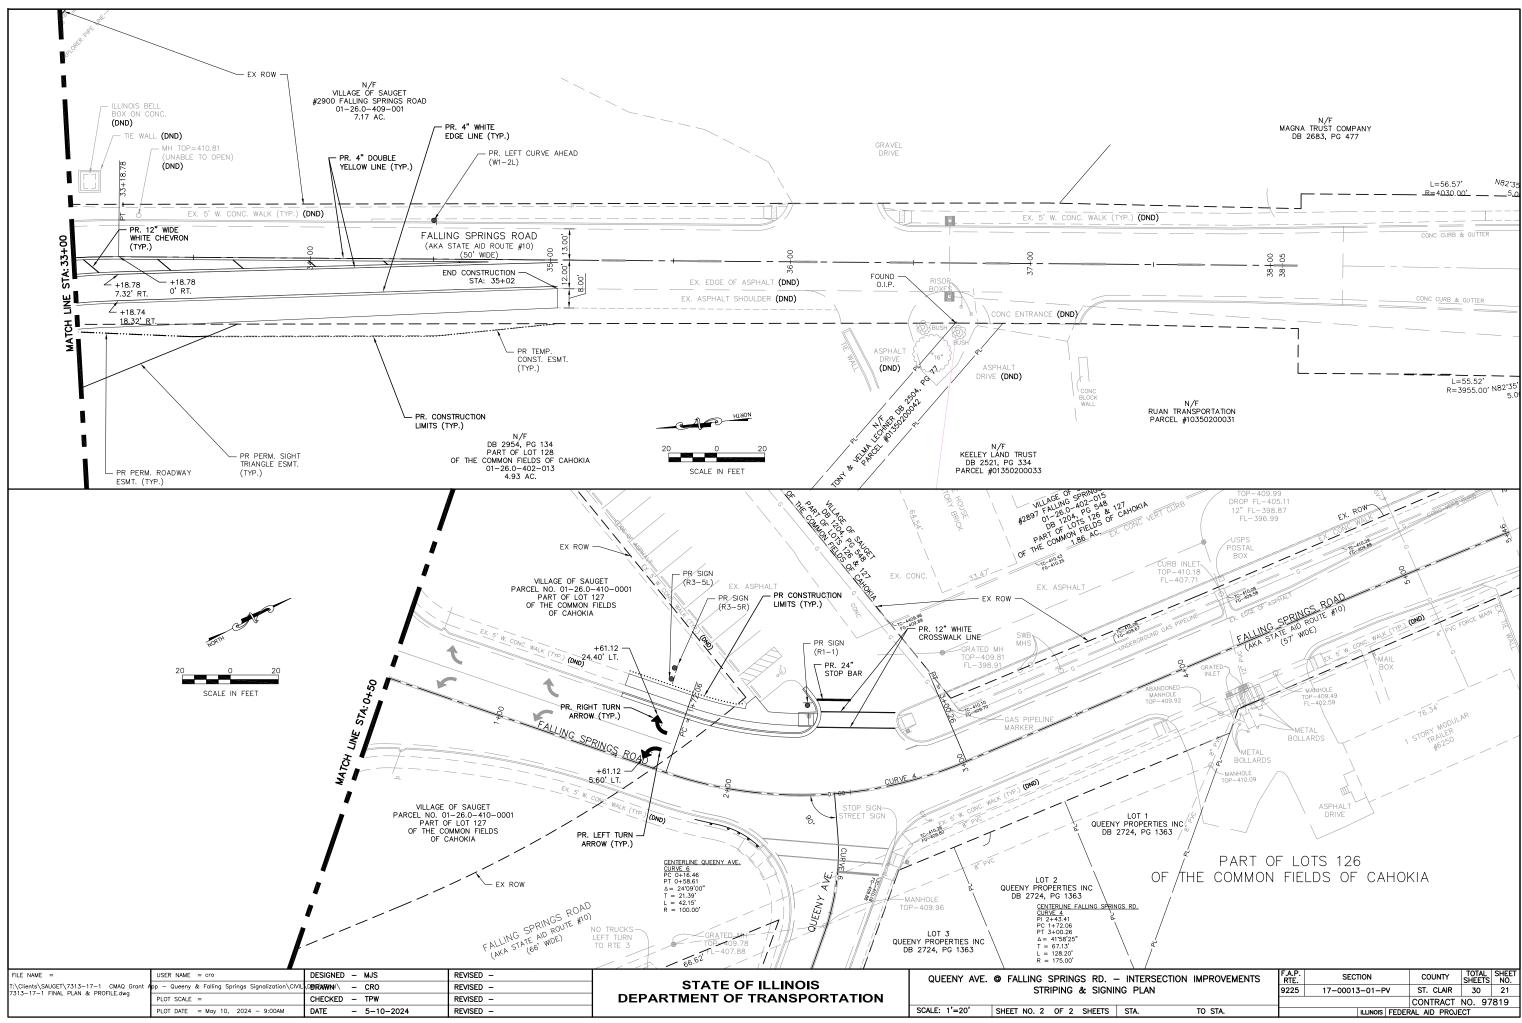


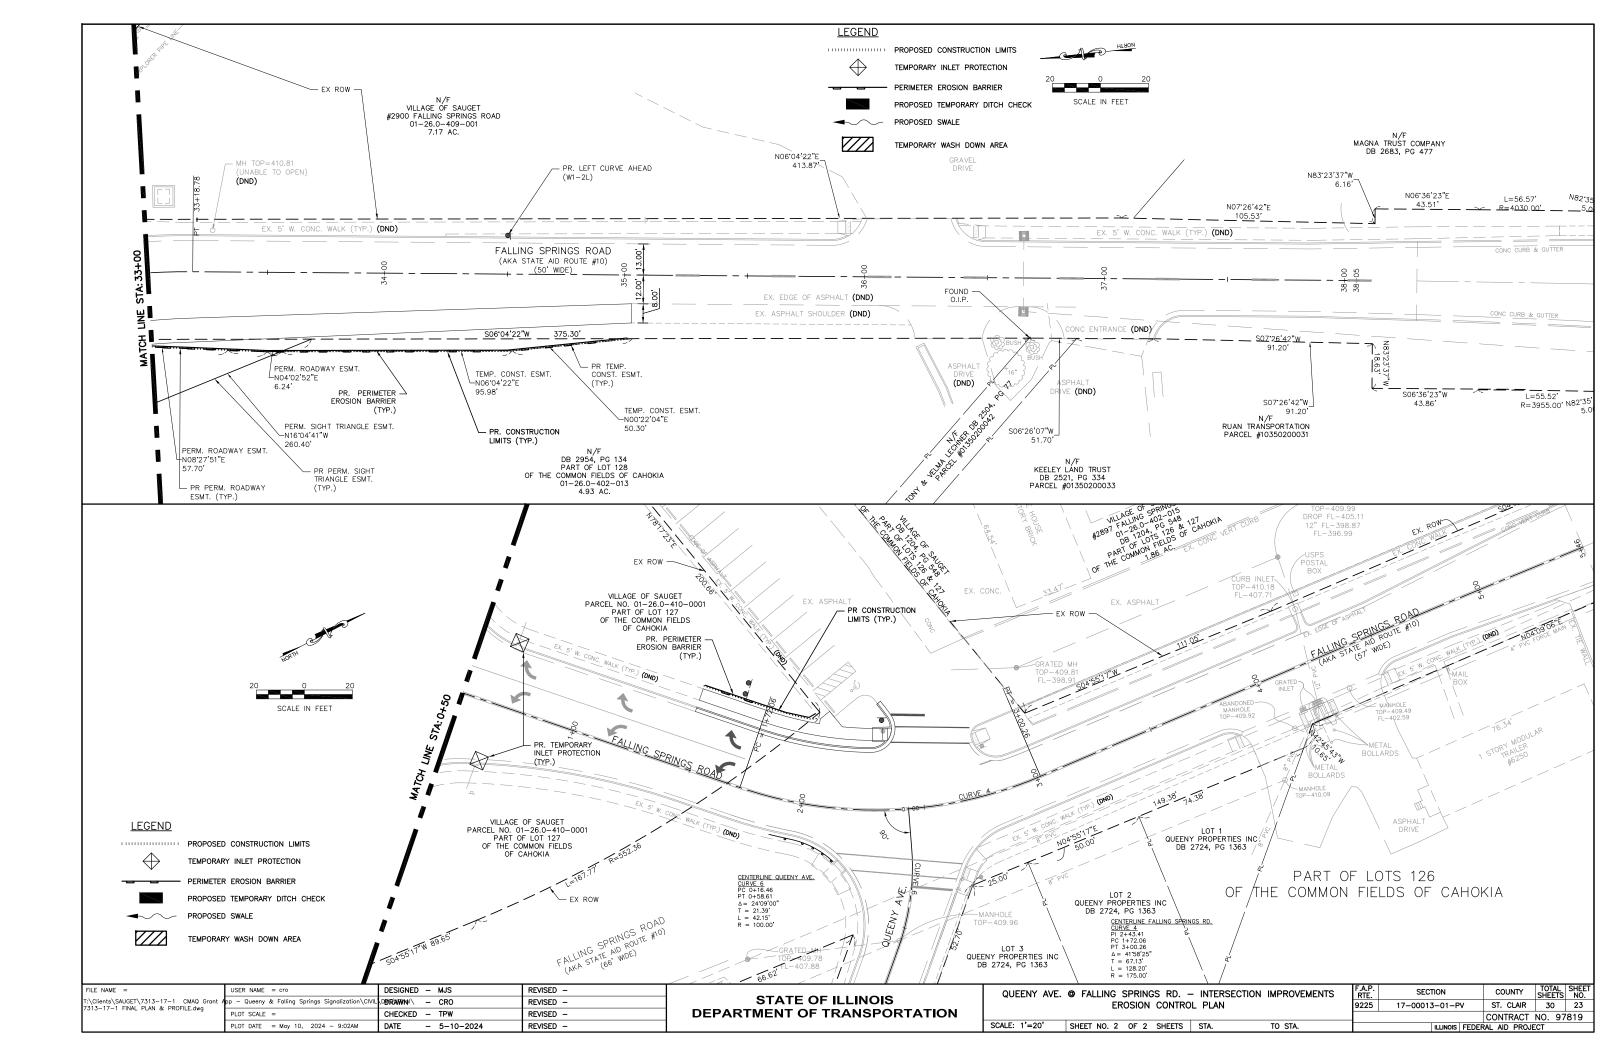

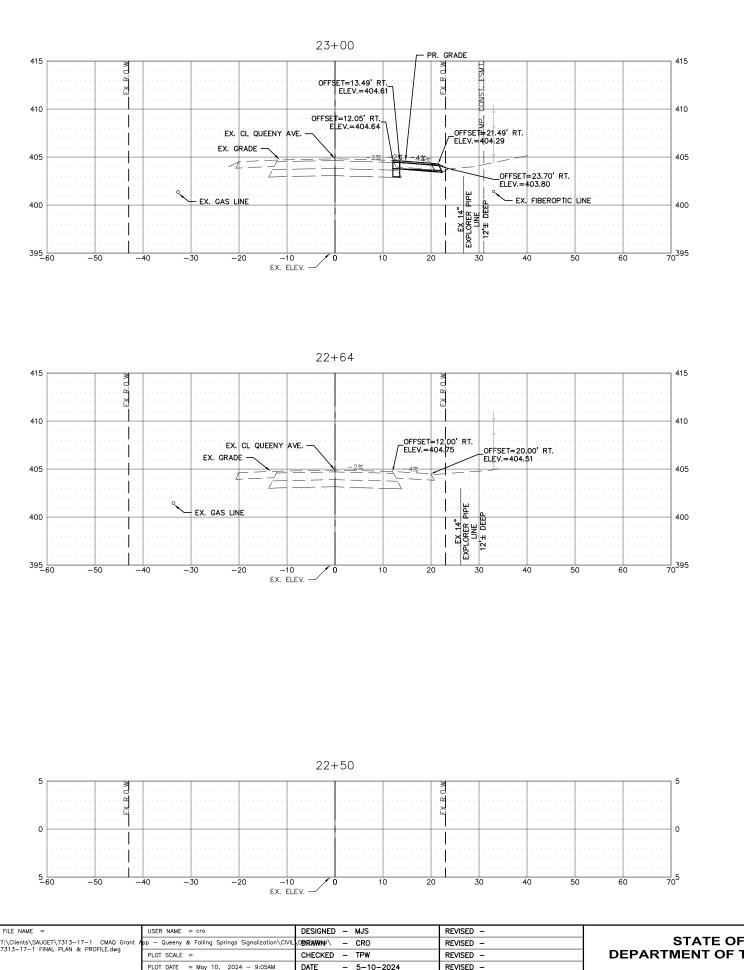


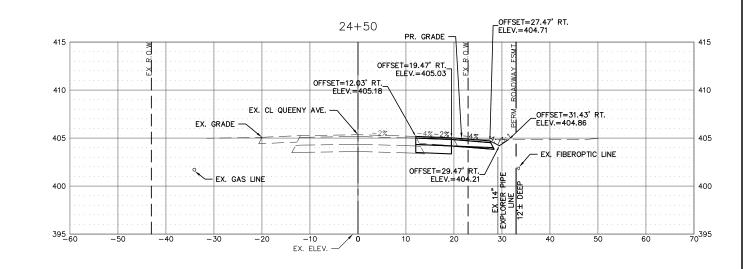


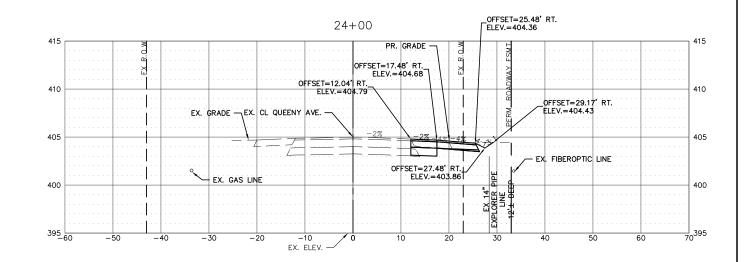


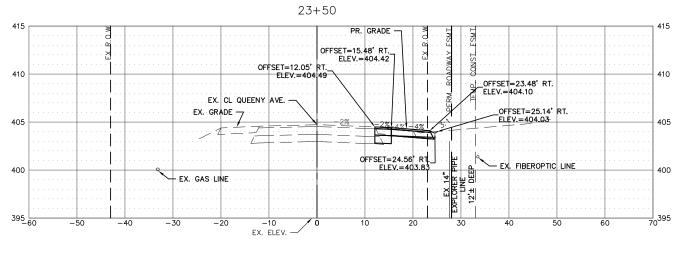


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				CROSS-SECTIONS			9225	17-00013-01-PV	ST. CLAIR	30 24	
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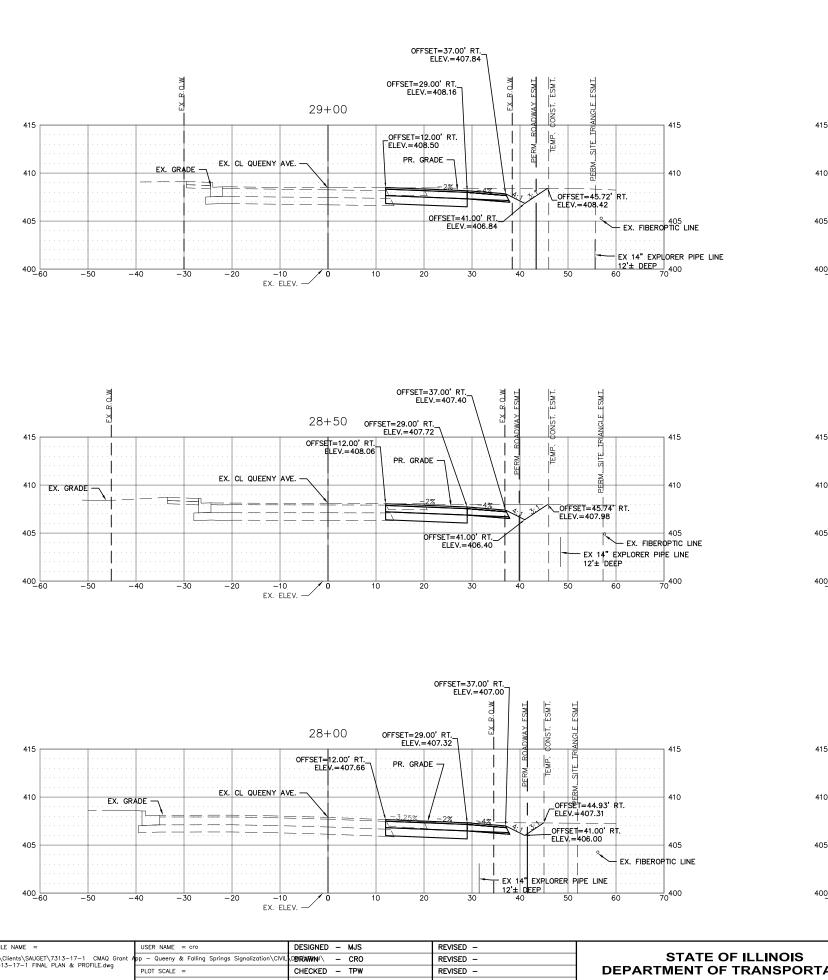


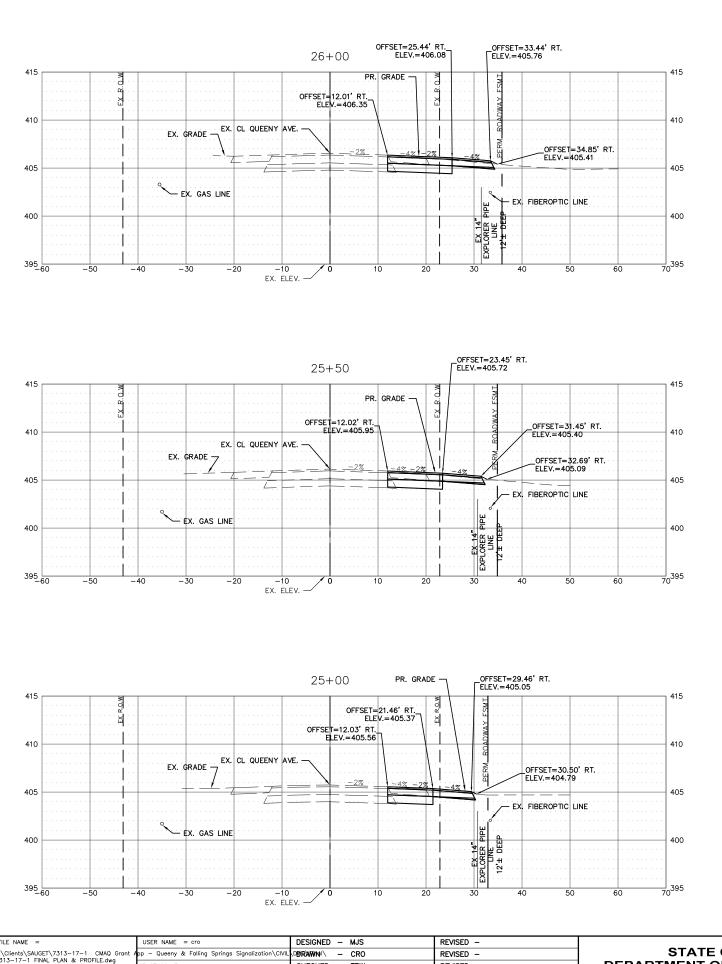
TO STA.

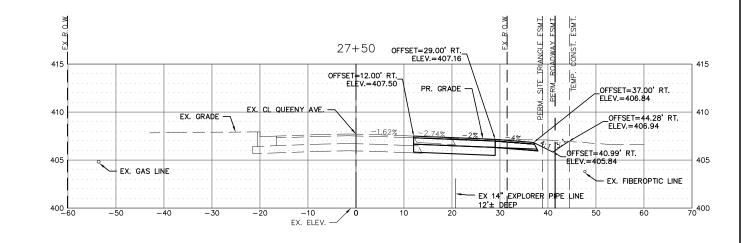CONTRACT NO. 97819

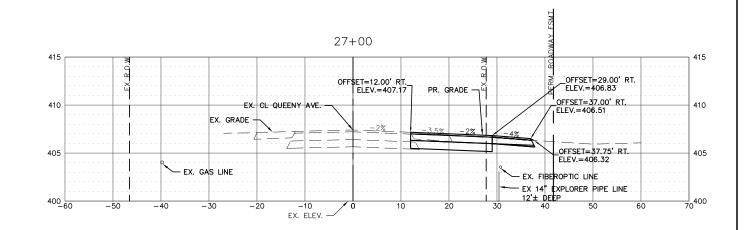
ILLINOIS FEDERAL AID PROJECT

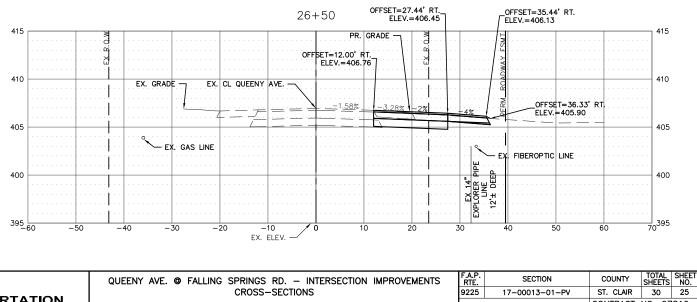
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7	313—17—1 FINAL PLAN & PROFILE.dwg	PLOT SCALE =	CHECKED - TPW	REVISED -	DEPARTMENT OF TRANSPORTATION			
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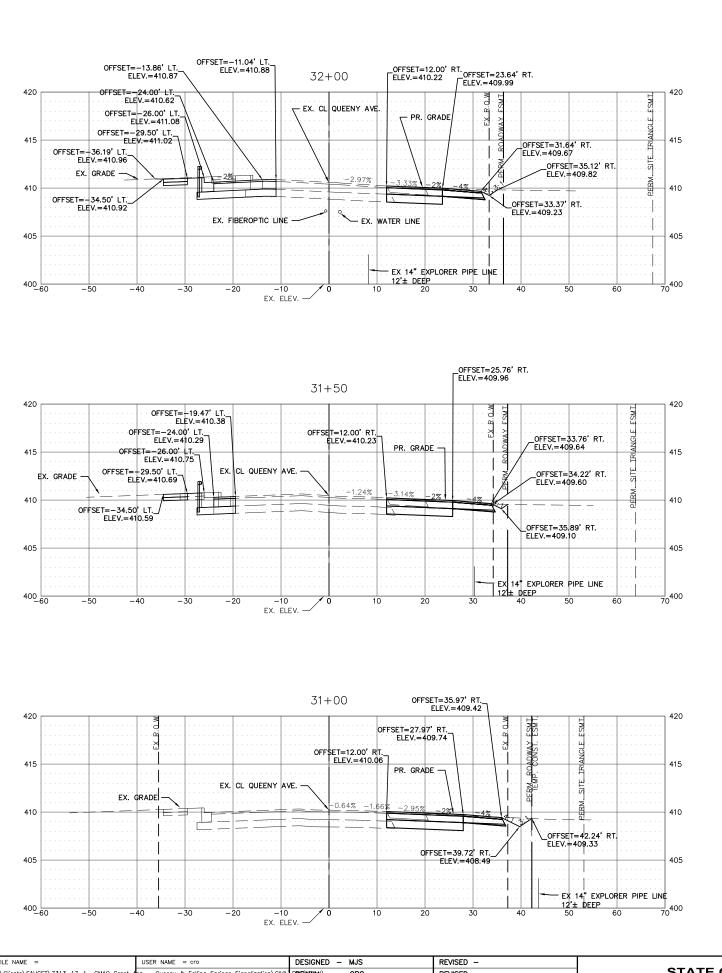


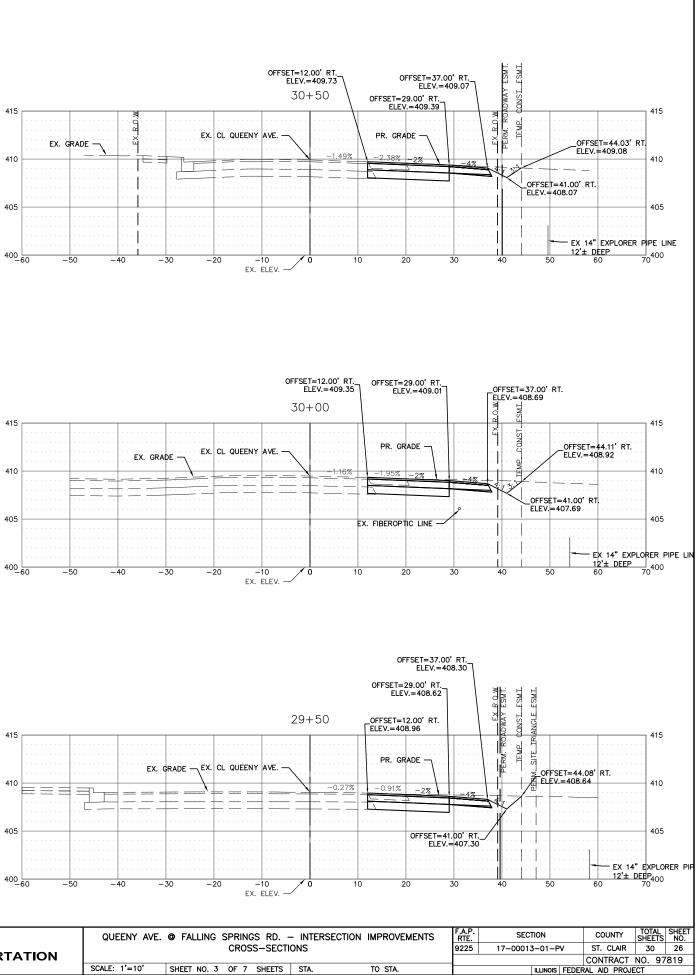



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T:\Clients\SAUGET\7313-17-1 CMAQ Grant App - Queeny & Falling Springs Sig 7313-17-1 FINAL PLAN & PROFILE.dwg		DØRAWNI – CRO	REVISED -	STATE OF ILLINOIS	QUELIN ME	CROSS-SECTIO
7515-17-1 FINAL PLAN & PROFILE.dwg	PLOT SCALE =	CHECKED - TPW	REVISED -	DEPARTMENT OF TRANSPORTATION		
	PLOT DATE = May 10, 2024 - 9:06AM	DATE - 5-10-2024	REVISED -		SCALE: 1'=10'	SHEET NO. 3 OF 7 SHEETS




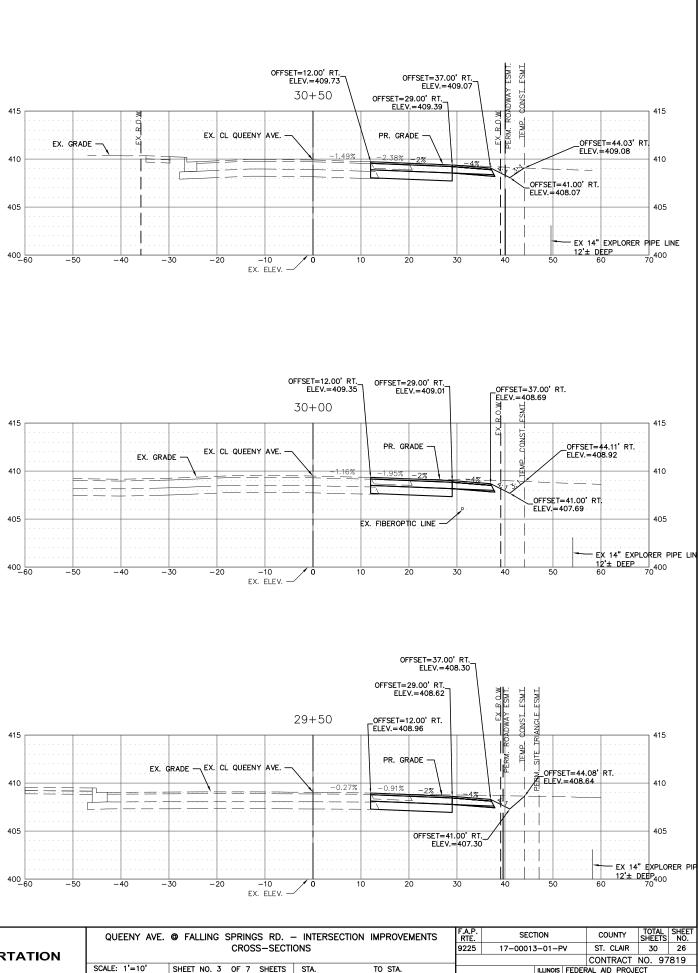

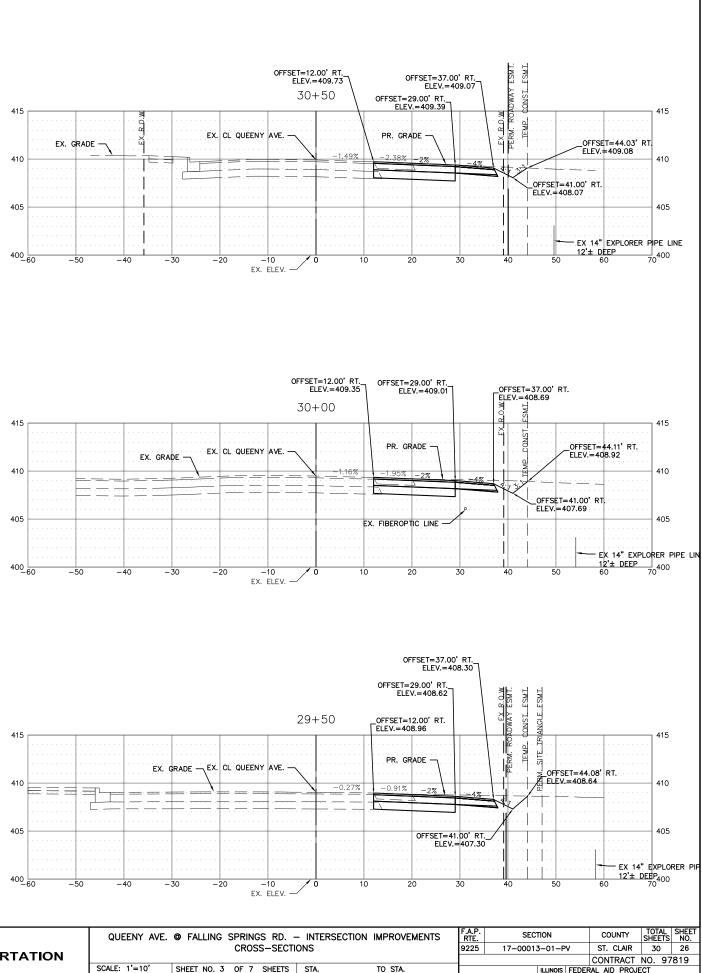


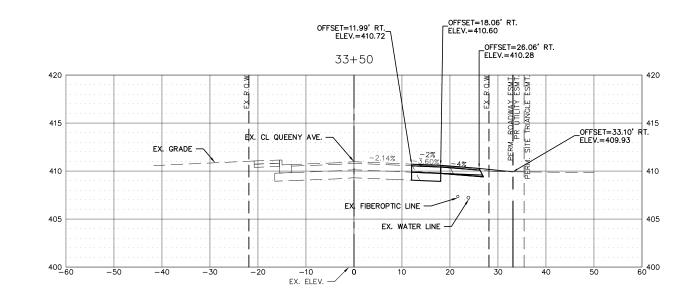


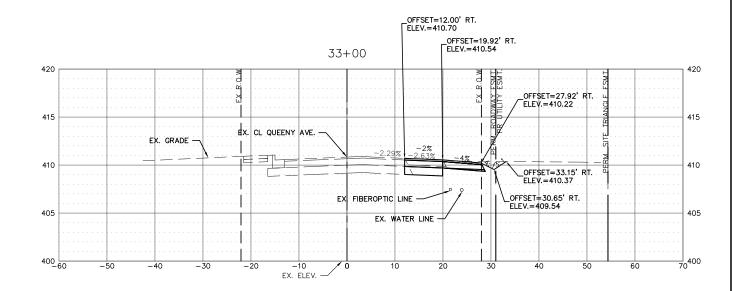

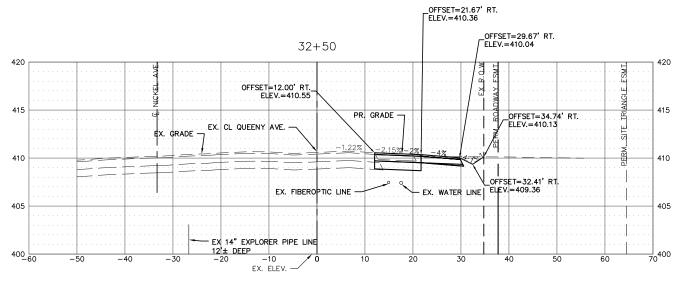


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Joro II. Think Four a thome.aug	PLOT SCALE =	CHECKED - TPW	REVISED -	DEPARTMENT OF TRANSPORTATION			CONTRACT NO. 97819
	PLOT DATE = May 10, 2024 - 9:10AM	DATE - 5-10-2024	REVISED -		SCALE: 1'=10' SHEET NO. 4 OF 7 SHEETS STA. TO STA.	ILLINOIS F	EDERAL AID PROJECT

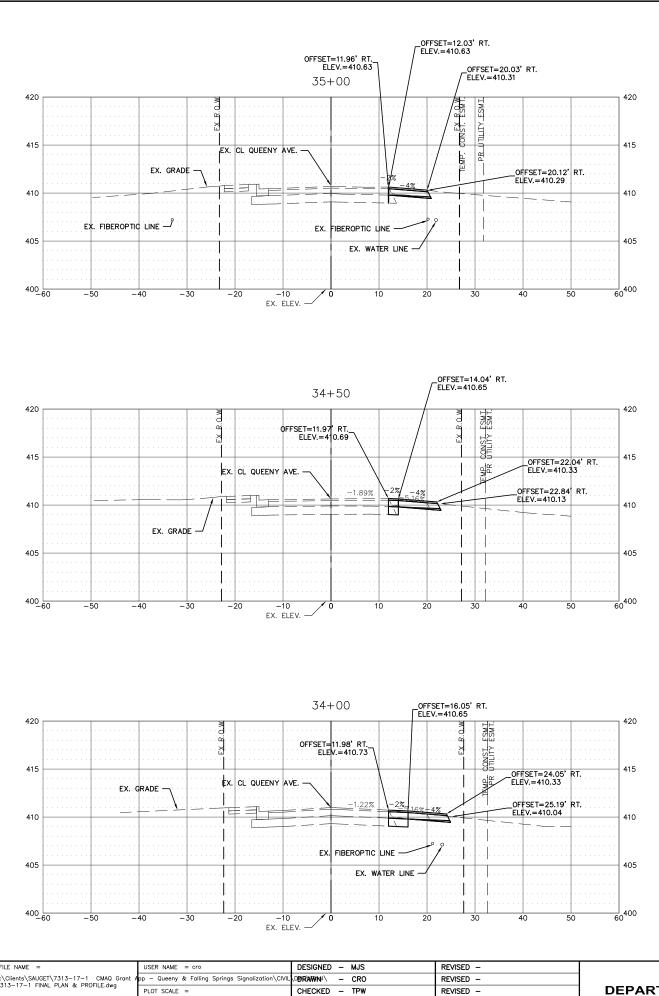


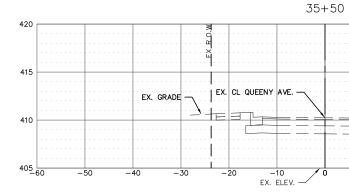



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			CHECKED - TPW	REVISED -	DEPARTMENT OF TRANSPORTATION				
		PLOT DATE = May 10, 2024 - 9:10AM	DATE - 5-10-2024	REVISED -		SCALE: 1'=10'	SHEET NO. 5 OF 7 SHEETS		

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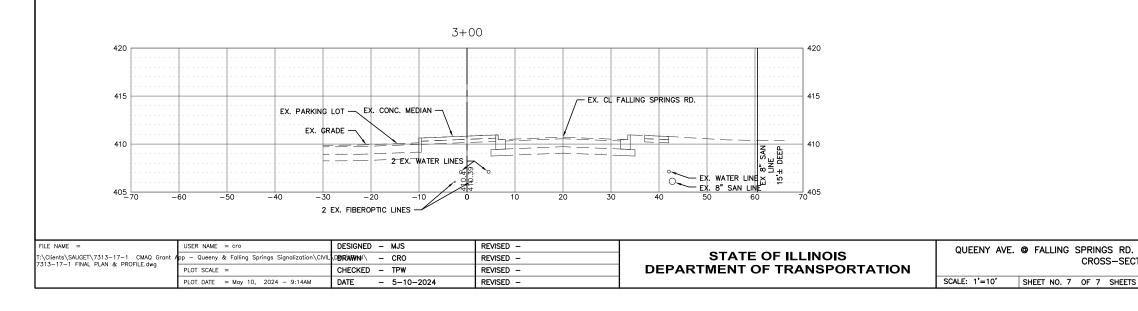


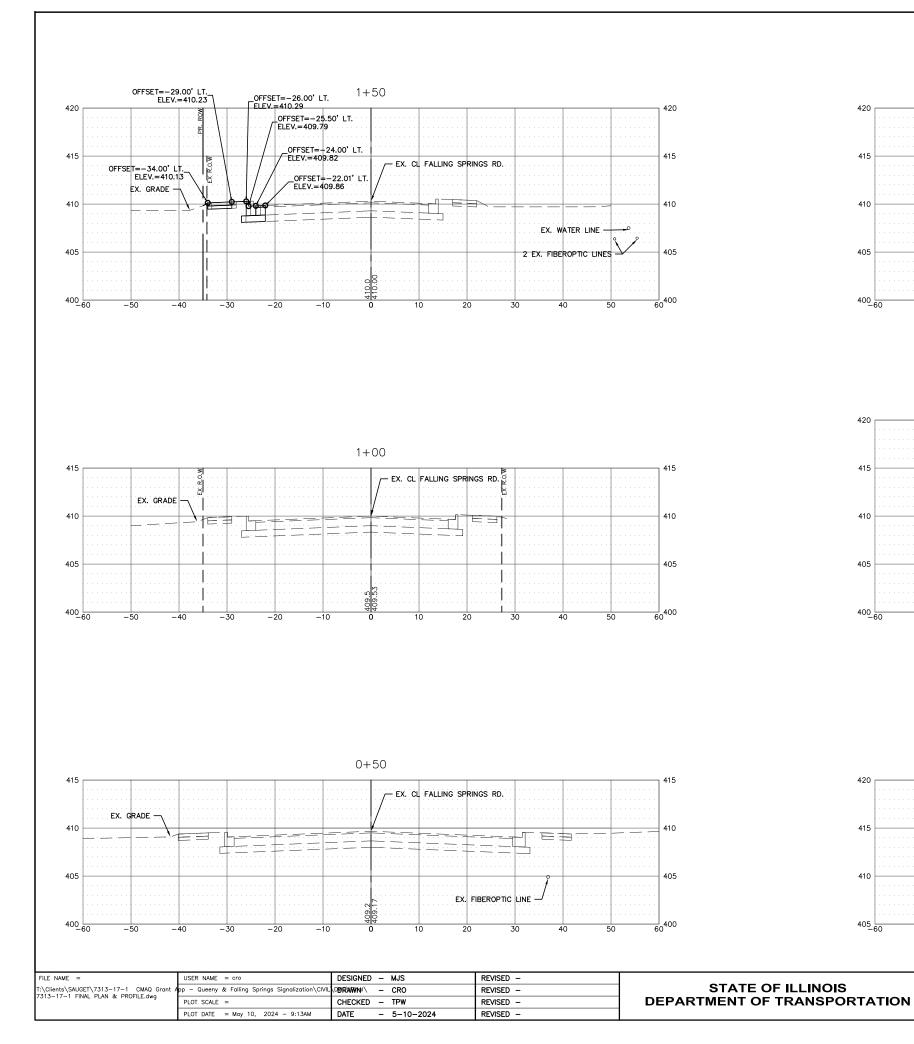

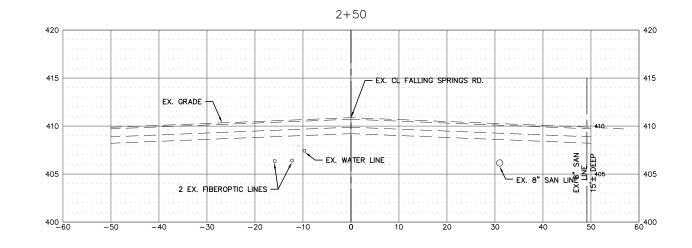

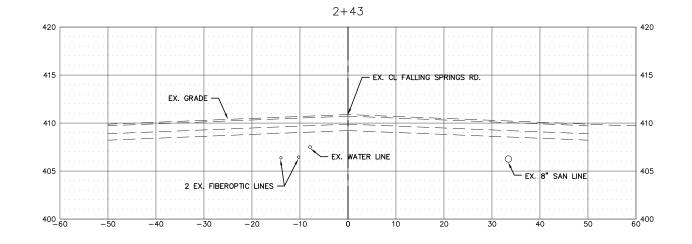

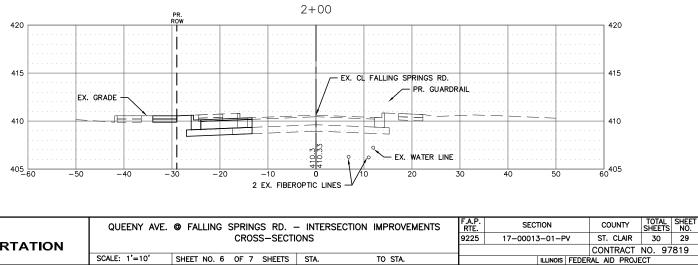SCALE: 1'=10' SHEET NO. 6 OF 7 SHEETS STA.



-	- INTERSECTION	IMPROVEMENTS	F.A.P. RTE.	SECTION	COUNTY	TOTAL SHEETS	SHEET NO.
TI	ONS		9225	17-00013-01-PV	ST. CLAIR	30	30
_					CONTRACT	NO. 97	819
	STA.	TO STA.		ILLINOIS FEDER	RAL AID PROJE	CT	