

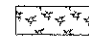
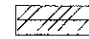

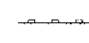
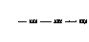





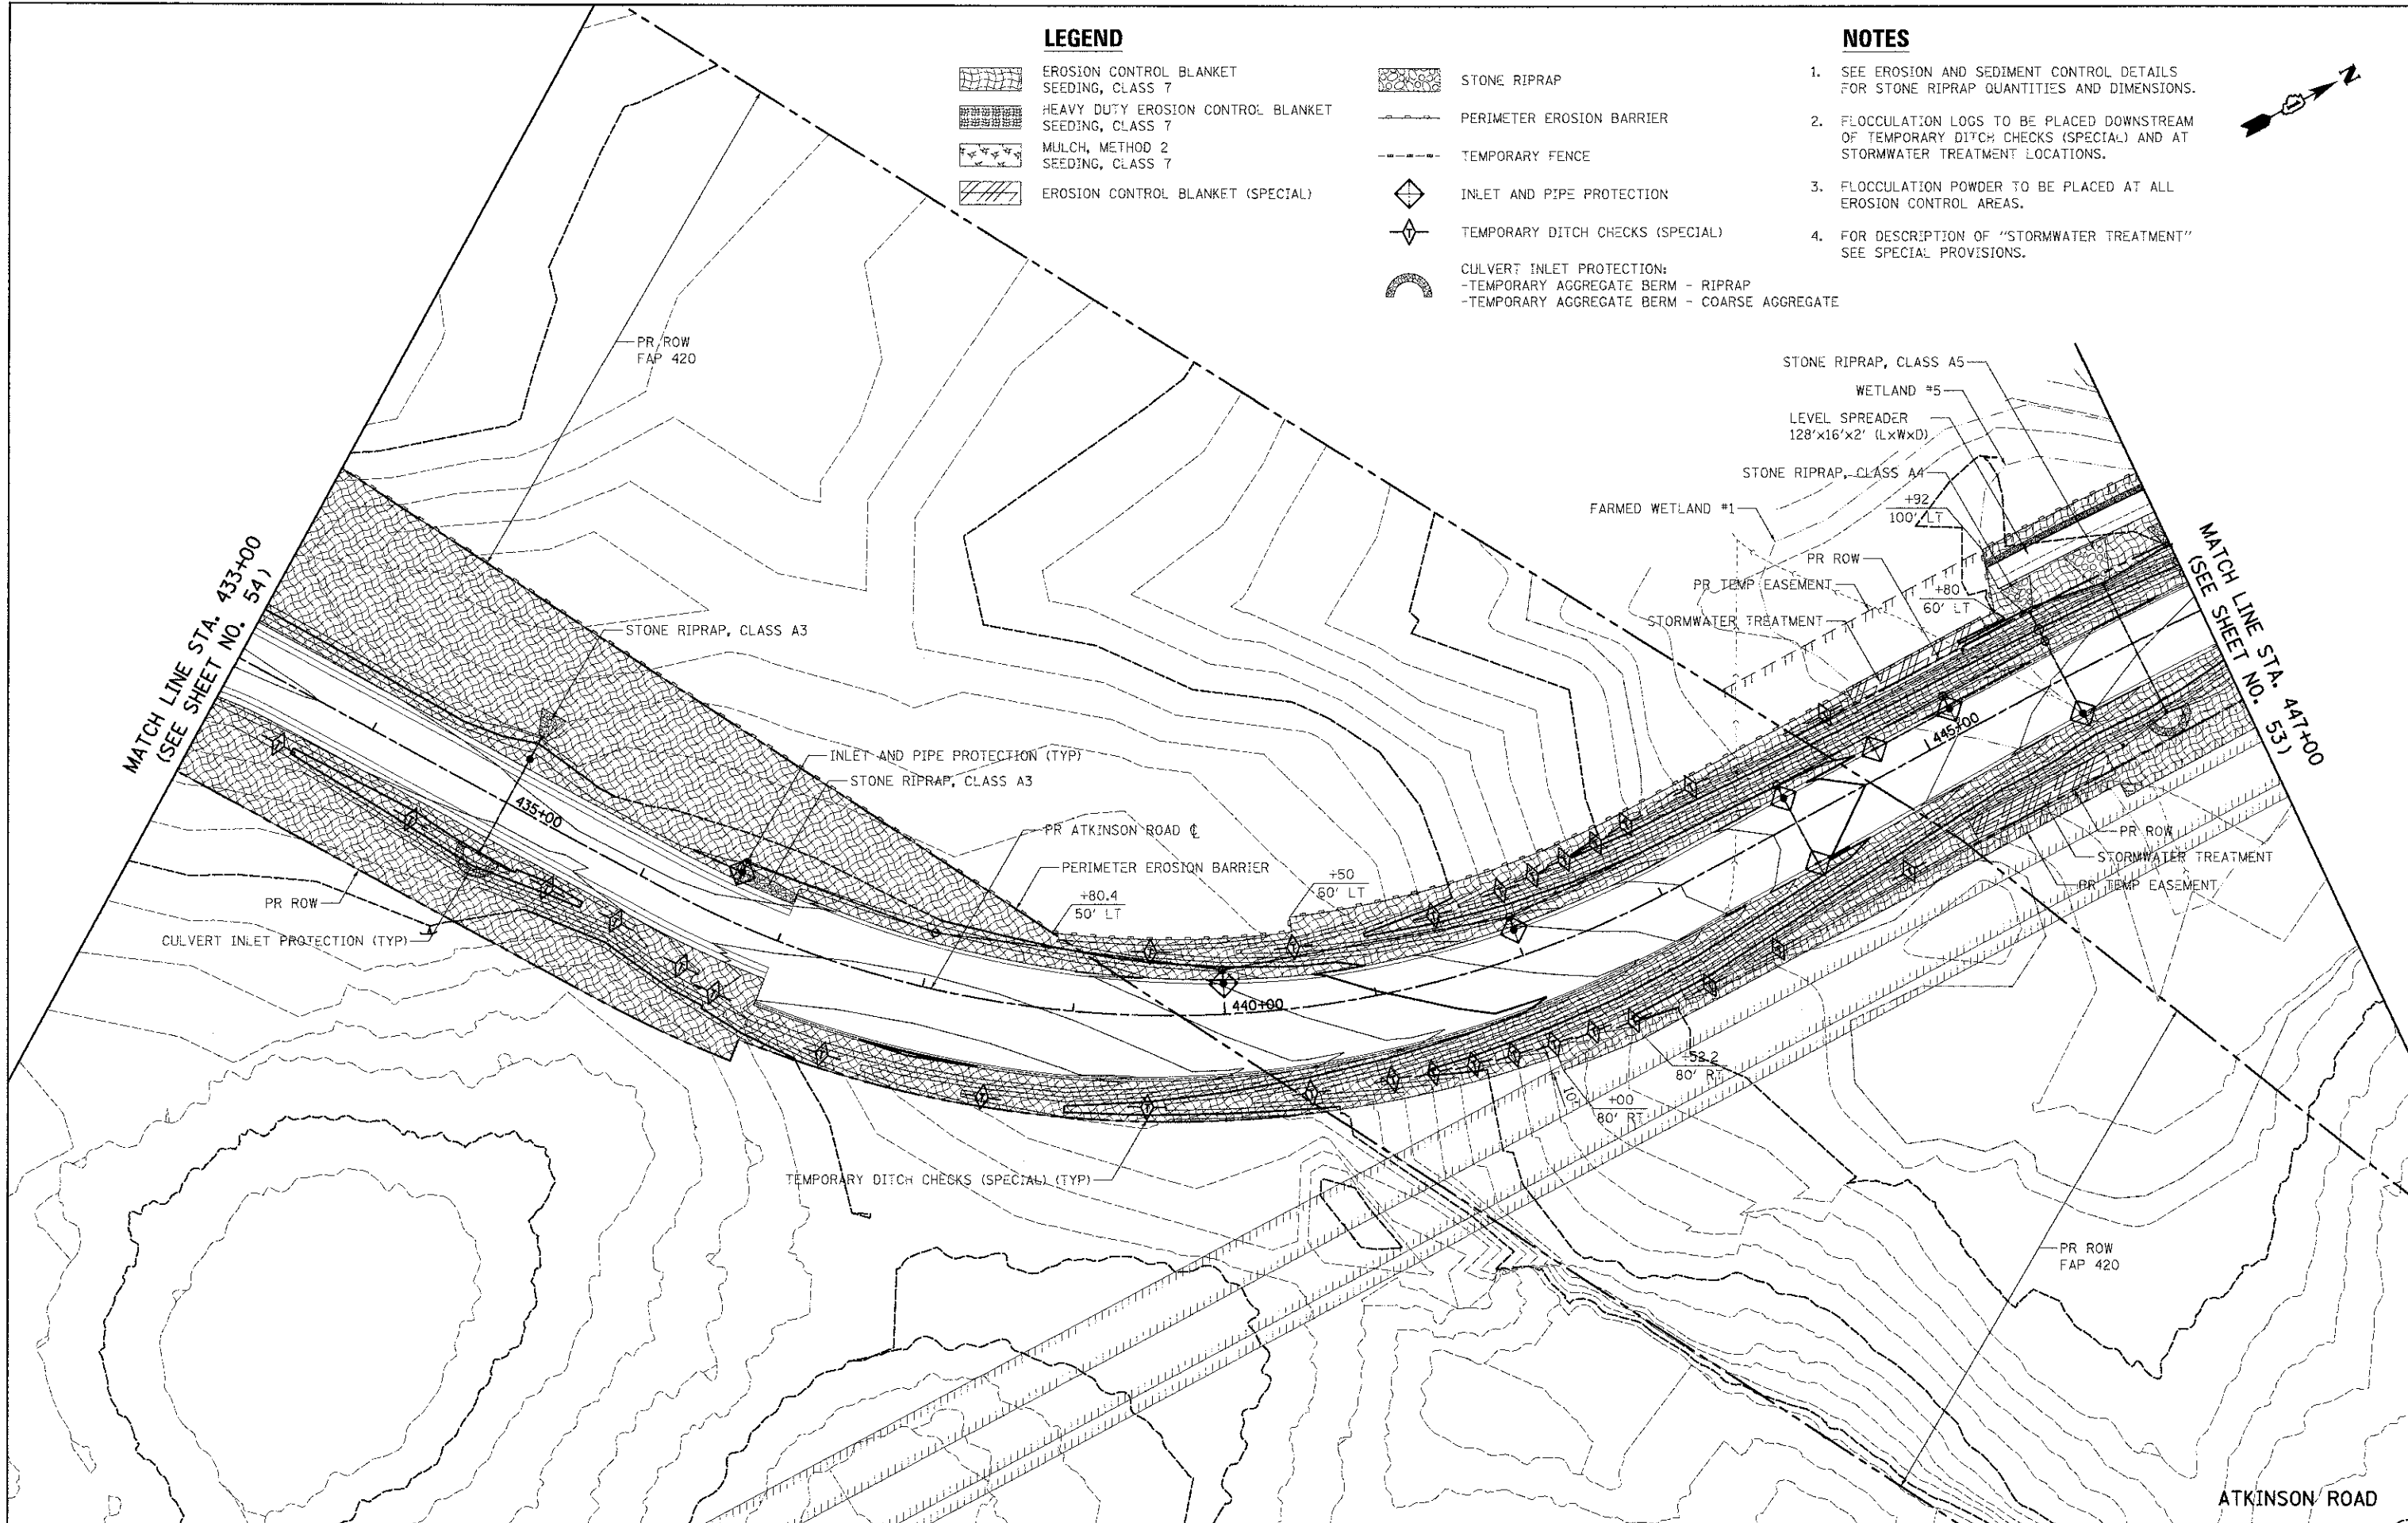
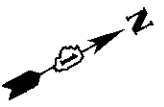
LEGEND

-  EROSION CONTROL BLANKET SEEDING, CLASS 7
-  HEAVY DUTY EROSION CONTROL BLANKET SEEDING, CLASS 7
-  MULCH, METHOD 2 SEEDING, CLASS 7
-  EROSION CONTROL BLANKET (SPECIAL)

-  STONE RIPRAP
-  PERIMETER EROSION BARRIER
-  TEMPORARY FENCE
-  INLET AND PIPE PROTECTION
-  TEMPORARY DITCH CHECKS (SPECIAL)
-  CULVERT INLET PROTECTION:
-TEMPORARY AGGREGATE BERM - RIPRAP
-TEMPORARY AGGREGATE BERM - COARSE AGGREGATE

NOTES

1. SEE EROSION AND SEDIMENT CONTROL DETAILS FOR STONE RIPRAP QUANTITIES AND DIMENSIONS.
2. FLOCCULATION LOGS TO BE PLACED DOWNSTREAM OF TEMPORARY DITCH CHECKS (SPECIAL) AND AT STORMWATER TREATMENT LOCATIONS.
3. FLOCCULATION POWDER TO BE PLACED AT ALL EROSION CONTROL AREAS.
4. FOR DESCRIPTION OF "STORMWATER TREATMENT" SEE SPECIAL PROVISIONS.



USER NAME = eds	DESIGNED - MJP	REVISED -
FILE NAME = ...2187-shtreros01.dgn	DRAWN - MJP	REVISED -
PLOT SCALE = 50.0000 / 1"	CHECKED - DNM	REVISED -
PLOT DATE = 2/2/2012	DATE = 02/06/12	REVISED -

**STATE OF ILLINOIS
DEPARTMENT OF TRANSPORTATION**

**ATKINSON ROAD
EROSION AND SEDIMENT CONTROL**

SCALE: 1" = 50' SHEET NO. 1 OF 5 SHEETS STA. 433+00 TO STA. 447+00

F.A.U. RTE. 198	SECTION 00-00045-00-PV	COUNTY LAKE	TOTAL SHEETS 195	SHEET NO. 52
CONTRACT NO. 63640				
FED. ROAD DIST. NO. 1 ILLINOIS FED. AID PROJECT				

ATKINSON ROAD