
DESIGN NUMBERD-91-417-01 47TH ST TO 31ST ST D-91-419-01 GARFIELD BLVD TO 47TH ST

PROJECT LOCATED IN CITY OF CHICAGO


DESIGN DESIGNATION

SB LOCAL LANES: 6042 (35) URBAN INTERSTATE 264.46 (CRC-30)

	(2020)	SPEED	SPEE
SB LOCAL LANES	122,330	60	45
RAMP 39D	7,120	45	40
RAMP 43A	5,335	45	40
RAMP 43D	5,000	45	40
RAMP 47A	14,040	45	40

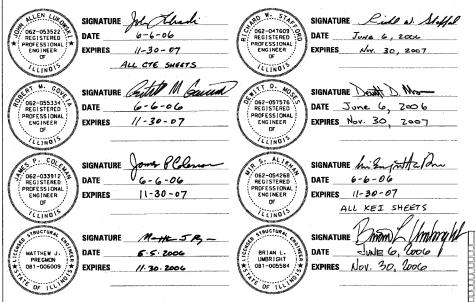

RETAINING WALL STRUCTURE NO. 016–W978
RETAINING WALL DESIGNATION: S–47N–R
RETAINING WALL DESIGNATION: S–43N–F
RETAINING WALL DESIGNATION: S–39S–R

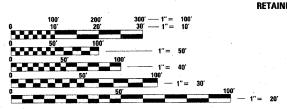

FULL SIZE PLANS HAVE BEEN PREPARED USING STANDARD ENGINEERING SCALES. REDUCED SIZED PLANS WILL NOT CONFORM TO STANDARD SCALES. IN MAKING MEASUREMENTS ON REDUCED PLANS, THE ABOVE SCALES MAY BE USED.

BEFORE EXCAVATING CALL: CHICAGO UTILITY ALERT NETWORK (312) 744-7000

CONTRACT NO. 62303

STATE OF ILLINOIS


DEPARTMENT OF TRANSPORTATION DIVISION OF HIGHWAYS

PLANS FOR PROPOSED FEDERAL AID HIGHWAY

PROJECT BEGINS

F.A.I. ROUTE 90/94 (DAN RYAN EXPRESSWAY) (190/94)
SECTION (2021-922 PT2 ETC 2324.6-1P) R-11
PROJECT: ACIM-000S(517)
RECONSTRUCTION OF SOUTHBOUND LOCAL
LANES AND RAMPS BETWEEN GARFIELD
BOULEVARD AND 31ST STREET
COOK COUNTY
C-91-420-01

PROJECT ENDS

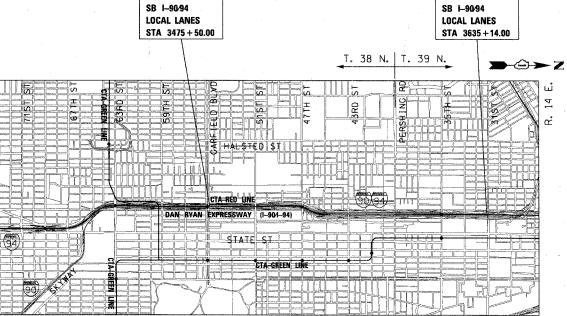


LOCATION MAP

GROSS LENGTH OF PROJECT = 15,964 FT (3.023 MILES)

NET LENGTH OF PROJECT = 15,964 FT (3.023 MILES)

| F.A.I. | SECTION | COUNTY | TOTAL SHEET | NO. | SHEET |



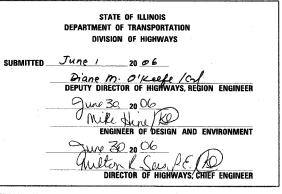



PRINTED BY THE AUTHORITY OF THE STATE OF ILLINOIS

INDEX OF SHEETS

SHEET NO. TITLE

SHEET NO.	TITLE .
1	COVER SHEET
2	INDEX OF SHEETS, LIST OF ILLINOIS DOT HIGHWAY STANDARDS, AND PROJECT COMMITMENTS
3	GENERAL NOTES
4-6	SUGGESTED SEQUENCE OF OPERATION
7-15	SUMMARY OF QUANTITIES
16-19	EXISTING TYPICAL SECTIONS
20-29	PROPOSED TYPICAL SECTIONS
30-35	SCHEDULE OF QUANTITIES
36-51	ALIGNMENT PLANS, SURVEY TIES AND CONTROL POINTS
52-67	EXISTING AND PROPOSED ROADWAY PLANS
68-79	PROPOSED PROFILES
80	CONSTRUCTION STAGING AND TRAFFIC CONTROL GENERAL NOTES
81 82-83	SCHEDULE OF QUANTITIES FOR TRAFFIC CONTROL CONSTRUCTION STAGING AND TRAFFIC CONTROL TYPICAL SECTIONS
84-116	SUGGESTED STAGES OF CONSTRUCTION AND TRAFFIC CONTROL
117	ALTERNATE ROUTE SIGNING PLANS
118-125	TEMPORARY SIGN PANEL DETAILS
126-133	EROSION CONTROL PLANS AND DETAILS
134	DRAINAGE NOTES AND LEGEND
135-154	DRAINAGE SCHEDULES
155-189	DRAINAGE AND UTILITY PLANS
190-209	S.U.E. SHEETS
210-226	PAVEMENT JOINT AND ELEVATION PLANS
227-235	PROPOSED PAVEMENT MARKING PLANS
236-237	SCHEDULE OF QUANTITIES FOR PROPOSED SIGNING
238-249	PROPOSED SIGNING PLANS
250	SIGN PANEL DETAILS
251-300 301-304	PROPOSED OVERHEAD SIGN STRUCTURE DETAILS PROPOSED GROUND MOUNTED SIGN STRUCTURE DETAILS
305-307	PROPOSED OVERHEAD SIGN STRUCTURE SOIL BORING LOGS
308-316	LANDSCAPING PLANS AND DETAILS
317-317	GRADING PLANS
318-332	ELECTRICAL INFRASTRUCTURE PLANS
333-350	ELECTRICAL INFRASTRUCTURE DETAILS
351-377	ROADWAY DETAILS
378-379	DRAINAGE DETAILS
380-394	SOIL BORING PLANS AND LOGS
395	- SHEET NOT USED -
396	PROPOSED RETAINING WALLS KEY PLAN AND GENERAL NOTES
397-411 412-435	RETAINING WALL S-47N-R
436-444	RETAINING WALL S-45S-F RETAINING WALL S-43N-F
445-452	RETAINING WALL S-39S-R
453-461	STRUCTURAL DETAILS -
462-477	MWRD CULVERT PLAN & DETAILS
478	BD-07 DISTRICT 1, STORM SEWER CONNECTION TO EXISTING SEWER
479	BD-08 DISTRICT 1, FRAMES AND LIDS ADJUSTMENT WITH MILLING: AND FRAMES AND LIDS ADJUSTMENT WITHOUT MILLING
480	BD-09 DISTRICT 1, CITY OF CHICAGO DRAINAGE DETAILS
481	BD-32 DISTRICT 1, BUTT JOINT AND BITUMINOUS TAPER DETAILS
482	BD-34 DISTRICT 1, STEEL PLATE BEAM GUARDRAIL ADJACENT TO CURB AND GUTTER AND STABILIZATION TBT TY. 1 SPL.
483	BD-47 DISTRICT 1, CITY OF CHICAGO CATCH BASINS, INLET AND MANHOLE DETAILS
484-486	BE-500 DISTRICT 1, LIGHT TOWER, 90 -> 130 FT. M.H.
487-488 489	BE-501 DISTRICT 1, LIGHT TOWER FOUNDATION, 90 - > 130 FT. M.H. TC-08 DISTRICT 1, ENTRANCE AND EXIT RAMP CLOSURE DETAIL
490	TC-09 DISTRICT 1, FREEWAY SINGLE AND MULTI LANE WEAVE
491	TC-10 DISTRICT 1, TRAFFIC CONTROL AND PROTECTION FOR SIDE ROADS, INTERSECTIONS AND DRIVEWAYS
492	TC-11 DISTRICT 1, RAISED REFLECTIVE PAVEMENT MARKINGS (SNOW PLOW RESISTANT)
493-494	TC-12 DISTRICT 1, MULTI-LANE FREEWAY PAVEMENT MARKING
495	TC-13 DISTRICT 1, DISTRICT ONE TYPICAL PAVEMENT MARKINGS
496	TC-16 DISTRICT 1, PAVEMENT MARKING LETTERS AND SYMBOLS FOR TRAFFIC STAGING
497	TC-17 DISTRICT 1, TRAFFIC CONTROL FOR SHOULDER CLOSURES AND PARTIAL RAMP CLOSURES
498	TC-18 DISTRICT 1, SIGNING FOR FLAGGING OPERATIONS AT WORK ZONE OPENINGS
499	TC-22 DISTRICT 1, TEMPORARY INFORMATION SIGNING
500-501	TC-24 DISTRICT 1, CITY OF CHICAGO TYPICAL PAVEMENT MARKINGS
502-557	ROADWAY CROSS SECTIONS
558-563 564-574	HMLT CROSS SECTIONS UTILITY CROSS SECTIONS
575-500	UTILITY CRUSS SECTIONS

LIST OF STATE STANDARDS

FED. ROAD DIST. NO. ILLINOIS FED. AID PROJECT STANDARD SYMBOLS, ABBREVIATIONS, AND PATTERNS 62303 *(2021-922 PT2 ETC 2324.6-1P) R-11 AREAS OF REINFORCEMENT BARS 001001 001006 DECIMAL OF AN INCH AND OF A FOOT 280001-02 TEMPORARY EROSION CONTROL SYSTEMS 420001**-0**6 PAVEMENT JOINTS 420111-*01* PCC PAVEMENT ROUNDOUTS 483001**-02** PCC SHOULDER 602001 CATCH BASIN TYPE A 602011 CATCH BASIN TYPE C 602401**-01** MANHOLE TYPE A PRECAST REINFORCED CONCRETE FLAT SLAB TOP 602601 602701-**01** MANHOLE STEPS 604001**-02** FRAME AND LIDS TYPE 1 604071**-02** FRAME AND GRATE TYPE 20 604091-01 FRAME AND GRATE TYPE 24 606001-*0*2 CONCRETE CURB TYPE B AND COMBINATION CONCRETE CURB AND GUTTER 630001**-06** STEEL PLATE BEAM GUARDRAIL 631011- *02* TRAFFIC BARRIER (TERMINAL, TYPE 2 631031**- 05** TRAFFIC BARRIER TERMINAL, TYPE 6 635006-*0*2 REFLECTOR AND TERMINAL MARKER PLACEMENT 635011-*01* REFLECTOR MARKER AND MOUNTING DETAILS 637001**- 02** CONCRETE BARRIER, DOUBLE FACE, 816 mm (32 in.) HEIGHT 642001 SHOULDER RUMBLE STRIPS OFF-RD OPERATIONS, MULTILANE, 4.5m (15') TO 600mm (24") FROM PAVEMENT EDGE 701101-01 701106-*01* OFF RD OPERATIONS, MULITLANE, MORE THAN 15' AWAY 701400**-02** APPROACH TO LANE CLOSURE, FREEWAY/EXPRESSWAY 701401-*0*3 LANE CLOSURE, FREEWAY/EXPRESSWAY 701402-*05* LANE CLOSURE, FREEWAY/EXPRESSWAY, WITH BARRIER 701406-04 LANE CLOSURE, FREEWAY/EXPRESSWAY, DAY OPERATIONS ONLY 701411-03 LANE CLOSURE, MULTILANE, AT ENTRANCE OR EXIT RAMP, FOR SPEEDS > 45 MPH 701446 TWO LANE CLOSURE FREEWAY / EXPRESSWAY 701601-*04* URBAN LANE CLOSURE, MULTILANE, 1W OR 2W WITH NONTRAVERSABLE MEDIAN

PROJECT COMMITMENTS

URBAN LANE CLOSURE, MULTILANE INTERSECTION

METAL POSTS FOR SIGNS, MARKERS & DELINEATORS

TRAFFIC CONTROL DEVICES

TEMPORARY CONCRETE BARRIER

SIGN PANEL MOUNTING DETAILS

SIGN PANÉL ERECTION DETAILS

TYPICAL PAVEMENT MARKINGS

SIGN PANELS EXTRUDED ALUMINUM TYPE

701701-*04*

701801-*03*

702001**.06**

704001-02

720001

720006

720011

729001

720021-*01*

780001-*01*

1. IDOT HAS COMMITTED TO ADDRESS CONSTRUCTION RELATED AIR QUALITY CONCERNS. THESE STRATEGIES INCLUDE REQUIRING DETAILED DUST CONTROL PLANS, REQUIRING THE USE OF CLEANER BURNING DIESEL FUELS ON CERTAIN DIESEL POWERED CONSTRUCTION EQUIPMENT AND/OR THE INSTALLATION OF EXHAUST EMISSION SCRUBBERS, AND THE REDUCTION OF CONSTRUCTION EQUIPMENT IDLING TIMES. THESE STRATEGIES ARE ADDRESSED IN SPECIAL PROVISIONS INCLUDED IN THIS CONTRACT AND DEVELOPED FOR THE DAN RYAN RECONSTRUCTION PROJECT.

APPLICATION OF TYPES A AND B METAL POSTS (FOR SINGS AND MARKERS)

LANE CLOSURE, MULTILANE, 1W OR 2W, CROSSWALK OR SIDEWALK CLOSURE, FOR SPEEDS < 45 MPH

- 2. IDOT HAS COMMITTED TO REDUCE TIRE-PAVEMENT HIGHWAY TRAFFIC NOISE FOR THE FINISHED PROJECT BY INCLUDING A SPECIAL PROVISION TO INCORPORATE VARIABLE WIDTH AND SKEWED "TINING" OF THE NEW CONCRETE PAVEMENT.
- 3. IDOT REQUIRES THE PREPARATION (BY THE CONTRACTOR) OF PRE-CONSTRUCTION PHOTO AND/OR VIDEO LOGS OF STRUCTURES DIRECTLY ADJACENT TO THE HIGHWAY R.O.W. TO DOCUMENT STRUCTURAL CONDITION PRIOR TO DAN RYAN RECONSTRUCTION.
- 4. IDOT WILL CONTINUE TO COORDINATE WITH THE CITY OF CHICAGO DEPARTMENT OF TRANSPORTATION (CDOT) AND THE CHICAGO TRANSPORTATION AUTHORITY (CTA) USING THE "DAN RYAN EXPRESSWAY LANDSCAPE GUIDLINES", PREPARED BY CDOT AS GUIDELINES THROUGHOUT PHASE II OF THE PROJECT (PREPARATION OF CONTRACT PLANS) ON THE AESTHETICS AND LANDSCAPING TREATMENTS.
- 5. THE ISGS CONDUCTED A PRELIMINARY ENVIRONMENTAL SITE ASSESSMENT (PESA) IN WHICH THEY ASSESSED A HIGH RISK FOR THE OCCURENCE OF HAZARDOUS MATERIALS. A SPECIAL WASTE WAVER HAS BEEN APPROVED WHICH ALLOWS DESIGN APPROVAL TO BE GRANTED PRIOR TO THE COMPLETION OF SPECIAL WASTE STUDIES. THERE ARE STILL OUTSTANDING SPECIAL WASTE ISSUES THAT MUST BE ADDRESSED. THE ENVIRONMENTAL STUDIES UNIT SHOULD BE CONTACTED AT (847) 705-4101 TO DISCUSS THESE ISSUES. TO DETERMINE THE IMPLICATIONS OF FUTURE DESIGN CHANGES, PLEASE REFER TO THE PESA REVIEW COVER MEMOS FOR ISGS *1106A, AS DEPICTED IN EXHIBIT 7 SPECIAL WASTE WAIVER IN THE CLASS OF ACTION DETERMINATION (ECAD).

ILLINOIS DEPARTMENT OF TRANSPORTATION
F.A.I. 94/90 (DAN RYAN EXPRESSWAY)
GARFIELD BLVD TO 31ST STREET (SB LOCAL LANES)

INDEX OF SHEETS AND STATE STDS

SCALE: NONE DRAWN BY: JDC
DATE: 06/09/06 CHECKED BY: RS

.A.I. SECTION

94/90 *

COLINTY

COOK

TO STA.

SHEETS NO.

588 2

BOWMAN, BARRETT & ASSOCIATES INC.
CONSULTING ENGINEERS
Chicago, Illinois
312.228.0100
www.bbandainc.com

575-588

SOIL PROFILES

GENERAL NOTES:

- 1. THE LOCATIONS OF EXISTING UTILITIES, AS SHOWN ON THE DRAWINGS, REPRESENT DATA RECEIVED FROM VARIOUS SOURCES. IT IS NOT GUARANTEED TO BE CORRECT OR ALL INCLUSIVE, THE CONTRACTOR MUST CONDUCT HIS OWN INVESTIGATIONS INTO THE LOCATION, SIZE, DEPTH, AND NATURE OF ANY AND ALL EXISTING UTILITIES WHICH MAY IMPACT THE WORK UNDER THIS CONTRACT. ANY EXISTING UTILITIES WHICH ARE TO REMAIN IN SERVICE MUST BE FULLY PROTECTED BY THE CONTRACTOR AND ANY DAMAGE CAUSED BY THE CONSTRUCTION MUST BE IMMEDIATELY REPAIRED AT THE CONTRACTOR'S EXPENSE TO THE SATISFACTION OF THE ENGINEER, THE CONTRACTOR WILL BE RESPONSIBLE FOR THE PROTECTION OF ANY AND ALL SURFACE AND UNDERGROUND UTILITIES, EVEN THOUGH THEY MAY NOT BE IDENTIFIED
- 2. THE CONTRACTOR MUST COORDINATE CONSTRUCTION ACTIVITIES WITH THE RESPECTIVE UTILITIES OF THE CITY OF CHICAGO, BEFORE STARTING ANY EXCAVATION, THE CONTRACTOR MUST CALL THE CHICAGO UTILITY ALERT NETWORK (C.U.A.N.) AT (312) 744-7000 FOR FIELD LOCATIONS OF BURIED ELECTRICAL, TELEPHONE, CABLE, AND GAS FACILITIES (48 HOURS NOTIFICATION IS REQUIRED). THE CONTRACTOR MUST CONTACT THE CITY OF CHICAGO DEPARTMENT OF WATER MANAGEMENT, PERMIT SECTION AT (312) 747-7893 FOR WATER AND CITY SEWER LOCATIONS.
- 10 FOOT TRANSITION LENGTHS MUST BE USED TO MATCH PROPOSED CURB AND GUTTER AND MEDIAN ITEMS OF WORK TO EXISTING CURBS AND GUTTERS AND MEDIANS IN THE FIELD UNLESS OTHERWISE SHOWN, THE TRANSITIONS MUST BE PAID FOR AT THE CONTRACT UNIT PRICE FOR THE PROPOSED
- 4. THE CONTRACTOR WILL NOT BE ALLOWED TO SET UP A YARD OR FIELD OFFICE ON STATE PROPERTY WITHOUT WRITTEN PERMISSION FROM IDOT.
- 5. WHEN ARTIFICIAL LIGHTING IS USED IN NIGHT OPERATIONS, THE CONTRACTOR MUST EXERCISE THE HITMOST PRECAUTIONS IN PREVENTING ADVERSE VISIBILITY TO THE MOTORING PUBLIC AND ADJOINING COMMERCIAL AND RESIDENTIAL AREAS.
- 6. ON STATE STANDARD 483001, SUBBASE GRANULAR MATERIAL, TYPE B. 24" MUST BE USED AS THE IMPROVED SUBGRADE. THE ADDITIONAL THICKNESS OF AGGREGATE SUBGRADE UNDER THE SHOULDER MUST BE INCLUDED IN THE COST PER SQ YARD OF "SUB-BASE GRANULAR MATERIAL, TYPE B, 24""
- 7. USE NO. 6 EPOXY-COATED TIE BARS CONFORMING TO ARTICLE 1006.10(B)(2) OF THE STANDARD SPECIFICATIONS FOR LONGITUDINAL SAWED JOINT AS SHOWN ON IDOT STANDARD 420001 AND FOR TYING THE CURB AND GUTTER SECTIONS TO THE MAINLINE SHOULDERS AND PAVEMENT AS SHOWN ON THE PLANS. THE TIE BARS WILL NOT BE PAID FOR SEPARATELY. TIE BARS USED FOR LONGITUDINAL CONSTRUCTION JOINTS MUST BE INCLUDED IN THE COST OF CONT REINFORCED PCC PAVFMENT. 14". TIE BARS USED WITH CURB AND GUTTER MUST BE INCLUDED IN THE COST OF THE COMBINATION CONCRETE CURB AND GUTTER OF THE TYPE SPECIFIED
- 8. USE NO. 8 EPOXY-COATED TIE BARS IN LIEU OF NO. 6 BARS, CONFORMING TO ARTICLE 1006.10(B)(2) OF THE STANDARD SPECIFICATIONS FOR LONGITUDINAL CONSTRUCTION JOINT AS SHOWN ON IDOT STANDARD 420001 AND FOR TYING SHOULDER SECTIONS TO THE MAINLINE PAVEMENT AND FOR TYING PCC CONCRETE WIDENING TO EXISTING CONCRETE PAVEMENT AND FOR TYING RAMP PAVEMENT TO EXISTING FRONTAGE ROAD CONCRETE BASE COURSE, AS SHOWN ON THE PLANS, TIE BARS USED FOR LONGITUDINAL CONSTRUCTION JOINTS MUST BE INCLUDED IN THE COST OF CONT REINFORCED PCC PAVEMENT, 14". TIE BARS USED WITH THE SHOULDERS MUST BE INCLUDED IN THE COST OF PCC HOULDERS, 14". ALL OTHER TIE BARS MUST BE INCLUDED IN THE COST OF PCC BASE COURSE, 9".
- 9. WHEN MILLED PAVEMENT IS OPEN TO TRAFFIC, THE MAXIMUM GRADE DIFFERENTIAL BETWEEN PASSES OF THE MILLING MACHINE MUST NOT EXCEED 11/2 INCHES WHERE THE SPEED LIMIT IS 45 MPH OR LESS AND 1 INCH WHERE THE SPEED LIMIT IS GREATER THAN 45 MPH. WITH WRITTEN APPROVAL FROM THE ENGINEER, A MAXIMUM GRADE DIFFERENTIAL OF 3 INCHES MAY BE ALLOWED IF THE EDGE OF THE MILLING IS SLOPED A MINIMUM 3:1 (H:V).
- 10. CHAIN LINK FENCE REMOVAL MUST BE CONSIDERED AS PART OF CLEARING.
- 11. THE VARIATION IN WIDTH OF THE COMBINATION CONCRETE CURB AND GUTTER AS SHOWN ON THE PLANS MUST BE INCLUDED IN THE COST OF COMBINATION CONCRETE CURB AND GUTTER OF THE
- 12. COMBINATION CURB AND GUTTER REMOVAL WILL BE MEASURED PER LINEAU FOOT. THE REMOVAL OF THE EXISTING BITUMINOUS OVERLAY OF THE GUTTER WILL NOT BE MEASURED FOR PAYMENT BUT IS INCLUDED THE CONTRACT UNIT PRICE FOR COMBINATION CURB AND GUTTER REMOVAL.
- 13. IT MUST BE THE CONTRACTOR'S RESPONSIBILITY TO ENSURE THAT NO GAP REMAINS BETWEEN PROPOSED FENCING OR WHERE PROPOSED FENCING TERMINATES AND EXISTING FENCE REMAINS IN PLACE.
- 14. THE CONTRACTOR MUST TAKE ALL NECESSARY SAFETY PRECAUTIONS TO PROTECT AND PROVIDE ACCESS TO ABUTTING PROPERTY, UTILITIES, PEDESTRIANS, AND VEHICULAR TRAFFIC.
- 15. WHERE SECTION OR SUBSECTION MONUMENTS ARE ENCOUNTERED, THE ENGINEER MUST BE NOTIFIED BEFORE SUCH MONUMENTS ARE REMOVED. THE CONTRACTOR MUST PROTECT AND CAREFULLY PRESERVE ALL PROPERTY MARKS AND MONUMENTS. THE ENGINEER OR AN AUTHORIZED SURVEYOR AGENT WILL WITNESS OR OTHERWISE REFERENCE AND RESET MONUMENTS AS NECESSARY. ALL PROPERTY CORNERS EXCEPT THOSE WITHIN AREAS WHERE THE SCHEDULE, IF PROVIDED, SHOWS PLACEMENT OF R.O.W. MARKERS MUST REMAIN UNDISTURBED.
- 16. ALL ELEVATIONS IN THIS PLAN SET ARE BASED ON THE CHICAGO CITY DATUM. THE CONVERSION EQUATION FROM CCD TO NAVD 88 IS: NAVD 88 ELEVATION = CCD + 579.19.

- 17. BARRICADES: THE CONTRACTOR MUST PROVIDE AND INSTALL TWO WEIGHTED SANDBAGS ON EACH TYPE I OR TYPE II BARRICADE LISED - ONE WEIGHTED SANDRAG ACROSS EACH BOTTOM RAIL. ALL TYPE III BARRICADES REQUIRE A MINIMUM OF FOUR SANDBAGS PER BARRICADE.
- 18. BUTT JOINTS WILL BE INSTALLED AT THE ENDS OF ALL RESURFACING (WHERE RESURFACING MEETS EXISTING PAVEMENT), IN ACCORDANCE WITH THE IDOT DISTRICT 1 "BUTT JOINT AND BITUMINOUS TAPER DETAILS" SHEET INCLUDED IN THE PLANS, UNLESS OTHERWISE SPECIFIED.
- 19 THE UNIT WEIGHT USED FOR ALL BITUMINOUS SURFACE MIXTURES IS 112 LB/SQ YD/IN.
- 20. THE QUANTITY FOR BITUMINOUS MATERIALS (PRIME COAT) WAS DETERMINED USING AN APPLICATION RATE
- 21. THE QUANTITY FOR AGGREGATE (PRIME COAT) WAS DETERMINED USING AN APPLICATION RATE OF 0.002 TONS/SO YD. 3.
- 22. SUPERSTRUCTURE RATING COARSE AGGREGATE MUST BE USED IN THE CONCRETE BARRIER WALL CONCRETE MIXTURE.
- 23. LOCATIONS OF ACCESS CONTROL FENCING AS SHOWN ON THE PLANS MAY BE ADJUSTED AS DIRECTED BY THE ENGINEER TO BETTER FIT FIELD CONDITIONS.
- 24. THE LOCATION OF VARIOUS ITEMS SUCH AS PAVEMENT, BARRIER WALLS, AND DRAINAGE STRUCTURES BUILT IN CONTRACTS UNDER CONSTRUCTION DURING THE PREPARATION OF THESE PLANS IS BASED ON THE PUBLISHED. CONTRACT PLAN DRAWINGS AVAILABLE DURING DESIGN. THE CONTRACTOR MUST FIELD VERIFY LIMITS, LOCATIONS AND ELEVATIONS OF THESE PREVIOUSLY CONSTRUCTED ITEMS.
- 25, CRUSHING PLANT AND CONCRETE PLANT LOCATIONS REQUIRE CITY OF CHICAGO APPROVAL
- 26. TEMPORARY CONCRETE BARRIER THE BARRIER UNIT AT EACH END OF THE INSTALLATIONS MUST BE SECURED TO THE PAVEMENT OR SHOULDER USING THREE ANCHORING PINS FOR F SHAPE OR THREE DOWEL BARS FOR NEW JERSEY SHAPE
- 27. HAMMER DRIVING OF PILES WILL NOT BE ALLOWED. ALL PILES MUST BE VIBRATED INTO PLACE.
- 28. THE CONCRETE MEDIAN SURFACE, 6" (SPECIAL) AT GUARDRAIL LOCATIONS MUST USE THE INTEGRAL RED CONCRETE WITHOUT THE BRICK PATTERN FINISH.
- 29. THE CONTRACTOR IS ALERTED THAT THERE ARE EXISTING CTA UTILITY FACILITIES WITHIN, ADJACENT TO, AND CROSSING UNDER THE EXPRESSWAY FROM THE FRONTAGE ROADS TO THE CTA OPERATING AREA. THE EXACT LOCATION OF THESE FACILITIES IS NOT KNOWN. THE CONTRACTOR MUST CONTACT THE CTA AT 312-681-3860 FOR OCATIONS OF THESE FACILITIES BEFORE PROCEEDING WITH ANY WORK WITHIN OR ADJACENT TO THE CTA OPERATING AREA.
- 30. THE CONTRACTOR MUST USE CARE IN GRADING OR EXCAVATING NEAR ANY AND ALL EXISTING ITEMS THAT WILL NOT BE REMOVED. ANY DAMAGE DONE TO EXISTING ITEMS BY THE CONTRACTOR MUST BE REPAIRED BY THE CONTRACTOR AT THE CONTRACTOR'S OWN EXPENSE
- 31. THE CONTRACTOR MUST MAINTAIN THE SURFACE DRAINAGE OF ALL ROADWAYS DURING CONSTRUCTION OF THIS PROJECT. WHEN EXISTING DRAINAGE FACILITIES ARE DISTURBED. THE CONTRACTOR MUST PROVIDE AND MAINTAIN TEMPORARY OUTLETS AND CONNECTIONS FOR ALL PRIVATE OR PUBLIC DRAINS, SEWERS, AND CATCH BASINS. THE CONTRACTOR MUST PROVIDE FACILITIES TO TAKE IN ALL STORM WATER WHICH WILL BE RECEIVED BY THESE DRAINS AND SEWERS AND DISCHARGE THE SAME, THE CONTRACTOR MUST PROVIDE AND MAINTAIN A TEMPORARY OUTLET AND BE PREPARED AT ALL TIMES TO DISPOSE OF THE WATER RECEIVED FROM THESE TEMPORARY CONNECTIONS UNTIL INSTALLATION IS COMPLETE INCLUDING PAVEMENT. THIS WORK MUST NOT BE PAID FOR SEPERATELY BUT MUST BE CONSIDERED INCLUDED IN THE COST OF THIS CONTRACT.

F.A.I. SECTIO	N	COUN	ΙY	SHEETS	NO.
94/90 *		C00	K	588	3
STA.	TO	STA.			
FED. ROAD DIST. NO.	ILLINOIS	FED.	AID	PROJECT	

TOTAL SHEET

62303 • (2021-922 PT2 ETC 2324.6-1P) R-11

GENERAL NOTES: CITY OF CHICAGO

(CITY OF CHICAGO NOTES APPLY ONLY TO WORK ON THE WELLS STREET/WENTWORTH AVENUE FRONTAGE ROAD.)

- 1. ALL CATCH BASINS IN THE CITY OF CHICAGO MUST MEET THE DEPARTMENT OF WATER MANAGEMENT STANDARDS
- 2. SEWER SIZES 21" DIAMETER OR SMALLER MUST BE EXTRA STRENGTH VITRIFIED CLAY PIPE C-700 OR DUCTILE IRON PIPE WITH PUSH-ON OR MECHANICAL JOINTS. SEWER SIZES 24" DIAMETER OR LARGER MUST BE REINFORCED CONCRETE PIPE TYPE C-76, CLASS III, WALL "B" WITH "O-RING" JOINTS.
- A PERMIT FROM THE DEPARTMENT OF WATER MANAGEMENT IS REQUIRED IN ADVANCE FOR ANY UNDERGROUND SEWER WORK INCLUDING ADJUSTMENT OF STRUCTURES, REMOVAL/REPLACEMENT OF FRAMES AND LIDS, TELEVISION SURVEYS, CLEANING, LINING, AND INSPECTIONS. THE DEPARTMENT OF WATER MANAGEMENT PERMIT MUST BE OBTAINED BY A LICENSED SEWER DRAIN LAYER PRIOR TO START OF CONSTRUCTION. THE LICENSED SEWER CONTRACTOR/SUBCONTRACTOR MUST SUBMIT TWO SETS OF PLANS APPROVED BY THE DEPARTMENT OF WATER MANAGEMENT FOR THE ISSUE OF THE SEWER PERMIT TO 333 SOUTH STATE STREET, SUITE 410, CHICAGO, IL 60604. INSPECTION WILL BE PROVIDED BY THE DEPARTMENTOF WATER MANAGEMENT.
- 4. IF THE SEWER PIPE COVER IS REDUCED TO LESS THAN 3 FEET, CONCRETE ENCASEMENT OF THE SEWER OR REPLACEMENT OF THE SEWER WITH CLASS 52 DUCTILE IRON PIPE WILL BE REQUIRED. THIS WORK WILL BE PAID FOR AS COMBINED SEWERS OR STORM SEWERS (WATER MAIN REQUIREMENTS) FOR THE
- 5. IN CASE OF DAMAGE TO CITY OF CHICAGO SEWERS, PRIVATE AND PUBLIC DRAINS, SEWER STRUCTURES AND/OR BENCH MONUMENTS, THE CONTRACTOR MUST IMMEDIATELY CONTACT THE DEPARTMENT OF WATER MANAGEMENT AT (312) 747-7892 OR (312) 747-7893.
- 6. BENCH MONUMENT LOCATIONS WITHIN THE LIMITS OF THE IMPROVEMENT CAN BE OBTAINED FROM THE DEPARTMENT OF WATER MANAGEMENT AT 333 SOUTH STATE STREET, SUITE 410, CHICAGO, IL 60604. THE CONTRACTOR IS RESPONSIBLE FOR THE COST OF REPLACING ANY BENCH MONUMENT DAMAGED OR DESTROYED DURING CONSTRUCTION.
- 7. IN LOCATIONS WHERE THE MAIN SEWERS, DRAINAGE STRUCTURES, PUBLIC, AND PRIVATE DRAIN CONNECTIONS ARE DISTURBED OR DAMAGED DURING CONSTRUCTION BY THE CONTRACTOR, IT WILL BE THE CONTRACTOR'S RESPONSIBILITY TO RESTORE AND REPLACE THE DAMAGED FACILITIES AT HIS/HER OWN EXPENSE TO THE SATISFACTION OF THE DEPARTMENT OF WATER MANAGEMENT. THE SEWER FLOWS MUST BE MAINTAINED AT ALL TIMES.
- 8. EXTREME CAUTION IS TO BE TAKEN TO ENSURE THAT NO FACILITY OWNED AND MAINTAINED BY THE DEPARTMENT OF WATER MANAGEMENT IS DAMAGED DURING CONSTRUCTION. IF ANY DAMAGE OCCURS TO ANY FACILITIES, THE CONTRACTOR WILL BE HELD RESPONSIBLE FOR THE COST OF REPAIRING
- 9. CLOSED LIDS MUST BE PLACED ON ALL MANHOLES EXCEPT AT INTERSECTIONS. PERFORATED LIDS MUST BE PLACED ON ALL CATCH BASINS.
- 10. ALL BROKEN, CRACKED, WORN OR OTHERWISE DAMAGED OR BICYCLE UNSAFE FRAMES AND GRATES OR LIDS ON SEWER STRUCTURES MUST BE REPLACED WITH NEW DEPARTMENT OF WATER MANAGEMENT STANDARD FRAMES AND GRATES OR LIDS. OLD FRAMES AND GRATES OR LIDS MUST BE DELIVERED TO THE DEPARTMENT OF WATER MANAGEMENT AT 39TH STREET AND ASHLAND AVENUE.
- 11. CITY OF CHICAGO WATER VALVE VAULTS AND SEWER STRUCTURES MUST NOT BE CLOSED, COVERED OR OTHERWISE OBSTRUCTED DURING CONSTRUCTION WITHOUT WRITTEN PERMISSION FROM THE CITY OF CHICAGO DEPARTMENT OF WATER MANAGEMENT.
- 12. CURB AND GUTTER CONSTRUCTION MUST PROVIDE A MINIMUM CURB HEIGHT OF 3".
- 13. PAVEMENT REPLACEMENT AROUND FRAMES AND GRATES OR LIDS WHERE DRAINAGE, WATER MAIN OR ELECTRICAL STRUCTURES ARE ADJUSTED OR RECONSTRUCTED, MUST BE WITH CLASS SI CONCRETE.
- 14. THE CHICAGO TRANSIT AUTHORITY (CTA) HAS BUS OPERATIONS ALONG WENTWORTH AVENUE / WELLS STREET. THE CONTRACTOR MUST INFORM THE CTA REPRESENTATIVE MARVIN A. WATSON (GENERAL MANAGER CONSTRUCTION) OF THE ON-GOING PROJECT SCHEDULE STARTING 28 DAYS BEFORE THE START OF CONSTRUCTION AT (312) 733-7000 EXTENSION 7008.
- 15. ALL SEWER CONNECTIONS WITH PIPES 21" DIAMETER AND SMALLER MUST BE MADE WITH PRECAST "TEE" OR "WYE" PIPES. PRECAST "TEE" AND "WYE" PIPE CONNECTIONS FOR PROPOSED SEWER WILL NOT BE PAID FOR SEPARATELY, BUT WILL BE INCLUDED IN THE COST FOR THE SEWERS. FOR PROPOSED SEWER PIPES LARGER THAN 21" DIAMETER, OPENINGS OF THE SPECIFIED DIAMETER MUST BE MADE IN THE PIPE AT THE TIME IT IS MANUFACTURED, FOR EXISTING SEWERS LARGER THAN 21". CONNECTIONS MUST BE CORE DRILLED.

REVISION NAME	S DATE	ILLINOIS DE				
		F.A.I. 94/90	(DAN	RYAN	EXPRES	SSWAY)
		GARFIELD BLVD	TO 31ST	STREET	(SB LOCAL	. LANES)
		GE	NERAL	NOTE	s	
		SCALE: NONE			DRAWN BY:	JDC

DATE: 06/09/06

DRAWN BY: JDC

CHECKED BY: RS

BOWMAN, BARRETT & ASSOCIATES INC. F CONSULTING ENGINEERS Chicago, Illinois 312.228.0100

Task Name CONTRACT 52303 START CONTRACT 62303 RETAINING WALL S-475-F/S-455-F PUBLIC NOTIFICATION START CONTRACT 62303 PRESTAGE EROSION CONTROL FABRICATE, DELIVER & ERECT OVERHEAD SIGN STRUCTURES ELECTRICAL COORDINATION TEMPORARY PAVEMENT MARKINGS TEMPORARY BARRIER WALL SHIFT TRAFFIC TO STAGE 1 CONTRACT 62303 47TH TO 31ST STAGE 1 RETAINING WALL S-39S-R EROSION CONTROL PAVEMENT REMOVAL STORM SEWER EARTH EXCAVATION SUBBASE GRANULAR MATERIAL TYPE B 24" STARK IZED SURBASE 6" CONTINUOUSLY REINFORCED PCC PAVEMENT 14" PCC SHOULDERS 14" BARRIER WALLIGUARORAL FLECTRICAL TOPSOIL AND SEEDING FEMPORARY PAVEMENT MARKINGS SHIFT TRAFFIC TO STAGE 2 OPEN SB SLIP RAMP A CONTRACT 82303 STA 2475+50 TO 3529+00 W/O GAPS (stages 1.2.1) PAVEMENT REMOVAL EARTH RETENTION SYSTEM STORM SEWERS EARTH EXCAVATION SUBBASE GRANULAR MATERIAL TYPE B 24° ELECTRICAL DUCTBANKS UNDERDRAINS STABILIZED SUBBASE 6" CONTINUOUSLY REINFORCED PCC PVMT 14" PCC SHOULDERS 14" CURB AND GUTTER BARRIER WALL SIGN FOUNDATIONS BARRIER WALL TRANSITIONS CONCRETE MEDIAN TOPSOIL PLACEMENT SEEDING BLANKET CONTRACT 52503 47TH TO 31ST STAGE 2 RETAINING WALL 5-43N-F EROSION CONTROL PAVEMENT REMOVAL STORM SEWER UNDERDRAMS EARTH EXCAVATION SUBBASE GRANULAR MATERIAL TYPE B 24" STABILIZEO SUBBASE 6" CONTINUOUSLY REINFORCED PCC PAVEMENT 14* PCC SHOULDERS 14" BARRIER WALLIGUARDRAIL 58 ELECTRICAL 59 TOPSOIL AND SEEDING 60 TEMPORARY PAVEMENT MARKING START STAGE 3 & 3A OPEN RAMP 55D TO TRAFFICICLOSE RAMPS 470 & SSAIREROUTE SLIP RAMP A CONTRACT \$2303 STA 3486+20 TO 3604+90 & 3511+60 TO 3518+90 Stages (3&3A) 63 PAVEMENT REMOVAL 64 STORM SEWERS 65 Rolled Up Split ****** Project: DANRYAN19&19A REV3 Date: Fri 6/2/06 Rolled Up Milestone External Tasks External Milestone Rolled Up Task

REVISIONS

ILLINOIS DEPARTMENT OF TRANSPORTATION
F.A.I. 90/94 (DAN RYAN EXPRESSWAY)


GARFIELD BLVD TO 3IST STREET (SB LOCAL LANES)

SUGGESTED SEQUENCE OF OPERATION

SCALE: NONE
DATE: June 9, 2006

DRAWN 8Y: NJH CHECKED 8Y: RMG

CTE AECOM

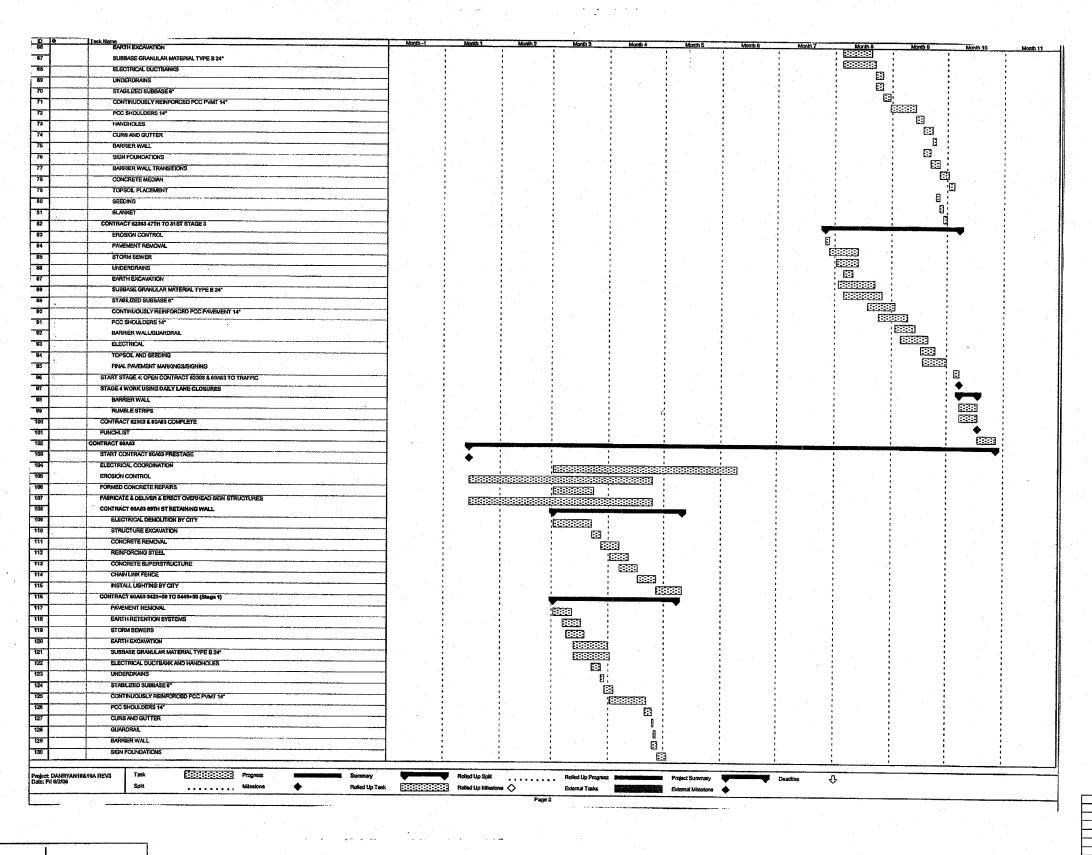


ILLINOIS DEPARTMENT OF TRANSPORTATION
F.A.I. 90/94 (DAN RYAN EXPRESSWAY)
GARFIELD BLVD TO 31ST STREET (SB LOCAL LANES)

SUGGESTED SEQUENCE OF OPERATION

SCALE: NONE
DATE: June 9, 2006

DRAWN BY: NJH CHECKED BY: RMG

CTE | AECOM

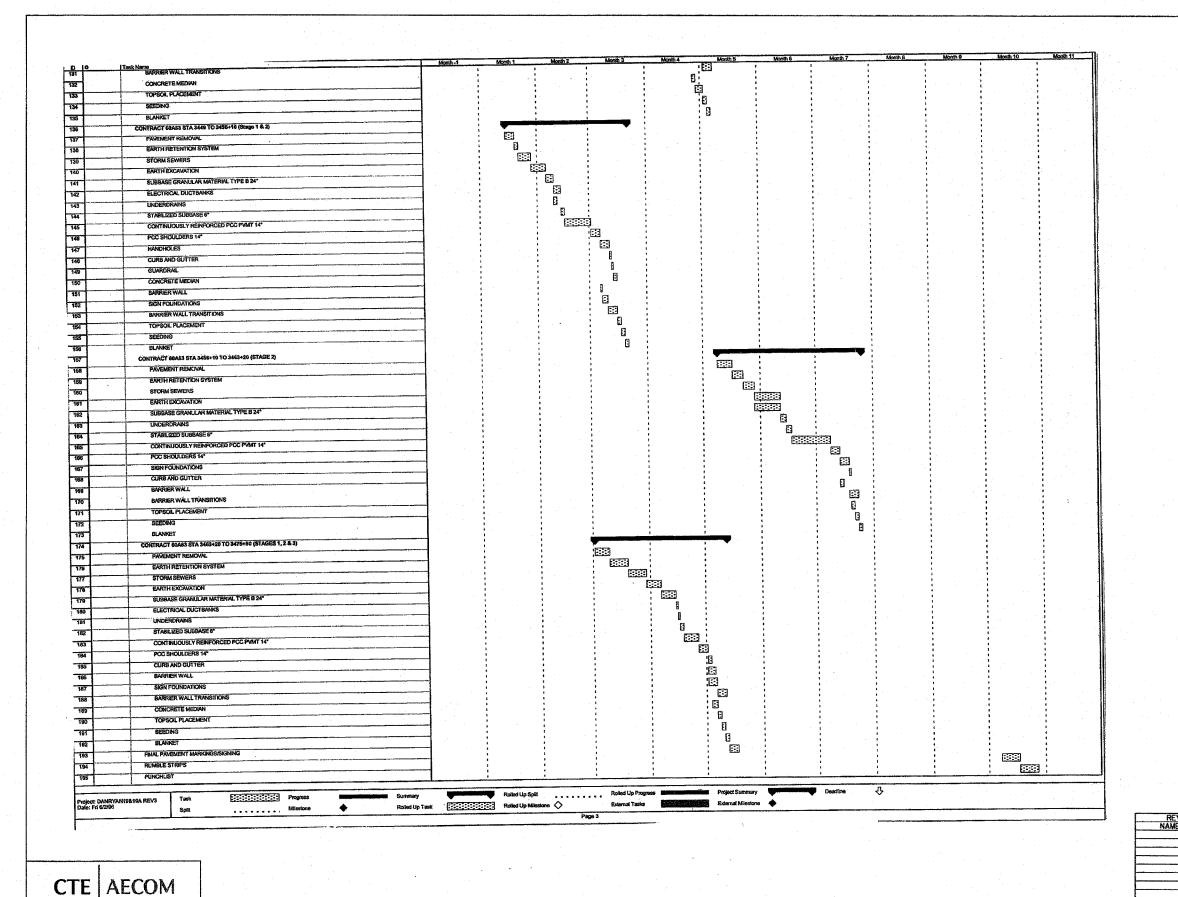

| Feb. ROAD DIST. NO. 1 | ILLINOIS | FED. AID | PROJECT | RO. 1 | RO.

CS-3

ILLINDIS DEPARTMENT OF TRANSPORTATION
F.A.I. 90/94 (DAN RYAN EXPRESSWAY)

GARFIELD BLVD TO 3LST STREET (SB LOCAL LANES)

SUGGESTED SEQUENCE OF OPERATION

SCALE: NONE I

DRAWN BY: NUH CHECKED BY: RMG

				URBAN	ROADWAY	ROADWAY		NG WALLS	MWRD		1	T	
	CODE	TITLI DECODIDITION	UNIT	TOTAL	IDOT	CDOT	69TH SW	39TH-47TH	CULVERT	SIGNING	SAFETY	LIGHTING	SURVEILLANCE
	UMBER	ITEM DESCRIPTION		QUANTITY	J000	J000 (Y007	Y007	X028-2A	Y002-1C	SFTY-3N	Y030-1E	Y032-1F
201	00110	TREE REMOVAL (6 TO 15 UNITS DIAMETER)	UNIT	764	764								
201	00210	TREE REMOVAL (OVER 15 UNITS DIAMETER)	UNIT	774	774		**			***************************************	*****************		
201	01000	TEMPORARY FENCE	FOOT	35	35				······				
202	200100	EARTH EXCAVATION	CU YD	110,547	110,547								<
				4									
202	200410	EARTH EXCAVATION (SPECIAL)	CU YD	2439	2439								
202	201200	REMOVAL AND DISPOSAL OF UNSUITABLE MATERIAL	CU YD	10,252	10,252						ļ		
207	700400	POROUS GRANULAR EMBANKMENT, SPECIAL	CU YD	75			14	56				5	
207	700420	POROUS GRANULAR EMBANKMENT, SUBGRADE	CU YD	1,500	1,500				•••••				
		1 01000 OTHER EMPARTMENT SOUTHE		1,000	1,000				•••••		ł		
208	300150	TRENCH BACKFILL	CU YD	3234	3234								
209	300110	POROUS GRANULAR BACKFILL	CU YD	844	844				•••••				
	,,,,,,,,,,,,,,,,,,,,,,,,,,,,,,,,,,,,,,,	1 01000 OTHITCEAN BACK ZEE					********************				†		
210	01000	GEOTECHNICAL FABRIC FOR GROUND STABILIZATION	SQ YD	119,406	119,406								
211	01615	TOPSOIL FURNISH AND PLACE, 4"	SQ YD	29,672	29,672							-	
	01015	TO SOLE TO MIST AND TEASE, Y		23,012	23,012								
211	01645	TOPSOIL FURNISH AND PLACE, 12"	SQ YD	34,170	34,170				·				
211	01825	COMPOST FURNISH AND PLACE, 6"	SQ YD	34,170	34,170								
1		Ovini OUT Fairwast AND FEASE, O	54 15	3 1,110	0 1,110						***************************************		
250	000210	SEEDING, CLASS 2A	ACRE	10.0	10. 0								
× \ 250	000400	NITROGEN FERTILIZER NUTRIENT	POUND	1,187	1,187						ļ		
1	,,,,,,,,,,,,,,,,,,,,,,,,,,,,,,,,,,,,,,,	NATIONALIA TERMINISTER INDIVIDENT	1 0010	1,101	1,101								
250	00500	PHOSPHORUS FERTILIZER NUTRIENT	POUND	1,185	1,185								
250		POTASSIUM FERTILIZER NUTRIENT	POUND	1,185	1,185				***************************************				
1	200000	TOTASSION TENTILIZEN NOTHERN	1 00110	1,163	1,100								
250	000750	MOWING	ACRE	/3.8	/3.8								
250	001800	SEEDING, CLASS 4 (MODIFIED)	ACRE	3. 2 .	3. 2								
1		SCEEDINGS SERVICE TO MODEL FEB.	AOIL										
.251	00630	EROSION CONTROL BLANKET	SQ YD	63,842	63,842								
250	200200	SUPPLEMENTAL WATERING	UNIT	1,534	1,534						•••••••		
1		oor remarke with ending		1,001	1,551								
. 280	000250	TEMPORARY EROSION CONTROL SEEDING	POUND	30,484	30,484								
280	000510	INLET FILTERS	EACH	408	408								
		20021 121010	EAGI	1	100				*******************				
311	01810	SUB-BASE GRANULAR MATERIAL, TYPE B 12"	54 YD	80,641	80,641								
311	01860	SUB-BASE GRANULAR MATERIAL, TYPE B 24"	SQ YD	39,765	39,765							 	
311		335 2.35 STATES THE BEST TO BE SET	54 10	1 .,,,,,,,,									
312	00100	STABILIZED SUB-BASE 4"	SQ YD	8,390	8,390								
353	300410	PORTLAND CEMENT CONCRETE BASE COURSE 9 1/2"	SQ YD	4,265	4,265								
		TOTAL SERVICE CONTROL TO BASE SOCIAL STA	34 10	7,203	TIEUU								
406	600200	BITUMINOUS MATERIALS (PRIME COAT)	TON	211	211								PEVISIONS

90% FEDERAL / 10%STATE

F.A.I. SECTION COUNTY TOTAL SHEET NO. 94/90 * COOK 588 TO STA. FED. ROAD DIST. NO. ILLINOIS FED. AID PROJECT

62303 • (2021-922 PT2 ETC 2324.6-1P) R-11

S0Q-01 ILLINOIS DEPARTMENT OF TRANSPORTATION F.A.I. 94/90 (DAN RYAN EXPRESSWAY) GARFIELD BLVD TO 31ST STREET (SB LOCAL LANES) SUMMARY OF QUANTITIES

DATE: 06/09/06

MP = NON · PARTICIPATING

* - SPECIALTY ITEM

BOWMAN, BARRETT & ASSOCIATES INC.
CONSULTING ENGINEERS
Chicago, Illinois 131,228,01100
www.bbandainc.com

SCALE: 1"=N.T.S DRAWN BY: RGR

CHECKED BY: DDM

Rev.

						9(0% FEDERAL	/ 10%STAT	E			
CODE	ITEM DESCRIPTION	UNIT	URBAN TOTAL	ROADWAY IDOT	ROADWAY CDOT	RETAINI 69TH SW	NG WALLS 39TH-47TH	MWRD CULVERT	SIGNING Y002-1C	SAFETY SFTY-3N	LIGHTING Y030-1E	SURVEILLANCE Y032-1F
NUMBER 40600300	AGGREGATE (PRIME COAT)	TON	QUANTITY 239	J000 239	J000´	Y007	Y007	X028-2A	1002-10	3F 1 - 3 4	1030-16	1032-11
42000521	PORTLAND CEMENT CONCRETE PAVEMENT 11" (JOINTED)	. SQ YD	6,013	6,013								
42001165	BRIDGE APPROACH PAVEMENT	SQ YD	400					400				
42001300	PROTECTIVE COAT	SQ YD	131,685	131,685								
42100380	CONTINUOUSLY REINFORCED PORTLAND CEMENT CONCRETE PAVEMENT 14"	SQ YD	80,645	80,645								
4400000 8	BITUMINOUS SURFACE REMOVAL 2 1/2"	SQ YD	2,759	2,759								
44000009	BITUMINOUS SURFACE REMOVAL 3"	SQ YD	1,134	1,134								
44000030	BITUMINOUS SURFACE REMOVAL (VARIABLE DEPTH)	SQ YD	38					38				
44000100	PAVEMENT REMOVAL	SQ YD	107,871	107,871								
44000500	COMBINATION CURB AND GUTTER REMOVAL	FOOT	32,686	32,686								
44000700	APPROACH SLAB REMOVAL	SQ YD	164					164				
44001980	CONCRETE BARRIER REMOVAL	FOOT	431	431								
44003100	MEDIAN REMOVAL	SQ FT	14,841	14,841								
44004250	PAVED SHOULDER REMOVAL	SQ YD	4,851	4,851								
48300600	PORTLAND CEMENT CONCRETE SHOULDERS 11"	SQ YD	394	394								•
50100300	REMOVAL OF EXISTING STRUCTURES NO. 1	EACH	1			1						
50100400	REMOVAL OF EXISTING STRUCTURES NO. 2	EACH	1				1					
50102400	CONCRETE REMOVAL	CU YD	88			42	46					
50200100	STRUCTURE EXCAVATION	CU YD	620			233	326	4			257	
* 50200400	ROCK EXCAVATION FOR STRUCTURES	CUYD	157	157		*************************						
50300225	CONCRETE STRUCTURES	CU YD	629,9	30		335	198.9				66	
50300255	CONCRETE SUPERSTRUCTURE	CU YD	369.6			133	147.6	89				
50300260	BRIDGE DECK GROOVING	SQ YD	142					142				
50300300	PROTECTIVE COAT	SQ YD	2.723			1,329	806	253			335	-
50300510	RUSTICATION FINISH	SQ FT	12,870			9,160	3,18 9				521	-
50500505	STUD SHEAR CONNECTORS	EACH	2,778			2,074	704					
\$ 50700209	UNTREATED TIMBER LAGGING	SQ FT	9,342			6,576	2,766				-	-
50700215	FURNISHING SOLDIER PILES (W SECTION)	FOOT	5,8 21			3,53€	2 , 28 5					-
50800205	REINFORCEMENT BARS, EPOXY COATED	POUND	149,040	5,000		64,550	55,960	15,780			7,750	

F.A.I. SECTIO	COUNTY	TOTAL SHEETS	SHEET NO.
94/90 •	COOK	588	8
STA.	TO STA.		
FED. ROAD DIST. NO.	ILLINOIS FED. AII	D PROJECT	

62303 • (2021-922 PT2 ETC 2324.6-1P) R-11

S0Q-02 REVISIONS DATE ILLINOIS DEPARTMENT OF TRANSPORTATION F.A.I. 94/90 (DAN RYAN EXPRESSWAY) ₹ GARFIELD BLVD TO 31ST STREET (SB LOCAL LANES)

SUMMARY OF QUANTITIES

SCALE: 1"=N.T.S DATE: 06/09/06

Rev.

DRAWN BY: RGR CHECKED BY: DDM

BOWMAN, BARRETT & ASSOCIATES INC.
CONSULTING ENGINEERS
Chicago, Illinois
312,228,0100
www.bbandainc.com

* - SPECIALTY ITEM

					***************************************	9	0% FEDERAL	/ 10%STA	TE.			
0005		T	URBAN	ROADWAY	ROADWAY	RETAIN	ING WALLS	MWRD	SIGNING	SAFETY	LIGHTING	SURVEILLANCE
CODE NUMBER	ITEM DESCRIPTION	UNIT	TOTAL QUANTITY	IDOT JOOO	CDOT JOOO,	69TH SW Y007	39TH-47TH Y007	CULVERT X028-2A	Y002-1C	SFTY-3N	Y030-1E	Y032-1F
550A0340	STORM SEWERS, CLASS A, TYPE 2 12"	FOOT	8,878	8,978								
550A0360	STORM SEWERS, CLASS A, TYPE 2 15"	FOOT	181	181							ļ	
												•
550A0380	STORM SEWERS, CLASS A, TYPE 2 18"	FOOT	81	81							ļ	
55100300	STORM SEWER REMOVAL 8"	FOOT	46	46								
55100400	STORM SEWER REMOVAL 10"	FOOT	3,286	3,286	• • • • • • • • • • • • • • • • • • • •							
55100500	STORM SEWER REMOVAL 12"	FOOT	2,805	2,805							 	
55100700	STORM SEWER REMOVAL 15"	FOOT	834	834							ļ	
55100900	STORM SEWER REMOVAL 18"	FOOT	443	443								
55404000	COOL COURT PRODUCT AND				***************************************							
55101200	STORM SEWER REMOVAL 24"	FOOT	56	56	***************************************							
58600100	SAND BACKFILL	CU YD	870	870								
59100100	GEOCOMPOSITE WALL DRAIN		741									
29100100	GEUCOMPUSITE WALL DRAIN	SQ YD	741		•••••	512	22 9					
60107700	PIPE_UNDERDRAINS_6"	FOOT	21,086	21,086								
60108000	PIPE UNDERDRAINS 12"	5007	+ 7/1	1 7/1				ļ				
60108000	FIFE UNDERDRAINS 12	FOOT	1,361	1,361								
60108200	PIPE UNDERDRAINS 6" (SPECIAL)	F00T	920	920							********************	
60109580	PIPE UNDERDRAINS FOR STRUCTURES 4"	FOOT	1,640		***************************************	720	920					
00103000	TILE UNDERDINARIO FOR STRUCTURES 4	F 001	1,040		***************************************	120	32.0				,	
60200105	CATCH BASINS, TYPE A, 4′-DIAMETER, TYPE 1 FRAME, OPEN LID	EACH	13	13								
60200805	CATCH BASINS, TYPE A, 4'-DIAMETER, TYPE 8 GRATE	EACH	14	14								
		LAUI		* '								
60201310	CATCH BASINS, TYPE A, 4'-DIAMETER, TYPE 20 FRAME AND GRATE	EACH	176	176								
60201340	CATCH BASINS, TYPE A, 4'-DIAMETER, TYPE 24 FRAME AND GRATE	EACH	11	11								
60208210	CATCH BASINS, TYPE C, TYPE 20 FRAME AND GRATE	EACH	10	10							•••••	
60218400	MANHOLES, TYPE A, 4'-DIAMETER, TYPE 1 FRAME, CLOSED LID	EACH	7	7								
60250400	CATCH BASINS TO BE ADJUSTED WITH NEW TYPE 1 FRAME, OPEN LID	EACH	Ч	4							••••••	
60251710	CATCH BASINS TO BE ADJUSTED WITH NEW TYPE 20 FRAME AND GRATE	EACH	7	7								
	Α		12.	16-								
60255800	MANHOLES TO BE ADJUSTED WITH NEW TYPE 1 FRAME, CLOSED LID	EACH	16	!6								
60258200	MANHOLES TO BE RECONSTRUCTED WITH NEW TYPE 1 FRAME, CLOSED LID	EACH	2	2								
60300105	FRAMES AND GRATES TO BE ADJUSTED	FACU	E7		·····		ļ	<u> </u>				
00300103	FRANCES AND GRATES TO DE ADJUSTEU	EACH	57	57				-		-		-
60500040	REMOVING MANHOLES	EACH	13	13				İ			1	
60500050	REMOVING CATCH BASINS	EAGU	129	129								
00300030	REMOVING GATUII DAGING	EACH	123	172								
60500060	REMOVING INLETS	EACH	91	91				<u></u>		<u> </u>		L

F.A.I	SECTION		COUNTY	TOTAL. SHEETS	SHEET NO.	ngp.li
94/90	*		COOK	588	9	8
STA.		TO	STA.			55
FED. R	OAD DIST, NO. IL	LINOIS	FED. AID	PROJECT		ဖြွ

FED. ROAD DIST. NO. | ILLINOIS | FED. AID PROJECT

62303 • (2021-922 PT2 ETC 2324.6-1P) R-11

ILLINOIS DEPARTMENT OF TRANSPORTATION F.A.I. 94/90 (DAN RYAN EXPRESSWAY) & GARFIELD BLVD TO 31ST STREET (SB LOCAL LANES)

SUMMARY OF QUANTITIES

SCALE: 1"=N.T.S

DRAWN BY: RGR CHECKED BY: DDM

• - SPECIALTY ITEM

BOWMAN, BARRETT & ASSOCIATES INC.

CONSULTING ENGINEERS
Chicago, Illinois
312.228.0100
www.bbandainc.com

Rev.

							9(0% FEDERAL	/ 10%STAT	E			
	CODE			URBAN TOTAL	ROADWAY IDOT	ROADWAY CDOT		NG WALLS	MWRD	SIGNING	SAFETY	LIGHTING	SURVEILLANCE
	NUMBER	ITEM DESCRIPTION	UNIT	QUANTITY	J000	J000:	69TH SW YOO7	39TH-47TH Y007	CULVERT X020: 2A	Y002-1C	SFTY-3N	Y030-1E	Y032-1F
	60500105	FILLING MANHOLES	EACH	2	2								
	60500205	FILLING CATCH BASINS	EACH	47	47								
	60602800	CONCRETE GUTTER, TYPE B	FOOT	3,445	3,445								
	60603800	COMBINATION CONCRETE CURB AND GUTTER, TYPE B-6.12	FOOT	1,801	1,801								
	60608521	COMBINATION CONCRETE CURB AND GUTTER, TYPE M-2.24	FOOT	1,186	1,186								
	60618324	CONCRETE MEDIAN SURFACE, 6 INCH (SPECIAL)	SQ FT	18,805	18,805								
*	63000000	STEEL PLATE BEAM GUARD RAIL, TYPE A	FOOT	988							988		
	63100045	TRAFFIC BARRIER TERMINAL, TYPE 2	EACH	1	Thems.							• • • • • • • • • • • • • • • • • • • •	
¥	63100045	TRAFFIC BARRIER TERMINAL, TYPE 2	EACH	1	1								
*	63100085	TRAFFIC BARRIER TERMINAL, TYPE 6	EACH	6	6								
*	63100167	TRAFFIC BARRIER TERMINAL, TYPE 1, SPECIAL (TANGENT)	EACH	8	8								
	63200310	GUARDRAIL REMOVAL	FOOT	1,749	1,749								
	63700805	CONCRETE BARRIER TRANSITION		10'34	1034				***************************************				
	03100003	CONONETE DANIGER TRANSPITON	FOOT	10.54	1034								
	64200105	SHOULDER RUMBLE STRIP	FOOT	60,655	60,655								
	66400550	CHAIN LINK FENCE, 4' (SPECIAL)	FOOT	1,781	1,781								
	67100100	MOBILIZATION -	L SUM	1	1								
	70300240	TEMPORARY PAVEMENT MARKING - LINE 6"	FOOT	28,250	25,160	3,090							
	70300510	PAVEMENT MARKING TAPE, TYPE III - LETTERS AND SYMBOLS	SQ FT	580	364	216							
	70300520	PAVEMENT MARKING TAPE, TYPE III 4"	FOOT	79,867	68,907	10,960							
	70300530	PAVEMENT MARKING TAPE, TYPE III 5"	FOOT	14,613	10,612	4,001							
	70300550	PAVEMENT MARKING TAPE, TYPE III 8"	FOOT	35,530	31,571	3,959							
	70300560	PAVEMENT MARKING TAPE, TYPE III 12"	FOOT	4,303	4,126	177							
	70301000	WORK ZONE PAVEMENT MARKING REMOVAL	SQ FT	63,998	46,249	17,749							
	70400100	TEMPORARY CONCRETE BARRIER	FOOT	8,420	8,420								
	70400200	RELOCATE TEMPORARY CONCRETE BARRIER	FOOT	31,830	27,330	4,500							
	72000100	SIGN PANEL-TYPE 1	SQ FT	179	0					179			
	72000200	SIGN PANEL-TYPE 2	SQ FT	280	0					280			
				1						200			
*	72000300	SIGN PANEL - TYPE 3	SQ FT	7,098						7,098			

F.A.I. SECTION COUNTY TOTAL SHEET NO. 94/90 • COOK 588 10 TO STA. FED. ROAD DIST, NO. ILLINOIS FED. AID PROJECT 62303 • (2021-922 PT2 ETC 2324.6-1P) R-11

S0Q-04 ILLINOIS DEPARTMENT OF TRANSPORTATION F.A.I. 94/90 (DAN RYAN EXPRESSWAY) GARFIELD BLVD TO 31ST STREET (SB LOCAL LANES) SUMMARY OF QUANTITIES

DATE: 06/09/06

BOWMAN, BARRETT & ASSOCIATES INC.

CONSULTING ENGINEERS
Chicago, Illilnois
312.228.0100
www.bbandainc.com

* 72400200 REMOVE SIGN PANEL ASSEMBLY-TYPE B

* - SPECIALTY ITEM

DRAWN BY: RGR CHECKED BY: DDM

					<u></u>	1		/ 10%STAT	t		Т	
CODE			TOTAL	ROADWAY	ROADWAY CDOT	RETAINI 69TH SW	NG WALLS 39TH-47TH	MWRD CULVERT	SIGNING	SAFETY	LIGHTING	SURVEILLANCE
NUMBER	ITEM DESCRIPTION	UNIT	QUANTITY	J000	J0001	Y007	Y007	X028-24	Y002-1C	SFTY-3N	Y030-1E	Y032-1F
72400330	REMOVE SIGN PANEL - TYPE 3	SQ FT	1,922						1,922			
72700100	STRUCTURAL STEEL SIGN SUPPORT - BREAKAWAY	POUND	652						652			
72800100	TELESCOPING STEEL SIGN SUPPORT	FOOT	96						96			
70000000												
72900200	METAL POST - TYPE B	FOOT	160				************		160			
73000100	WOOD SIGN SUPPORT	FOOT	874						874			
73000105	WOOD SIGN SUPPORT, SPECIAL	FOOT	17									17
73100100	BASE FOR TELESCOPING STEEL SIGN SUPPORT	EACH	10						10		ļ	
		Laci										
73300100	OVERHEAD SIGN STRUCTURE - SPAN, TYPE I-A (4'-0" X 4'-6")	FOOT	448						448			
73300200	OVERHEAD SIGN STRUCTURE - SPAN, TYPE II-A (4'-6" X 5'-3")	F00T	173	***************************************					173			
73300300	OVERHEAD SIGN STRUCTURE - SPAN, TYPE III-A (5'-0" X 7'-0")	FOOT	133						133			
73302190	OVERHEAD SIGN STRUCTURE - CANTILEVER, TYPE III-C-A (24" X 7'-0")						•					
13302130	OVERHEAD SIGN STRUCTURE - CANTILEVER, TYPE III-C-A (24" X ('-0")	FOOT	26						26			
73304000	OVERHEAD SIGN STRUCTURE - BRIDGE MOUNTED	FOOT	104						104			
73305000	OVERHEAD SIGN STRUCTURE WALKWAY	FOOT	532						532			
73400100	CONCRETE FOUNDATIONS	CU YD	1 -						1			
			1				•		1			
73400200	DRILLED SHAFT CONCRETE FOUNDATIONS	CU YD	140						140			
73600200	REMOVE OVERHEAD SIGN STRUCTURE - CANTILEVER	EACH	1						1			
73602000	REMOVE OVERHEAD SIGN STRUCTURE - BRIDGE MOUNTED	EACH	1						1			
73700100	REMOVE GROUND-MOUNTED SIGN SUPPORT		40		,							
13100100	REMOVE GROUND-MOUNTED SIGN SUPPORT	EACH	18						18			
73700200	REMOVE CONCRETE FOUNDATION - GROUND MOUNT	EACH	18						18			
73700300	REMOVE CONCRETE FOUNDATION - OVERHEAD	EACH	5						5			
78008200	POLYUREA PAVEMENT MARKING TYPE I - LETTERS & SYMBOLS	SQ FT	182	182								
78008210	POLYUREA PAVEMENT MARKING TYPE I - LINE 4"	FOOT	56,684	56,684								
78008220	POLYUREA PAVEMENT MARKING TYPE I - LINE 5"	FOOT	22,034	22,034								
78008240	POLYUREA PAVEMENT MARKING TYPE I - LINE 8"	FOOT	26,869	26,869								
70000000	DOLANDE DUELEN HOUSE THE TOTAL OF											
78008250	POLYUREA PAVEMENT MARKING TYPE I - LINE 12"	FOOT	5,739	5,739								
78008270	POLYUREA PAVEMENT MARKING TYPE I - LINE 24"	FOOT	59	59								
78100100	RAISED REFLECTIVE PAVEMENT MARKER	EACH	2,193	2,193								
78100105	RAISED REFLECTIVE PAVEMENT MARKER (BRIDGE)	EACH	4	4								
·		EACH	4	+								
78200100	MONODIRECTIONAL PRISMATIC BARRIER REFLECTOR	EACH	1,775	1,593	182	L		J				

F.A.I.	SECTION		COUNT	Υ	TOTAL SHEETS	SHEET NO.
94/90			COOK		588	11
STA.		TO	STA.			
FED. RO	AD DIST. NO. I	LLINOIS	FED.	AID	PROJECT	
623	03 • (202	1-922	PT2 E	TC 2	324.6-1F	P) R-11

S0Q-05 ILLINOIS DEPARTMENT OF TRANSPORTATION F.A.I. 94/90 (DAN RYAN EXPRESSWAY) GARFIELD BLVD TO 31ST STREET (SB LOCAL LANES) SUMMARY OF QUANTITIES

DATE: 06/09/06

DRAWN BY: RGR

CHECKED BY: DDM

BOWMAN, BARRETT & ASSOCIATES INC.
CONSULTING ENGINEERS
Chicago, Illinois
312.228.0100
www.bbandainc.com

* - SPECIALTY ITEM

					90% FEDERAL				/ 10%STAT	E			
	0.005			URBAN	ROADWAY	ROADWAY		ING WALLS	MWRD	SIGNING	SAFETY	LIGHTING	SURVEILLANCE
	CODE NUMBER	ITEM DESCRIPTION	UNIT	QUANTITY	IDOT JOOO	CDOT JOOO	69TH SW Y007	39TH-47TH Y007	CULVERT XOZO-2A	Y002-1C	SFTY-3N	Y030-1E	Y032-1F
*	78200410	GUARDRAIL MARKERS, TYPE A	EACH	21							21		
*	78200530	BARRIER WALL MARKERS, TYPE C	EACH	261	261								
			LACII					************************					
*	78201000	TERMINAL MARKER, DIRECT APPLIED	EACH	8							8		-
	78300100	PAVEMENT MARKING REMOVAL	SQ FT	32,609	17,947	14,662							
*	81000600	CONDUIT IN TRENCH, 2" DIA., GALVANIZED STEEL	F00T	2,652									2,652
*	81000800	CONDUIT IN TRENCH, 3" DIA., GALVANIZED STEEL	FOOT	389	-							99	290
u	81016600	CONDUIT IN TRENCH, 2" DIA., HIGH DENSITY POLYETHYLENE, COILABLE	5007	160						***************************************			160
*	81018800	CONDUIT IN TRENCH, 2" DIA., HIGH DENSITY POLYETHYLENE, COILABLE	FOOT	168									168
. *	81016700	CONDUIT IN TRENCH, 2 1/2" DIA., HIGH DENSITY POLYETHYLENE, COILABLE	FOOT	6									6
*	81017000	CONDUIT IN TRENCH, 4" DIA., HIGH DENSITY POLYETHYLENE, COILABLE	FOQT	374			,			*****			374
*	81023750	CONDUIT ENCASED, CONCRETE, 3" DIA., PVC	FOOT	449									449
*	81200120	CONDUIT EMBEDDED IN STRUCTURE, 2" DIA., GALVANIZED STEEL	FOOT	20	·								20
	01400000	JEANY DIEV (IAIRING E											
*	81400200	HEAVY-DUTY HANDHOLE	EACH	11									11
*	81400205	HEAVY-DUTY HANDHOLE (SPECIAL)	EACH	6						, ,			6
*	81400205	MENAX-BRIX HANDROFE (SECTAL)											
	Carrinadade	The state of the s	v-3-24(000000000000000000000000000000000000										
*	81500200	TRENCH AND BACKFILL FOR ELECTRICAL WORK	FOOT	3,979								297	3,682
	87800100	CONCRETE FOUNDATION, TYPE A	FOOT	9									9
*	87900200	DRILL EXISTING HANDHOLE	EACH	1									
٠	89502385	REMOVE EXISTING CONCRETE FOUNDATION	EACH	5								***************************************	5
•	C2000124	SHRUB, AESCULUS PARVIFLORA (BOTTLEBRUSH BUCKEYE), 2' HEIGHT, BALLED AND BURLAPPED	EACH	176	176								
×	C2C05818	SHRUB, RHUS AROMATICA GRO-LOW (GRO-LOW FRAGRANT SUMAC), 18" WIDTH, CONTAINER	EACH	63	63								
*	E20200G1	VINE-PARTHENOCISSUS QUINQUEFOLIA (VIRGINIA CREEPER), 1-GALLON POT	EACH	743	743								
		THE THIRTIEROSSOCO GOTTOCH WINGHIN CHEEFEN, T CALLON TO	EAUT	173									
*	E20220G1	VINE-PARTHENOCISSUS TRICUSPIDATA (BOSTON IVY), 1-GALLON POT	EACH	891	891								
*	K0030400	PERENNIAL PLANTS, DAYLILIES	UNIT	18	18								
	X0320333	ROADWAY CLEANING (SPECIAL)	EACH	19	19								
	X0321720	WATER MAIN REMOVAL	FOOT	143	143								
	X0321905	CTODA SEWEDS TYPE 1 WATER MATALOUGHTY PIPE 107	5007	AAP!								-	
*	X0321905	STORM SEWERS, TYPE 1. WATER MAIN QUALITY PIPE, 12" PILE EXTRACTION	F00T EACH	395 2	395		2			.,,			
	X0322256	TEMPORARY INFORMATION SIGNING	SQ FT	2,794	2,490	304	· · · · · · · · · · · · · · · · · · ·						
ye.	X0322859	WEED CONTROL, PRE-EMERGENT GRANULAR HERBICIDE	POUND	29	29								-
*		and services (the engineer) strongers recorded.	I OUND	2,3	23								
	1		1		1	1	1		1		1	1	1

F.A.I.	SECTION		COUN	ry	TOTAL SHEETS	SHEET NO.
94/90	•		COOH	ζ.	588	12
STA.		TO	STA.			
FED. ROA	AD DIST. NO. I	LLINOIS	FED.	AID	PROJECT	•

62303 • (2021-922 PT2 ETC 2324.6-1P) R-11

S0Q-06 ILLINOIS DEPARTMENT OF TRANSPORTATION F.A.I. 94/90 (DAN RYAN EXPRESSWAY) GARFIELD BLVD TO 31ST STREET (SB LOCAL LANES)

SUMMARY OF QUANTITIES

SCALE: 1"=N.T.S DATE: 06/09/06

REVISIONS DATE

DRAWN BY: RGR CHECKED BY: DDM

* - SPECIALTY ITEM

BOWMAN, BARRETT & ASSOCIATES INC.
CONSULTING ENGINEERS
Chicago, Illinois
312.228.0100
www.bbandainc.com

				*	90% FEDERAL			/ 10%STAT	E				
	CODE	TELL PROMPTION	T	URBAN TOTAL	ROADWAY IDOT	ROADWAY CDOT	RETAINI 69TH SW	NG WALLS 39TH-47TH	MWRD CULVERT	SIGNING	SAFETY	LIGHTING	SURVEILLANCE
	NUMBER X0323221	ITEM DESCRIPTION PLUG AND ABANDON EXISTING PIPE	CU YD	QUANTITY 5	J000 5	J000	Y007	Y007	X028-2A	Y002-1C	SFTY-3N	Y030-1E	Y032-1F
	X0323426	SEDIMENT CONTROL, DRAINAGE STRUCTURE INLET FILTER CLEANING		ļ									
			EACH	764	764								
*	X0323907	COMMUNICATIONS VAULT	EACH	4									4
	X0323973	SEDIMENT CONTROL, SILT FENCE	FOOT	13,675	13,675	******************			***************************************				
	X0323974	SEDIMENT CONTROL, SILT FENCE MAINTENANCE	FOOT	3,420	3,420								
	X0323988	TEMPORARY SOIL RETENTION SYSTEM	SQ FT	18,192	17,647		545						
	X0324112	BARRIER BASE	FOOT	17,288	17,288								
	X0324433	LIGHT TOWER, SERVICE PAD, 6"	SQ FT	136								136	
*	X0324455	DRILLLING AND SETTING SOLDIER PILES (IN SOIL)	CU FT	34,296		• • • • • • • • • • • • • • • • • • • •	26,0 7	8 , 2 20					
	X0324469	CONDUIT ENCASED, REINFORCED CONCRETE, 2-4" DIA., CNC											EG
			FOOT	58									58
*	X0324470	CONDUIT ENCASED, REINFORCED CONCRETE, 3-4" DIA., CNC	FOOT	499		***************************************							499
*	X0324471	CONDUIT ENCASED, REINFORCED CONCRETE, 4-4" DIA., CNC	FOOT	316								137	179
*	X0324472	CONDUIT ENCASED, REINFORCED CONCRETE, 5-4" DIA., CNC	FOOT	258									258
*	X0324646	CONDUIT ENCASED, REINFORCED CONCRETE, 6-4" DIA., CNC	FOOT	29									29
	X0324697	SOIL STABILIZERS	POUND	1 695,770	1,695,770								
	X0324698	APPLYING DUST SUPPRESSION AGENT	UNIT	1,255	1,255								
	X0324793	LIGHT TOWER, SERVICE PAD, SPECIAL	SQ FT	1,768								1,768	
												1,100	
	X0325080	VIDEO TAPING OF MWRD CULVERT	FOOT	245					245				
	X0325081	CONCRETE SLAB HYDRO-DEMOLITION	SQ YD	151					151				
	X0919000	TEMPORARY PAVEMENT REMOVAL	SQ YD	11,443	10,921						522		
	X2020300	EXCAVATE.AND PLACE EXISTING GRANULAR MATERIAL	CU YD	26,713	26,713								
*	X2500322	SEEDING, CLASS 5A (MODIFIED)	ACRE	3 .2	3.2								
	X4066426	BITUMINOUS CONCRETE SURFACE COURSE, SUPERPAVE, MIX "D", N70	TON	431	431								
	X4067100	POLYMERIZED LEVELING BINDER (MACHINE METHOD), SUPERPAVE, IL-4.75, N50	TON	288	288								
	X4210400	LUG SYSTEM REMOVAL		2	2								
			EACH										
	X4834090	PORTLAND CEMENT CONCRETE SHOULDERS 14"	SQ YD	25,506	25,506								
	X6061003	COMBINATION CONCRETE CURB AND GUTTER, TYPE M-4.48 (MODIFIED)	FOOT	5,025	5,025								
	X6063401	COMBINATION CONCRETE CURB AND GUTTER, TYPE M-4.12	FOOT	283	283								
	X6063600	COMBINATION CONCRETE CURB AND GUTTER, TYPE M-4.24	FOOT	8,467	8,467								DEUT (TOTAL)

F.A.I. SECTION COUNTY TOTAL SHEET NO. COOK 588 13 STA. TO STA. FED. ROAD DIST. NO. ILLINOIS FED. AID PROJECT 62303 * (2021-922 PT2 ETC 2324.6-1P) R-11

S0Q-07 ILLINOIS DEPARTMENT OF TRANSPORTATION F.A.I. 94/90 (DAN RYAN EXPRESSWAY) GARFIELD BLVD TO 31ST STREET (SB LOCAL LANES) SUMMARY OF QUANTITIES

SCALE: 1"=N.T.S DATE: 06/09/06

DRAWN BY: RGR CHECKED BY: DDM

* - SPECIALTY ITEM

BOWMAN, BARRETT & ASSOCIATES INC.
CONSULTING ENGINEERS
Chicago, Illinois
312.228.0100
www.bbandainc.com

						9(0% FEDERAL	L / 10%STATE				
CODE	TTEM DECONOTION	1	URBAN TOTAL	ROADWAY IDOT	ROADWAY CDOT	RETAINI 69TH SW	NG WALLS 39TH-47TH	MWRD CULVERT	SIGNING	SAFETY	LIGHTING	SURVEILLANCE
NUMBER X6065740	ITEM DESCRIPTION CONCRETE MEDIAN SURFACE, 5" (MODIFIED)	UNIT SQ FT	QUANTITY 7,221	J000 7,221	1000	Y007	Y007	X028-2A	Y002-1C	SFTY-3N	Y030-1E	Y032-1F
				• • • • • • • • • • • • • • • • • • • •								
X6370910	CONCRETE BARRIER, SINGLE FACE, 32" HEIGHT	FOOT	6,048	6,048								
X6370930	CONCRETE BARRIER, DOUBLE FACE, 32" HEIGHT	FOOT	10,146	10,146								
X6370935	CONCRETE BARRIER, SINGLE FACE, 32" (MODIFIED)	F00T	360	360								
X6640050	CHAIN LINK FENCE, 42" ATTACHED TO STRUCTURE (SPECIAL)	FOOT	1,64 5			1,000	64 5					
X6640500	CHAIN LINK GATE ASSEMBLY (SPECIAL)	EACH	1			1						
X6700410	ENGINEER'S FIELD OFFICE, TYPE A (SPECIAL)	CAL MO	13	13								
X6700600	ENGINEER'S FIELD LABORATORY (SPECIAL)	CAL MO	13	13			••••					
X7011008	TRAFFIC CONTROL AND PROTECTION FOR ALTERNATE ROUTE SIGNING	CAL MO	13	13								
X7011015	TRAFFIC CONTROL AND PROTECTION (EXPRESSWAYS)											
		L SUM	1	1								
X7013820	TRAFFIC CONTROL SURVEILLANCE, EXPRESSWAYS	CAL DA	390	390								
X7015000	CHANGEABLE MESSAGE SIGN	CAL MO	204	204	• • • • • • • • • • • • • • • • • • • •						***************************************	***************************************
* X8100045	CONDUIT ENCASED, REINFORCED CONCRETE, 1-3" DIA., CNC	FOOT	325								145	180
XX001854	STABILIZED SUB-BASE 6"	SQ YD	119,406	119,406								
XX002957	REMOVE AND RE-ERECT EXISTING SIGN	EACH	14						14			
XX003988	TEMPORARY CONCRETE BARRIER REMOVAL	FOOT	13,613	13,613								
XX004201	PAVEMENT REINFORCEMENT 14"	SQ YD	80,645	80,645					.,			
Z0002600	BAR SPLICERS							100				
		EACH	102					102				
* Z0008244	DRILLED SHAFT IN SOIL 44"	FOOT	56			26	30					
Z0013798	CONSTRUCTION LAYOUT	L SUM	1	1								
Z0018500	DRAINAGE STRUCTURES TO BE CLEANED	EACH	15	15							.,,,,,,,,,,,,,,,,,,,,,,,,,,,,,,,,,,,,,,	
* Z0029999	IMPACT ATTENUATOR REMOVAL	EACH	3						• • • • • • • • • • • • • • • • • • • •	3		
* Z0030070	IMPACT ATTENUATOR (SEVERE USE, NARROW), TEST LEVEL 3	EACH	4							4		
* Z0030250	IMPACT ATTENUATORS, TEMPORARY (NON-REDIRECTIVE), TEST LEVEL 3	EACH	14							14		
* Z0030275	IMPACT ATTENUATORS, TEMPORARY (SEVERE USE,NARROW), TEST LEVEL 2	EACH	1							1		
* Z0030280	IMPACT ATTENUATORS, TEMPORARY (SEVERE USE,NARROW), TEST LEVEL 3	EACH	2							2		
										1		
* Z0030350	IMPACT ATTENUATORS, RELOCATE (NON- REDIRECTIVE), TEST LEVEL 3	EACH	7							7		
* Z0030360	IMPACT ATTENUATORS, RELOCATE (SEVERE USE), TEST LEVEL 3	EACH	1							1		
Z0040530	PIPE UNDERDRAIN REMOVAL	FOOT	7,672	7,672								DEVICTORS

F.A.I.	SECTION		COUNTY	TOTAL	SHEET NO.
94/90 *			COOK	588	14
STA.		TO	STA.		
FED. ROAD	DIST. NO. IL	LINOIS	FED. AIC	PROJECT	
6230	3 + (2021	1-922	PT2 ETC	2324.6~1F) R-11

REVISIONS
NAME
DATE
F.A.I. 94/90 (DAN RYAN EXPRESSWAY)
GARFIELD BLVD TO 31ST STREET (SB LOCAL LANES)
SUMMARY OF QUANTITIES
SCALE: 1"=N.T.S DRAWN BY: RGR

CHECKED BY: DDM

DATE: 06/09/06

* - SPECIALTY ITEM

BOWMAN, BARRETT & ASSOCIATES INC.
CONSULTING ENGINEERS
Chicago, Illinois
312.228.0100
www.bbandainc.com

Rev.

	ODE								/ 10%STATE					
				TOTAL	RBAN ROADWAY ROADWAY RETAINING WALLS OTAL IDOT CDOT 69TH SW 39TH-47TH				MWRD CULVERT	SIGNING	SAFETY	LICHTING	SURVEILLANCE	
NUI	MBER	ITEM DESCRIPTION	UNIT	QUANTITY	J000	J000	Y007	Y007	X028-24	Y002-1C	SFTY-3N	Y030-1E	Y032-1F	
Z004	8665	RAILROAD PROTECTIVE LIABILITY INSURANCE	L SUM	1	1									
O -Z007	6600	TRAINEES	HOUR	1500	1500									
X032	5502	MEDIAN BARRIER GATE SYSTEM	EACH	2	2						••••••			
X032	?5 <i>51</i> 5	LUG SYSTEM COMPLETE 41'		1						***************************************		• • • • • • • • • • • • • • • • • • • •		
			EACH	1	1									
X031	25514	LUG SYSTEM COMPLETE 49'	EACH	1	1	***************************************								
* X032	25517	CONDUIT EMBEDDED IN STRUCTURE, 1-1/4" DIA., GALVANIZED STEEL	FOOT	45		***************************************							45	
* X032	25085	TEMPORARY PAVEMENT (INTERSTATE)	SQ YD	2,863	2,341						522			
* X032	25505	CONDUIT ENCASED, REINFORCED CONCRETE, 1-2" DIA., CNC	FOOT	397									397	
* X03:	25506	CONDUIT ENCASED, REINFORCED CONCRETE, 2-2" DIA, CNC	FOOT	115		****							115	
Y033	25510	VIDEO TAPING OF PIPE UNDERDRAINS	FOOT	9,387	9,387									
	5,5,0,70		F001	3,301	3,301	*******								
X038	25509	TEMPORARY PAVEMENT (VARIABLE DEPTH)	SQ YD	481	481				•••••					
Xosa	25516	CLEANING PIPE UNDERDRAINS	FOOT	4,694	4,694									
X60	13700	PIPE UNDERDRAIN REMOVAL, SPECIAL	FOOT	3,602	3,602	••••								
X032	25498	DUCTILE IRON PIPE	FOOT	423	423									
				423	423									
Z001	8100	DRAINAGE STRUCTURES TO BE ADJUSTED, SPECIAL	EACH	28	28									
									••••					

						,,,,,,,,,,,,,,,,,,,,,,,,,,,,,,,,,,,,,,,								

					1									
														
				<u> </u>										
											,			
				ļ										
				<u> </u>										

F.A.I. SECTION COUNTY TOTAL SHEET NO.
94/90 • COOK 588 15

STA. TO STA.

FED. ROAD DIST. NO. ILLINOIS FED. AID PROJECT

62303 • (2021-922 PT2 ETC 2324.6-1P) R-11


REVISIONS
NAME
DATE
F.A.I. 94/90 (DAN RYAN EXPRESSWAY)
GARFIELD BLVD TO 31ST STREET (SB LOCAL LANES)

SUMMARY OF QUANTITIES


SCALE: 1"=N.T.S DATE: 06/09/06 DRAWN BY: RGR CHECKED BY: DDM

0 - Y080 7 • - SPECIALTY ITEM




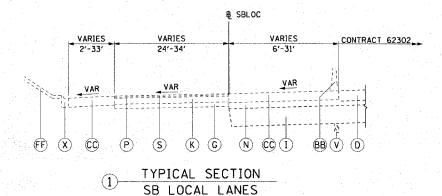


STA 3475+50.00 TO STA 3515+10.04

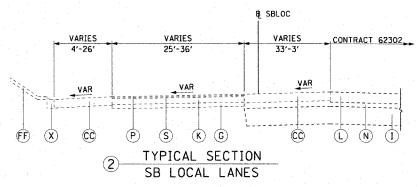


STA 3515+10.04 TO STA 3520+14.98

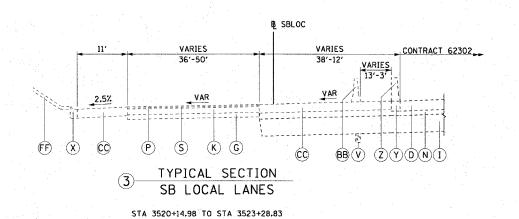

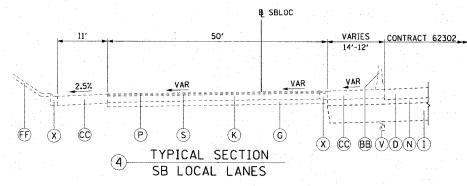

STA 3523+28.83 TO STA 3523+84.69

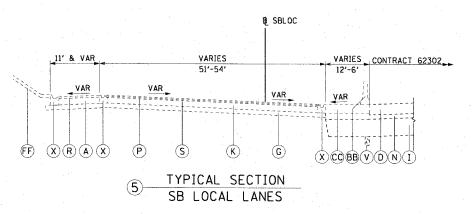

STA 3523+84.69 TO STA 3529+00

EXISTING LEGEND:

- (A) GRAVEL OR CRUSHED STONE BASE COURSE, TY A, 6"
- D PORTLAND CEMENT CONCRETE SHOULDERS, 14"
- G SUB-BASE GRANULAR MATERIAL, 6"
- (I) SUB-BASE GRANULAR MATERIAL, TYPE B. 24"
- (K) CONTINUOUSLY REINFORCED PORTLAND CEMENT CONCRETE PAVEMENT, 10"
- (L) CONTINUOUSLY REINFORCED PORTLAND CEMENT CONCRETE PAVEMENT, 14"
- (N) STABILIZED SUB-BASE, 6"
- P) BITUMINOUS CONCRETE SURFACE COURSE, 1/2"
- R) BITUMINOUS CONCRETE SURFACE COURSE, 21/2"
- S BITUMINOUS CONCRETE BINDER COURSE, 11/2"
- V PIPE UNDERDRAIN, 6"
- (X) COMBINATION CONCRETE CURB AND GUTTER
- Y BARRIER BASE
- Z CONCRETE BARRIER, SINGLE FACE, 32" HEIGHT
- BB TEMPORARY CONCRETE BARRIER WITH MONODIRECTIONAL PRISMATIC BARRIER REFLECTOR
- CC TEMPORARY PAVEMENT (INTERSTATE) 12" P.C.C. OR 14" BITUMINOUS
- FF GRASS AREA

NOTE: THE EXISTING PAVEMENT TYPES AND THICKNESSES WERE TAKEN FROM DAN RYAN DESIGN PLANS OR RECORD DRAWINGS.

REVISIONS
NAME DATE

GARFIELD BLVD TO 31ST STREET (SB LOCAL LANES)


EXISTING TYPICAL SECTIONS
SOUTHBOUND LOCAL LANES

SCALE: H:1"=10" V:1"=5"


DATE: June 9, 2006

DRAWN BY: NJH CHECKED BY: RMG

CTE | AECOM

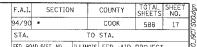


FED. ROAD DIST. NO. ILLINOIS FED. AID PROJECT 62303 • (2021-922 PT2 ETC 2324.6-1P) R-11

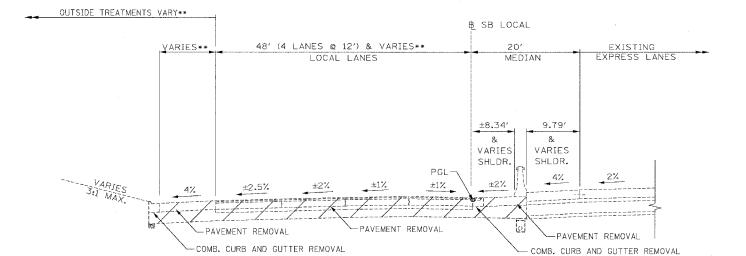

EXISTING LOCAL LANES WITH AUXILIARY LANE

STA. 3530+96 TO 3548+15 STA. 3561+31 TO 3571+95 STA. 3581+45 TO 3601+50 STA. 3619+33 TO 3625+62 (SUPER ELEVATED SECTIONS ARE SIMILAR)

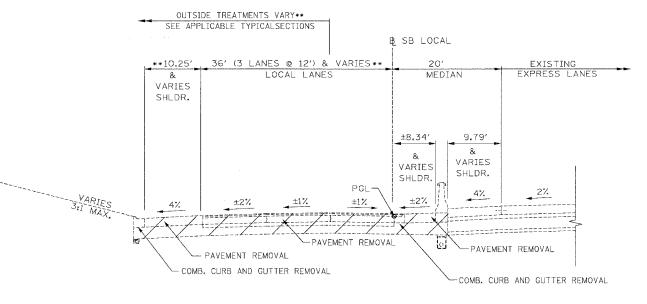

EXISTING VARYING DEPTH SUB-BASE GRANULAR MATERIAL 3581+87 - 3586+20 3586+20 - 3587+20 18" - 36 3587+20 - 3605+35 3605+35 - 3607+50 36" - 18" 3607+50 - 3608+45 3608+45 - 3611+50 24" - 42 3611+50 - 3618+50 3618+50 - 3622+50 18" - 42" 3622+50 - 3627+00 3627+00 - 3629+96

EXISTING LOCAL LANES

STA. 3529+00 TO 3629+96 (SUPERELEVATED SECTIONS ARE SIMILAR)

- 1. THICKNESS OF EXISTING PAVEMENT AND SUB BASES ARE TAKEN FROM RECORD DRAWING PLANS.
- 2. SUPERELEVATED SECTIONS ARE SIMILAR TO TANGENT SECTIONS
- * PAVEMENT CROSS SLOPES AS STATED & VARIES
- ** SEE PLAN SHEETS FOR DETAILS

EXISTING LEGEND

- GRAVEL OR CRUSHED STONE BASE COURSE, TYPE A, 6"
- PORTLAND CEMENT CONCRETE BASE COURSE, 9"
- (c) PORTLAND CEMENT CONCRETE PAVEMENT, 10"
- PORTLAND CEMENT CONCRETE SHOULDERS, 14"
- GEOTECHNICAL FABRIC FOR GROUND STABILIZATION
- SUB-BASE GRANULAR MATERIAL (DEPTH VARIES SEE SCHEDULE ON THIS SHEET)
- SUB-BASE GRANULAR MATERIAL, 6"
- SUB-BASE GRANULAR MATERIAL, 6" AND VARIES
- SUB-BASE GRANULAR MATERIAL, TYPE B, 24"
- CONCRETE MEDIAN SURFACE, 6" (SPECIAL)
- CONTINUOUSLY REINFORCED PORTLAND CEMENT CONCRETE PAVEMENT, 10"
- CONTINUOUSLY REINFORCED PORTLAND CEMENT CONCRETE PAVEMENT, 14"
- STABILIZED SUB-BASE, 4"
- (N)STABILIZED SUB-BASE, 6"
- 0 BITUMINOUS SURFACE, 11/2"
- BITUMINOUS CONCRETE SURFACE COURSE, 11/2"
- BITUMINOUS CONCRETE SURFACE COURSE, 13/4"
- BITUMINOUS CONCRETE SURFACE COURSE, 21/2"
- (S) BITUMINOUS CONCRETE BINDER COURSE, 11/2"
- BITUMINOUS CONCRETE BINDER COURSE, 13/4"
- BITUMINOUS SHOULDERS SUPERPAVE, 6"
- PIPE UNDERDRAINS, 6"
- PIPE UNDERDRAINS, 8"
- (x)COMBINATION CONCRETE CURB AND GUTTER
- (Y)
- (Z) CONCRETE BARRIER, SINGLE FACE, 32" HEIGHT
- CONCRETE BARRIER, DOUBLE FACE, 32" HEIGHT
- TEMPORARY CONCRETE BARRIER WITH MONODIRECTIONAL PRISMATIC BARRIER REFLECTOR
- TEMPORARY PAVEMENT (INTERSTATE) 12" P.C.C. OR 14" BITUMINOUS
- OD TEMPORARY SOIL RETENTION SYSTEM
- ĒĒ SAND BACKFILL
- (FF) GRASS AREA
- (GC) RETAINING WALL
- CHAIN LINK FENCE
- GUARDRAIL

EXTYP-2

CHECKED BY: RS

REVISION NAME	DATE	ILLINOIS DEPARTMENT OF TRANSPORTATION F.A.I. 94/90 (DAN RYAN EXPRESSWA) GARFIELD BLVD TO 31ST STREET (SB LOCAL LANES					
		EXISTING TYPICAL SI	ECTIONS				


DATE: 06/09/06

BOWMAN, BARRETT & ASSOCIATES INC. CONSULTING ENGINEERS
Chicago, Illinois
312.228.0100

F.A.I. SECTION	COUNTY	SHEETS	NO.				
94/90 *	COOK	588	18				
STA.	TO STA.	TO STA.					
FED. ROAD DIST. NO.	ILLINOIS FED. AID	PROJECT					

62303 * (2021-922 PT2 ETC 2324.6-1P) R-11

EXISTING LEGEND

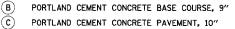

GRAVEL OR CRUSHED STONE BASE COURSE, TYPE A, 6"

PORTLAND CEMENT CONCRETE SHOULDERS, 14"

GEOTECHNICAL FABRIC FOR GROUND STABILIZATION

SUB-BASE GRANULAR MATERIAL (DEPTH VARIES SEE SCHEDULE ON THIS SHEET)

SUB-BASE GRANULAR MATERIAL, 6"

SUB-BASE GRANULAR MATERIAL, 6" AND VARIES

SUB-BASE GRANULAR MATERIAL, TYPE 8, 24"

CONCRETE MEDIAN SURFACE, 6" (SPECIAL)

CONTINUOUSLY REINFORCED PORTLAND CEMENT CONCRETE PAVEMENT, 10"

CONTINUOUSLY REINFORCED PORTLAND CEMENT CONCRETE PAVEMENT, 14"

STABILIZED SUB-BASE, 4"

N STABILIZED SUB-BASE, 6"

0 BITUMINOUS SURFACE, 11/2"

BITUMINOUS CONCRETE SURFACE COURSE, 11/2"

(a) BITUMINOUS CONCRETE SURFACE COURSE, 13/4"

(R) BITUMINOUS CONCRETE SURFACE COURSE, 21/2"

BITUMINOUS CONCRETE BINDER COURSE, 11/2"

BITUMINOUS CONCRETE BINDER COURSE, 13/4"

BITUMINOUS SHOULDERS SUPERPAVE, 6"

PIPE UNDERDRAINS, 6"

PIPE UNDERDRAINS, 8"

COMBINATION CONCRETE CURB AND GUTTER

(Y) BARRIER BASE

(Z) CONCRETE BARRIER, SINGLE FACE, 32" HEIGHT

CONCRETE BARRIER, DOUBLE FACE, 32" HEIGHT

TEMPORARY CONCRETE BARRIER WITH MONODIRECTIONAL PRISMATIC BARRIER REFLECTOR

(H) TEMPORARY PAVEMENT (INTERSTATE) - 12" P.C.C. OR 14" BITUMINOUS

TEMPORARY SOIL RETENTION SYSTEM

SAND BACKFILL

(FF) GRASS AREA

RETAINING WALL

© ⊞ CHAIN LINK FENCE

GUARDRAIL

EXTYP-3

COMB. CURB AND

-GUTTER REMOVAL

- 1. THICKNESS OF EXISTING PAVEMENT AND SUB BASES ARE TAKEN FROM RECORD DRAWING PLANS.
 2. SUPERELEVATED SECTIONS ARE SIMILAR TO TANGENT SECTIONS
- * PAVEMENT CROSS SLOPES AS STATED & VARIES
- ** SEE PLAN SHEETS FOR DETAILS

REVISION NAME	S DATE	ILLINOIS DEPARTMENT OF TRANSPORTATION F.A.I. 94/90 (DAN RYAN EXPRESSWAY GARFIELD BLVD TO 31ST STREET (SB LOCAL LANES)					
		EXISTING TYPICAL SECTIONS					
		SCALE: NTS DRAWN BY: JDC DATE: 06/09/06 CHECKED BY: RS					

BOWMAN, BARRETT & ASSOCIATES INC. CONSULTING ENGINEERS
Chicago, Illinois
312.228.0100
www.bhandainc.com B WENTWORTH AVE

VAR.

COMB. CURB AND GUTTER REMOVAL

MEDIAN REMOVAL -

CHAIN LINK FENCE REMOVAL

3:1 MAX.

EXISTING ONE LANE RAMP

7050+39 TO 7055+00 - 43C

5042+39 TO 5047+88 - 43A

7040+50 TO 7048+37 - 39D

7043+09 TO 7043+57 - T35D

5022+81 TO 5024+33 - T39A

5002+94 TO 5004+05 - 35A

7004+89 TO 7004+64 - 31D


STATION

(NO STATIONING DUE TO RAMP RE-ALIGNMENT) - 47A

COMB. CURB AND


-GUTTER REMOVAL

PAVEMENT REMOVAL

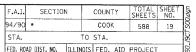


FED. ROAD DIST. NO. ILLINOIS FED. AID PROJECT

62303 * (2021-922 PT2 ETC 2324.6-1P) R-11

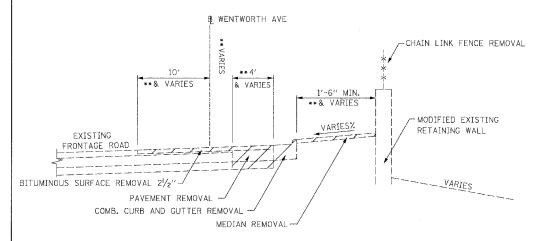


RECXOSIS INTELICFICION TANGEHRICADA PAIRICI AVALL

STA, 12+72 TO 17+95

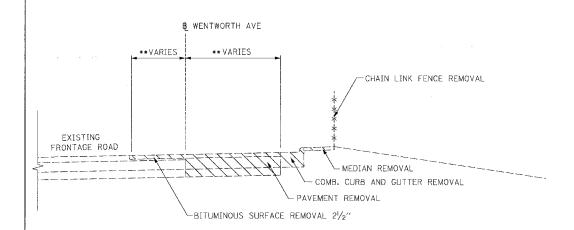


EXISTING FRONTAGE ROAD PAVEMENT REDUCTION

RAMP 47A: STA. 5071+93 TO 5073+94

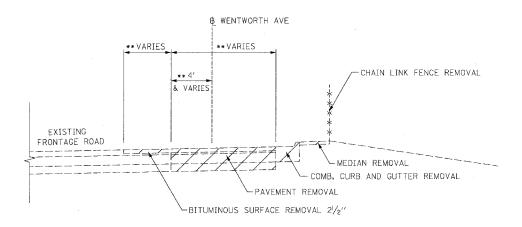

EXISTING FRONTAGE ROAD PARTIAL RECONSTRUCTION

STA. 12+72 TO 5071+93 STA. 26+99.1 TO 29+96.9 STA. 30+71.8 TO 37+66.1 STA. 53+66.7 TO 56+23.8

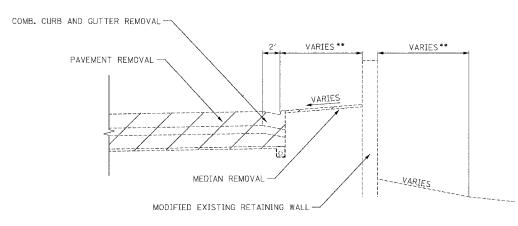

EXISTING TYPICAL INSIDE RAMP SHOULDER TREATMENT WITH RETAINING WALL

STATION

(NO STATIONING DUE TO RAMP RE-ALIGNMENT) -

54+80 TO 7044+09 -

EXISTING LEGEND

GRAVEL OR CRUSHED STONE BASE COURSE, TYPE A, 6"

PORTLAND CEMENT CONCRETE BASE COURSE, 9"

(c) PORTLAND CEMENT CONCRETE PAVEMENT, 10"

(D) PORTLAND CEMENT CONCRETE SHOULDERS, 14"

(E) GEOTECHNICAL FABRIC FOR GROUND STABILIZATION

(F) SUB-BASE GRANULAR MATERIAL (DEPTH VARIES SEE SCHEDULE ON THIS SHEET)

SUB-BASE GRANULAR MATERIAL, 6"

SUB-BASE GRANULAR MATERIAL, 6" AND VARIES

SUB-BASE GRANULAR MATERIAL, TYPE B, 24"

CONCRETE MEDIAN SURFACE, 6" (SPECIAL)

CONTINUOUSLY REINFORCED PORTLAND CEMENT CONCRETE PAVEMENT, 10"

CONTINUOUSLY REINFORCED PORTLAND CEMENT CONCRETE PAVEMENT, 14"

STABILIZED SUB-BASE, 4"

(N)STABILIZED SUB-BASE, 6"

BITUMINOUS SURFACE, 11/2"

BITUMINOUS CONCRETE SURFACE COURSE, 11/2"

(a) BITUMINOUS CONCRETE SURFACE COURSE, 134"

R BITUMINOUS CONCRETE SURFACE COURSE, 21/2"

(S) BITUMINOUS CONCRETE BINDER COURSE, 11/2"

(1) BITUMINOUS CONCRETE BINDER COURSE, 13/4"

(U) BITUMINOUS SHOULDERS SUPERPAVE, 6"

(v) PIPE UNDERDRAINS, 6"

PIPE UNDERDRAINS, 8"

(X) COMBINATION CONCRETE CURB AND GUTTER

(Y) BARRIER BASE

CONCRETE BARRIER, SINGLE FACE, 32" HEIGHT

CONCRETE BARRIER, DOUBLE FACE, 32" HEIGHT

TEMPORARY CONCRETE BARRIER WITH MONODIRECTIONAL PRISMATIC BARRIER REFLECTOR

 (\widetilde{cc}) TEMPORARY PAVEMENT (INTERSTATE) - 12" P.C.C. OR 14" BITUMINOUS

TEMPORARY SOIL RETENTION SYSTEM

(EE) SAND BACKFILL

(BB)

GRASS AREA

FF GG RETAINING WALL

 $\widetilde{\mathbb{H}}$ CHAIN LINK FENCE

GUARDRAIL

EXTYP-4

REVISIONS NAME	DATE	ILLINOIS DEPARTMENT OF T F.A.I. 94/90 (DAN RYA GARFIELD BLVD TO 31ST STREET	N EXPRESSWAY)
		EXISTING TYPICAL	SECTIONS
		SCALE: NTS	DRAWN BY: JDC
		DATE: 06/09/06	CHECKED BY: RS


BOWMAN, BARRETT & ASSOCIATES INC.
CONSULTING ENGINEERS
Chicago, Illinois Chicago, Illinois 312.228.0100


1. THICKNESS OF EXISTING PAVEMENT AND SUB BASES ARE TAKEN FROM RECORD DRAWING PLANS.

2. SUPERELEVATED SECTIONS ARE SIMILAR TO TANGENT SECTIONS


* PAVEMENT CROSS SLOPES AS STATED & VARIES

** SEE PLAN SHEETS FOR DETAILS

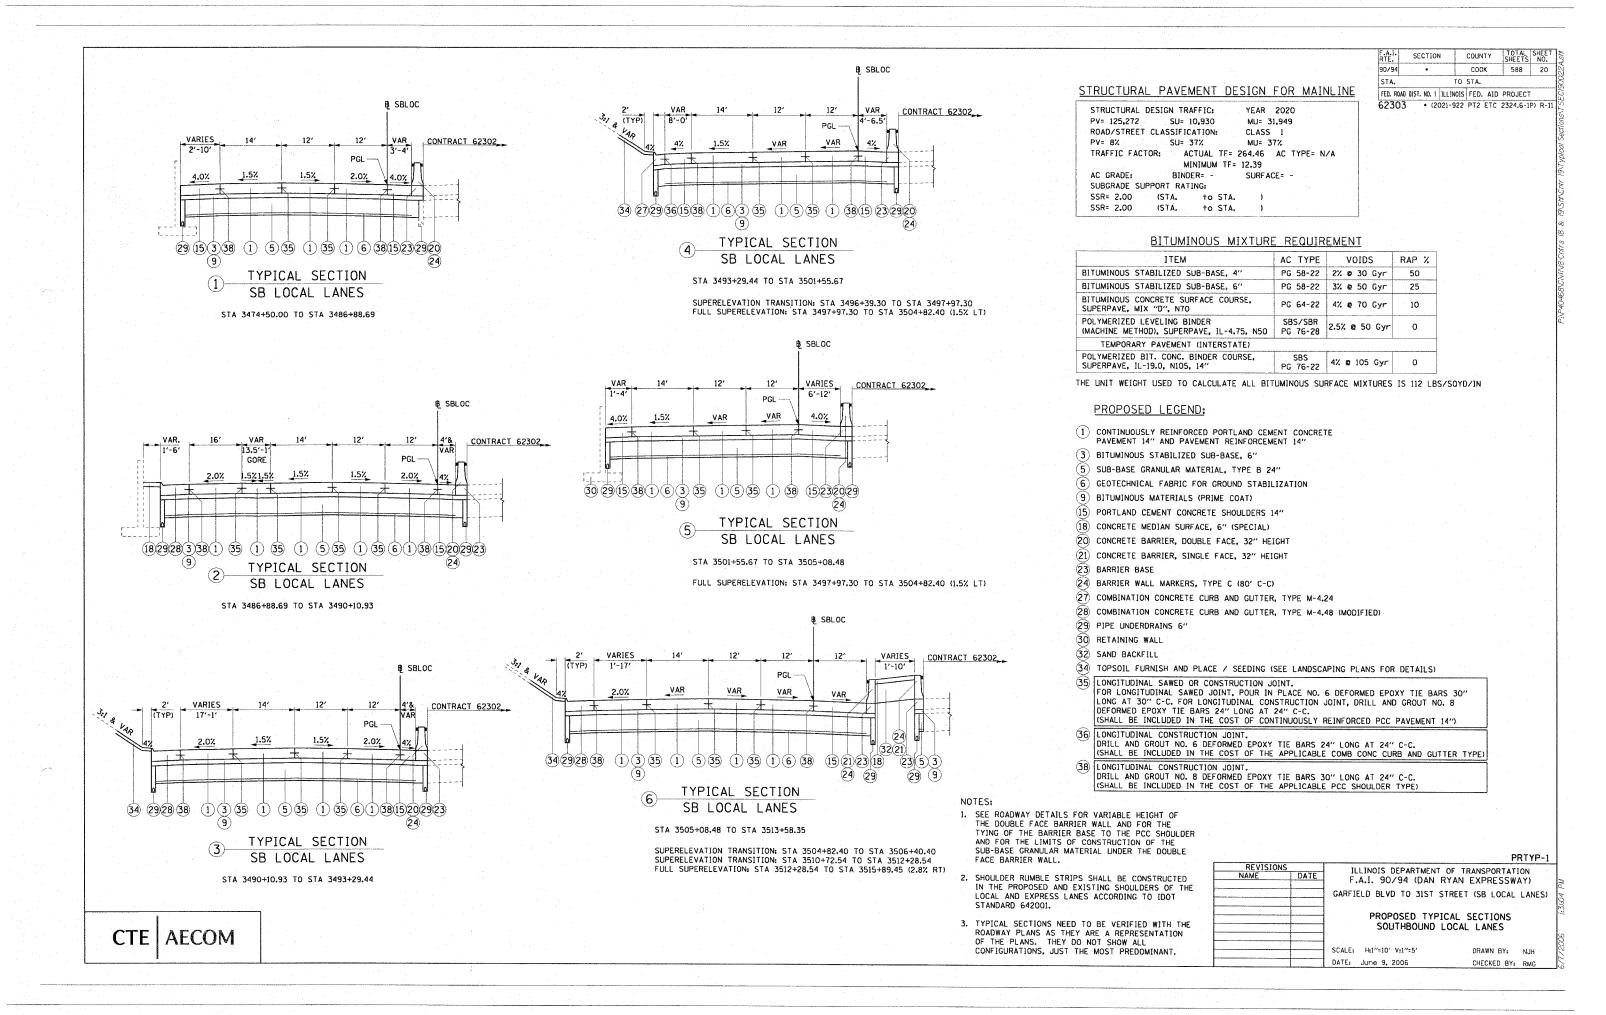

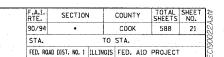


62303 • (2021-922 PT2 ETC 2324.6-1P) R-1

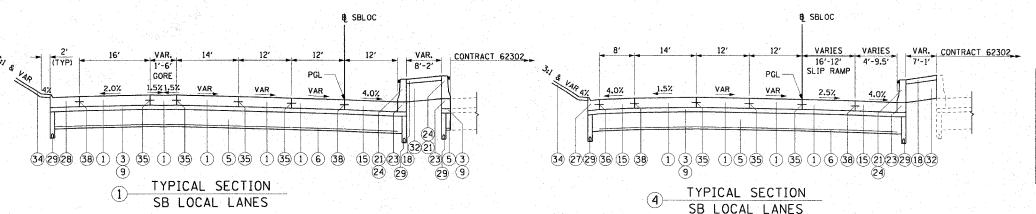

STA 3520+14.98 TO STA 3523+72.02


SUPERELEVATION TRANSITION: STA 3522+48.47 TO STA 3525+31.47

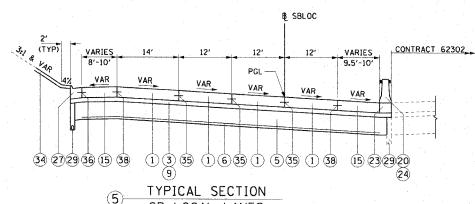

SB LOCAL LANES

STA 3523+72.02 TO STA 3529+00.00

SUPERELEVATION TRANSITION: STA 3522+48.47 TO STA 3525+31.47 FULL SUPERELEVATION: STA 3525+31.47 TO STA 3531+43.15 (5.7% RT)

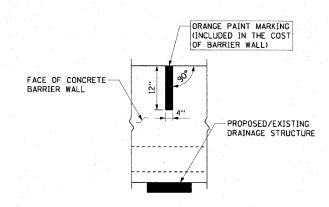

CONCRETE BARRIER WALL MARKING AT DRAINAGE STRUCTURE

PLACE ON BARRIER WALL CONSTRUCTED ADJACENT TO ROADWAY PLANS AS THEY ARE A REPRESENTATION OF THE PLANS. THEY DO NOT SHOW ALL ALL PROPOSED AND/OR EXISTING DRAINAGE STRUCTURES CONFIGURATIONS, JUST THE MOST PREDOMINANT.

STANDARD 642001.

NOTES:

STRUCTURAL PAVEMENT DESIGN FOR MAINLINE

STRUCTURAL DESIGN TRAFFIC: YEAR 2020 PV= 125,272 SU= 10,930 MU= 31,949 ROAD/STREET CLASSIFICATION: CLASS 1 PV= 8% SU= 37% MU= 37% TRAFFIC FACTOR: ACTUAL TF= 264.46 AC TYPE= N/A MINIMUM TF= 12.39 BINDER= -AC GRADE: SURF ACE = SUBGRADE SUPPORT RATING: SSR= 2.00 (STA. to STA.

to STA.

PROPOSED LEGEND:

SSR= 2.00

- (1) CONTINUOUSLY REINFORCED PORTLAND CEMENT CONCRETE PAVEMENT 14" AND PAVEMENT REINFORCEMENT 14"
- BITUMINOUS STABILIZED SUB-BASE, 6"

(STA.

- SUB-BASE GRANULAR MATERIAL, TYPE B 24"
- GEOTECHNICAL FABRIC FOR GROUND STABILIZATION
- BITUMINOUS MATERIALS (PRIME COAT)
- PORTLAND CEMENT CONCRETE SHOULDERS 14"
- (18) CONCRETE MEDIAN SURFACE, 6" (SPECIAL)
- (20) CONCRETE BARRIER, DOUBLE FACE, 32" HEIGHT
- (21) CONCRETE BARRIER, SINGLE FACE, 32" HEIGHT
- (23) BARRIER BASE
- (24) BARRIER WALL MARKERS, TYPE C (80' C-C)
- COMBINATION CONCRETE CURB AND GUTTER, TYPE M-4.24
- (28) COMBINATION CONCRETE CURB AND GUTTER, TYPE M-4.48 (MODIFIED)
- (29) PIPE UNDERDRAINS 6"
- 30 RETAINING WALL
- (32) SAND BACKFILL
- (34) TOPSOIL FURNISH AND PLACE / SEEDING (SEE LANDSCAPING PLANS FOR DETAILS)
- LONGITUDINAL SAWED OR CONSTRUCTION JOINT. FOR LONGITUDINAL SAWED JOINT, POUR IN PLACE NO. 6 DEFORMED EPOXY TIE BARS 30" LONG AT 30" C-C. FOR LONGITUDINAL CONSTRUCTION JOINT, DRILL AND GROUT NO. 8 DEFORMED EPOXY TIE BARS 24" LONG AT 24" C-C.
- (SHALL BE INCLUDED IN THE COST OF CONTINUOUSLY REINFORCED PCC PAVEMENT 14")
- (36) LONGITUDINAL CONSTRUCTION JOINT.
 DRILL AND GROUT NO. 6 DEFORMED EPOXY TIE BARS 24" LONG AT 24" C-C.
- (SHALL BE INCLUDED IN THE COST OF THE APPLICABLE COMB CONC CURB AND GUTTER TYPE) (38) LONGITUDINAL CONSTRUCTION JOINT.
- DRILL AND GROUT NO. 8 DEFORMED EPOXY TIE BARS 30" LONG AT 24" C-C. (SHALL BE INCLUDED IN THE COST OF THE APPLICABLE PCC SHOULDER TYPE)

FACE BARRIER WALL. 2. SHOULDER RUMBLE STRIPS SHALL BE CONSTRUCTED IN THE PROPOSED AND EXISTING SHOULDERS OF THE LOCAL AND EXPRESS LANES ACCORDING TO IDOT

AND FOR THE LIMITS OF CONSTRUCTION OF THE SUB-BASE GRANULAR MATERIAL UNDER THE DOUBLE

1. SEE ROADWAY DETAILS FOR VARIABLE HEIGHT OF THE DOUBLE FACE BARRIER WALL AND FOR THE TYING OF THE BARRIER BASE TO THE PCC SHOULDER

3. TYPICAL SECTIONS NEED TO BE VERIFIED WITH THE

PRTYP-2

EVISIONS		ILLINOIS DEPARTMENT OF TRANSPORTATION						
ME	DATE	F.A.I. 90/94 (DAN RYAN EXPRESSWAY)						
		GARFIELD BLVD TO 31ST STREET (SB LOCAL LANES)						
		PROPOSED TYPICAL SECTIONS						
		SOUTHBOUND LOCAL LANES						

SCALE: H:1"=10' V:1"=5' DRAWN BY: N.H.

DATE: June 9, 2006 CHECKED BY: RMG

AECOM

4.0%

29 (15) (38) (6) (1) (3) (35)

STA 3513+58.35 TO STA 3516+11.82

VARIES

3'-8.5

VAR

29 (15) (38)

(9)

FULL SUPERELEVATION: STA 3512+28.54 TO STA 3515+89.45 (2.8% RT) SUPERELEVATION TRANSITION: STA 3515+89.45 TO STA 3517+45.45

12'

PGL

VAR

(1) (3) (35) (1) (35) (6) (29) (1) (35)

PGL

(1)(5)(35)(1)(35)(29)(1)(35)

TYPICAL SECTION SB LOCAL LANES

STA 3518+96.04 TO STA 3520+14.98

SUPERELEVATION TRANSITION: STA 3515+89.45 TO STA 3517+45.45

B SBLOC

LGORE

CONTRACT 62302

TYPICAL SECTION

SB LOCAL LANES

STA 3516+11.82 TO STA 3518+96.04

B SBLOC


VARIES

18'-5.5


GORE

CONTRACT 62302_



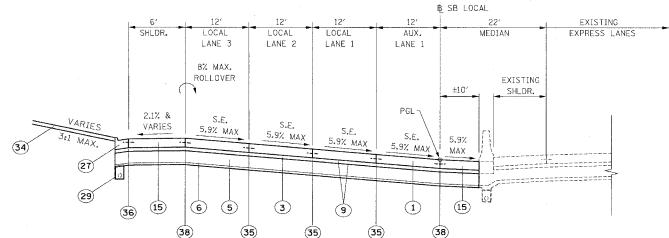

STA. 3529+00 TO 3530+92.51 - SUPERELEVATION = 5.7% (SUPERELEVATION TRANSITION SECTION FROM STA. 3530+92.51 TO 3537+00.25 IS SIMILAR)

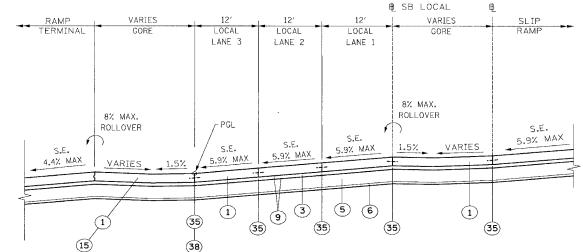

PROPOSED LOCAL LANES

STA, 3537+00.25 TO STA, 3541+43.17 - SUPERELEVATION = 5.7% (SUPERELEVATION TRANSITION SECTION FROM STA. 3541+43.17 TO STA. 3545+91.96 IS SIMILAR)

- 1. SEE ROADWAY DETAILS FOR VARIABLE HEIGHT OF THE DOUBLE FACE BARRIER WALL AND FOR THE TYING OF THE BARRIER BASE TO THE PCC SHOULDER AND FOR THE LIMITS OF CONSTRUCTION OF
- 2, SHOULDER RUMBLE STRIPS SHALL BE CONSTRUCTED IN THE PROPOSED AND EXISTING SHOULDERS OF THE LOCAL AND EXPRESS LANES ACCORDING TO IDOT STANDARD 642001.
- OF THE PLANS, THEY DO NOT SHOW ALL CONFIGURATIONS, JUST THE MOST PREDOMINANT.

3. TYPICAL SECTIONS NEED TO BE VERIFIED WITH THE ROADWAY PLANS AS THEY ARE A REPRESENTATION

(38) (35) (35) (35) PROPOSED LOCAL LANES

ksr= 200

MAINLINE: STRUCTURAL DESIGN TRAFFIC: YEAR 2020 PV= 125,272 SU= 10,930 MU= 31,949 ROAD/STREET CLASSIFICATION: CLASS: 1 S= 37% P= 8% M= 37% TRAFFIC FACTOR: ACTUAL TF= 264,46 AC TYPE= N/A MINIMUM TF= 12.39 AC GRADE: BINDER:= SURFACE:= SUBGRADE SUPPORT RATING:

BOWMAN, BARRETT & ASSOCIATES INC. CONSULTING ENGINEERS Chicago, Illinois 312.228.0100 www.bbandainc.com

ILLINOIS DEPARTMENT OF TRANSPORTATION F.A.I. 94/90 (DAN RYAN EXPRESSWAY) GARFIELD BLVD TO 31ST STREET (SB LOCAL LANES) PROPOSED TYPICAL SECTIONS SCALE: NTS DRAWN BY: JDC

DATE: 06/09/06

THE SUB-BASE GRANULAR MATERIAL UNDER THE DOUBLE FACE BARRIER WALL.

** SEE PLAN SHEETS FOR DETAILS

COMBINATION CONCRETE CURB AND GUTTER, TYPE 8-6.12 COMBINATION CONCRETE CURB AND GUTTER, TYPE M-2.24 COMBINATION CONCRETE CURB AND GUTTER, TYPE M-4.24 COMBINATION CONCRETE CURB AND GUTTER, TYPE M-4.48 (MODIFIED)

(30) RETAINING WALL (31) MODIFIED EXISTING RETAINING WALL

PIPE UNDERDRAINS 6"

GEOTECHNICAL FABRIC FOR GROUND STABILIZATION

STRIP REFLECTIVE CRACK CONTROL TREATMENT

PORTLAND CEMENT CONCRETE BASE COURSE 91/2"

PORTLAND CEMENT CONCRETE SHOULDERS 11"

PORTLAND CEMENT CONCRETE SHOULDERS 14"

CONCRETE MEDIAN SURFACE, 5" (MODIFIED)

CONCRETE MEDIAN SURFACE, 6" (SPECIAL)

CONCRETE BARRIER, DOUBLE FACE, 32" HEIGHT

CONCRETE BARRIER, SINGLE FACE, 32" HEIGHT

BARRIER WALL MARKERS, TYPE C (80' C-C)

CONCRETE GUTTER, TYPE B

CONCRETE MEDIAN SURFACE, 6"

CHAIN LINK FENCE, 4' (SPECIAL)

PORTLAND CEMENT CONCRETE PAVEMENT 11" (JOINTED)

BITUMINOUS MATERIALS (PRIME COAT)

BITUMINOUS CONCRETE SURFACE COURSE, SUPERPAVE, MIX "D" N70, 11/2"

POLYMERIZED LEVELING BINDER (MACHINE METHOD), SUPERPAVE, IL-4.75, N50, 1"

(32) SAND BACKFILL (33) GUARDRAIL

BARRIER BASE

3

(4)

(5)

(6)

(7)

(8)

9

(10)

(11)

(12)

(13)

(14) (15)

(16)

(17)

(18)

(19)

(20)

(21)

(22)

(23)

(24)

(25)

(26)

(27)

(28)

29

TOPSOIL FURNISH AND PLACE / SEEDING (SEE LANDSCAPING PLANS FOR DETAILS)

LONGITUDINAL SAWED OR CONSTRUCTION JOINT, FOR LONGITUDINAL SAWED JOINT, POUR IN PLACE NO. 6 DEFORMED EPOXY TIE BARS 30" LONG AT 30" C-C. FOR LONGITUDINAL CONSTRUCTION JOINT, DRILL AND GROUT NO. 8 DEFORMED EPOXY TIE BARS 24" LONG AT 24" C-C. (SHALL BE INCLUDED IN THE COST OF C.R.P.C.C. PAVEMENT 14")

LONGITUDINAL CONSTRUCTION JOINT.
DRILL AND GROUT NO. 6 DEFORMED EPOXY TIE BARS 24" LONG AT 24" C-C.
(SHALL BE INCLUDED IN THE COST OF THE APPLICABLE COMB. CONC. CURB AND GUTTER TYPE)


LONGITUDINAL CONSTRUCTION JOINT.
DRILL AND GROUT NO. 8 DEFORMED EPOXY TIE BARS 24" LONG AT 24" C-C.
(SHALL BE INCLUDED IN THE COST OF P.C.C. BASE COURSE 9")


LONGITUDINAL CONSTRUCTION JOINT.
DRILL AND GROUT NO. 8 DEFORMED EPOXY TIE BARS 30" LONG AT 24" C-C.
(SHALL BE INCLUDED IN THE COST OF THE APPLICABLE P.C.C. SHOULDERS TYPE) 38

PRTYP-3

CHECKED BY: RS


588

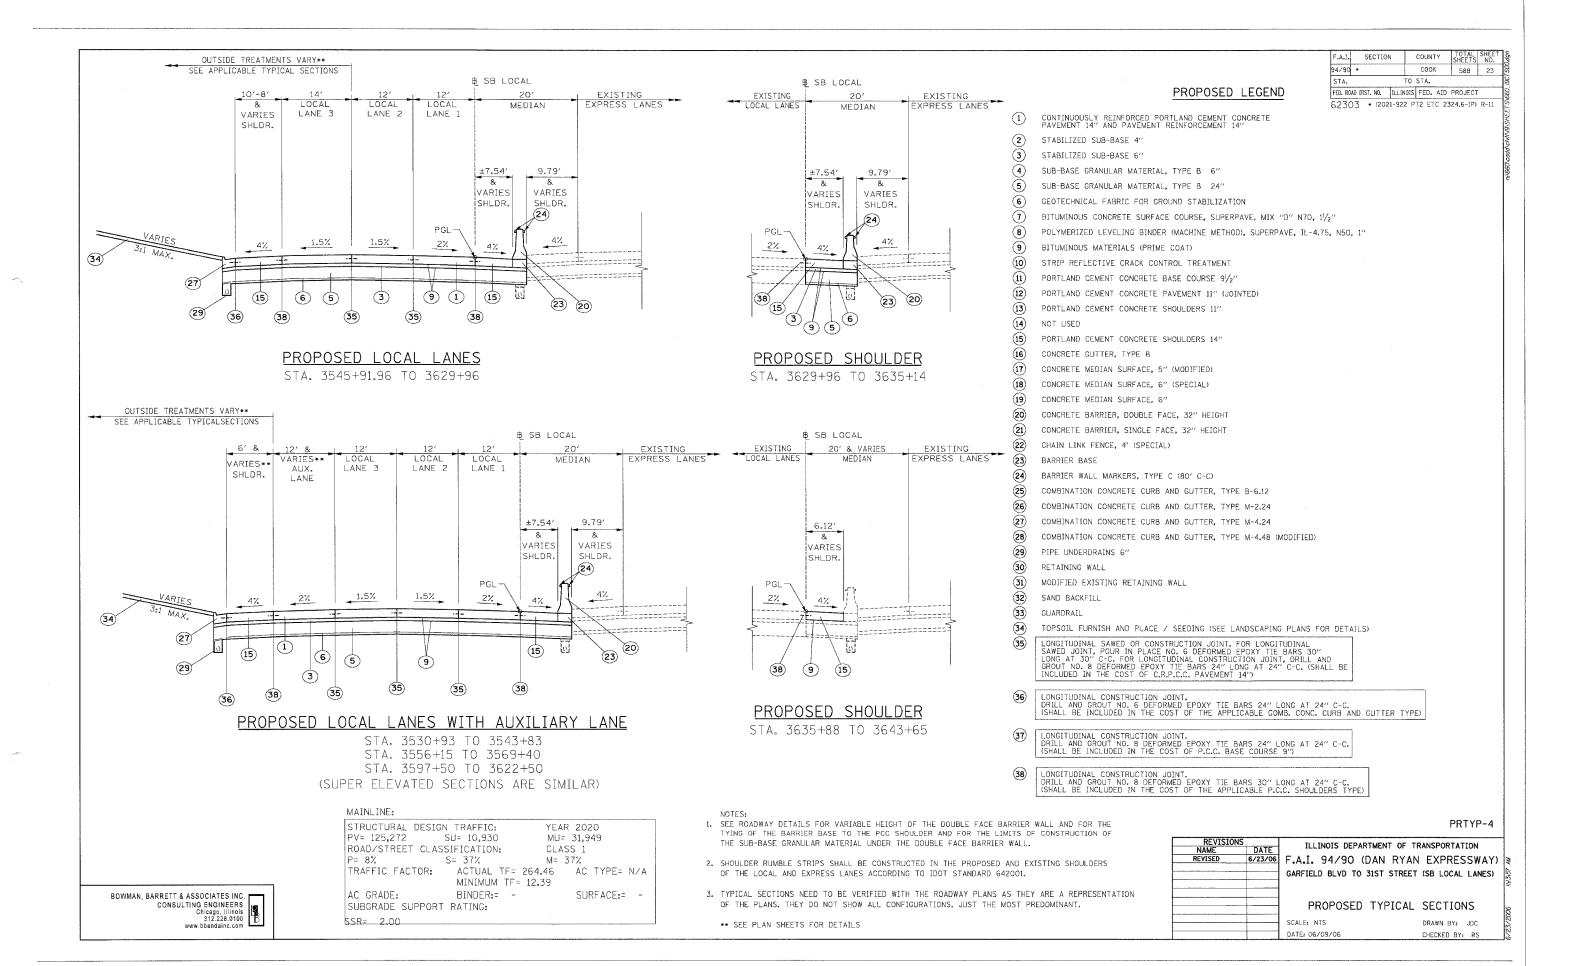

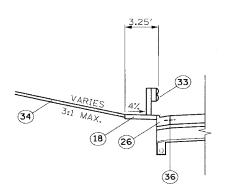

PROPOSED GUARDRAIL

STA. 3529+14.17 TO 3531+47.10 STA. 3556+35.88 TO 3559+23.74 STA. 3566+23.18 TO 3568+62.98 STA. 3576+22.01 TO 3578+36.60 STA. 3583+69.87 TO 3585+72.20

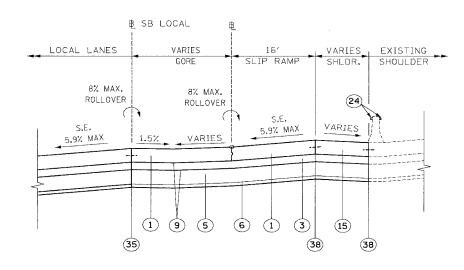


PROPOSED SLIP RAMP

STA. 721+23 TO 725+72.77 - SUPERELEVATION = 5.9%

(SUPERELEVATION TRANSITION SECTION FROM STA. 725+72,77 TO 727+63.41 IS SIMILAR)

MAINLINE:

STRUCTURAL DESIGN TRAFFIC: YEAR 2020 PV= 125,272 SU= 10,930 MU= 31,949 ROAD/STREET CLASSIFICATION: CLASS 1 P= 8% M= 37% ACTUAL TF= 264.46 TRAFFIC FACTOR: AC TYPE= N/A MINIMUM TF= 12.39 AC GRADE: BINDER:= SURFACE:= SUBGRADE SUPPORT RATING: SSR= 2.00

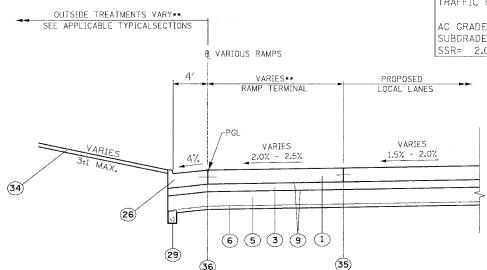

	<u>S</u>	<u>TAT</u>	<u>ION</u>
-	5060+00	TO 5	5062+66.19
-	7057+45.05	ΤO	7059+84.92
****	5040+09.48	ΤO	5041+61.85
	7048+50.27	ΤO	7050+90.17
	7046+58.03	ΤO	7053+38.03
	5020+23.52	ΤO	5022+06.41
-	5000+11.36	ΤO	5001+93.91
-	7007+33.48	TO	7009+73.36
	-	- 5060+00 7 - 7057+45.05 - 5040+09.48 - 7048+50.27 - 7046+58.03 - 5020+23.52 - 5000+11.36	STAT - 5060+00 TO 5 - 7057+45.05 TO - 5040+09.48 TO - 7048+50.27 TO - 7046+58.03 TO - 5020+23.52 TO - 5000+11.36 TO - 7007+33.48 TO

CRC LOCAL LANE RAMP TERMINAL

- 1. SEE ROADWAY DETAILS FOR VARIABLE HEIGHT OF THE DOUBLE FACE BARRIER WALL AND FOR THE TYING OF THE BARRIER BASE TO THE PCC SHOULDER AND FOR THE LIMITS OF CONSTRUCTION OF THE SUB-BASE GRANULAR MATERIAL UNDER THE DOUBLE FACE BARRIER WALL.
- 2. SHOULDER RUMBLE STRIPS SHALL BE CONSTRUCTED IN THE PROPOSED AND EXISTING SHOULDERS OF THE LOCAL AND EXPRESS LANES ACCORDING TO IDOT STANDARD 642001.
- 3. TYPICAL SECTIONS NEED TO BE VERIFIED WITH THE ROADWAY PLANS AS THEY ARE A REPRESENTATION OF THE PLANS. THEY DO NOT SHOW ALL CONFIGURATIONS, JUST THE MOST PREDOMINANT.
- ** SEE PLAN SHEETS FOR DETAILS

PROPOSED LEGEND

STA. FED. ROAD DIST. NO. ILLINOIS FED. AID PROJECT 62303 * (2021-922 PT2 ETC 2324.6-1P) R-11

SECTION

94/90

COUNTY TOTAL SHEETS

588 24

COOK

CONTINUOUSLY REINFORCED PORTLAND CEMENT CONCRETE PAVEMENT 14" AND PAVEMENT REINFORCEMENT 14"

(2) STABILIZED SUB-BASE 4"

3 STABILIZED SUB-BASE 6"

(4) SUB-BASE GRANULAR MATERIAL, TYPE B 6"

(5) SUB-BASE GRANULAR MATERIAL, TYPE B 24"

(6) GEOTECHNICAL FABRIC FOR GROUND STABILIZATION

(7) BITUMINOUS CONCRETE SURFACE COURSE, SUPERPAVE, MIX "D" N70, 11/2"

(8) POLYMERIZED LEVELING BINDER (MACHINE METHOD), SUPERPAVE, IL-4,75, N50, 1"

(9) BITUMINOUS MATERIALS (PRIME COAT)

(10) STRIP REFLECTIVE CRACK CONTROL TREATMENT

(11) PORTLAND CEMENT CONCRETE BASE COURSE 91/2"

(12) PORTLAND CEMENT CONCRETE PAVEMENT 11" (JOINTED)

(13) PORTLAND CEMENT CONCRETE SHOULDERS 11"

(14)

(15) PORTLAND CEMENT CONCRETE SHOULDERS 14"

(16) CONCRETE GUTTER, TYPE B

(17) CONCRETE MEDIAN SURFACE, 5" (MODIFIED)

(18) CONCRETE MEDIAN SURFACE, 6" (SPECIAL)

(19) CONCRETE MEDIAN SURFACE, 6"

(20) CONCRETE BARRIER, DOUBLE FACE, 32" HEIGHT

(21) CONCRETE BARRIER, SINGLE FACE, 32" HEIGHT

(22) CHAIN LINK FENCE, 4' (SPECIAL)

(23) BARRIER BASE

(24) BARRIER WALL MARKERS, TYPE C (80' C-C)

(25) COMBINATION CONCRETE CURB AND GUTTER, TYPE B-6.12

(26) COMBINATION CONCRETE CURB AND GUTTER, TYPE M-2.24

(27) COMBINATION CONCRETE CURB AND GUTTER, TYPE M-4.24

(28)

COMBINATION CONCRETE CURB AND GUTTER, TYPE M-4.48 (MODIFIED)

(29) PIPE UNDERDRAINS 6"

(30) RETAINING WALL

(31) MODIFIED EXISTING RETAINING WALL

(32) SAND BACKFILL

(33) GUARDRAIL

TOPSOIL FURNISH AND PLACE / SEEDING (SEE LANDSCAPING PLANS FOR DETAILS)

LONGITUDINAL SAWED OR CONSTRUCTION JOINT. FOR LONGITUDINAL SAWED JOINT, POUR IN PLACE NO. 6 DEFORMED EPOXY TIE BARS 30" LONG AT 30" C-C. FOR LONGITUDINAL CONSTRUCTION JOINT, DRILL AND GROUT NO. 8 DEFORMED EPOXY TIE BARS 24" LONG AT 24" C-C. (SHALL BE INCLUDED IN THE COST OF C.R.P.C.C. PAVEMENT 14")

(36) LONGITUDINAL CONSTRUCTION JOINT.
DRILL AND GROUT NO. 6 DEFORMED EPOXY TIE BARS 24" LONG AT 24" C-C.
(SHALL BE INCLUDED IN THE COST OF THE APPLICABLE COMB. CONC. CURB AND GUTTER TYPE)

LONGITUDINAL CONSTRUCTION JOINT. DRILL AND GROUT NO. 8 DEFORMED EPOXY TIE BARS 24" LONG AT 24" C-C. (SHALL BE INCLUDED IN THE COST OF P.C.C. BASE COURSE 9")

LONGITUDINAL CONSTRUCTION JOINT. DRILL AND GROUT NO. 8 DEFORMED EPOXY TIE BARS 30" LONG AT 24" C-C. (SHALL BE INCLUDED IN THE COST OF THE APPLICABLE P.C.C. SHOULDERS TYPE)

PRTYP-5

DRAWN BY: JDC


CHECKED BY: RS


REVISIONS NAME ILLINOIS DEPARTMENT OF TRANSPORTATION F.A.I. 94/90 (DAN RYAN EXPRESSWAY) GARFIELD BLVD TO 31ST STREET (SB LOCAL LANES)

PROPOSED TYPICAL SECTIONS

SCALE: NTS DATE: 06/09/06

BOWMAN, BARRETT & ASSOCIATES INC. CONSULTING ENGINEERS Chicago, Illinois 312.228.0100

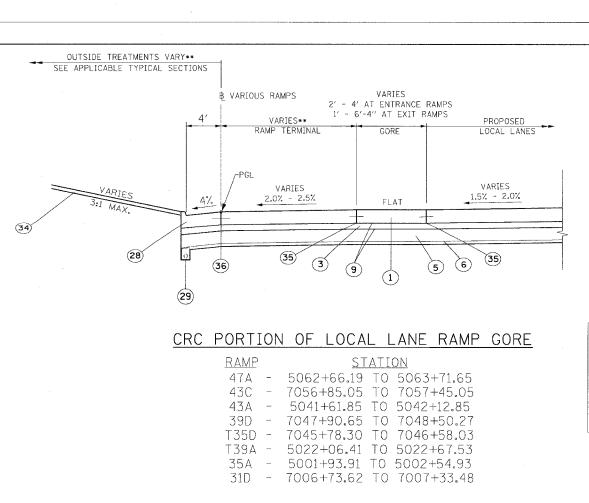

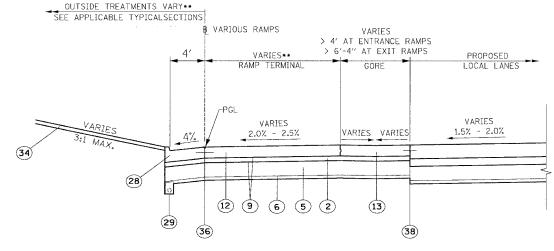

JOINTED PORTION OF LOCAL LANE RAMP GORE

RAMP		ST	ATI	ON
47A	_			5065+59.83
43C	-	7054+55.21	ΤO	7056+85.05
43A	-	5042+12.85	ΤO	5043+00.73
39D	-	7045+66.83	ΤO	7047+90.65
T35D	-	7043+58.07	ΤO	7045+78.30
T39A	_	5022+67.53	ΤO	5023+73.67
35A		5002+54.93	ΤO	5003+60.75
31D	-	7004+91.72	ΤO	7006+73.62

MAINLINE:

STRUCTURAL DESIG	N TRAFFIC:	YEAR	2020	
PV= 125,272	SU= 10,930	MU=	31,949	
ROAD/STREET CLAS	SSIFICATION:	CLASS	5 1	
		M= 37	7%	
TRAFFIC FACTOR:	S= 37% ACTUAL TF= 264	.46	AC TYPE=	N/A
	MINIMUM TF= 12.			
AC GRADE:	BINDER:= -		SURFACE:=	-
SUBGRADE SUPPORT	F RATING:			
SSR= 2,00				

RAMPS:

STRUCTURAL DESIGN	N TRAFFIC:	YEAF	202	0	
PV= 16,758	SU= 532	MU=	1,710)	
ROAD/STREET CLAS	SIFICATION:	CLAS	SS 1		
P= 100%	S= 100%	M= 1	00%		
TRAFFIC FACTOR:	ACTUAL TF	= 38.10	AC	TYPE=	N/A
	MINIMUM T	F= 16.75			
AC GRADE:	BINDER:=	_	SUR	FACE:=	-
SUBGRADE SUPPORT	RATING:				
1					

PROPOSED LEGEND

94/90 COOK 588 FED. ROAD DIST. NO. ILLINOIS FED. AID PROJECT 62303 * (2021-922 PT2 ETC 2324.6-1P) R-11

COUNTY

F.A.I.

SECTION

CONTINUOUSLY REINFORCED PORTLAND CEMENT CONCRETE PAVEMENT 14" AND PAVEMENT REINFORCEMENT 14"

(2) STABILIZED SUB-BASE 4"

(3) STABILIZED SUB-BASE 6"

(4) SUB-BASE GRANULAR MATERIAL, TYPE B 6"

(5) SUB-BASE GRANULAR MATERIAL, TYPE B 24"

(6) GEOTECHNICAL FABRIC FOR GROUND STABILIZATION

(7) BITUMINOUS CONCRETE SURFACE COURSE, SUPERPAVE, MIX "D" N70, 11/2"

(8) POLYMERIZED LEVELING BINDER (MACHINE METHOD), SUPERPAVE, IL-4.75, NSO, 1"

(9) BITUMINOUS MATERIALS (PRIME COAT)

(10) STRIP REFLECTIVE CRACK CONTROL TREATMENT

(11) PORTLAND CEMENT CONCRETE BASE COURSE 91/2"

(12) PORTLAND CEMENT CONCRETE PAVEMENT 11" (JOINTED)

(13) PORTLAND CEMENT CONCRETE SHOULDERS 11"

(14) NOT USED

(15) PORTLAND CEMENT CONCRETE SHOULDERS 14"

(16) CONCRETE GUTTER, TYPE B

(17) CONCRETE MEDIAN SURFACE, 5" (MODIFIED)

(18) CONCRETE MEDIAN SURFACE, 6" (SPECIAL)

(19) CONCRETE MEDIAN SURFACE, 6"

(20) CONCRETE BARRIER, DOUBLE FACE, 32" HEIGHT

(21) CONCRETE BARRIER, SINGLE FACE, 32" HEIGHT

(22) CHAIN LINK FENCE, 4' (SPECIAL)

(23) BARRIER BASE

(24) BARRIER WALL MARKERS, TYPE C (80' C-C)

(25) COMBINATION CONCRETE CURB AND GUTTER, TYPE B-6.12

COMBINATION CONCRETE CURB AND GUTTER, TYPE M-2.24

(27) COMBINATION CONCRETE CURB AND GUTTER, TYPE M-4.24

(28) COMBINATION CONCRETE CURB AND GUTTER, TYPE M-4.48 (MODIFIED)

(29) PIPE UNDERDRAINS 6"

(30) RETAINING WALL

(31) MODIFIED EXISTING RETAINING WALL

(32) SAND BACKFILL

(33) GUARDRAIL

TOPSOIL FURNISH AND PLACE / SEEDING (SEE LANDSCAPING PLANS FOR DETAILS)

LONGITUDINAL SAWED OR CONSTRUCTION JOINT, FOR LONGITUDINAL SAWED JOINT, POUR IN PLACE NO. 6 DEFORMED EPOXY TIE BARS 30" LONG AT 30" C-C. FOR LONGITUDINAL CONSTRUCTION JOINT, DRILL AND GROUT NO. 8 DEFORMED EPOXY TIE BARS 24" LONG AT 24" C-C. (SHALL BE INCLUDED IN THE COST OF C.R.P.C.C. PAVEMENT 14")

LONGITUDINAL CONSTRUCTION JOINT.

DRILL AND GROUT NO. 6 DEFORMED EPOXY TIE BARS 24" LONG AT 24" C-C. (SHALL BE INCLUDED IN THE COST OF THE APPLICABLE COMB. CONC. CURB AND GUTTER TYPE)

LONGITUDINAL CONSTRUCTION JOINT. DRILL AND GROUT NO, 8 DEFORMED EPOXY TIE BARS 24" LONG AT 24" C-C. (SHALL BE INCLUDED IN THE COST OF P.C.C. BASE COURSE 9")

LONGITUDINAL CONSTRUCTION JOINT.
DRILL AND GROUT NO. 8 DEFORMED EPOXY TIE BARS 30" LONG AT 24" C-C.
(SHALL BE INCLUDED IN THE COST OF THE APPLICABLE P.C.C. SHOULDERS TYPE) (38)

1. SEE ROADWAY DETAILS FOR VARIABLE HEIGHT OF THE DOUBLE FACE BARRIER WALL AND FOR THE TYING OF THE BARRIER BASE TO THE PCC SHOULDER AND FOR THE LIMITS OF CONSTRUCTION OF THE SUB-BASE GRANULAR MATERIAL UNDER THE DOUBLE FACE BARRIER WALL.

2. SHOULDER RUMBLE STRIPS SHALL BE CONSTRUCTED IN THE PROPOSED AND EXISTING SHOULDERS OF THE LOCAL AND EXPRESS LANES ACCORDING TO IDOT STANDARD 642001.


3. TYPICAL SECTIONS NEED TO BE VERIFIED WITH THE ROADWAY PLANS AS THEY ARE A REPRESENTATION OF THE PLANS. THEY DO NOT SHOW ALL CONFIGURATIONS, JUST THE MOST PREDOMINANT.

** SEE PLAN SHEETS FOR DETAILS

PRTYP-6

REVISIONS	ILLINOIS DEPARTMENT OF T	MOTTATION
NAME DATE	TEETHOLS DELANTIMENT OF TH	NAME OF TATION
	F.A.I. 94/90 (DAN RYAN	I EXPRESSWAY)
	GARFIELD BLVD TO 31ST STREET	(SB LOCAL LANES)
	PROPOSED TYPICAL	SECTIONS
	SCALE: NTS	DRAWN BY: JDC
	DATE: 06/09/06	CHECKED BY: RS

BOWMAN, BARRETT & ASSOCIATES INC. CONSULTING ENGINEERS NG ENGINEERS
Chicago, Illinois
312.228.0100 www.bbandainc.com

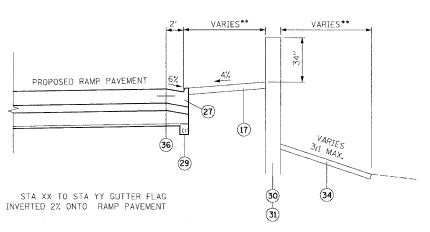

PROPOSED TYPICAL INSIDE RAMP SHOULDER TREATMENT WITH RETAINING WALL


STATION

5066+13.30 TO 5070+72.56 - 47A 54+79.84 TO 7044+17 - 39D

B VARIOUS RAMPS VARIES 8'~10' EXISTING FRONTAGE ROAD (11) PROPOSED RAMP PAVEMENT 9 10 7 (8) 4 (8) (9) (30) (29) (17) (18) (36)

PROPOSED TYPICAL OUTSIDE RAMP SHOULDER TREATMENT WITH RETAINING WALL

STATION RAMP 5065+29.90 TO 5069+92 -

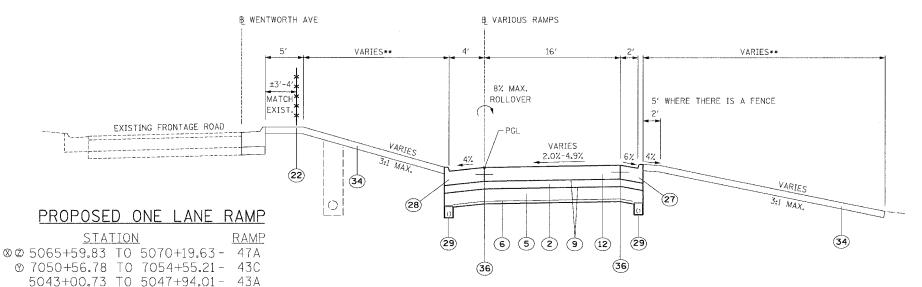

(INVERT RAMP 47A 24" GUTTER FLAG 2% ONTO RAMP PAVEMENT FROM STA 5070+30 TO THE FRONTAGE ROAD CURB AND GUTTER) (INVERT RAMP 43C 24" GUTTER FLAG 2% ONTO RAMP PAVEMENT FROM THE FRONTAGE ROAD CURB AND GUTTER TO STA 7050+28) (INVERT RAMP 43A 24" GUTTER FLAG 2% ONTO RAMP PAVEMENT FROM STA 5047+88 TO THE FRONTAGE ROAD CURB AND GUTTER)

- ⊗ SEE "PROPOSED TYPICAL INSIDE RAMP SHOULDER TREATMENT WITH RETAINING WALL" FOR LEFT SIDE TREATMENT.
- SEE "EARTH RETAINING RAMP BARRIER WALL" FOR RIGHT SIDE TREATMENT.
- ② SEE "PROPOSED TYPICAL OUTSIDE RAMP SHOULDER TREATMENT WITH RETAINING WALL" FOR RIGHT SIDE TREATMENT

- 1. SEE ROADWAY DETAILS FOR VARIABLE HEIGHT OF THE DOUBLE FACE BARRIER WALL AND FOR THE TYING OF THE BARRIER BASE TO THE PCC SHOULDER AND FOR THE LIMITS OF CONSTRUCTION OF THE SUB-BASE GRANULAR MATERIAL UNDER THE DOUBLE FACE BARRIER WALL.
- 2. SHOULDER RUMBLE STRIPS SHALL BE CONSTRUCTED IN THE PROPOSED AND EXISTING SHOULDERS OF THE LOCAL AND EXPRESS LANES ACCORDING TO IDOT STANDARD 642001.
- 3. TYPICAL SECTIONS NEED TO BE VERIFIED WITH THE ROADWAY PLANS AS THEY ARE A REPRESENTATION OF THE PLANS. THEY DO NOT SHOW ALL CONFIGURATIONS, JUST THE MOST PREDOMINANT.
- ** SEE PLAN SHEETS FOR DETAILS

PROPOSED LEGEND

COOK 588 FED. ROAD DIST. NO. ILLINOIS FED. AID PROJECT 62303 * (2021-922 PT2 ETC 2324.6-1P) R-11

F.A.I. SECTION 94/90 *

COUNTY TOTAL SHEE NO.

- CONTINUOUSLY REINFORCED PORTLAND CEMENT CONCRETE PAVEMENT 14" AND PAVEMENT REINFORCEMENT 14"
- (2) STABILIZED SUB-BASE 4"
- (3) STABILIZED SUB-BASE 6"
- (4) SUB-BASE GRANULAR MATERIAL, TYPE B 6"
- (5) SUB-BASE GRANULAR MATERIAL, TYPE B 24"
- (6) GEOTECHNICAL FABRIC FOR GROUND STABILIZATION
- BITUMINOUS CONCRETE SURFACE COURSE, SUPERPAVE, MIX "D" N70, 11/2"
- POLYMERIZED LEVELING BINDER (MACHINE METHOD), SUPERPAVE, IL-4.75, N50, 1"
- (9) BITUMINOUS MATERIALS (PRIME COAT)
- (10) STRIP REFLECTIVE CRACK CONTROL TREATMENT
- (11)PORTLAND CEMENT CONCRETE BASE COURSE 91/2"
- (12) PORTLAND CEMENT CONCRETE PAVEMENT 11" (JOINTED)
- (13) PORTLAND CEMENT CONCRETE SHOULDERS 11"
- (14) NOT USED

(15)

- PORTLAND CEMENT CONCRETE SHOULDERS 14"
- CONCRETE GUTTER, TYPE B
- (17) CONCRETE MEDIAN SURFACE, 5" (MODIFIED)
- (18) CONCRETE MEDIAN SURFACE, 6" (SPECIAL)
- 19 CONCRETE MEDIAN SURFACE, 6"
- (20) CONCRETE BARRIER, DOUBLE FACE, 32" HEIGHT
- (21) CONCRETE BARRIER, SINGLE FACE, 32" HEIGHT
- (22) CHAIN LINK FENCE, 4' (SPECIAL)
- (23) BARRIER BASE
- (24) BARRIER WALL MARKERS, TYPE C (80' C-C)
- (25) COMBINATION CONCRETE CURB AND GUTTER, TYPE B-6.12
- (26) COMBINATION CONCRETE CURB AND GUTTER, TYPE M-2.24
- (27) COMBINATION CONCRETE CURB AND GUTTER, TYPE M-4.24
- (28) COMBINATION CONCRETE CURB AND GUTTER, TYPE M-4.48 (MODIFIED)
- 29 PIPE UNDERDRAINS 6"
- (30) RETAINING WALL
- (31) MODIFIED EXISTING RETAINING WALL
- (32) SAND BACKFILL
- (33) GUARDRAIL
- TOPSOIL FURNISH AND PLACE / SEEDING (SEE LANDSCAPING PLANS FOR DETAILS)
- LONGITUDINAL SAWED OR CONSTRUCTION JOINT, FOR LONGITUDINAL SAWED JOINT, POUR IN PLACE NO. 6 DEFORMED EPOXY TIE BARS 30" LONG AT 30" C-C, FOR LONGITUDINAL CONSTRUCTION JOINT, DRILL AND GROUT NO. 8 DEFORMED EPOXY TIE BARS 24" LONG AT 24" C-C. (SHALL BE INCLUDED IN THE COST OF C.R.P.C.C. PAVEMENT 14") 35)
- LONGITUDINAL CONSTRUCTION JOINT, DRILL AND GROUT NO. 6 DEFORMED EPOXY TIE BARS 24" LONG AT 24" C-C. (SHALL BE INCLUDED IN THE COST OF THE APPLICABLE COMB. CONC. CURB AND GUTTER TYPE)
- LONGITUDINAL CONSTRUCTION JOINT-DRILL AND GROUT NO. 8 DEFORMED EPOXY TIE BARS 24" LONG AT 24" C-C. (SHALL BE INCLUDED IN THE COST OF P.C.C. BASE COURSE 9")
- LONGITUDINAL CONSTRUCTION JOINT.
 DRILL AND GROUT NO. 8 DEFORMED EPOXY TIE BARS 30" LONG AT 24" C-C.
 (SHALL BE INCLUDED IN THE COST OF THE APPLICABLE P.C.C. SHOULDERS TYPE)

PRTYP-7

CHECKED BY: RS

ILLINOIS DEPARTMENT OF TRANSPORTATION F.A.I. 94/90 (DAN RYAN EXPRESSWAY) GARFIELD BLVD TO 31ST STREET (SB LOCAL LANES) PROPOSED TYPICAL SECTIONS

DATE: 06/09/06

SCALE: NTS DRAWN BY: JDC

BOWMAN, BARRETT & ASSOCIATES INC. 1 CONSULTING ENGINEERS Chicago, Illinois 312,228,0100

⊗7040+64.74 TO 7045+66.83 - 39D

⊗ 5023+73.67 TO 5024+32.53 - T39A

♥5003+60.75 TO 5004+04.93 - 35A

♥ 7004+63.75 TO 7004+91.72 - 31D

7043+08.57 TO 7043+58.07 - T35D

STRUCTURAL DESIGN TRAFFIC: YEAR 2020 PV= 16,758 SU= 532 MU= 1,710 ROAD/STREET CLASSIFICATION: CLASS 1 2= 100% S= 100% M= 100% ACTUAL TF= 38.10 TRAFFIC FACTOR: AC TYPE= N/A MINIMUM TF= 16.75 SURFACE:= -AC GRADE. RINDER :=

SSR= 2.00

RAMPS:

SUBGRADE SUPPORT RATING:

F.A.I. S	ECTION	con	YTY	TOTAL	SHEET NO.	
94/90 *		CO	3K	588	27	
STA.		TO STA				
FED. ROAD DIST	NO. TELL	NOIS FEE	. AID	PROJECT		

PROPOSED LEGEND

62303 * (2021-922 PT2 ETC 2324,6-1P) R-11

CONTINUOUSLY REINFORCED PORTLAND CEMENT CONCRETE PAVEMENT 14" AND PAVEMENT REINFORCEMENT 14"

STABILIZED SUB-BASE 4"

3 STABILIZED SUB-BASE 6"

(4) SUB-BASE GRANULAR MATERIAL, TYPE B 6"

(5) SUB-BASE GRANULAR MATERIAL, TYPE B 24"

GEOTECHNICAL FABRIC FOR GROUND STABILIZATION

(7) BITUMINOUS CONCRETE SURFACE COURSE, SUPERPAVE, MIX "D" N70, 11/2"

(8) POLYMERIZED LEVELING BINDER (MACHINE METHOD), SUPERPAVE, IL-4.75, N50, 1"

(9) BITUMINOUS MATERIALS (PRIME COAT)

(10) STRIP REFLECTIVE CRACK CONTROL TREATMENT

(11) PORTLAND CEMENT CONCRETE BASE COURSE 91/2"

(12) PORTLAND CEMENT CONCRETE PAVEMENT 11" (JOINTED)

(13) PORTLAND CEMENT CONCRETE SHOULDERS 11"

(14)

15) PORTLAND CEMENT CONCRETE SHOULDERS 14"

(16) CONCRETE GUTTER, TYPE B

(17) CONCRETE MEDIAN SURFACE, 5" (MODIFIED)

(18) CONCRETE MEDIAN SURFACE, 6" (SPECIAL)

(19) CONCRETE MEDIAN SURFACE, 6"

(20) CONCRETE BARRIER, DOUBLE FACE, 32" HEIGHT

(21) CONCRETE BARRIER, SINGLE FACE, 32" HEIGHT

(22) CHAIN LINK FENCE, 4' (SPECIAL)

(23) BARRIER BASE

(24) BARRIER WALL MARKERS, TYPE C (80' C-C)

(25) COMBINATION CONCRETE CURB AND GUTTER, TYPE B-6.12

(26) COMBINATION CONCRETE CURB AND GUTTER, TYPE M-2.24

(27) COMBINATION CONCRETE CURB AND GUTTER, TYPE M-4.24

(28) COMBINATION CONCRETE CURB AND GUTTER, TYPE M-4.48 (MODIFIED)

29 PIPE UNDERDRAINS 6"

(30) RETAINING WALL

(31) MODIFIED EXISTING RETAINING WALL

(32) SAND BACKFILL

(33) GUARDRAIL

TOPSOIL FURNISH AND PLACE / SEEDING (SEE LANDSCAPING PLANS FOR DETAILS)

LONGITUDINAL SAWED OR CONSTRUCTION JOINT. FOR LONGITUDINAL SAWED JOINT, POUR IN PLACE NO. 6 DEFORMED EPOXY TIE BARS 30" LONG AT 30" C-C. FOR LONGITUDINAL CONSTRUCTION JOINT, DRILL AND GROUT NO. 8 DEFORMED EPOXY TIE BARS 24" LONG AT 24" C-C. (SHALL BE INCLUDED IN THE COST OF C.R.P.C.C. PAVEMENT 14")

LONGITUDINAL CONSTRUCTION JOINT.
DRILL AND GROUT NO, 6 DEFORMED EPOXY TIE BARS 24" LONG AT 24" C-C.
(SHALL BE INCLUDED IN THE COST OF THE APPLICABLE COMB, CONC. CURB AND GUTTER TYPE)

LONGITUDINAL CONSTRUCTION JOINT.
DRILL AND GROUT NO. 8 DEFORMED EPOXY TIE BARS 24" LONG AT 24" C-C.
(SHALL BE INCLUDED IN THE COST OF P.C.C. BASE COURSE 9")

LONGITUDINAL CONSTRUCTION JOINT.
DRILL AND GROUT NO. 8 DEFORMED EPOXY TIE BARS 30" LONG AT 24" C-C.
(SHALL BE INCLUDED IN THE COST OF THE APPLICABLE P.C.C. SHOULDERS TYPE)

B WENTWORTH AVE VARIES** VARIES ** MATCH³ EXIST. EXISTING FRONTAGE ROAD 25) *** (22)

RAMP

- 47A

- 43C

- 43A

- 39D

VARIES**

EXISTING

FRONTAGE ROAL

VARIES**

±1%*

(SEE "PROPOSED FRONTAGE ROAD PARTIAL RECONSTRUCTION")

VARIES**

PROPOSED

RAMP

FRONTAGE ROAD RAMP TERMINAL

STATION

28+00.37 TO 29+96.92

30+71.79 TO 32+10.62

54+44.95 TO 56+23.80

FRONTAGE ROAD RAMP GORE

37 4 11 9 8 7

VARIES**

PROPOSED

<u>S</u>	TATI	ON		RAME
27+44.09	ΤO	28+00.37	_	43C
32+10.62	ΤO	32+55.42		43A
53+97.30	ΤO	54+44.95	-	39D

PROPOSED FRONTAGE ROAD PAVEMENT REDUCTION

STA, 5071+93 TO 5073+94

- 1. SEE ROADWAY DETAILS FOR VARIABLE HEIGHT OF THE DOUBLE FACE BARRIER WALL AND FOR THE TYING OF THE BARRIER BASE TO THE PCC SHOULDER AND FOR THE LIMITS OF CONSTRUCTION OF THE SUB-BASE GRANULAR MATERIAL UNDER THE DOUBLE FACE BARRIER WALL.
- 2. SHOULDER RUMBLE STRIPS SHALL BE CONSTRUCTED IN THE PROPOSED AND EXISTING SHOULDERS OF THE LOCAL AND EXPRESS LANES ACCORDING TO IDOT STANDARD 642001.
- 3. TYPICAL SECTIONS NEED TO BE VERIFIED WITH THE ROADWAY PLANS AS THEY ARE A REPRESENTATION OF THE PLANS, THEY DO NOT SHOW ALL CONFIGURATIONS, JUST THE MOST PREDOMINANT.
- ** SEE PLAN SHEETS FOR DETAILS

PRTYP-8

CHECKED BY: RS

ILLINOIS DEPARTMENT OF TRANSPORTATION F.A.I. 94/90 (DAN RYAN EXPRESSWAY) GARFIELD BLVD TO 31ST STREET (SB LOCAL LANES) PROPOSED TYPICAL SECTIONS SCALE: NTS DRAWN BY: JDC

DATE: 06/09/06


BOWMAN, BARRETT & ASSOCIATES INC. CONSULTING ENGINEERS Chicago, Illinois 312.228.0100

VARIES**

EXISTING

FRONTAGE ROAD

VARIES**

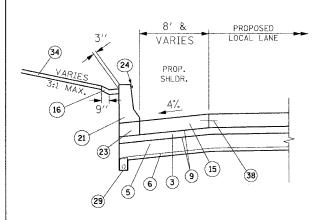

EARTH RETAINING LOCAL

LANE BARRIER WALL

STA, 3551+50 TO 3555+50

STA. 3605+57 TO 3608+44

STA. 3609+47 TO 3616+89

STA. 3618+95 TO 3621+84

STA. 3622+70 TO 3625+49

STA. 3628+02 TO 3629+96

EARTH RETAINING LOCAL LANE BARRIER WALL ADJACENT TO EXISTING PAVEMENT

(15)

8′ &

VARIES

PROP

SHLDR.

4%

EXISTING

LOCAL LANE

STA. 3629+96 TO 3635+14

34 VARIOUS RAMPS VARIES 3:1 MAX. 16 9" 4/. 21 23 9 33 38


EARTH RETAINING RAMP BARRIER WALL

RAMP STATION 43C - 7050+84.05 TO 7053+65.86 T39A - 5022+67.53 TO 5024+32.53 35A - 5002+54.93 TO 5004+04.93 31D - 7004+63.75 TO 7006+73.62

B WENTWORTH AVE 101 1'-6" MIN ** & VARIES & VARIES ** & VARIES MATCH EXISTING SLOPE EXISTING ±1% FRONTAGE ROAD ** VARIES 11 (36) 9 10 7 37 (8) (9)

RECONSTRUCTION WITH RETAINING WALL

STA. 5065+29.90 TO 17+95.20 STA, 33+18.14 TO 37+68.14

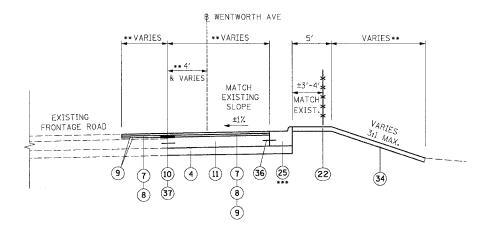

PROPOSED FRONTAGE ROAD PARTIAL RECONSTRUCTION

STA. 5070+19.63 TO 5071+93 STA. 26+99.07 TO 27+44.09 STA. 32+55.42 TO 33+18.14 STA. 53+66.73 TO 53+97.30

NOTES:

- 1. SEE ROADWAY DETAILS FOR VARIABLE HEIGHT OF THE DOUBLE FACE BARRIER WALL AND FOR THE TYING OF THE BARRIER BASE TO THE PCC SHOULDER AND FOR THE LIMITS OF CONSTRUCTION OF THE SUB-BASE GRANULAR MATERIAL UNDER THE DOUBLE FACE BARRIER WALL.
- SHOULDER RUMBLE STRIPS SHALL BE CONSTRUCTED IN THE PROPOSED AND EXISTING SHOULDERS
 OF THE LOCAL AND EXPRESS LANES ACCORDING TO IDOT STANDARD 642001.
- 3. TYPICAL SECTIONS NEED TO BE VERIFIED WITH THE ROADWAY PLANS AS THEY ARE A REPRESENTATION OF THE PLANS. THEY DO NOT SHOW ALL CONFIGURATIONS, JUST THE MOST PREDOMINANT.

PROPOSED LEGEND

F.A.I. SECTION COUNTY TOTAL SHEET NO.

94/90 • COOK 588 28

STA. TO STA.

FED. ROAD DIST. NO. | ILLINOIS | FED. AID | PROJECT

62303 • (2021-922 PT2 ETC 2324.6-1P) R-11

CONTINUOUSLY REINFORCED PORTLAND CEMENT CONCRETE PAVEMENT 14" AND PAVEMENT REINFORCEMENT 14"

2 STABILIZED SUB-BASE 4"

3 STABILIZED SUB-BASE 6"

SUB-BASE GRANULAR MATERIAL, TYPE B 6"

(5) SUB-BASE GRANULAR MATERIAL, TYPE B 24"

(6) GEOTECHNICAL FABRIC FOR GROUND STABILIZATION

BITUMINOUS CONCRETE SURFACE COURSE, SUPERPAVE, MIX "D" N70, 11/2"

8) POLYMERIZED LEVELING BINDER (MACHINE METHOD), SUPERPAVE, IL-4.75, N50, 1"

BITUMINOUS MATERIALS (PRIME COAT)

(10) STRIP REFLECTIVE CRACK CONTROL TREATMENT

(1) PORTLAND CEMENT CONCRETE BASE COURSE 91/2"

12 PORTLAND CEMENT CONCRETE PAVEMENT 11" (JOINTED)

(13) PORTLAND CEMENT CONCRETE SHOULDERS 11'

(14) NOT USED

(4)

15) PORTLAND CEMENT CONCRETE SHOULDERS 14"

(16) CONCRETE GUTTER, TYPE B

(17) CONCRETE MEDIAN SURFACE, 5" (MODIFIED)

(18) CONCRETE MEDIAN SURFACE, 6" (SPECIAL)

(19) CONCRETE MEDIAN SURFACE, 6"

CONCRETE BARRIER, DOUBLE FACE, 32" HEIGHT

(21) CONCRETE BARRIER, SINGLE FACE, 32" HEIGHT

(22) CHAIN LINK FENCE, 4' (SPECIAL)

23) BARRIER BASE

(20)

(29)

(24) BARRIER WALL MARKERS, TYPE C (80' C-C)

(25) COMBINATION CONCRETE CURB AND GUTTER, TYPE B-6,12

26 COMBINATION CONCRETE CURB AND GUTTER, TYPE M-2.24

(27) COMBINATION CONCRETE CURB AND GUTTER, TYPE M-4.24

(28) COMBINATION CONCRETE CURB AND GUTTER, TYPE M-4.48 (MODIFIED)

PIPE UNDERDRAINS 6"

(30) RETAINING WALL

(31) MODIFIED EXISTING RETAINING WALL

(32) SAND BACKFILL

(33) GUARDRAIL

) TOPSOIL FURNISH AND PLACE / SEEDING (SEE LANDSCAPING PLANS FOR DETAILS)

LONGITUDINAL SAWED OR CONSTRUCTION JOINT, FOR LONGITUDINAL SAWED JOINT, POUR IN PLACE NO. 6 DEFORMED EPDXY TIE BARS 30" LONG AT 30" C-C. FOR LONGITUDINAL CONSTRUCTION JOINT, DRILL AND GROUT NO. 8 DEFORMED EPOXY TIE BARS 24" LONG AT 24" C-C. (SHALL BE INCLUDED IN THE COST OF C.R.P.C.C. PAVEMENT 14")

LONGITUDINAL CONSTRUCTION JOINT.
DRILL AND GROUT NO. 6 DEFORMED EPOXY TIE BARS 24" LONG AT 24" C-C.
(SHALL BE INCLUDED IN THE COST OF THE APPLICABLE COMB. CONC. CURB AND GUTTER TYPE)

(SHALL BE INCLUDED IN THE COST OF P.C.C. BASE COURSE 9")

LONGITUDINAL CONSTRUCTION JOINT.
DRILL AND GROUT NO. 8 DEFORMED EPOXY TIE BARS 30" LONG AT 24" C-C.
(SHALL BE INCLUDED IN THE COST OF THE APPLICABLE P.C.C. SHOULDERS TYPE)

PRTYP-9

REVISIONS		
NAME.	DATE	
REVISED	6/23/06	
		

ILLINOIS DEPARTMENT OF TRANSPORTATION

A.I. 94/90 (DAN RYAN EXPRESSWAY)

ARFIELD BLVD TO 31ST STREET (SB LOCAL LANES)


PROPOSED TYPICAL SECTIONS

SCALE: NTS DATE: 06/09/06 DRAWN BY: JDC CHECKED BY: RS

BOWMAN, BARRETT & ASSOCIATES INC.


CONSULTING ENGINEERS
Chicago, Illinois
312 228 0100
www.bbandainc.com

** SEE PLAN SHEETS FOR DETAILS

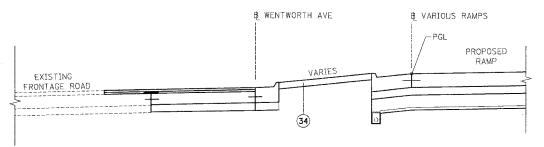


PROPOSED UPPER RAMP GROUND TREATMENT

RAMPS: 43C, 39D

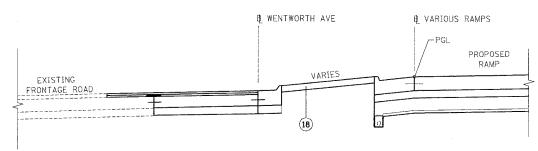


PROPOSED UPPER RAMP GROUND TREATMENT

RAMPS: 43A

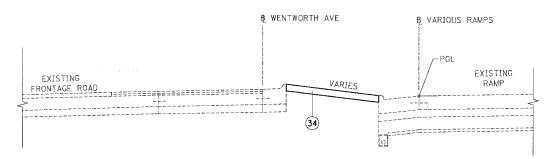

PROPOSED UPPER RAMP GROUND TREATMENT

RAMPS: T35D, T39A, 35A, 31D

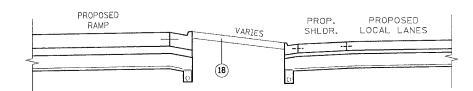

PROPOSED LOWER RAMP GROUND TREATMENT

STATION	K	<u>AMP</u>	
(PAVED ATTENUATOR PAD)	-	47A	
7053+75.16 TO 7054+50.54		43C	
5043+15.19 TO 5043+02.73	-	43A	
7044+85.05 TO 7045+64.71		39D	
7043+29.85 TO 7043+55.03		T35D	
5023+75.91 TO 5023+90.86		T39A	
(PAVED ATTENUTAOR PAD)		35A	
7004+64.38 TO 7004+89.50	-	31D	

NOTES:

- 1. SEE ROADWAY DETAILS FOR VARIABLE HEIGHT OF THE DOUBLE FACE BARRIER WALL AND FOR THE TYING OF THE BARRIER BASE TO THE PCC SHOULDER AND FOR THE LIMITS OF CONSTRUCTION OF THE SUB-BASE GRANULAR MATERIAL UNDER THE DOUBLE FACE BARRIER WALL.
- SHOULDER RUMBLE STRIPS SHALL BE CONSTRUCTED IN THE PROPOSED AND EXISTING SHOULDERS
 OF THE LOCAL AND EXPRESS LANES ACCORDING TO IDOT STANDARD 642001.
- 3. TYPICAL SECTIONS NEED TO BE VERIFIED WITH THE ROADWAY PLANS AS THEY ARE A REPRESENTATION OF THE PLANS. THEY DO NOT SHOW ALL CONFIGURATIONS, JUST THE MOST PREDOMINANT.
 - ** SEE PLAN SHEETS FOR DETAILS

F.A.I.	SECTION	1	COUN	ΓΥ	TOTAL SHEETS	SHEET NO.		
94/90	•		C00	<	588 29			
STA.		Ţ	O STA.					
FED. ROAD	DIST. NO.	ILLIN0	IS FED.	AID	PROJECT			

PROPOSED LEGEND

62303 • (2021-922 PT2 ETC 2324.6-1P) R-11
CONTINUOUSLY REINFORCED PORTLAND CEMENT CONCRETE
PAVEMENT 14" AND PAVEMENT REINFORCEMENT 14"

2) STABILIZED SUB-BASE 4"

3 STABILIZED SUB-BASE 6"

(4) SUB-BASE GRANULAR MATERIAL, TYPE B 6"

5) SUB-BASE GRANULAR MATERIAL, TYPE B 24"

6) GEOTECHNICAL FABRIC FOR GROUND STABILIZATION

BITUMINOUS CONCRETE SURFACE COURSE, SUPERPAVE, MIX "D" N70, 1/2"

8 POLYMERIZED LEVELING BINDER (MACHINE METHOD), SUPERPAVE, IL-4.75, N50, 1"

9 BITUMINOUS MATERIALS (PRIME COAT)

10) STRIP REFLECTIVE CRACK CONTROL TREATMENT

(11) PORTLAND CEMENT CONCRETE BASE COURSE 91/2"

(12) PORTLAND CEMENT CONCRETE PAVEMENT 11" (JOINTED)

(13) PORTLAND CEMENT CONCRETE SHOULDERS 11"

(14) NOT USE

(15) PORTLAND CEMENT CONCRETE SHOULDERS 14"

(16) CONCRETE GUTTER, TYPE B

(17) CONCRETE MEDIAN SURFACE, 5" (MODIFIED)

(18) CONCRETE MEDIAN SURFACE, 6" (SPECIAL)

(19) CONCRETE MEDIAN SURFACE, 6"

CONCRETE BARRIER, DOUBLE FACE, 32" HEIGHT

21) CONCRETE BARRIER, SINGLE FACE, 32" HEIGHT

22) CHAIN LINK FENCE, 4' (SPECIAL)

23 BARRIER BASE

(24) BARRIER WALL MARKERS, TYPE C (80' C-C)

(25) COMBINATION CONCRETE CURB AND GUTTER, TYPE B-6.12

(26) COMBINATION CONCRETE CURB AND GUTTER, TYPE M-2.24

(27) COMBINATION CONCRETE CURB AND GUTTER, TYPE M-4.24

(28) COMBINATION CONCRETE CURB AND GUTTER, TYPE M-4.48 (MODIFIED)

29 PIPE UNDERDRAINS 6"

(30) RETAINING WALL

SO RETAINING WALL

31) MODIFIED EXISTING RETAINING WALL

32 SAND BACKFILL

(33) GUARDRAIL

34) TOPSOIL FURNISH AND PLACE / SEEDING (SEE LANDSCAPING PLANS FOR DETAILS)

LONGITUDINAL SAWED OR CONSTRUCTION JOINT, FOR LONGITUDINAL SAWED JOINT, POUR IN PLACE NO. 6 DEFORMED EPOXY TIE BARS 30" LONG AT 30" C-C. FOR LONGITUDINAL CONSTRUCTION JOINT, DRILL AND GROUT NO. 8 DEFORMED EPOXY TIE BARS 24" LONG AT 24" C-C. (SHALL BE INCLUDED IN THE COST OF C.R.P.C.C. PAVEMENT 14")

LONGITUDINAL CONSTRUCTION JOINT.
DRILL AND GROUT NO. 6 DEFORMED EPOXY TIE BARS 24" LONG AT 24" C-C.
(SHALL BE INCLUDED IN THE COST OF THE APPLICABLE COMB. CONC. CURB AND GUTTER TYPE)

LONGITUDINAL CONSTRUCTION JOINT.
DRILL AND GROUT NO. 8 DEFORMED EPOXY TIE BARS 24" LONG AT 24" C-C.
(SHALL BE INCLUDED IN THE COST OF P.C.C. BASE COURSE 9")

LONGITUDINAL CONSTRUCTION JOINT.
DRILL AND GROUT NO. 8 DEFORMED EPOXY TIE BARS 30" LONG AT 24" C-C.
(SHALL BE INCLUDED IN THE COST OF THE APPLICABLE P.C.C. SHOULDERS TYPE)

PRTYP-10

REVISIONS
NAME DATE

F.A.I. 94/90 (DAN RYAN EXPRESSWAY)

GARFIELD BLVD TO 31ST STREET (SB LOCAL LANES)

PROPOSED TYPICAL SECTIONS

SCALE: NTS DRAWN BY: JDC
DATE: 06/09/06 CHECKED BY: RS

BOWMAN, BARRETT & ASSOCIATES INC.
CONSULTING ENGINEERS
Chicago, Illinois
312, 228, 0100

THE CEE DIAM CHEETE FOR DETAILS

ROADWAY REMOVAL SCHEDULE

			BITUMINOUS SURFACE REMOVAL 2-1/2"	PAVEMENT REMOVAL	COMBINATION CURB AND GUTTER REMOVAL	CONCRETE BARRIER REMOVAL	MEDIAN REMOVAL	PAVED SHOULDER REMOVAL	GUARDRAIL REMOVAL	TEMPORARY CONCRETE BARRIER REMOVAL	LUG SYSTEM REMOVAL	IMPACT ATTENUATOR REMOVAL
STATION	то	STATION	SQ YD	SQ YD	FOOT	FOOT	SQFT	SQ YD	FOOT	FOOT	EACH	EACH
3475+50.00	ТО	3479+00.00	0	1,665	350	64	0	100	156	242	0	0
3479+00.00	TO	3491+00.00	0	6,952	1,200	71	0	0	0	1,122	0	1
3491+00.00	ТО	3503+00.00	0	6,243	1,198	27	0	5	0	1,077	0	0
3503+00.00	TO	3515+00.00	0	7,904	1,203	0	0	0	0	1,199	0	0
3515+00.00	ТО	3526+00.00	0	8,048	1,119	0	0	212	0	562	0	2
3526+00.00	TO	3529+00.00	0	1,925	615	0	0	296	0	230	0	0
3529+00.00	TO	3541+00.00	1036	10871	4426	0	5277.6	516	132	89	0	0
3541+00.00	TO	3533+00.00	325	9582	2618	49	1734.5	828	201	945	0	0
3533+00.00	ТО	3565+00.00	1109	10304	2693	31	3815.3	187	157	1285	0	0
3565+00.00	ТО	3577+00.00	0	8904	3694	23	1969.8	756	235	1370	0	0
3577+00.00	ТО	3589+00.00	289	4907	3213	69	2043.9	985	307	1193	2	0
3589+00.00	то	3601+00.00	0	8335	3025	27	0	686	107	1163	0	0
3601+00.00	то	3613+00.00	0	8570	2629	41	0	36	229	1018	0	0
3613+00.00	то	3625+00.00	0	8532	3099	29	0	84	225	1105	0	0
3625+00.00	то	3637+00.00	0	4702	1604	0	0	160	0	1013	0	0
3637+00.00	то	3638+05.00	0	427	0	0	0	0	0	0	0	0
		TOTALS	2,759	107,871	32,686	431	14,841	4,851	1,749	13,613	2	3

CURB AND GUTTER SCHEDULE

							·	
			CONCRETE GUTTER, TYPE B	COMBINATION CONCRETE CURB & GUTTER, TYPE B-6.12	COMBINATION CONCRETE CURB & GUTTER, TYPE M-2.24	COMBINATION CONCRETE CURB & GUTTER, TYPE M-4.48 (MODIFIED)	COMBINATION CONCRETE CURB & GUTTER, TYPE M-4.12	COMBINATION CONCRETE CURB & GUTTER, TYPE M-4.24
STATION	то	STATION	FOOT	FOOT	FOOT	FOOT	FOOT	FOOT
3475+50.00	то	3479+00.00	0	0	0	0	0	0
3479+00.00	то	3491+00.00	0	0	0	285	0	0
3491+00.00	то	3503+00.00	0	0	0	127	0	928
3503+00.00	то	3515+00.00	0	0	0	995	0	24
3515+00.00	то	3526+00.00	0	0	0	113	0	629
3526+00.00	то	3529+00.00	0	0	0	0	0	225
3529+00.00	то	3541+00.00	0	887	239	533	283	1365
3541+00.00	то	3533+00.00	372	300	0	894	0	777
3533+00.00	то	3565+00.00	266	583	288	684	0	1192
3565+00.00	TO	3577+00.00	0	0	320	524	0	843
3577+00.00	то	3589+00.00	0	31	339	592	0	843
3589+00.00	то	3601+00.00	0	0	0	278	0	1016
3601+00.00	то	3613+00.00	828	0	0	0	0	410
3613+00.00	то	3625+00.00	1038	0	0	0	0	139
3625+00.00	ТО	3637+00.00	943	0	0	0	0	75
3637+00.00	то	3638+05.00	0	0	0	0	0	00
	ļ		**************************************	T	r	7	,	
		TOTALS	3,445	1,801	1,186	5,025	283	8,467

| F.A.I. SECTION | COUNTY | STATE | SHEET | SALE |

62303 • (2021-922 PT2 ETC 2324.6-1P) R-11

SCH-01

	SCH-01		
	ILLINOIS DEPARTMENT OF TRANSPORTATION	DATE	REVISIONS NAME
ď	F.A.I. 94/90 (DAN RYAN EXPRESSWAY)	DATE 6/23/06	REVISED SHEET
2.26.48	GARFIELD BLVD TO 31ST STREET (SB LOCAL LANES)		
7	ROADWAY SCHEDULES		
2006]		
23/20	SCALE: NTS DRAWN BY: RA		
Š	DATE: 06/09/06 CHECKED BY: RS	 	

BOWMAN, BARRETT & ASSOCIATES INC.
CONSULTING ENGINEERS
Chicago, Illinois
312 228 0100
www.bbandainc.com

LANDSCAPING SCHEDULE

			TREE REMOVAL (6 TO 15 UNITS DIAMETER)	TREE REMOVAL (OVER 15 UNITS DIAMETER)	SUPPLEMENTAL WATERING	TOPSOIL FURNISH AND PLACE, 4"	TOPSOIL FURNISH AND PLACE, 12"	COMPOST FURNISH AND PLACE, 6"	SEEDING CLASS 2A	NITROGEN FERTILIZER NUTRIENT	PHOSPHOROUS FERTILIZER NUTRIENT	POTASSIUM FERTILIZER NUTRIENT	SEEDING, CLASS 4 (MODIFIED)	EROSION CONTROL BLANKET	VINE-PARTHENOCISSUS QUINQUEFOLIA (VIRGINIA CREEPER), 1-GALLON POT	VINE-PARTHENOCISSUS TRICUSPIDATA (BOSTON IVY), 1-GALLON POT	SEEDING, CLASS 5A (MODIFIED)	WEED CONTROL	
STATION	то	STATION	UNIT	UNIT	UNIT	SQ YD	SQ YD	SQ YD	ACRE	POUND	POUND	POUND	ACRE	SQ YD	EACH	EACH	ACRE	POUND	
3475+50.00	то	3482+00.00	0	0	0	0	3	3	0.00	1	1	1	0.00	3	5	0	0.00	1.00	
3482+00.00	то	3506+00.00	0	0	60	942	1,561	1,561	0.52	47	47	47	0.00	2,503	40	16	0.00	1.00	
3506+00.00	TO	3529+00.00	0	0	179	3,477	3,992	3,992	0.98	135	133	133	0.48	7,469	285	68	0.48	10.00	
3529+00.00	то	3553+00.00	216	506	258	6,040	4,698	4,698	1.72	200	200	200	0.5	10,738	0	210	0.50	2.90	
3553+00.00	то	3577+00.00	385	252	389	7,803	8,393	8,393	1.82	302	302	302	1.5	16,196	43	17	1.54	0.80	
3577+00.00	то	3601+00.00	163	16	312	6,371	6,590	6,590	2.01	241	241	241	0.7	12,961	0	0	0.67	0.00	
3601+00.00	то	3625+00.00	0	0	243	3,551	6,579	6,579	2.10	189	189	189	0.0	10,130	370	260	0.00	8.80	
3625+00.00	то	3638+05.00	0	0	92	1,488	2,354	2,354	0.80	72	72	72	0.0	3,842	0	320	0.00	4.50	
		TOTALS	764	774	1,534	29,672	34,170	34,170	9.95	1,187	1,185	1,185	3.19	63,842	743	891	3.19	29.00	

EROSION CONTROL SCHEDULE

			SEDIMENT CONTROL, SILT FENCE	SEDIMENT CONTROL, SILT FENCE MAINTENANCE	INLET FILTERS	SEDIMENT CONTROL, DRAINAGE STRUCTURE INLET FILTER CLEANING	TEMPORARY EROSION CONTROL SEEDING	MOWING
STATION	то	STATION	FOOT	FOOT	EACH	EACH	POUND	ACRE
3475+50.00	то	3482+00.00	0	0	12	24	0	0.00
3482+00.00	то	3506+00.00	1,290	323	44	88	1,612	0.52
3506+00.00	то	3529+00.00	1,794	449	46	92	4,650	1.87
3529+00.00	то	3553+00.00	2,257	564	66	132	7,286	2.3
3553+00.00	то	3577+00.00	2,625	656	62	124	10,513	3.4
3577+00.00	то	3601+00.00	2,444	611	55	110	3,159	2.6
3601+00.00	то	3625+00.00	2,394	599	65	130	2,319	2.2
3625+00.00	TO	3638+05.00	871	218	32	64	944	0.9
		TOTALS	13,675	3,419	382	764	30,484	13.76

F.A.I.	SECTION	COUNTY	TOTAL SHEETS	SHEET NO.
94/90	*	COOK	588	31
STA.		TO STA.		

FED. ROAD DIST. NO. | ILLINOIS | FED. AID PROJECT 62303 * (2021-922 PT2 ETC 2324.6-1P) R-11

			SCH-02
REVISIONS		THI TNOTS DEPAR	TMENT OF TRANSPORTATION
NAME	DATE		
REVISED SHEET	6/23/06	F.A.I. 94/90 (C	DAN RYAN EXPRESSWAY)
		GARFIELD BLVD TO 3	31ST STREET (SB LOCAL LANES)
		ROADWA	Y SCHEDULES
		SCALE: NTS	DRAWN BY: RA
		DATE: 06/09/06	CHECKED BY: RS

BOWMAN, BARRETT & ASSOCIATES INC.
CONSULTING ENGINEERS
Chicago, Illinois
312 222 8.0100
www.bbandainc.com

F.A.I. SECTION	N COUNTY	TOTAL	SHEET NO.
94/90 *	COOK	588	32
STA.	TO STA.		
FED. ROAD DIST. NO.	ILLINOIS FED. AID	PROJECT	-

62303 • (2021-922 PT2 ETC 2324,6-1P) R-11

ROADWAY ITEMS SCHEDULE

STATION		STATION	<pre> GEOTECHNICAL FABRIC FOR GROUND STABILIZATION </pre>	S SUB-BASE GRANULAR → MATERIAL, TYPE B 12"	SUB-BASE GRANULAR MATERIAL, TYPE B 24"	STABILIZED SUB-BASE 4"	© 5 P.C.C. BASE COURSE 9-1/2"	CONTINUOUSLY REINFORCED PORTLAND CEMENT CONCRETE PAVEMENT 14"	S P.C.C. PAVEMENT 11" d (JOINTED)	B P.C.C. SHOULDERS 11"	SHOULDER RUMBLE STRIP	BITUMINOUS CONCRETE SURFACE COURSE, SUPERPAVE, MIX 'D'', NTO (1-1/2")	POLYMERIZED LEVELING BINDER (MACHINE METHOD), SUPERPAVE, IL 4.75, N50 (1")	P.C.C. SHOULDERS 14"	STABILIZED SUB-BASE 6"	S PAVEMENT	BITUMINOUS MATERIALS PRIME COAT)	AGGREGATE 2 (PRIME COAT)
3475+50.00	ТО	3479+00.00	1,940	1,478	462	0	0	1,478	0	0	1,400	0	0.0	323	1,940	1,478	0.8	3.9
3479+00.00	ТО	3491+00.00	8,005	6,091	1,914	0	0	6,092	0	0	4,389	0	0.0	1,425	8,005	6,092	3.3	16.1
3491+00.00	ТО	3503+00.00	7,348	5,220	2,128	0	0	5,221	0	0	4,573	0	0.0	1,462	7,348	5,221	3.0	14.7
3503+00.00	ТО	3515+00.00	8,825	6,169	2,656	0	0	6,169	0	0	4,307	0	0.0	1,634	8,825	6,169	3.6	17.7
3515+00.00	TO	3526+00.00	8,223	6,398	1,825	0	0	6,399	0	0	4,300	0	0.0	1,408	8,223	6,399	3.3	16.5
3526+00.00	ТО	3529+00.00	2,436	1,679	1,757	0	0	1,680	0	0	1,187	0	0.0	608	2,436	1,680	1.0	4.9
3529+00.00	ТО	3541+00.00	12,445	8,657	3,788	1,529	777	8,657	1,155	0	4,541	153.5	102.3	2,551	12,445	8,657	30.6	5.5
3541+00.00	ТО	3553+00.00	9,490	6,053	3,437	1,575	126	6,053	1,105	134	3,987	38.7	25.8	1,602	9,490	6,053	23.7	1.4
3553+00.00	Τ0	3565+00.00	10,217	5,966	4,251	1,490	1,029	5,966	1,046	3	4,609	181.1	120.8	1,862	10,217	5,966	26.0	6.5
3565+00.00	Т0	3577+00.00	9,456	6,125	3,332	1,145	0	6,125	820	0	3,836	0.0	0.0	2,340	9,456	6,125	22.5	0.0
3577+00.00	TO	3589+00.00	8,492	5,932	2,560	683	2,334	5,932	472	0	4,270	57.8	38.6	2,066	8,492	5,932	19.9	2.1
3589+00.00	ТО	3601+00.00	8,991	5,207	3,784	636	0	5,207	481	0	4,569	0.0	0.0	1,997	8,991	5,207	20,5	0.0
3601+00.00	ТО	3613+00.00	9,905	6,656	3,249	432	0	6,656	293	85	4,178	0.0	0.0	1,600	9,905	6,656	22.0	0.0
3613+00.00	ТО	3625+00.00	9,692	6,830	2,863	378	0	6,830	267	78	4,088	0.0	0.0	2,115	9,692	6,830	21.4	0.0
3625+00.00	TO	3637+00.00	3,941	2,182	1,759	522	0	2,182	374	93	4,382	0.0	0.0	2,085	3,941	2,182	9.5	0.0
3637+00.00	TO	3638+05.00	0	0	0	0	0	0	0	0	2,039	0.0	0.0	427	0	0	0.0	0.0
		TOTAL	119,406	80,641	39,765	8,390	4,265	80,645	6,013	394	60,655	431.1	287.5	25,506	119,406	80,645	211	89

REVISIONS
NAME
REVISED SHEET 6/23/06

REVISED SHEET 6/23/06

F.A.I. 94/90 (DAN RYAN EXPRESSWAY) GARFIELD BLVD TO 31ST STREET (SB LOCAL LANES)

SCH-03

ROADWAY SCHEDULES

SCALE: NTS

DRAWN BY: RA CHECKED BY: RS

BOWMAN, BARRETT & ASSOCIATES INC.
CONSULTING ENGINEERS
Chicago, Illinois
312.228.0100
www.bbandainc.com

| F.A.I. | SECTION | COUNTY | SHEET | NO. | | 94/90 | COOK | 588 | 33 | | STA. | TO STA. | | FED. ROAD DIST. NO. | ILLINOIS | FED. AID | PROJECT |

62303 * (2021-922 PT2 ETC 2324.6-1P) R-11

MEDIAN SCHEDULE

			SAND BACKFILL	CONCRETE MEDIAN SURFACE 6 INCH (SPECIAL)	CONCRETE MEDIAN SURFACE 5 INCH (MODIFIED)
STATION	то	STATION	CUYD	SQFT	SQ FT
3475+50.00	TO	3479+00.00	39	475	0
3479+00.00	то	3491+00.00	0	415	0
3491+00.00	то	3503+00.00	0	0	0
3503+00.00	то	3515+00.00	617	7,781	0
3515+00.00	то	3526+00.00	214	2,975	0
3526+00.00	то	3529+00.00	0	0	0
3529+00.00	то	3541+00.00	0	2,040	1,826
3541+00.00	то	3533+00.00	0	335	808
3533+00.00	то	3565+00.00	0	1,256	1,308
3565+00.00	то	3577+00.00	0	1,294	1,392
3577+00.00	то	3589+00.00	0	1,022	1,887
3589+00.00	то	3601+00.00	0	103	0
3601+00.00	то	3613+00.00	0	75	0
3613+00.00	то	3625+00.00	0	675	. 0
3625+00.00	то	3637+00.00	0	359	0
3637+00.00	то	3638+05.00	0	0	0
		TOTALS	870	18,805	7,221

PAVEMET MARKING SCHEDULE

			POLYUREA PAVEMENT MARKING TYPE I- LETTERS & SYMBOLS	POLYUREA PAVEMENT MARKING TYPE I - LINE 4"	POLYUREA PAVEMENT MARKING TYPE I - LINE 5"	POLYUREA PAVEMENT MARKING TYPE I - LINE 8"	POLYUREA PAVEMENT MARKING TYPE I - LINE 12"	POLYUREA PAVEMENT MARKING TYPE I - LINE 24"	RAISED REFLECTIVE PAVEMENT MARKER	RAISED REFLECTIVE PAVEMENT MARKER (BRIDGE)
STATION	TO	STATION	SQFT	FOOT	FOOT	FOOT	FOOT	FOOT	EACH	EACH
3475+50.00	ТО	3482+00.00	0	2,612	818	0	83	0	85	0
3482+00.00	TO	3506+00.00	0	8,782	3,003	1,628	376	0	323	0
3506+00.00	TO	3529+00.00	0	7,515	2,475	5,488	717	0	295	0
3529+00.00	то	3553+00.00	127	6,945	2,951	9,481	1,897	36	360	0
3553+00.00	то	3577+00.00	0	8,181	3,178	3,150	380	23	280	0
3577+00.00	то	3601+00.00	55	8,453	2,400	2,749	1,158	0	244	4
3601+00.00	то	3625+00.00	0	8,525	3,538	2,388	298	0	374	0
3625+00.00	TO	3638+05.00	0	5,671	2,310	1,958	451	0	232	0
FRANKLIN CO	NNEC'	TOR	0	0	1361	27	380	0	0	0
		TOTALS	182	56,684	22,034	26,869	5,739	59	2,193	4

SCH-04

CHECKED BY: RS

							-	3CH 04
REVISIONS		TI I	INOIS DEP	ARTME	NT OF TR	ANSPOR	TATI	ΩN
NAME	DATE	16	MOLD DEL	71 \ 1 IVIL	0, 110	A1131 011	1 1 1 1	··•
REVISED SHEET	6/23/06	F.A.I.	94/90	(DAI	N RYAN	EXPF	RESS	SWAY)
*****		GARFIELD	BLVD TO	315	T STREET	(SB LC	CAL	LANES)
			ROADW	ΑY	SCHEDU	LES		
		SCALE:	NTS			DRAWN E	Y: R	łA.

SAFETY SCHEDULE

			STEEL PLATE BEAM GUARDRAIL, TYPE A	TRAFFIC BARRIER TERMINAL, TYPE 2	TRAFFIC BARRIER TERMINAL, TYPE 6	TRAFFIC BARRIER TERMINAL TYPE 1. SPECIAL (TANGENT)	CONCRETE BARRIER TRANSITION	GUARD RAIL MARKERS, TYPE A	BARRIER WALL MARKERS, TYPE C	TERMINAL MARKER, DIRECT APPLIED	BARRIER BASE	CONCRETE BARRIER, SINGLE FACE, 32" HEIGHT	CONCRETE BARRIER, DOUBLE FACE, 32" HEIGHT	CONCRETE BARRIER, SINGLE FACE, 32" HEIGHT (MODIFIED)	IMPACT ATTENUATOR (SEVERE USE, NARROW), TEST LEVEL 3
STATION	то	STATION	FOOT	EACH	EACH	EACH	FOOT	EACH	EACH	EACH	FOOT	FOOT	FOOT	FOOT	EACH
3475+50.00	то	3479+00.00	0	0	0	0	60	0	10	0	482	168	254	0	0
3479+00.00	то	3491+00.00	0	0	0	0	54	0	29	0	1,138	0	1,084	0	1
3491+00.00	то	3503+00.00	0	0	0	0	94	0	28	0	1,096	0	1,002	0	0
3503+00.00	то	3515+00.00	0	0	0	0	71	0	30	0	2,175	1,950	154	0	0
3515+00.00	то	3526+00.00	0	0	0	0	82	0	11	0	625	399	144	0	1
3526+00.00	то	3529+00.00	0	0	0	0	15	0	6	0	230	0	215	0	0
3529+00.00	то	3541+00.00	163	0	1	1		4	2	1	85	0	85	0	1
3541+00.00	то	3533+00.00	238	0	0	1	65	5	8	1	611	432	114	0	1
3533+00.00	то	3565+00.00	150	0	1	1	77	3	18	1	1,392	250	1,065	74	0
3565+00.00	то	3577+00.00	238	1	1	1	108	5	12	1	957	0	849	74	0
3577+00.00	TO	3589+00.00	100	0	1	2	104	2	14	2	1,076	15	957	87	0
3589+00.00	TO	3601+00.00	0	0	0	0	32	0	15	0	1,190	0	1,158	0	0
3601+00.00	то	3613+00.00	D	0	0	0	122	0	25	0	1,947	803	1,022	74	0
3613+00.00	TO	3625+00.00	0	0	1	1	120	0	28	1	2,237	1,074	1,043	57	0
3625+00.00	TO	3637+00.00	100	0	. 1	1	30	2	25	1	1,987	957	1,000	0	0
3637+00.00	TO	3638+05.00	0	0	0	0	0	0	0	0	0	0	0	0	0
								-							
		TOTALS	987.5	1	6	8	1,034	21	261	8	17,228	6,048	10,146	366	4

			PROTECTIVE COAT
STATION	то	STATION	SQ YD
3475+50.00	TO	3479+00.00	2,228
3479+00.00	TO	3491+00.00	8,605
3491+00.00	TO	3503+00.00	7,888
3503+00.00	TO	3515+00.00	10,859
3515+00.00	TO	3526+00.00	8,870
3526+00.00	TO	3529+00.00	2,537
3529+00.00	TO	3541+00.00	13,619
3541+00.00	TO	3533+00.00	9,879
3533+00.00	TO	3565+00.00	10,833
3565+00.00	TO	3577+00.00	11,017
3577+00.00	TO	3589+00.00	10,304
3589+00.00	TO	3601+00.00	9,081
3601+00.00	TO	3613+00.00	9,639
3613+00.00	TO	3625+00.00	10,295
3625+00.00	TO	3637+00.00	5,605
3637+00.00	TO	3638+05.00	427
		TOTALS	131,685

EARTHWORK SCHEDULE

							,			
) DISPOSAL OF MATERIAL	TION	TION (SPECIAL)	EXCAVATION SHRINKAGE*		BALANCE R SHORTAGE(-)	EXISTING GRANULAR	G GRANULAR	ULAR MATERIAL : (+) OR
		REMOVAL AND D UNSUITABLE MA`	EARTH EXCAVATION	EARTH EXCAVATION	TOTAL EARTH E ADJUSTED FOR	EMBANKMENT	EARTHWORK BAL WASTE(+) OR SF	EXCAVATE EXIST MATERIAL	PLACE EXISTING MATERIAL	EXISTING GRANULAR BALANCE WASTE (+) SHORTAGE(-)
STATION T	O STATION	CU YD	CU YD	CU YD	CU YD	CU YD	CU YD	CU YD	CU YD	CU YD
3475+50.00	3476+00.00	1	250	0	213	6	+207	12	71	-59
3476+00.00	3477+00.00	4	518	0	441	17	+424	23	141	-118
3477+00,00	3478+00.00	6	513	0	437	6	+431	23	141	-118
3478+00.00	3479+00.00	12	516	0	439	0	+439	23	141	-118
3479+00.00	3480+00.00	15	524	0	446	0	+446	23	141	-118
3480+00.00	3481+00.00	15	507	0	431	0	+431	23	141	-118
3481+00.00	3482+00.00	13	472	0	402	0	+402	23	141	-118
3482+00.00	3483+00.00	15	461	0	392	D	+392	23	141	-118
3483+00.00	3484+00.00	19	481	0	409	Ď	+409	23	141	-118
3484+00.00	3485+00.00	19	476	0	405	0	+405	23	141	-118
3485+00.00	3486+00.00	17	444	0	378	D	+378	23	141	-118
3486+00.00	3487+00.00	8	548	0	466	D	+466	27	195	-168
3487+00.00	3488+00.00	2	676	0	575	0	+575	32	245	-213
3488+00.00	3489+00.00	8	672	0	572	0	+572	32	234	-202
3489+00.00	3490+00.00	13	628	0	534	0	+534	32	217	-185
3490+00.00	3491+00.00	19	543	0	462	- 8	+454	32	197	-165
3491+00.00	3492+00.00	28	467	2	399	28	+371	32	176	-144
3492+00.00	3493+00.00	38	474	2	405	21	+384	32	158	-126
3493+00.00	3494+00.00	45	535	0	455	0	+455	32	145	-113
3494+00,00	3495+00.00	52	601	0	511	0	+511	27	141	-114
3495+00.00	3496+00.00	58	677	0	576	0	+576	23	141	-118
3496+00.00	3497+00.00	60	724	0	616	0	+616	23	141	-118
3497+00.00	3498+00.00	60	779	0	663	0	+663	23	1.41	-118
3498+00.00	3499+00.00	56	844	0	718	0	+718	23	141	-118
3499+00.00	3500+00.00	52	844	0	718	0	+718	23	141	-118
3500+00,00	3501+00.00	49	818	0	696	0	+696	23	141	-118
3501+00.00	3502+00.00	23	690	0	587	0	+587	23	141	-118
3502+00.00	3503+00.00	6	557	0	474	0	+474	23	141	-118
3503+00.00	3504+00.00	13	535	0	455	0	+455	23	141	-118
3504+00.00	3505+00.00	21	542	0	461	0	+461	23	141	-118
3505+00.00	3506+00.00	39	579	0	493	10	+483	23	145	-122
3506+00.00	3507+00.00	58	633	0	539	26	+513	23	152	-129
3507+00.00	3508+00.00	71	739	0	629	41	+588	23	160	-137
3508+00.00	3509+00.00	82	846	0	720	49	+671	23	167	-144
3509+00.00	3510+00.00	91	890	0	757	49	+708	23	175	-152
3510+00.00	3511+00.00	100	942	0	801	49	+752	23	182	-159
3511+00.00	3512+00.00	108	939	0	799	47	+752	23	189	-166
3512+00.00	3513+00.00	108 99	831	0	707	45 38	+662	23	197	-174
3513+00.00	3514+00.00		666	0	567 505		+529	23	204	-181
3514+00.00 3515+00.00	3515+00.00	86	594			21 10	+484	23 28	212 254	-189
3515+00.00	3516+00.00 3517+00.00	73 34	721 632	0	613 538		+603 +534	35	254	-226 -206
3517+00.00	3518+00.00	0	445	0	379	4	+379	35	182	-147
3518+00.00	3519+00.00		445	0	359		+359	34	167	-133
3519+00.00	3520+00.00	0	396	0	337	2	+335	34	154	-120
3520+00.00	3521+00.00	6	524	0	446	23	+423	34	173	-120
3521+00.00	3522+00.00	19	666	0	567	32	+535	34	191	-157
3522+00.00	3523+00.00	36	631	0	537	28	+509	40	186	-146
3523+00.00	3524+00.00	52	684	0	582	17	+565	48	186	-138
3524+00.00	3525+00.00	69	851	0	724	0	+724	49	186	-137
3525+00.00	3526+00.00	89	990	0	842	17	+825	49	186	-137
3526+00.00	3527+00.00	113	1,046	8	896	91	+805	49	186	-137
1	3528+00.00	128	1,168	8	1,000	75	+925	49	186	-137
3527+00.00										
3527+00.00 3528+00.00	3529+00.00	65	1,040	0	884	0	+884	48	186	-138

CONTINUED NEXT SHEET

SCH-05

DRAWN BY: RA

CHECKED BY: RS

COUNTY TOTAL SHEET NO.

COOK 588 34 문

F.A.I. SECTION

FED. ROAD DIST. NO. | ILLINOIS | FED. AID PROJECT | 62303 • (2021-922 PT2 ETC 2324.6-1P) R-11

94/90 *

REVISIONS
NAME DATE
REVISED SHEET 6/23/06
GARFIELD BLVD TO 31ST STREET (SB LOCAL LANES)
ROADWAY SCHEDULES

SCALE: NTS

DATE: 06/09/06

BOWMAN, BARRETT & ASSOCIATES INC.
CONSULTING ENGINEERS
Chicago, Illinois
312.228 0100
www.bbandainc.com

• THE SHRINKAGE FACTOR USED TO CALCULATE EARTHWORK QUANTITIES IS 15%. FACTOR IS FOR BOTH 'EARTH EXCAVATION' AND 'EARTH EXCAVATION (SPECIAL)' QUANTITIES.

		EAR	THWC	PRK S	CHED	ULE	·			T
		REMOVAL AND DISPOSAL OF UNSUITABLE MATERIAL	EARTH EXCAVATION	EARTH EXCAVATION (SPECIAL)	TOTAL EARTH EXCAVATION ADJUSTED FOR SHRINKAGE*	EMBANKMENT	EARTHWORK BALANCE WASTE(+) OR SHORTAGE(-)	EXCAVATE EXISTING GRANULAR MATERIAL	PLACE EXISTING GRANULAR MATERIAL	EXISTING GRANULAR MATERIAL BALANCE WASTE (+) OR SHORTAGE(-)
STATION TO STATION		CU YD	CU YD	CU YD	CU YD	CU YD	CU YD	CU YD	CU YD	CU YD
3529+00.00	3530+00.00	66	1,115	0	948	0	+948	67 65	186	-119
3530+00.00 3531+00.00	3531+00.00 3532+00.00	125 114	1,195 1,021	0	1,016 868	0 12	+1,016 +856	65 65	186 186	-121 -121
532+00.00	3533+00.00	105	1,209	0	1,028	12	+1,016	69	199	-130
533+00.00	3534+00.00	103	1,702	0	1,447	0	+1,447	73	219	-146
534+00.00	3535+00.00	103	2,134	0	1,814	0	+1,814	76	234	-158
535+00.00	3536+00.00	101	2,515	0	2,138	0	+2,138	80	239	-159
536+00.00	3537+00.00	89	2,746	0	2,335	0	+2,335	82	238	-156
537+00.00	3538+00.00	70	2,822	0	2,399	0	+2,399	99	238	-139
538+00.00	3539+00.00	60	2,669	0	2,269	0	+2,269	113	238	-125
539+00.00	3540+00.00	56	2,165	0	1,841	0	+1,841	110	238	-128
540+00.00 541+00.00	3541+00.00 3542+00.00	42 39	1,423 930	15 37	1,223 822	156 234	+1,067 +588	89 69	234 219	-145 -150
542+00.00	3543+00.00	46	743	43	669	301	+368	63	199	-136
543+00.00	3544+00.00	59	603	56	561	428	+133	60	184	-124
544+00.00	3545+00.00	84	529	56	498	355	+143	62	184	-122
545+00.00	3546+00.00	101	537	22	476	76	+400	63	200	-137
546+00.00	3547+00.00	111	561	0	477	0	+477	65	176	-111
547+00.00	3548+00.00	112	619	0	527	0	+527	69	141	-72
548+00.00	3549+00.00	110	879	0	748	0	+748	73	141	-68
549+00.00	3550+00.00	111	1,205	0	1,025	0	+1,025	62	141	-79
550+00.00	3551+00.00	115	1,455	0	1,237	0	+1,237	49	141	-92
551+00.00	3552+00.00	118	1,463	0	1,244	0	+1,244	49	141	-92
552+00.00	3553+00.00	122	1,225	0	1,042	0	+1,042	50	141	-91
553+00.00	3554+00.00	132	939	16	812	156	+656	52	141	-89
554+00.00	3555+00.00	145	889	31	782	202	+580	52	141	-89
555+00.00	3556+00.00	77	863	16	748	35	+713	49	141	-92
556+00.00 557+00.00	3557+00.00 3558+00.00	74	943	0	802	0	+802	50	145	-95
558+00.00	3559+00.00	140	1,211	0	1,030	0	+1,030	56 56	152	-96 -104
559+00.00	3560+00.00	120 108	1,374 1,531	0	1,168 1,302	0	+1,168	56 58	160 167	-104 -109
560+00.00	3561+00.00	109	1,611	0	1,370	0	+1,370	60	175	-115
561+00.00	3562+00.00	110	1,529	0	1,300	0	+1,300	62	178	-116
562+00.00	3563+00.00	106	1,171	24	1,016	147	+869	63	178	-115
563+00.00	3564+00.00	110	737	64	681	224	+457	71	178	-107
564+00.00	3565+00.00	129	600	40	544	74	+470	73	178	-105
565+00.00	3566+00.00	70	630	0	536	0	+536	65	200	-135
566+00.00	3567+00.00	76	832	0	708	0	+708	65	200	-135
567+00.00	3568+00.00	148	1,208	0	1,027	0	+1,027	67	178	-111
568+00.00	3569+00.00	144	1,358	0	1,155	0	+1,155	67	178	-111
569+00.00	3570+00.00	143	1,367	0	1,162	0	+1,162	67	178	-111
570+00.00	3571+00.00	137	1,235	23 59	1,070	175	+895	67	188	-121
571+00.00 572+00.00	3572+00.00 3573+00.00	134 133	1,024 880	68	921 806	238 259	+683 +547	67 69	200 173	-133 -104
573+00.00	3574+00.00	123	805	58	734	220	+514	73	141	-68
574+00.00	3575+00.00	108	911	26	797	38	+759	65	141	-76
575+00.00	3576+00.00	95	1,052	0	895	0	+895	54	141	-87
576+00.00	3577+00.00	98	908	0	772	0	+772	54	141	-87
577+00.00	3578+00.00	107	559	0	476	25	+451	56	141	-85
578+00.00	3579+00.00	109	433	45	407	251	+156	56	141	-85
3579+00.00	3580+00.00	123	511	107	526	405	+121	56	141	-85
3580+00.00	3581+00.00	147	613	89	597	351	+246	56	141	-85
3581+00.00	3582+00.00	80	519	26	464	39	+425	143	145	-2
3582+00.00	3583+00.00	0	439	0	374	0	+374	234	154	80

			EART	HWOR	K SC	HEDU	LE			
		REMOVAL AND DISPOSAL OF UNSUITABLE MATERIAL	EARTH EXCAVATION	EARTH EXCAVATION (SPECIAL)	TOTAL EARTH EXCAVATION ADJUSTED FOR SHRINKAGE*	EMBANKMENT	EARTHWORK BALANCE WASTE(+) OR SHORTAGE(-)	EXCAVATE EXISTING GRANULAR MATERIAL	PLACE EXISTING GRANULAR MATERIAL	EXISTING GRANULAR MATERIAL BALANCE WASTE (+) OR SHORTAGE(-)
STATION TO STATION		CU YD	CU YD	CU YD	CU YD	CU YD	CU YD	CU YD	CU YD	CU YD
3583+00.00	3584+00.00	56	711	0	605	0	+605	252	163	89
3584+00.00	3585+00.00	56	840	0	714	0	+714	273	171	102
3585+00.00 3586+00.00	3586+00.00 3587+00.00	27	766 600	0	652 510	0	+652 +510	284 476	180 191	104 285
3587+00.00	3588+00.00	27	400	0	340	0	+340	676	200	476
3588+00.00	3589+00.00	0	319	0	272			702	210	492
3589+00.00	3590+00.00	0	250		213	0	+272 +213	728	219	509
3590+00.00	3591+00.00	0	202	0	172	0	+172	773	234	539
3591+00.00	3592+00.00	0	130	0	111	0	+111	689	193	496
3592+00.00	3593+00.00	0	59	0	51	0	+51	575	141	434
3593+00.00	3594+00.00	0	25	0	22	0	+22	575	141	434
3594+00.00	3595+00.00	11	6	10	14	73	-+59	550	141	409
3595+00.00	3596+00.00	19	0	18	16	125	-+109	499	141	358
3596+00,00	3597+00.00	16	0	15	13	102	-+89	452	141	311
3597+00.00	3598+00.00	17	0	16	14	106	-+92	402	147	255
3598+00.00	3599+00.00	18	0	17	15	110	-+95	352	156	196
3599+00.00	3600+00.00	21	0	20	17	117	~+100	321	163	158
3600+00.00	3601+00.00	34	0	32	28	170	-+142	289	171	118
3601+00,00	3602+00.00	42	39	21	51	86	-+35	260	176	84
3602+00.00	3603+00.00	42	82	0	70	0	+70	239	178	61
3603+00.00	3604+00.00	36	61	0	52	0	+52	223	178	45
3604+00.00	3605+00.00	40	18	25	37	84	-+47	282	178	104
3605+00.00	3606+00.00	71	0	66	57	215	-+158	380	178	202
3606+00.00	3607+00.00	99	122	94	184	325	-+141	373	178	195
3607+00.00	3608+00.00	106	270	100	315	347	-+32	373	178	195
3608+00.00	3609+00.00	52	332	49	324	118	+206	365	178	187
3609+00.00	3610+00.00	64	526	0	448	0	+448	350	178	172
3610+00.00	3611+00.00	127	515	0	438	0	+438	569	178	391
3611+00.00	3612+00.00	123	355	0	302	0	+302	773	178	595
3612+00.00	3613+00.00	60	219	0	187	0	+187	789	178	611
3613+00.00	3614+00.00	45	139	0	119	0	+119	756	178	578
3614+00.00	3615+00.00	80	192	0	164	0	+164	675	178	497
3615+00.00	3616+00.00	63	130	0	111	0	+111	563	178	385
3616+00.00	3617+00.00	39	62	0	53	0	+53	476	178	298
3617+00.00	3618+00.00	41	20	28	41	94	-+53	562	178	384
3618+00.00	3619+00.00	70	0	66	57	192	-+135	678	178	500
3619+00.00	3620+00.00	80	0	75	64	330	-+266	671	178	493
3620+00.00	3621+00.00	89	120	84	174	411	-+237	556	178	378
3621+00,00	3622+00.00	49	359	47	346	142	+204	375	178	197
3622+00.00	3623+00.00	55	613	52	566	130	+436	312	178	134
3623+00.00	3624+00.00	109	708	102	689	274	+415	391	178	213
3624+00.00	3625+00.00	107	659	101	646	320	+326	454	178	276
3625+00.00	3626+00.00	105	504	99	513	275	+238	604	160	444
3626+00.00	3627+00.00	100	219	94	267	207	+60	863	141	722
3627+00.00	3628+00.00	48	41	45	74	58	+16	782	141	641
3628+00.00	3629+00.00	10	0	9	8	45	-+37	525	141	384
3629+00.00	3630+00.00	27	0	25	22	108	-+86	271	141	130
3630+00.00	3631+00.00	43	33	40	63	165	-+102	49	71	-22
3631+00.00	3632+00.00	41	71	38	93	144	-+51	15	0	15
3632+00.00 3633+00.00	3633+00.00 3634+00.00	36 51	74 74	34 48	92	95	-+3	15 15	0	15
3634+00.00	3635+00.00	30			104	133	-+29 +176			15
202440000	TOTAL	10,252	239 108,442	28 2,439	227 94 , 328	51 10 , 325	+176 84,003	15 28,818	26,713	15 2,105
	iviaL	1.0,534		£,7JJ	3 ,,320	10,020	,003	20,010	20,110	2,103

F.A.I.	SECTIO	N	COUN	ΓΥ	TOTAL	SHEET NO.
94/90	*		COOL	(588	35
STA.		1	O STA.			
FED. RO	AD DIST. NO.	ILLIN	OIS FED.	AID	PROJECT	

62303 * (2021-922 PT2 ETC 2324.6-1P) R-11

1. AVAILABLE QUANTITIES FOR 'EXCAVATE AND PLACE EXISTING GRANULAR MATERIAL' ARE ESTIMATED BASED ON EXISTING MATERIAL THICKNESSES OBTAINED FROM AS-BUILT DRAWINGS, AS SHOWN ON THE TYPICAL SECTIONS. IT WAS ASSUMED THAT 3" OF THE EXISTING SUBBASE GRANULAR MATERIAL THICKNESS WILL NOT MEET THE REQUIREMENTS OF THE SPECIAL PROVISION FOR 'EXCAVATE AND PLACE EXISTING GRANULAR MATERIAL', AND THIS REDUCTION IN AVAILABLE VOLUME IS REFLECTED IN THE PLAN QUANTITIES.

2. END AREAS SHOWN IN THE CROSS SECTIONS DO NOT REFLECT 'EXCAVATE AND PLACE EXISTING GRANULAR MATERIAL'. 'EARTH EXCAVATION' VOLUMES GIVEN IN THE EARTHWORK SCHEDULE HAVE BEEN ADJUSTED TO ACCOUNT FOR THE VOLUME OF 'EXCAVATE AND PLACE EXISTING GRANULAR MATERIAL'.

SCH-06


CHECKED BY: RS


REVISIONS
NAME DATE
REVISED SHEET 6/23/06 F.A.I. 94/90 (DAN RYAN EXPRESSWAY) ILLINOIS DEPARTMENT OF TRANSPORTATION GARFIELD BLVD TO 31ST STREET (SB LOCAL LANES) ROADWAY SCHEDULES SCALE: NTS DRAWN BY: RA


DATE: 06/09/06


BOWMAN, BARRETT & ASSOCIATES INC.
CONSULTING ENGINEERS
Chicago, illinois
312.228.0100


* THE SHRINKAGE FACTOR USED TO CALCULATE EARTHWORK QUANTITIES IS 15%. FACTOR IS FOR BOTH 'EARTH EXCAVATION' AND 'EARTH EXCAVATION (SPECIAL)' QUANTITIES.

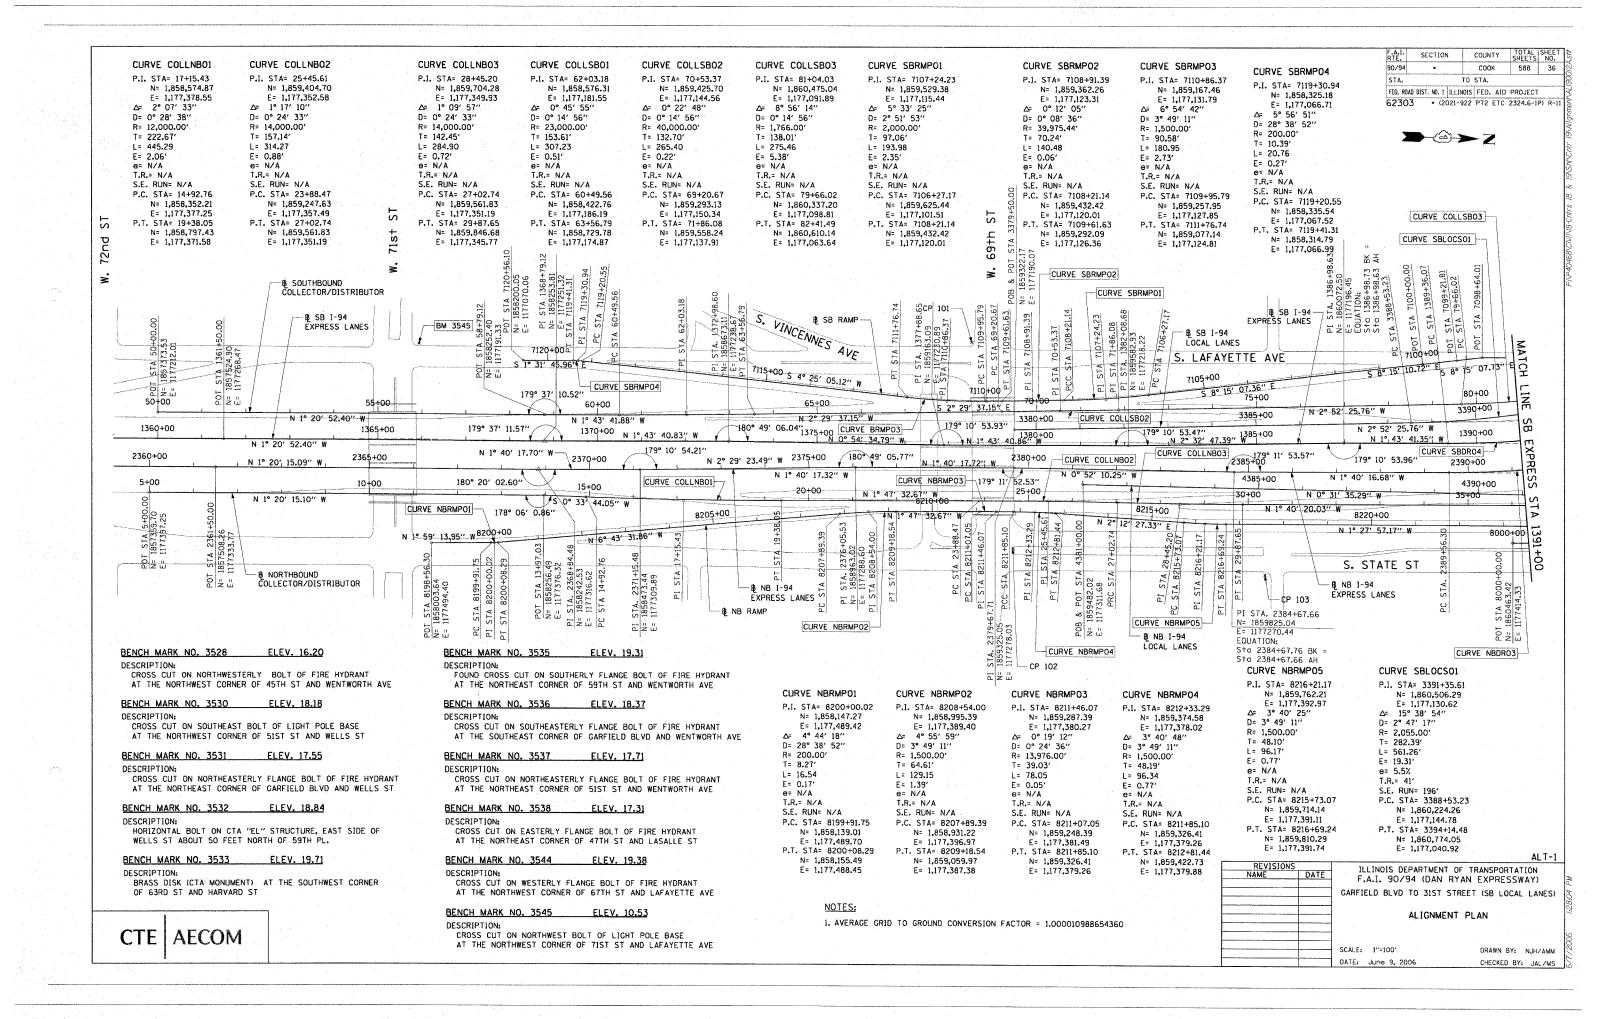


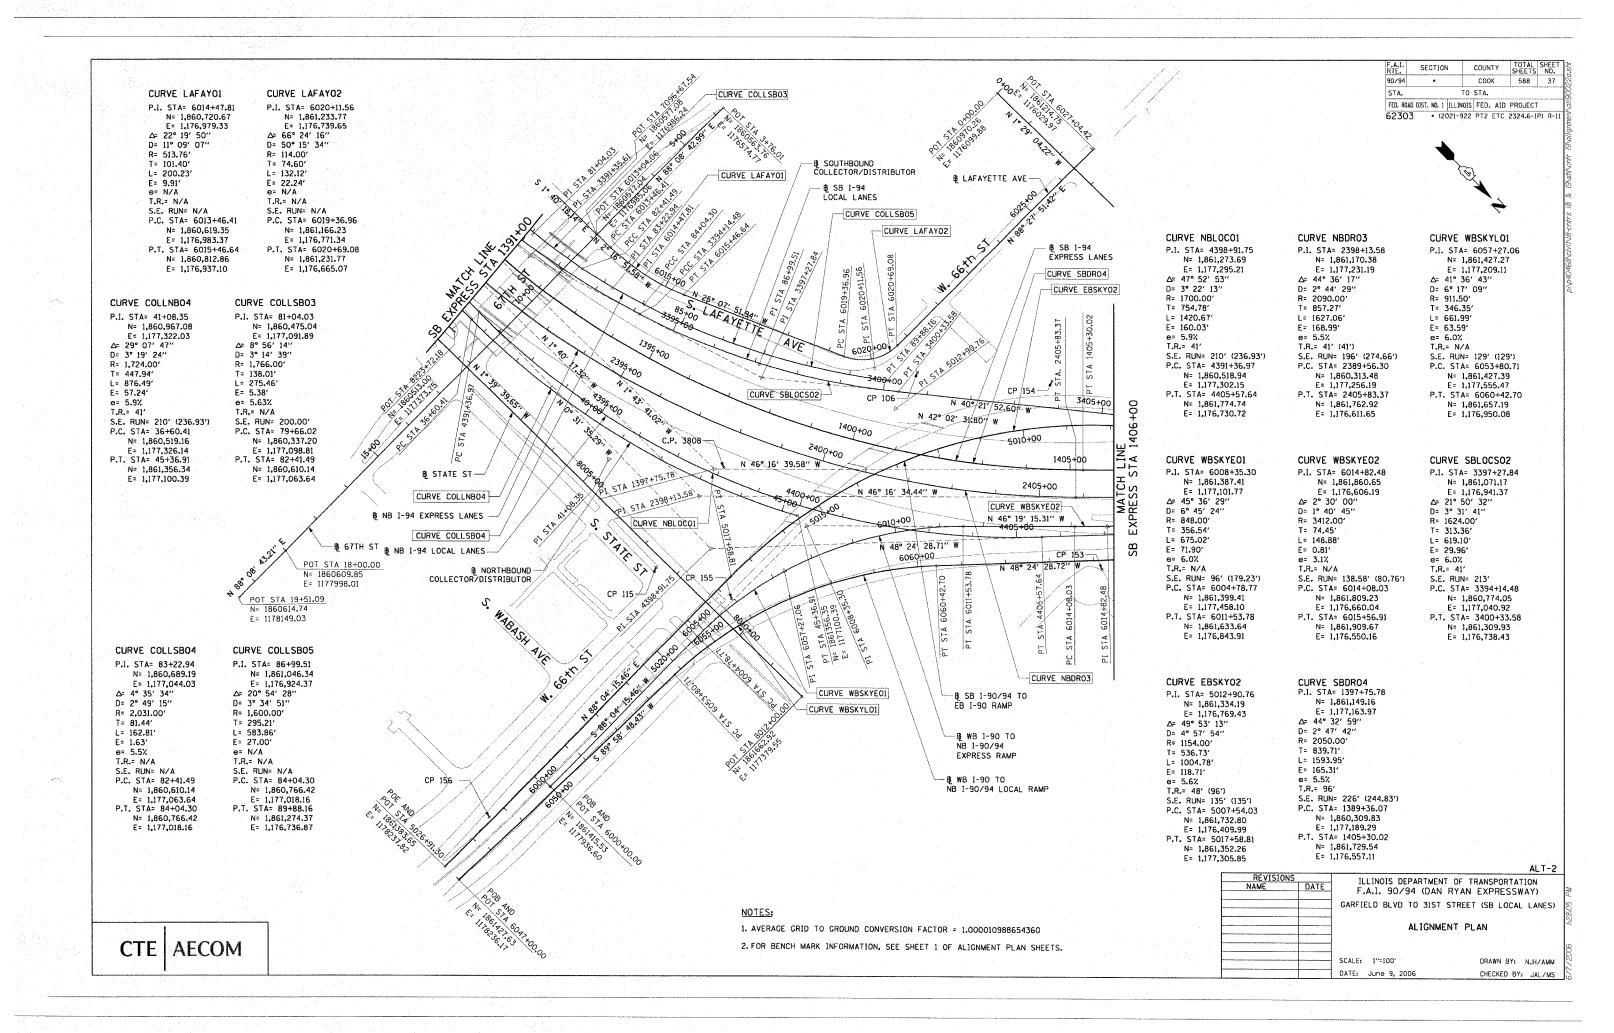


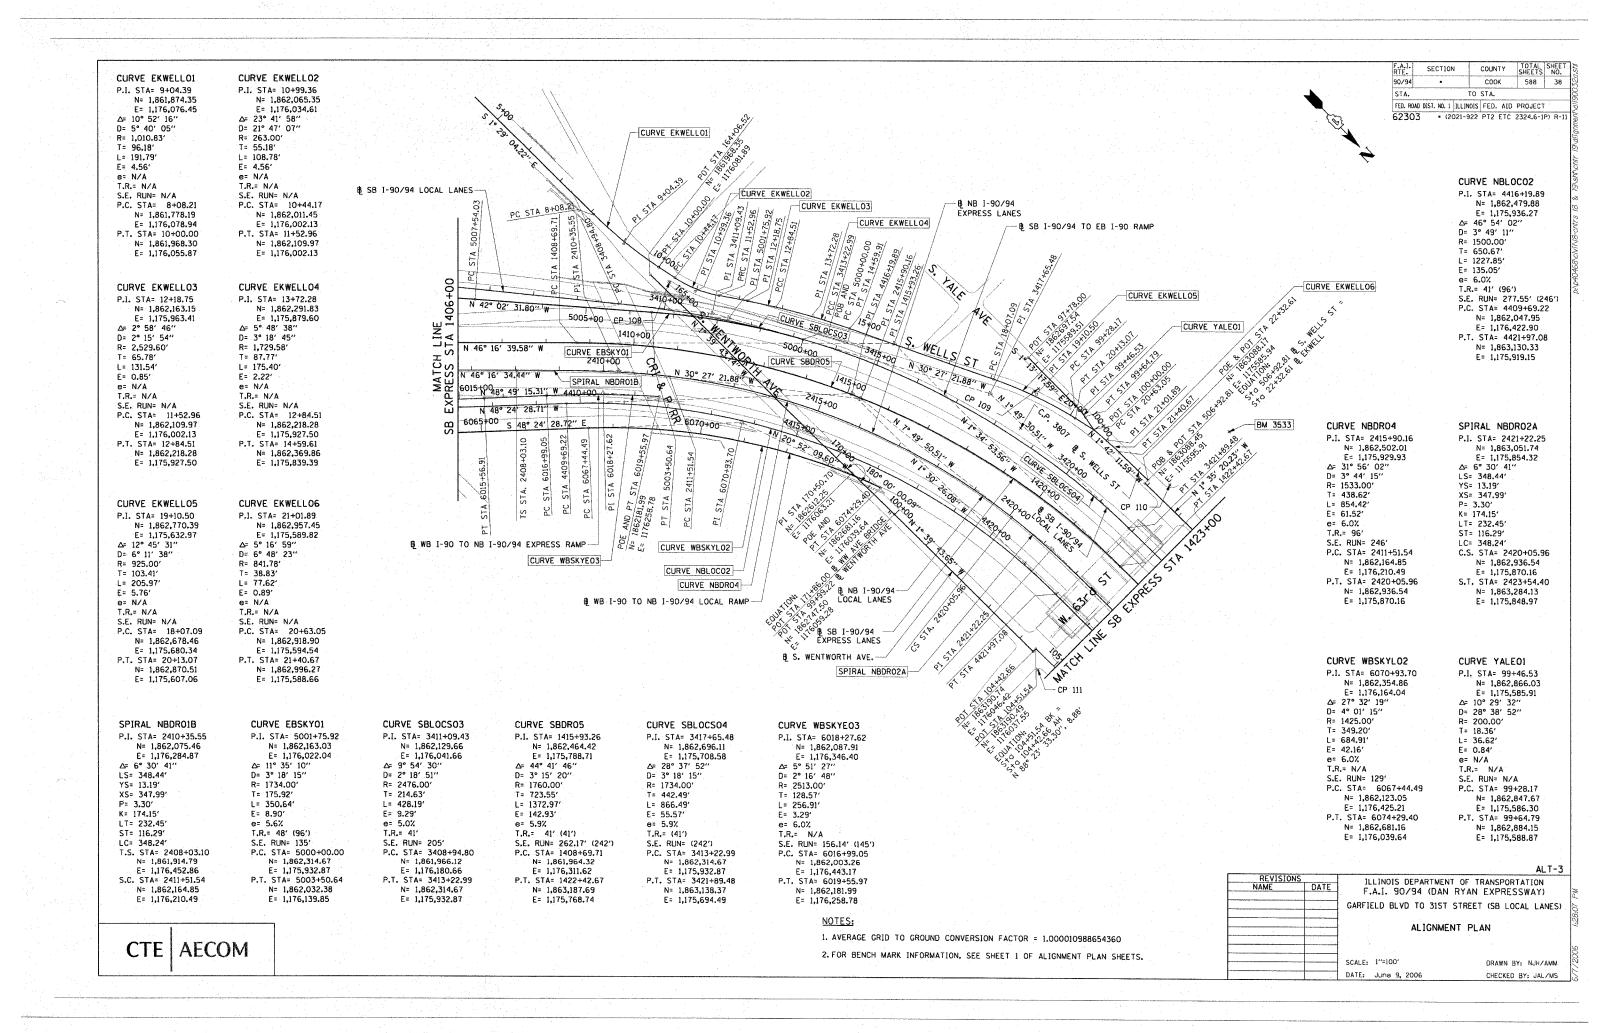

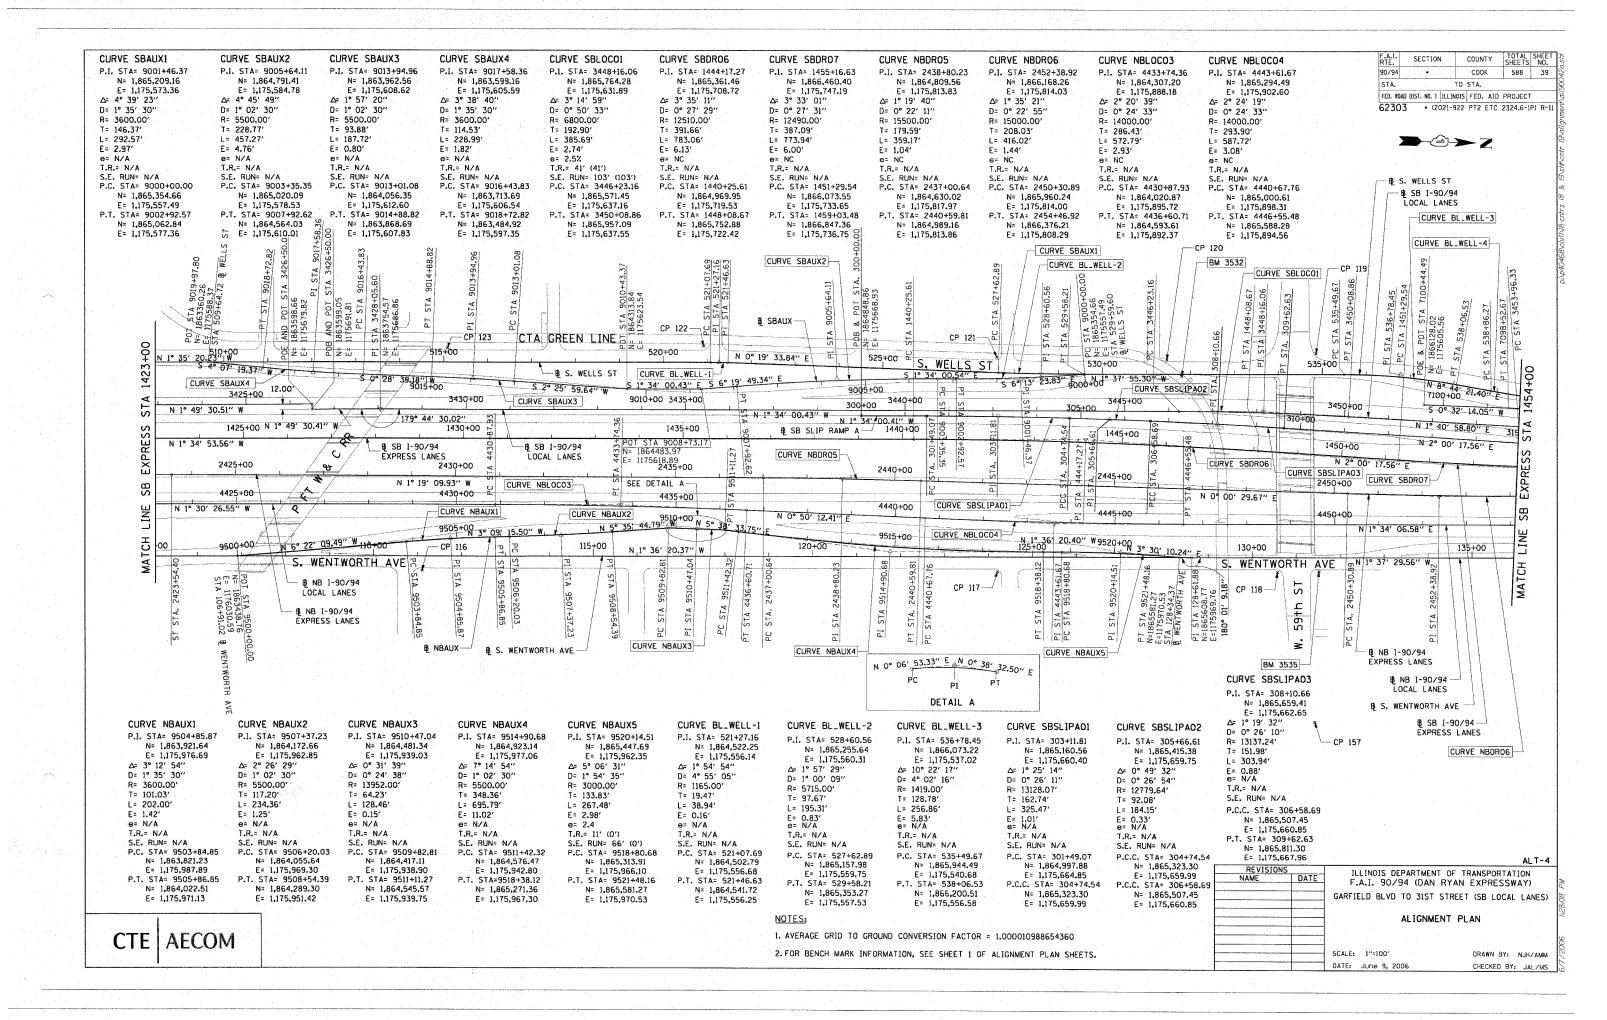

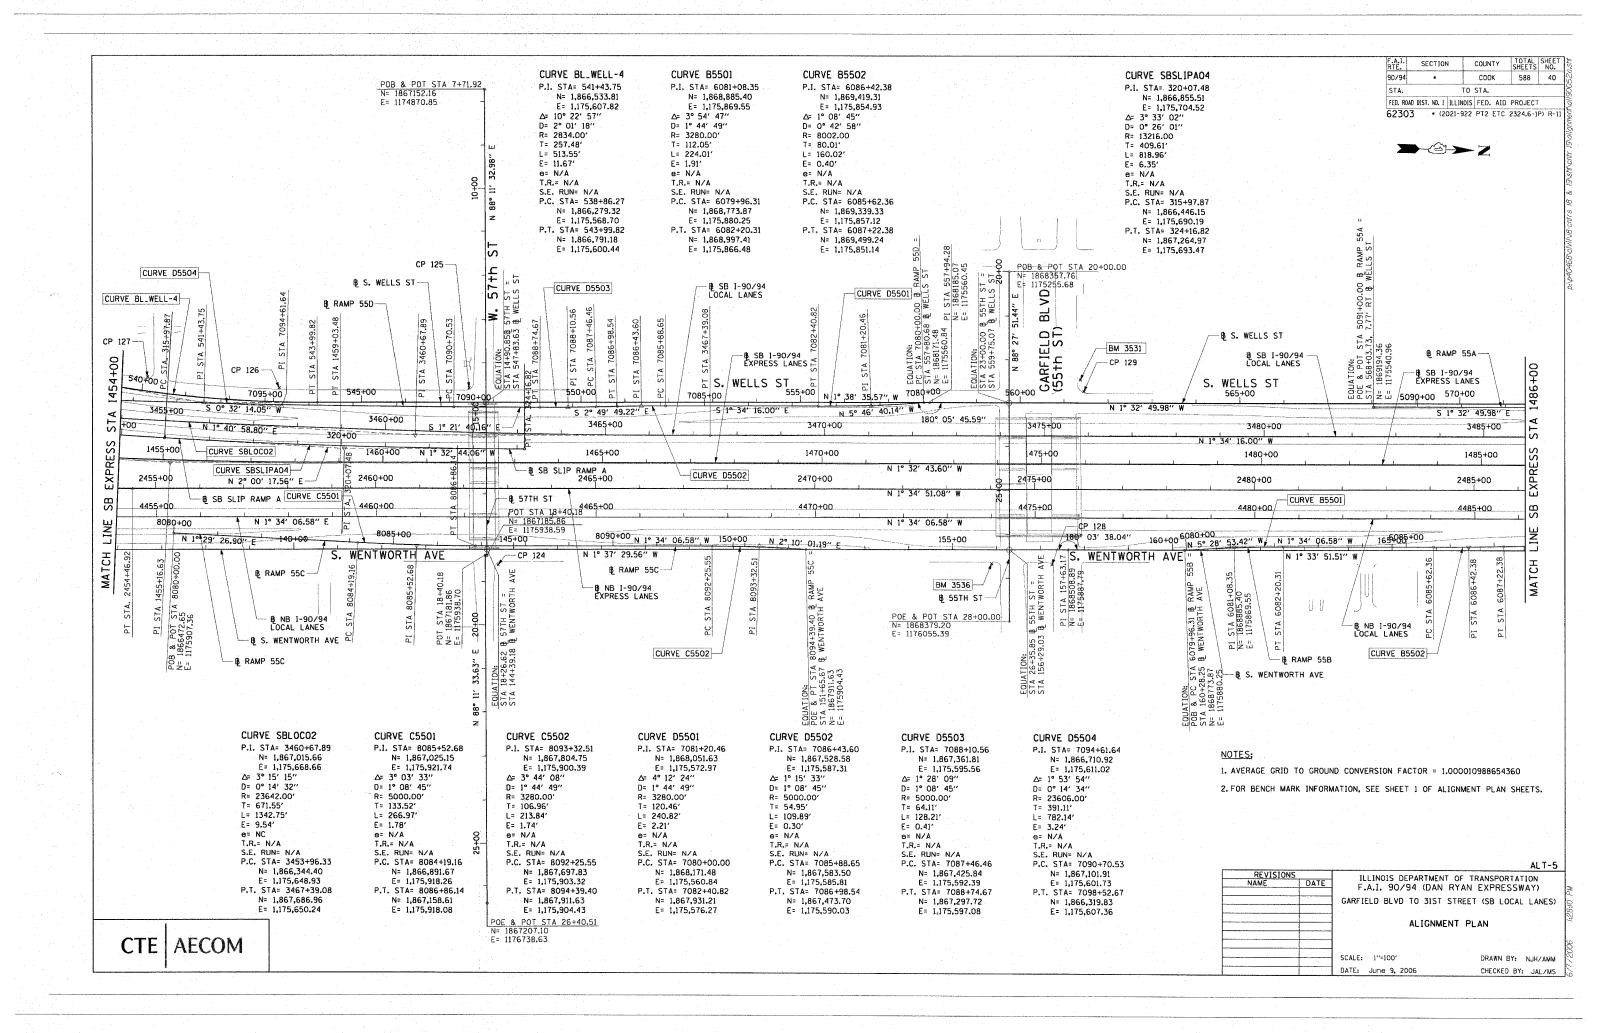

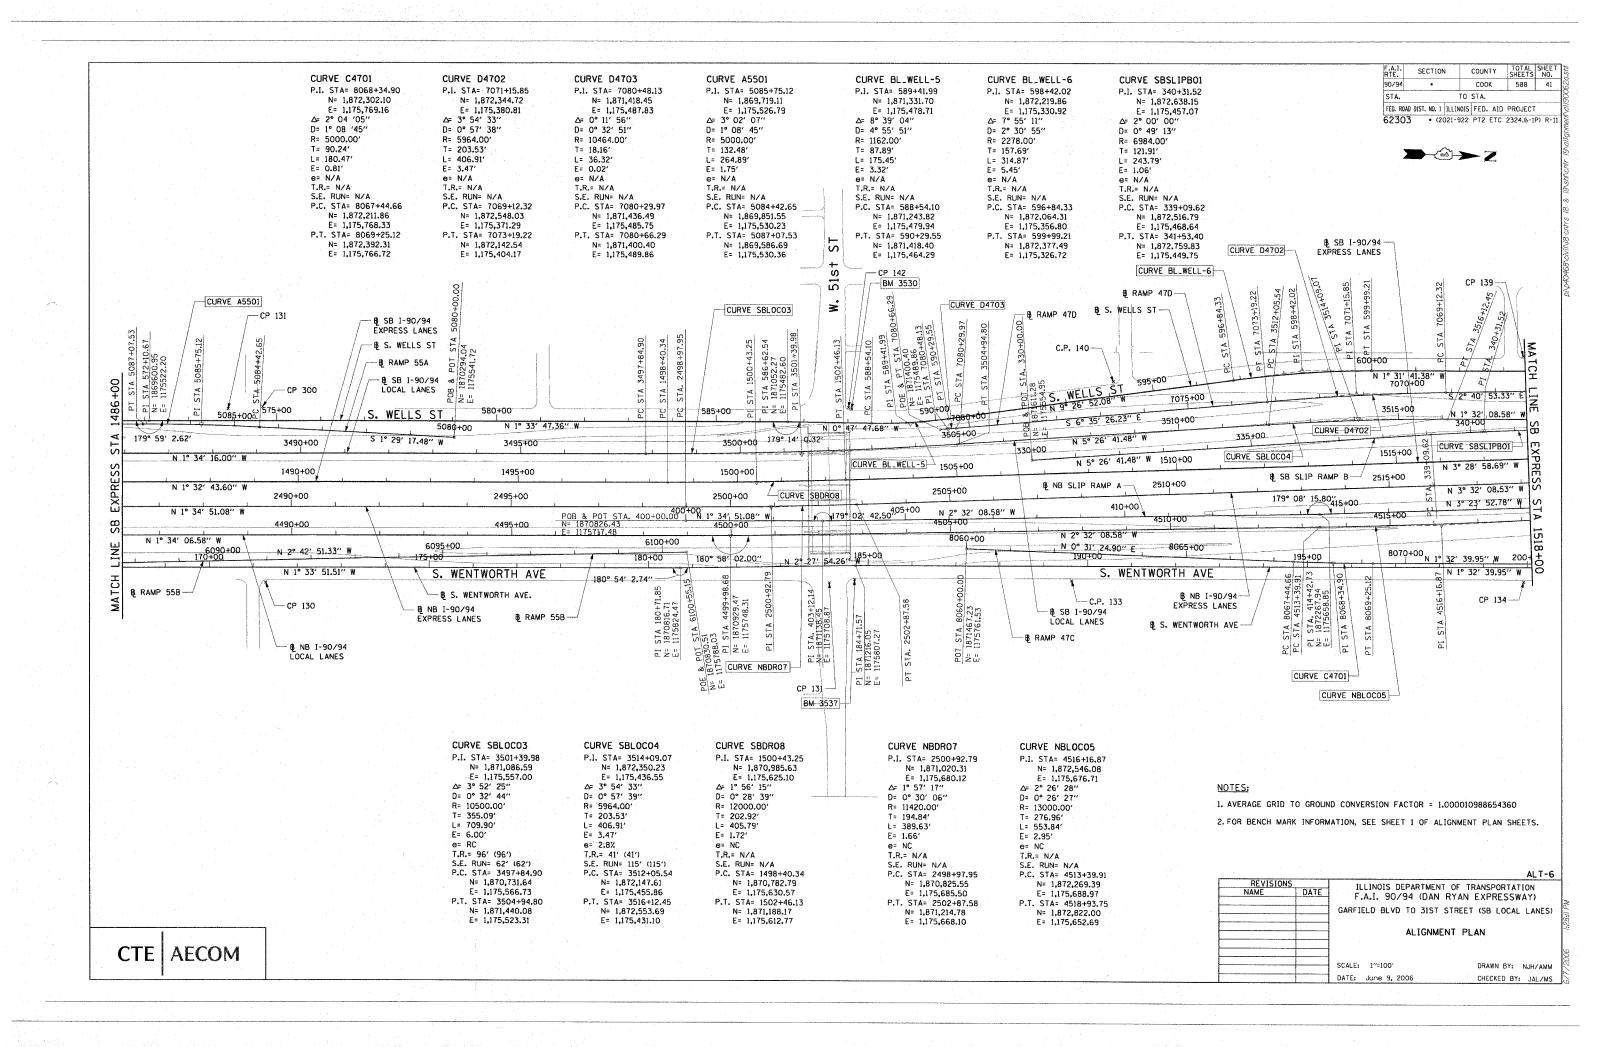

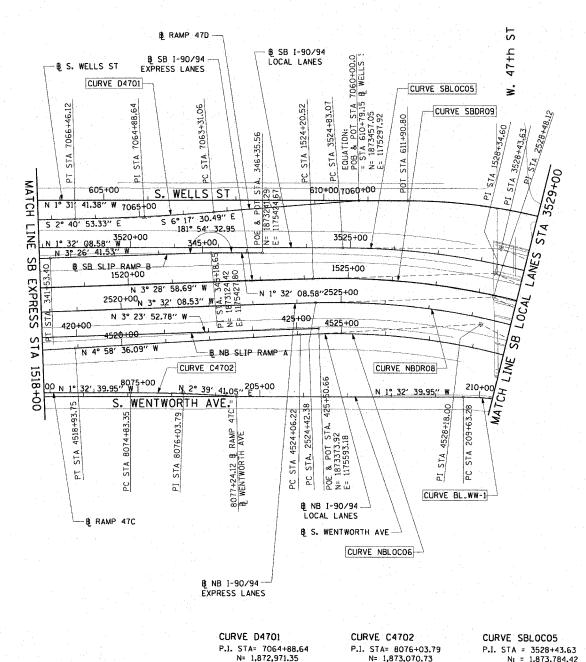

N= 1,872,971.35

E= 1,175,748.43

S.E. RUN= N/A P.C. STA= 8074+83.35

N= 1,872,950.33

E= 1,175,751.68

E= 1,175,754.03

P.T. STA= 8077+24.12 N= 1,873,191.04

Δ= 4° 12′ 21″ D= 1° 44′ 49″

R= 3280,00'

T= 120.44'

L= 240,77

T.R.= N/A

E= 2.21'

e= N/A

E= 1,175,351,47

S.E. RUN= N/A P.C. STA= 7063+31.06

N= 1,873,127.98

E= 1,175,334.20

N= 1,872,813.94

E= 1,175,358.84

P.T. STA= 7066+46.12

Δ= 3° 36′ 37″ D= 1° 08′ 45″

R= 5000.00'

T= 157.58'

L= 315.06

T.R.= N/A

E= 2.48'

e= N/A

TOTAL SHEE SHEETS NO. SECTION COUNTY COOK 90/94 588 STA. TO STA. FED. ROAD DIST. NO. 1 ILLINOIS FED. AID PROJECT

62303 • (2021-922 PT2 ETC 2324.6-1P) R-1



CURVE SBDR09 P.I. STA = 3528+43.63 P.I. STA = 1528+34.60 N: = 1,873,771.86 E: = 1,175,455.52 N: = 1.873.784.42

E: = 1,175,398.10 $\Delta = 23^{\circ} 47' 11'' (RT)$ D = 3° 20' 48" R = 1.712.00'T = 360.56'

L = 710.73' E = 37.56' e = 5.7% S.A. = STA 3522+04.49 TO STA 3526+01.07 T.R. = 42.58'

S.E. RUN = 354.00' S.R. = BEGIN CONTINUOUSLY ROTATING PLANE AT STA 3530+92.51 P.C. STA = 3524+83.07 N: = 1,873,423.99

E: = 1,175,407.76 P.T. STA = 3531+93.80 N: = 1,874,118.14 E: = 1,175,534.63

L = 812.35' E = 49.71'e = 5.7%S.A. = STA 1521+84.22 TO STA 1525+21.75 T.R. = 33.53" S.E. RUN = 304.00' S.R. = BEGIN CONTINUOUSLY ROTATING PLANE AT STA 1531+40.60 P.C. STA = 1524+20.52 N: = 1,873,358.54 E: = 1,175,480.67 P.T. STA = 1532+32.87 N: = 1,874,150,45

E: = 1,175,623.26

 $\Delta = 27^{\circ} 22' 45'' (RT)$

D = 3° 22′ 13″

R = 1.700.00'

T = 414.09'

P.I. STA = 2528+48.12 N: = 1,873,770.44 E: = 1,175,510.19 $\Delta = 29^{\circ} 20' 17'' (RT)$ D = 3° 41' 47" R = 1.550.00' T = 405.74'L = 793.68' E = 52.23' e = 5.9% S.A. = STA 2521+65.07 TO STA 2525+47.05 T.R. = 67.98' S.E. RUN = 314.00' S.R. = BEGIN CONTINUOUSLY ROTATING PLANE AT STA 2531+59.12 P.C. STA = 2524+42.38 N: = 1,873,365.47 E: = 1,175,535.22 P.T. STA = 2532+36.06 N: = 1,874,135.73

E: = 1,175,686.80

CURVE NBDRO8

N: = 1,873,742.76 E: = 1.175,572.51 Δ = 30° 46′ 45″ (RT) D = 3° 49' 48" R = 1,496.00' T = 411.77'L = 803.65' E = 55.64' e = 5.9% S.A. = STA 4521+22.64 TO STA 4525+10.89 T.R. = 74.25' S.E. RUN = 314.00' S.R. = BEGIN CONTINUOUSLY ROTATING PLANE AT STA 4531+18.51 P.C. STA = 4524+06.22 N: = 1.873.332.54 E: = 1,175,608.23

P.T. STA = 4532+09.87

N: = 1,874,113.48 E: = 1,175,751.74

CURVE NBLOCO6

P.I. STA = 4528+18.00

NOTES:

1. AVERAGE GRID TO GROUND CONVERSION FACTOR = 1.000010988654360

2. FOR BENCH MARK INFORMATION, SEE SHEET 1 OF ALIGNMENT PLAN SHEETS.

ALT-7 REVISIONS NAME ILLINOIS DEPARTMENT OF TRANSPORTATION F.A.I. 90/94 (DAN RYAN EXPRESSWAY) GARFIELD BLVD TO 31ST STREET (SB LOCAL LANES) ALIGNMENT PLAN


DRAWN BY: NJH/AMM


CHECKED BY: JAL/MS


SCALE: 1"=100"


DATE: June 9, 2006


CTE | AECOM

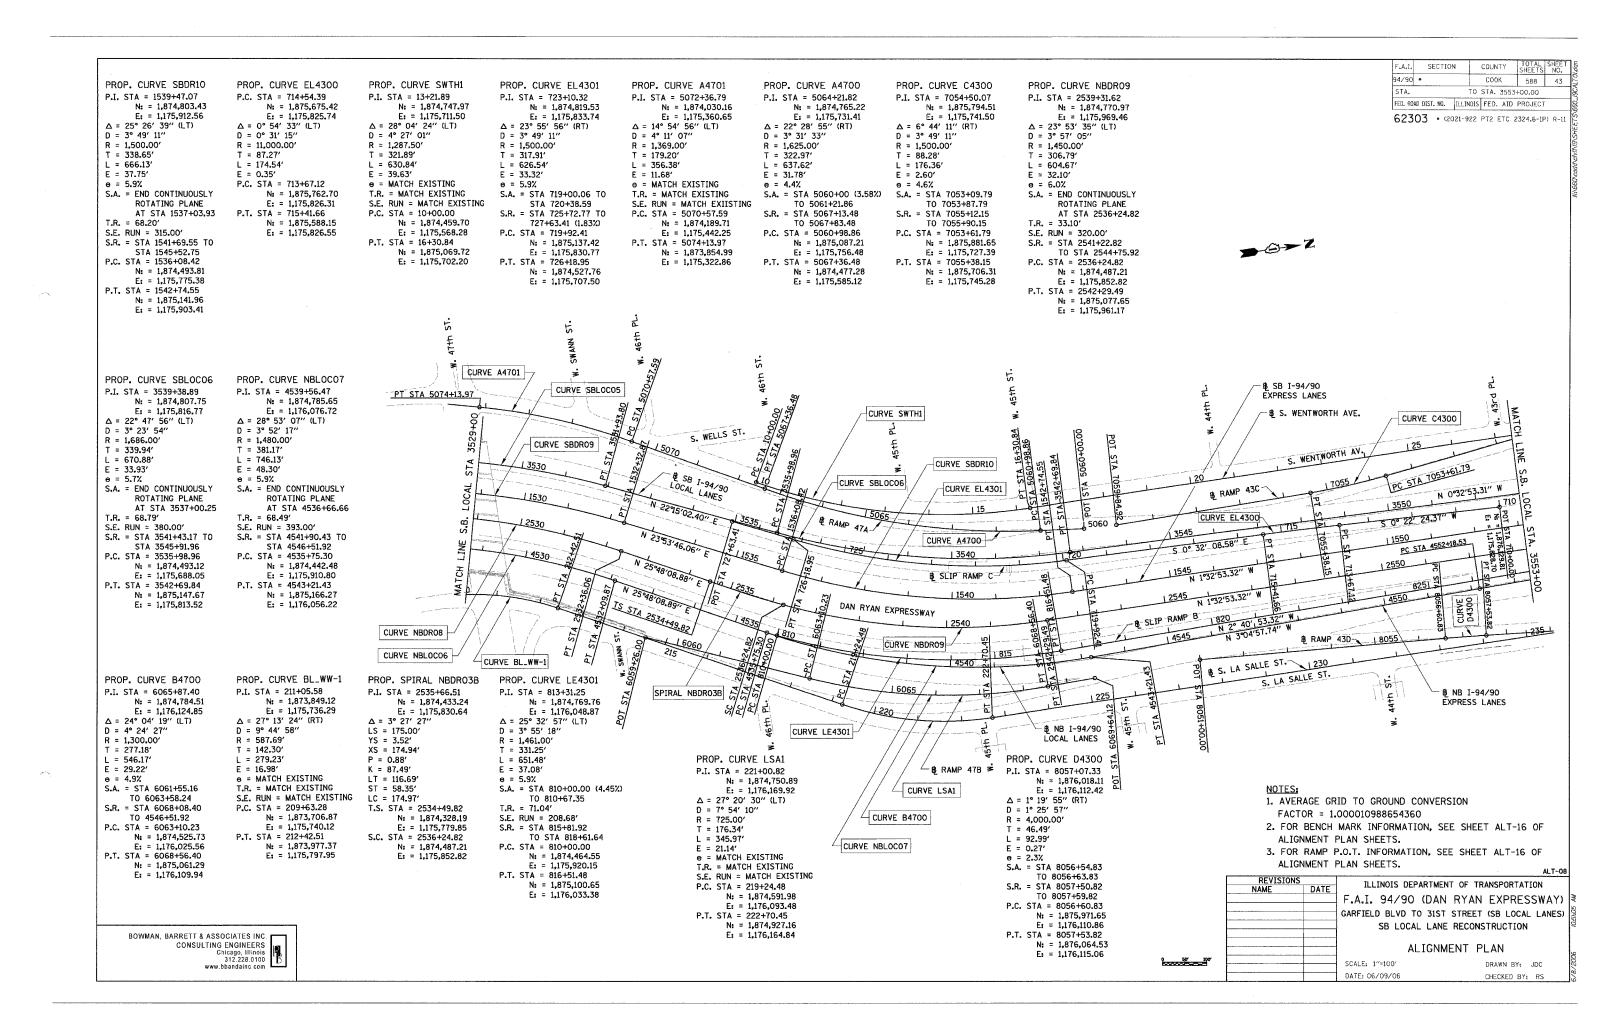


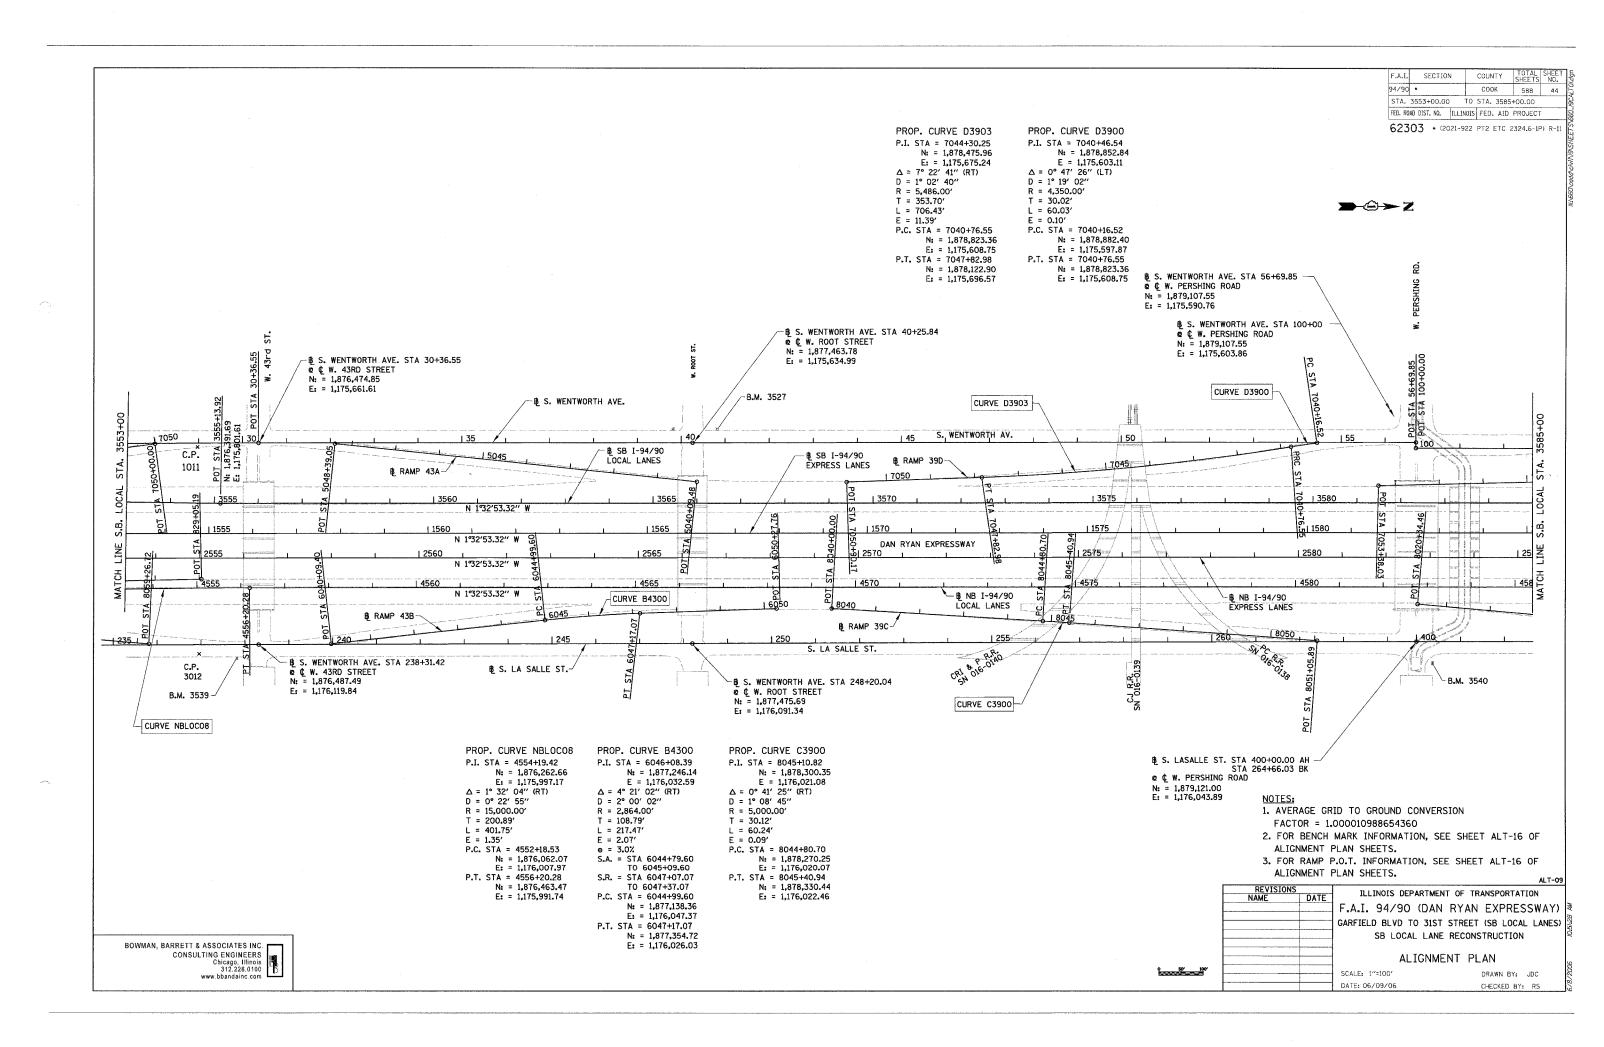


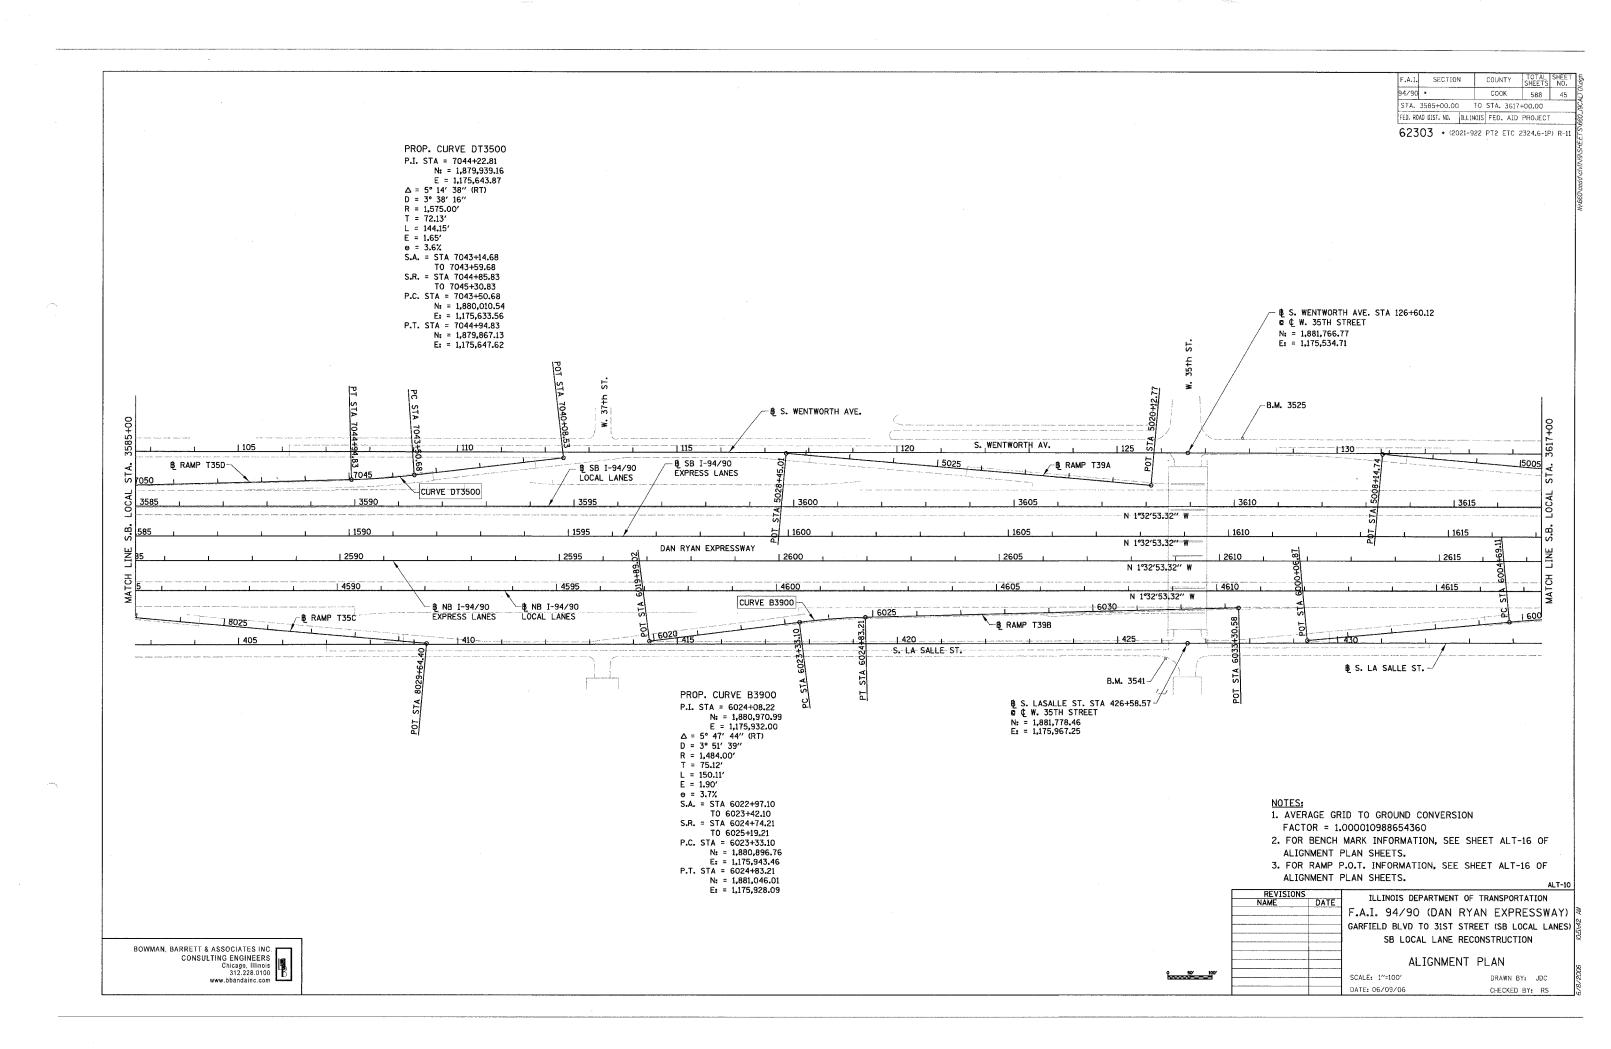


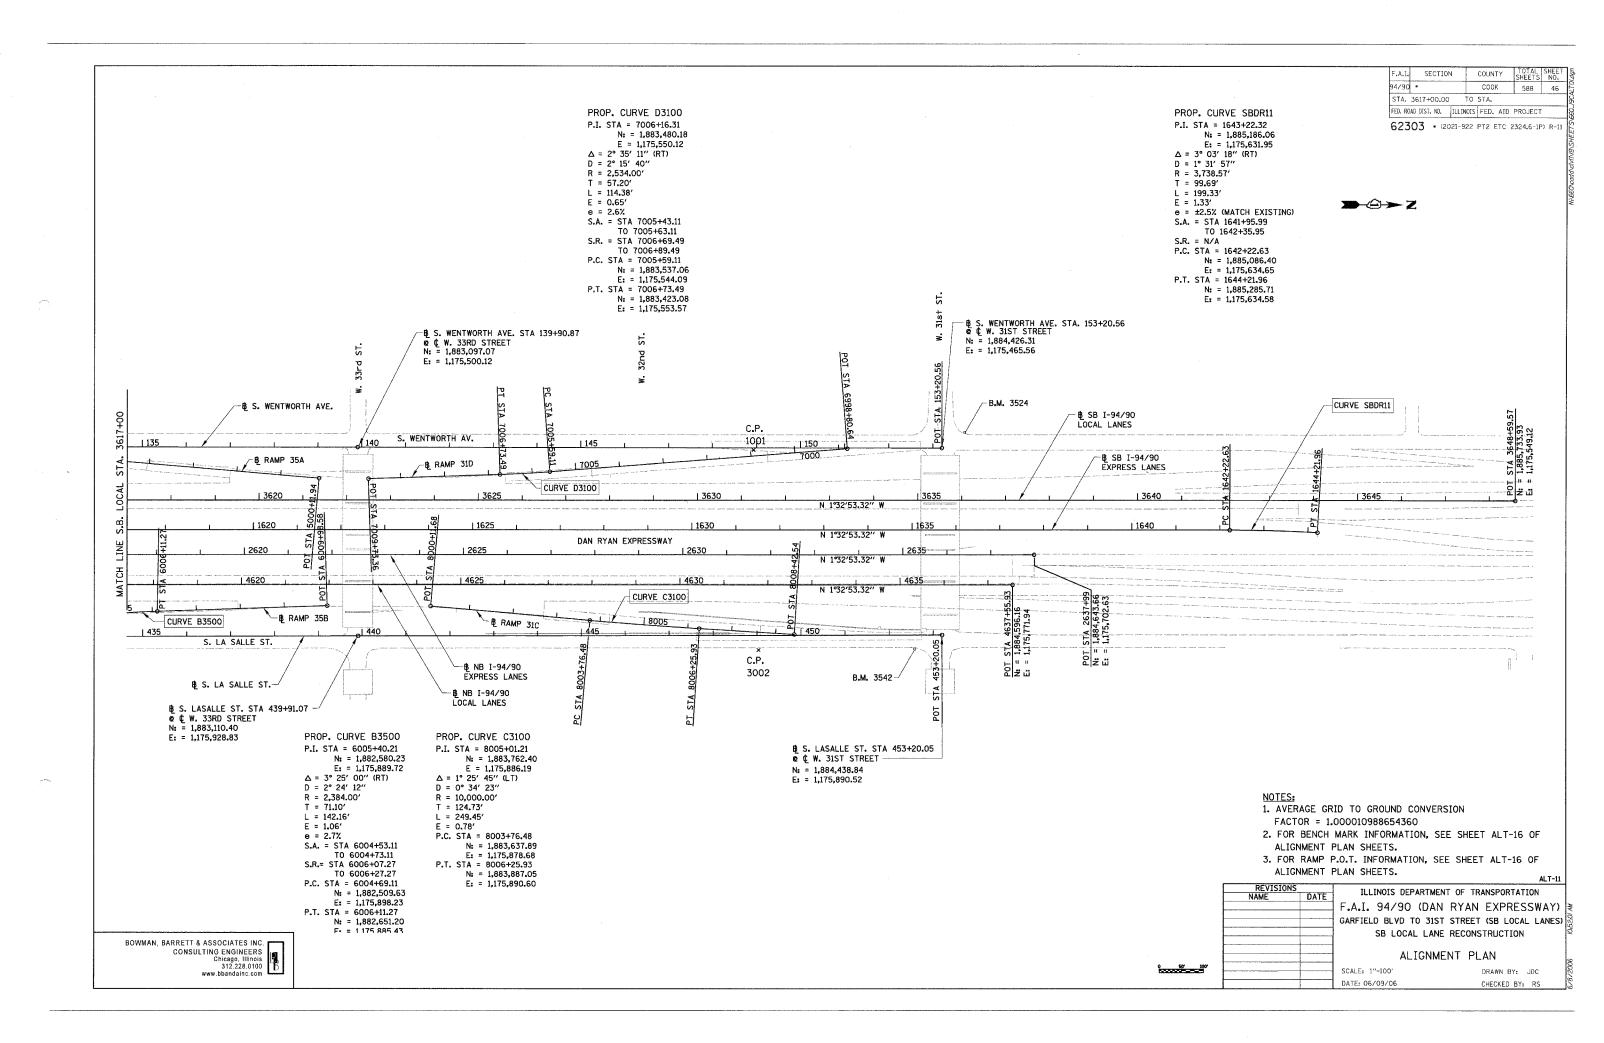

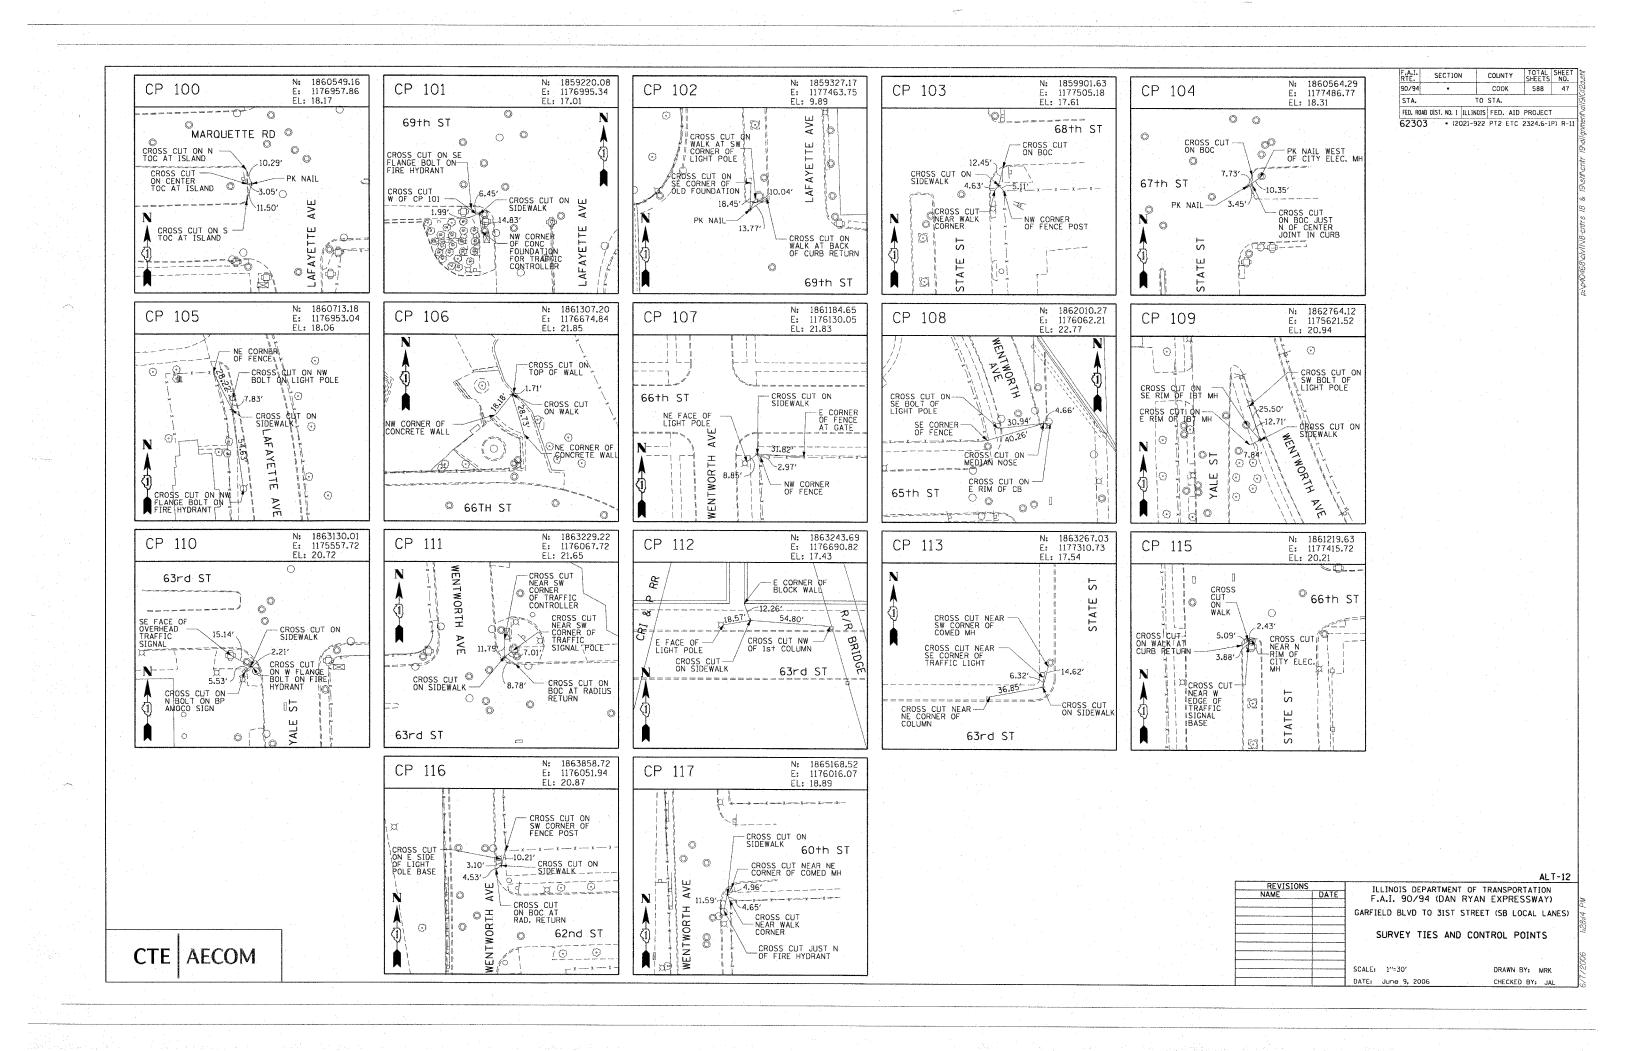

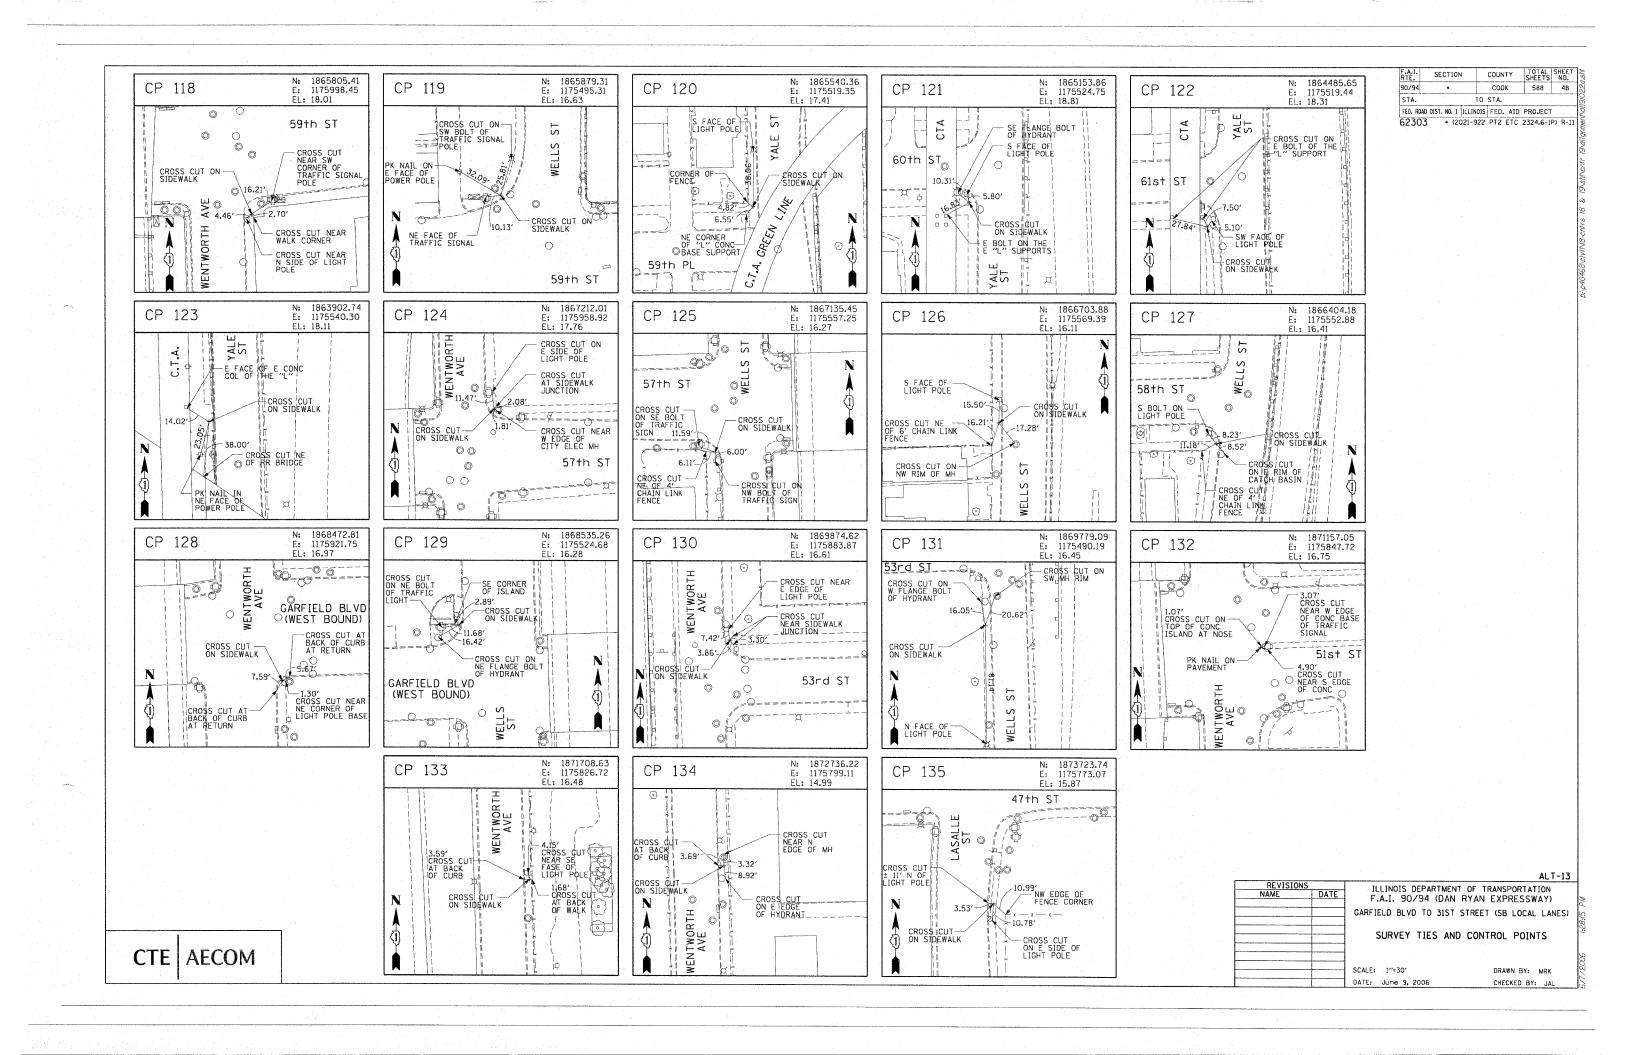

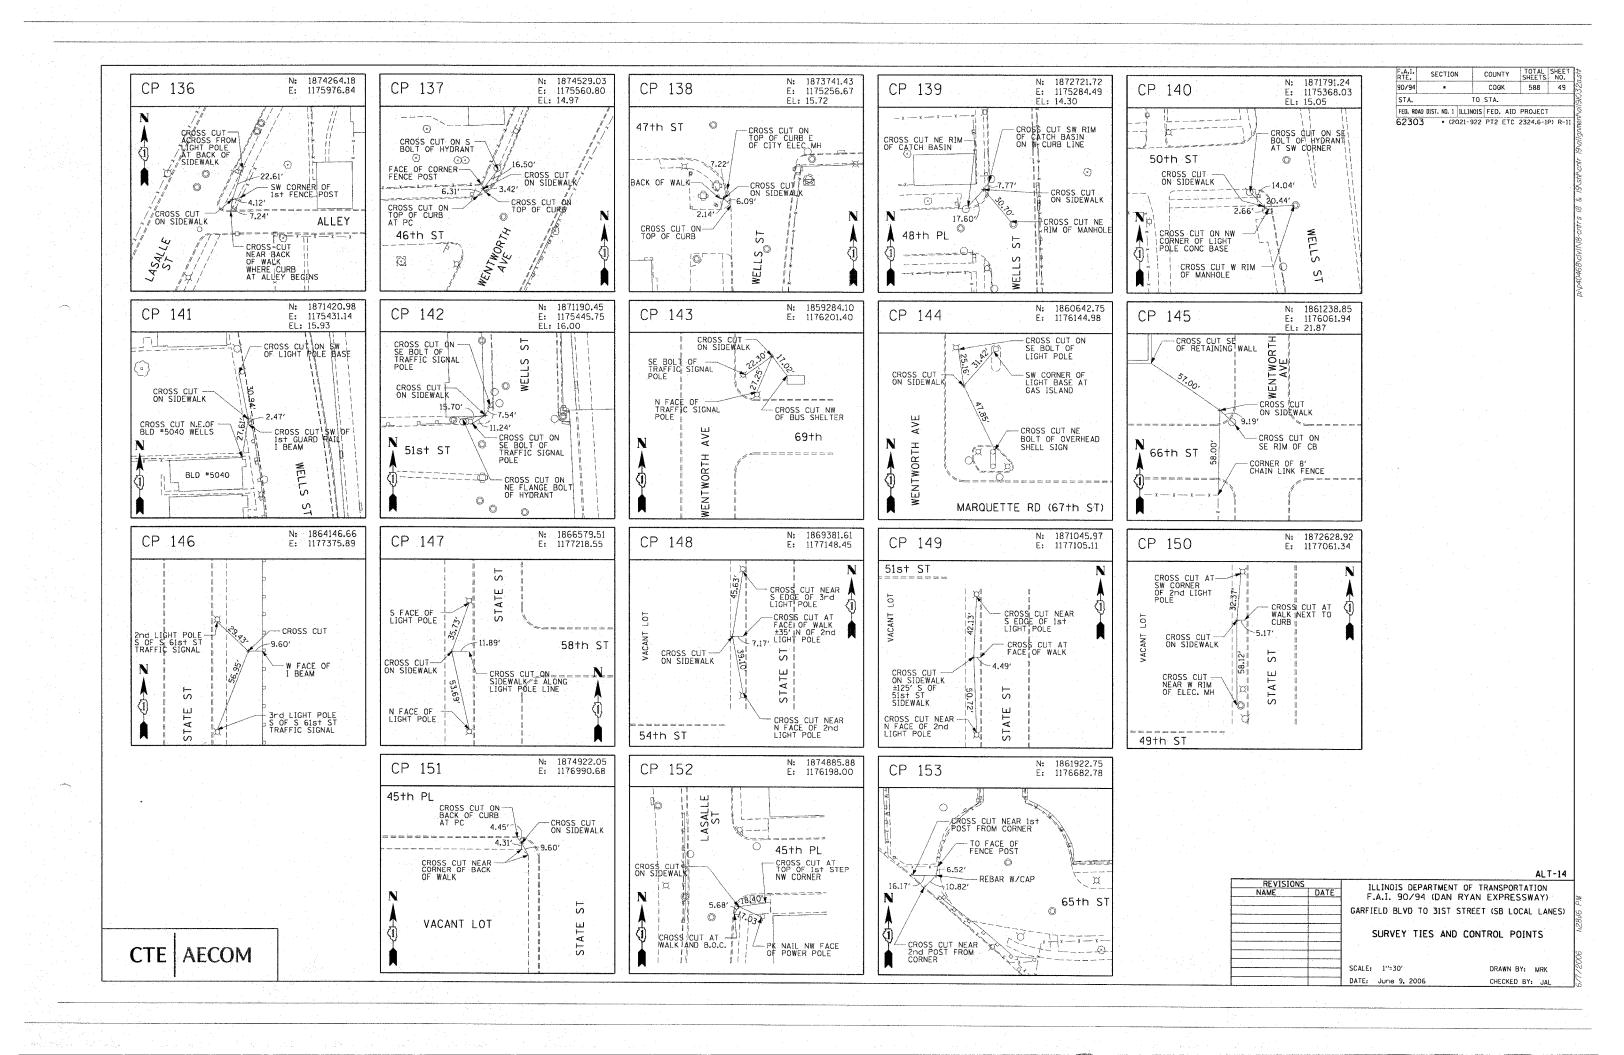

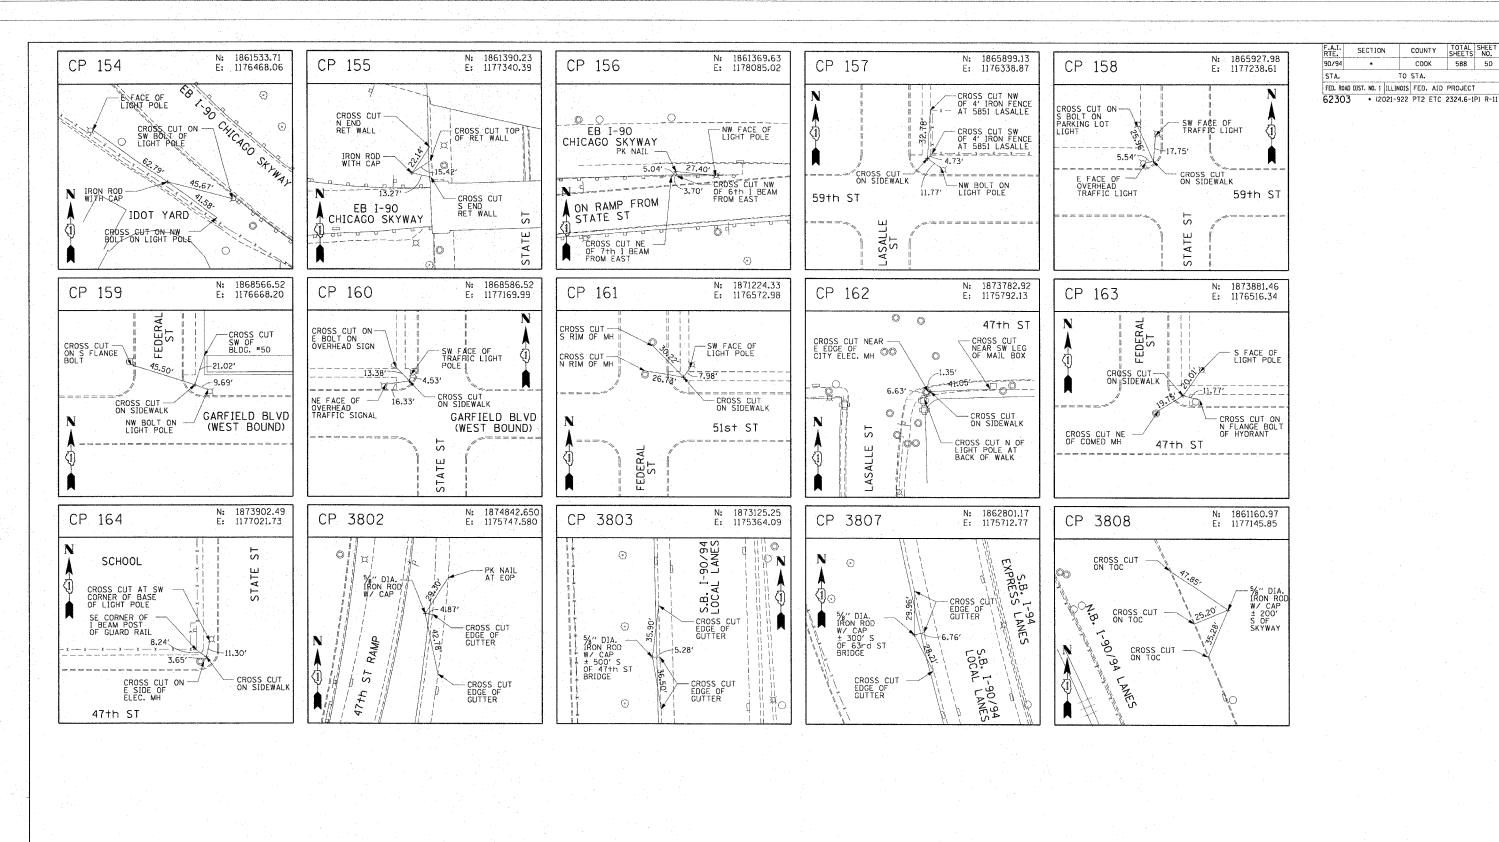


ILLINOIS DEPARTMENT OF TRANSPORTATION F.A.I. 90/94 (DAN RYAN EXPRESSWAY) GARFIELD BLVD TO 31ST STREET (SB LOCAL LANES) SURVEY TIES AND CONTROL POINTS SCALE: 1"=30" DRAWN BY: MRK DATE: June 9, 2006 CHECKED BY: JA


COUNTY TOTAL SHEE


соок


TO STA.

AECOM

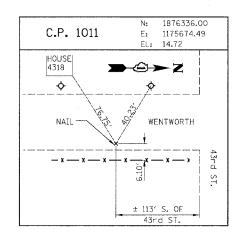

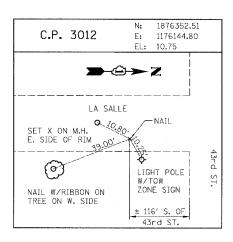

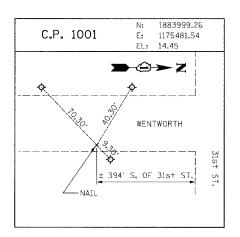

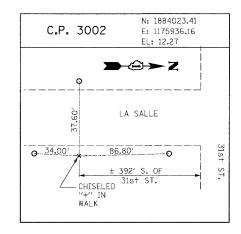

RAMP P.O.T. COORDINATE INFORMATION

POINT	DESCRIPTION	STATION	NORTH	EAST
BEGIN	RAMP 47A	5060+00-00	1.875.185.77	1.175.764.15
END	RAMP 47A	5074+13.97	1,873,854.99	1,175,322.86
BEGIN	RAMP 47B	6059+26.00	1.874.166.99	1,175,887,94
END	RAMP 47B	6069+64.12	1,875,168.85	1,176,104.15
BEGIN	RAMP 43C	7050+00.00	1,876,238.80	1,175,669.59
END	RAMP 43C	7059+84.92	1,875,259.95	1,175,764.44
BEGIN	RAMP 43D	8051+00.00	1,875,411.12	1,176,092.10
END	RAMP 43D	8059+26.72	1,876,237.16	1,176,124.86
BEGIN	RAMP 43A	5040+09.48	1,877,475.98	1,175,723.30
END	RAMP 43A	5048+39.05	1,876,648.91	1,175,658.90
BEGIN	RAMP 43B	6040+09.40	1,876,652.70	1,176,113.96
END	RAMP 43B	6050+27.76	1,877,664.85	1,176,007.29
BEGIN	RAMP 39D	7040+16.52	1,878,882.40	1,175,597.87
END	RAMP 39D	7050+90.17	1,877,816.27	1,175,715.09
BEGIN	RAMP 39C	8040+00.00	1,877,789.82	1,176,003.91
END	RAMP 39C	8051+05.89	1,878,894.81	1,176,048.24

POINT DESCRIPTION STATION NORTH EAS BEGIN END RAMP T35D 7040+08.53 1,880,349.18 1,175,56 END RAMP T35D 7053+38.03 1,879,025.07 1,175,6 BEGIN END RAMP T35C 8020+34.46 1,879,121.15 1,175,98 END RAMP T35C 8029+64.40 1,880,049.40 1,176,0 BEGIN END RAMP T39A 5020+12.77 1,881,685.70 1,175,68 END RAMP T39A 5028+45.01 1,880,854.96 1,175,58	84.62 91.43 58.93
END RAMP T35D 7053+38.03 1,879,025.07 1,175,60 BEGIN RAMP T35C 8020+34.46 1,879,121.15 1,175,90 END RAMP T35C 8029+64.40 1,880,049.40 1,176,00 BEGIN RAMP T39A 5020+12.77 1,881,685.70 1,175,60	91.43 58.93
END RAMP T35D 7053+38.03 1,879,025.07 1,175,60 BEGIN RAMP T35C 8020+34.46 1,879,121.15 1,175,90 END RAMP T35C 8029+64.40 1,880,049.40 1,176,00 BEGIN RAMP T39A 5020+12.77 1,881,685.70 1,175,60	91.43 58.93
BEGIN RAMP T35C 8020+34.46 1,879,121.15 1,175,91 END RAMP T35C 8029+64.40 1,880,049.40 1,176,0 BEGIN RAMP T39A 5020+12.77 1,881,685.70 1,175,61	58.93
END RAMP T35C 8029+64.40 1,880,049.40 1,176,0 BEGIN RAMP T39A 5020+12.77 1,881,685.70 1,175,6	
END RAMP T35C 8029+64.40 1,880,049.40 1,176,0 BEGIN RAMP T39A 5020+12.77 1,881,685.70 1,175,6	14.92
END DAND T204 E020+4E01 1000 0E4 0C 117E E0	
END NAME 133A 3020745,01 1,000,034,30 1,115,30	60.34
BEGIN RAMP T39B 6019+89.02 1,880,556.70 1,175,99	95.95
END RAMP T39B 6033+30.58 1,881,892.23 1,175,88	
END (NAMI) 1330 6033+30.30 1,001,032.23 1,113,00	77.07
BEGIN RAMP 35A 5000+11.94 1,883,011.02 1,175,5	73.65
END RAMP 35A 5008+14.74 1,882,209.69 1,175,5	25.14
BEGIN RAMP 35B 6000+06.87 1.882.050.72 1.175.99	= 7 E C
END RAMP 35B 6009+98.58 1,883,037.81 1,175,86	52.08
BEGIN RAMP 31D 6998+80.64 1,884,211.76 1,175,4	72.66
END RAMP 31D 7009+73.36 1,883,123.75 1,175,5	
1,000,125,15	11.00
BEGIN RAMP 31C 8000+11.68 1,883,273.75 1,175,8	56.72
END RAMP 31C 8008+42.54 1,884,103.52 1,175,89	

BENCH MARK NO. 3524 ELEV. 15.17

DESCRIPTION:

CROSS CUT ON NORTH FLANGE BOLT OF FIRE HYDRANT AT THE NORTHWEST CORNER OF 31s+ ST. AND WENTWORTH AVE.

BENCH MARK NO. 3525 ELEV. 16.93

DESCRIPTION:

CROSS CUI ON NORTHWEST FLANGE BOLT OF FIRE HYDRANT AT THE NORTHWEST CORNER, OF 35th ST. AND WENTWORTH AVE.

BENCH MARK NO. 3526 ELEV, 17.37

DESCRIPTION:

CROSS CUT ON NORTHWEST FLANGE BOLT OF FIRE HYDRANT AT THE WENTWORTH GARDEN OFFICE ALONG THE WEST SIDE OF WENTWORTH AVE.

BENCH MARK NO. 3527 ELEV. 15.63

DESCRIPTION

CROSS CUT ON NORTHERLY FLANGE BOLT OF FIRE HYDRANT AT THE NORTHWEST CORNER OF ROOT ST. AND WENTWORTH AVE.

BENCH MARK NO. 3539 ELEV. 13.10

DESCRIPTION:

CROSS CUT ON EASTERLY BOLT OF LIGHT POLE BASE AT THE SOUTHEAST CORNER OF 43rd ST. AND LA SALLE ST.

BENCH MARK NO. 3540 ELEV. 12.33

DESCRIPTION:

SQUARE CUT ON THE SOUTHWEST CORNER OF THE TRAFFIC CONTROL BOX AT THE NORTHEAST CORNER OF 39+h ST. AND LA SALLE ST.

BENCH MARK NO. 3541 ELEV. 14.78

DESCRIPTION:

CROSS CUT ON THE SOUTHWEST BOLT OF LIGHT POLE BASE AT THE SOUTH EAST CORNER OF 35th ST. AND LA SALLE ST.

BENCH MARK NO. 3542 ELEV. 13.57

DESCRIPTION:

CROSS CUT ON THE EASTERLY FLANCE BOLT OF THE FIRE HYDRANT AT THE INTERSECTION OF 31st ST. AND LA SALLE ST.

REVISIONS
NAME
DATE

ILLINOIS DEPARTMENT OF TRANSPORTATION

F.A.I. 94/90 (DAN RYAN EXPRESSWAY)

GARFIELD BLVD TO 31ST STREET (SB LOCAL LANES)

SB LOCAL LANE RECONSTRUCTION

SURVEY TIES AND CONTROL POINTS

SCALE: 1"=100"

DATE: 06/09/06

DATE: 06/09/06

CHECKED BY: RS

F.A.I. SECTION

STA. 3617+00.00 TO STA.

FED. ROAD DIST. NO. | ILLINOIS | FED. AID PROJECT

62303 • (2021-922 PT2 ETC 2324.6-1P) R-11


94/90 *


COUNTY


COOK


588 51


BOWMAN, BARRETT & ASSOCIATES INC.
CONSULTING ENGINEERS
Chicago, Illinois
312.228.0100
www.bbandainc.com

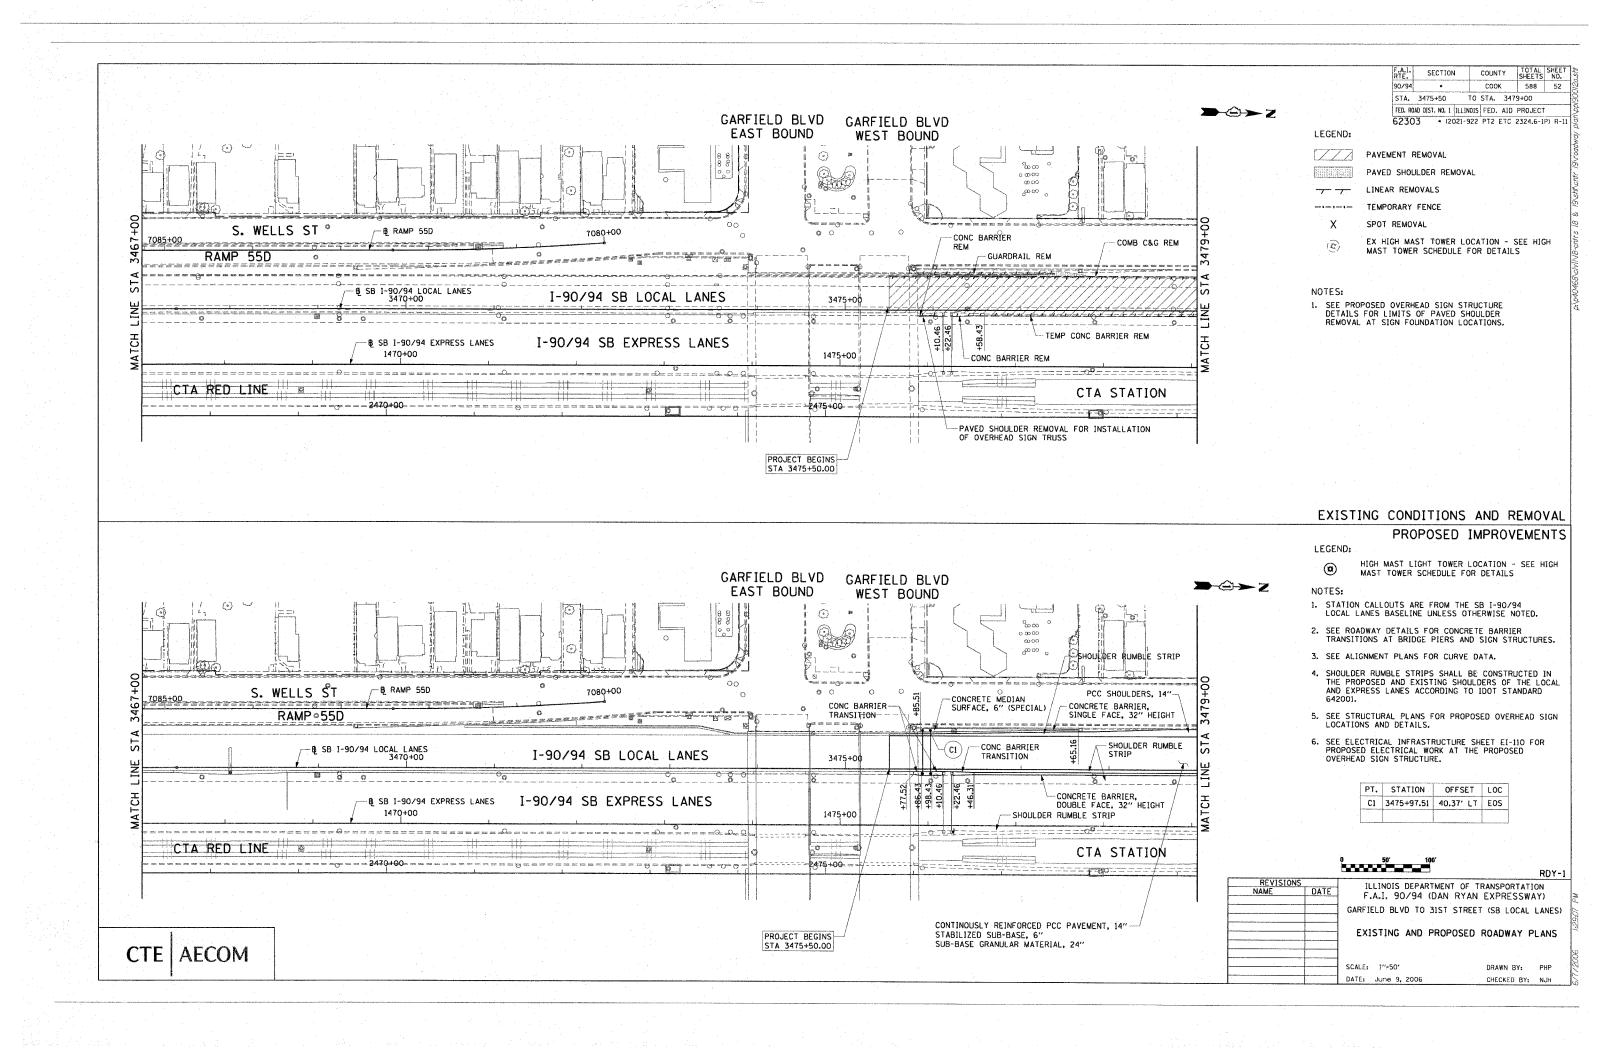

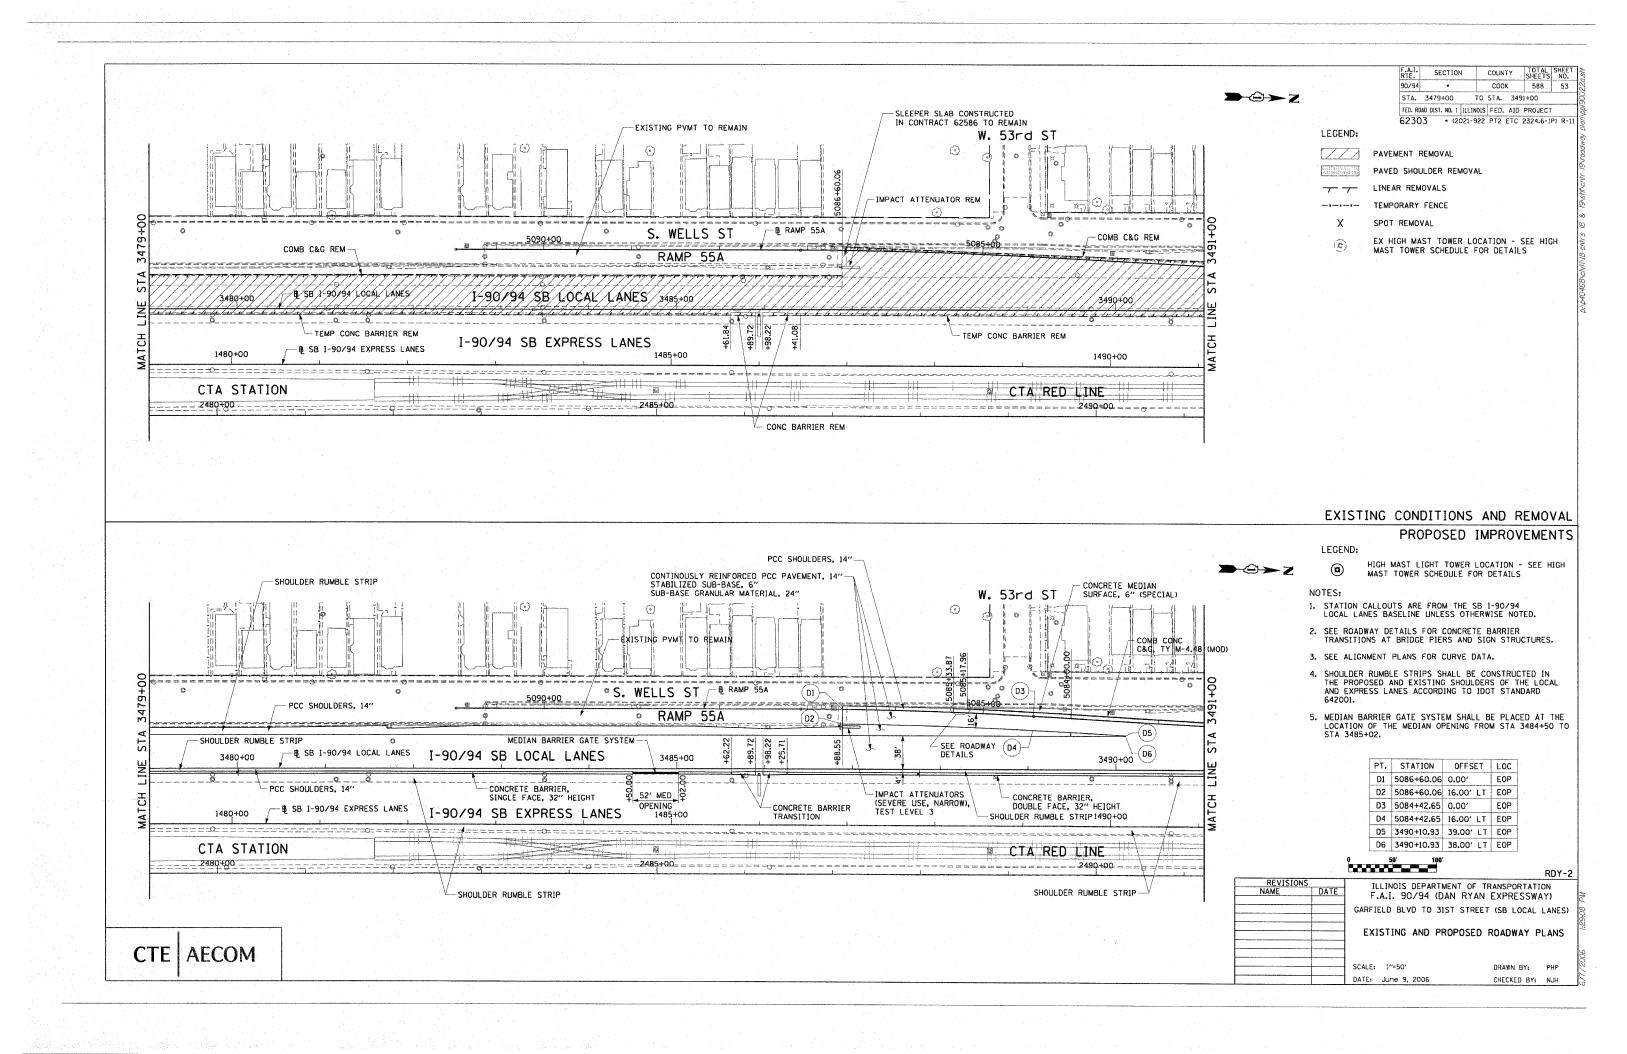

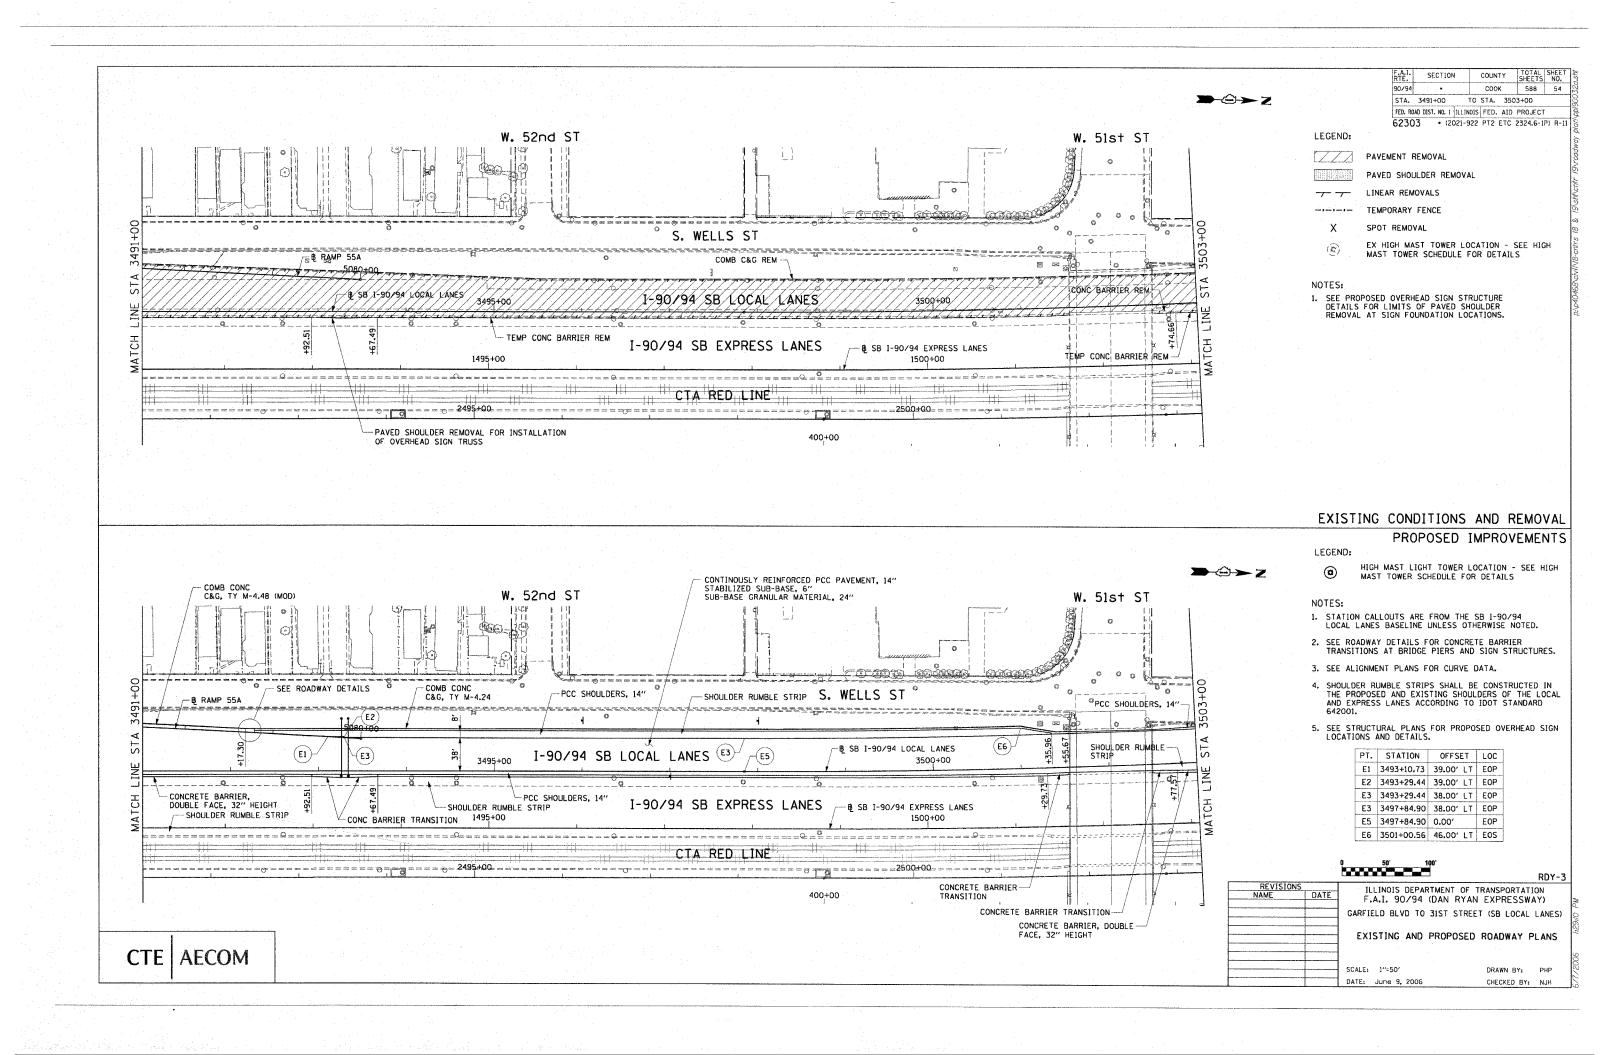

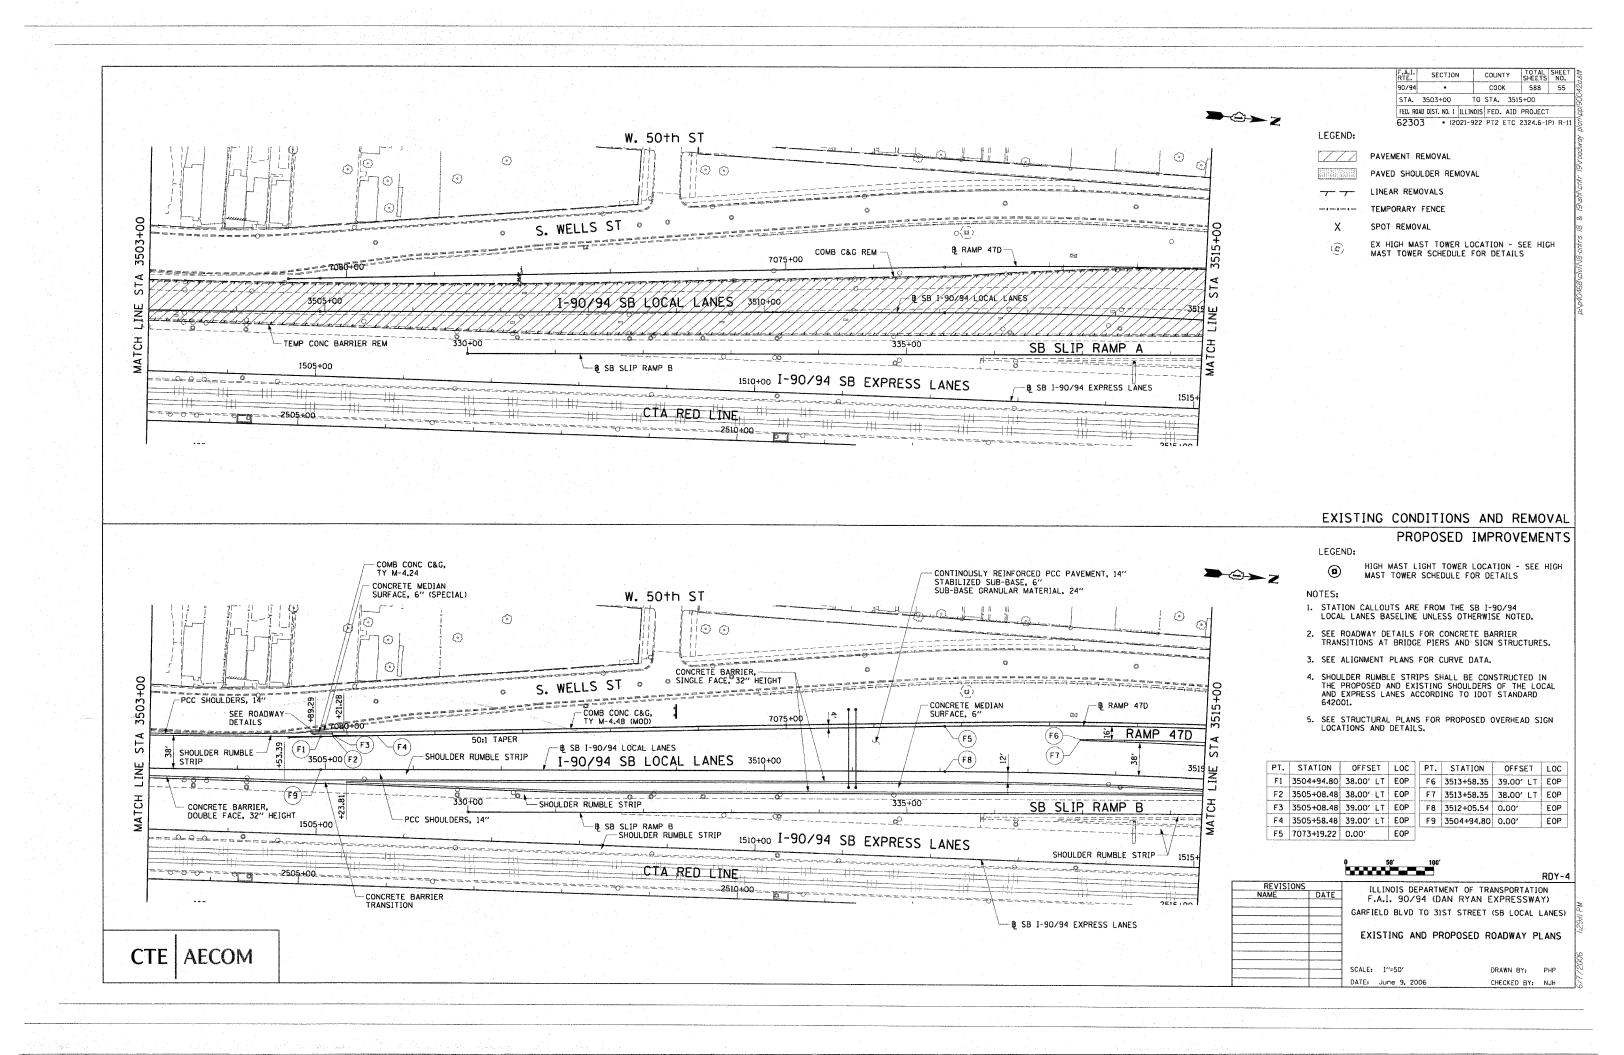

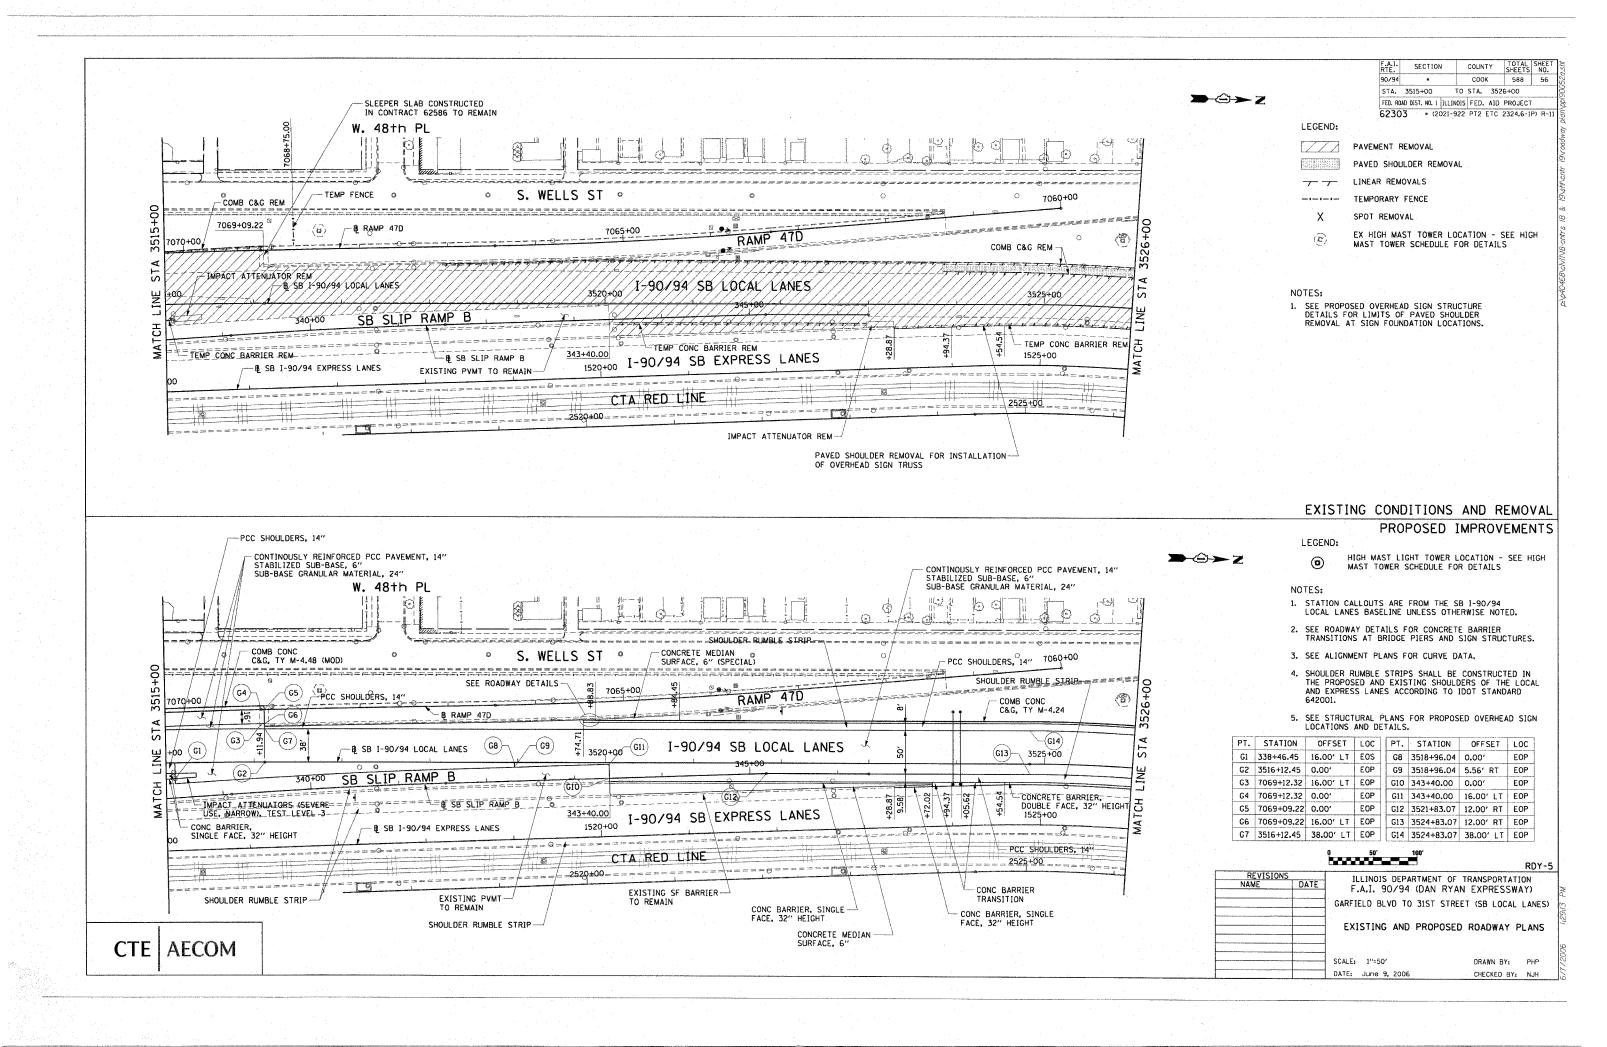

W. A7th ST S. WELLS ST 0 3. 11----COMB C&G REM 7907/94/\$B/LOCAL LANES 18/58/-90/94/LOCAL VANES 8-1-90/94 SB TEMP CONC BARRIER REM EXPRESS LANES 5 -8 SB 1-90/94 EXPRESS LANES CTA RED LINE

COUNTY TOTAL SHEE NO. SECTION . COOK 90/94 588 57 STA. 3526+00 TO STA. 3529+00 FED. ROAD DIST, NO. 1 ILLINOIS FED. AID PROJECT 62303 • (2021-922 PT2 ETC 2324.6-1P) R-11

-OTZ

PAVEMENT REMOVAL

LEGEND:

PAVED SHOULDER REMOVAL

LINEAR REMOVALS

TEMPORARY FENCE

SPOT REMOVAL

EX HIGH MAST TOWER LOCATION - SEE HIGH MAST TOWER SCHEDULE FOR DETAILS

EXISTING CONDITIONS AND REMOVAL

PROPOSED IMPROVEMENTS

LEGEND:

HIGH MAST LIGHT TOWER LOCATION - SEE HIGH MAST TOWER SCHEDULE FOR DETAILS

-G-Z

NOTES:

- 1. STATION CALLOUTS ARE FROM THE SB 1-90/94 LOCAL LANES BASELINE UNLESS OTHERWISE NOTED.
- 2. SEE ROADWAY DETAILS FOR CONCRETE BARRIER TRANSITIONS AT BRIDGE PIERS AND SIGN STRUCTURES.
- 3. SEE ALIGNMENT PLANS FOR CURVE DATA.
- 4. SHOULDER RUMBLE STRIPS SHALL BE CONSTRUCTED IN THE PROPOSED AND EXISTING SHOULDERS OF THE LOCAL AND EXPRESS LANES ACCORDING TO 1DOT STANDARD

50' 100

RDY-6

ILLINOIS DEPARTMENT OF TRANSPORTATION F.A.I. 90/94 (DAN RYAN EXPRESSWAY) GARFIELD BLVD TO 31ST STREET (SB LOCAL LANES) EXISTING AND PROPOSED ROADWAY PLANS

SCALE: 1"=50"


CHECKED BY: NJH


AECOM CTE


W. A7th ST -CONTINOUSLY REINFORCED PCC PAVEMENT, 14" STABILIZED SUB-BASE, 6" SUB-BASE GRANULAR MATERIAL, 24" . S. WELLS ST O S. WILL SHOLEDER RUMBLE STRIP PCC SHOULDERS, 14" - COMB CONC C&G, TY M-4.24 B SB 1-90/94 LOCAL LANES -90/94 SB LOCAL PCC SHOULDERS, 14" LANES CONCRETE BARRIER TRANSTION CONCRETE BARRIER 1-90/94 SB EXPRESS LANES DOUBLE FACE, 32" HEIGHT LANES LANES ᆼ CTA RED LINE


SHOULDER RUMBLE STRIP-


DRAWN BY: PHP DATE: June 9, 2006

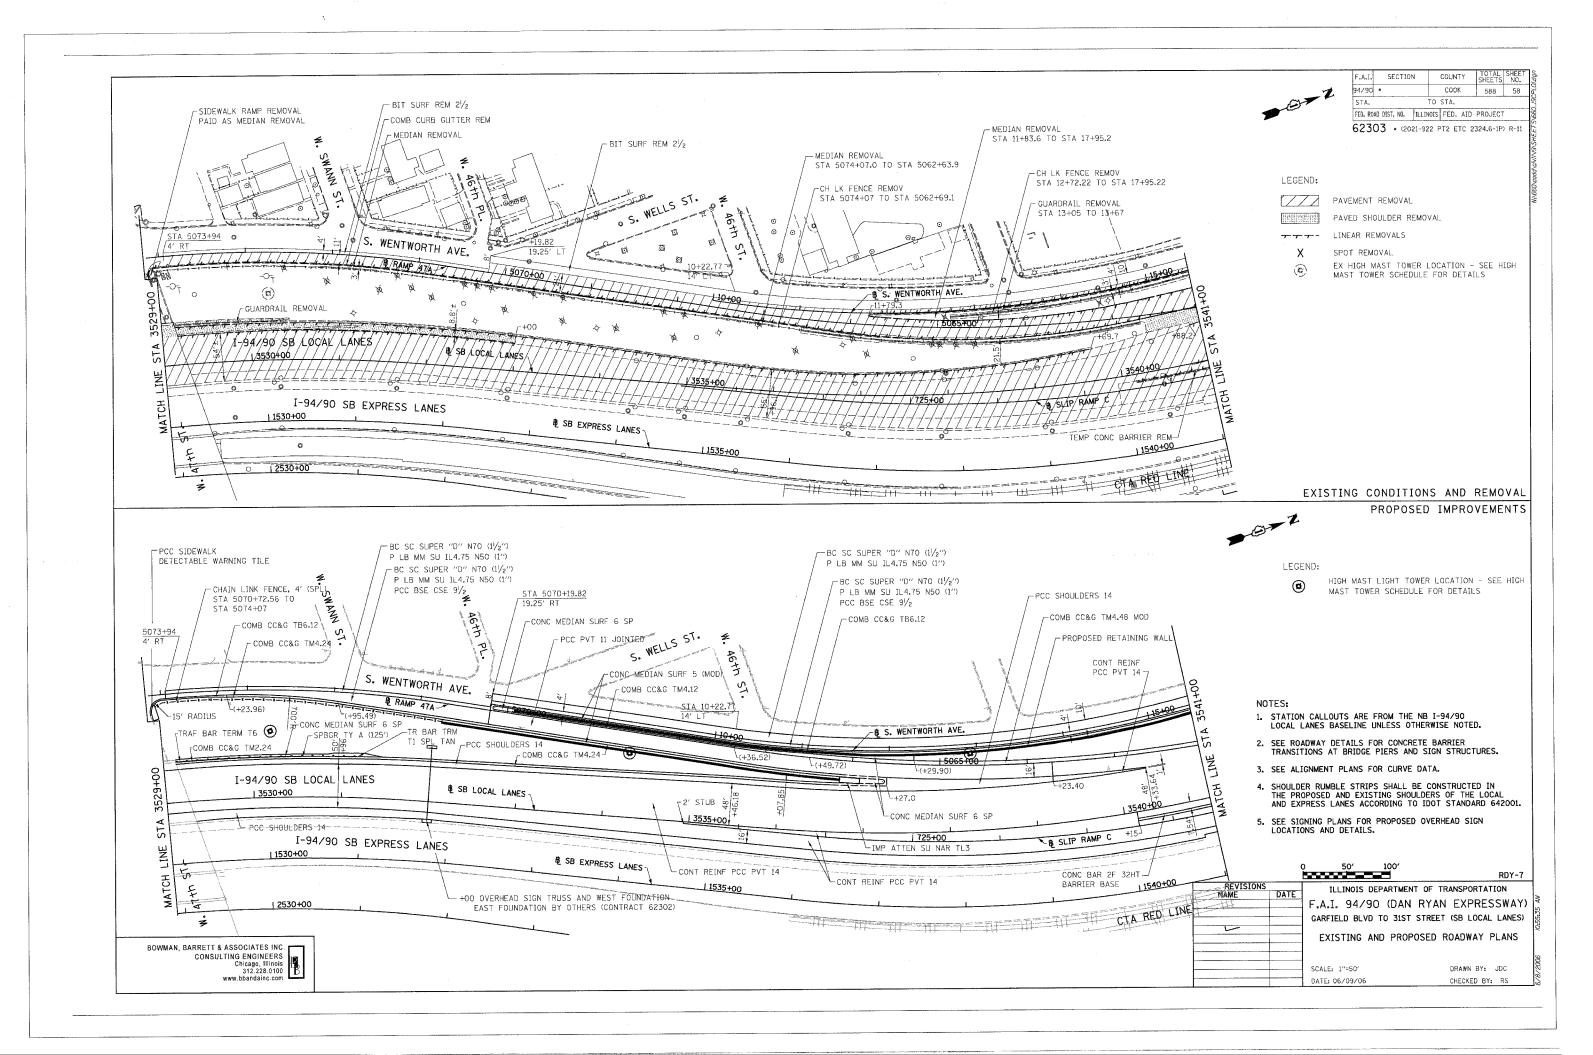


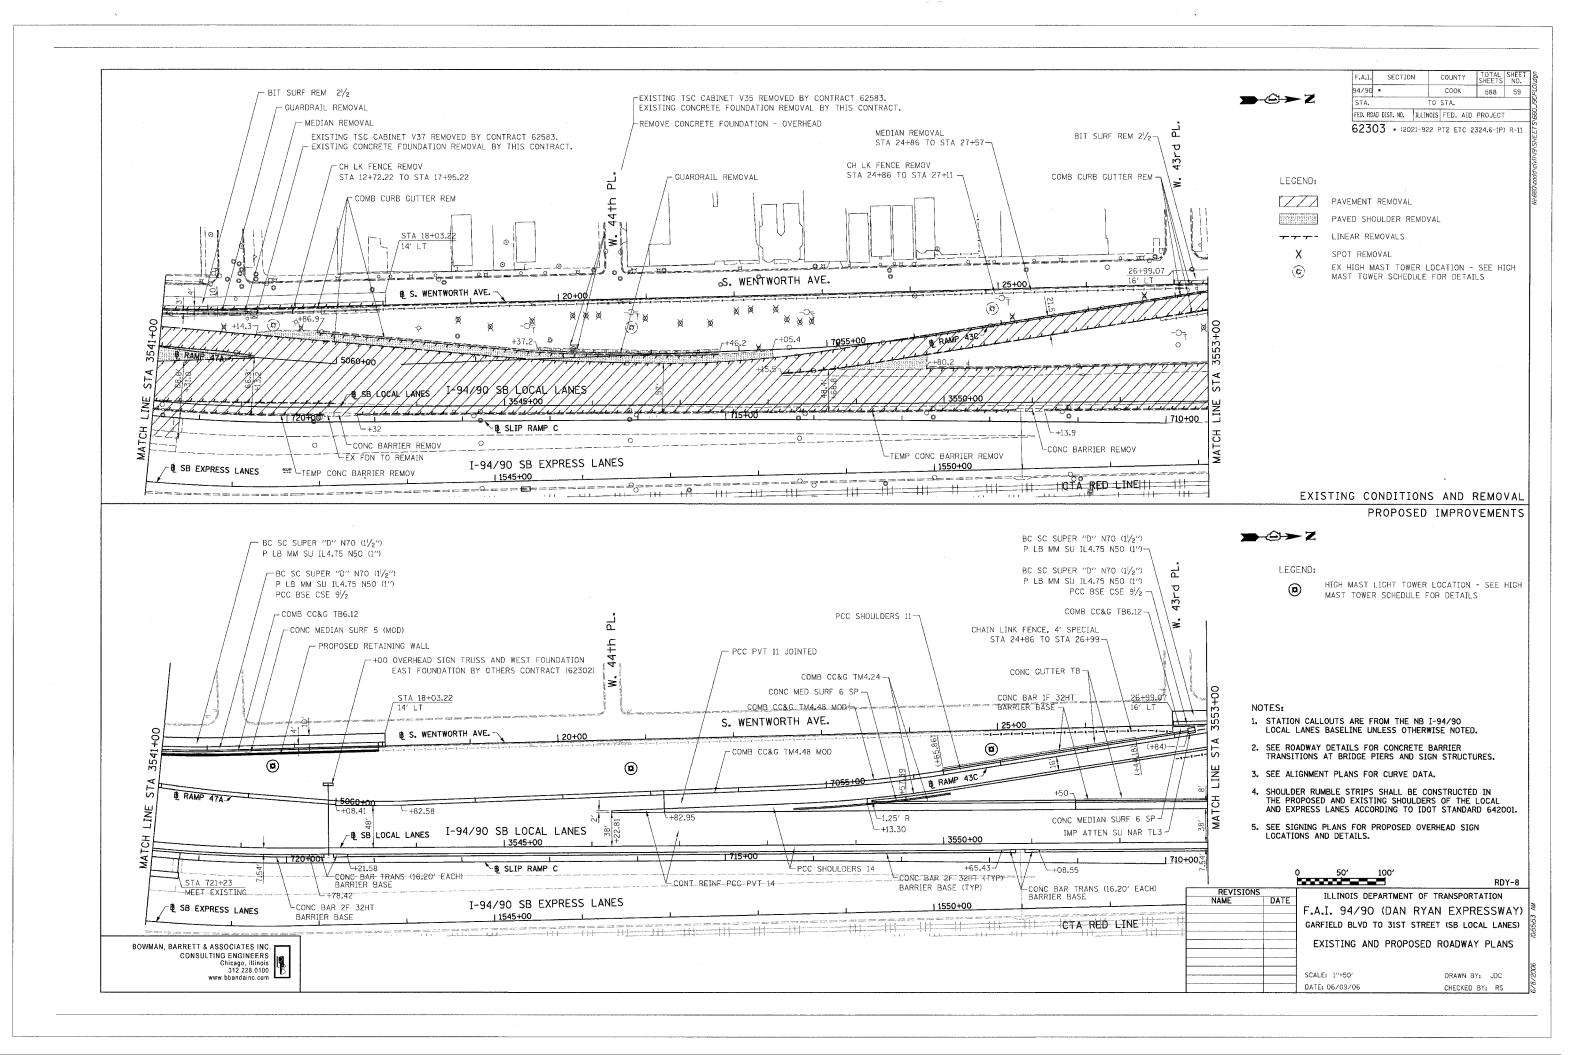


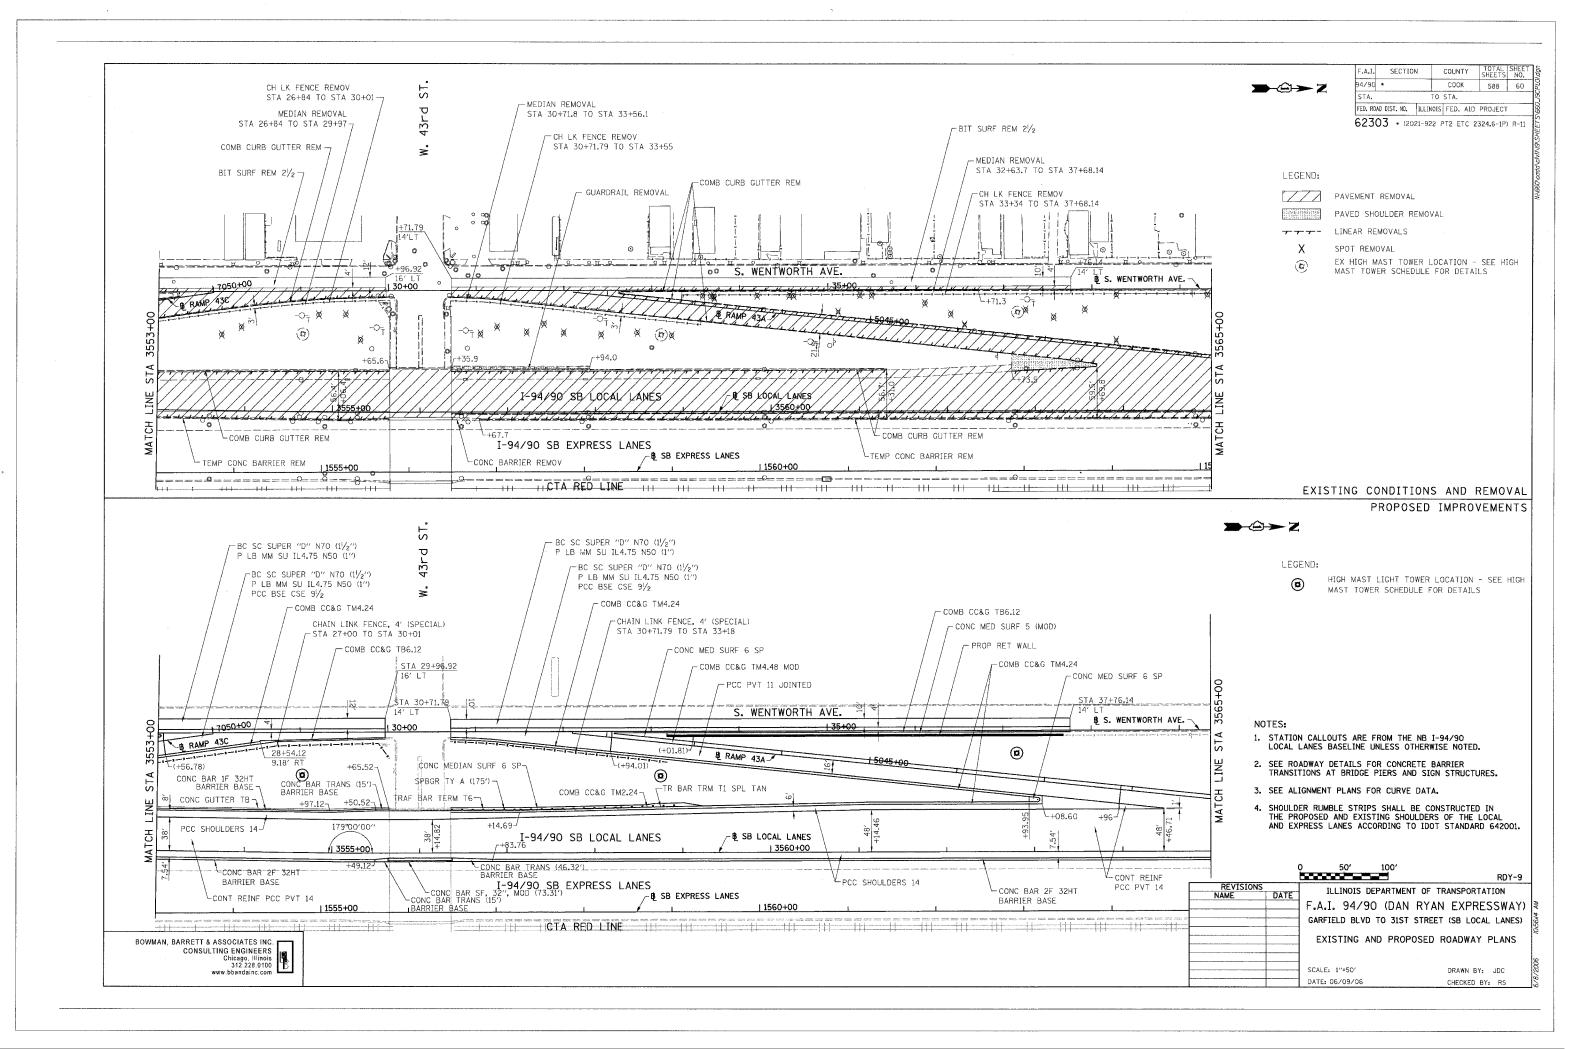


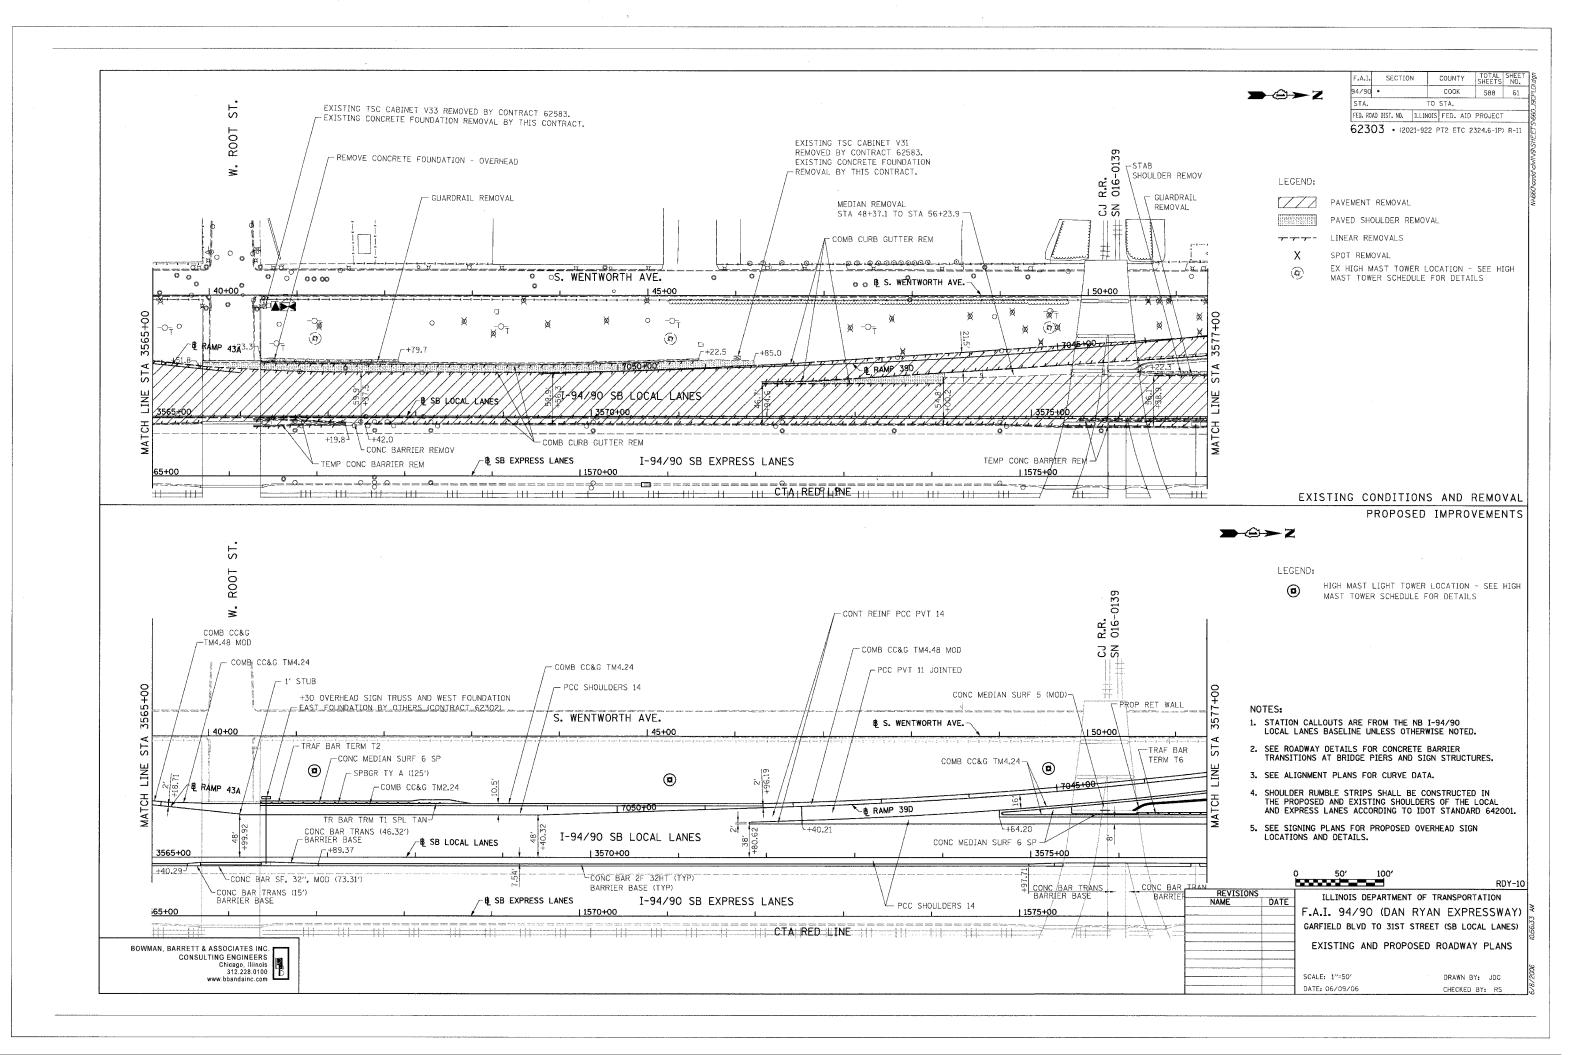


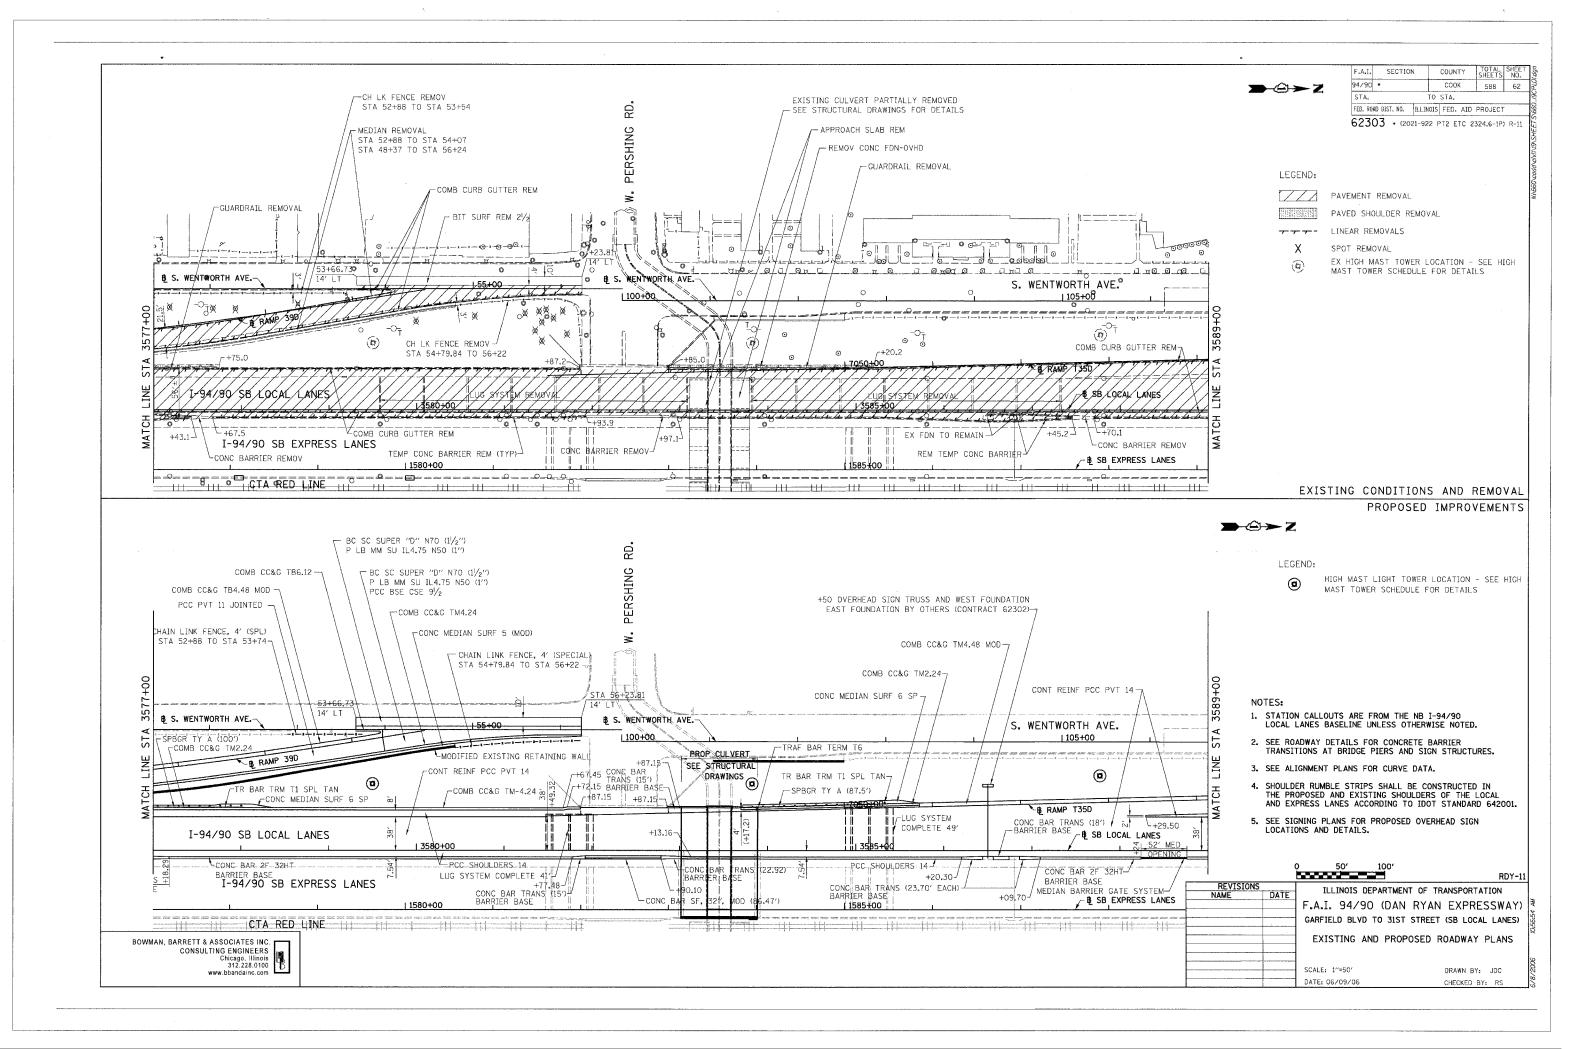


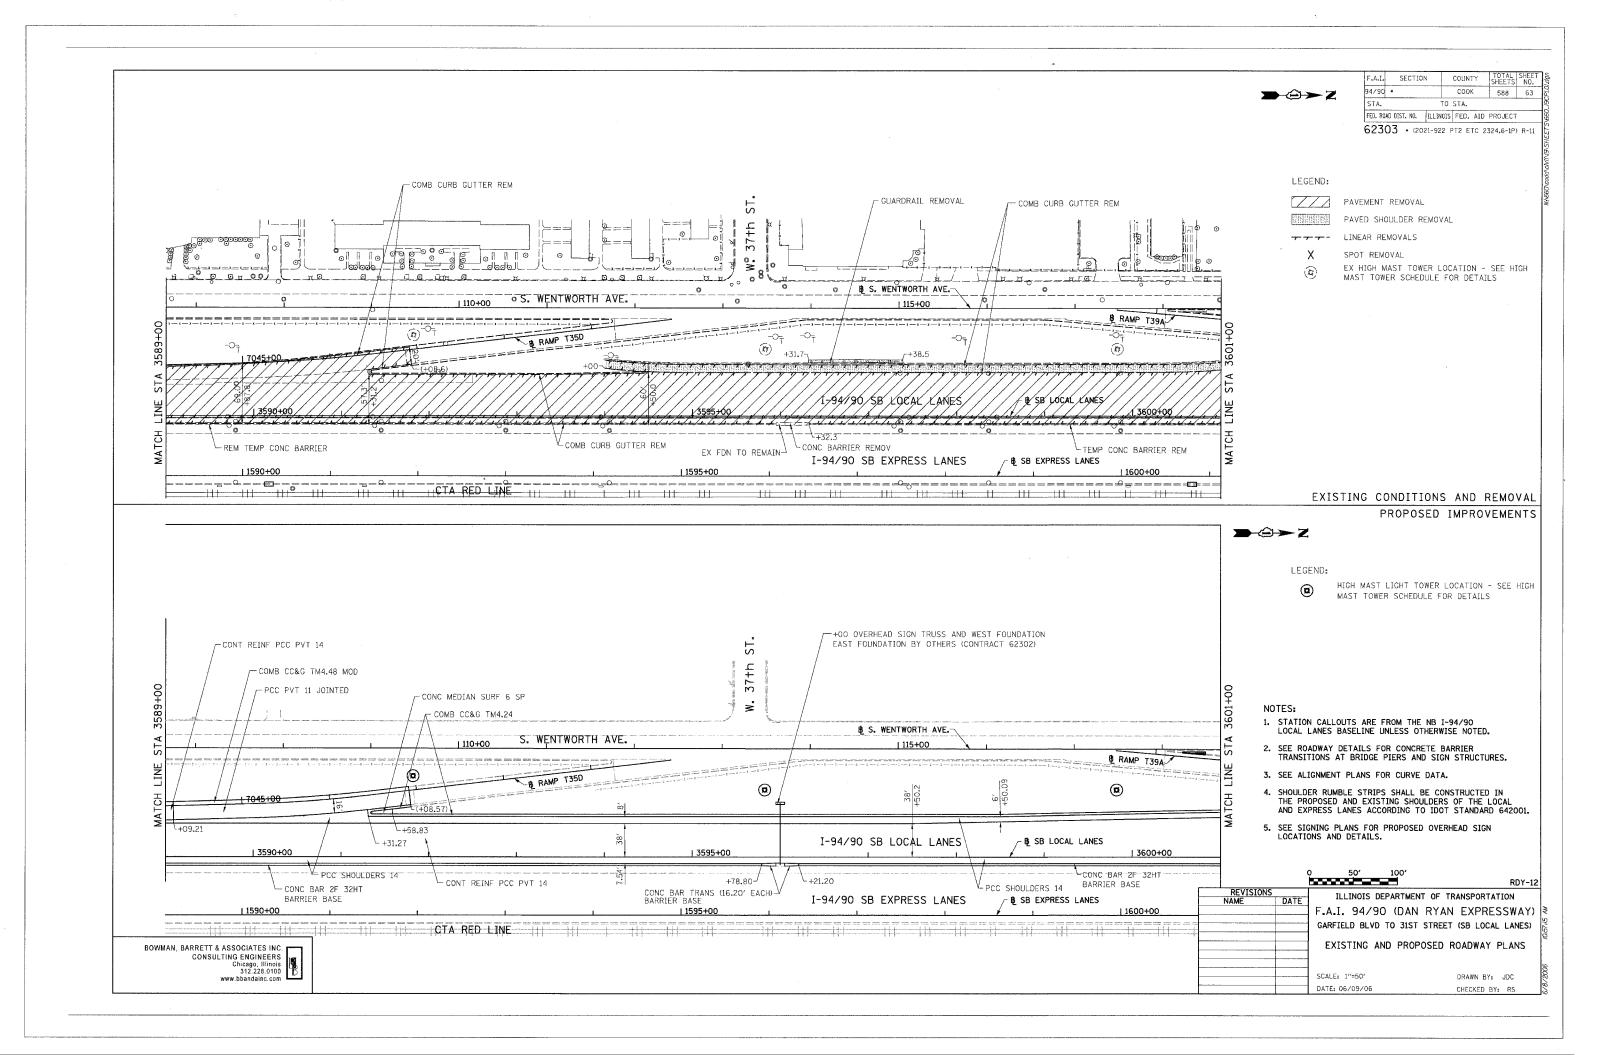


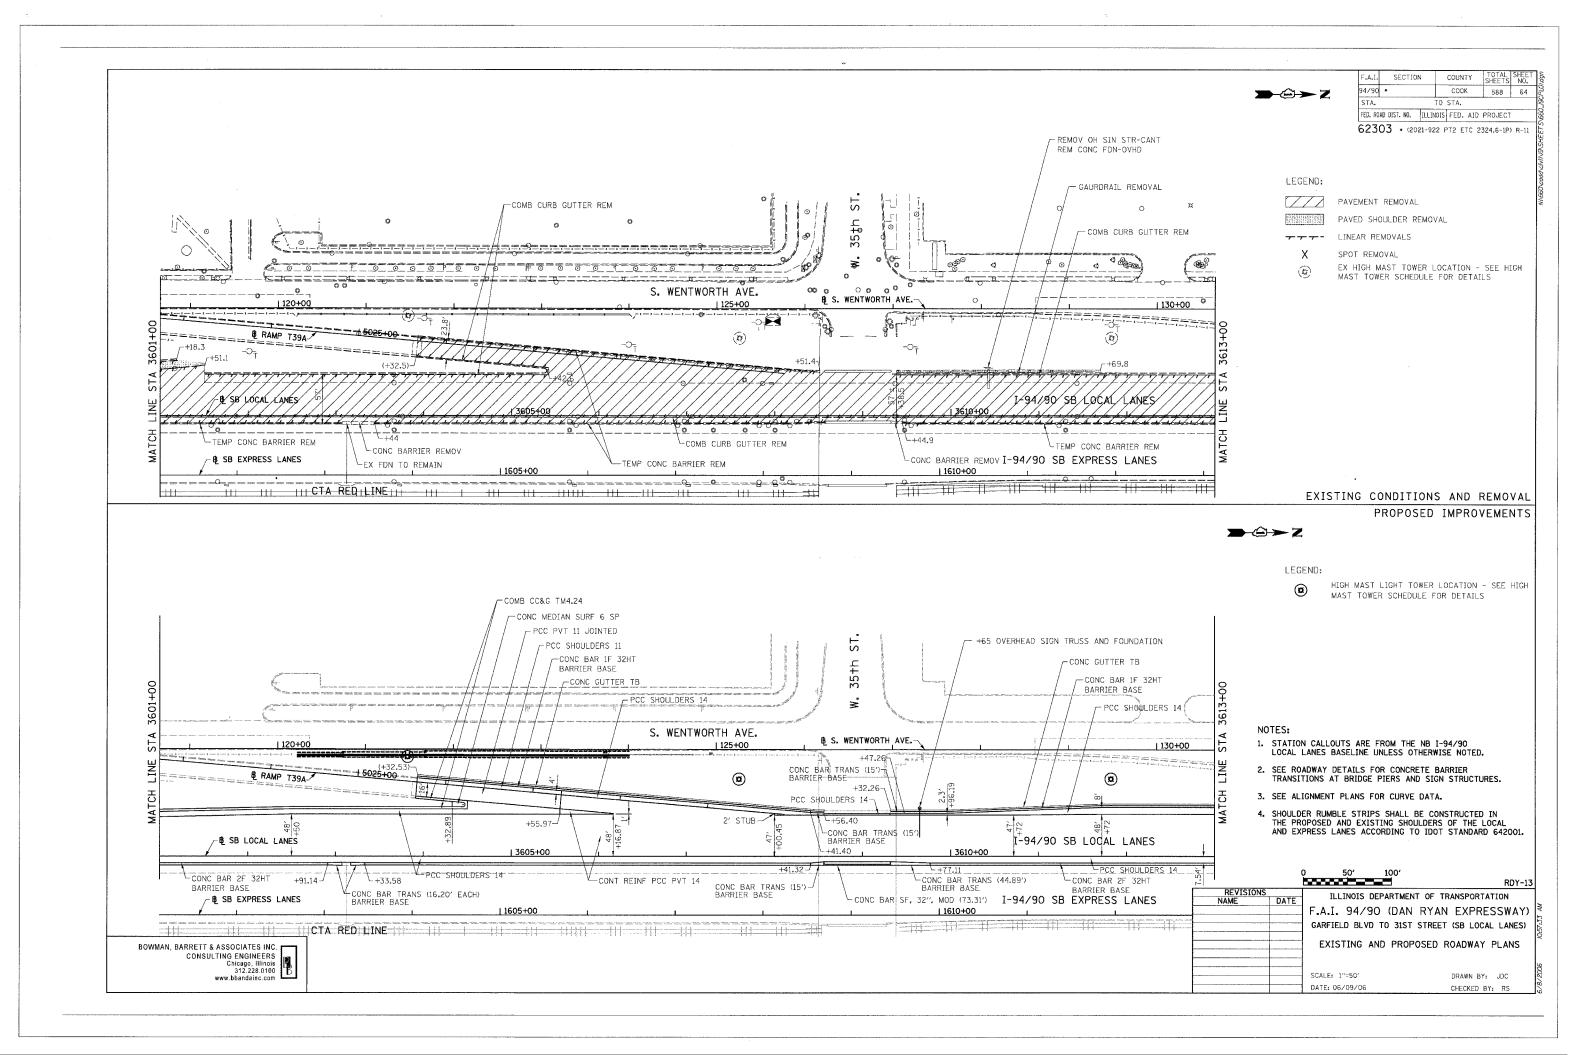


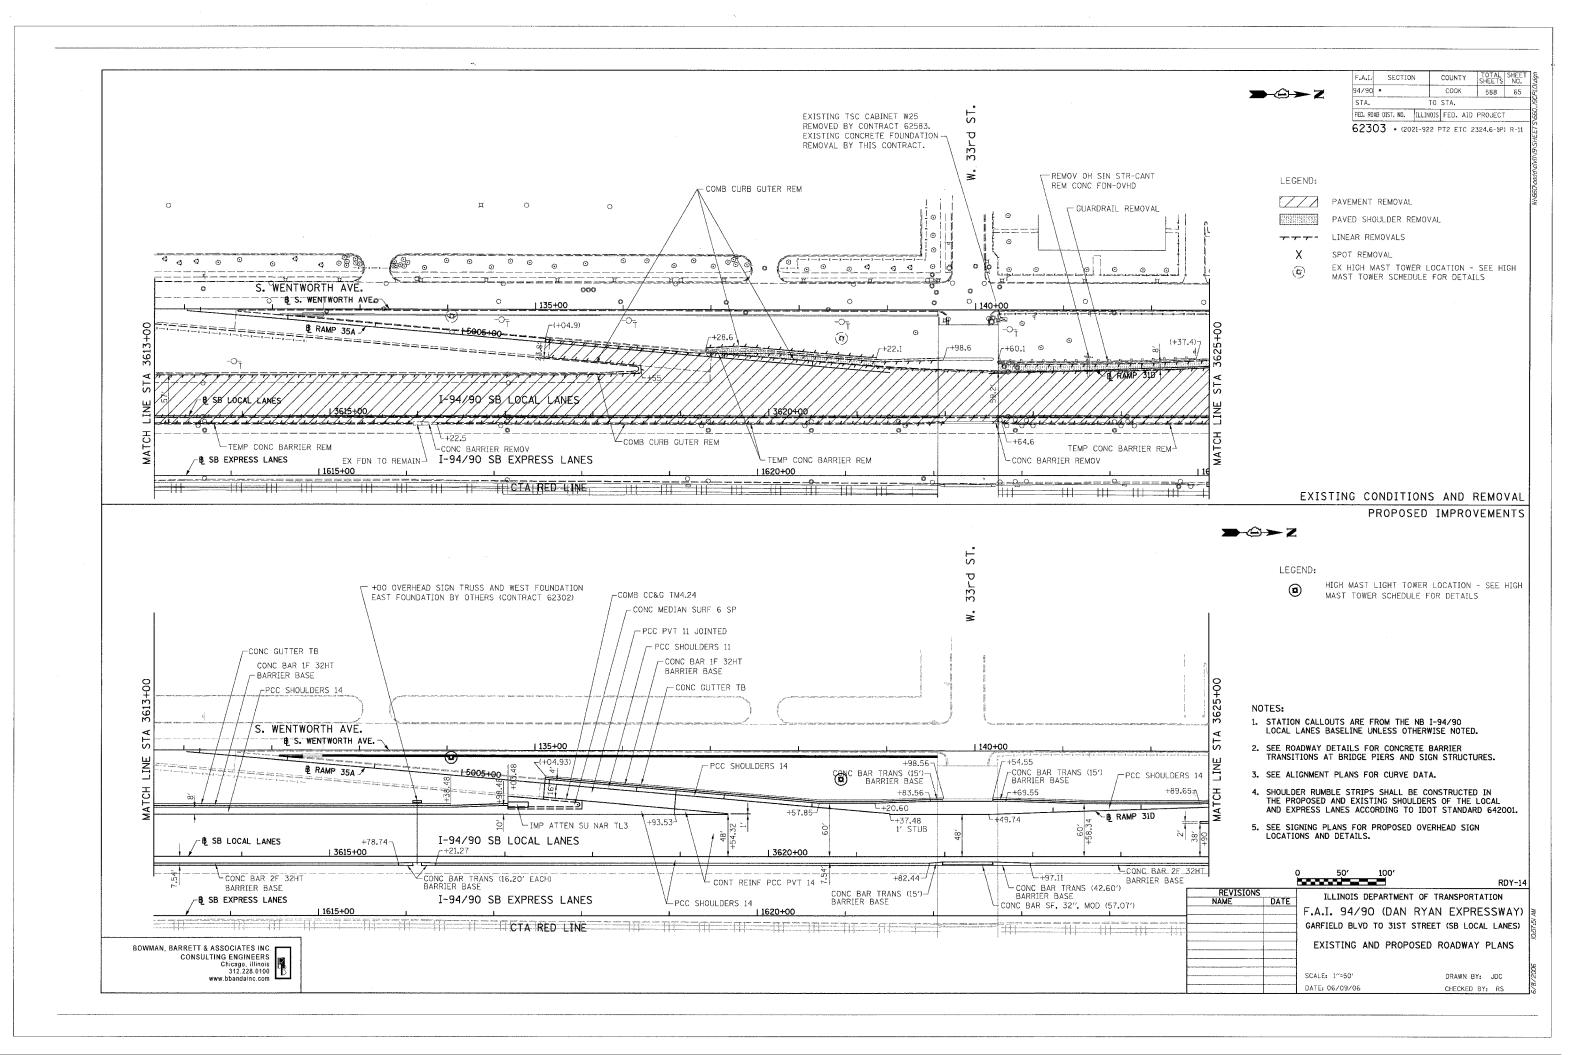


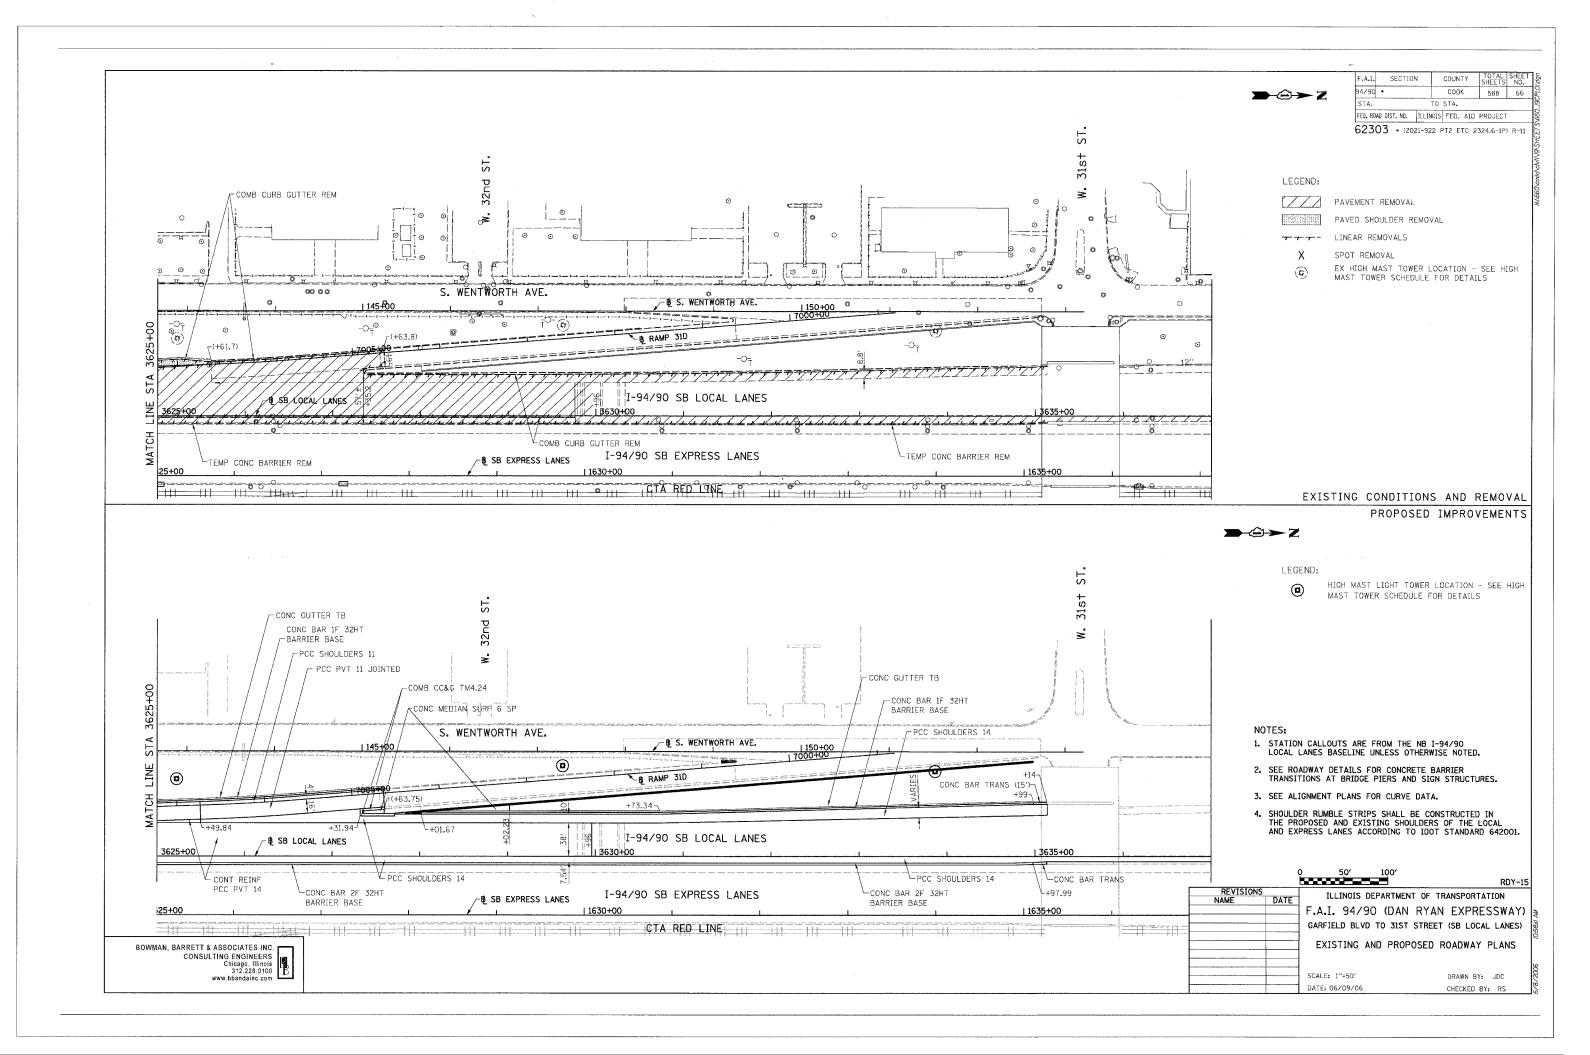


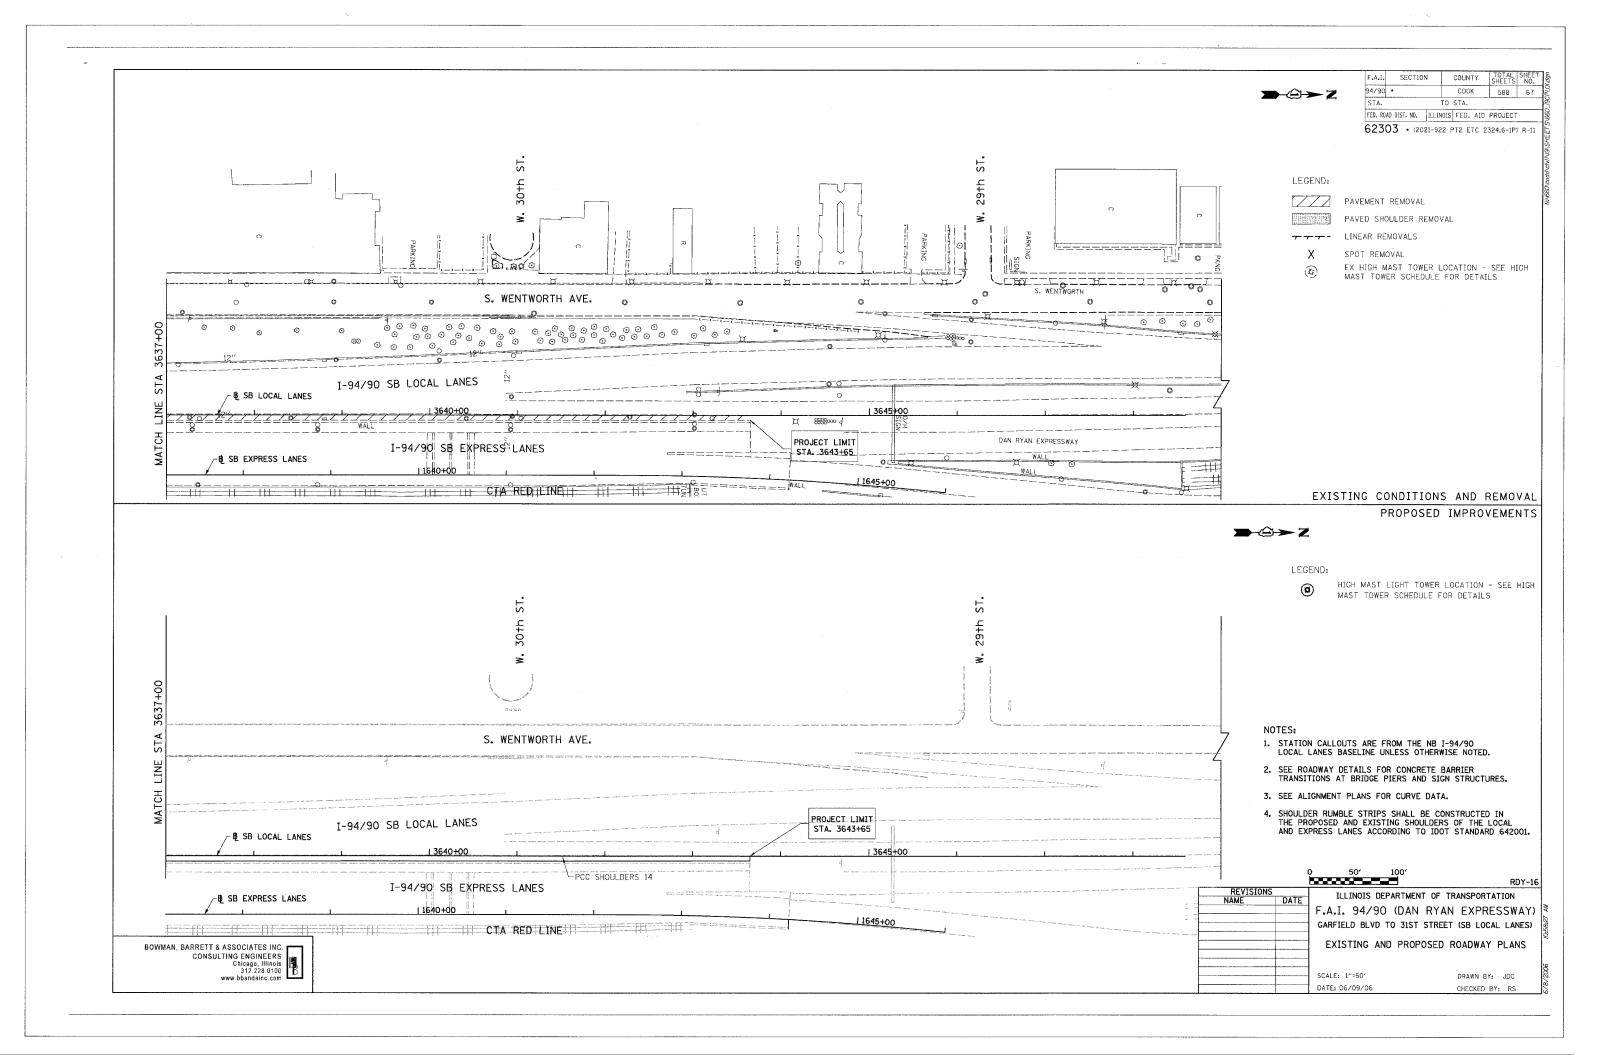


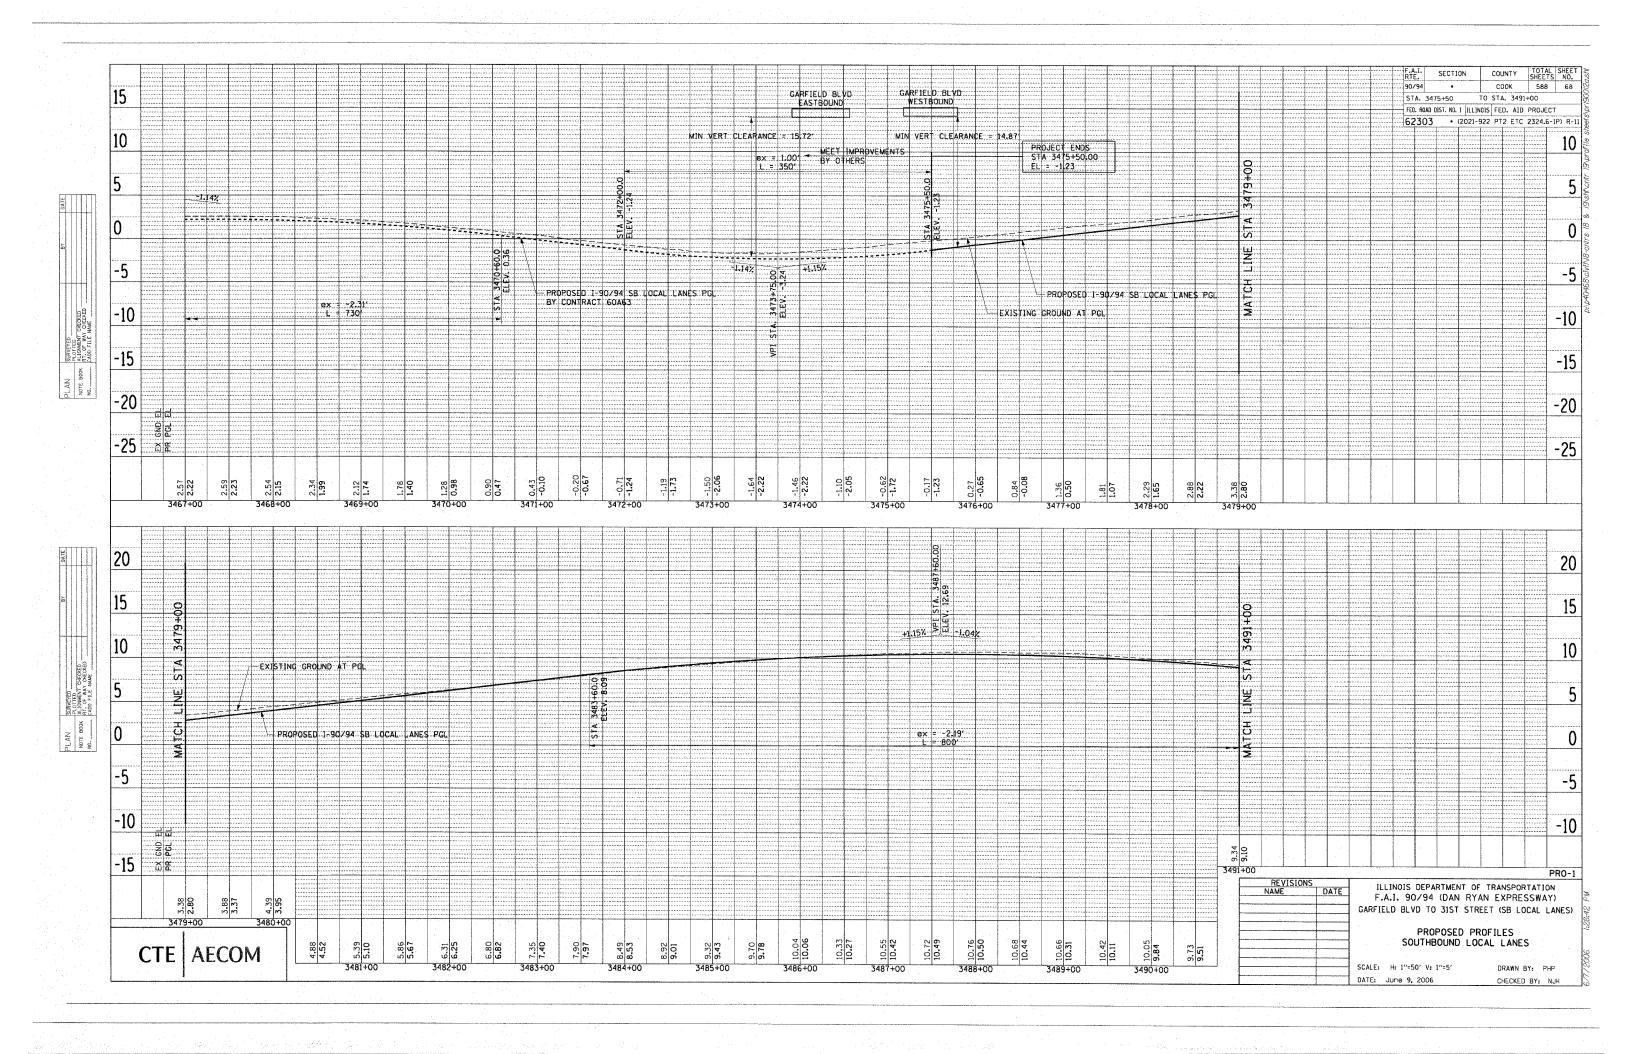


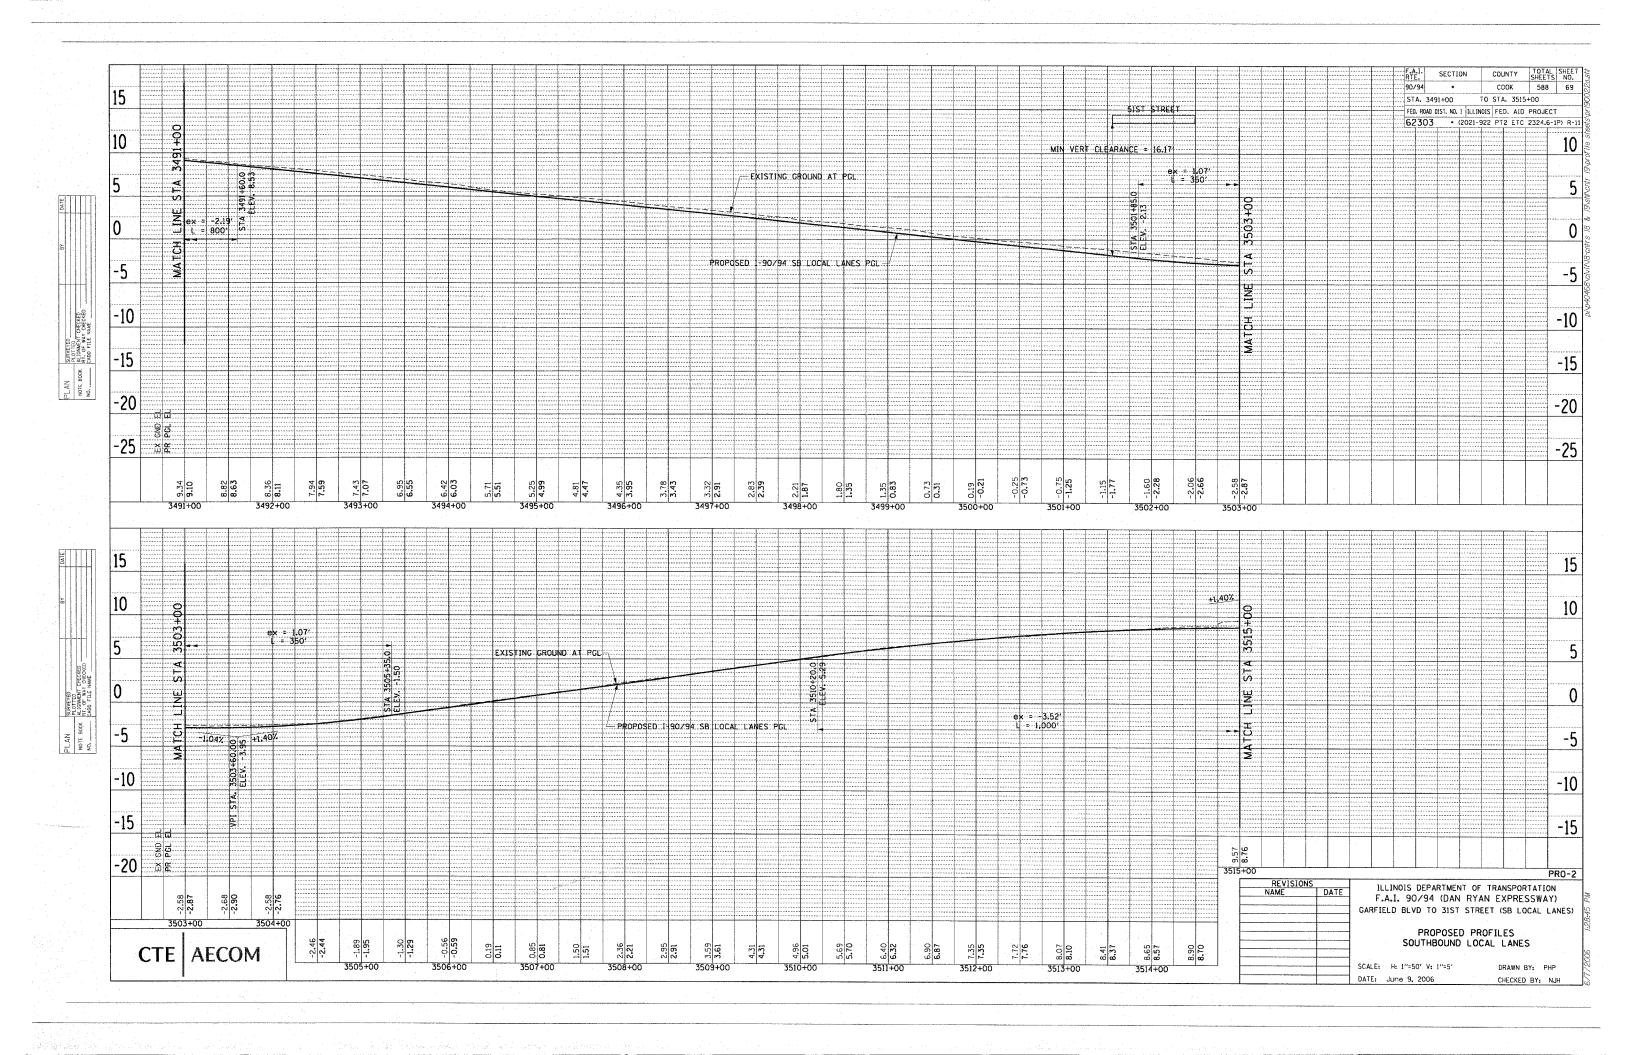


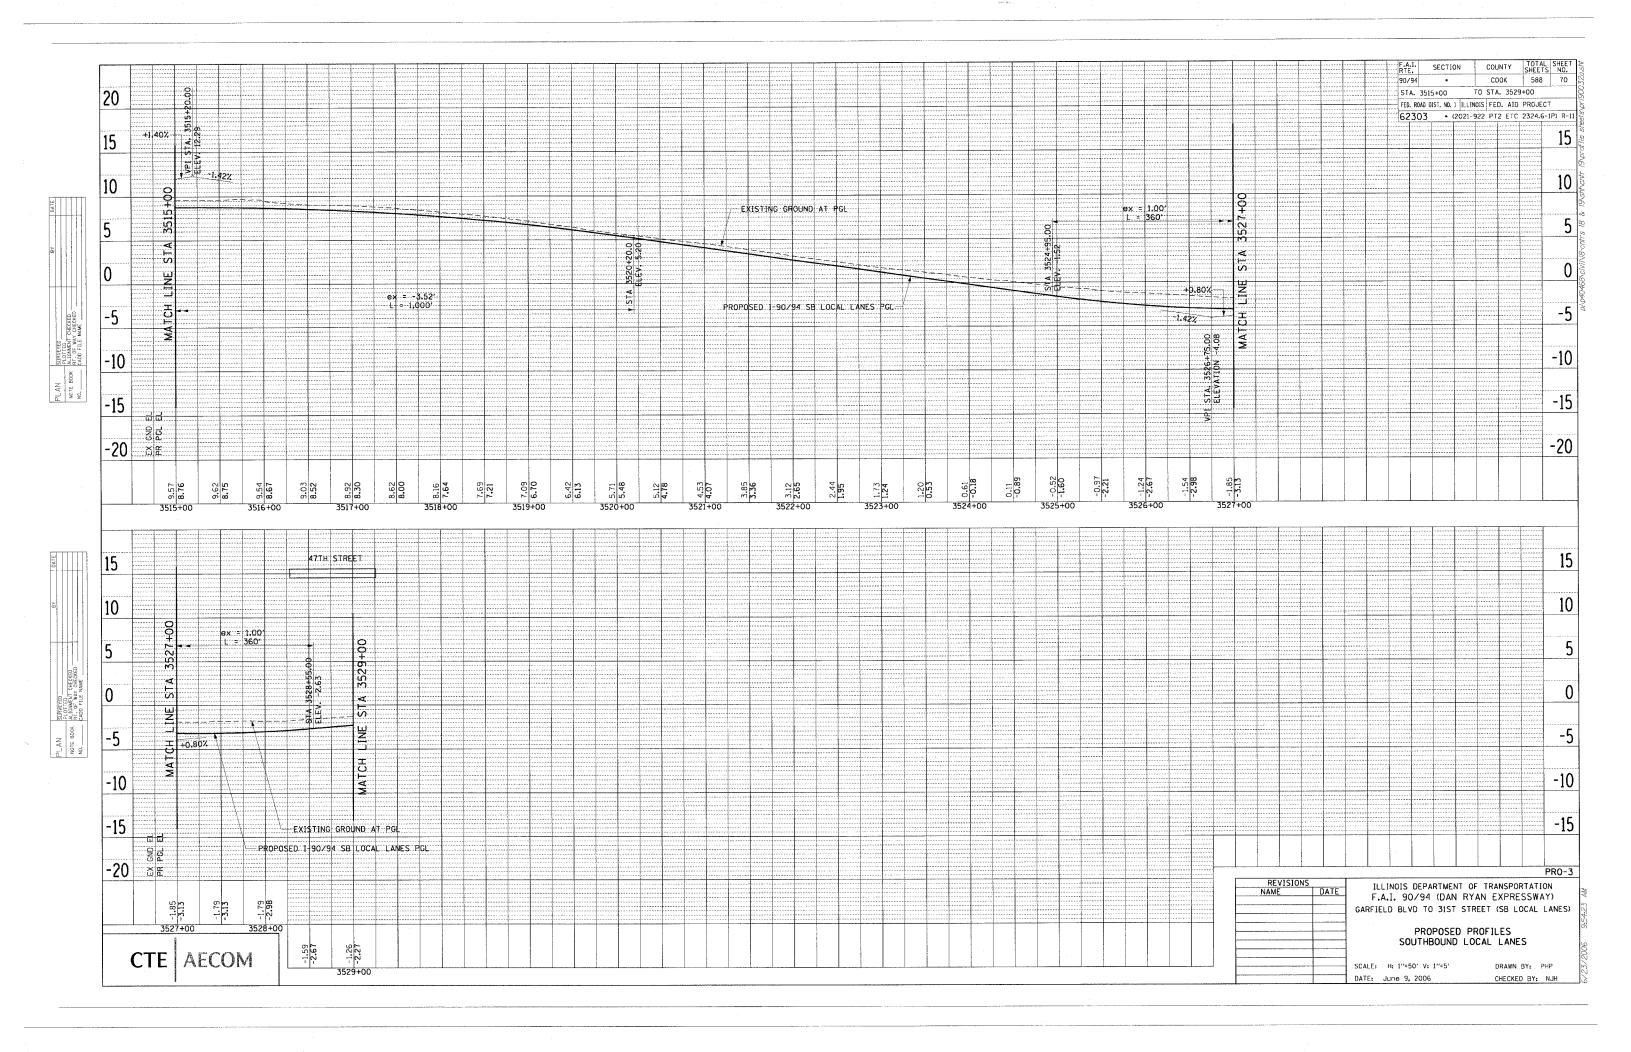


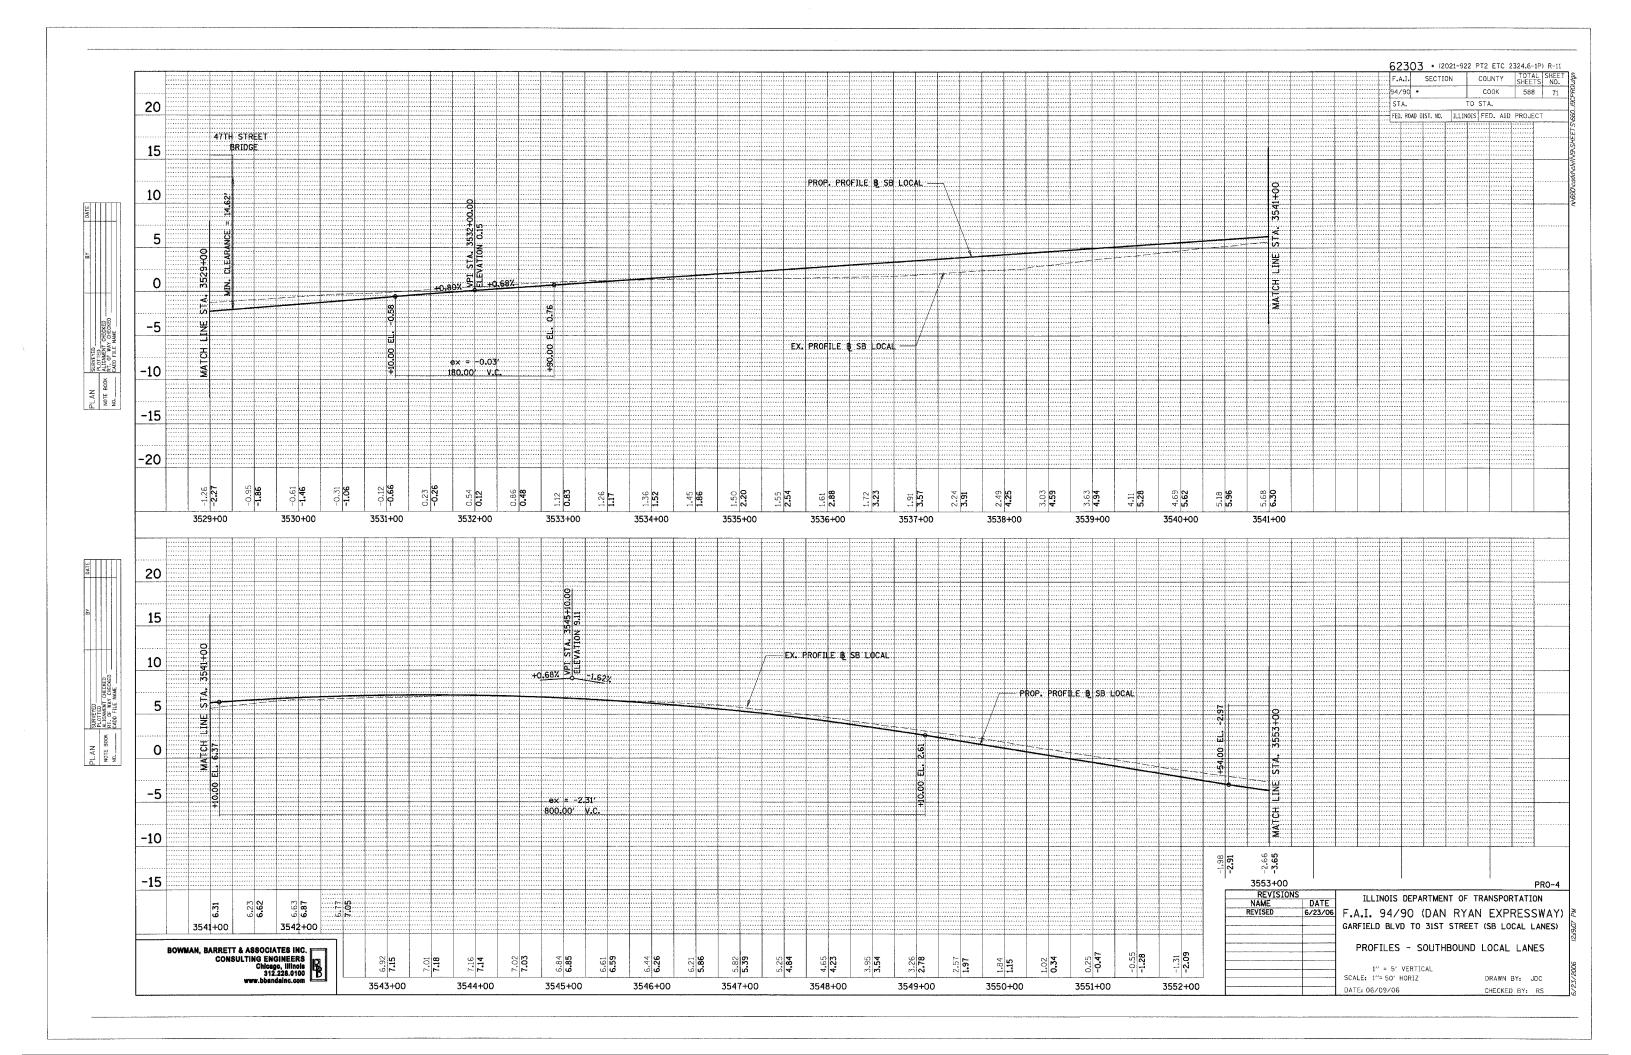


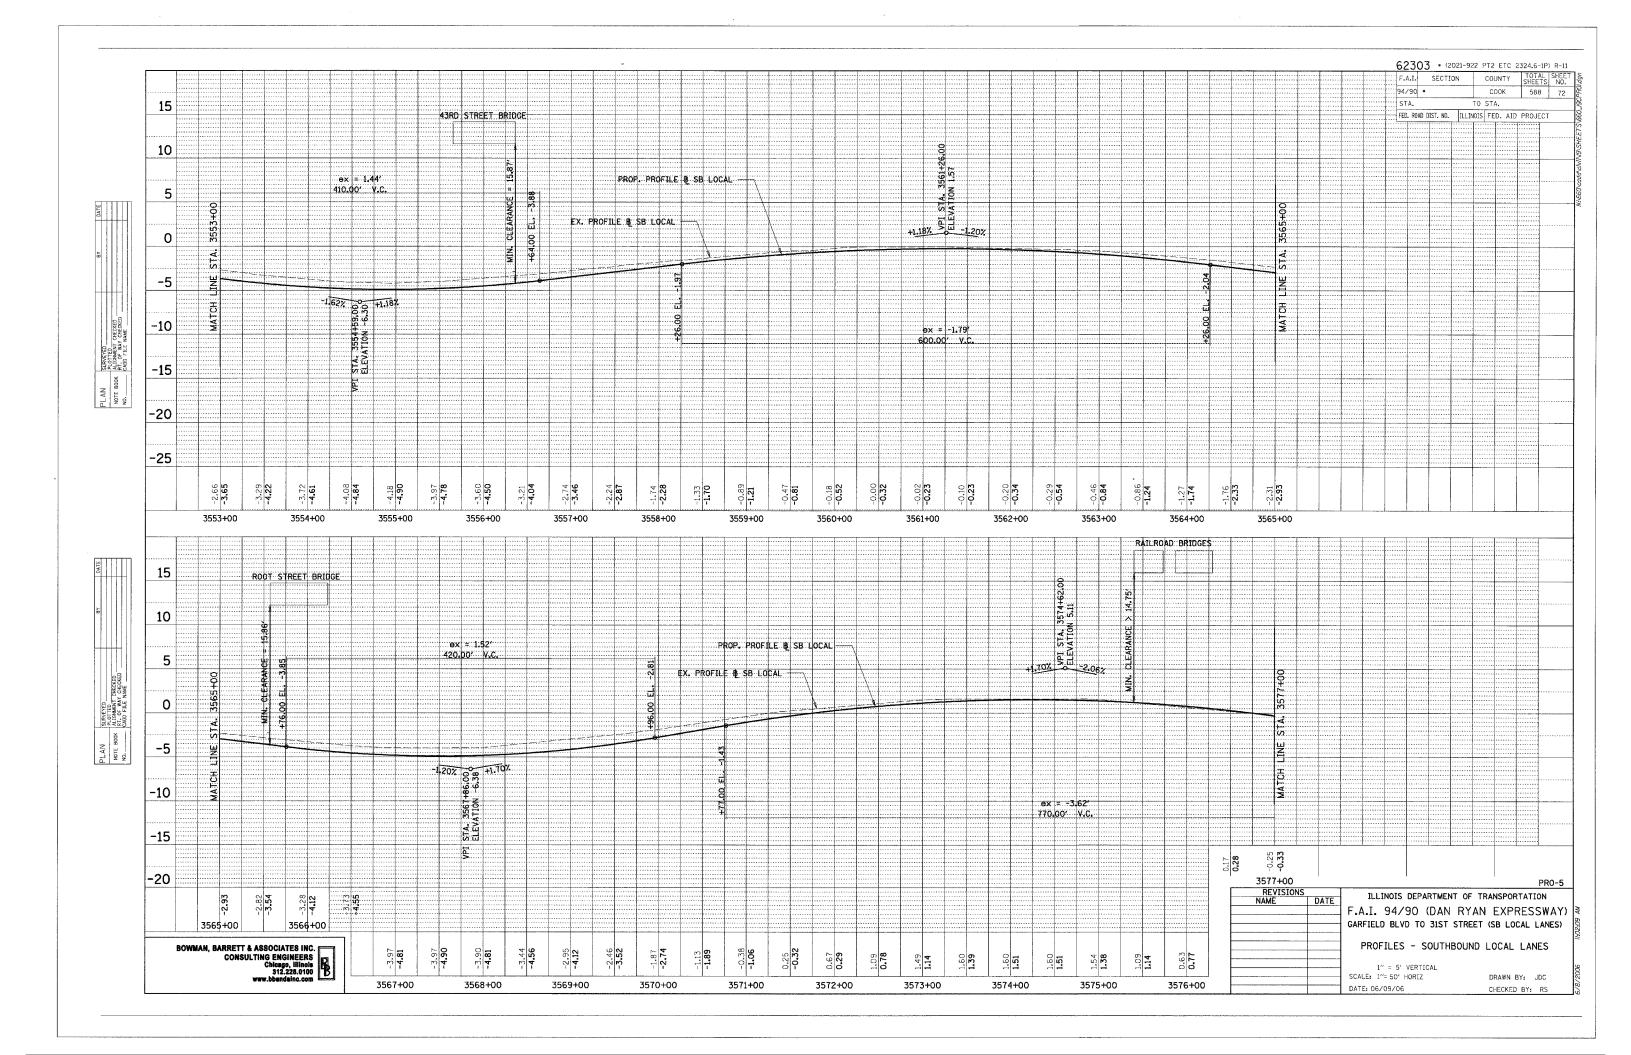


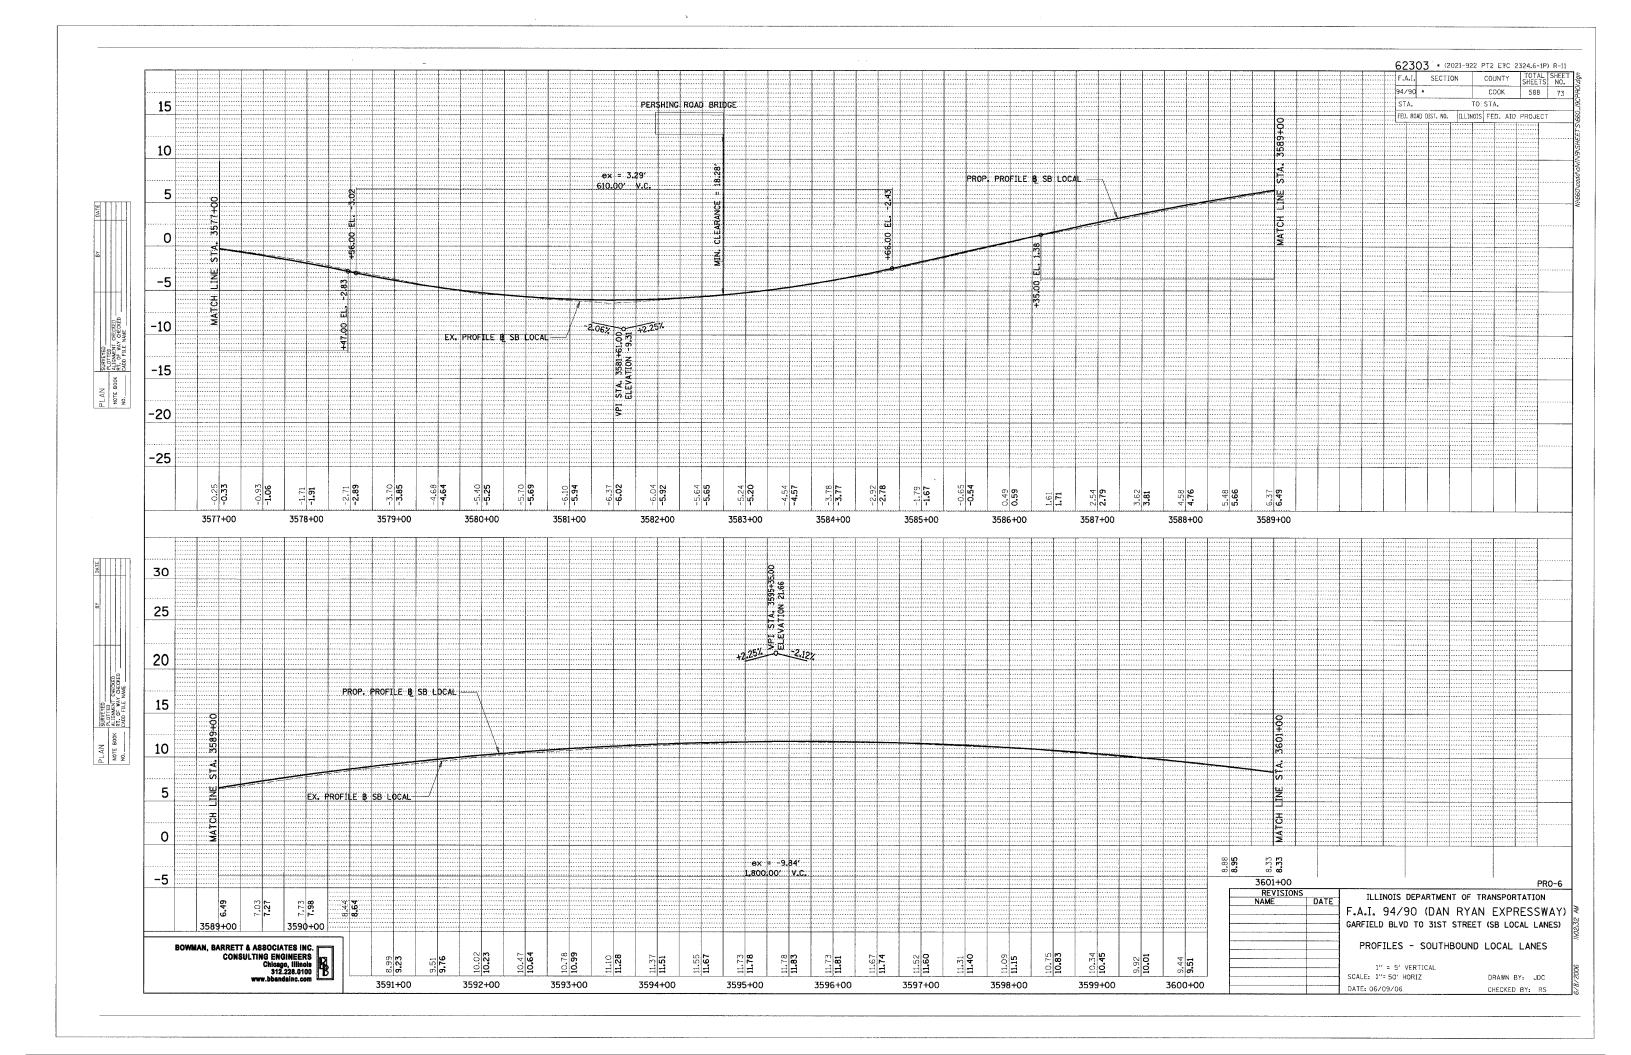


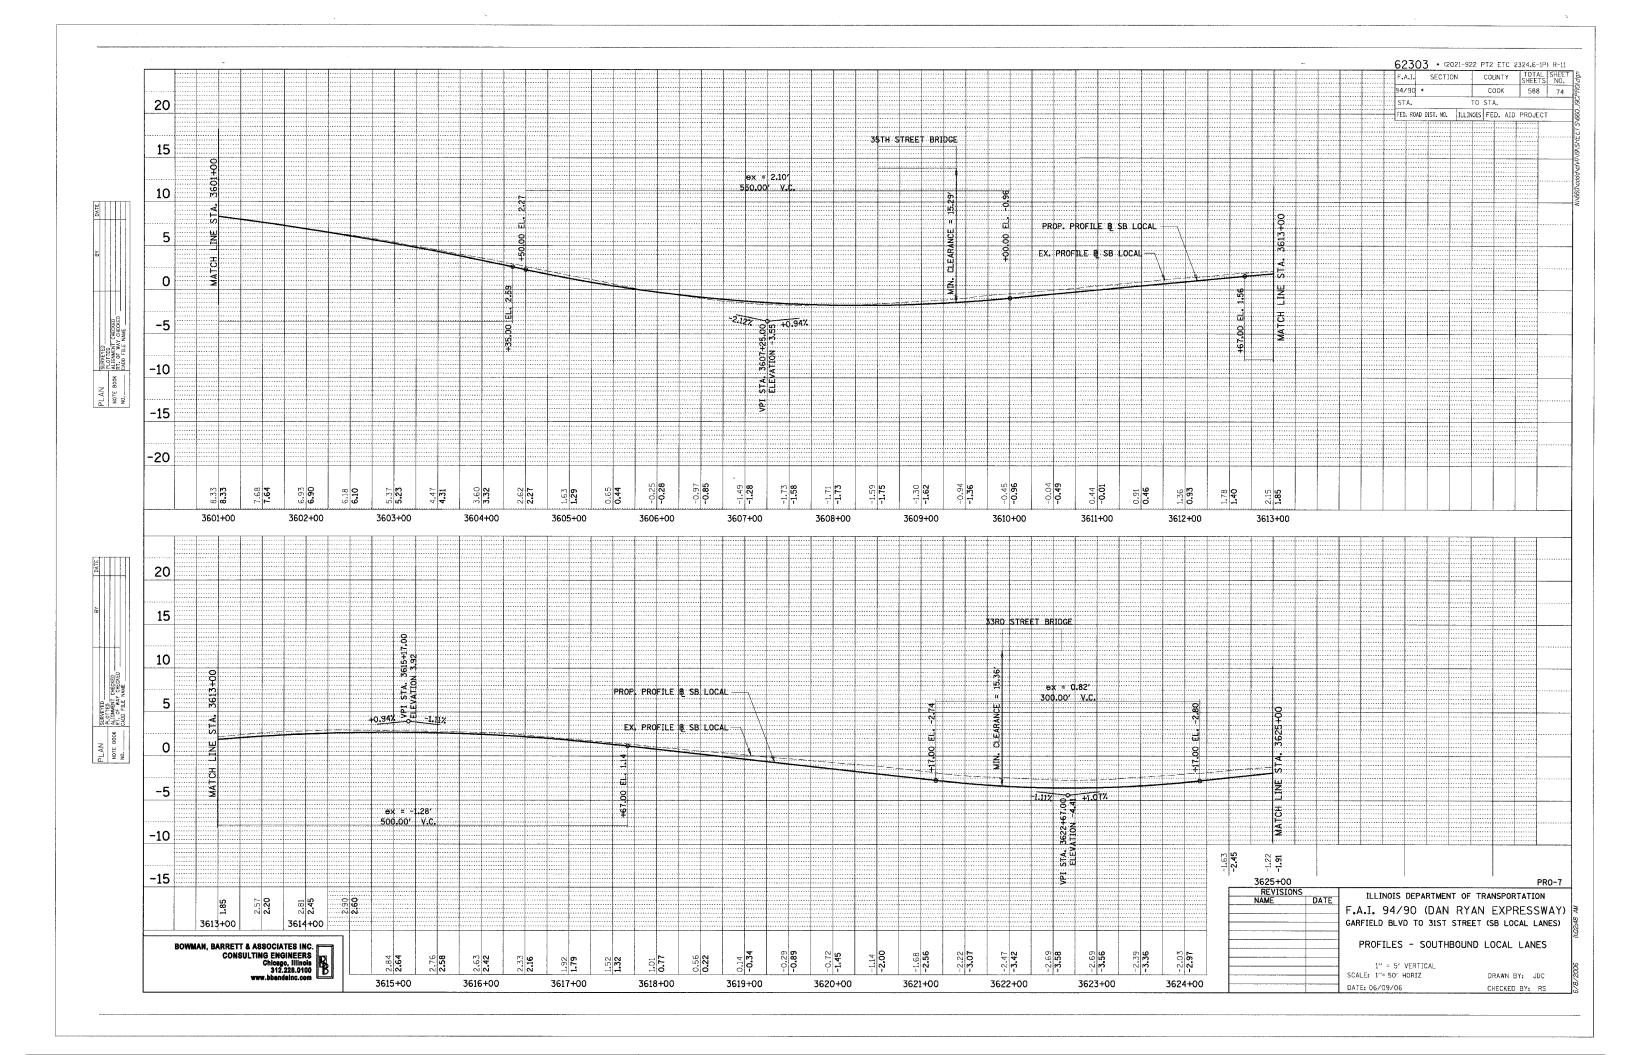


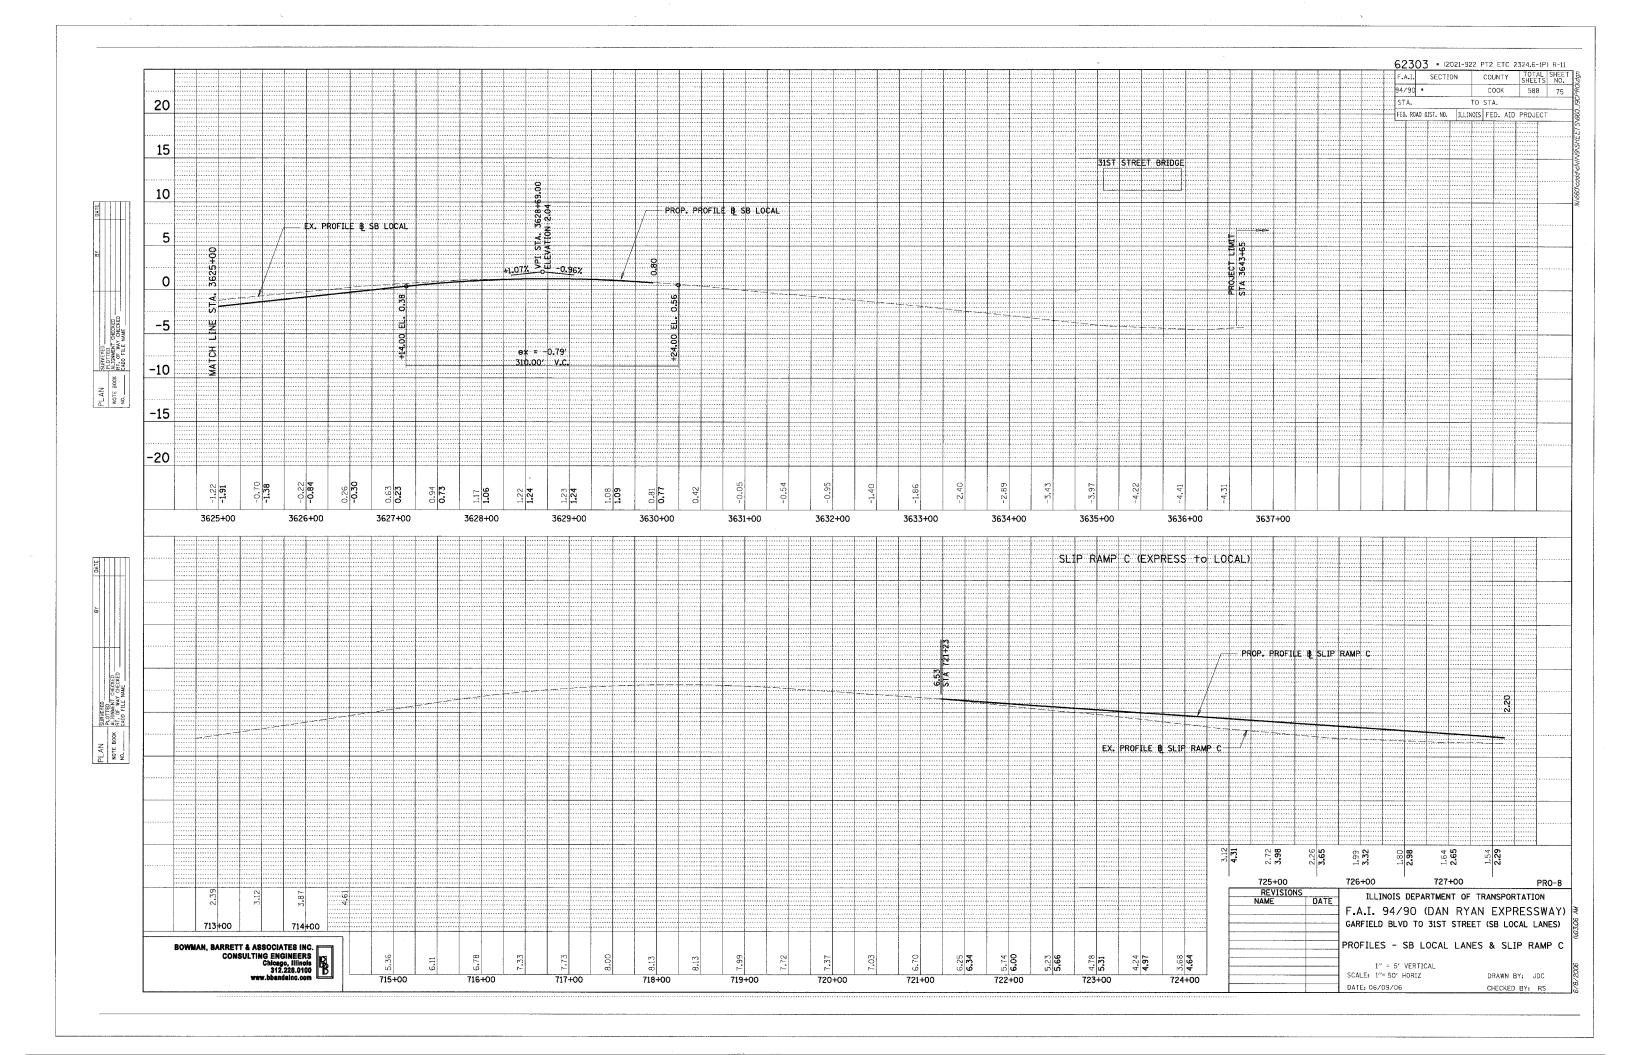

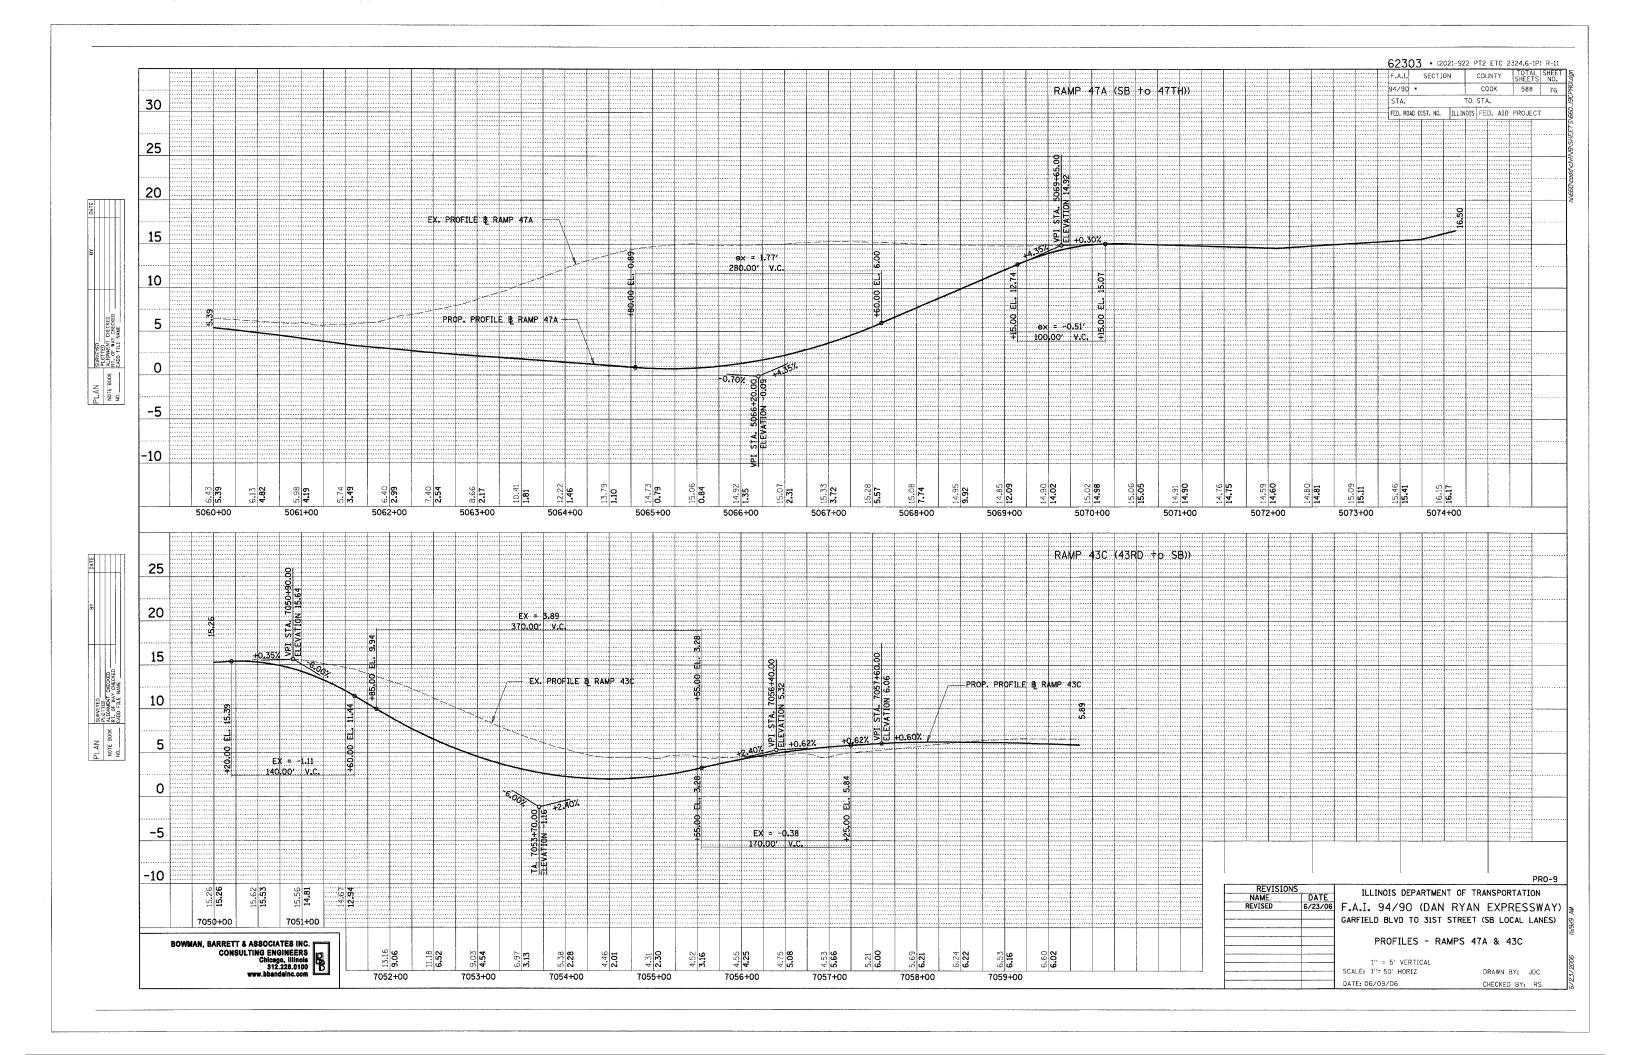

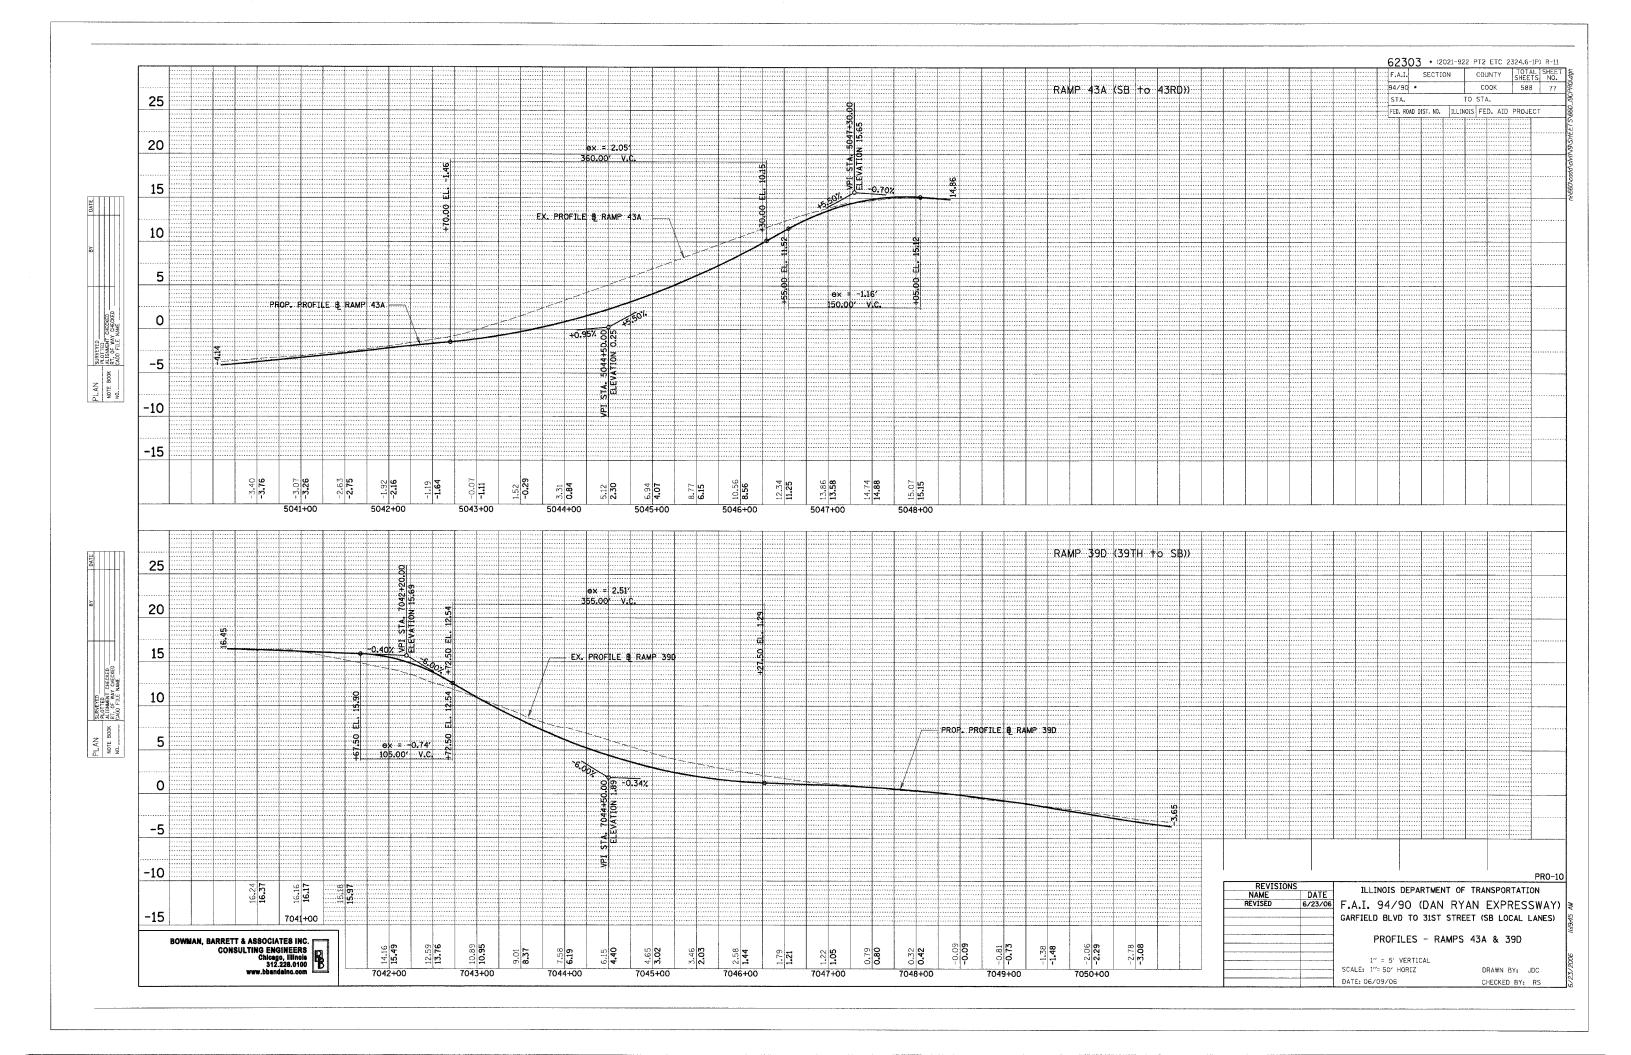

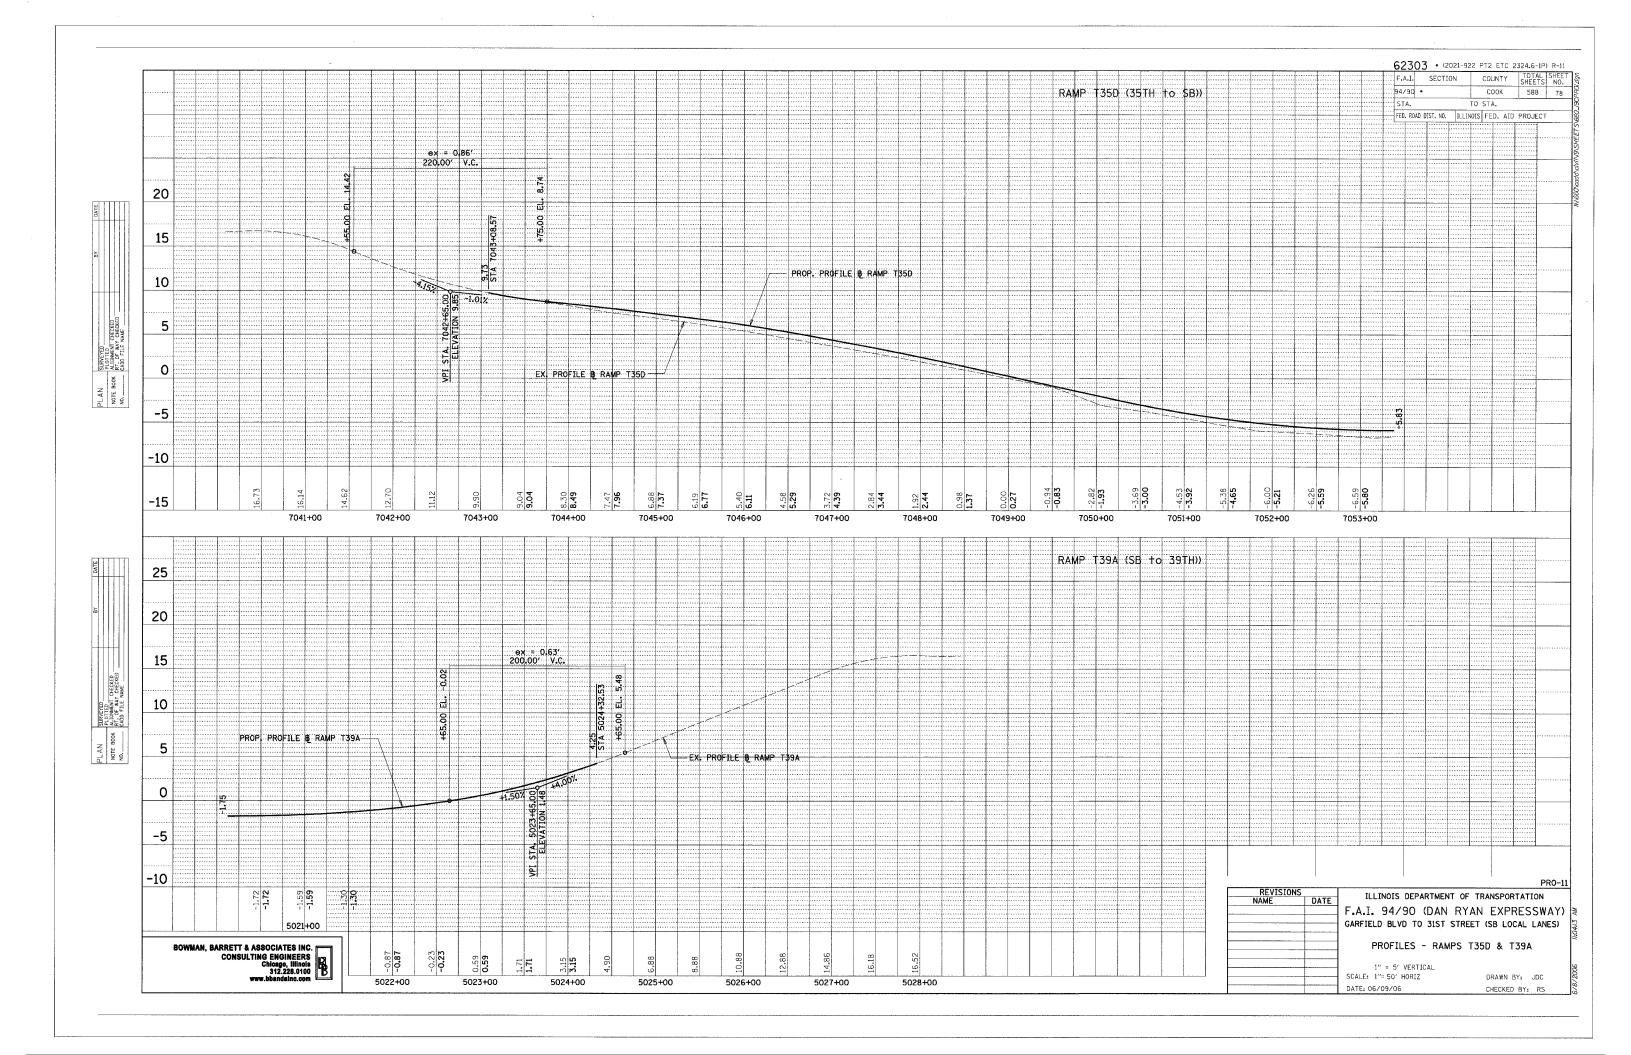

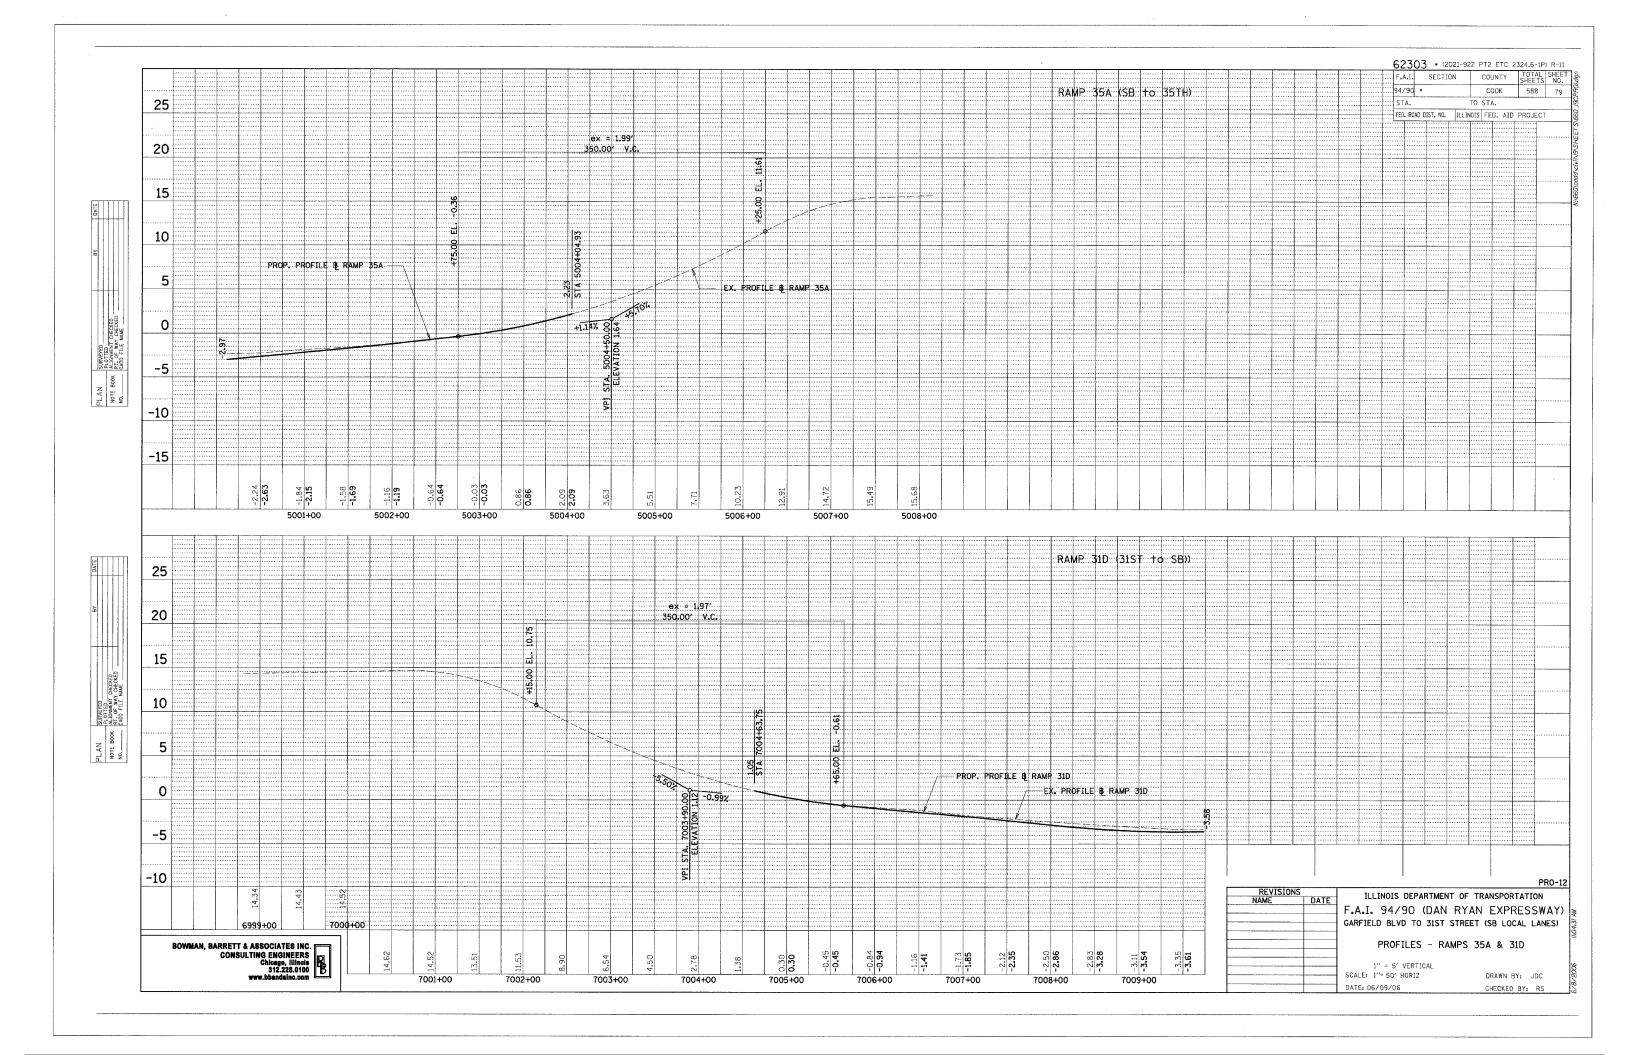

MAINTENANCE OF TRAFFIC GENERAL NOTES

- 1. THE CONTRACTOR MUST COORDINATE ALL LANE CLOSURES WITH THE ENGINEER.
- 2. SEE SPECIAL PROVISIONS FOR PROTECTION AND COORDINATION REQUIRED WITH THE CHICAGO TRANSIT AUTHORITY.
- ALL TRAFFIC CONTROL DEVICES AND SIGNAGE REQUIRED ON THE DAN RYAN EXPRESSWAY AND RAMPS IN ACCORDANCE WITH APPLICABLE IDOT DISTRICT I STANDARDS, IDOT HIGHWAY STANDARDS, AND THIS CONTRACT DRAWINGS IS INCLUDED IN THE COST OF TRAFFIC CONTROL AND PROTECTION (EXPRESSWAYS). AND WILL NOT BE PAID FOR SEPARATELY.
- ALL EXISTING DRAINAGE STRUCTURE LIDS AND GRATES SHALL BE SECURED TO THE SATISFACTION OF THE ENGINEER AT LOCATIONS WHERE TRAFFIC IS LOCATED ON THE SHOULDERS. SECURING OF THE LIDS AND GRATES WHILL NOT BE PAID FOR SEPARATELY AND IS INCLUDED IN THE CONTRACT UNIT PRICE FOR TRAFFIC CONTROL AND PROTECTION.
- 5. THE CONTRACTOR MUST COORDINATE WORK WITH IDOT CONTRACTS 62581, 62583, 62593, 60A62, 62985, AND 62986.
- 6. TRAFFIC CONTROL FOR THE DAN RYAN LOCAL LANES, EXPRESS LANES, AND ALL RAMPS AS DETAILED HEREIN WILL BE PAID FOR AT THE CONTRACT LUMP SUM PRICE FOR TRAFFIC CONTROL AND PROTECTION (EXPRESSWAYS). TRAFFIC CONTROL FOR THE LOCAL STREETS SUCH AS WELLS, WENTWORTH, LA SALLE, LAFAYETTE AND STATE WILL PAID FOR AT THE CONTRACT LUMP SUM PRICE FOR TRAFFIC CONTROL AND PROTECTION (SPECIAL).
- 7. LANE CLOSURES, RAMP CLOSURES, SIGNING, PAVEMENT MARKING AND BARRICADE PLACEMENT SHALL BE IN ACCORDANCE WITH THE INCLUDED IDOT STANDARD DRAWINGS AND IDOT DISTRICT 1 STANDARD DETAILS.
- ANY RAISED REFLECTIVE PAVEMENT MARKERS THAT CONFLICT WITH THE TEMPORARY TRAFFIC LANES SHALL HAVE THE REFLECTIVE LENSES REMOVED. AS DIRECTED BY THE ENGINEER, AND REPLACED AT THE END OF THE PROJECT. THE COST OF REMOVAL AND REPLACEMENT OF THE RAISED REFLECTIVE PAVEMENT MARKER LENSES IS INCLUDED IN THE CONTRACT UNIT PRICE FOR TRAFFIC CONTROL AND PROTECTION (EXPRESSWAYS).
- 9. EXISTING PAVEMENT MARKINGS THAT CONFLICT WITH TEMPORARY PAVEMENT MARKINGS SHALL BE REMOVED, AS DIRECTED BY THE ENGINEER, THE REMOVAL WILL BE MEASURED IN SQUARE FEET AND PAID FOR AS PAVEMENT
- 10. ALL DRUMS, VERTICAL PANELS, AND BARRICADES IMMEDIATELY ADJACENT TO THE EDGE OF TRAVELED WAY SHALL BE EQUIPPED WITH STEADY BURN MONO-DIRECTIONAL LIGHTS, CONES WILL NOT BE ALLOWED, UNLESS NOTED, DRUM SPACINGS SHALL BE 50' CENTER TO CENTER ALONG THE DAN RYAN AND 25' C-C AT ALL RAMP LOCATIONS, DRUMS SHALL BE PLACED AT 100' C-C AT LOCATIONS OF FULL SHOULDER WIDTH.
- 11. ANY EXISTING SIGNS DENOTED WITHIN THE PLAN SET THAT DO NOT APPLY TO THE REVISED TRAFFIC PATTERNS SHALL BE REMOVED OR COVERED, AS DIRECTED BY THE ENGINEER, THE COVERING OR REMOVAL OF GROUND MOUNTED/ OVERHEAD SIGNS SHALL BE NON-DESTRUCTIVE IN NATURE AND WILL NOT BE MEASURED FOR PAYMENT BUT IS CONSIDERED INCLUDED IN THE CONTRACT UNIT PRICE FOR TRAFFIC CONTROL AND PROTECTION (EXPRESSWAYS) / (SPECIAL).
- 12. MONODIRECTIONAL PRISMATIC BARRIER REFLECTORS SHALL BE PLACED ON ALL TEMPORARY CONCRETE BARRIER WALL AS INDICATED IN THE SPECIAL PROVISIONS.
- 13. THE BASE OF THE TEMPORARY CONCRETE BARRIER ON THE EXPRESSWAY LANES SHALL BE MARKED WITH A 6" LINE AS DESCRIBED IN THE SPECIAL PROVISION FOR TRAFFIC CONTROL AND PROTECTION (EXPRESSWAYS). THESE MARKINGS WILL BE MEASURED IN LINEAR FEET AND PAID FOR AS TEMPORARY PAVEMENT MARKING, LINE 6".
- 14. AT LOCATIONS WHERE A HAZARD EXISTS WITHIN 4.0 FEET OF THE TEMPORARY CONCRETE BARRIER, THE BARRIER SHALL BE ANCHORED TO THE PAVEMENT, ANCHORING OF THE TEMPORARY CONCRETE BARRIER WILL NOT BE MEASURED FOR PAYMENT BUT IS INCLUDED IN THE CONTRACT UNIT PRICE FOR TEMPORARY CONCRETE BARRIER AND RELOCATE TEMPORARY CONCRETE BARRIER
- 15. ADVANCE SIGNING AND WORK LIMIT SIGNING MUST CONFORM TO IDOT HIGHWAY STANDARDS 701400 AND 701600, SIGNS THAT INCORRECTLY IDENTIFY A WORK ZONE OR END CONSTRUCTION SHALL BE REMOVED, CONSTRUCTION WORK, TRAFFIC CONTROL, AND ADVANCE SIGNING MUST BE COORDINATED WITH ADJACENT DAN RYAN CONSTRUCTION CONTRACTS.
- 16. ADVANCED SIGNING PER IDOT DISTRICT 1 DETAIL TC-22 AND/OR CHANGABLE MESSAGE SIGNS SHALL BE USED IN ADVANCE OF ROAD WORK IN BOTH NORTHBOUND AND SOUTHBOUND DIRECTIONS, ON BOTH THE FRONTAGE ROADS AND EXPRESSWAY LANES. THESE SIGNS WILL BE PAID FOR AT THE CONTRACT UNIT PRICE FOR TEMPORARY INFORMATION SIGNING OR CHANGEABLE MESSAGE SIGN.
- 17. ALL TEMPORARY PAVEMENT MARKINGS ARE SHOWN ON THE PLANS AS PAVEMENT MARKING TAPE, TYPE III OF THE LINE WIDTH SPECIFIED, THE CONTRACTOR MAY REQUEST PERMISSION TO USE EPOXY PAVEMENT MARKING IN PLACE OF PAVEMENT MARKING TAPE, TYPE III WHEN WEATHER CONDITIONS FALL OUTSIDE THE TEMPERATURE RESTRICTIONS STATED IN THE MANUFACTURERS SPECIFICATIONS FOR INSTALLING THE TAPE, THE INSTALLATION AND REMOVAL OF THE EPOXY PAVEMENT MARKING SHALL BE PAID FOR AS PAVEMENT MARKING TAPE, TYPE III AND WORK ZONE PAVEMENT MARKING REMOVAL RESPECTIVELY.
- 18. THE CONTRACTOR IS RESPONSIBLE FOR COORDINATING AND PROVIDING ACCESS POINTS TO THE WORK ZONE. ACCESS POINTS MUST BE APPROVED BY THE ENGINEER PRIOR TO INSTALLATION. ANY SIGNING OR ADDITIONAL TRAFFIC CONTROL DEVICES REQUIRED TO PROVIDE CONTRACTOR ACCESS TO THE WORK ZONE IS INCLUDED IN THE COST OF TRAFFIC CONTROL AND PROTECTION (EXPRESSWAYS) AND WILL NOT BE PAID FOR SEPARATELY.
- 19. CLOSE COORDINATION IS NEEDED WITH CONTRACT 62A62 AND 625B1. LANE CLOSURES AND STAGE CHANGES ARE DEPENDENT ON WORK INCLUDED IN CONTRACT 62A62 AND 62581 AND SHALL BE COORDINATED BETWEEEN THE CONTRACTORS. THE CONTRACTOR SHALL NOTIFY THE CONTRACTOR OF CONTRACT 62A62 AND 62581 OF ANY LANE CLOSURES AND SCHEDULE CHANGES TO ALLOW THE CONSTRUCTION SEQUENCE TO FLOW SMOOTHLY.
- 20. THERE ARE NO DRAWINGS FOR STAGE 4 TRAFFIC CONTROL. ALL WORK SHALL BE COMPLETED USING DAYTIME/NIGHTTIME.
 SHOULDER AND LANE CLOSURES. THERE ARE NO DRAWINGS FOR PRESTAGE 1 TRAFFIC CONTROL. ALL WORK SHALL BE COMPLETED USING FREEWAY ENTRANCE AND EXIT RAMP CLOSURE DETAILS' FOR THE 47TH ST EXIT RAMP, AND HIGHWAY STD 701601 FOR THE FRONTAGE ROAD.

BOWMAN, BARRETT & ASSOCIATES INC. F CONSULTING ENGINEERS Chicago, Illinois 312.228.0100 www.bbandainc.con

MAINTENANCE OF TRAFFIC GENERAL NOTES (CONTINUED)

21. "RELOCATE TEMPORARY CONCRETE BARRIER" WILL BE MEASURED FOR PAYMENT WHEN THE BARRIER IS RELOCATED AND USED AS A TRAFFIC CONTROL DEVICE, THERE MAY BE SOME INSTANCES WHEN THE EXISTING TEMPORARY CONCRETE BARRIER REQUIRES RELOCATION DUE TO THE CONTRACTORS ACTIVITIES BUT THE BARRIER WILL NOT BE USED FOR MAINTENANCE OF TRAFFIC DURING THAT STAGE, THIS BARRIER WILL NOT BE MEASURED FOR PAYMENT UNTIL IT IS USED AS A TRAFFIC CONTOL DEVICE IN A SUBSEQUENT STAGE.

F.A.I.	SECTIO	N	COUNTY	TOTAL SHEETS	SHEET NO.		
94/90			COOK	588	80		
STA.			TO STA.				
FED. RO	AD DIST. NO.	ILLIN	OIS FED. AID	PROJECT			

62303 * (2021-922 PT2 ETC 2324.6-1P) R-11

STAGING OVERVIEW:

PRE-STAGE 1

RAMPS CLOSED TO TRAFFIC:

-RAMP 47A (47TH STREET EXIT RAMP) THE REST OF THE RAMPS ARE OPEN TO TRAFFIC

DESCRIPTION OF WORK PERFORMED IN THIS PRE-STAGE. -RETAINING WALL S-47N-R, AND S-45S-F

STAGE 1

RAMPS OPEN TO TRAFFIC:

-GARFIELD BLVD EXIT RAMP

-RAMP 43C (43RD STREET ENTRANCE RAMP)

-RAMP 43A (43RD STREET EXIT RAMP) -RAMP T35D (35TH STREET ENTRANCE RAMP)

-RAMP 35A (35TH STREET EXIT RAMP)

RAMPS CLOSED TO TRAFFIC:

-RAMP 47D (47TH STREET ENTRANCE RAMP)

-RAMP 47A (47TH STREET EXIT RAMP)

-RAMP 39D (PERSHING ROAD ENTRANCE RAMP)

-RAMP 394 (PERSHING ROAD EXIT RAMP) -RAMP 31D (31ST STREET ENTRANCE RAMP)

DESCRIPTION OF WORK PERFORMED IN THIS STAGE:

-LOCAL LANE RECONSTRUCTION (GARFIELD BLVD TO 53RD STREET, 52ND STREET TO 31ST STREET) -FRONTAGE ROAD SOUTH OF PERSHING AND

RAMP RECONSTRUCTION -GORE WORK AT RAMPS 39A AND 31D

(RAMPS ARE OPEN TO TRAFFIC IN SUBSTAGE IA) -RETAINING WALL S-47N-R, S-45S-F, S-39S-R

SUBSTAGE 1A

RAMPS OPEN TO TRAFFIC:

-GARFIELD BLVD EXIT RAMP

-RAMP 43C (43RD STREET ENTRANCE RAMP) -RAMP 43A (43RD STREET EXIT RAMP)

-RAMP T35D (35TH STREET ENTRANCE RAMP)

-RAMP 39A (PERSHING ROAD EXIT RAMP)

-RAMP 35A (35TH STREET EXIT RAMP)

-RAMP 31D (31ST STREET ENTRANCE RAMP)

RAMPS CLOSED TO TRAFFIC:

-RAMP 47D (47TH STREET ENTRANCE RAMP)

-RAMP 47A (47TH STREET EXIT RAMP) -RAMP 39D (PERSHING ROAD ENTRANCE RAMP)

DESCRIPTION OF WORK PERFORMED IN THIS STAGE: -WORK SOUTH OF PERSHING ROAD SAME AS

CERMAK / FRANKLIN CONNECTOR

LAKESHORE DRIVE / 18TH STREET

26TH STREET / FRANKLIN CONNECTOR

SUGGESTED LOCATIONS

(NB) I-55 / I-90/94

31ST STREET EXIT RAMP

31ST ST ENTRANCE RAMP

35TH STREET EXIT RAMP

39TH STREET EXIT RAMP

43RD STREET EXIT RAMP 43RD STREET ENTRANCE RAMP

47TH STREET EXIT RAMP SB I-55 EAST OR STATE ST

55TH ST. EXIT RAMP 47TH ST. ENTRANCE RAMP

35TH STREET ENTRANCE RAMP

39TH STREET ENTRANCE RAMP

NB I-55 WEST OF DAMEN AVE.

DESCRIBED IN STAGE 1 -GORE WORK AT RAMPS 39A AND 31D IS DONE AND RAMPS ARE OPEN TO TRAFFIC

STAGING OVERVIEW (CONTINUED):

STAGE 2

RAMPS OPEN TO TRAFFIC.

-GARFIELD BLVD EXIT RAMP

-RAMP 47D (47TH STREET ENTRANCE RAMP)

-RAMP 47A (47TH STREET EXIT RAMP)

-RAMP 39D (PERSHING ROAD ENTRANCE RAMP)

-RAMP 39A (PERSHING ROAD EXIT RAMP) -RAMP 31D (31ST STREET ENTRANCE RAMP)

RAMPS CLOSED TO TRAFFIC:

-RAMP 43C (43RD STREET ENTRANCE RAMP)

-RAMP 43A (43RD STREET EXIT RAMP)

-RAMP T35D (35TH STREET ENTRANCE RAMP)

-RAMP 35A (35TH STREET EXIT RAMP)

DESCRIPTION OF WORK PERFORMED IN THIS STAGE: -LOCAL LANE RECONSTRUCTION (GARFIELD BLVD

TO 53RD STREET, 52ND STREET TO 31ST STREET)

-FRONTAGE ROAD SOUTH OF PERSHING AND RAMP RECONSTRUCTION

(SEE CONTRACT 62581)

-GORE WORK AT RAMPS T35D AND 35A

(RAMPS ARE OPEN TO TRAFFIC IN SUBSTAGE 2B) -RETAINING WALL S-45N-F

SUBSTAGE 2A

DESCRIPTION OF WORK PERFORMED IN THIS STAGE: -WORK SOUTH OF 33RD STREET SAME AS DESCRIBED IN STAGE 2 -SB LOCAL LANES ON HIGH BRIDGE OPEN

> THIS SUBSTAGE 24 WILL CONNECT TRAFFIC FLOW FROM THE SB HIGH BRIDGE CONTRACT 62581 TO THE SB LOCAL LANE CONTRACT 62303.

SUBSTAGE 2B

RAMPS OPEN TO TRAFFIC:

-RAMP 47A (47TH STREET EXIT RAMP)

-RAMP 39D (PERSHING ROAD ENTRANCE RAMP)

-RAMP 39A (PERSHING ROAD EXIT RAMP)

-RAMP T35D (35TH STREET EXIT RAMP) -RAMP 35A (35TH STREET EXIT RAMP)

-RAMP 31D (31ST STREET ENTRANCE RAMP)

RAMPS CLOSED TO TRAFFIC:

CMS BOARDS : TOTAL DURATION

(CAL MO)

12

12

12

12

12

12

(EACH)

ΤΟΤΔΙ

-RAMP 43C (43RD STREET ENTRANCE RAMP)

-RAMP 43A (43RD STREET EXIT RAMP)

DESCRIPTION OF WORK PERFORMED IN THIS STAGE.

-WORK SOUTH OF PERSHING ROAD SAME AS

DESCRIBED IN STAGE 2.
-GORE WORK AT RAMPS T35D AND 35A IS DONE AND RAMPS ARE OPEN TO TRAFFIC

STAGING OVERVIEW (CONTINUED):

STAGE 3

RAMPS OPEN TO TRAFFIC:

-RAMP 47D (47TH STREET ENTRANCE RAMP)

-RAMP 47A (47TH STREET EXIT RAMP)

-RAMP 43A (43RD STREET EXIT RAMP)

-RAMP 39D (PERSHING ROAD ENTRANCE RAMP)

-RAMP 39A (PERSHING ROAD EXIT RAMP)

~RAMP T35D (35TH STREET EXIT RAMP) -RAMP 35A (35TH STREET EXIT RAMP)

-RAMP 31D (31ST STREET ENTRANCE RAMP)

RAMPS CLOSED TO TRAFFIC:

-RAMP 43C (43RD STREET ENTRANCE RAMP) -GARFIFLD BLVD FXIT RAMP

DESCRIPTION OF WORK PERFORMED IN THIS STAGE: -LOCAL LANE RECONSTRUCTION (GARFIELD BLVD

TO 53RD STREET, 52ND STREET TO 31ST STREET)
-FRONTAGE ROAD SOUTH OF PERSHING AND RAMP 43C RECONSTRUCTION

STAGE 4

RAMPS OPEN TO TRAFFIC:

-RAMP 47A (47TH STREET EXIT RAMP)

-RAMP 43C (43RD STREET ENTRANCE RAMP)

-RAMP 43A (43RD STREET EXIT RAMP) -RAMP 39D (PERSHING ROAD ENTRANCE RAMP)

-RAMP 39A (PERSHING ROAD EXIT RAMP)

-RAMP T35D (35TH STREET EXIT RAMP)

-RAMP 35A (35TH STREET EXIT RAMP)

-RAMP 31D (31ST STREET ENTRANCE RAMP)

RAMPS CLOSED TO TRAFFIC:

AND LOCAL LANES

-NONE

DESCRIPTION OF WORK PERFORMED IN THIS STAGE:

-TWO SINGLE FACE CONCRETE BARRIER AND RAISED CONCRETE MEDIAN AT THE TEMPORARY

47TH STREET ENTRANCE RAMP -INSTALL SHOULDER RUMBLE STRIP IN EXPRESS

-FINISH CROSS OVER AREAS USED ON STAGE 3.

THE CONTRACTOR IS RESPONSIBLE FOR COORDINATING THE PLACEMENT AND MESSAGES FOR ALL CHANGEABLE MESSAGE SIGNS. PROVIDED BELOW FOR INFORMATION ONLY ARE ANTICIPATED LOCATIONS AND DURATIONS AT EACH LOCATION FOR PORTABLE CHANGEABLE MESSAGE SIGNS:

KEA1210N2		ILLINOIS DEPARTMENT OF TRANSPORTATION										
NAME	DATE	TELLIANTS DEL WILLIMETAL OF LUMINSCOLLATION										
		F.A.I. 94/90 (DAN RYAN EXPRESSWAY)										
		GARFIELD BLVD TO 31ST STREET (SB LOCAL LANES)										
		MAINTENANCE OF TRAFFIC										
		GENERAL NOTES										

	MU	IGN	-01
ANSPOR	ТДТ	ton	

SCALE: NTS DRAWN BY: RA DATE: 06/09/06 CHECKED BY: RS

CHANGEABLE MESSAGE SIGNS

F.A.I. SECTION COUNTY TOTAL SHEET NO. 94/90 • COOK 588 81 STA. TO STA. FED. ROMO DIST. NO. | ILLINOIS | FED. AID | PROJECT | 62303 • (2021-922 | PTZ | ETC | 2324.6-1P) | R-11

	1	1 ~	· · · · · · · · · · · · · · · · · · ·	Т	·	Ţ		r	·		T					T	1	1		1			
	TEMPORARY PAVEMENT MARKING LINE 6"	PAVEMENT MARKING TAPE, TYPE III LETTER AND SYMBOLS	PAVEMENT MARKING TAPE, TYPE III 4"	PAVEMENT MARKING TAPE, TYPE III 5"	PAVEMENT MARKING TAPE, TYPE III 8"	PAVEMENT MARKING TAPE, TYPE III 12"	WORK ZONE PAVEMENT MARKING REMOVAL	TEMPORARY CONCRETE BARRIER	RELOCATE TEMPORARY CONCRETE BARRIER	MONODIRECTIONAL PRISMATIC BARRIER REFLECTOR	PAVEMENT MARKING REMOVAL	TEMPORARY INFORMATION SIGNING	IMPACT ATTENUATORS TEMPORARY (NON-REDIRECTIVE) TEST LEVEL 3	IMPACT ATTENUATORS RELOCATE (NON-REDIRECTIVE) TEST LEVEL 3	IMPACT ATTENUATORS, TEMPORARY (SEVERE USE, NARROW) TEST LEVEL 3	IMPACT ATTENUATORS, RELOCATE (SEVERE USE, NARROW) TEST LEVEL 3	TEMPORARY PAVEMENT (INTERSTATE)	TEMPORARY PAVEMENT REMOVAL	TEMPORARY PAVEMENT (VARIABLE DEPTH)	IMPACT ATTENUATORS, TEMPORARY (SEVERE USE, NARROW) TEST LEVEL 2	BITUMINOUS SURFACE REMOVAL 3"	PAVEMENT REMOVAL	
	FOOT	SQ FT	F00T	FOOT	FOOT	FOOT	SQ FT	FOOT	FOOT	EACH	SQ FT	SQ FT	EACH	EACH	EACH	EACH	SY	SY	TON	EACH	SY	SY	
MOT-101	0	0	1300	488	0	0	1288	0	650	26	1820	0	0	0	0	0	0	0	0.0	0	0	0	
M0T-102	1430	108	3709	1803	2462	89	855	0	2190	88	4295	123	1	0	0	0	0	0	0.0	0	0	0	
MOT-103	1250	0	4180	1711	384	0	1234	0	1250	50	4828	89	0	0	0	0	0	0	0.0	0	0	0	
M0T-104	1710	73	5231	1800	1446	144	0	490	1220	77	4557	23.5	1	0	1	0	0	0	89.1	1	0	0	
MOT-105	2730	0	5158	1800	1227	59	0	190	2540	133	3497	91.0	2	0	0	0	0	0	32.7	0	0	0	
MOT-106	1340	0	5318	1800	1352	122	0	750	2400	123	2713	137.3	1	0	1	0	0	0	31.1	.0	0	0	
MOT-107	630	0	6118	1800	0	0	0	630	720	121	2729	88.8	1	0	0	0	0	0	0.0	0	0	0	
MOT-108	710	0	4970	1275	853	106	0	510	200	69	1970	371.0	1	0	0	0	0	0	37.5	0	0	0	
MOT-109	0	0	4721	0	1945	220	0	0	0	0	1440	72.0	0	0	0	0	0	0	0.0	0	0	0	
MOT-1A01	2280	0	2303	0	3021	341	511	1540	270	100	445	126.0	3	0	0	0	468	0	62.5	0	0	0	
MOT-1A02	0	0	174	0	568	0	93	0	0		0	196.0	1	0	0	0	232	0	61.9	0	908	260	
MOT-201	0	36	0	0	130	0	541	0	0	0	355	32	0	0	0	0	0	0	0	0	0	0	
MOT-202	40	72	0	0	81	0	544	0	40	2	1,207	20	0	0	0	0	0	0	' 0	0	0	0	
MOT-203	370	0	1,276	0	902	89	0	0	370	16	0	20	1	0	0	0	522	522	0	0	0	0	
MOT-204	1,890	0	1,445	0	2,501	390	1,021	180	1,710	90	0	72.0	1	1	0	0	0	1,592	33.3	0	0	0	
MOT-205	2,240	73	3,319	268	1,311	125	1,300	50	630	73	0	23.5	0	1	0	1	671	585	23,7	0	0	0	
M0T-206	0	0	886	0	0	0	1,021	0	230	10	0	137.5	0	0	0	0	0	556	0.0	0	0	0	
M0T-207	560	0	330	0	0	0	212	0	450	23	0	98.5	0	1	0	0	0	0	0.0	0	0	0	
MOT-208	0	0	0	0	0	0	0	0	0	0	0	226.5	0	0	0	0	0	669	0.0	0	0	0	
MOT-209	0	0	0	0	0	0	0	0	0	0	0	72	0	0	0	0	0	0	0.0	0	0	0	
MOT-2A01	0	73	3,397	295	5,074	973	2,119	30	950	39	552	300.0	0	1	0	0	467	0	63.5	0	0	0	
MOT-2B01	1,550	0	2,698	0	2,333	137	602	1,530	250	25	0	55.0	0	1	0	0	185	487	27.3	0	0	0	
M0T-2B02	2,400	0	3,485	0	3,239	338	951	370	3,990	175	0	14.0	0	0	0	0	0	0	0.0	0	0	0	
MOT-2B03	0	73	843	0	2,694	380	1,328	0	0	0	44	84.0	0	0	0	0	0	0	0.0	0	0	0	
M0T-301	0	0	0	0	0	0	3,147	0	0	0	2,157	0	0	0	0	0	0	0	0	0	0	0	
M0T-302	0	0	495	0	0	0	5,874	0	0	0	0	20	0	0	0	0	0	0	0	0	0	0	
MOT-303	0	0	0	0	0	0	4,266	0	0	0	0	0	0	0	0	0	0	0	0	0	0	0	
MOT-304	0	0	0	0	113	0	5,087	0	0	0	0		0	0	0	0	0	595	0.0	0	0	0	
MOT-305	1,700	0	5,154	130	641	378	7,239	1,030	2,070	78	0	57.5	1	0	0	0	318	1,469	17.7	0	225	0	
MOT-306	2,400	0	5,563	600	994	61	7,158	1,120	3,680	192	0	84.0	0	0	0	0	0	1,172	0.0	0	0	260	
MOT-307	2,400	0	6,293	600	796	123	7,158	0	4,800	192	0	160.0	0	0	0	0	0	0	0.0	0	0		
MOT-308	620	73	1,501	244	1,463	229	9,039	0	1,220	73	0	0.0	0	2	0	0	0	1,719	0.0	0	0		
MOT-309	0	0	0	0	0	0	1,415	0	0	0	0	0	0	0	0	0	0	0	0.0	0	0		
	-			-	-		,	-	-		-	-		-						- -			
TOTAL.	28,250	580	79,867	14,614	35,530	4,303	63,998	8,420	31,830	1,775	32,609	2,794	14	7	2	1	2,863	9,366	480	1	1,134		4

REVISIONS		ILLINOIS DEPARTMENT OF TRANSPORTATION								
NAME D	ATE	ILLINOIS DEPARTMENT OF TRANSPORTATION								
		F.A.I. 94/90 (DAN RYAN EXPRESSWAY)								
		GARFIELD BLVD TO 31ST STREET (SB LOCAL LANES)								
		MAINTENANCE OF TRAFFIC								
		SCHEDULE								
l		i								

SCALE: =NTS DATE: 06/09/06 DRAWN BY: RA CHECKED BY: RS

BOWMAN, BARRETT & ASSOCIATES INC.
CONSULTING ENGINEERS
Chicago, Illinois
312 228 0.100
www.bbandainc.com

SECTION C-C STATION 1475+50.00 TO 1490+96.82 SECTION C-C STATION 1507+50.00 TO 1528+87.61

STATION RANGE

1475+56.06 TO 1489+61.03 1523+00 TO 1528+87.61

STATION RANGE


& SB EXPRESS LANES

1475+56.06 TO 1483+00 1483+00 TO 1485+00 1485+00 TO 1490+96.82

1507+50 TO 1528+00 1528+00 TO 1528+50 1528+50 TO 1528+87.61

& SB EXPRESS LANES MIN 1' (2) (A) (F)(3)(B) (C) (8)(A)

SECTION H-H STATION 1490+96.82 TO 1507+50.00

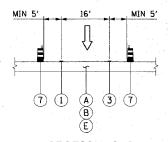

SECTION G-G RAMP SECTIONS

55TH STREET EXIT RAMP 47TH STREET ENTRANCE RAMP

1 PAVEMENT MARKING - LINE 4" (WHITE)

2 PAVEMENT MARKING - LINE 5" (WHITE SKIP DASH)

(3) PAVEMENT MARKING - LINE 4" (YELLOW)

(4) RELOCATE TEMPORARY CONCRETE BARRIER

(5) TEMPORARY PAVEMENT MARKING - LINE 6"

(6) MONODIRECTIONAL PRIMATIC BARRIER REFLECTOR

(7) DRUM OR BARRICADE TYPE II WITH STEADY BURN LIGHT

SECTION

COUNTY TOTAL SHEET NO.

TO STA. FED. ROAD DIST. NO. 1 ILLINOIS FED. AID PROJECT

62303 * (2021-922 PT2 ETC 2324.6-1P) R-1

COOK 588 82

(8) PAVEMENT MARKING - LINE 8" (WHITE SKIP DASH)

(9) PAVEMENT MARKING - LINE 8" (WHITE)

(A) PAVEMENT

B SHOULDER

(C) EXISTING BARRIER WALL

(D) EXISTING TEMPORARY BARRIER WALL

(E) TEMPORARY PAVEMENT

F PAVEMENT-SHOULDER JOINT

G PAVEMENT-PAVEMENT JOINT

MOTTS-01


ILLINOIS DEPARTMENT OF TRANSPORTATION F.A.I. 90/94 (DAN RYAN EXPRESSWAY) GARFIELD BLVD TO 31ST STREET (SB LOCAL LANES) SUGGESTED STAGES OF CONSTRUCTION
AND TRAFFIC CONTROL
TYPICAL SECTIONS 3475+50 TO 3529+00

SCALE: 1"=50" DATE: June 9, 2006

DRAWN BY: PHP CHECKED BY: RMG

TYPICAL SECTIONS NEED TO BE VERIFIED WITH THE TRAFFIC CONTROL PLANS WITH REGARDS TO TRAFFIC CONTROL CONDITIONS AND PAVEMENT MARKING SIZES.

CTE **AECOM**

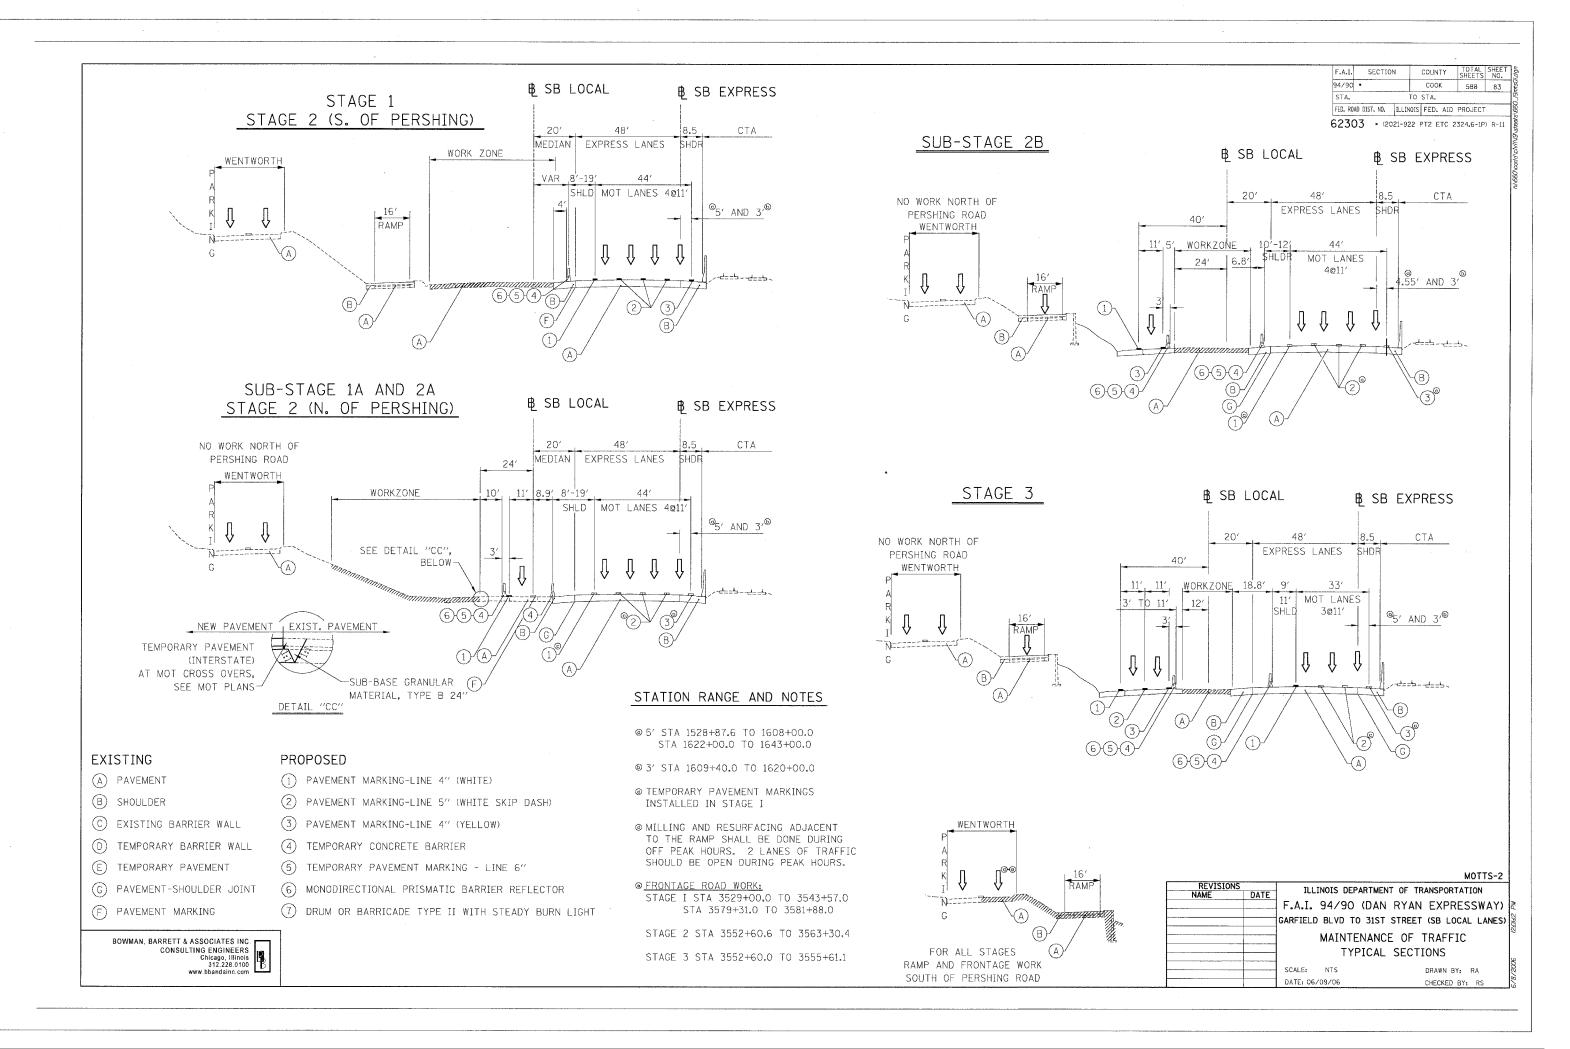

SECTION COUNTY TOTAL SHEE COOK 588 84 90/94 TO STA. 3482+00 FED. ROAD DIST. NO. 1 ILLINOIS FED. AID PROJECT 62303 • (2021-922 PT2 ETC 2324.6-1P) R-1 1 LANE NUMBER AND DIRECTION OF TRAFFIC TEMPORARY PAVEMENT IMPACT ATTENUATORS, TEMPORARY (NON-REDIRECTIVE), TEST LEVEL 3 DRUM OR BARRICADE TYPE II WITH STEADY BURNING LIGHT

> BARRICADE TYPE III TEMPORARY CONCRETE BARRIER

LINE 4" (YELLOW EDGE) LINE 4" (WHITE EDGE)

WORK AREA

LEGEND:

TT

LINE 4" (SKIP DASH, 6' SKIP - 2' DASH, WHITE) LINE 5" (SKIP DASH, 30' SKIP - 10' DASH, WHITE)

LINE 8" (WHITE GORE LINE)


LINE 8" (SKIP DASH, 12' SKIP - 3' DASH, WHITE) LINE 12" (DIAGONAL, 30' C-C, WHITE)

LETTERS AND SYMBOLS

ES-XXX-XX EXISTING OVERHEAD OR CANTILEVER SIGNS GS-XXX-XX EXISTING POST MOUNTED SIGNS

TS-XXX-XX TEMPORARY SIGNS

+XX.XX STATION PROVIDED FROM THE ± SB I-90/94 EXPRESS LANES (+XX.XX) STATION PROVIDED FROM THE ± SB I-90/94 LOCAL LANES

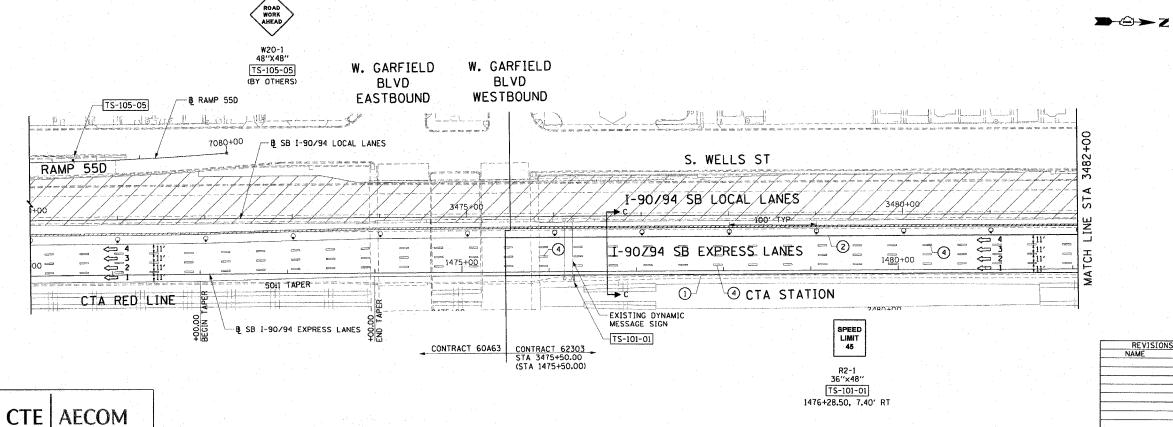

1. SEE SHEET MOTTS-01 FOR TYPICAL SECTIONS.

2. SEE TEMPORARY SIGN PANEL SHEETS FOR DETAILS.

THE SIGNING OF RAMP 55D SHALL BE IN ACCORDANCE WITH STATE STANDARD 701411.


MOT-101


REVISIONS NAME ILLINOIS DEPARTMENT OF TRANSPORTATION F.A.I. 90/94 (DAN RYAN EXPRESSWAY) GARFIELD BLVD TO 31ST STREET (SB LOCAL LANES)


SUGGESTED STAGES OF CONSTRUCTION AND TRAFFIC CONTROL STAGE 1


SCALE: 1"=50"


DRAWN BY: PHP

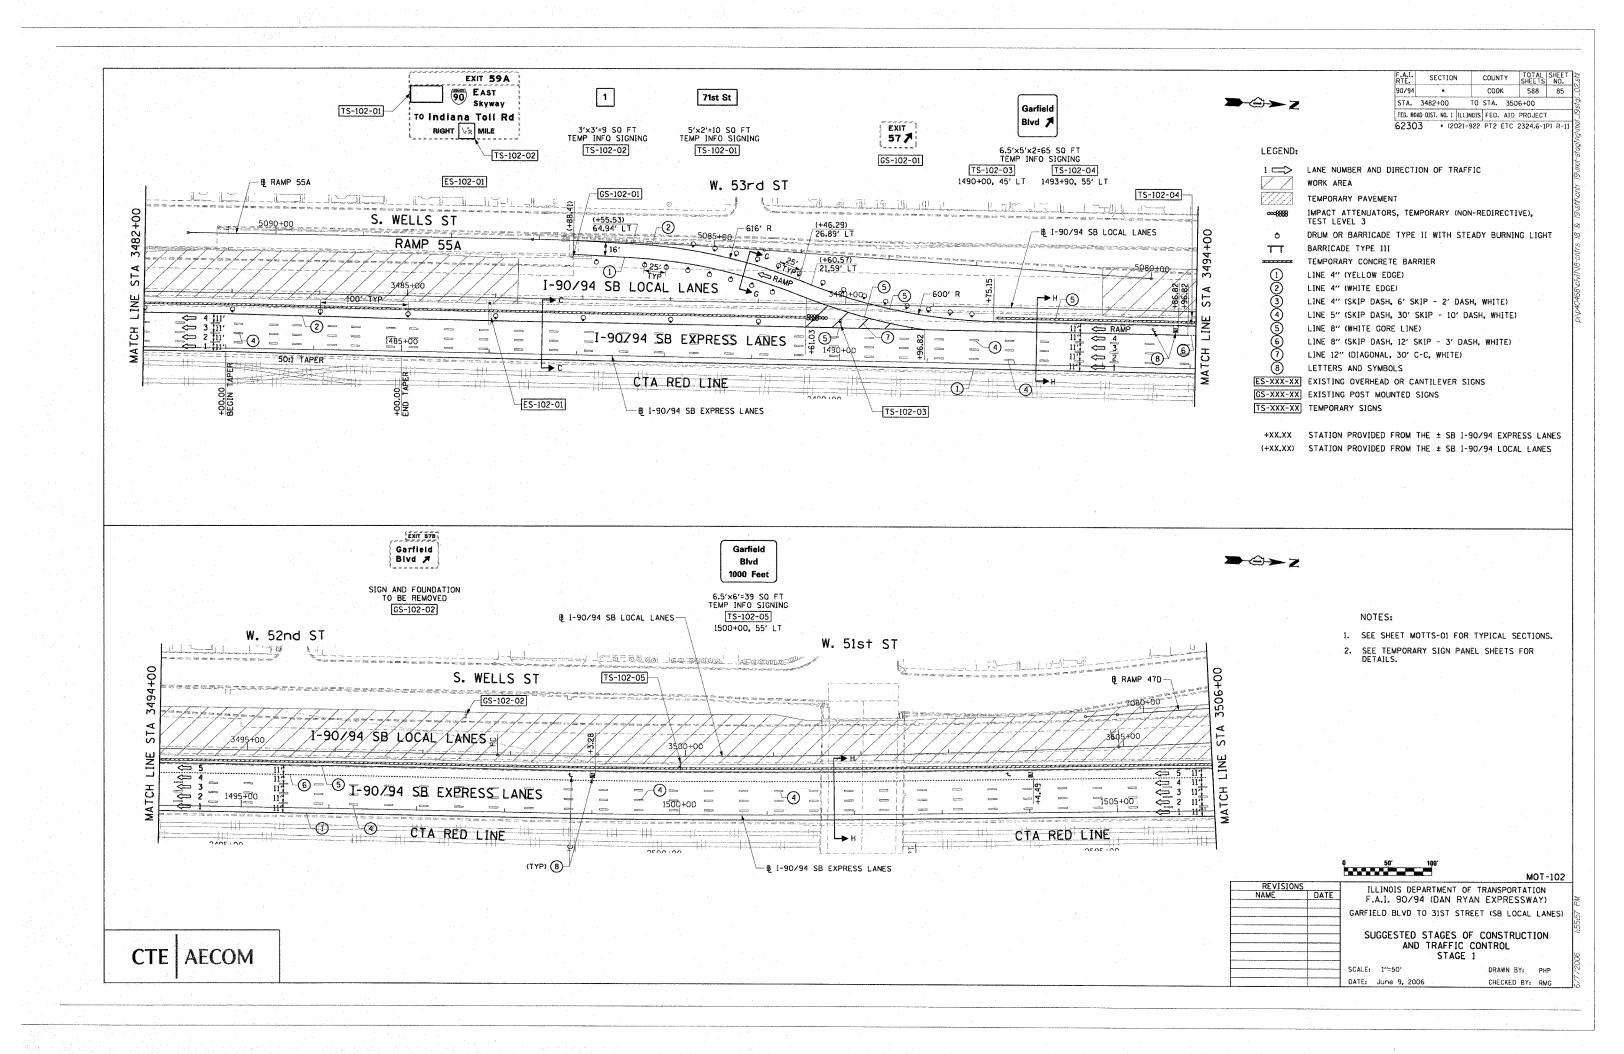


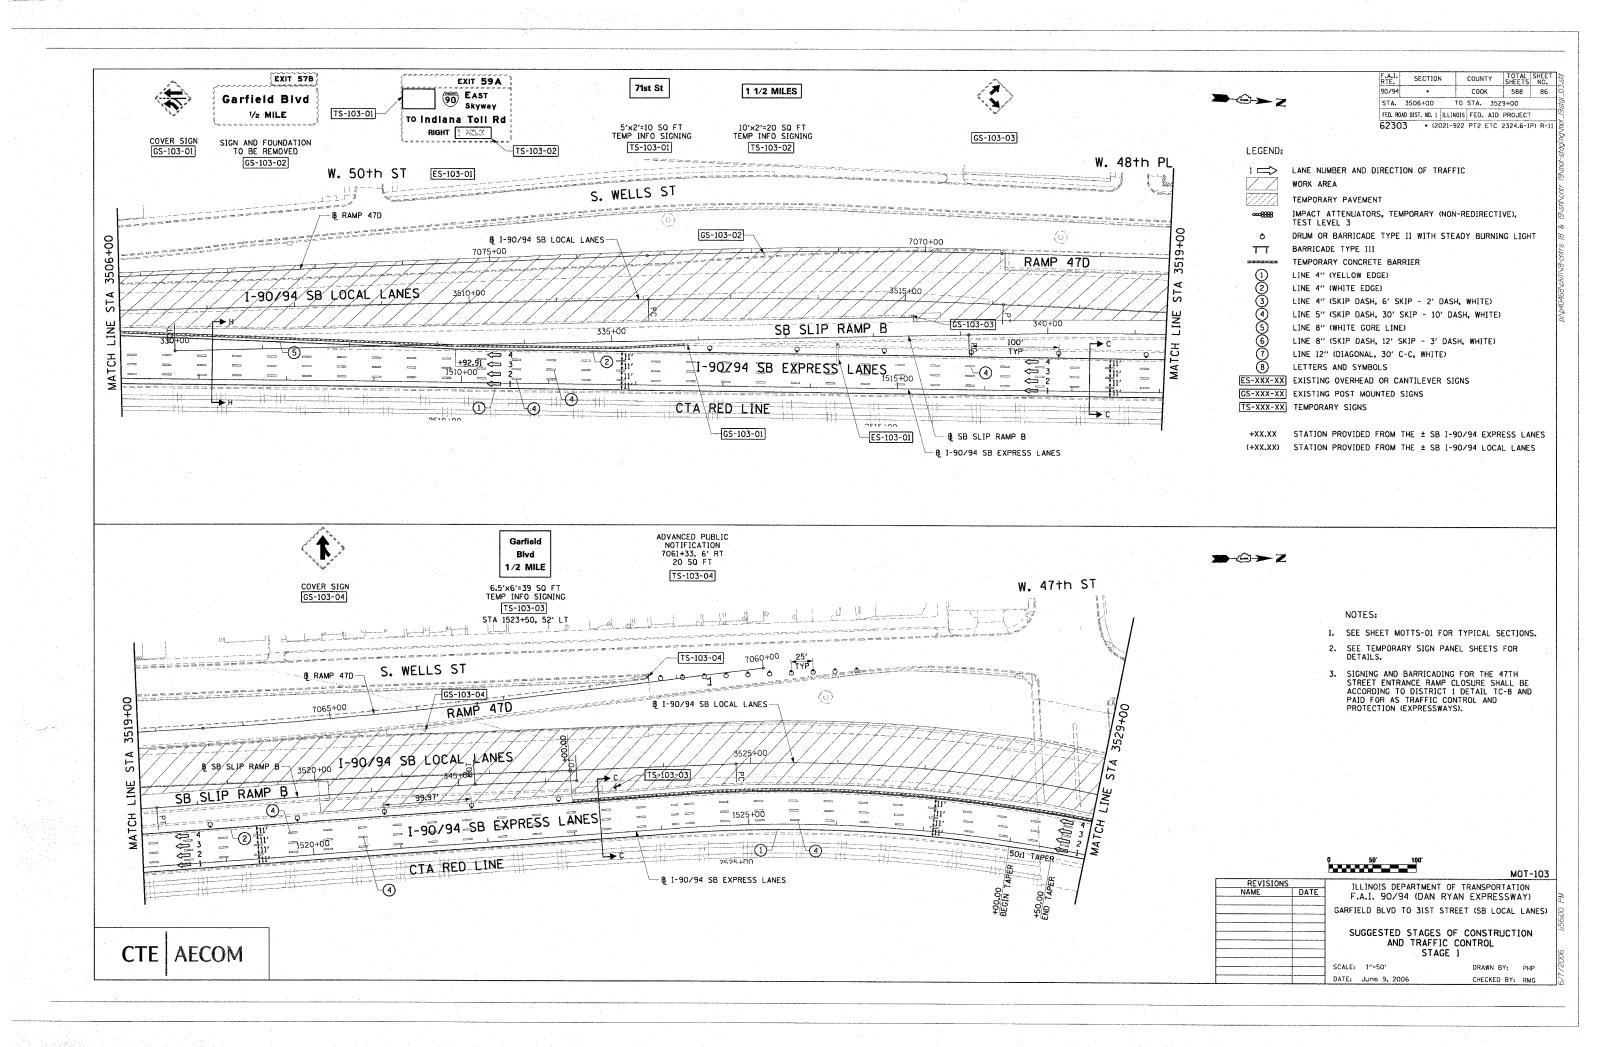


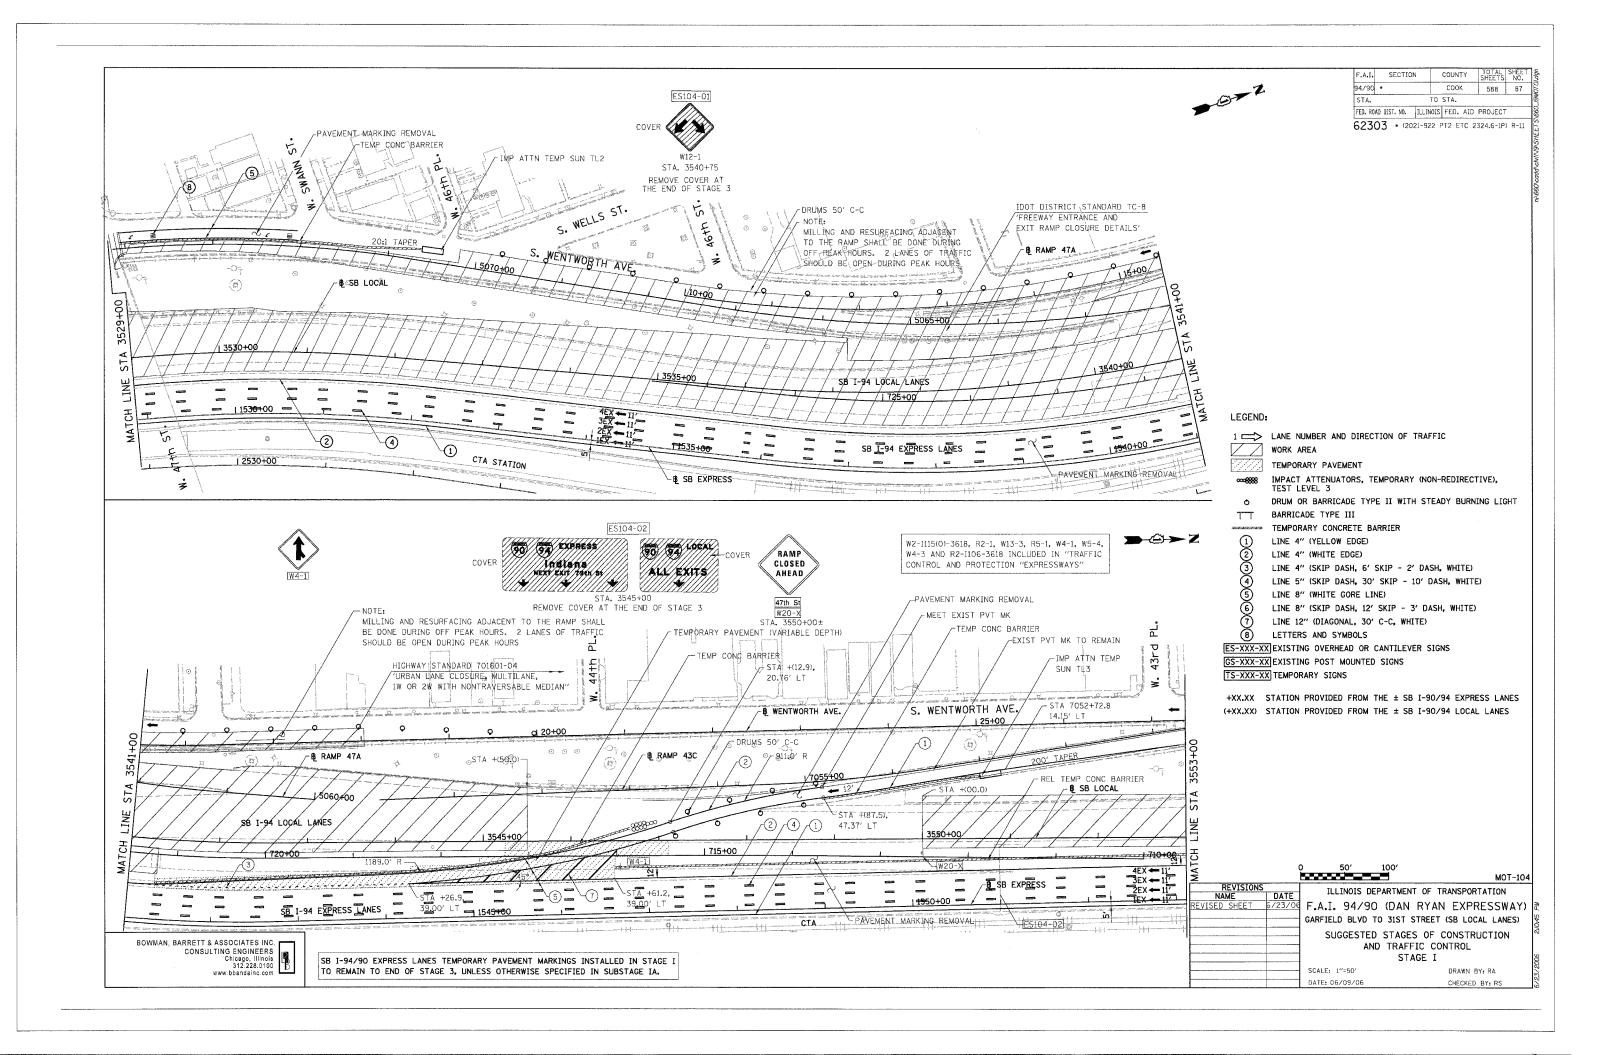


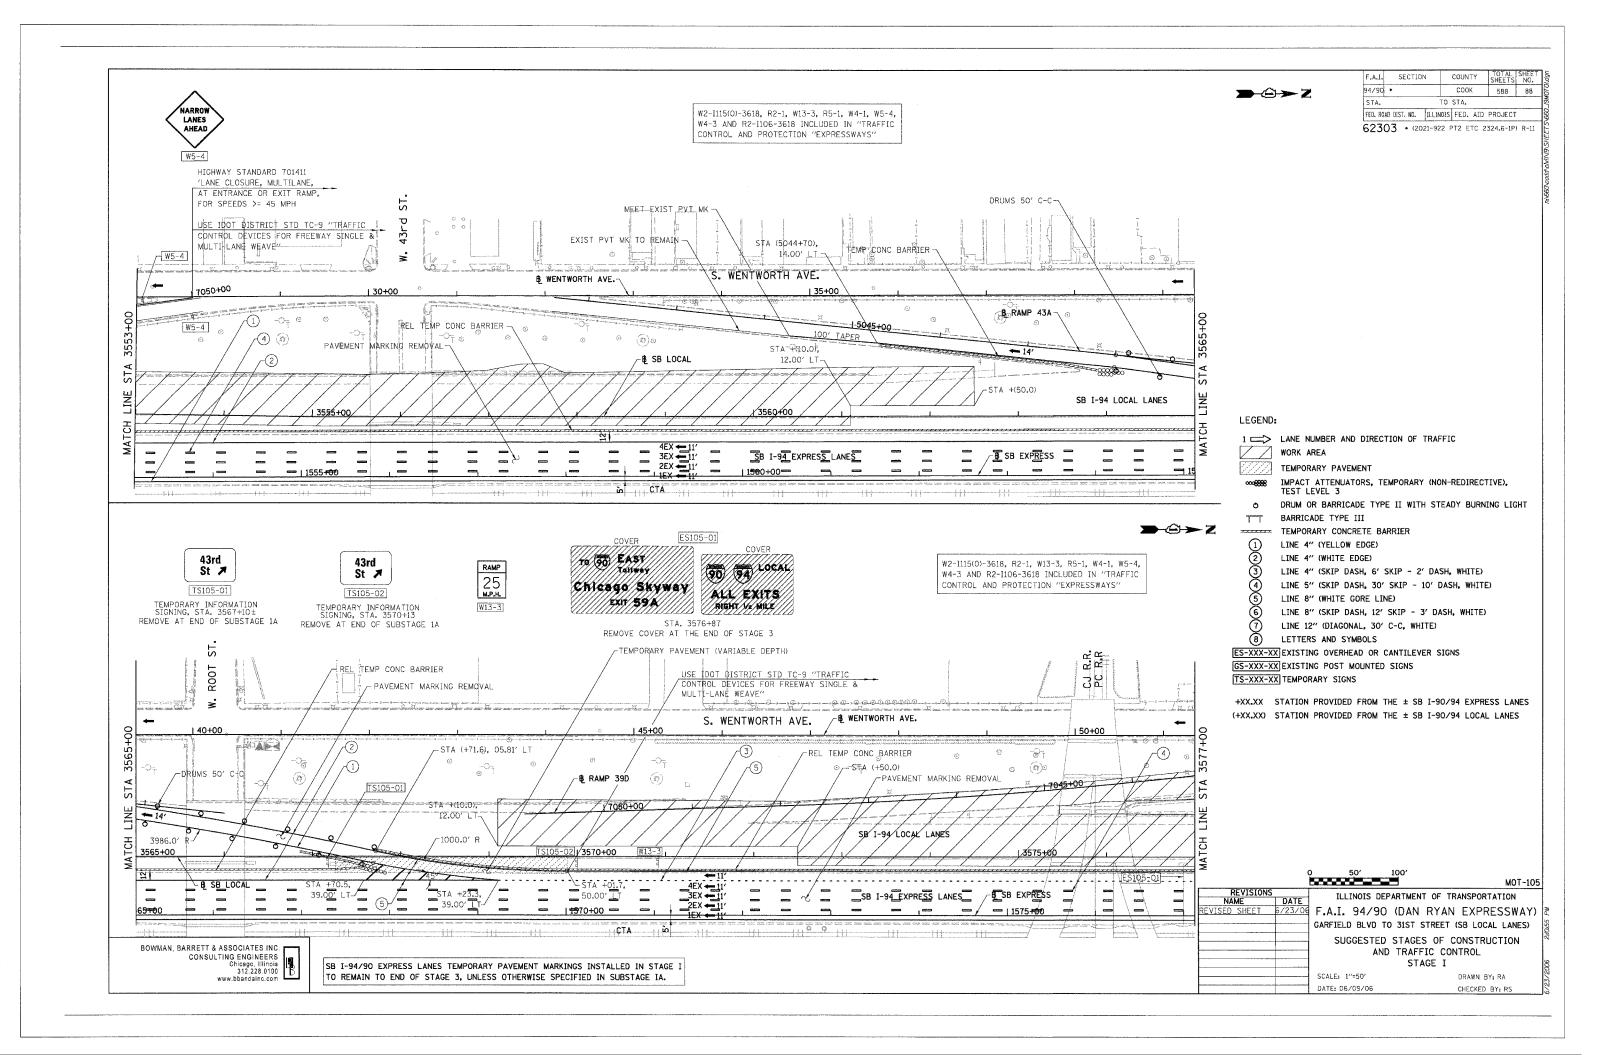


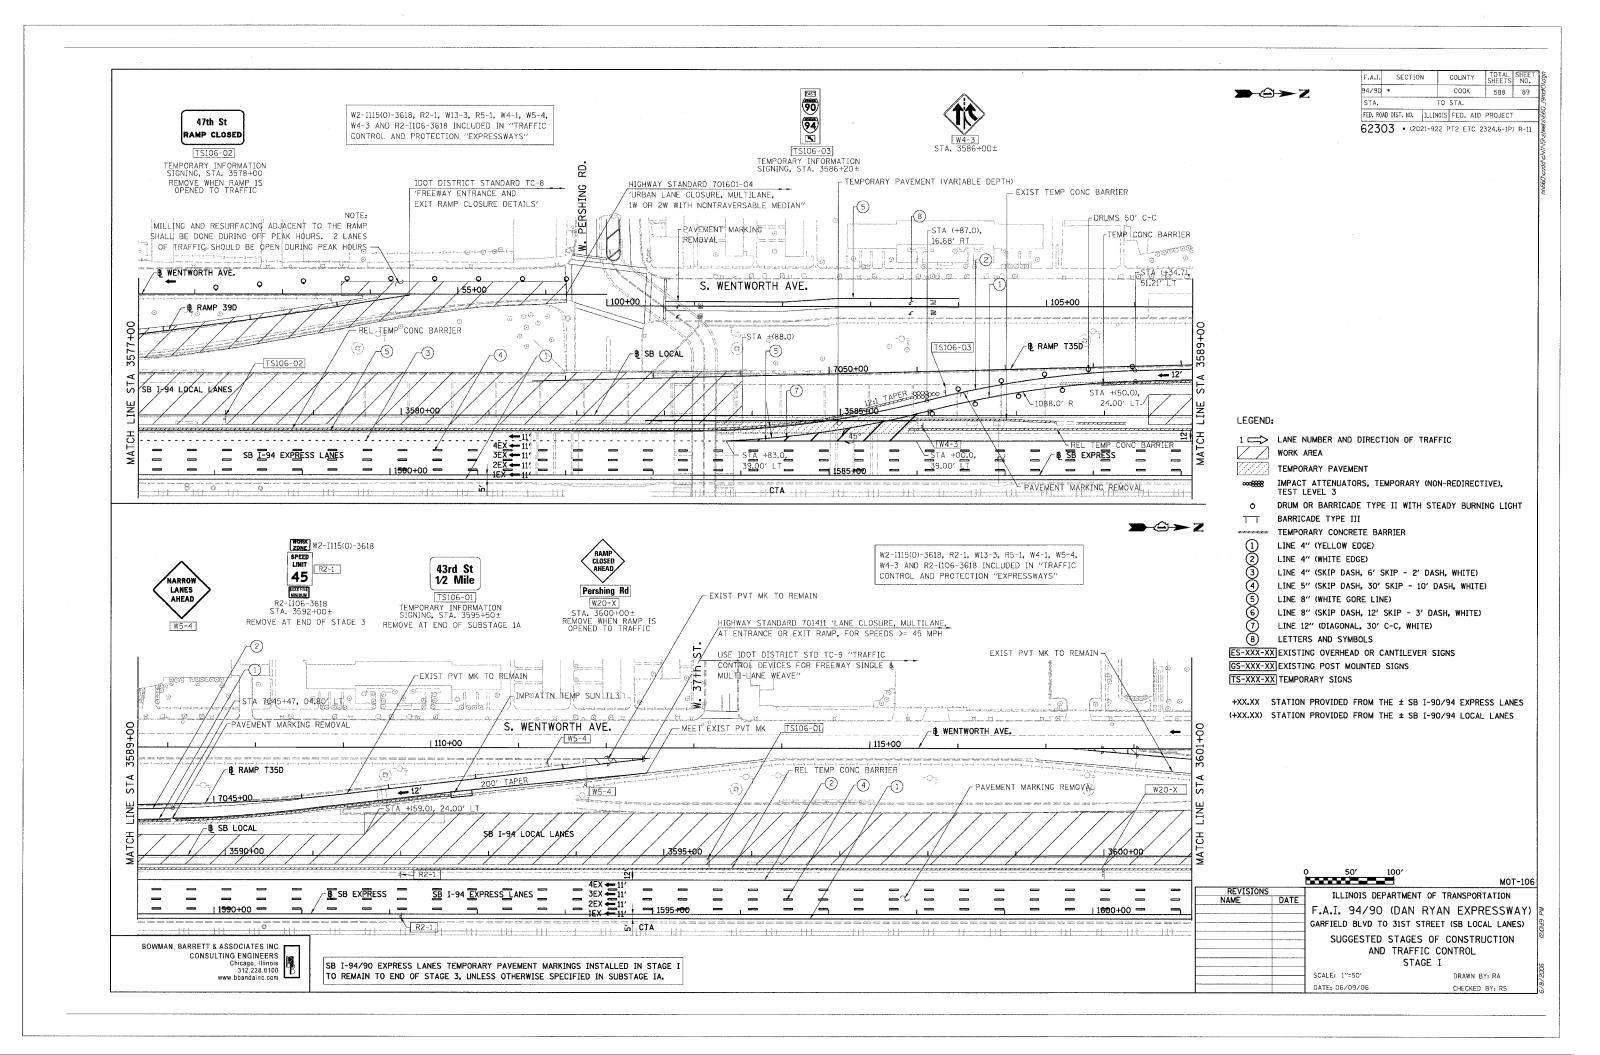


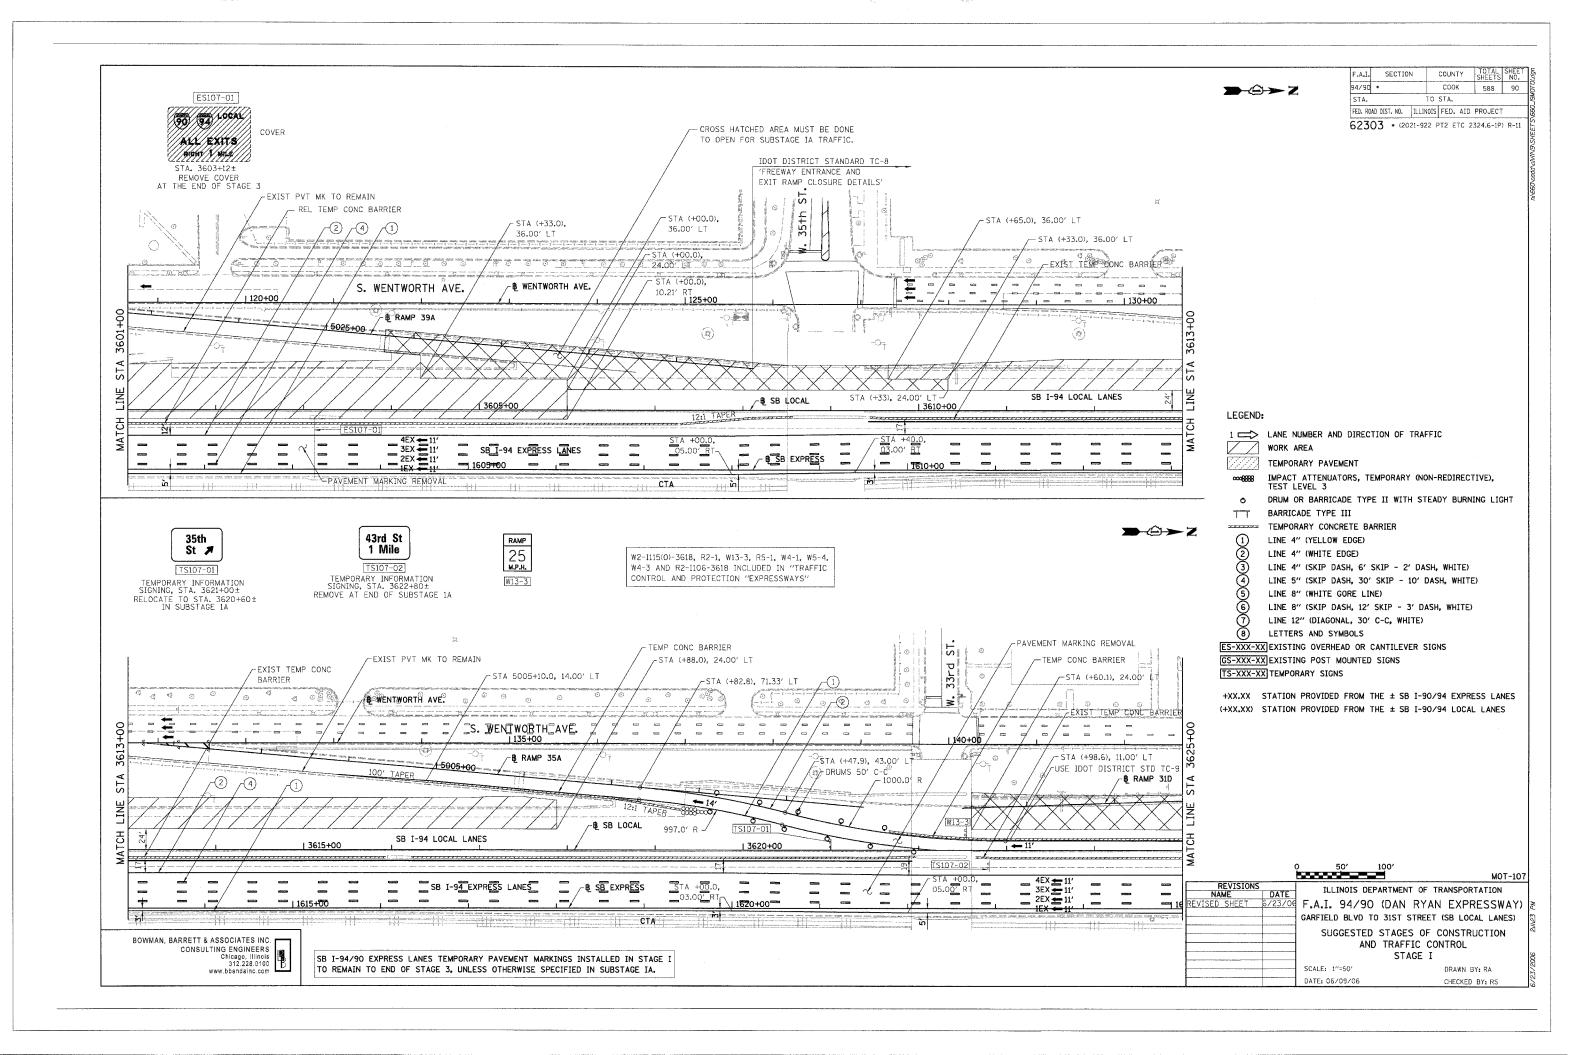


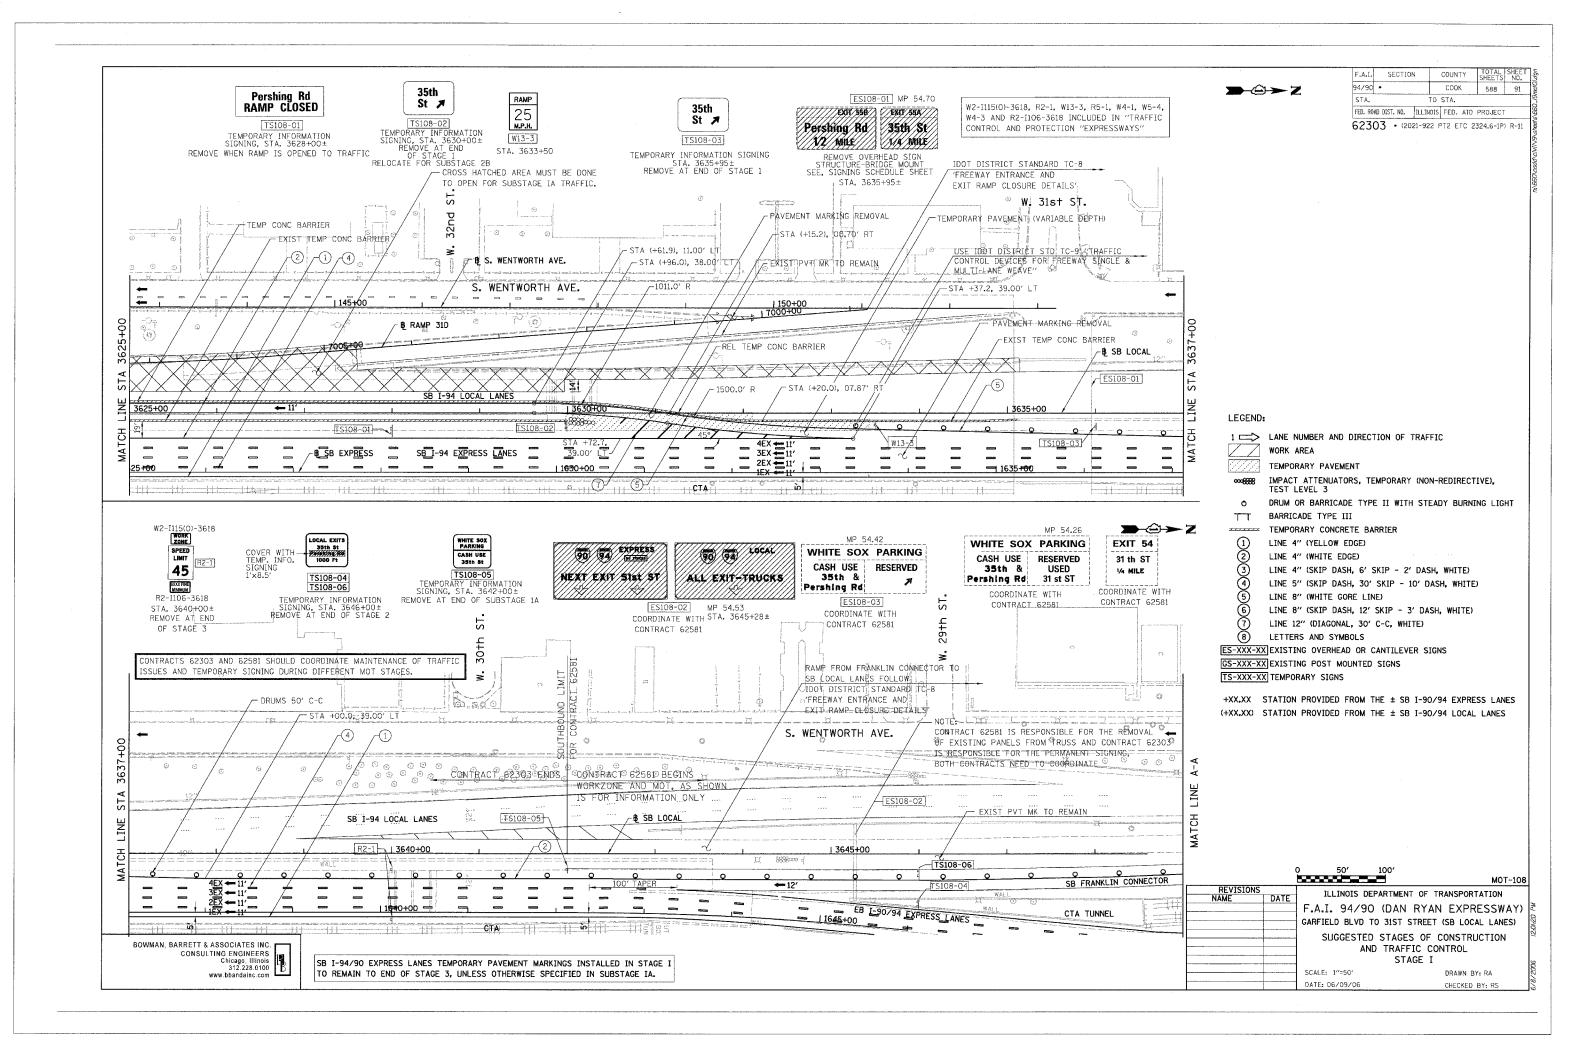

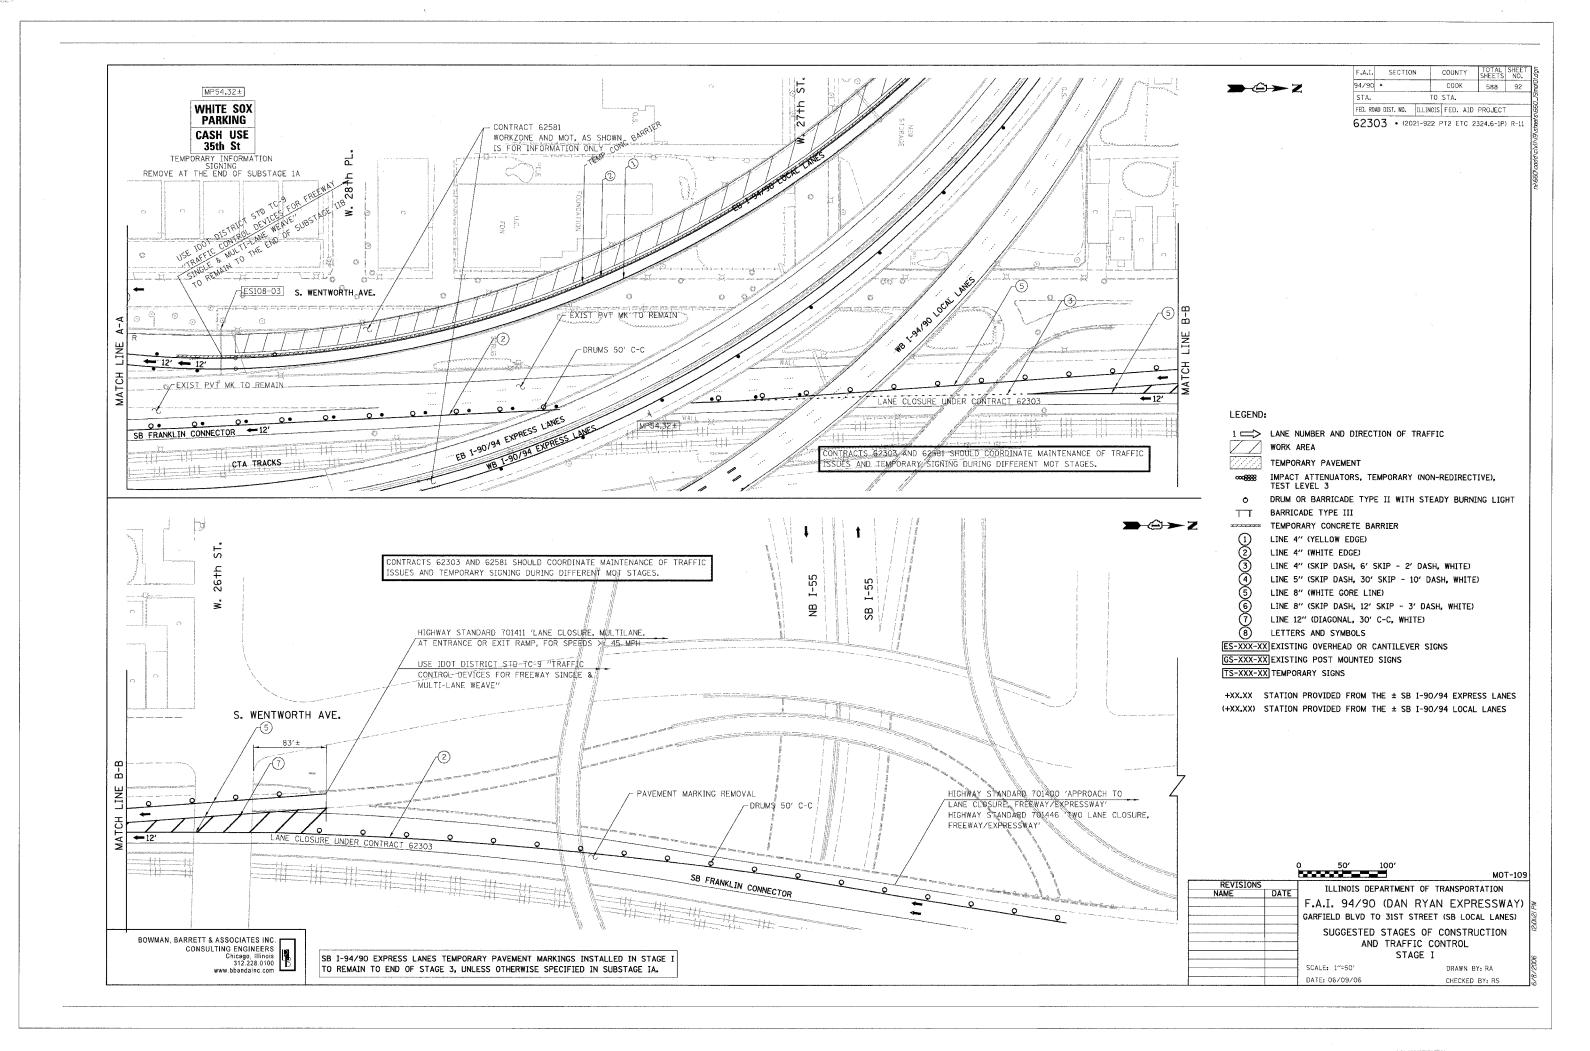

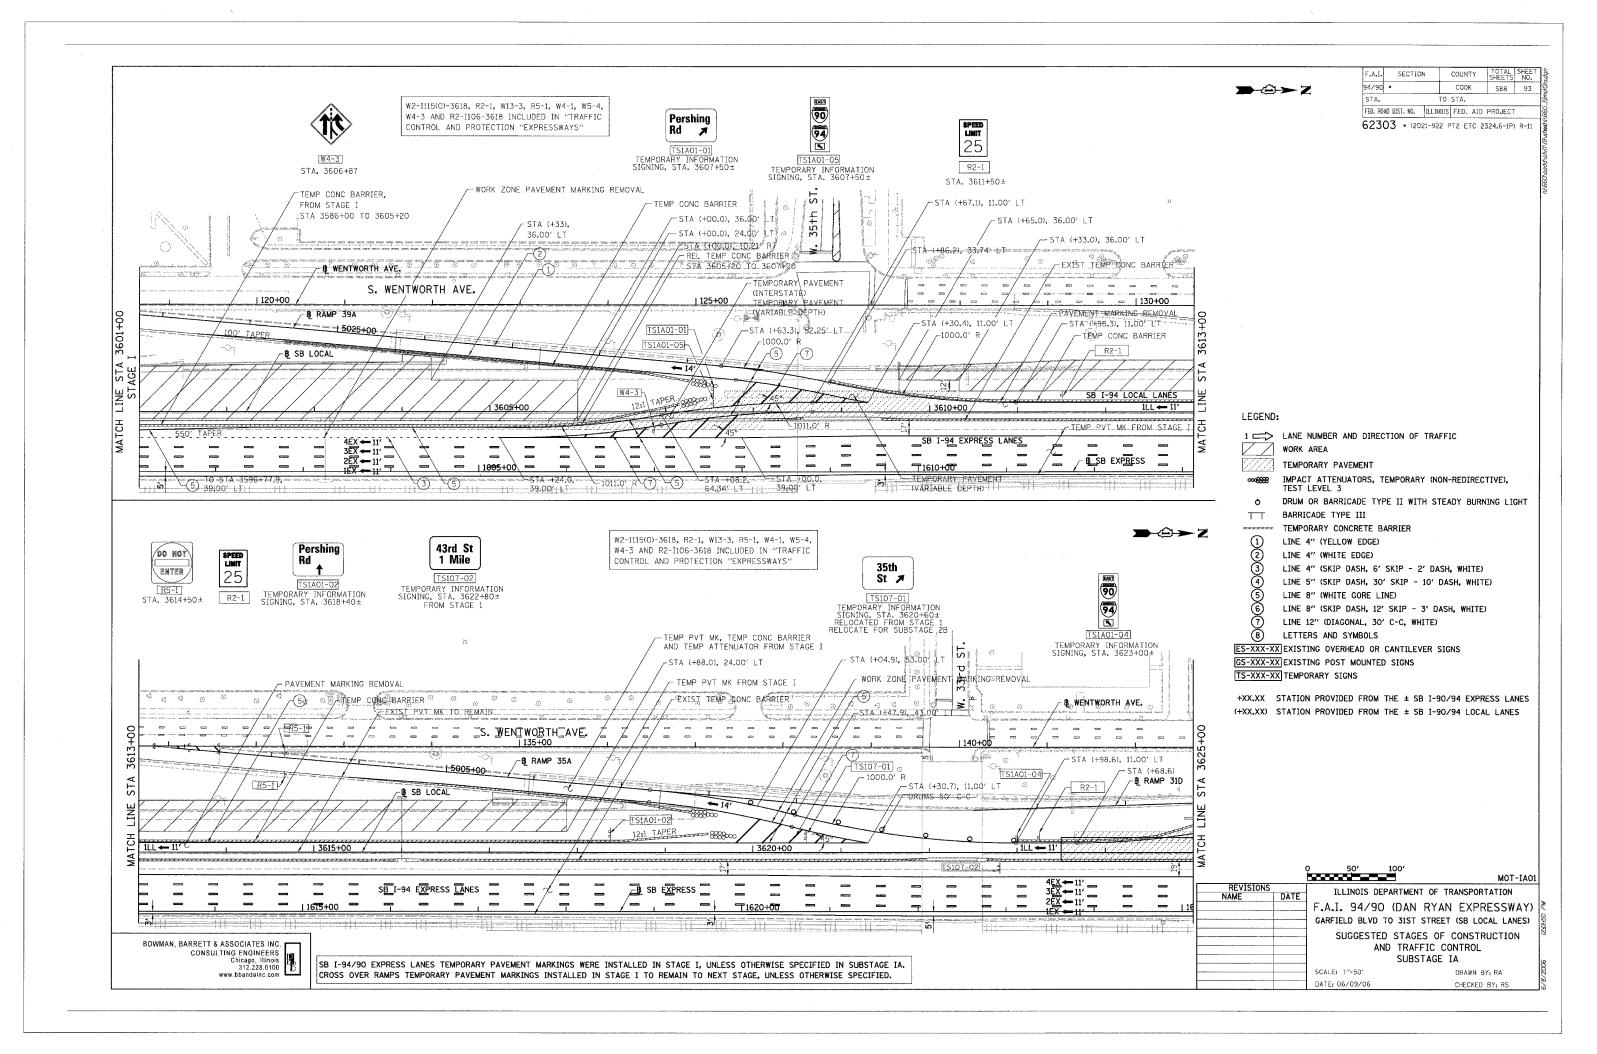

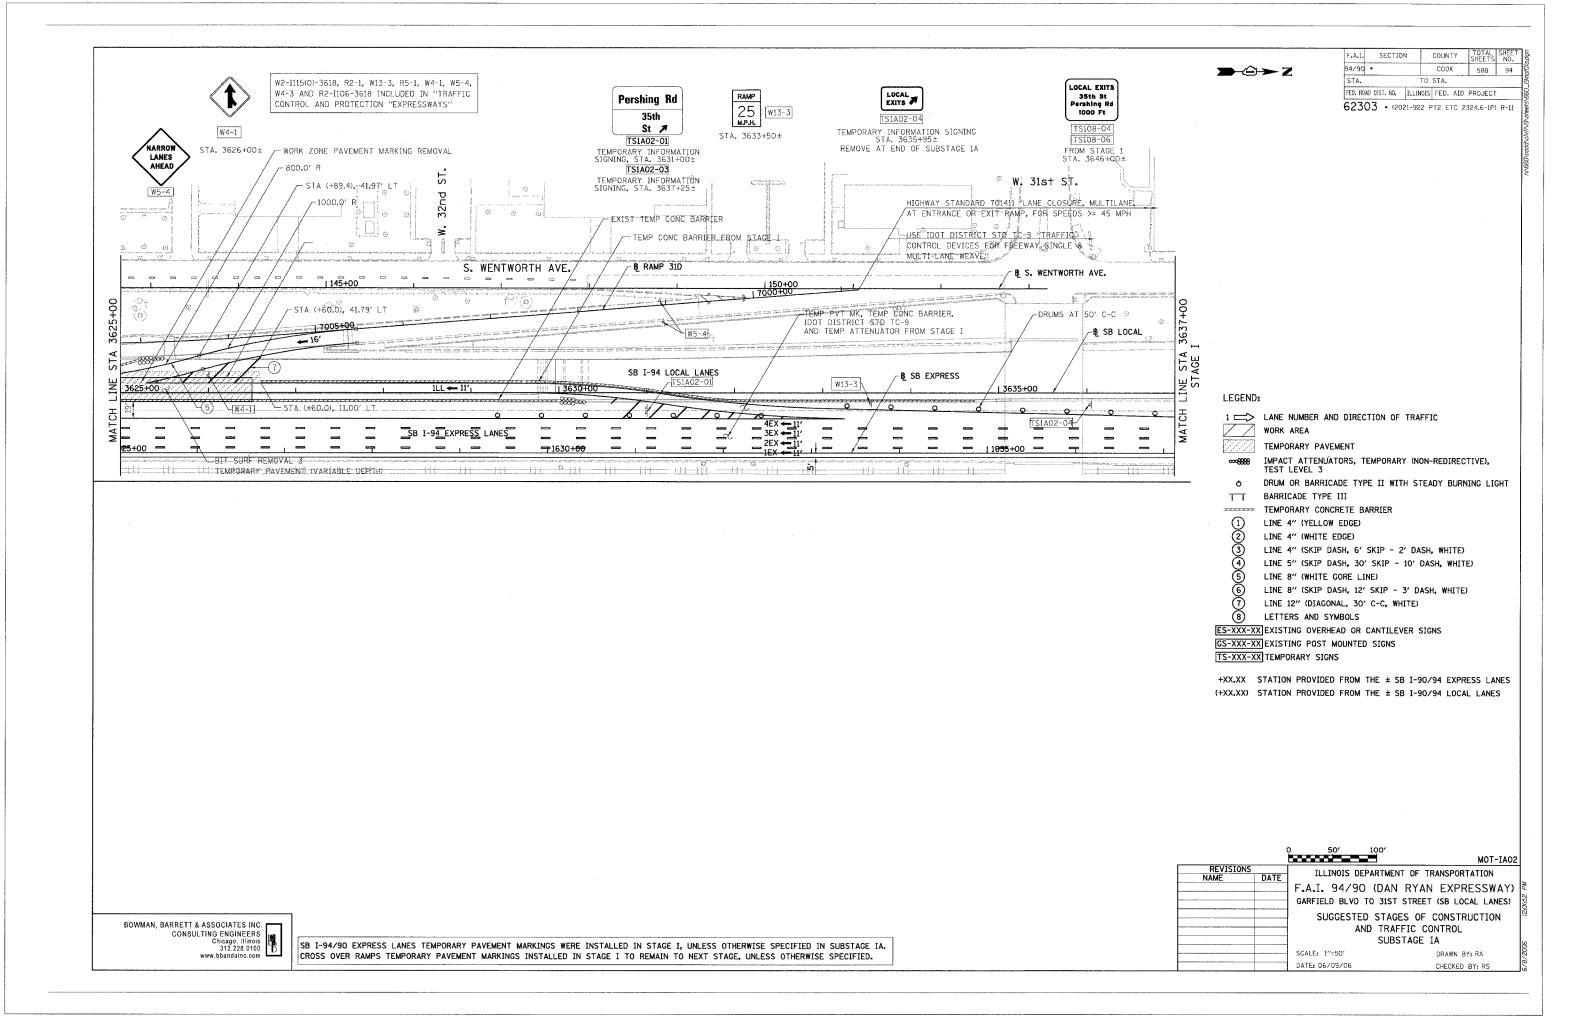

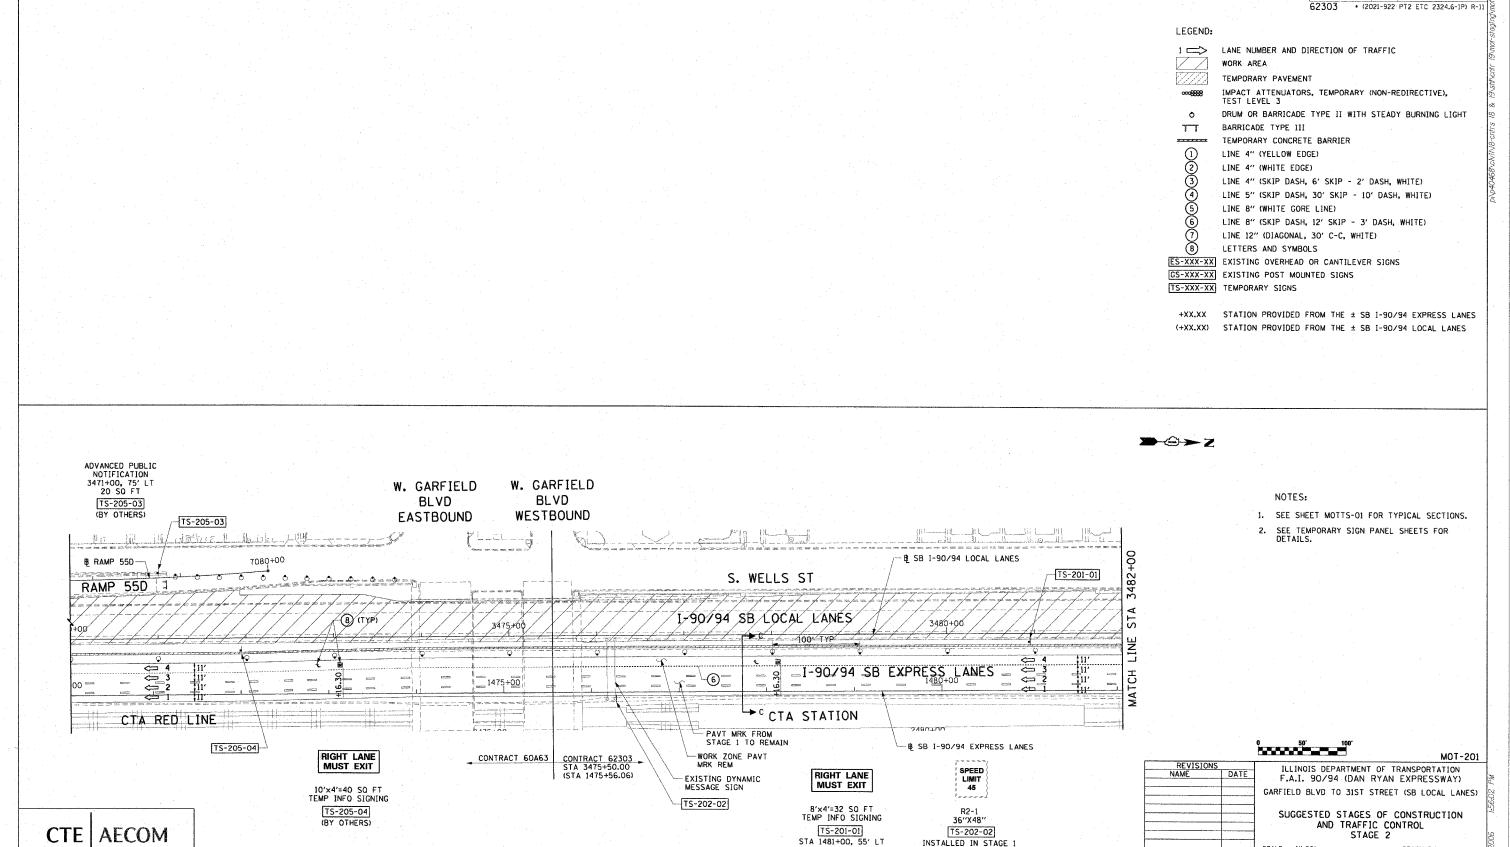

TS-202-02 INSTALLED IN STAGE 1

CTE | AECOM

COUNTY TOTAL SHE

COOK 588

TO STA. 3482+00

FED. ROAD DIST. NO. 1 ILLINOIS FED. AID PROJECT

RTE. SECTION

STA. 3475+50

90/94

SUGGESTED STAGES OF CONSTRUCTION AND TRAFFIC CONTROL STAGE 2

SCALE: 1"=50"

DRAWN BY: PHP CHECKED BY: RMG

