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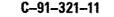
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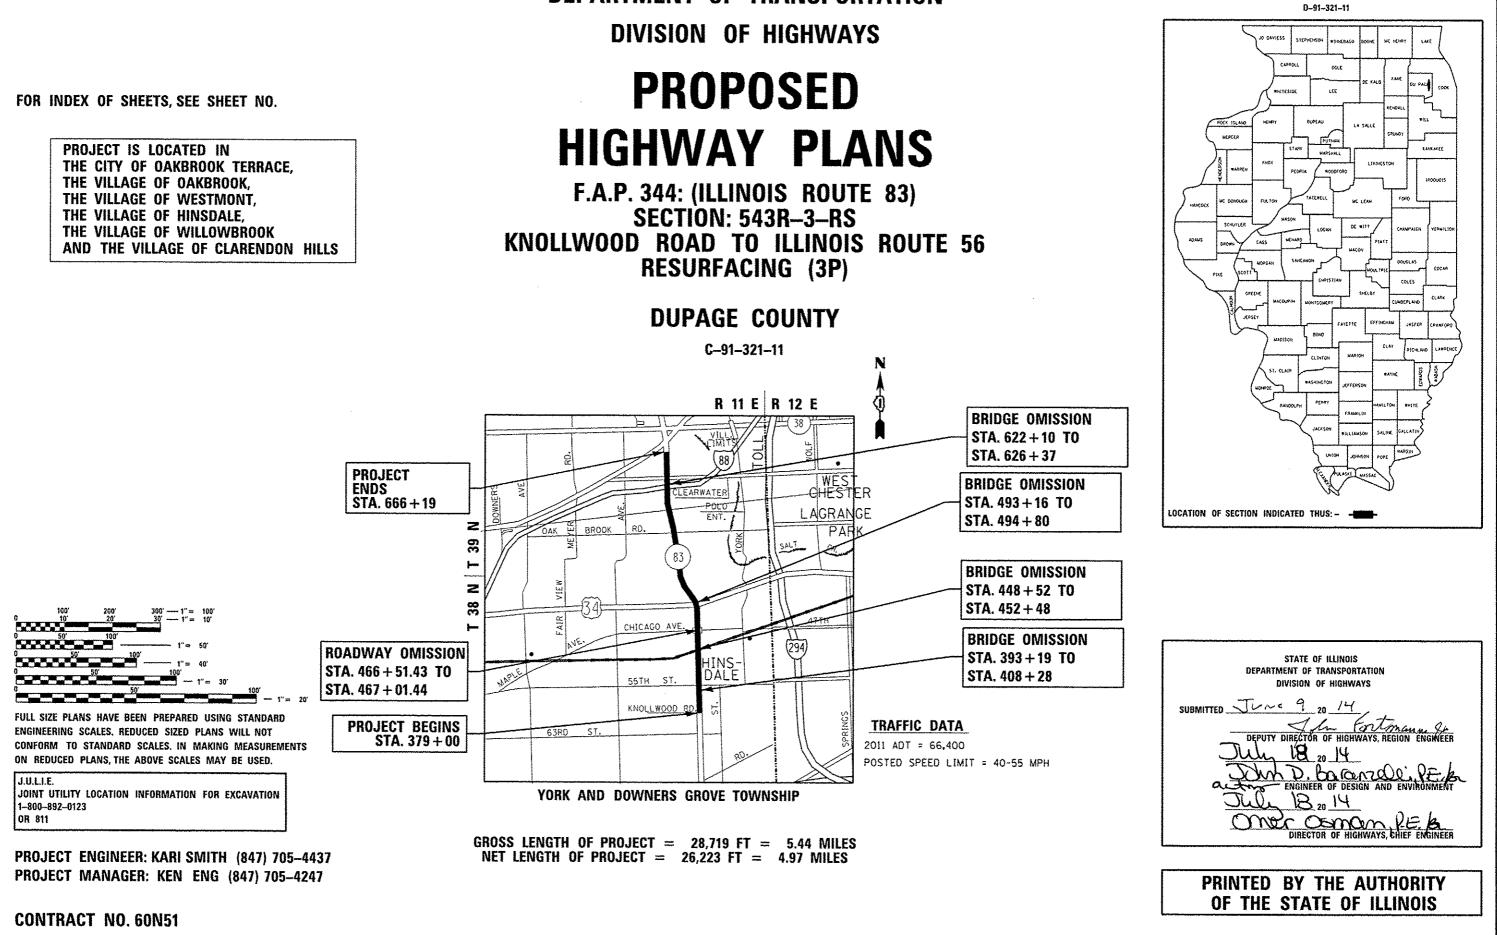
THE CITY OF OAKBROOK TERRACE. THE VILLAGE OF OAKBROOK. THE VILLAGE OF WESTMONT, THE VILLAGE OF HINSDALE, THE VILLAGE OF WILLOWBROOK


STATE OF ILLINOIS

DEPARTMENT OF TRANSPORTATION

SECTION: 543R-3-RS **RESURFACING (3P)**





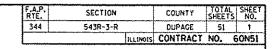

LIST OF ILLINOIS DOT HIGHWAY STANDARDS

- 000001-06 STANDARD SYMBOLS, ABBREVIATIONS, AND PATTERNS
 - 001001-02 AREAS OF REINFORCEMENT BARS
 - 442201-03 CLASS C AND D PATCHES
 - HMA SHOULDER STRIPS/SHLDS. WITH RESURFACING OR WIDENING 482011-03 AND RESURFACING PROJECTS
 - 606001-05 CONCRETE CURB TYPE B AND COMBINATION CONCRETE CURB AND GUTTER
 - 635011-02 REFLECTOR MARKER AND MOUNTING DETAILS
 - CONCRETE BARRIER, DOUBLE FACE, 32 IN. (815 MM) HEIGHT 637001-05
 - 701400-07 APPROACH TO LANE CLOSURE, FREEWAY/EXPRESSWAY
 - 701406-08 LANE CLOSHRE, EREEWAY/EXPRESSWAY, DAY OPERATIONS ONLY
 - 701411-08 LANE CLOSURE. MULTILANE, AT ENTRANCE OR EXIT RAMP, FOR SPEED >= 45 MPH
 - TRAFFIC CONTROL SETUP AND REMOVAL FREEWAY/EXPRESSWAY 701428
 - 701446-05 TWO LANE CLOSURE FREEWAY/EXPRESSWAY
 - URBAN LANE CLOSURE, MULTILANE, 1W OR 2W WITH NONTRAVERSABLE MEDIAN 701601-09
 - 701701-09 URBAN LANE CLOSURE, MULTILANE INTERSECTION
 - 701901-03 TRAFFIC CONTROL DEVICES

MAINTENANCE OF TRAFFIC GENERAL NOTES

- STANDARDS TOIGOL AND TO1701 SHALL ONLY BE APPLIED TO TRAFFIC CONTROL BETWEEN IL 56 (BUTTERFIELD RD) AND INTERSTATE 88.
- 2 STANDARDS 701400, 701428, 701406 AND 701446 SHALL ONLY BE APPLIED TO TRAFFIC CONTROL BETWEEN INTERSTATE 88 AND KNOLLWOOD RD.

COMMITMENTS

THE CONTRACTOR SHALL CONTACT TIM HALIK, VILLAGE ADMINISTRATOR OF THE VILLAGE OF WILLOWBROOK AT (630) 920-2261 TWO WEEKS BEFORE THE START OF CONSTRUCTION.

- NOTIFICATION IS REDUIRED.
- 3 WITHOUT WRITTEN PERMISSION FROM THE DEPARTMENT.
- KIND.
- ADDITIONAL COST TO THE DEPARTMENT.
- BE AS DIRECTED BY THE ENGINEER.
- NOTED ON THE PLANS.
- BY THE ENGINEER.
- 11
- DURING THE CONSTRUCTION OF THIS PROJECT.
- 14 DO NOT SCALE PLANS FOR CONSTRUCTION DIMENSIONS.
- THE MILLING MACHINE SHALL NOT EXCEED 1 1/2 INCHES 45 MPH. WITH WRITTEN APPROVAL FROM THE ENGINEER, SLOPED A MINIMUM 1:3 (V:H).

- AND 5:00 AM FOR EVERY DAY OF THE WEEK.
- GARMENTS.

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- INDEX OF SHEETS
- 1 COVER SHEET
- 2-3 INDEX OF SHEETS, LIST OF IDOT HIGHWAY STANDARDS, GENERAL NOTES, AND COMMITMENTS
- 4-6 SUMMARY OF QUANTITIES
- 7-13 TYPICAL SECTIONS
- 14-23 ROADWAY AND PAVEMENT MARKING PLAN
- 24 TYPICAL REPAIR FOR FULL DEPTH (BARRIER WALL)
- FULL DEPTH BARRIER WALL REPAIR DETAIL STA. 383+50 25
- 26-29 DETECTOR LOOP REPLACEMENT
- 30-31 ATR SITE #1340 DETAILS
- 32 FRAMES AND LIDS ADJUSTMENT WITH MILLING (BD08)
- 33 PAVEMENT PATCHING FOR HMA SURFACED PAVEMENT (8022)
- 34 CURB OR CURB AND GUTTER REMOVAL AND REPLACE (8024)
- CONCRETE BARRIER TRANSITION & GENERAL DETAILS, CONCRETE 35 BARRIER BASE (BD27)
- 36 BUTT JOINTS AND HMA TAPER (BD32)
- 37 MISC. ELECTRICAL DETAILS, SHEET B (BE703)
- 38 HMA TAPER AT EDGE OF P.C.C. PAVEMENT
- 39 FREEWAY ENTRANCE AND EXIT RAMP CLOSURE DETAILS (TCO8)
- 40 TRAFFIC CONTROL AND PROTECTION FOR SIDE ROADS. INTERSECTIONS AND DRIVEWAYS (TCIO)
- 41 RAISED REFLECTIVE PAVEMENT MARKERS, SNOW PLOW RESISTANT (TCII)
- 42-43 MULTI-LANE FREEWAY PAVEMENT MARKING DETAILS (TC12)
- 44 DISTRICT ONE TYPICAL PAVEMENT MARKINGS (TC13)
- 45 TRAFFIC CONTROL AND PROTECTION AT TURN BAYS (TO REMAIN OPEN TO TRAFFIC) (TC14)
- 46 PAVEMENT MARKING LETTERS AND SYMBOLS FOR TRAFFIC STAGING (TC-16)
- 47 TRAFFIC CONTROL DETAILS FOR FREEWAY SHOULDER CLOSURES AND PARTIAL RAMP CLOSURES (TC-17)
- 48 ARTERIAL ROAD INFORMATION SIGN (TC22)
- 49 DISTRICT ONE STANDARD TRAFFIC SIGNAL DESIGN DETAILS (TS05)
- 50 DETECTOR LOOP INSTALLATION DETAILS FOR ROADWAY RESURFACE (TSO7)
- 51 PRUNING FOR SAFETY AND EQUIPMENT CLEARNACE (BM20)

GENERAL NOTES

1 BEFORE STARTING ANY EXCAVATION, THE CONTRACTOR SHALL CALL "J.U.L.I.E." AT 800-892-0123 FOR FIELD LOCATIONS OF BURIED ELECTRIC, TELEPHONE. AND GAS FACILITIES. 48 HOUR

2 THE CONTRACTOR SHALL COORDINATE CONSTRUCTION ACTIVITIES WITH THE UTILITY COMPANIES, CITY OF OAKBROOK TERRACE, VILLAGE OF OAKBROOK, VILLAGE OF WESTMONT, VILLAGE OF HINSDALE, VILLAGE OF WILLOWBROOK AND VILLAGE OF CLARENDON HILLS.

THE CONTRACTOR WILL NOT BE ALLOWED TO SET UP A YARD OR FIELD OFFICE ON STATE PROPERTY.

4 ANY PAVEMENT MARKINGS AND RAISED REFLECTIVE PAVEMENT MARKERS OBLITERATED BY MILLING AND RESURFACING OPERATIONS ON SIDE STREETS AND ENTRANCES SHALL BE REPLACED AND PAID FOR IN

5 ALL DAMAGE TO EXISTING PAVEMENT MARKING OR RAISED REFLECTIVE PAVEMENT MARKERS OUTSIDE THE REMOVAL LINE SHOWN ON THE PLANS SHALL BE REPLACED AT THE CONTRACTORS EXPENSE. NO

6 BEFORE BEGINNING ANY WORK, THE CONTRACTOR SHALL RETAIN AND RECORD FOR FUTURE REFERENCES. ALL EXISTING PAVEMENT MARKING LINES AND RAISED REFLECTIVE PAVEMENT MARKERS IN ORDER THAT THESE LOCATIONS CAN BE RE-ESTABLISHED FOR STRIPING. EXACT LOCATIONS OF ALL STRIPING SHALL

7 ALL PAVEMENT PATCHING LOCATIONS WILL BE DETERMINED IN THE FIELD BY THE ENGINEER.

LOCATIONS OF COMBINATION CONCRETE CURB AND GUTTER REMOVAL AND REPLACEMENT AS WELL AS MEDIAN REMOVAL AND REPLACEMENT, WILL BE DETERMINED IN THE FIELD BY THE ENGINEER UNLESS

9 DRAINAGE ADJUSTMENT, RECONSTRUCTION OR CLEANING LOCATIONS WILL BE DETERMINED IN THE FIELD

10 THE CONTRACTOR SHALL BE RESPONSIBLE FOR VERIFYING ALL DIMENSIONS AND CONDITIONS EXISTING IN THE FIELD PRIOR TO CONSTRUCTION AND ORDERING MATERIALS.

THE CONTRACTOR SHALL CONTACT THE DISTRICT ONE TRAFFIC CONTROL SUPERVISOR AT (847) 705-4470 A MINIMUM OF 72 HOURS IN ADVANCE OF BEGINNING WORK.

12 THE ENGINEER SHALL CONTACT DON CHIARUGI, THE TRAFFIC FIELD TECHNICIAN AT (847)741-9857 A MINIMUM OF TWO (2) WEEKS PRIOR TO THE PLACEMENT OF PERMANENT PAVEMENT MARKINGS.

13 THE CONTRACTOR SHALL BE REQUIRED TO PROVIDE ACCESS TO ABUTTING PROPERTY AT ALL TIMES

15 WHEN MILLED PAVEMENT IS OPEN TO TRAFFIC THE MAXIMUM GRADE DIFFERENTIAL BETWEEN PASSES OF WHERE THE SPEED LIMIT IS 45 MPH OR LESS AND 1 INCH WHERE THE SPEED LIMIT IS GREATER THAN A MAXIMUM GRADE DIFFERENTIAL OF 3 INCHES MAY BE ALLOWED IF THE EDGE OF THE MILLING IS

16 BUTT JOINTS WILL BE INSTALLED AT THE ENDS OF ALL RESURFACING (WHERE RESURFACING MEETS EXISTING PAVEMENT). IN ACCORDANCE WITH THE "BUTT JOINT AND HOT-MIX ASPHALT TAPER DETAILS" SHEET INCLUDED IN THE PLANS UNLESS OTHERWISE SPECIFIED.

IT PAVEMENT MARKING TAPE, TYPE III SHALL BE USED FOR SHORT TERM PAVEMENT MARKINGS ON ALL FINAL SURFACES. THE COST OF THE PAVEMENT MARKING TAPE. TYPE III AND IT'S REMOVAL SHALL BE INCLUDED IN THE COST OF SHORT TERM PAVEMENT MARKING.

18 THE CONTRACTOR WILL ONLY BE ALLOWED TO PERFORM WORK ON IL 83 BETWEEN THE HOURS OF 8:00 PM

19 WHEN WORK IS BEING PERFORMED IN LANE 2 OF A 3 LANE SECTION OF ROAD. THE CONTRACTOR MUST CLOSE LANES FROM THE LEFT WHEN ADJACENT TO ANY RAMPS.

20 NIGHTTIME FLACGERS OR WORKERS SHALL BE EQUIPPED WITH A FLUORESCENT ORANGE OR FLUORESCENT YELLOW/GREEN VEST MEETING THE REQUIREMENTS OF ANSI/ISEA 107-2004 FOR CONSPICUITY CLASS 3

21 THE CONTRACTOR'S ATTENTION IS CALLED TO THE FACT THAT THE PRESERVATION OF EXISTING TREES IS OF UTMOST IMPORTANCE TO THE VILLAGE OF CLARENDON HILLS. ALL ROOT PRUNNING SHALL BE COMPLETED BEFORE CONSTRUCTION OPERATIONS COMMENCE IN ANY AREA. AT NO TIME SHALL THE CONTRACTOR PRUNE ANY TREES UNLESS SPECIFICALLY DIRECTED BY THE ENGINEER.

S	F.A. RTE.	SECTION	COUNTY	TOTAL	SHEET NO.
IIGHWAY) (BUTTERFIELD ROAD)	344	543R-3-RS	DUPAGE	51	2
DUITENFIELD NUAD	1		CONTRACT	[NO. 6	SON51
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GENERAL NOTES

- 22 BUTT JOINTS WILL BE INSTALLED AT THE ENDS OF ALL RESURFACING (WHERE RESURFACING MEETS EXISTING PAVEMENT). IN ACCORDANCE WITH THE "BUTT JOINT AND HOT-MIX ASPHALT TAPER DETAILS" SHEET INCLUDED IN THE PLANS UNLESS OTHERWISE SPECIFIED.
- 23 WHEN EDGE OF BARRIER IS WITHIN 3 FT OF THE TRAFFIC LANE EDGE, REDUCE LANE TO 11 FT LANE WITH TYPE III TEMPORARY TAPE AND TAPER IN 45:1. COST OF THE TAPE AND ITS REMOVAL IS INCLUDED IN THE COST OF "TRAFFIC CONTROL AND PROTECTION".
- 24 FOR WORK OUTSIDE THE LIMITS OF BRIDGE APPROACH PAVEMENT, ALL REFERENCES IN THE HIGHWAY STANDARDS AND STANDARD SPECIFICATIONS FOR REINFORCEMENT, DOWEL BARS AND TIE BARS IN PAVEMENT, SHOULDERS, CURB, GUTTER, COMBINATION CURB & GUTTER AND MEDIAN, AND CHAIR SUPPORTS FOR CRC PAVEMENT, SHALL BE EPOXY COATED, UNLESS NOTED ON THE PLANS.
- 25 THE CONTRACTOR SHALL REQUEST AN UNDERGROUND CABLE LOCATE FOR STATE OWNED ELECTRICAL FACILITIES WITH IN THEIR PROJECT LIMITS PRIOR TO START OF WORK.
- 26 THERE IS A CONDUIT(S) AND AN EMBEDDED JUNCTION BOX IN THE BARRIER WALL. CARE MUST BE TAKEN TO PREVENT DAMAGE TO ANY CONDUIT(S) AND JUNCTION BOX. IF IT IS DAMAGED, THE CONDUIT AND/OR JUNCTION BOX SHALL BE REPAIRED OR REPLACED. IF ELECTRICAL OR COPPER COMMUNICATIONS CABLE IS DAMAGED, IT SHALL BE REPLACED FROM JUNCTION BOX TO JUNCTION BOX (1500 FT. MIN.). IF FIBER OPTIC COMMUNICATIONS CABLE IS DAMAGED, IT SHALL BE REPLACED FROM EXISTING SPLICE ENCLOSURE TO EXISTING SPLICE ENCLOSURE OR TERMINATION POINT. FOR THE LOCATION OF THE CONDUITS, CONTACT ROY LAWSON AT THE ELECTRICAL FIELD OFFICE AT (708) 524-2145.
- 27 ANY CONDUIT RUSTED THRU, EXPOSED CABLES, PULL BOXES OR HANDHOLES FOR BRIDGE LIGHTING, TRAFFIC SIGNALS, COUNTERS, SURVEILLANCE EQUIPMENT FOUND IN DISREPAIR THE ENCINEER SHALL TAKE THE APPROPIATE ACTION:

NO SAW CUTTING OR REMOVAL WILL BE MADE OR CONCRETE POURED UNTIL THE APPROPRIATE ACTION IS TAKEN TO RESOLVE EACH ISSUE;

ALL WORK REQUIRED TO REPAIR/REPLACE SIGNAL SURVEILLANCE OR LIGHTING ITEMS WILL BE DOCUMENTED BY THE ENGINEER AND THE BUREAU OF TRAFFIC WILL BE NOTIFIED.

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			URBAN		CONSTRUCTIO	N TYPE CODE			
	SUMMARY OF QUANTITIES			100%			T	SUMMARY OF QUANTITIES	·
CODE NO	ITEM	UNIT	TOTAL QUANTITIES	STATE			CODE NO	ITEM	UNI
21101615	TOPSOIL FURNISH AND PLACE, 4"	50 YD	50	50			44000160	HOT-MIX ASPHALT SURFACE REMOVAL, 2 3/4	" sa
25200110	SODDING, SALT TOLERANT	SQ YO	50	50			4400221		2 50 1
	· · ·							3/4"	
10600400	MIXTURE FOR CRACKS. JOINTS, AND	TON	3519	3519					
	FLANGEWAYS						44003510	D MEDIAN REMOVAL PARTIAL DEPTH	SQ
40600827	POLYMERIZED LEVELING BINDER (MACHINE	TON	12183	12183			4420129	B DOWEL BARS 1 1/4"	EAC
	METHOD). (L-4, 75, N50								
							4420176	5 CLASS D PATCHES, TYPE II, 10 INCH	SO
10600895	CONSTRUCTING TEST STRIP	EACH	3	3					
							44201769	CLASS D PATCHES, TYPE III. 10 INCH	SQ
10600982	HOT-MIX ASPHALT SURFACE REMOVAL - BUTT	SO YD	228	228					
	TUIOL						4420177	I CLASS D PATCHES, TYPE IV. 10 INCH	so
40600985	PORTLAND CEMENT CONCRETE SURFACE	SO YD	6346	6346			44213200	SAW CUTS	FOC
	REMOVAL - BUTT JOINT								
							44213202	2 TIE BARS 1"	EA
40601005	HOT-MIX ASPHALT REPLACEMENT OVER	TON	639	639					
	PATCHES						44300200	STRIP REFLECTIVE CRACK CONTROL	FO
								TREATMENT	
40603153	POLYMERIZED HOT-MIX ASPHALT SURFACE	TON	24809	24809					
	COURSE. STONE MATRIX ASPHALT. NBO						48102100	AGGREGATE WEDGE SHOULDER, TYPE B	TO
40603340	HOT-MIX ASPHALT SURFACE COURSE. MIX	TON	12815	12815			50102400	CONCRETE REMOVAL	CU
	"D", N70							-	·····
	· · · · · · · · · · · · · · · · · · ·						5030022	5 CONCRETE STRUCTURES	CU
42001300	PROTECTIVE COAT	SQ YD	178	178					
							60250200	CATCH BASINS TO BE ADJUSTED	EAC
44000157	HOT-MIX ASPHALT SURFACE REMOVAL, 2"	SO YD	47802	47802					
							60262700 15		EAG
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60300305	FRAMES AND LIDS TO BE ADJUSTED	ЕАСН	55	55						70300100	SHORT TERM PAN	VEMENT MARKING	FOOT
										70300210	TEMPORARY PAV	MENT MARKING LETTERS AND	SO FT
60404950	FRAMES AND GRATES, TYPE 24	EACH	6	6							SYMBOLS		
60406000	FRAMES AND LIDS. TYPE 1, OPEN LID	EACH	2	2									
										70300220	TEMPORARY PAV	EMENT MARKING - LINE 4"	FOOT
60406100	FRAMES AND LIDS, TYPE 1. CLOSED LID	EACH	6	6						70300240		EMENT MARKING - LINE 6"	FOOT
60618300	CONCRETE MEDIAN SURFACE, 4 INCH	SO FT	245	245				-		10300240			
00010300										70300250	TEMPORARY PAV	EMENT MARKING - LINE 8"	FOOT
67000400	ENGINEER'S FIELD OFFICE, TYPE A	CAL MO	6	6									
										70300260	TEMPORARY PAV	EMENT MARKING - LINE 12"	FOOT
67100100	MOBILIZATION	LSUM		1					-	70300280	TEMPORARY PAV	EMENT MARKING - LINE 24"	FOOT
70100420	TRAFFIC CONTROL AND PROTECTION,	EACH	1	1									
	STANDARD 701411								_	70301000	WORK ZONE PAV	EMENT MARKING REMOVAL	SQ FT
									- *	78000100	THERMOPLASTIC	PAVEMENT MARKING -	SQ FT
70100700	TRAFFIC CONTROL AND PROTECTION.	L SUM		-					_		LETTERS AND S		
70100815	TRAFFIC CONTROL AND PROTECTION.	LSUM	1	1					*	78000200	THERMOPLASTIC	PAVEMENT MARKING - LINE 4"	F00T
	STANDARD 701446								- *	-78000400	THERMOPLASTI	PAVEMENT MARKING - LINE 6"	FOOT
70102630	TRAFFIC CONTROL AND PROTECTION,	L SUM	1	1									
	STANDARD 701601								*	78000500	THERMOPLASTIC	PAVEMENT MARKING - LINE 8"	FOOT
													FOOT
70102635		LSUM	۱ 	1					*	78000600	THERMOPLASTI	PAVEMENT MARKING - LINE 12"	F 001
	STANDARD 701701								-	78000650	THERMOPLASTI	PAVEMENT MARKING - LINE 24"	FOOT
70200100	NICHTTIME WORK ZONE LIGHTING	L SUM	1	1									
	· · · · · · · · · · · · · · · · · · ·								*	78100100 15	RAISED REFLE	CTIVE PAVEMENT MARKER	EACH
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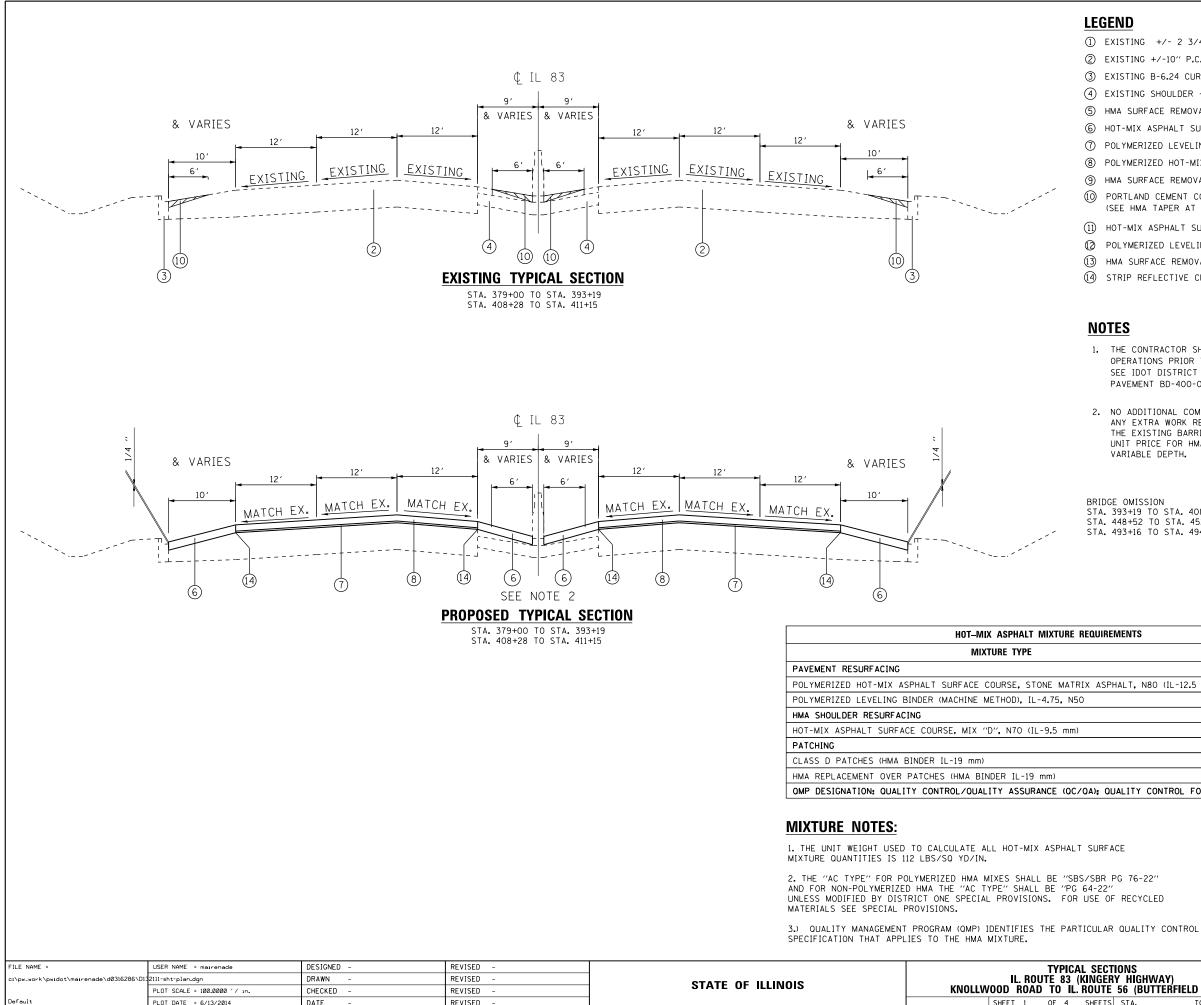
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* 78200530	BARRIER WALL MARKERS, TYPE C	ЕАСН	1340	1340					20004562	COMBINATION C	ONCRETE CURB AND GUTTER	FOOT
				e oraș din în dere dere dere dere		14 vermus 4 verb 4 verb 4 verb		A 1111 - 414 - 41		REMOVAL AND R	EPLACEMENT	
* 78300200	RAISED REFLECTIVE PAVEMENT MARKER REMOVAL	EACH	2950	2950								
									20018500	ORAINAGE STRU	CTURES TO BE CLEANED	EACH
* 88600100	DETECTOR LOOP. TYPE I	FOOT	318	318								
									20030850	TEMPORARY INF	ORMATION SIGNING	SO FT
* 88600600	DETECTOR LOOP REPLACEMENT	FOOT	2726	2726								
							***		20034105	MATERIAL TRAN	SFER DEVICE	TÓN
* 89502300	REMOVE ELECTRIC CABLE FROM CONDUIT	FOOT	90	90								
		-							\$ <u>20076604</u>	TRAINEES - TR	AINING PRIGRAM GRADUATE	HOUR
K1004595	PRUNING FOR SAFETY AND EQUIPMENT	LSUM	1	1					5		GKNDUNTE	
	CLEARANCE	·										
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X0301242	PIEZO AXLE SENSOR, CLASS II	FOOT	44	44								
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X2020110	GRADING AND SHAPING SHOULDERS	UNIT	345	345								
	BITUMINOUS MATERIALS (PRIME COAT)	POUND	149309	149309							:	
40800025							_					
X4400100	PORTLAND CEMENT CONCRETE SURFACE	SO YO	24812	24812								
	REMOVAL (VAR(ABLE DEPTH)	-										
X4401198	HOT-MIX ASPHALT SURFACE REMOVAL,	SQ YD	31918	31918								
	VARIABLE DEPTH											
X4402020	CONCRETE MEDIAN SURFACE REMOVAL	SQ FT	245	245								
x5537800	STORM SEWERS TO BE CLEANED 12"	FOOT	4500	4500								
							-					
XZ043900	PREFORMED JOINT FILLER REMOVAL	FOOT	24500	24500								
104	· ·											
FILE NAME :				REVISE				STATE OF		<u> </u>	SUMMAR IL. ROUTE 83	Y OF QUANT
ci/pw.unarsi/pwilderind	PLOT SCALE * 1000000 / In C	HECKED -		REVISE	> -				RANSPORT/		KNOLLWOOD ROAD TO I	L. ROUTE 56
*SPECIALT)	······································	ATE -		REVISE) -						SCALE: SHEET NO. OF	3H2215 31

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		100-	<u> </u>	ONSTRUCT	ION TYPE	CODE	·
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	450	450					
	336	336					
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ļ	ITIES		F.A.I RTE	SE!	I CTION	COUNTY	TOTAL SHEET SHEETS NO.
1	IGHWAY) (BUTTERFIELI	ROAD	344	543	1-3-85		51 6 NO. 60N51
		TO STA.	FED.	ROAD DIST. NO. 1	ILLINOIS FED.	AID PROJECT	NUL BUILD
-							



SHEET 1 OF 4 SHEET

① EXISTING +/- 2 3/4" HMA ② EXISTING +/-10" P.C.C. BASE 3 EXISTING B-6.24 CURB AND GUTTER (4) EXISTING SHOULDER +/-8" (5) HMA SURFACE REMOVAL - 2 3/4" (SEE NOTE 1) 6 HOT-MIX ASPHALT SURFACE COURSE, MIX "D", N70 (IL-9.5mm) -3" ⑦ POLYMERIZED LEVELING BINDER (MACHINE METHOD), IL-4.75, N50 -1" (8) POLYMERIZED HOT-MIX ASPHALT SURFACE COURSE, STONE MATRIX ASPHALT, N80 -2" (9) HMA SURFACE REMOVAL - 2" (1) PORTLAND CEMENT CONCRETE SURFACE REMOVAL VARIABLE DEPTH (SEE HMA TAPER AT EDGE OF P.C.C. PAVEMENT DETAIL) (1) HOT-MIX ASPHALT SURFACE COURSE, MIX "D", N70 (IL-9.5mm) -2" (2) POLYMERIZED LEVELING BINDER (MACHINE METHOD), IL-4.75, N50 -3/4" (13) HMA SURFACE REMOVAL, VARIABLE DEPTH (1) STRIP REFLECTIVE CRACK CONTROL TREATMENT


1. THE CONTRACTOR SHALL PERFORM THE PAVEMENT PATCHING OPERATIONS PRIOR TO THE HMA SURFACE REMOVAL OPERATION. SEE IDOT DISTRICT 1 DETAIL PAVEMENT PATCHING FOR HMA SURFACED PAVEMENT BD-400-04 (BD-22) FOR ADDITIONAL INFORMATION.

2. NO ADDITIONAL COMPENSATION WILL BE GIVEN TO THE CONTRACTOR FOR ANY EXTRA WORK REQUIRED TO REMOVE THE HMA SHOULDER ADJACENT TO THE EXISTING BARRIER WALL. THIS WORK WILL BE INCLUDED IN THE CONTRACT UNIT PRICE FOR HMA SURFACE REMOVAL - 2" AND HMA SURFACE REMOVAL VARIABLE DEPTH.

BRIDGE OMISSION STA. 393+19 TO STA. 408+28 STA. 448+52 TO STA. 452+48 STA. 493+16 TO STA. 494+80

REMENTS		
	AIR VOIDS Ndes	QUALITY MANAGEMENT PROGRAM (QMP)
PHALT, N80 (IL-12.5 mm)	3.5% @ 80 GYR.	PFP
	3.5% @ 50 GYR.	PFP
	4% @ 70 GYR.	QCP
	4% @ 70 GYR.	QC/QA
	4% @ 70 GYR.	QC/QA
QUALITY CONTROL FOR PE	RFORMANCE (OCP); PA	Y FOR PERFORMANCE (PFP)

	IONS		F.A.P. RTE.	SECTION	COUNTY	TOTAL SHEETS	SHEET NO.
ER			344	543R-3-RS	DUPAGE	51	7
IE,	20 (ROI	TERFIELD ROAD)	_		CONTRAC	T NO. 6	50N51
TS	STA.	TO STA.		ILLINOIS FED. A	D PROJECT		

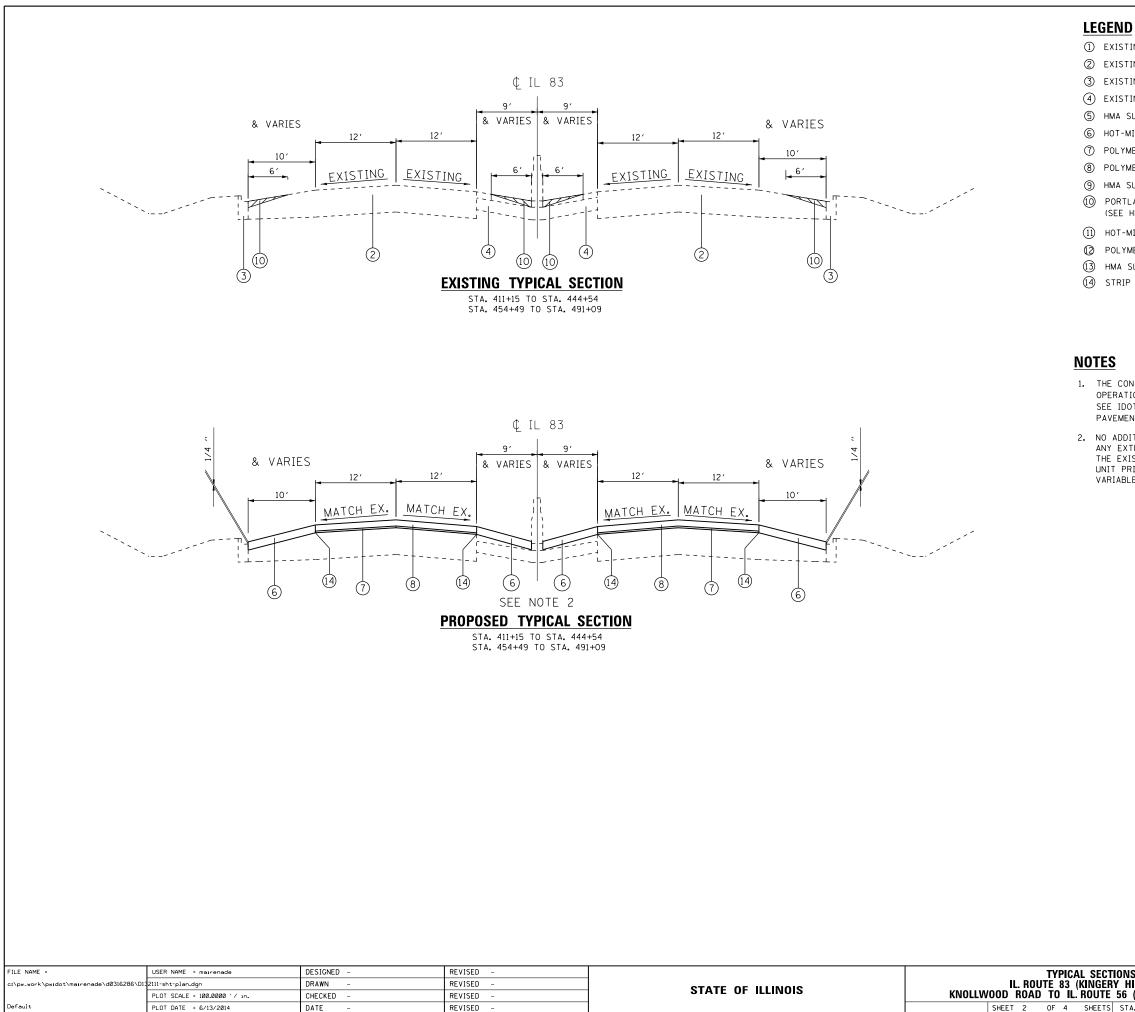


() EXISTING +/- 2 3/4" HMA ② EXISTING +/-10" P.C.C. BASE (3) EXISTING B-6.24 CURB AND GUTTER (4) EXISTING SHOULDER +/-8" (5) HMA SURFACE REMOVAL - 2 3/4" (SEE NOTE 1) 6 HOT-MIX ASPHALT SURFACE COURSE, MIX "D", N70 (IL-9.5mm) -3" ⑦ POLYMERIZED LEVELING BINDER (MACHINE METHOD), IL-4.75, N50 -1" (8) POLYMERIZED HOT-MIX ASPHALT SURFACE COURSE, STONE MATRIX ASPHALT, N80 -2" (9) HMA SURFACE REMOVAL - 2" (1) PORTLAND CEMENT CONCRETE SURFACE REMOVAL VARIABLE DEPTH (SEE HMA TAPER AT EDGE OF P.C.C. PAVEMENT DETAIL) (1) HOT-MIX ASPHALT SURFACE COURSE, MIX "D", N70 (IL-9.5mm) -2" POLYMERIZED LEVELING BINDER (MACHINE METHOD), IL-4.75, N50 -3/4" (13) HMA SURFACE REMOVAL, VARIABLE DEPTH

(14) STRIP REFLECTIVE CRACK CONTROL TREATMENT

1. THE CONTRACTOR SHALL PERFORM THE PAVEMENT PATCHING OPERATIONS PRIOR TO THE HMA SURFACE REMOVAL OPERATION. SEE IDOT DISTRICT 1 DETAIL PAVEMENT PATCHING FOR HMA SURFACED PAVEMENT BD-400-04 (BD-22) FOR ADDITIONAL INFORMATION.

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	IONS		F.A.P. RTE.	SECTION	COUNTY	TOTAL SHEETS	SHEET NO.
ERY HIGHWAY) FE 56 (BUTTERFIELD ROAD)				543R-3-RS	DUPAGE	51	8
IE	20 (BUI	TERFIELD RUAD)			CONTRAC	T NO. 6	50N51
TS	STA.	TO STA.		ILLINOIS FED. A	ID PROJECT		

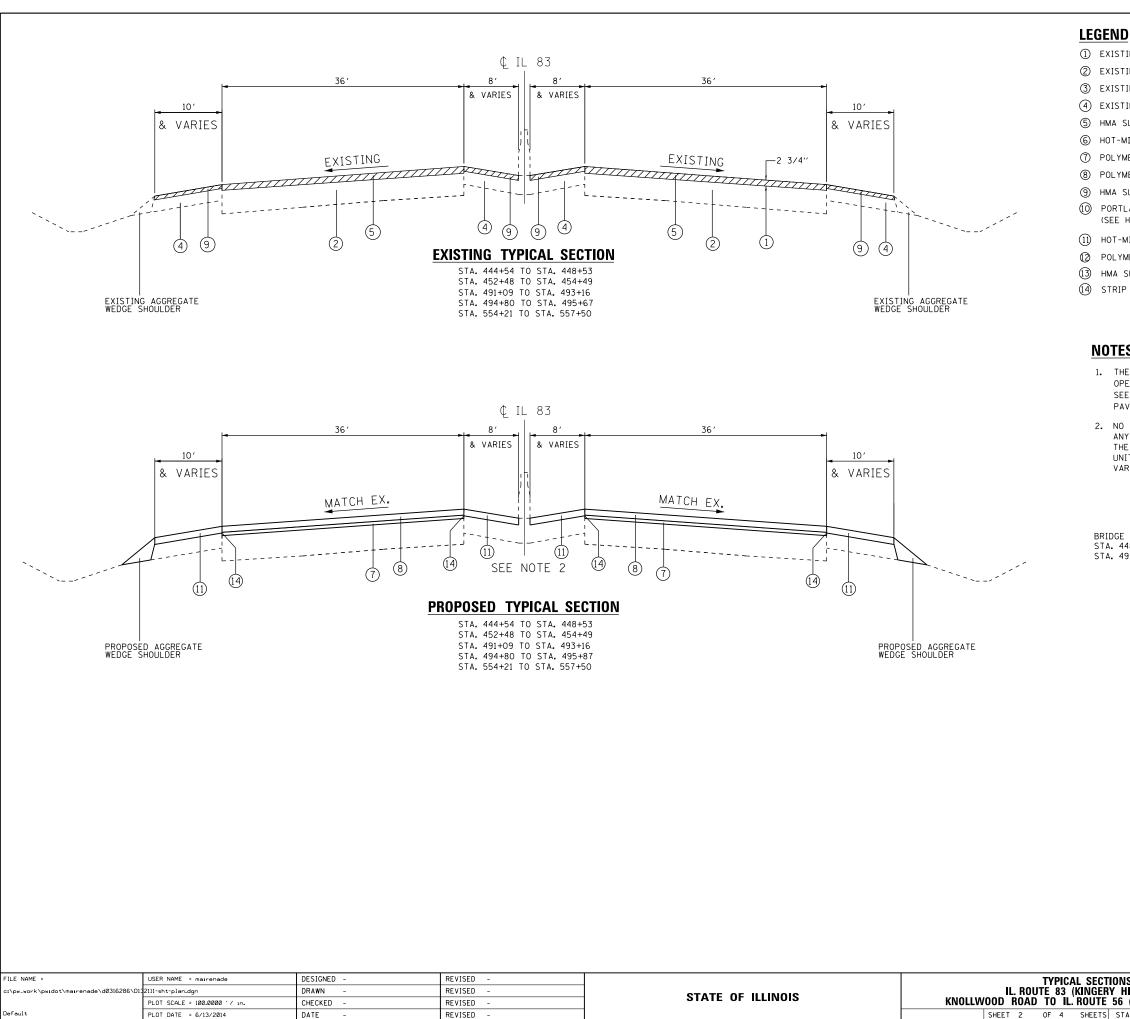

() EXISTING +/- 2 3/4" HMA ② EXISTING +/-10" P.C.C. BASE (3) EXISTING B-6.24 CURB AND GUTTER (4) EXISTING SHOULDER +/-8" (5) HMA SURFACE REMOVAL - 2 3/4" (SEE NOTE 1) 6 HOT-MIX ASPHALT SURFACE COURSE, MIX "D", N70 (IL-9.5mm) -3" ⑦ POLYMERIZED LEVELING BINDER (MACHINE METHOD), IL-4.75, N50 -1" (8) POLYMERIZED HOT-MIX ASPHALT SURFACE COURSE, STONE MATRIX ASPHALT, N80 -2" (9) HMA SURFACE REMOVAL - 2" (1) PORTLAND CEMENT CONCRETE SURFACE REMOVAL VARIABLE DEPTH (SEE HMA TAPER AT EDGE OF P.C.C. PAVEMENT DETAIL) (1) HOT-MIX ASPHALT SURFACE COURSE, MIX "D", N70 (IL-9.5mm) -2" POLYMERIZED LEVELING BINDER (MACHINE METHOD), IL-4.75, N50 -3/4" (13) HMA SURFACE REMOVAL, VARIABLE DEPTH (14) STRIP REFLECTIVE CRACK CONTROL TREATMENT


NOTES

1. THE CONTRACTOR SHALL PERFORM THE PAVEMENT PATCHING OPERATIONS PRIOR TO THE HMA SURFACE REMOVAL OPERATION. SEE IDOT DISTRICT 1 DETAIL PAVEMENT PATCHING FOR HMA SURFACED PAVEMENT BD-400-04 (BD-22) FOR ADDITIONAL INFORMATION.

2. NO ADDITIONAL COMPENSATION WILL BE GIVEN TO THE CONTRACTOR FOR ANY EXTRA WORK REQUIRED TO REMOVE THE HMA SHOULDER ADJACENT TO THE EXISTING BARRIER WALL. THIS WORK WILL BE INCLUDED IN THE CONTRACT UNIT PRICE FOR HMA SURFACE REMOVAL - 2" AND HMA SURFACE REMOVAL VARIABLE DEPTH.

BRIDGE OMISSION STA. 448+52 TO STA. 452+48 STA. 493+16 TO STA. 494+80

CTION		F.A.P. RTE.	SEC	LION	COUNTY	TOTAL SHEETS	SHEET NO.
		344 543R-3-RS			DUPAGE	51	9
IE 56	(BUTTERFIELD R	JAD)			CONTRACT	T NO. 6	50N51
TS ST	A. TO S	ΓΑ.		ILLINOIS FED. A	ID PROJECT		

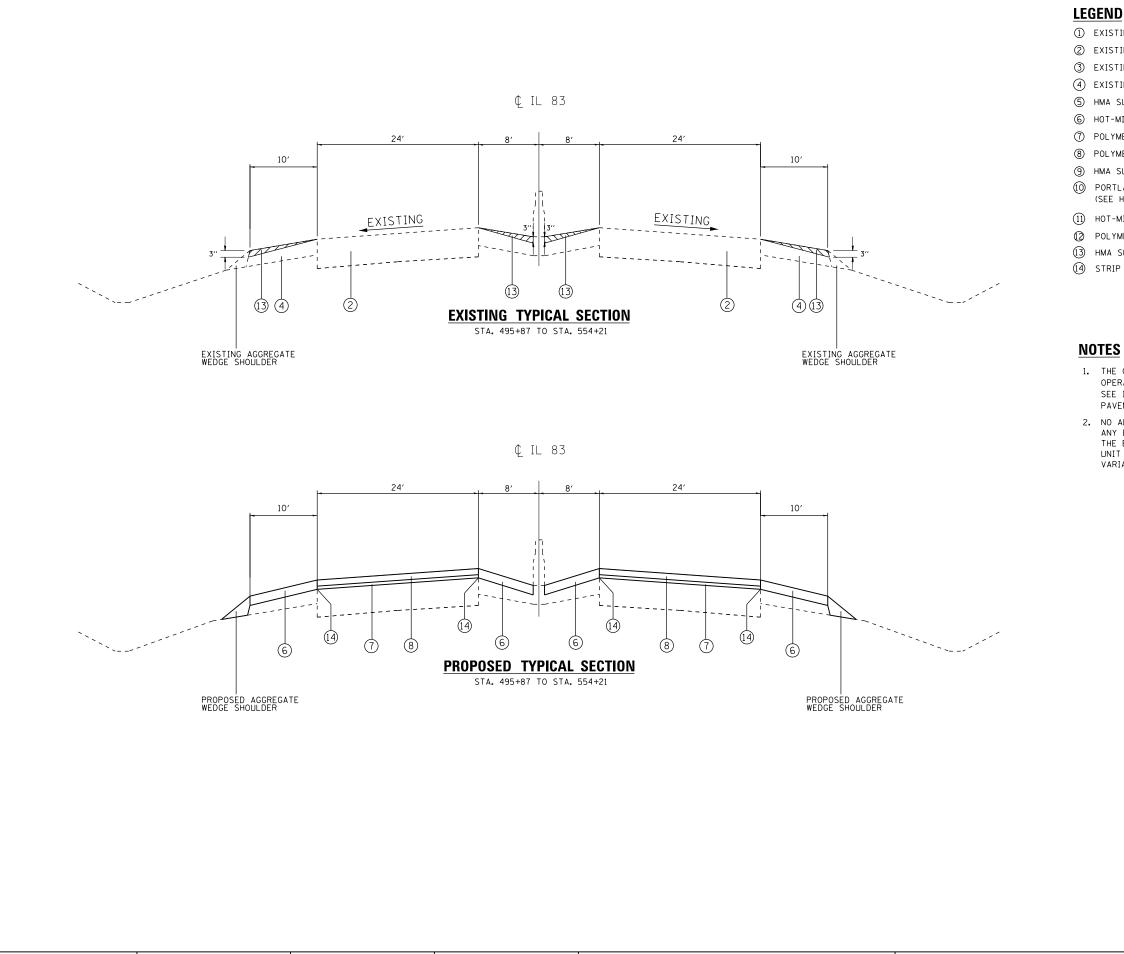


FILE NAME =	USER NAME = mairenade	DESIGNED -	REVISED -		TYPICAL SECTIONS	F.A.P.	SECTION	COUNTY TOTAL SHEET
c:\pw_work\pwidot\mairenade\d0316286\D13	2111-sht-plan.dgn	DRAWN -	REVISED -	STATE OF ILLINOIS	IL. ROUTE 83 (KINGERY HIGHWAY)	344	543R-3-RS	DUPAGE 51 10
	PLOT SCALE = 100.0000 ' / in.	CHECKED -	REVISED -	STATE OF ILLINOIS	KNOLLWOOD ROAD TO IL ROUTE 56 (BUTTERFIELD ROAD)			CONTRACT NO. 60N51
Default	PLOT DATE = 6/13/2014 DATE - C REVISED - REVIS						ILLINOIS FED. A	ND PROJECT

① EXISTING +/- 2 3/4" HMA ② EXISTING +/-10" P.C.C. BASE (3) EXISTING B-6.24 CURB AND GUTTER (4) EXISTING SHOULDER +/-8" (5) HMA SURFACE REMOVAL - 2 3/4" (SEE NOTE 1) 6 HOT-MIX ASPHALT SURFACE COURSE, MIX "D", N70 (IL-9.5mm) -3" ⑦ POLYMERIZED LEVELING BINDER (MACHINE METHOD), IL-4.75, N50 -1" (8) POLYMERIZED HOT-MIX ASPHALT SURFACE COURSE, STONE MATRIX ASPHALT, N80 -2" (9) HMA SURFACE REMOVAL - 2" (1) PORTLAND CEMENT CONCRETE SURFACE REMOVAL VARIABLE DEPTH (SEE HMA TAPER AT EDGE OF P.C.C. PAVEMENT DETAIL) (1) HOT-MIX ASPHALT SURFACE COURSE, MIX "D", N70 (IL-9.5mm) -2" POLYMERIZED LEVELING BINDER (MACHINE METHOD), IL-4.75, N50 -3/4" (13) HMA SURFACE REMOVAL, VARIABLE DEPTH (14) STRIP REFLECTIVE CRACK CONTROL TREATMENT

NOTES

- 1. THE CONTRACTOR SHALL PERFORM THE PAVEMENT PATCHING OPERATIONS PRIOR TO THE HMA SURFACE REMOVAL OPERATION. SEE IDOT DISTRICT 1 DETAIL PAVEMENT PATCHING FOR HMA SURFACED PAVEMENT BD-400-04 (BD-22) FOR ADDITIONAL INFORMATION.
- 2. NO ADDITIONAL COMPENSATION WILL BE GIVEN TO THE CONTRACTOR FOR ANY EXTRA WORK REQUIRED TO REMOVE THE HMA SHOULDER ADJACENT TO THE EXISTING BARRIER WALL. THIS WORK WILL BE INCLUDED IN THE CONTRACT UNIT PRICE FOR HMA SURFACE REMOVAL - 2" AND HMA SURFACE REMOVAL VARIABLE DEPTH.

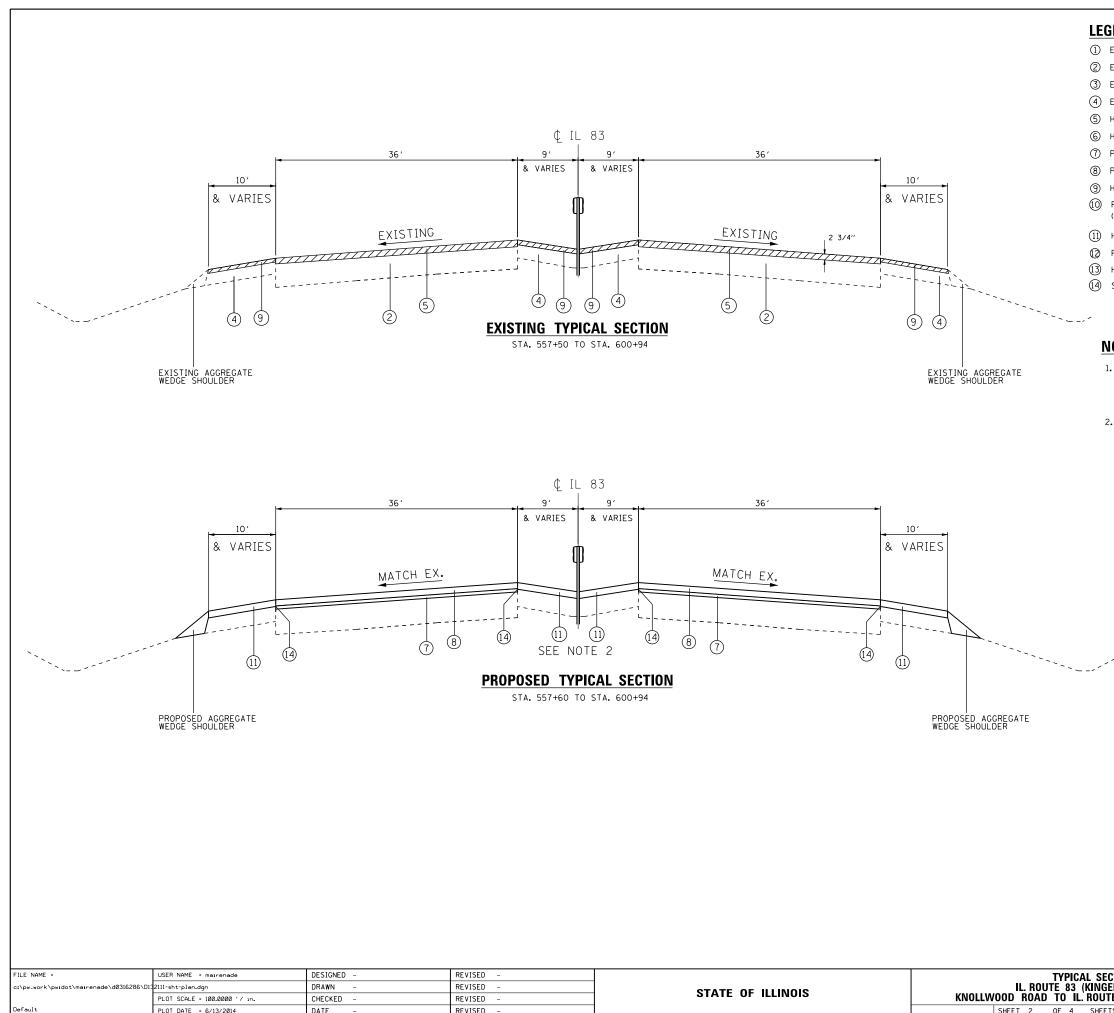

SHEET 2 OF 4 SHEET


LEGEND

① EXISTING +/- 2 3/4" HMA ② EXISTING +/-10" P.C.C. BASE (3) EXISTING B-6.24 CURB AND GUTTER (4) EXISTING SHOULDER +/-8" (5) HMA SURFACE REMOVAL - 2 3/4" (SEE NOTE 1) 6 HOT-MIX ASPHALT SURFACE COURSE, MIX "D", N70 (IL-9.5mm) -3" ⑦ POLYMERIZED LEVELING BINDER (MACHINE METHOD), IL-4.75, N50 -1" (8) POLYMERIZED HOT-MIX ASPHALT SURFACE COURSE, STONE MATRIX ASPHALT, N80 -2" (9) HMA SURFACE REMOVAL - 2" (1) PORTLAND CEMENT CONCRETE SURFACE REMOVAL VARIABLE DEPTH (SEE HMA TAPER AT EDGE OF P.C.C. PAVEMENT DETAIL) (1) HOT-MIX ASPHALT SURFACE COURSE, MIX "D", N70 (IL-9.5mm) -2" POLYMERIZED LEVELING BINDER (MACHINE METHOD), IL-4.75, N50 -3/4" (13) HMA SURFACE REMOVAL, VARIABLE DEPTH (14) STRIP REFLECTIVE CRACK CONTROL TREATMENT

NOTES

- 1. THE CONTRACTOR SHALL PERFORM THE PAVEMENT PATCHING OPERATIONS PRIOR TO THE HMA SURFACE REMOVAL OPERATION. SEE IDOT DISTRICT 1 DETAIL PAVEMENT PATCHING FOR HMA SURFACED PAVEMENT BD-400-04 (BD-22) FOR ADDITIONAL INFORMATION.
- 2. NO ADDITIONAL COMPENSATION WILL BE GIVEN TO THE CONTRACTOR FOR ANY EXTRA WORK REQUIRED TO REMOVE THE HMA SHOULDER ADJACENT TO THE EXISTING BARRIER WALL. THIS WORK WILL BE INCLUDED IN THE CONTRACT UNIT PRICE FOR HMA SURFACE REMOVAL - 2" AND HMA SURFACE REMOVAL VARIABLE DEPTH.

	IONS		F.A.P. RTE.	SECTION	COUNTY	TOTAL SHEETS	SHEET NO.
ER			344	543R-3-RS	DUPAGE	51	11
	E 56 (BUTTERFIELD ROAD)				CONTRAC	T NO. 6	50N51
TS	STA.	TO STA.		ILLINOIS FED. A	ID PROJECT		

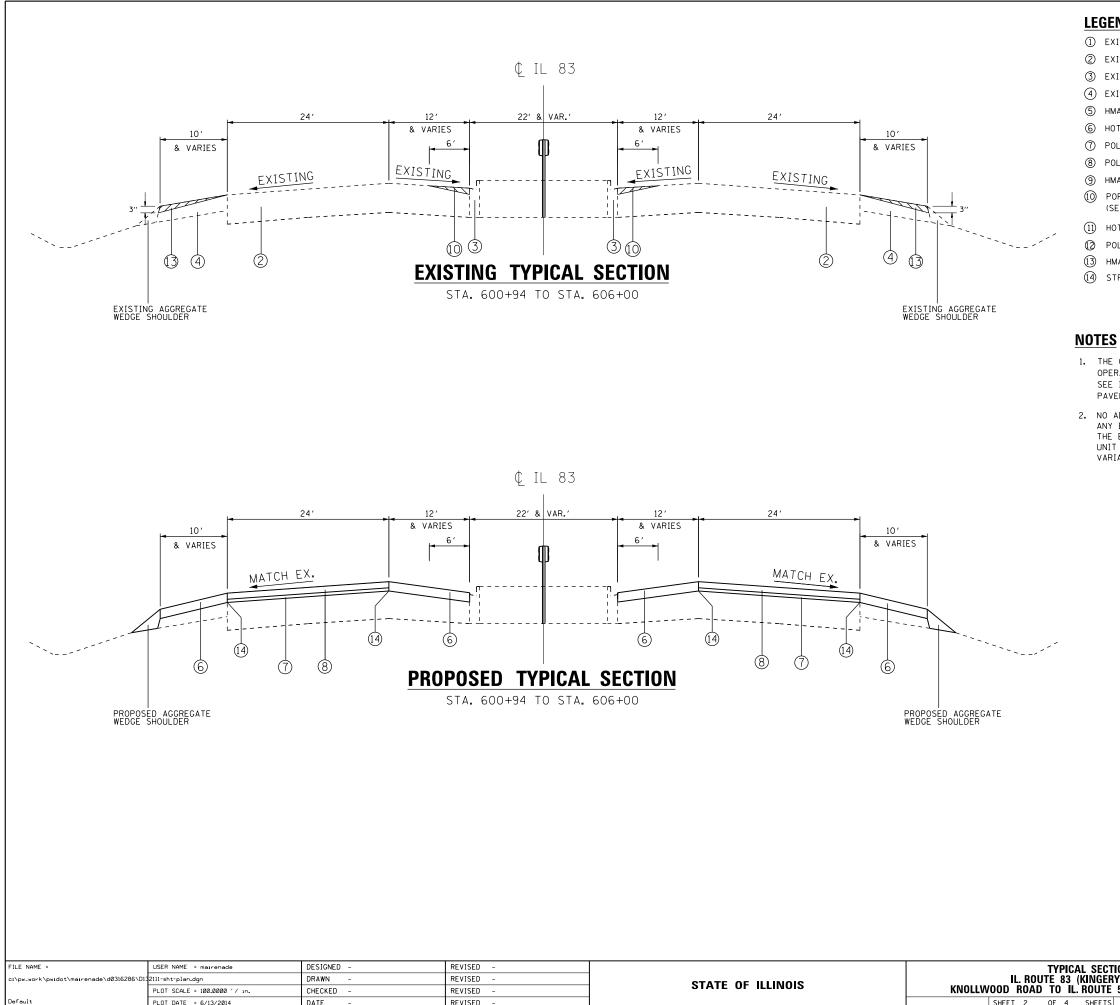

SHEET 2 OF 4 SHEET

LEGEND


① EXISTING +/- 2 3/4" HMA ② EXISTING +/-10" P.C.C. BASE (3) EXISTING B-6.24 CURB AND GUTTER (4) EXISTING SHOULDER +/-8" (5) HMA SURFACE REMOVAL - 2 3/4" (SEE NOTE 1) 6 HOT-MIX ASPHALT SURFACE COURSE, MIX "D", N70 (IL-9.5mm) -3" ⑦ POLYMERIZED LEVELING BINDER (MACHINE METHOD), IL-4.75, N50 -1" (8) POLYMERIZED HOT-MIX ASPHALT SURFACE COURSE, STONE MATRIX ASPHALT, N80 -2" (9) HMA SURFACE REMOVAL - 2" (1) PORTLAND CEMENT CONCRETE SURFACE REMOVAL VARIABLE DEPTH (SEE HMA TAPER AT EDGE OF P.C.C. PAVEMENT DETAIL) (1) HOT-MIX ASPHALT SURFACE COURSE, MIX "D", N70 (IL-9.5mm) -2" POLYMERIZED LEVELING BINDER (MACHINE METHOD), IL-4.75, N50 -3/4" (13) HMA SURFACE REMOVAL, VARIABLE DEPTH

(14) STRIP REFLECTIVE CRACK CONTROL TREATMENT

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TIONS	F.A.P. RTE.	SECTION	COUNTY	TOTAL SHEETS	SHEET NO.
	344	543R-3-RS	DUPAGE	51	12
E 56 (BUTTERFIELD ROAD)			CONTRACT	T NO. 6	50N51
S STA. TO STA.		ILLINOIS FED. A	D PROJECT		



() EXISTING +/- 2 3/4" HMA ② EXISTING +/-10" P.C.C. BASE (3) EXISTING B-6.24 CURB AND GUTTER (4) EXISTING SHOULDER +/-8" (5) HMA SURFACE REMOVAL - 2 3/4" (SEE NOTE 1) 6 HOT-MIX ASPHALT SURFACE COURSE, MIX "D", N70 (IL-9.5mm) -3" ⑦ POLYMERIZED LEVELING BINDER (MACHINE METHOD), IL-4.75, N50 -1" (8) POLYMERIZED HOT-MIX ASPHALT SURFACE COURSE, STONE MATRIX ASPHALT, N80 -2" (9) HMA SURFACE REMOVAL - 2" (1) PORTLAND CEMENT CONCRETE SURFACE REMOVAL VARIABLE DEPTH (SEE HMA TAPER AT EDGE OF P.C.C. PAVEMENT DETAIL) (1) HOT-MIX ASPHALT SURFACE COURSE, MIX "D", N70 (IL-9.5mm) -2" POLYMERIZED LEVELING BINDER (MACHINE METHOD), IL-4.75, N50 -3/4" (13) HMA SURFACE REMOVAL, VARIABLE DEPTH

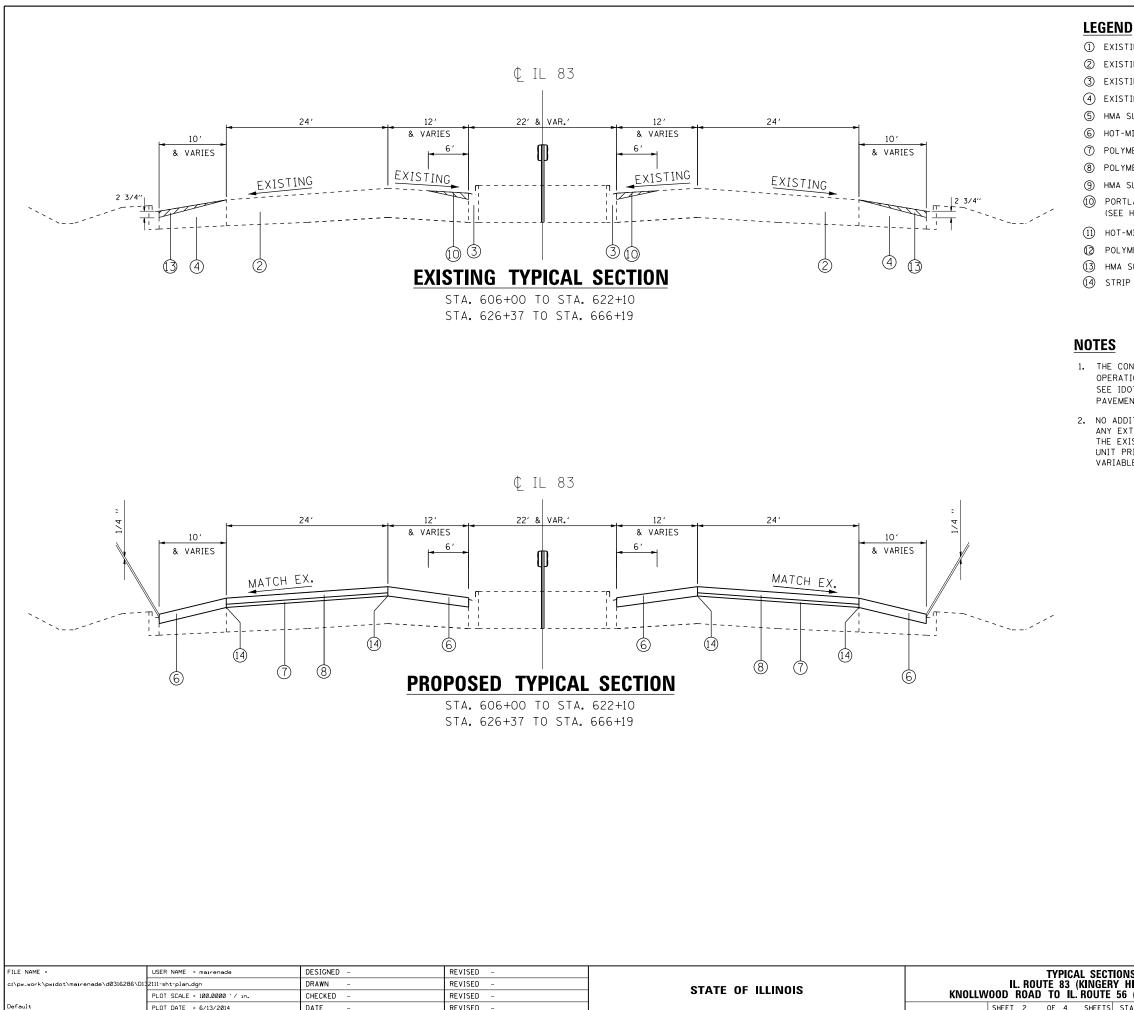(14) STRIP REFLECTIVE CRACK CONTROL TREATMENT


1. THE CONTRACTOR SHALL PERFORM THE PAVEMENT PATCHING OPERATIONS PRIOR TO THE HMA SURFACE REMOVAL OPERATION. SEE IDOT DISTRICT 1 DETAIL PAVEMENT PATCHING FOR HMA SURFACED PAVEMENT BD-400-04 (BD-22) FOR ADDITIONAL INFORMATION.


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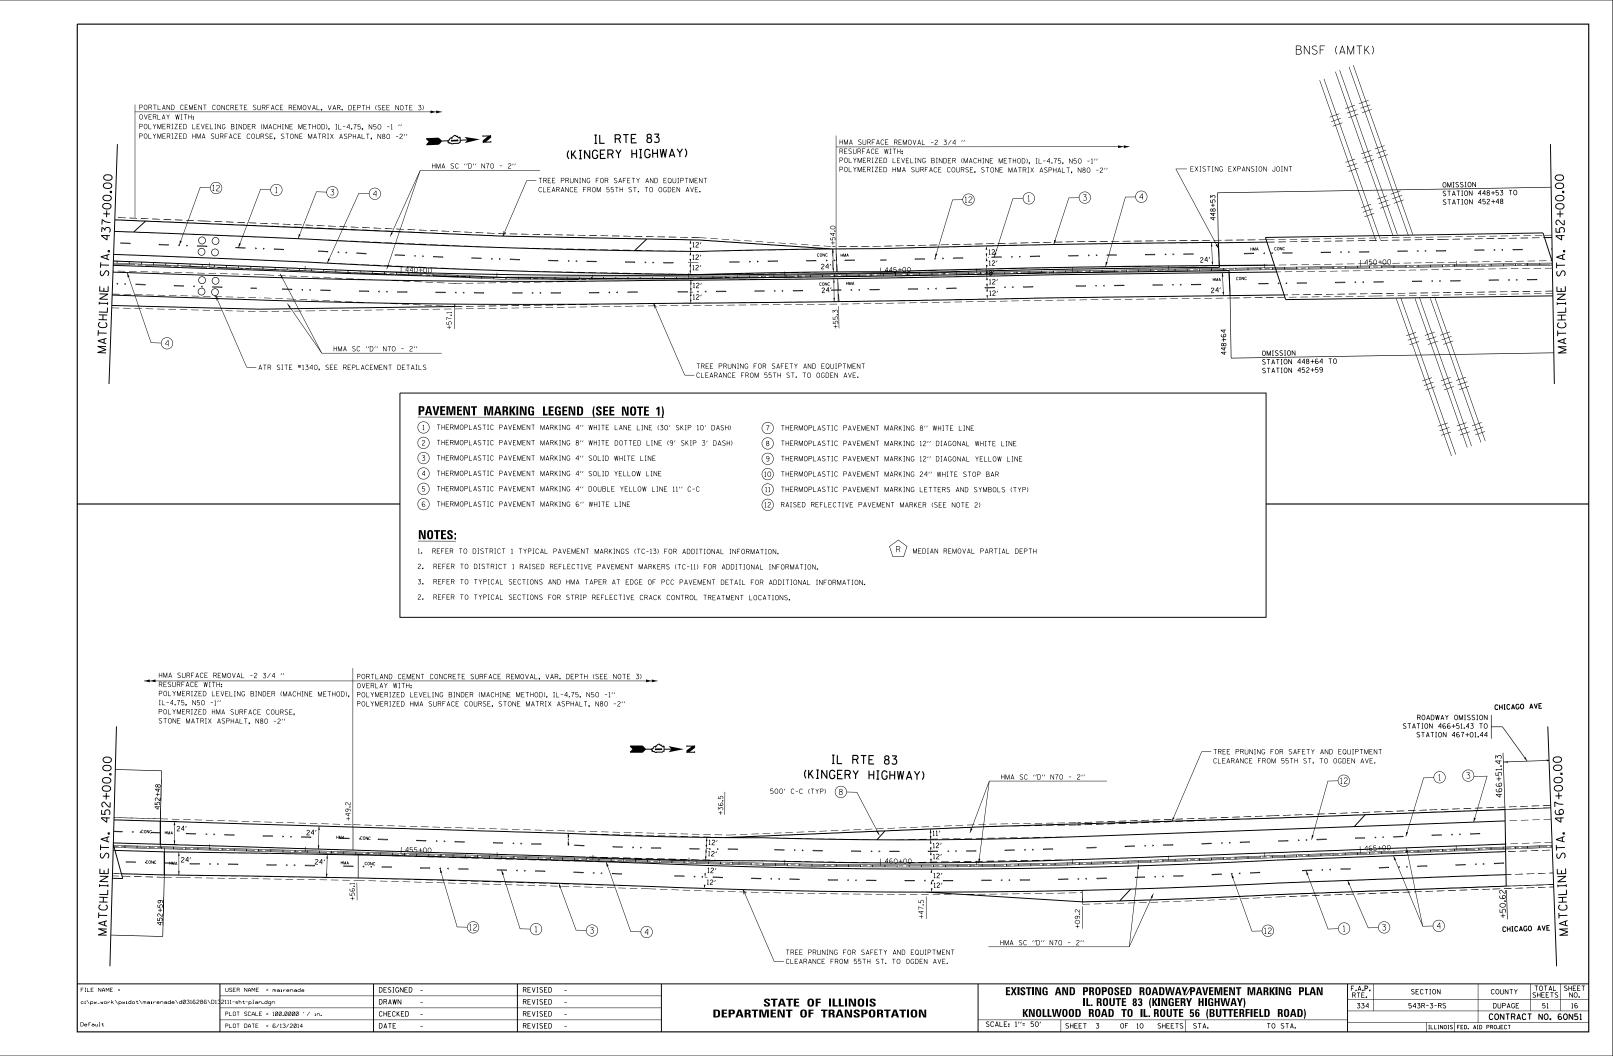
	IONS		F.A.P. RTE	SECTION	COUNTY	TOTAL SHEETS	SHEET NO.
ER			344	543R-3-RS	DUPAGE	51	13
IE,	20 (ROI	TERFIELD ROAD)	_		CONTRAC	T NO. 6	50N51
TS	STA.	TO STA.		ILLINOIS FED. AI	D PROJECT		


KNOLL WOOD ROAD	NS NCRETE SURFACE REMOVAL, VAR. DEPTH (SEE NOTE 3)	≌-⊕-> z	IL RTE 83 (KINGERY HIGHWAY)
POLYMERIZED LEVELING	G BINDER (MACHINE METHOD), IL-4.75, N50 - 1 " RFACE COURSE, STONE MATRIX ASPHALT, N80 -2"	112'	
		· · · · · · · · · · · · · · · · · · ·	
	PAVEMENT MARKING LEGEND (SEE NOTE 1 1 THERMOPLASTIC PAVEMENT MARKING 4" WHITE LANE LINE (3 2 THERMOPLASTIC PAVEMENT MARKING 8" WHITE DOTTED LINE 3 THERMOPLASTIC PAVEMENT MARKING 4" SOLID WHITE LINE 4 THERMOPLASTIC PAVEMENT MARKING 4" SOLID YELLOW LINE 5 THERMOPLASTIC PAVEMENT MARKING 4" DOUBLE YELLOW LINE 6 THERMOPLASTIC PAVEMENT MARKING 6" WHITE LINE 1. REFER TO DISTRICT 1 TYPICAL PAVEMENT MARKINGS (TC-13) 2. REFER TO DISTRICT 1 RAISED REFLECTIVE PAVEMENT MARKE 3. REFER TO TYPICAL SECTIONS AND HMA TAPER AT EDGE OF 2. REFER TO TYPICAL SECTIONS FOR STRIP REFLECTIVE CRACK	30' SKIP 10' DASH) (7) THERMOPLASTIC PAVEMENT MARKING 8" WH: 1 (9' SKIP 3' DASH) (8) THERMOPLASTIC PAVEMENT MARKING 12" DI (9) THERMOPLASTIC PAVEMENT MARKING 12" DI (10) THERMOPLASTIC PAVEMENT MARKING 24" WH NE 11" C-C (11) THERMOPLASTIC PAVEMENT MARKING LETTER (12) RAISED REFLECTIVE PAVEMENT MARKER (SE FOR ADDITIONAL INFORMATION. RS (TC-11) FOR ADDITIONAL INFORMATION. PCC PAVEMENT DETAIL FOR ADDITIONAL INFORMATION.	AGONAL WHITE LINE AGONAL YELLOW LINE HITE STOP BAR RS AND SYMBOLS (TYP)
PORTLAND CEMENT CONCRETE SURFACE REMOVAL, VAR. DEPTH OVERLAY WITH: POLYMERIZED LEVELING BINDER (MACHINE METHOD), IL-4.75, N POLYMERIZED HMA SURFACE COURSE, STONE MATRIX ASPHALT,	N50 -1 " (KINGERY H		
00.00+56		DRY LAND BRIDGE OMISSIC STATION 393+19 TO STATION 408+28 = = = = = = = = = = = = = = = = = = =	
MATCHLINE STA. 39			
FILE NAME = USER NAME = mairenade DESIG	IGNED - REVISED - WN - REVISED -	STATE OF ILLINOIS	EXISTING AND PROPOSED ROADWAY IL. ROUTE 83 (KINGER)


c:\pw_work\pwidot\mairenade\d0316286\D13	2111-sht-plan.dgn	DRAWN -	REVISED -	STATE OF ILLINOIS	
	PLOT SCALE = 100.0000 ' / in.	CHECKED -	REVISED -	DEPARTMENT OF TRANSPORTATION	KNOLL
Default	PLOT DATE = 6/13/2014	DATE -	REVISED -		SCALE: 1"= 50'




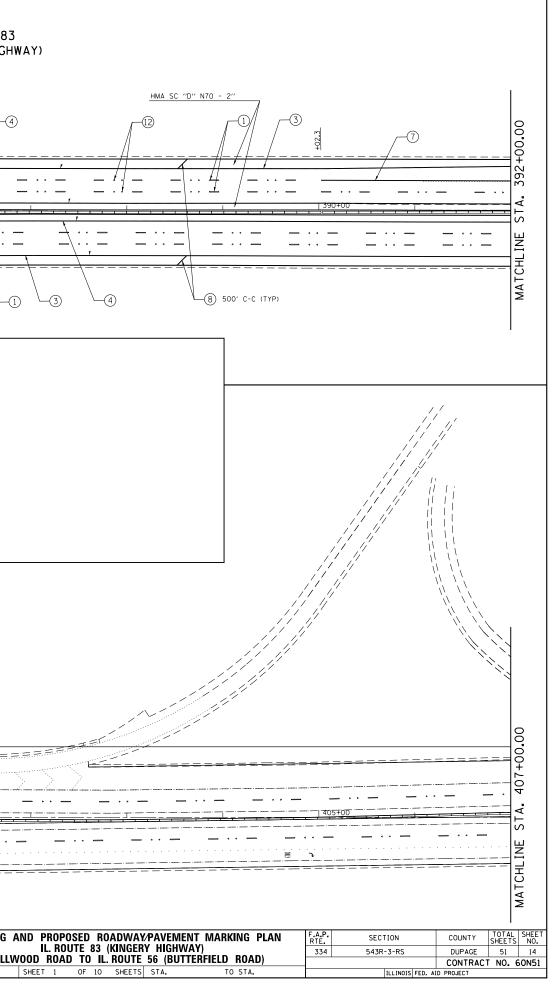


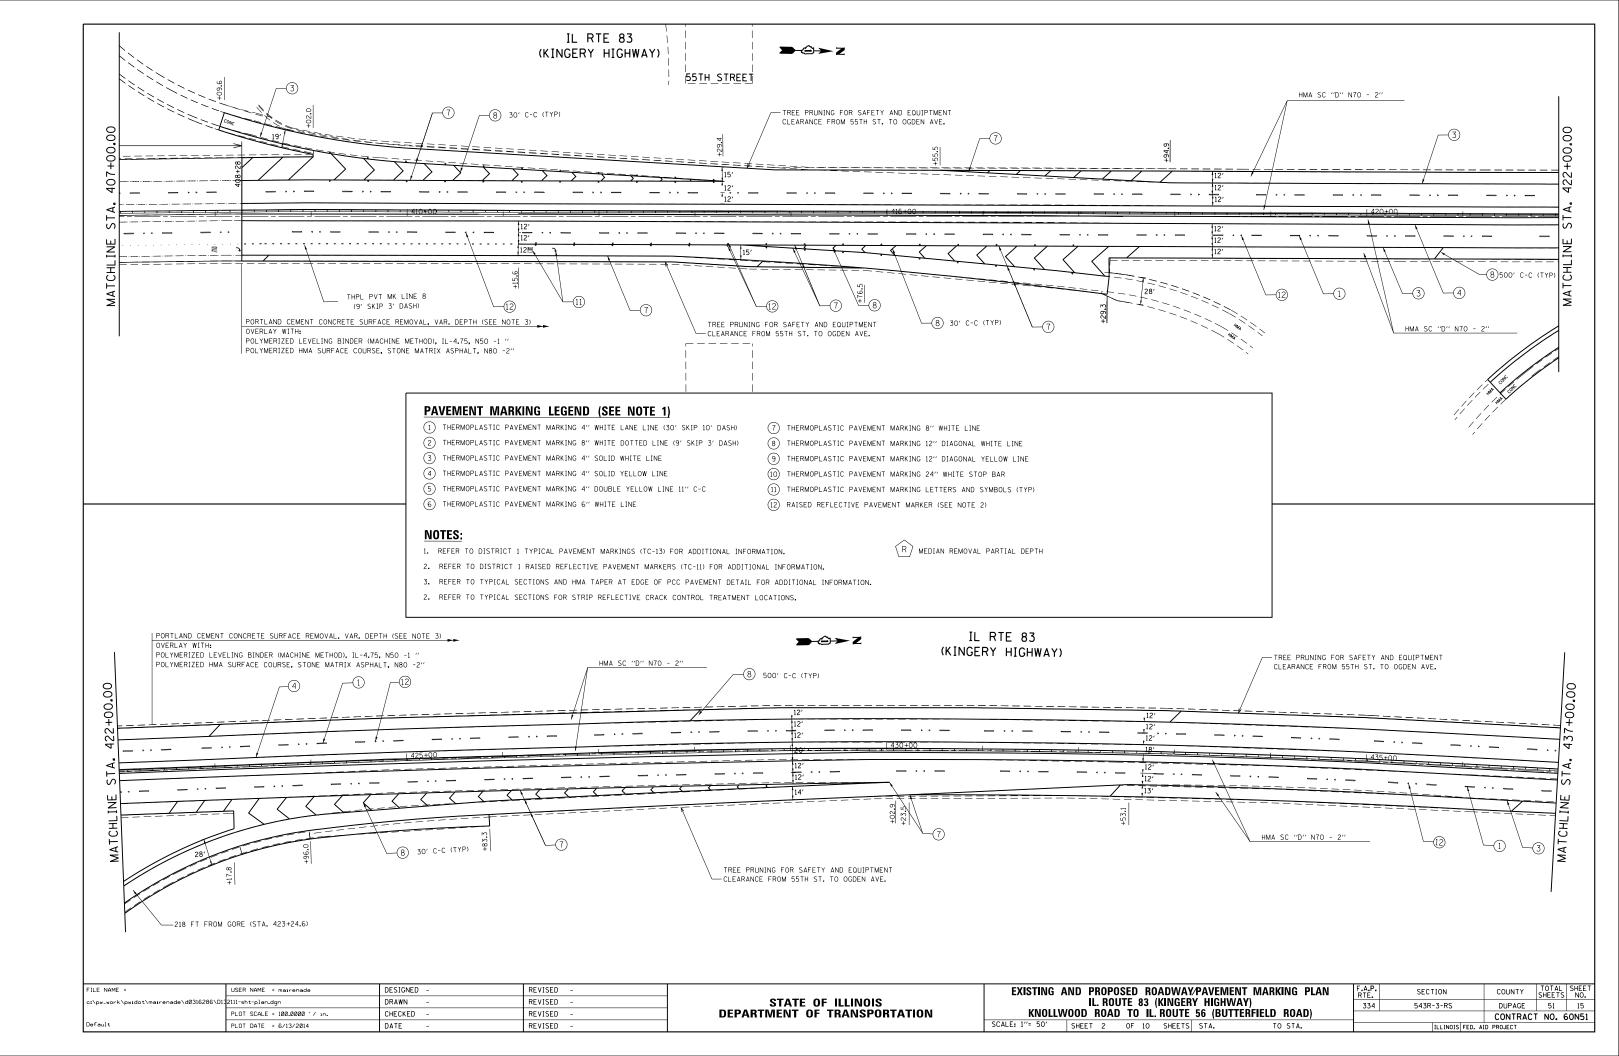


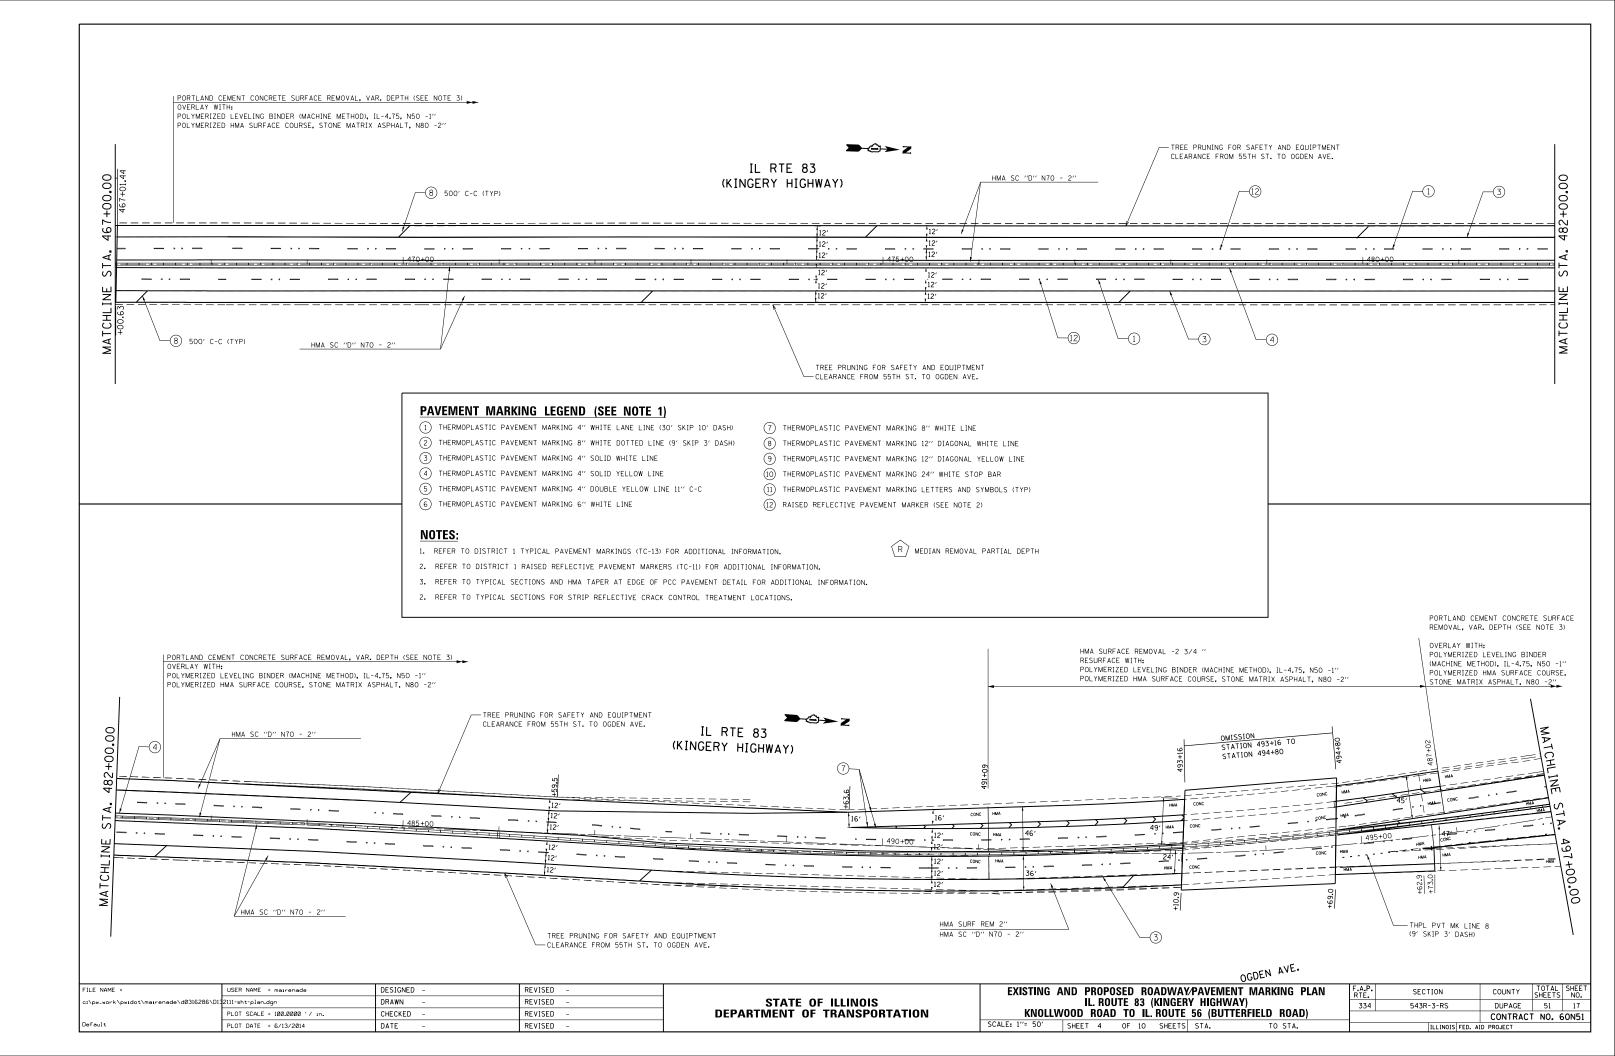


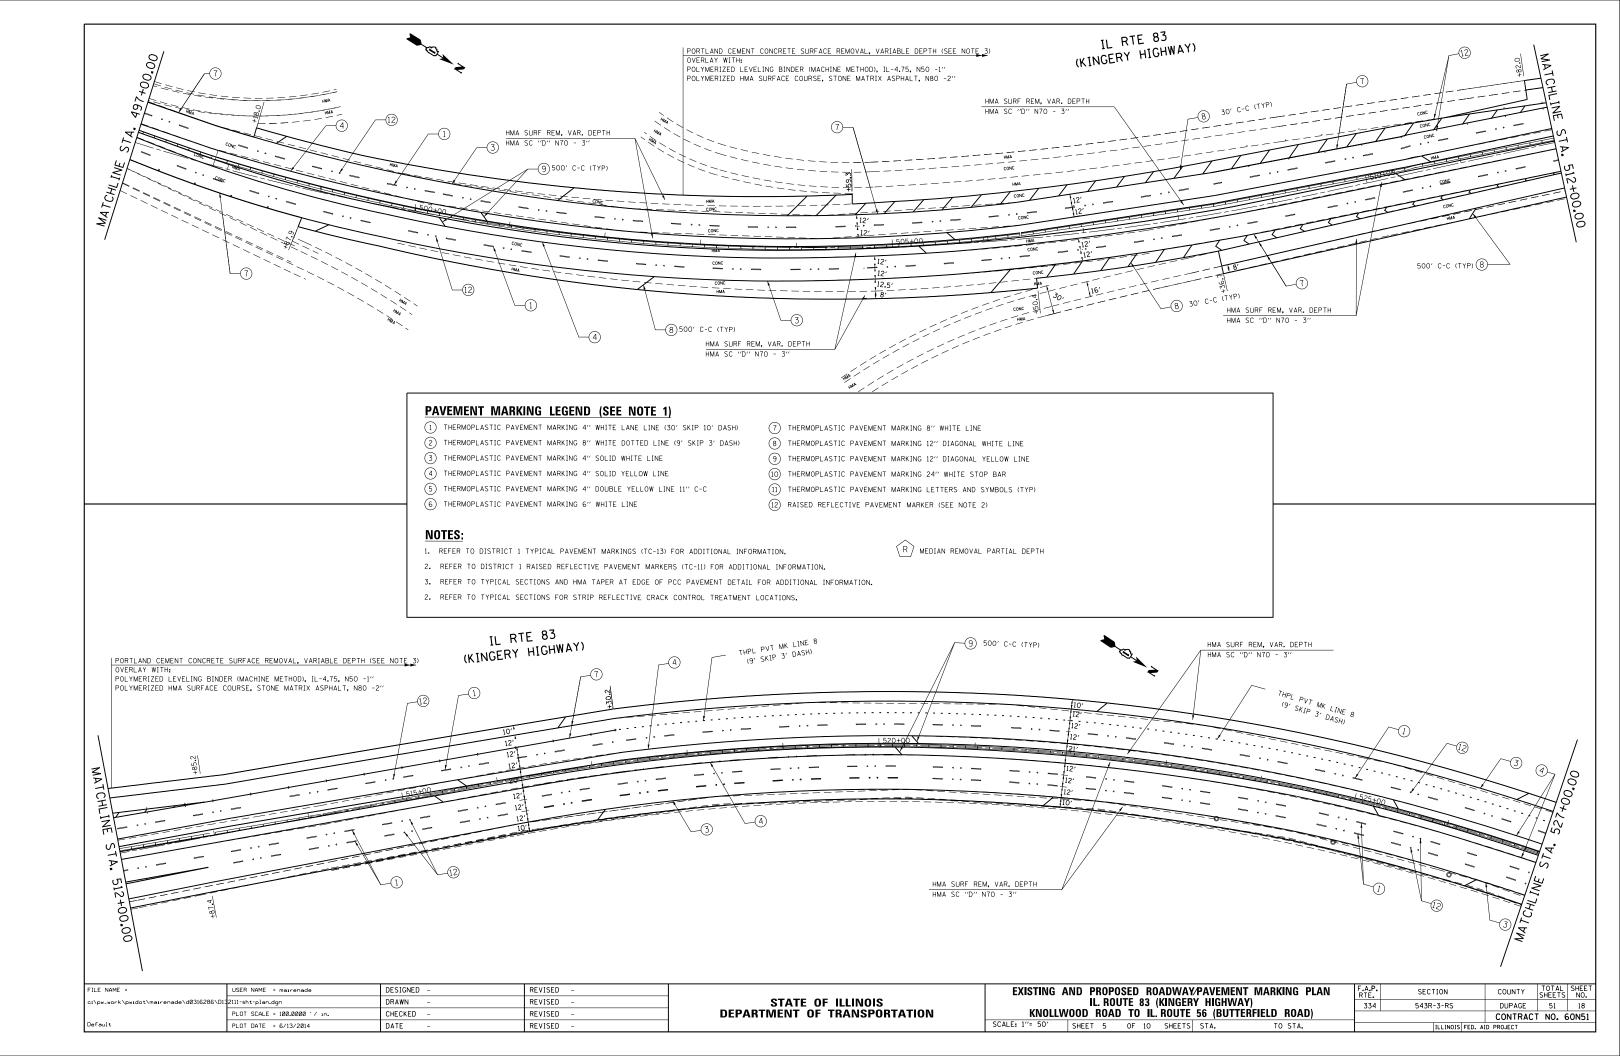


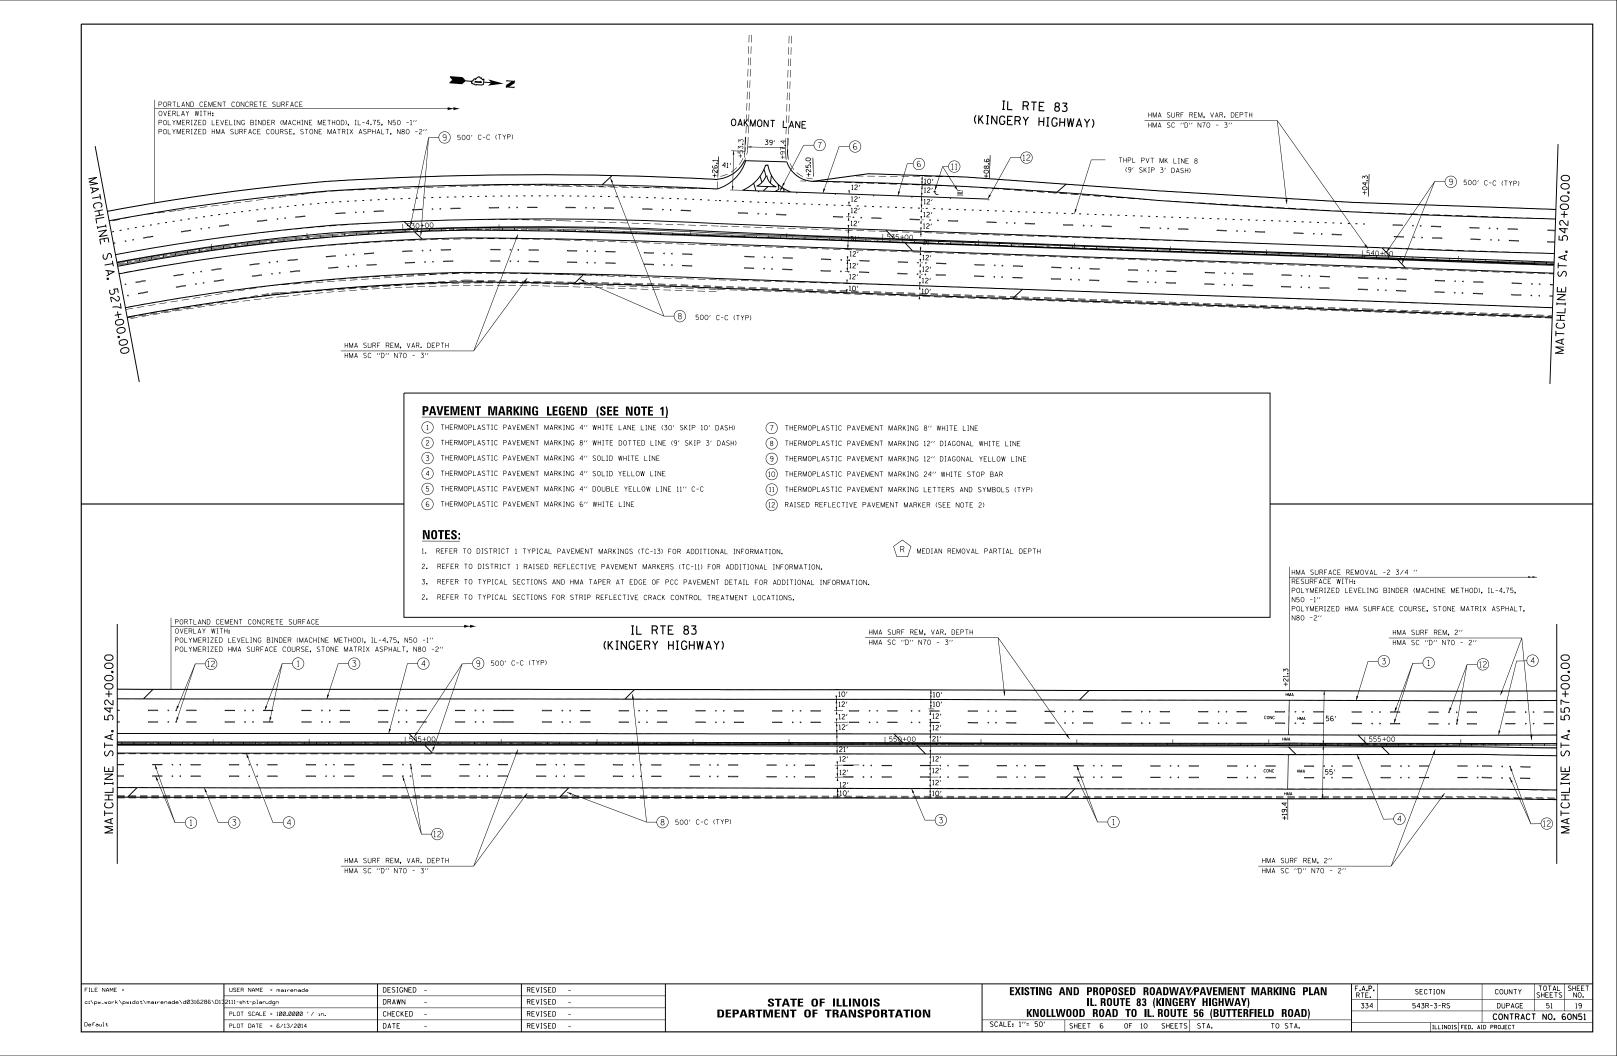


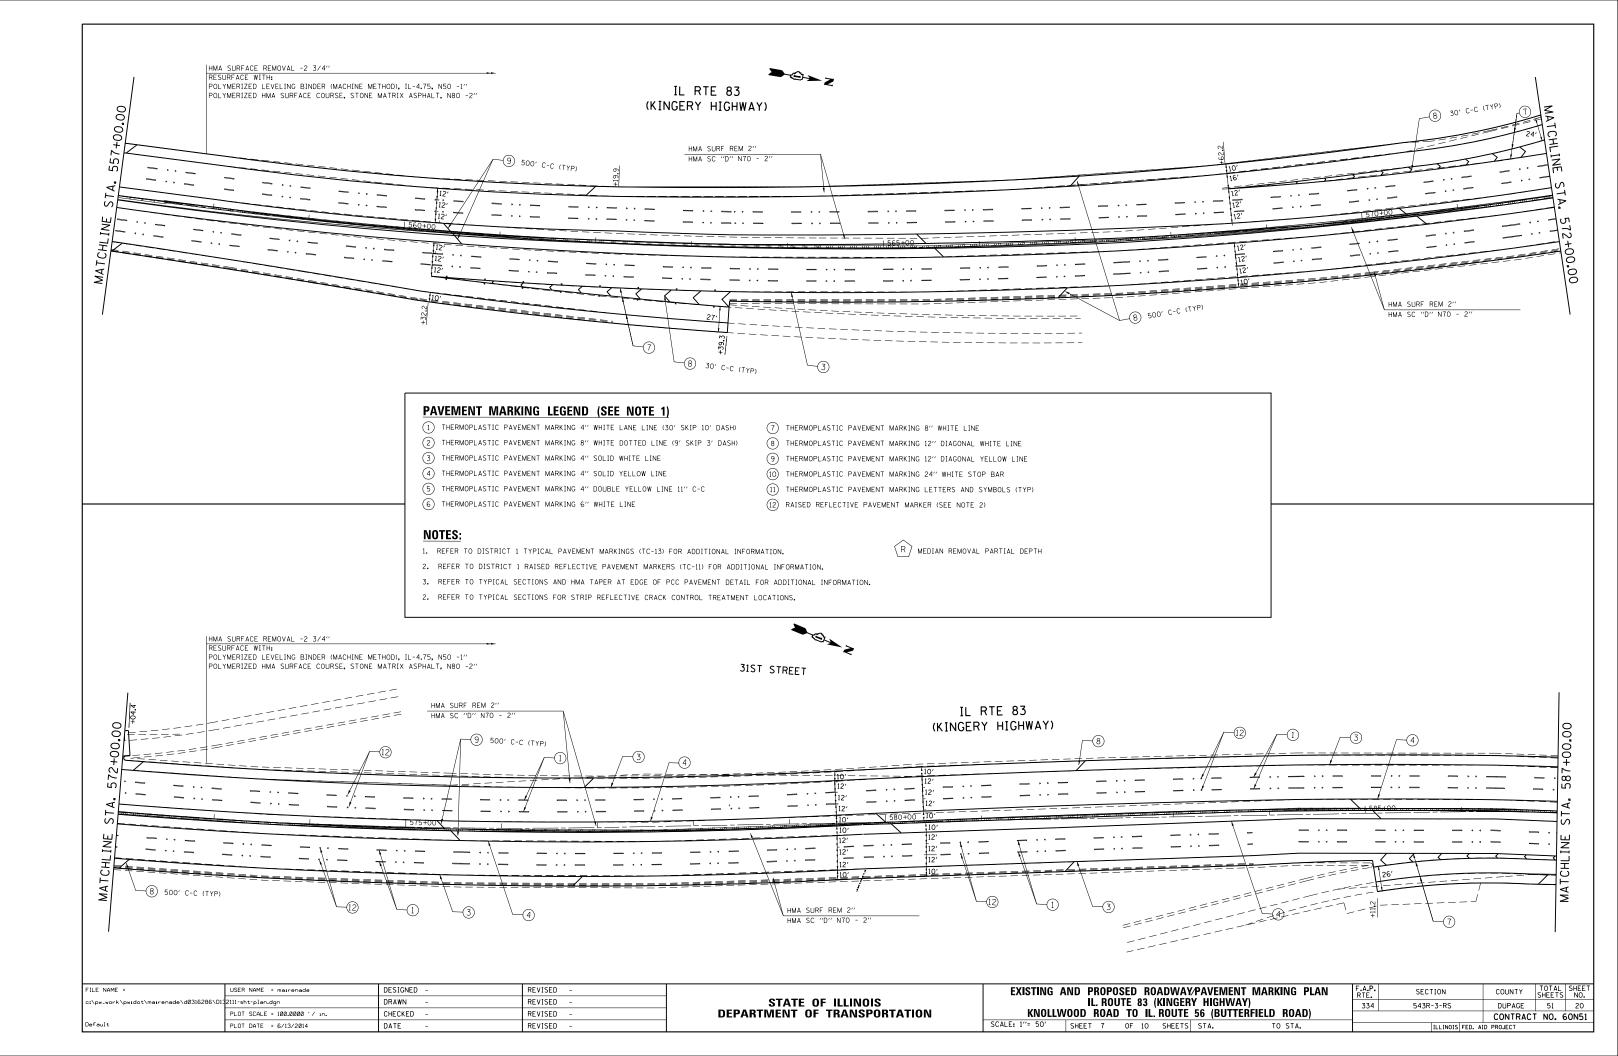

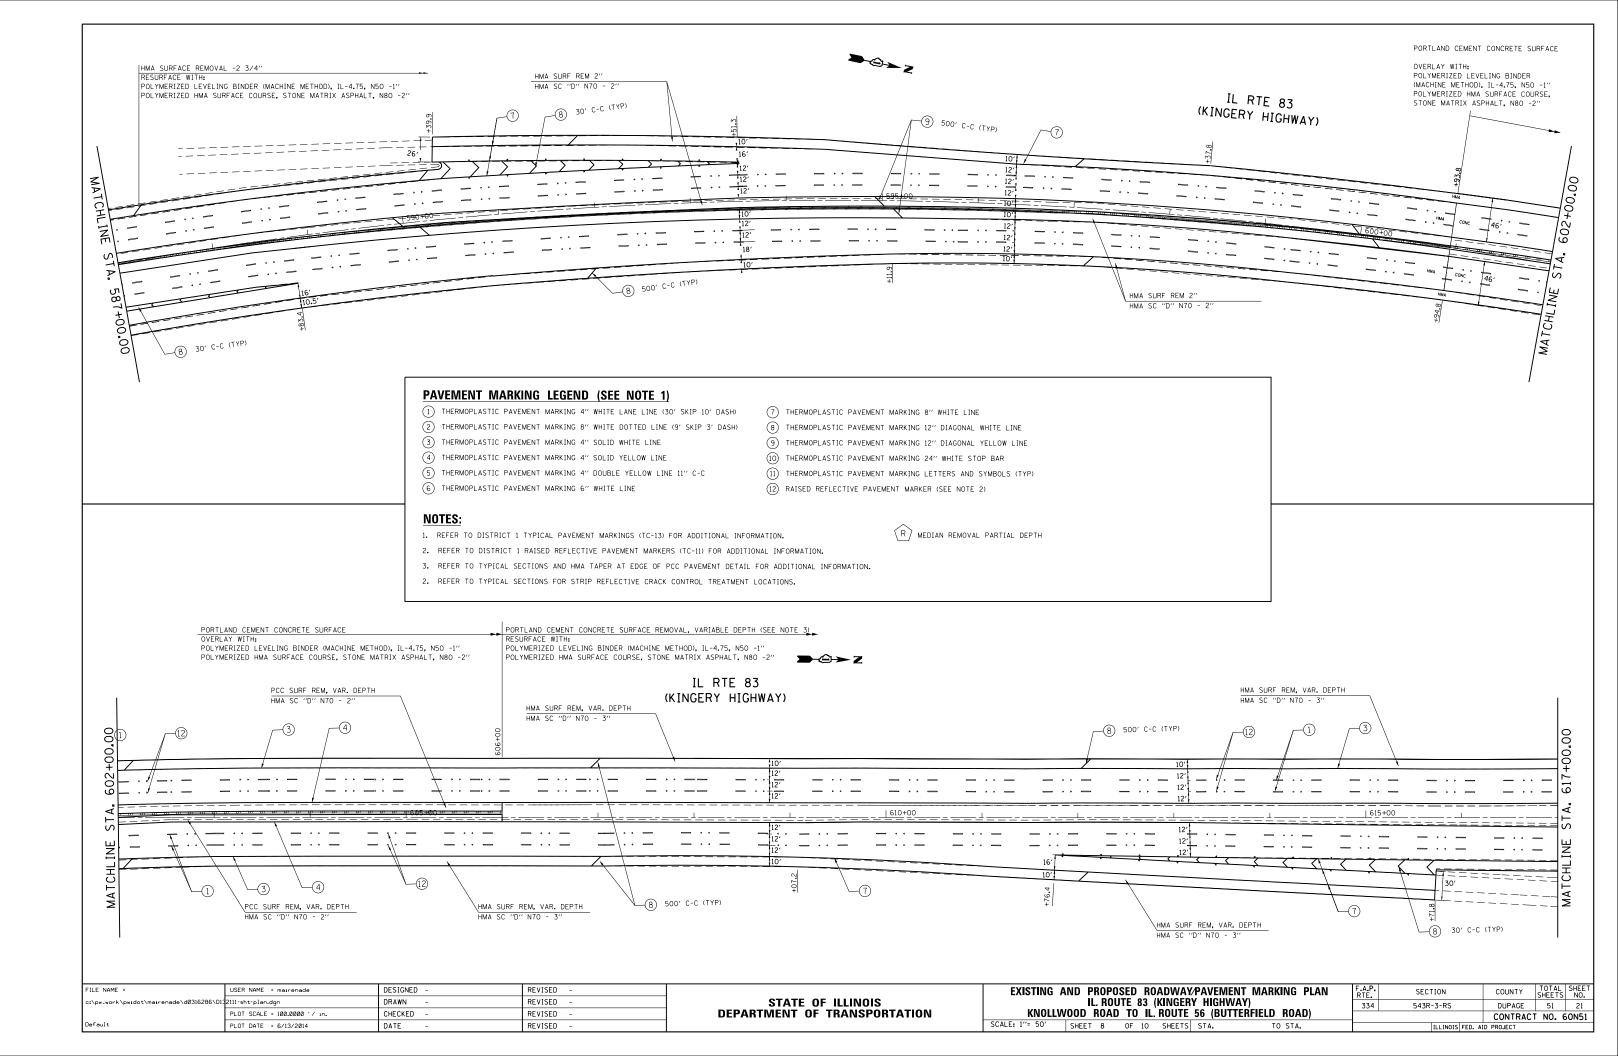

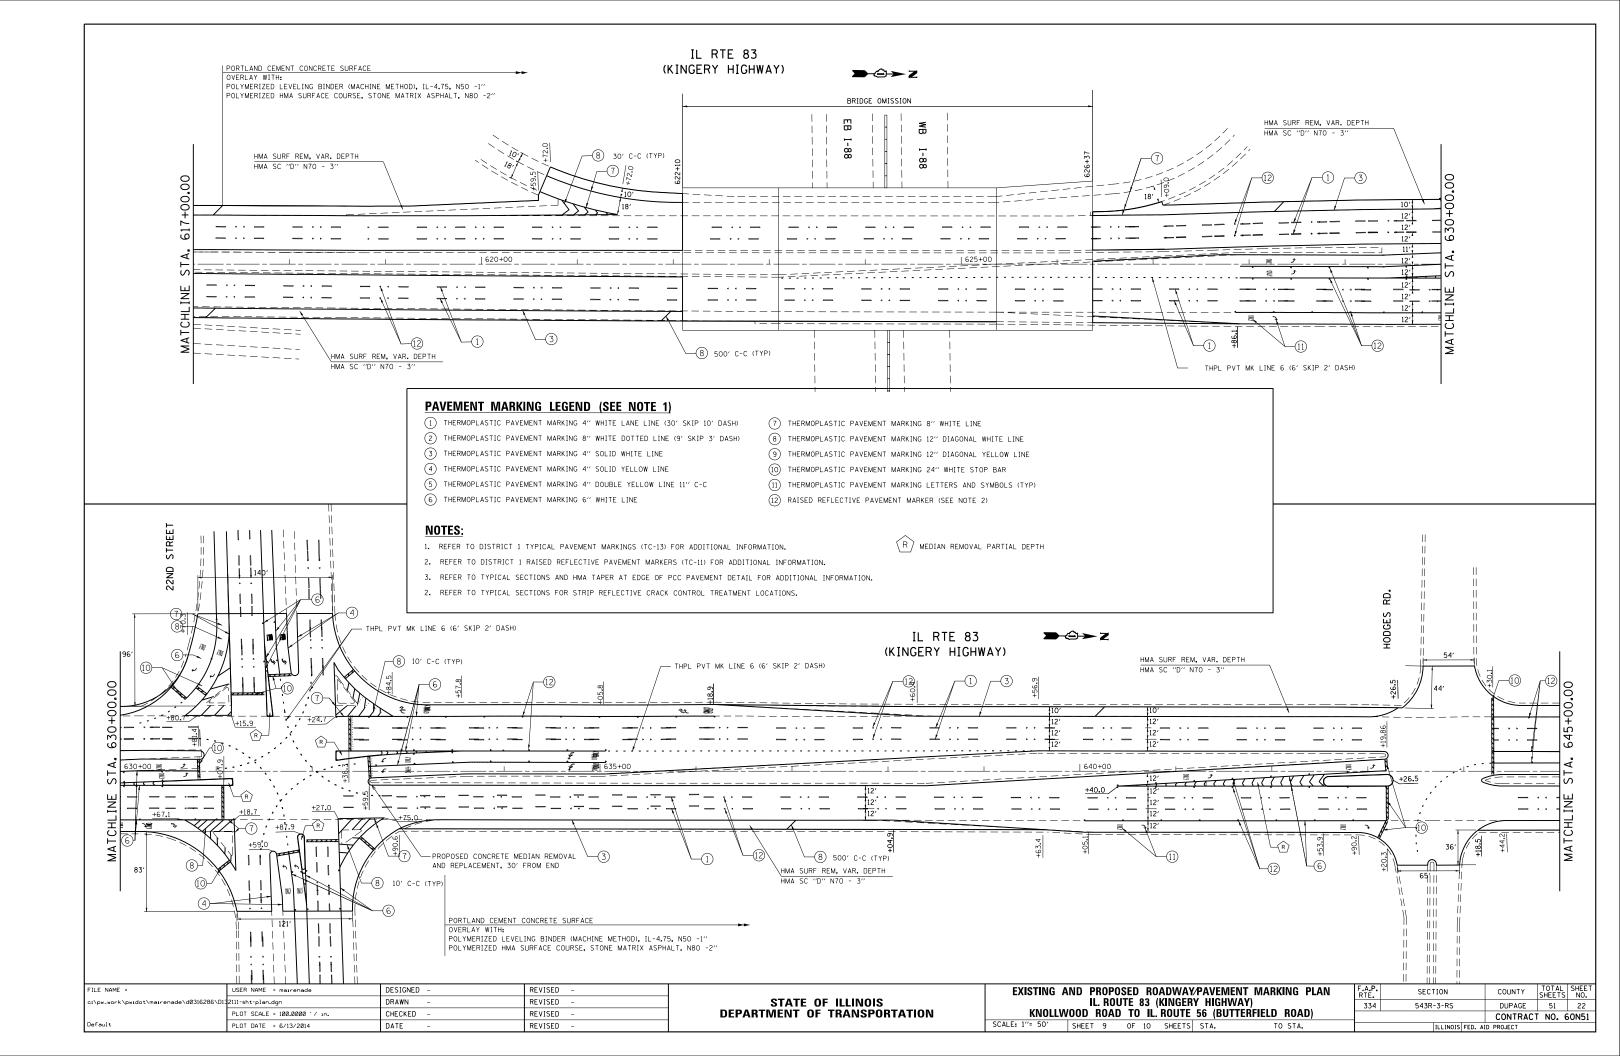

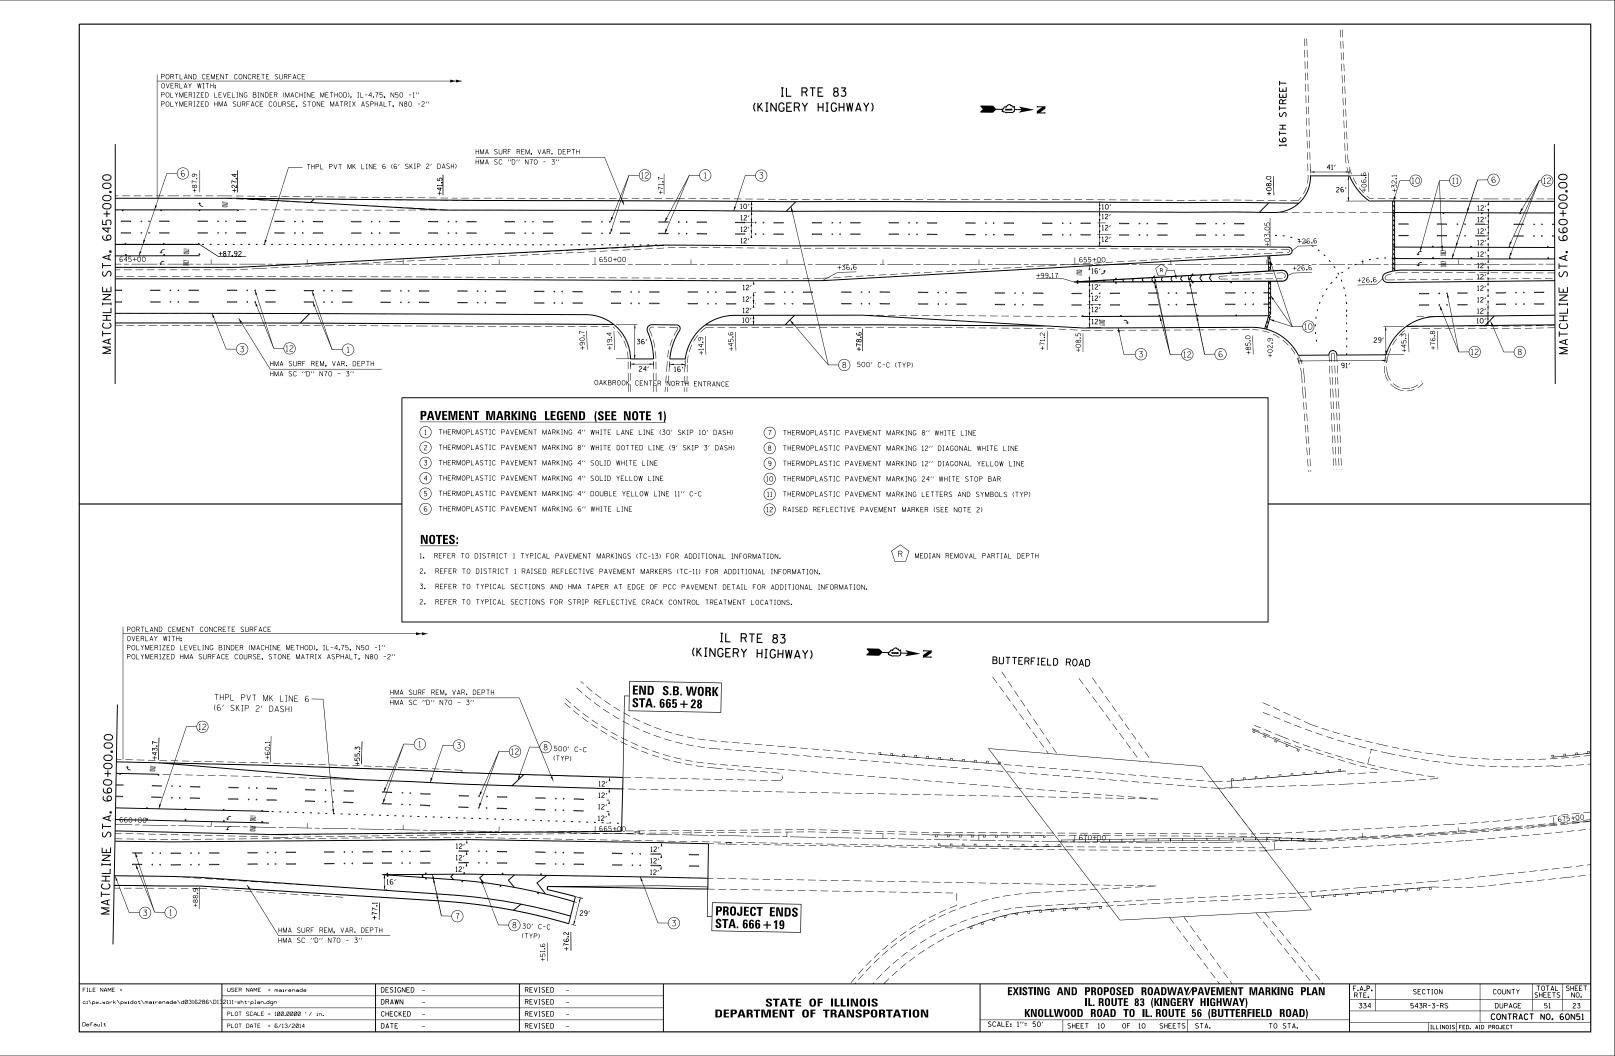

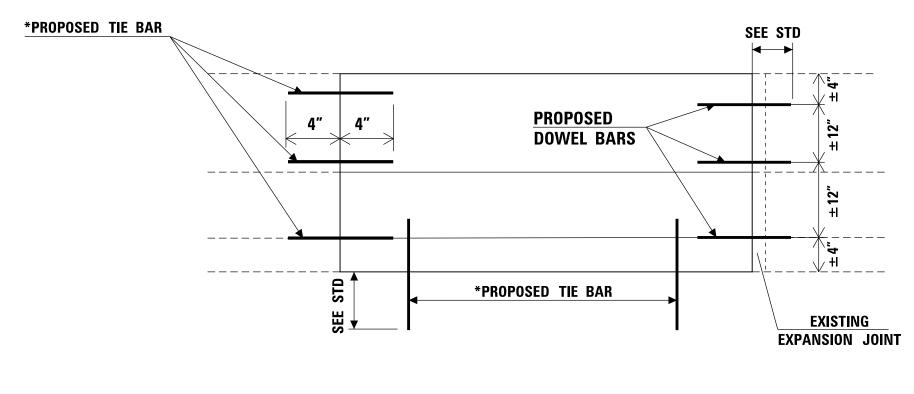


FULL DEPTH REPAIR

NOTE:


ALL BARRIER WALL REPAIR SHALL BE COMPLETED IN ACCORDANCE WITH STATE STANDARDS 637001 AND 637006 AND SECTION 637 OF THE STANDARD SPECIFICATIONS AND AS SHOWN ON THE PLANS. ALL PROPOSED DOWEL BARS AND TIE BARS SHALL BE DRILLED AND GROUTED IN PLACE. REINFORCEMENT SHALL BE INCLUDED AS SHOWN IN STANDARDS 637001 AND 637006 AND DESCRIBED IN SECTION 637 OF THE STANDARD SPECIFICATIONS EXCEPT WHEN A REINFORCEMENT CAGE IS ENCOUNTERED. IN SUCH A CASE, THE CONTRACTOR SHALL REMOVE THE DAMAGED PORTIONS OF THE CAGE AND SHALL REPLACE IT WITH BARS OF THE SAME SIZE AND SPACING. THE SCOPE OF REPAIR AT EACH LOCATION SHALL BE AS SHOWN ON THE PLANS AND APPROVED BY THE ENGINEER PRIOR TO CONSTRUCTION. *USE #8 EPOXY-COATED TIE BARS, CONFORMING TO ART. 1006.10 OF THE STANDARD SPECIFICATIONS, FOR ALL TIE BARS.

FILE NAME =	USER NAME = mairenade	DESIGNED -	REVISED -		ТҮ	PICAL REP	AIR FOR	FULL D	EPTH (BA	RRIER WALL)	F.A.P.	SECTION	COUNTY	TOTAL SHEET
c:\pw_work\pwidot\mairenade\d0316286\D13	2111-sht-plan.dgn	DRAWN -	REVISED -	STATE OF ILLINOIS		IL. R	OUTE 83	3 (KINGE	RY HIGHW	/AY) [′]	344	543R-3-RS	DUPAGE	51 24
	PLOT SCALE = 100.0000 '/ in.	CHECKED -	REVISED -	DEPARTMENT OF TRANSPORTATION	KNOLI	WOOD RO	AD TO I	IL. ROUT	E 56 (BUT	TERFIELD ROAD)				NO. 60N51
Default	PLOT DATE = 6/13/2014	DATE -	REVISED -		SCALE: N.T.S.	SHEET	OF	SHEET	S STA.	TO STA.		ILLINOIS FED. /		

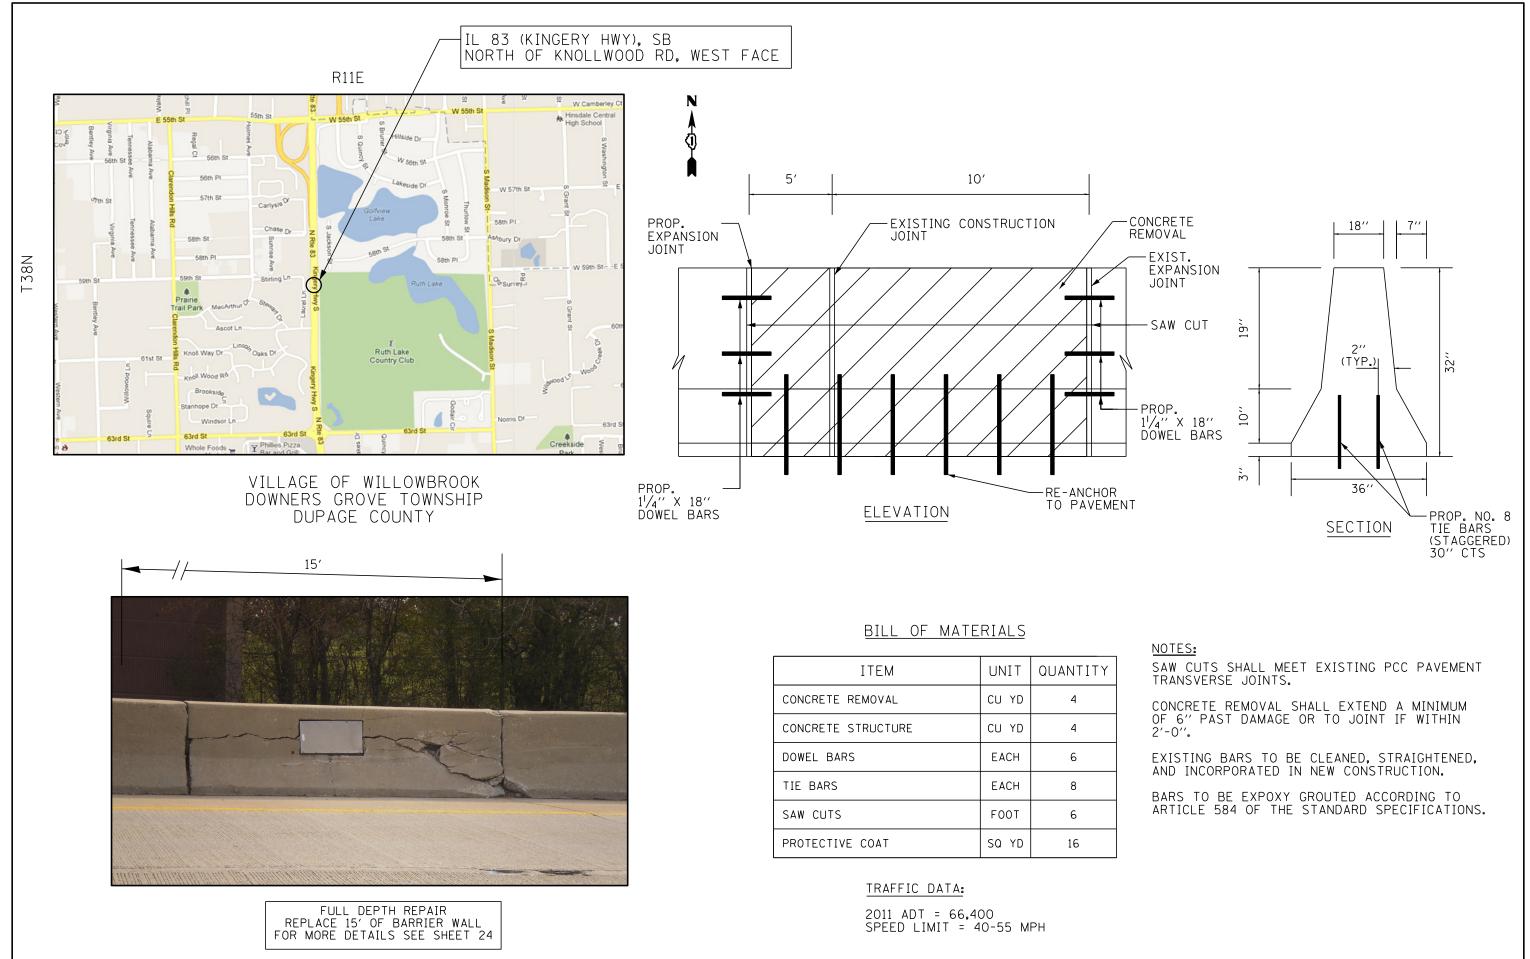

FILE NAME =	USER NAME = mairenade	DESIGNED -	REVISED -		FULL C	EPTH BA	RRIER W	VALL REPAIR	DETAIL ST	TA. 383 + 50	F.A.P.	SECTION	COUNTY	TOTAL SHEET SHEETS NO.
c:\pw_work\pwidot\mairenade\d0316286\D1	2111-sht-plan.dgn	DRAWN -	REVISED -	STATE OF ILLINOIS	IL. ROUTE 83 (KINGERY HIGHWAY) KNOLLWOOD ROAD TO IL. ROUTE 56 (BUTTERFIELD ROAD)			344	543R-3-RS	DUPAGE	51 25			
	PLOT SCALE = 100.0000 ' / 10.	CHECKED -	REVISED -	DEPARTMENT OF TRANSPORTATION	KNOLL	NOOD RO	AD TO	IL. ROUTE 56	(BUTTERFI	IELD ROAD)			CONTRAC	CT NO. 60N51
Default	PLOT DATE = 5/31/2014	DATE –	REVISED -		SCALE: N.T.S.	SHEET	OF	SHEETS ST	Α.	TO STA.		ILLINOIS FED. A	ID PROJECT	

WORK SHALL MEET THE REQUIREMENTS OF THE SPECIAL PROVISION, "TRAFFIC SIGNAL SPECIFICATIONS FOR DETECTOR LOOP REPLACEMENT AND/OR INSTALLATION ON ROADWAY GRINDING, RESURFACING AND PATCHING OPERATIONS". SPECIAL ATTENTION MUST BE MADE TO THE SECTIONS "INSPECTION OF CONSTRUCTION" AND "DETECTOR LOOP REPLACEMENT" FOR INSTALLATION AND INSPECTION REQUIREMENTS. LOOP REPLACEMENT WORK THAT DOES NOT MEET THE CONTRACT REQUIREMENTS SHALL NOT BE PAID. WORK NECESSARY TO COMPLETE THE LOOP REPLACEMENT WORK MAY BE ASSIGNED BY THE ENGINEER TO IDOT'S ELECTRICAL MAINTENANCE CONTRACTOR (EMC); ALL RELATED COSTS WILL BE THE RESPONSIBILITY OF THE CONTRACTOR.

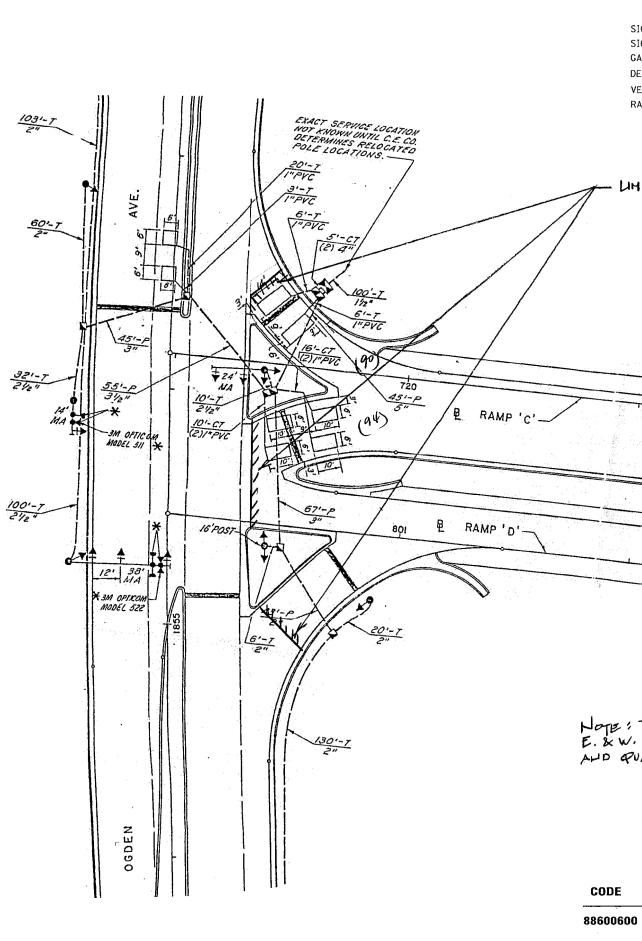

THIS	PLAN	IS FOR	THE SOLE PURPOSE OF
DE	TECTOR	LOOP	REPLACEMENTS ONLY

FILE NAME =	USER NAME = mairenade	DESIGNED -	REVISED -		DETECTOR LOOP REPLACEMENT	F.A.P.	SECTION	COUNTY TOTAL SHEET
c:\pw_work\pwidot\mairenade\d0316286\D13	2111-sht-plan.dgn	DRAWN -	REVISED -	STATE OF ILLINOIS	IL. ROUTE 83 (KINGERY HIGHWAY)	344	543R-3-RS	DUPAGE 51 26
	PLOT SCALE = 100.0000 ' / 10.	CHECKED -	REVISED -	DEPARTMENT OF TRANSPORTATION	KNOLLWOOD ROAD TO IL. ROUTE 56 (BUTTERFIELD ROAD)			CONTRACT NO. 60N51
Default	PLOT DATE = 5/31/2014	DATE –	REVISED -		SCALE: SHEET OF SHEETS STA. TO STA.		ILLINOIS FED. AID P	
				1		1	1	


<u>IRAFFIC SIGNAL LEGEND</u>		
	<u>PROPOSED</u>	EXISTING
SIGNAL HEAD WITH BACKPLATE		$+ \triangleright$
SIGNAL HEAD		\neg
GALVANIZED STEEL CONDUIT IN TRENCH OR PUSHED		·
DETECTOR LOOP	· 🔲	
VEHICLE DETECTOR, NON COMPENSATED MAGNETIC TYPE		— ——
RACEWAY FOR MAGNETIC DETECTOR, TYPE I OR TYPE II		с <u>т</u> "Е"

LINT OF RESURFACING



NOTE: THIS PLAN IS TO BE USED FOR U.S. 34 @ E. & W. RAMPS THE LOOP REPLACEMENTS ARE SIMILAR AND QUANTITIES SAME


BOTH E. & W. РАМР ЮОРG, ШМП'S АТ.
БАСН LOCATION WH BE TOO U.G. 34 E.O.P.REPLACE ALL DETECTOR LOOPS AS SHOWN
(WITHIN THE RESURFACING LIMITS)
QUANTITYO #184(2)=368FOOTD #184(2)=368FOOT

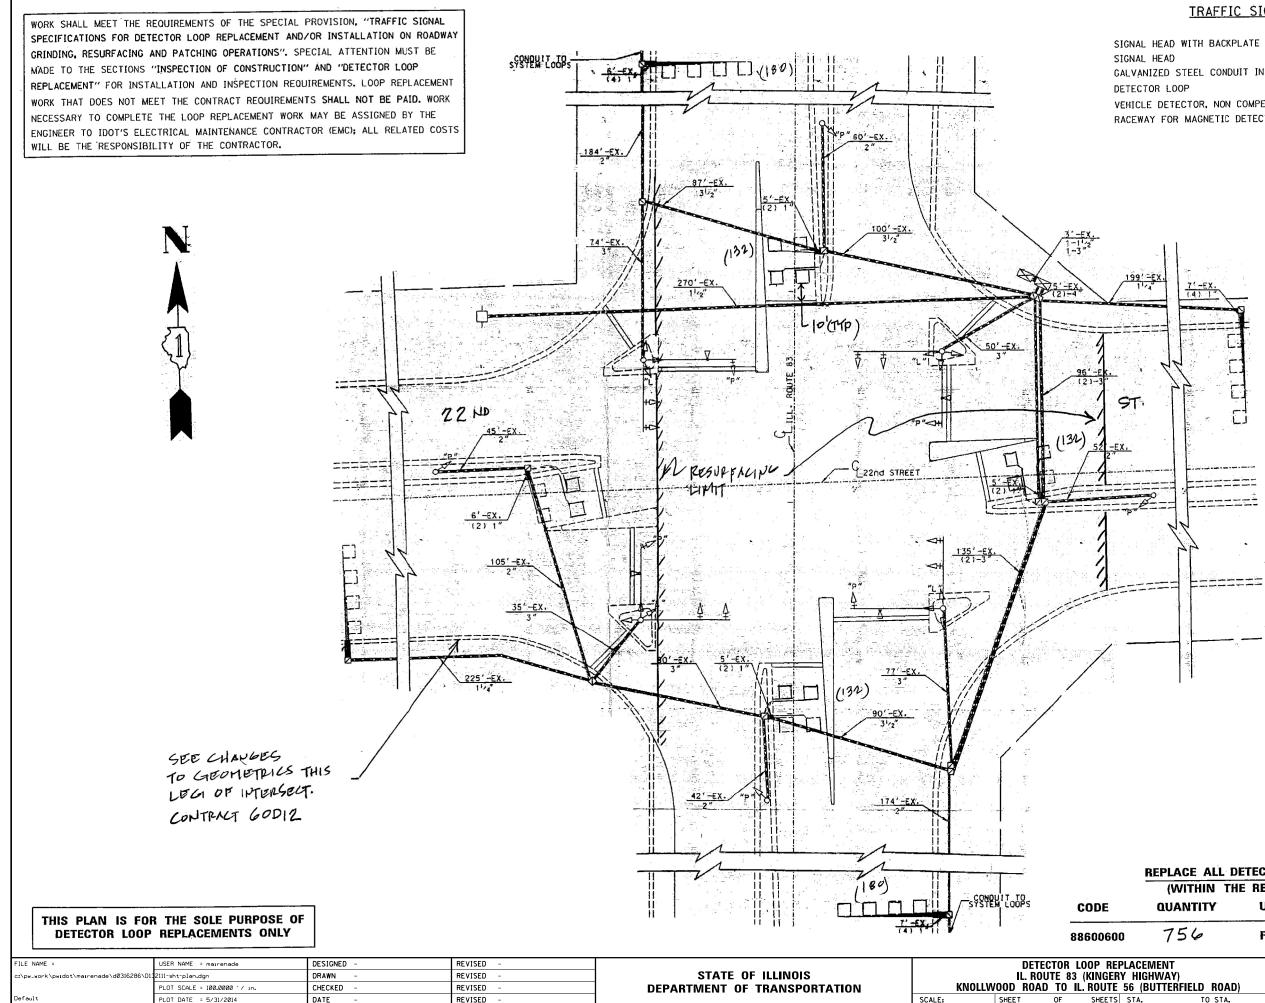

PROPOSED	EXISTING
	\rightarrow
	-12
	<u> </u>
	5
	
I	шт "E"

	REPLACE ALL DETECTOR LOOPS AS SHOWN										
	(WITHIN TH	IE RESURFACING	LIMITS)								
	QUANTITY	UNIT		ITEM							
00 756		FOOT	DETECTOR	LOOP, REPL	ACEM	ent					
REPLAC		F.A.P. RTE.	SECTION	COUNTY	TOTAL SHEETS	SHEET NO.					
		344	543R-3-RS	DUPAGE	51	27					
E 56 (BUTTERFIELD ROAD	η		CONTRACT	「 NO. 6	50N51					

	QUANTITY	UNI	Т		EM		
601	0 756	F00	T	DETECTOR LO	OP, REPL	ACEM	ENT
	PLACEMENT		F.A.P. RTE.	SECTION	COUNTY	TOTAL SHEETS	SHEET NO.
	Y HIGHWAY)		344	543R-3-RS	DUPAGE	51	27
	56 (BUTTERFIELD ROAD)				CONTRACT	NO. 6	50N51
TS	STA. TO STA.			ILLINOIS FED. A	ID PROJECT		

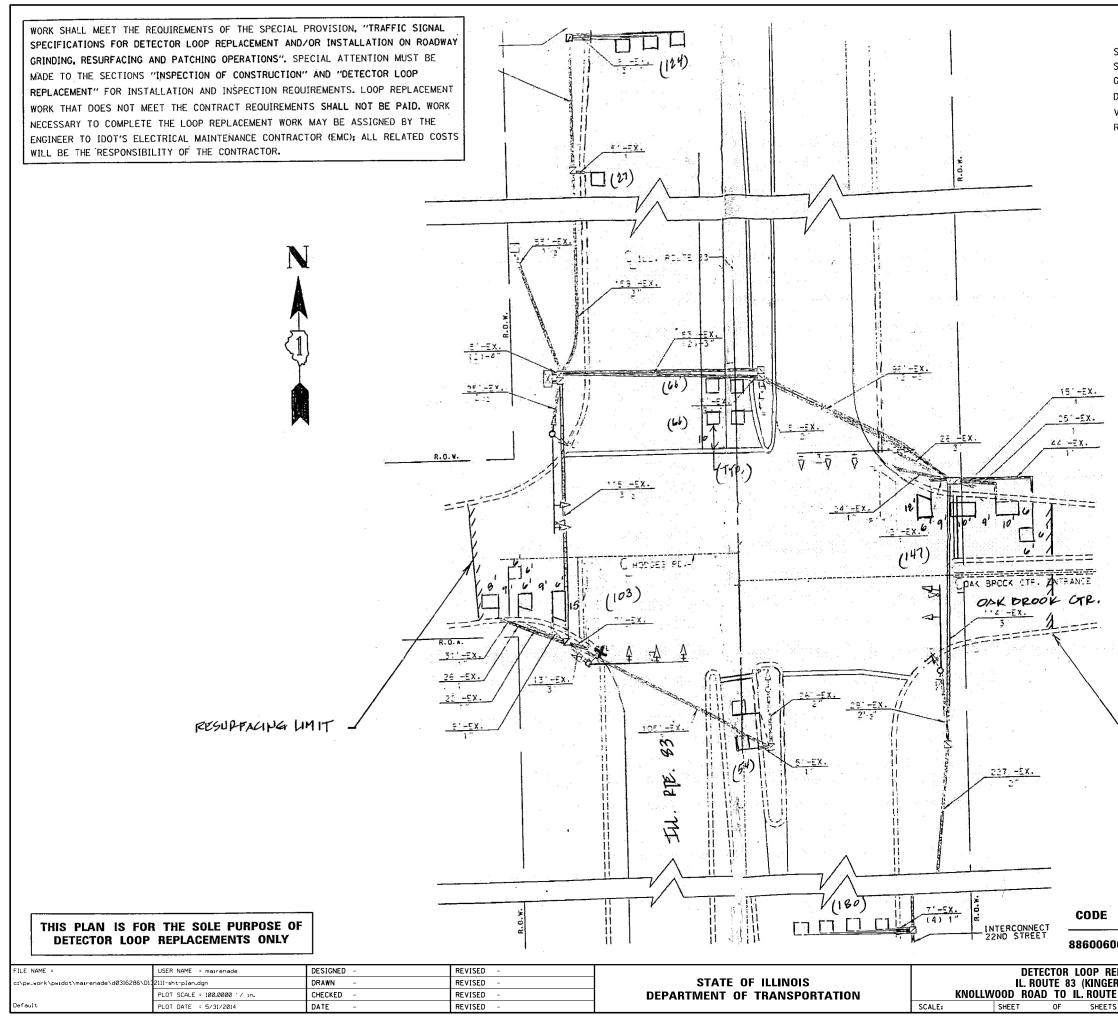


TRAFFIC SIGNAL LEGEND		
· · · ·	PROPOSED	EXISTING
SIGNAL HEAD WITH BACKPLATE		$+ \triangleright$
SIGNAL HEAD		\rightarrow
GALVANIZED STEEL CONDUIT IN TRENCH OR PUSHED		
DETECTOR LOOP		5
VEHICLE DETECTOR, NON COMPENSATED MAGNETIC TYPE		
RACEWAY FOR MAGNETIC DETECTOR, TYPE I OR TYPE II		└──── "E"
		<i>(</i> -

RESURPACING LIMIT

REPLACE ALL DETECTOR LOOPS AS SHOWN (WITHIN THE RESURFACING LIMITS)


-	QUANTITY	UNIT		ITEM				
00	0 646 FOOT DETECTOR LOOP, REPLACEM						ENT	
	PLACEMENT		F.A.P. RTE.	SECTION	COUNTY	TOTAL SHEETS	SHEET NO.	
	RY HIGHWAY)		344	543R-3-RS	DUPAGE	51	28	
_	56 (BUTTERFIELD ROAD)	U) CONTRACT NO. 60N				50N51		
٢S	STA. TO STA.			ILLINOIS FED. A	ID PROJECT			

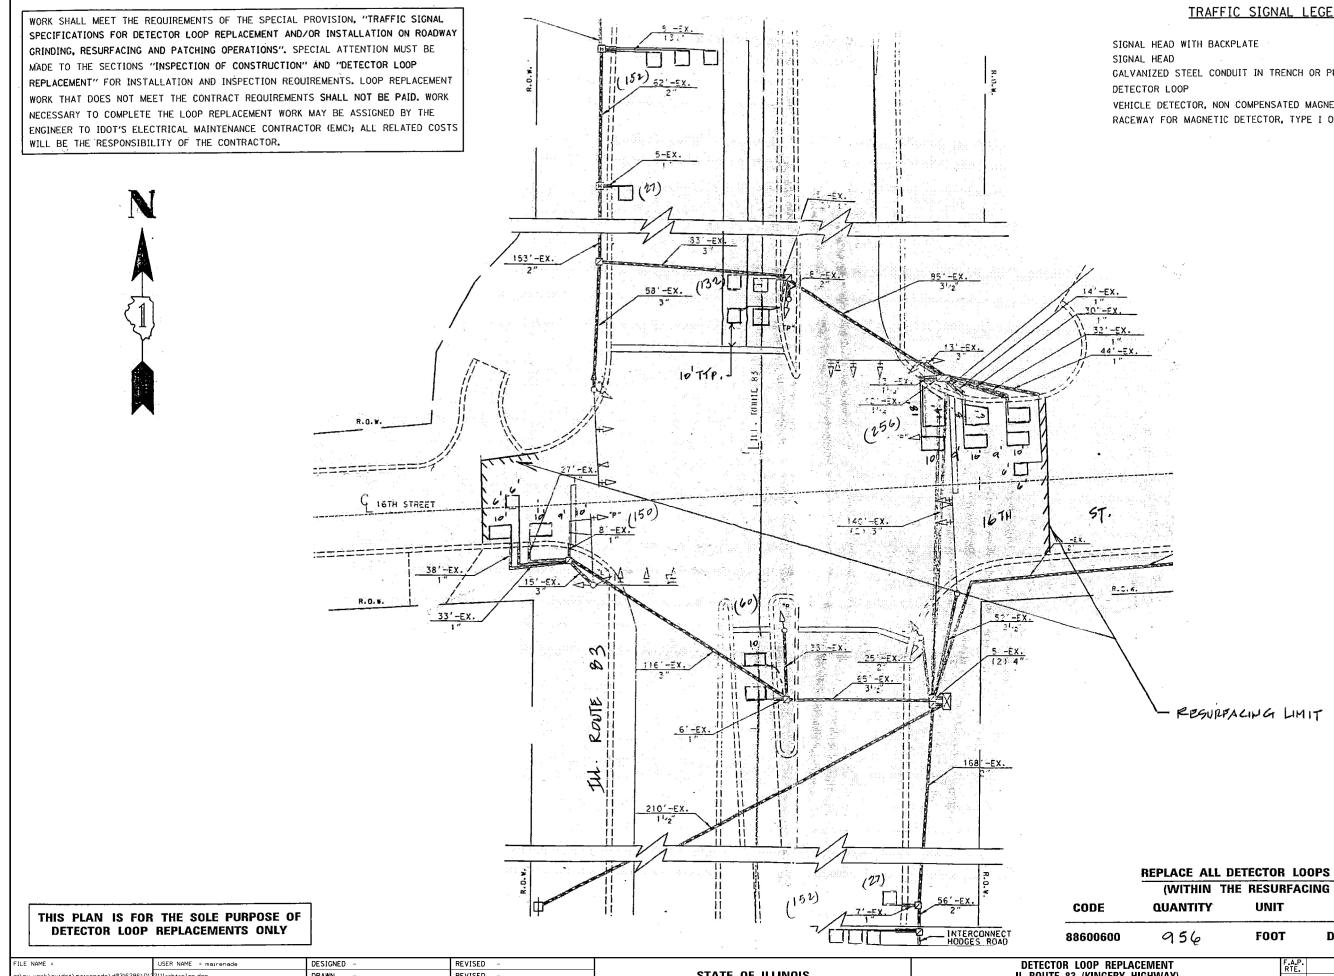

FILE NAME =	USER NAME = mairenade	DESIGNED -	REVISED –			DETEC	CTOR LO	00P RE
c:\pw_work\pwidot\mairenade\d0316286\D13	2111-sht-plan.dgn	DRAWN -	REVISED -	STATE OF ILLINOIS		IL. ROU		(KINGEI
	PLOT SCALE = 100.0000 ' / in.	CHECKED -	REVISED -	DEPARTMENT OF TRANSPORTATION	KNOLLW	OOD ROAD	TO IL	ROUTE
Default	PLOT DATE = 5/31/2014	DATE –	REVISED -		SCALE:	SHEET	OF	SHEETS


TRAFFIC SIGNAL LEGEND		
	PROPOSED	EXISTING
SIGNAL HEAD WITH BACKPLATE		$+ \triangleright$
SIGNAL HEAD		>
GALVANIZED STEEL CONDUIT IN TRENCH OR PUSHED		
DETECTOR LOOP		
VEHICLE DETECTOR, NON COMPENSATED MAGNETIC TYPE		— —-
RACEWAY FOR MAGNETIC DETECTOR, TYPE I OR TYPE I		□ "E"
		6

	REPLACE ALL DETECTOR LOOPS AS SHOWN (WITHIN THE RESURFACING LIMITS)								
	QUANTITY	UNIT		ITEM					
00	956	FOOT	DETEC	TOR LOOP, REPL	Acement				
	ACEMENT	F./ RT	A.P. SECTI	ON COUNTY	TOTAL SHEET SHEETS NO.				
	ERY HIGHWAY) TE 56 (BUTTERFIELD ROAD)		44 543R-3		51 29				
	TA. TO STA.	′			T NO. 60N51				
13 3	TA. 10 STA.			LLINOIS FED. AID PROJECT					

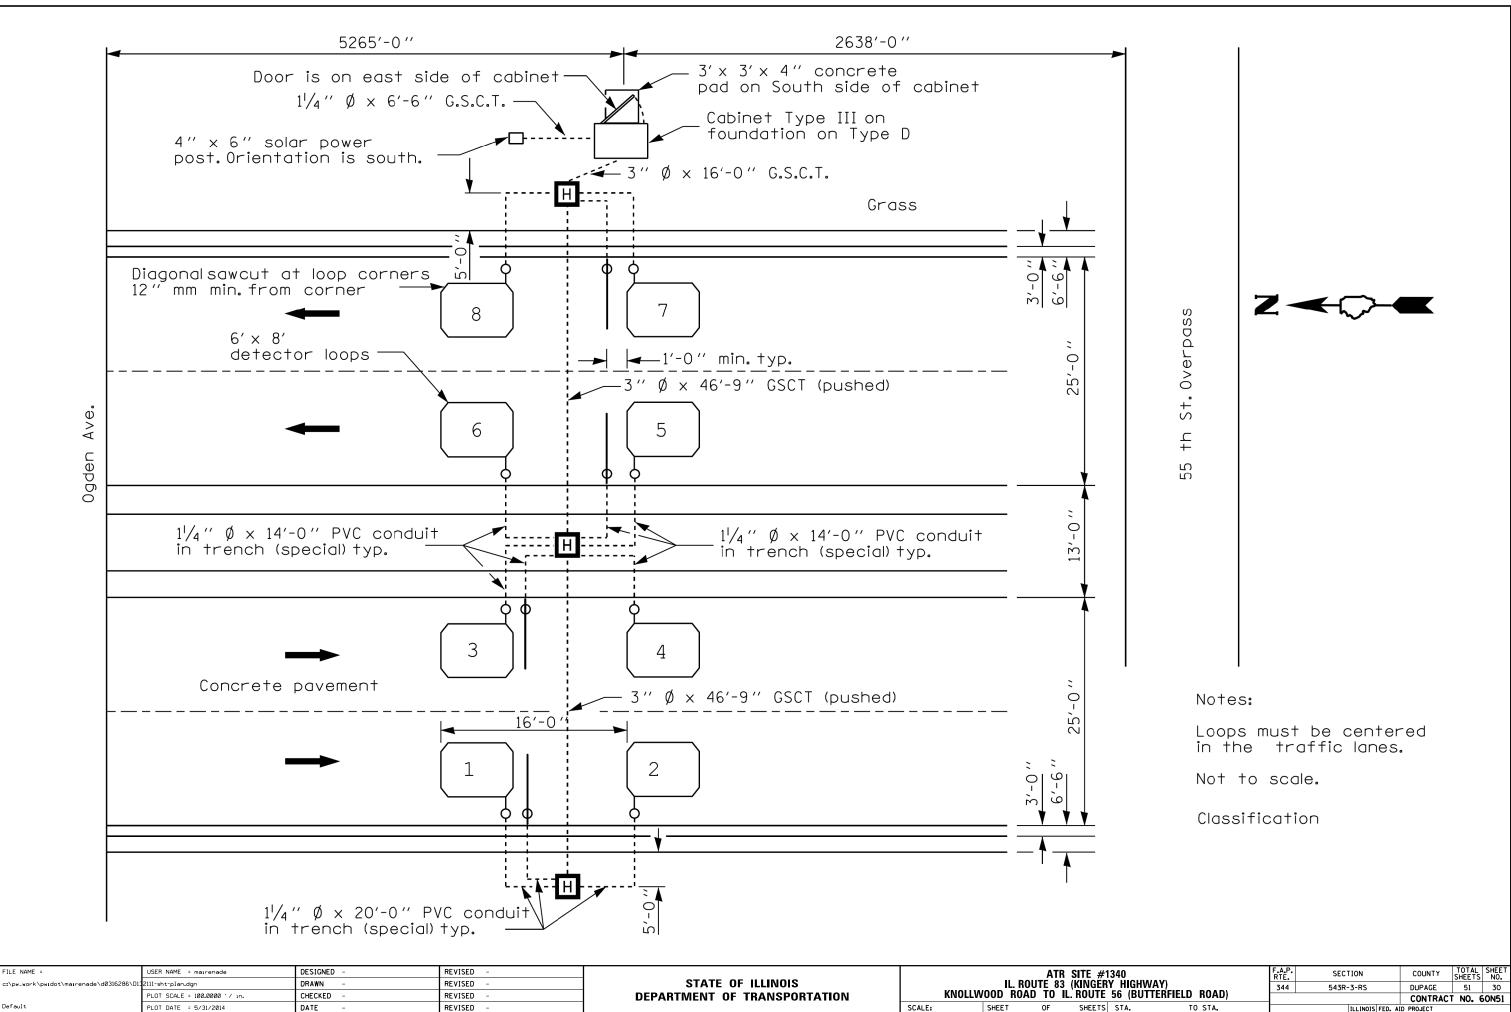


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JIE	20 (BUITERFIEL	D KUAD)		CONTRACT I
ETS	STA.	TO STA.	ILLINOIS FED. A	ID PROJECT

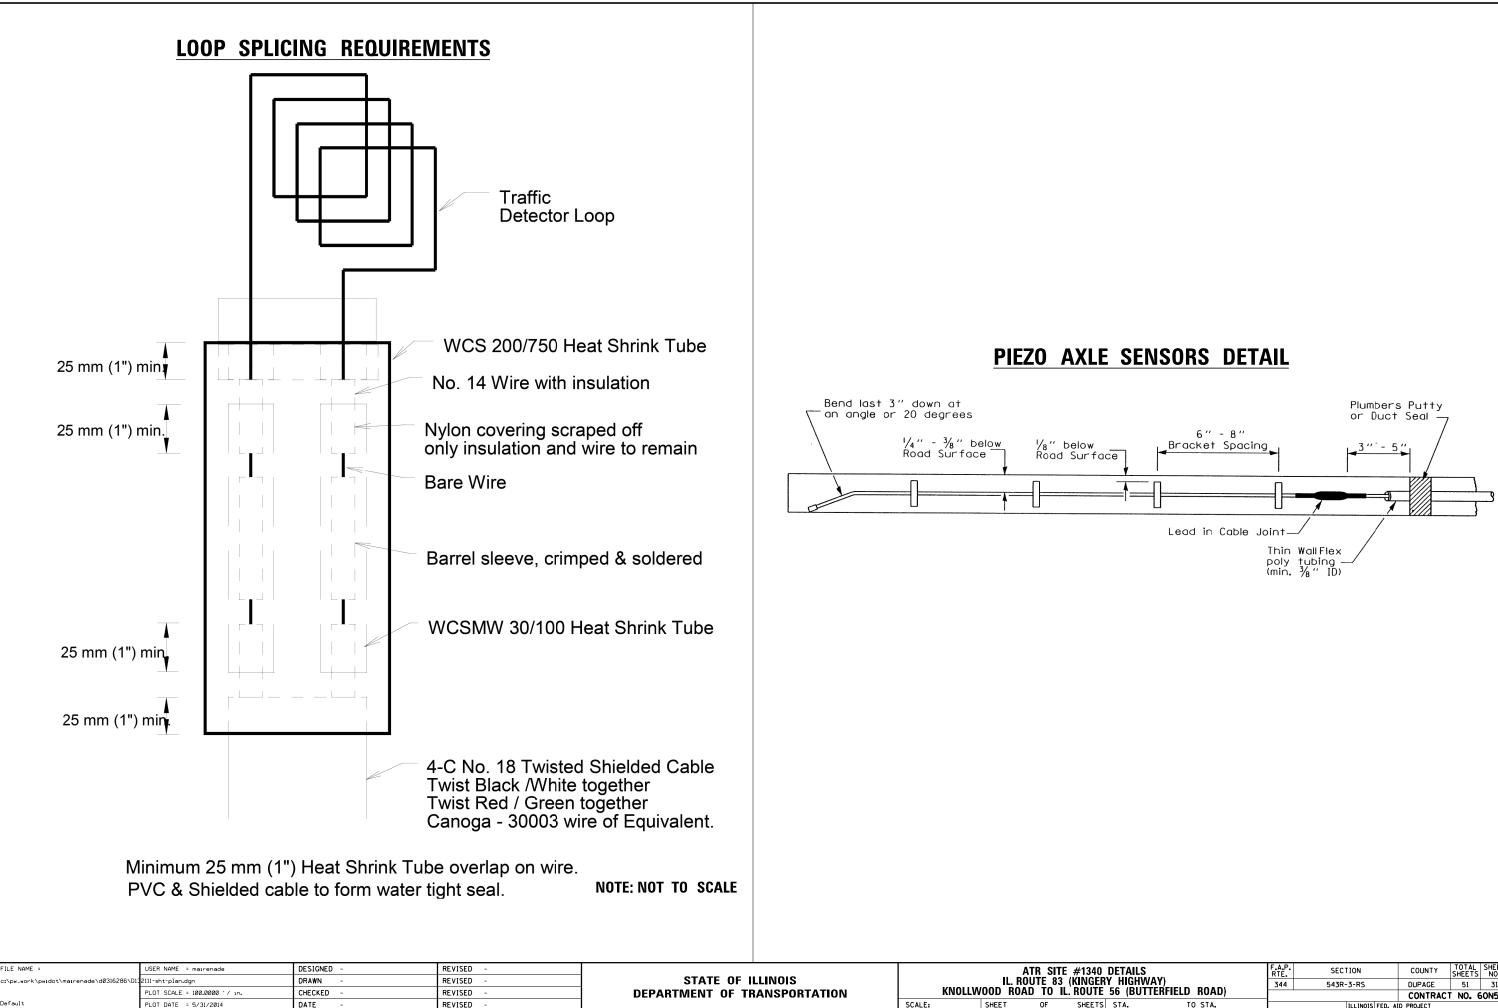

	DETAILS		F.A.P. RTE.	SECTION	COUNTY	TOTAL SHEETS	SHEET NO.		
						31			
IE,	E 56 (BUTTERFIELD ROAD)				CONTRACT	T NO. 6	50N51		
TS	STA.	TO STA.		ILLINOIS FED. AID PROJECT					

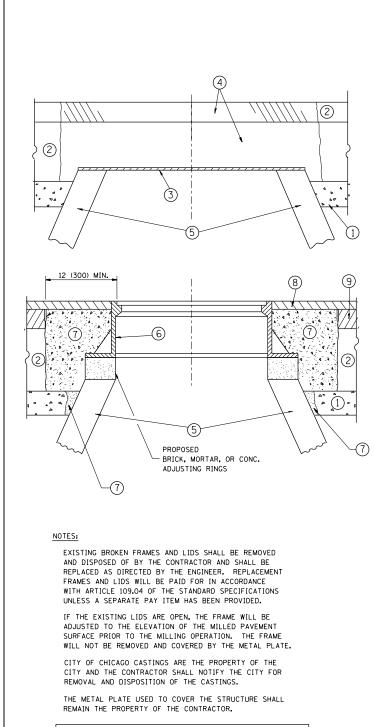

WHEN STRUCTURES ARE TO BE ADJUSTED OR RECONSTRUCTED, THE LOWERING AND RAISING OF THE FRAMES AND LIDS WILL NOT BE PAID FOR SEPARATELY BUT WILL BE INCLUDED IN THE COST OF THE CORRESPONDING PAY ITEM.

DETAILS FOR FRAMES AND LIDS ADJUSTMENT WITH MILLING

FILE NAME =	USER NAME = mairenade	DESIGNED - R. SHAH	REVISED - R. WIEDEMAN 05-14-04			DETAILS FOR	F.A.P.	SECTION	COUNTY	TOTAL SHEET
c:\pw_work\pwidot\mairenade\d0316286	DI32111-sht-plan.dgn	DRAWN -	REVISED - R. BORO 01-01-07	STATE OF ILLINOIS			344	543R-3-RS	DUPAGE	51 32
	PLOT SCALE = 100.0000 '/ in.	CHECKED -	REVISED - R. BORO 03-09-11	DEPARTMENT OF TRANSPORTATION	FRAMES AND LIDS ADJUSTMENT WITH MILLING		B	BD600-03 (BD-8)	CONTRACT	T NO. 60N51
	PLOT DATE = 6/13/2014	DATE - 10-25-94	REVISED - R. BORO 12-06-11		SCALE: NONE SHEET NO.	1 OF 1 SHEETS STA. TO STA.	FED. ROAD		ID PROJECT	

CONSTRUCTION PROCEDURES

STAGE 1 (BEFORE PAVEMENT MILLING)

- A) REMOVE A MINIMUM OF 12 (300) OF THE PAVEMENT FROM AROUND THE STRUCTURE. B) REMOVE THE EXISTING FRAME AND LID FROM THE STRUCTURE.
- C) COVER THE STRUCTURE OPENING WITH A 36 (900) DIAMETER METAL PLATE. D) BACKFILL WITH CRUSHED STONE AND A MINIMUM 1^{\prime}_{2} (40)
- THICK HMA SURFACE MIX APPROVED BY THE ENGINEER.

STAGE 2 (AFTER PAVEMENT MILLING)

- A) REMOVE THE HMA SURFACE MIX AND CRUSHED STONE.
- B) INSTALL THE FRAME AND LID; ADJUST THE FRAME TO ITS FINAL SURFACE ELEVATION.
- C) THE SURROUNDING SPACE SHALL BE FILLED WITH CLASS PP-1* CONCRETE TO THE ELEVATION OF THE SURFACE OF THE EXISTING BASE COURSE OR THE BINDER COURSE.
- * UNLESS OTHERWISE SPECIFIED IN THE PLANS.

THE PROCEDURE EXPLAINED ABOVE SHALL CONFORM TO THE APPLICABLE PORTIONS OF SECTIONS 353, 406, 602, AND 603 OF THE STANDARD SPECIFICATIONS EXCEPT THAT "THE CONTRACTOR SHALL ADJUST THE STRUCTURES TO THE FINISHED PAVEMENT ELEVATION NO MORE THAN 5 CALENDAR DAYS PRIOR TO PLACEMENT OF THE FINAL LIFT OF SURFACE UNLESS APPROVED BY THE ENGINEER."

LEGEND

1	SUB-BASE GRANULAR MATERIAL	6 FRAME AND LID (SEE NOTES)
2	EXISTING PAVEMENT	CLASS PP-1* CONCRETE
3	36 (900) DIAMETER METAL PLATE	(8) PROPOSED HMA SURFACE COURSE
4	PROPOSED CRUSHED STONE AND HMA SURFACE MIX	-
(5)	EXISTING STRUCTURE	9 PROPOSED HMA BINDER COURSE

(5) EXISTING STRUCTURE

LOCATION OF STRUCTURES:

THE CONTRACTOR WILL BE REQUIRED TO KEEP A RECORD OF THE LOCATIONS OF THE BURIED STRUCTURES ACCORDING TO THE STATION AND DISTANCE LEFT OR RIGHT OF THE CENTERLINE OF PAVEMENT. UPON COMPLETION OF THE WORK, THE CONTRACTOR WILL DELIVER THE RECORD TO THE ENGINEER.


BASIS OF PAYMENT:

REMOVING FRAMES AND LIDS ON DRAINAGE AND UTILITY STRUCTURES IN THE PAVEMENT PRIOR TO MILLING, AND ADJUSTING TO FINAL GRADE PRIOR TO PLACING THE SURFACE COURSE, WILL BE PAID FOR AT THE CONTRACT UNIT PRICE EACH FOR "FRAMES AND LIDS TO BE ADJUSTED (SPECIAL)."

THIS WORK WILL NOT BE PAID FOR WHEN DRAINAGE AND UTILITY STRUCTURES ARE SPECIFIED FOR PAYMENT AS STRUCTURE RECONSTRUCTION.

NEW FRAMES AND LIDS, WHEN SPECIFIED, WILL BE PAID FOR SEPARATELY.

ALL DIMENSIONS	ARE IN	INCHES	(MILLIMETERS)	UNLESS	OTHERWISE	SHOWN
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FILE NAME =	USER NAME = mairenade	DESIGNED - R. SHAH	REVISED - A. ABBAS 04-27-98			PAVEMENT PATCHING FOR		F.A.P. SECTION	COUNTY TOTAL SHEET SHEETS NO.
c:\pw_work\pwidot\mairenade\d0316286\D132111-sht-plan.dgn		DRAWN -	REVISED - R. BORO 01-01-07	STATE OF ILLINOIS	HMA SURFACED PAVEMENT			344 543R-3-RS	DUPAGE 51 33
	PLOT SCALE = 100.0000 ' / 10.	CHECKED -	REVISED - R. BORO 09-04-07	DEPARTMENT OF TRANSPORTATION				BD400–04 (BD–22)	CONTRACT NO. 60N51
	PLOT DATE = 6/13/2014	DATE - 10-25-94	REVISED - K. ENG 10-27-08		SCALE: NONE	SHEET NO. 1 OF 1 SHEETS STA.	TO STA.	FED. ROAD DIST. NO. 1 ILLINOIS FED.	AID PROJECT

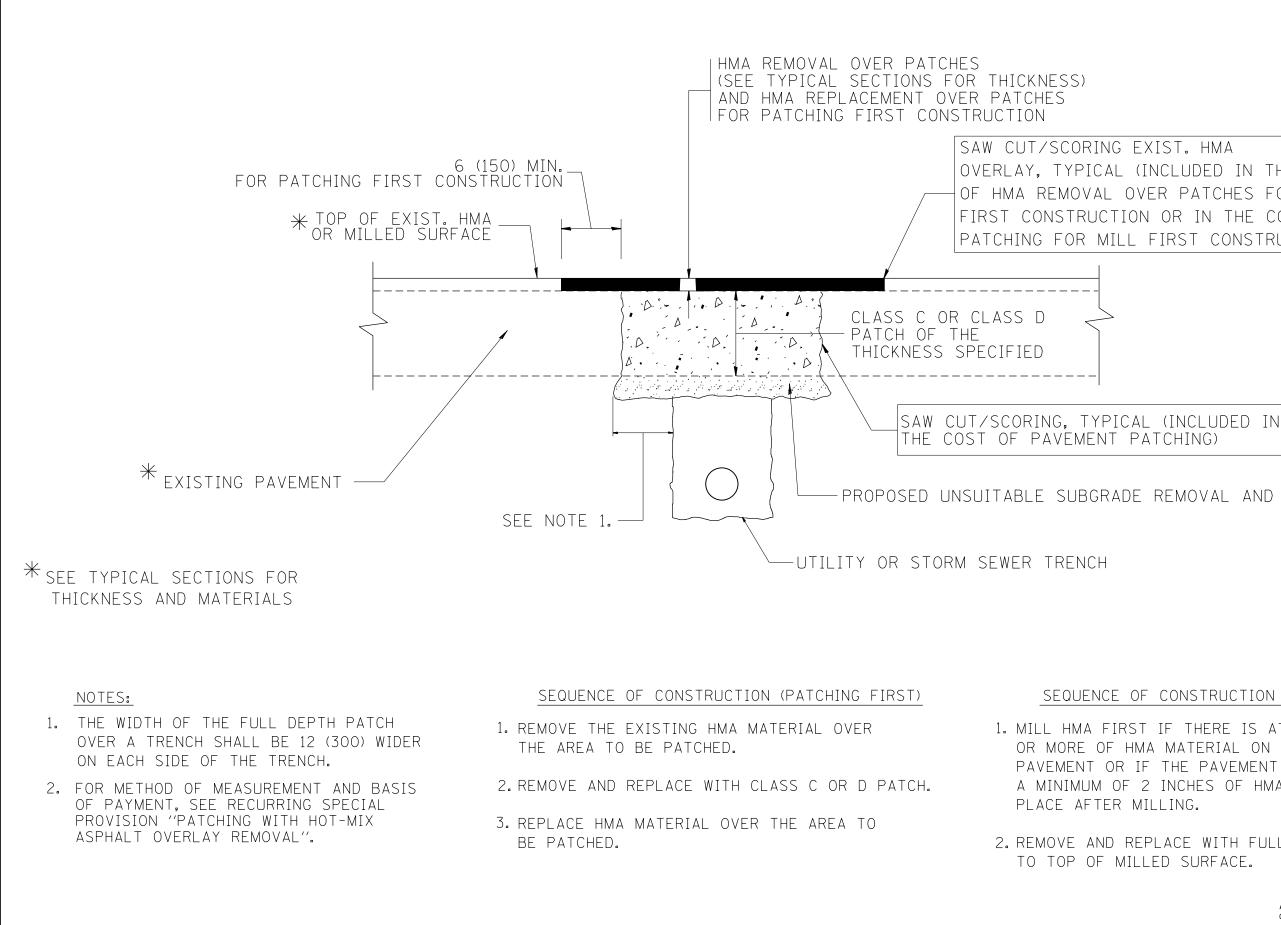OVERLAY, TYPICAL (INCLUDED IN THE COST OF HMA REMOVAL OVER PATCHES FOR PATCHING FIRST CONSTRUCTION OR IN THE COST OF PAVEMENT PATCHING FOR MILL FIRST CONSTRUCTION).


PROPOSED UNSUITABLE SUBGRADE REMOVAL AND REPLACEMENT

SEQUENCE OF CONSTRUCTION (MILLING FIRST)

1. MILL HMA FIRST IF THERE IS AT LEAST $4\frac{1}{2}$ INCHES OR MORE OF HMA MATERIAL ON TOP OF THE EXISTING PAVEMENT OR IF THE PAVEMENT IS FULL DEPTH HMA. A MINIMUM OF 2 INCHES OF HMA MATERIAL SHALL BE IN

2. REMOVE AND REPLACE WITH FULL DEPTH CLASS D PATCHES TO TOP OF MILLED SURFACE.

		DIMENSIONS ARE IN INCHE RWISE SHOWN.	S (MILLIMETERS) UNLES	S
OR	F.A.P. RTE.	SECTION	COUNTY	TOTAL SHEETS	SHEE NO.
				-	

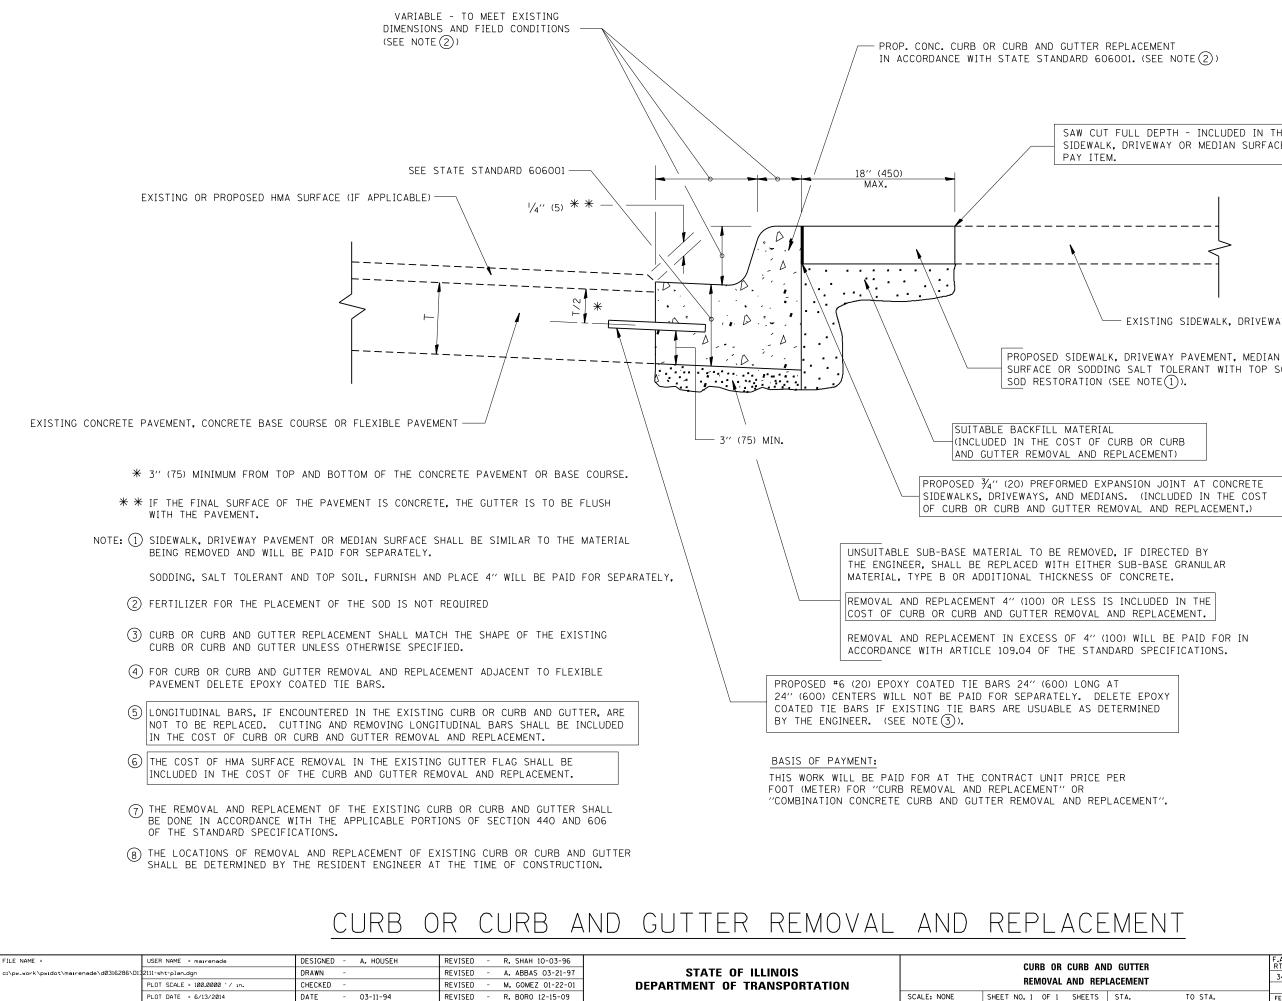


SAW CUT FULL DEPTH - INCLUDED IN THE COST OF SIDEWALK, DRIVEWAY OR MEDIAN SURFACE REMOVAL

EXISTING SIDEWALK, DRIVEWAY, MEDIAN SURFACE, SOD OR GROUND.

SURFACE OR SODDING SALT TOLERANT WITH TOP SOIL, 4" (100)


ALL DIMENSIONS ARE IN INCHES (MILLIMETERS) UNLESS OTHERWISE SHOWN.

ND GUTTER EPLACEMENT		F.A.P. RTE	SECTION	COUNTY	TOTAL SHEETS	SHEET NO.	
		344	543R-3-RS	DUPAGE	51	34	
			BD600-06 (BD-24)	CONTRACT	NO. 6	50N51	
,	STA.	TO STA.	FED. R	DAD DIST. NO. 1 ILLINOIS FED. AI	D PROJECT		

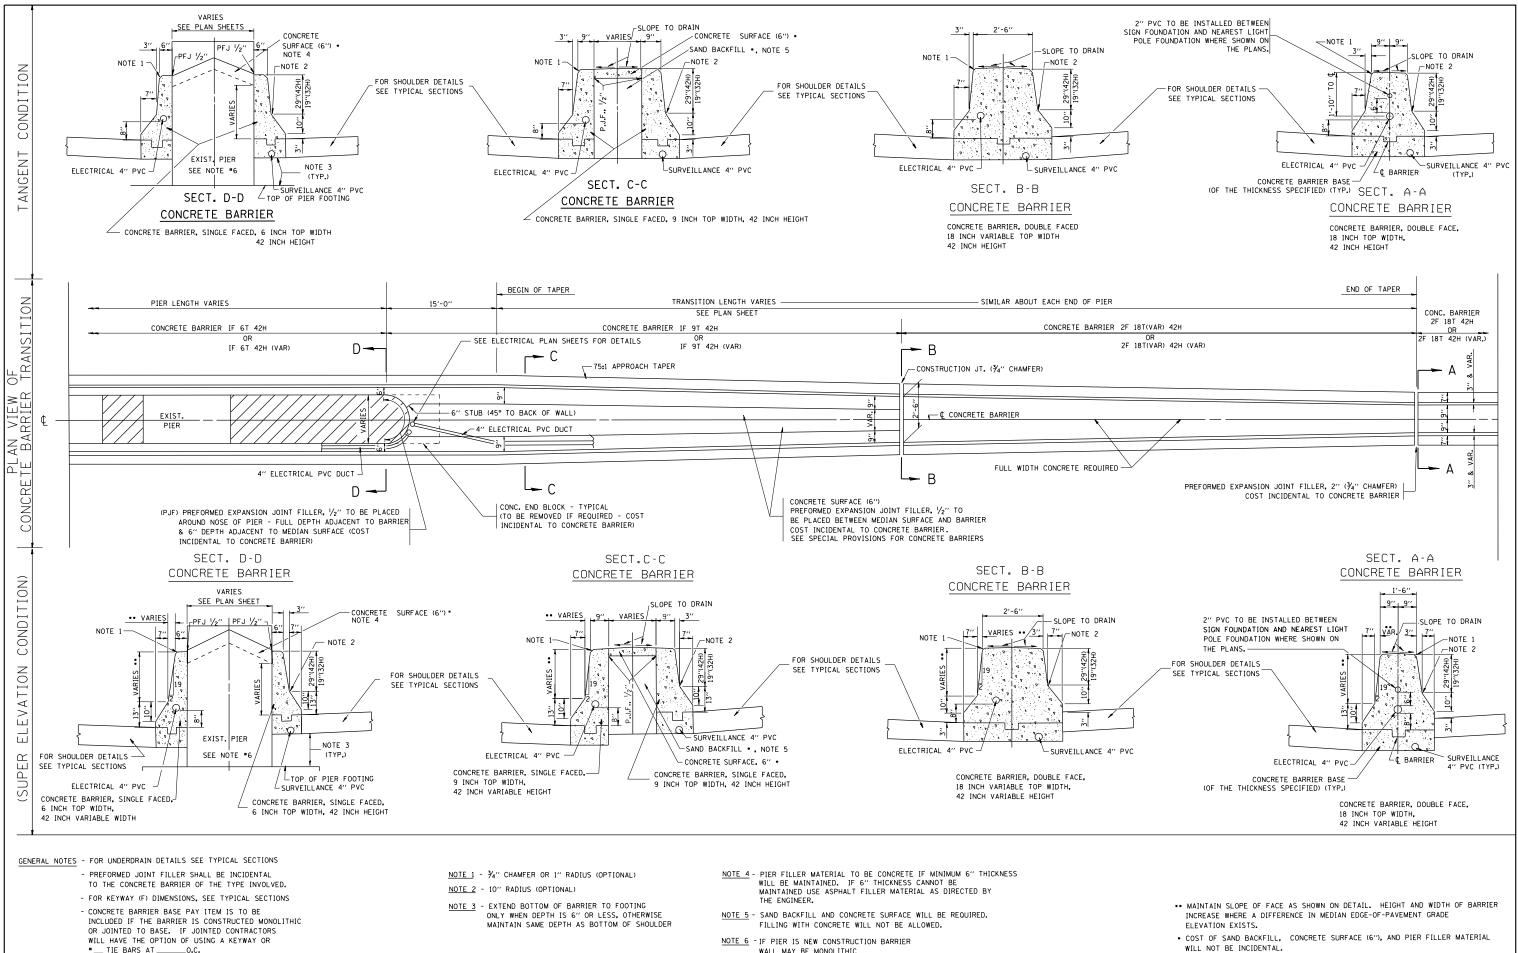

- WALL MAY BE MONOLITHIC


FILE NAME =	USER NAME = mairenade	DESIGNED - FORD	REVISED - FORD 12-06-88			CONCRETE BARRIER TRANSITION &	F.A.P.	SECTION	COUNTY TOTAL SHEET
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		1/ ID. CHECKED - REVISED -	DEPARTMENT OF TRANSPORTATION	GENERAL DETAILS, CONCRETE BARRIER BASE			BD-27	CONTRACT NO. 60N51	
	PLOT DATE = 6/13/2014	DATE - 09-09-88	REVISED -		SCALE: NONE	SHEET NO. 1 OF 1 SHEETS STA. TO STA.	FED. ROA	D DIST. NO. 1 ILLINOIS FED. 4	AID PROJECT

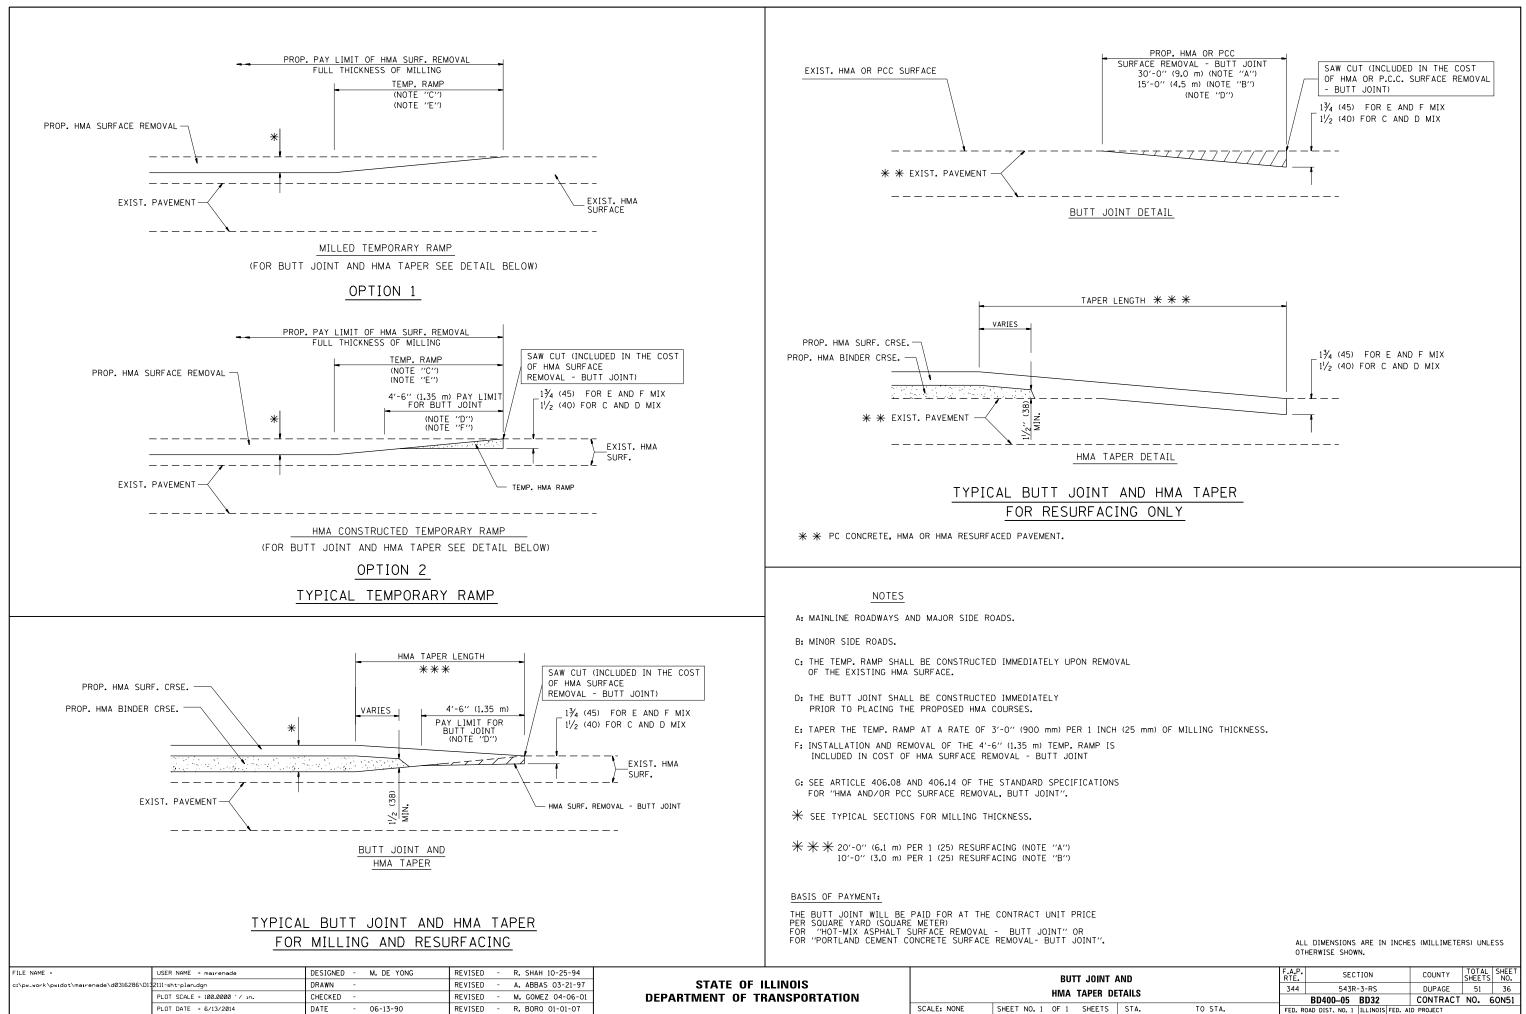


AND DETAILS		F.A.P. RTE	P. SECTION			COUNTY	TOTAL SHEETS	SHEET NO.	
		344	543R-3-RS			DUPAGE	51	36	
		_	BD400-05	BD32		CONTRACT	NO. 6	50N51	
	STA.	TO STA.	FED. R	OAD DIST. NO. 1	ILLINOIS	FED. A	D PROJECT		


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D132111-sht-plan.dgn		DRAWN -	REVISED -	STATE OF ILLINOIS	J BOX EMBEDDED IN BARRIER WALL – INSTALLATION OF CONDUIT IN BRIDGE	344 543R-3-RS	DUPAGE 51 37
	PLOT SCALE = 100.0000 '/ in.	CHECKED -	REVISED -	DEPARTMENT OF TRANSPORTATION	PARAPET EXPANSION JOINT – ELECTRIC CONNECTION TO UNDERPASS LIGHTING	BE-703	CONTRACT NO. 60N51
	PLOT DATE = 6/13/2014	DATE - 01-20-2009	REVISED -		SCALE: NONE SHEET NO. 1 OF 1 SHEETS STA. TO STA.	FED. ROAD DIST. NO. 1 ILLINOIS FED.	AID PROJECT




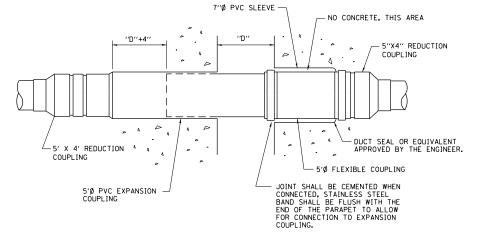

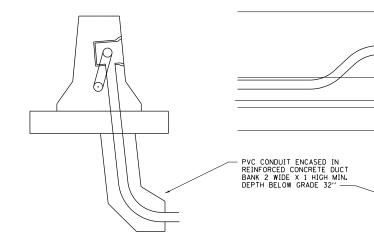


ED - BWD ELECTRIC CONNECTION TO UNDERPASS LIGHTING

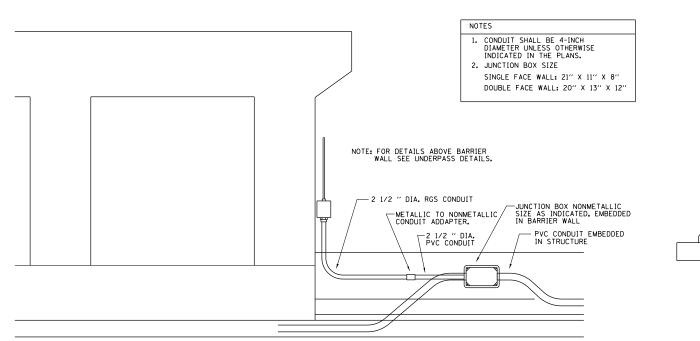

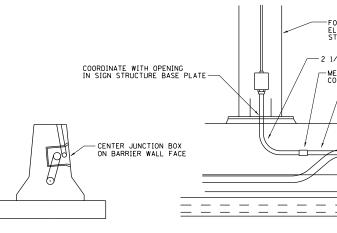



ED - SGN

-FOR DETAILS ON SIGN SEE ELECTRICAL CONNECTION TO SIGN STRUCTURE DETAIL	
2 1/2 " DIA. RGS CONDUIT -METALLIC TO NONMETALLIC CONDUIT ADDAPTER. -2 1/2 " DIA. PVC CONDUIT -2 1/2 " DIA. -2 1/2 " DIA	EDDED
	NOTES 1. CONDUIT SHALI DIAMETER UNLI INDICATED IN 2. JUNCTION BOX

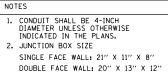

JUNCTION BOX EMBEDDED IN BARRIER WALL FOR SIGN LIGHTING

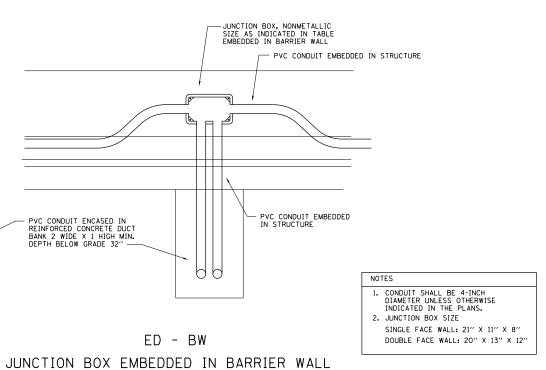

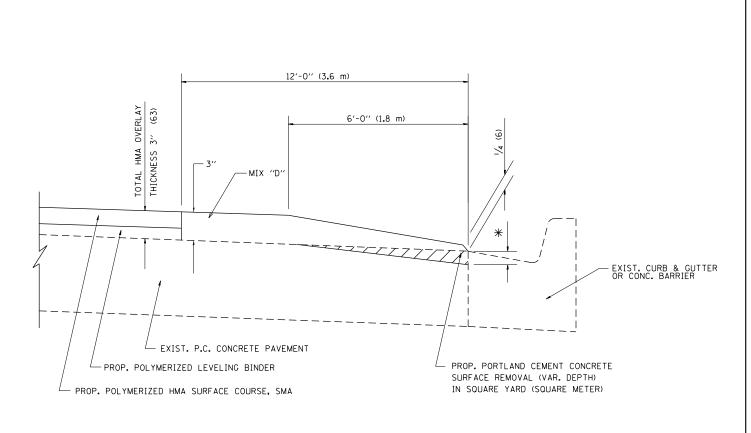


<u>hma taper at</u> EDGE OF P.C.C PAVEMENT

HMA SURFACE		
MIX	THICKNESS	★ MILLING AT GUTTER FLAG
D	3''	2 3/4"


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c:\pw_work\pwidot\mairenade\d0316286\D1	2111-sht-plan.dgn	DRAWN -	REVISED -	STATE OF ILLINOIS							344	543R-3-RS	DUPAGE	51	38
	PLOT SCALE = 100.0000 ' / in.	CHECKED -	REVISED -	DEPARTMENT OF TRANSPORTATION			EDGE UN	P.C.C. P/	VENIENI				CONTRAC	T NO.	30N51
Default	PLOT DATE = 6/13/2014	DATE -	REVISED -		SCALE:	SHEET	OF	SHEETS	STA.	TO STA.		ILLINOIS FED.			

ALL DIMENSIONS ARE IN INCHES (MILLIMETERS) UNLESS OTHERWISE SHOWN.

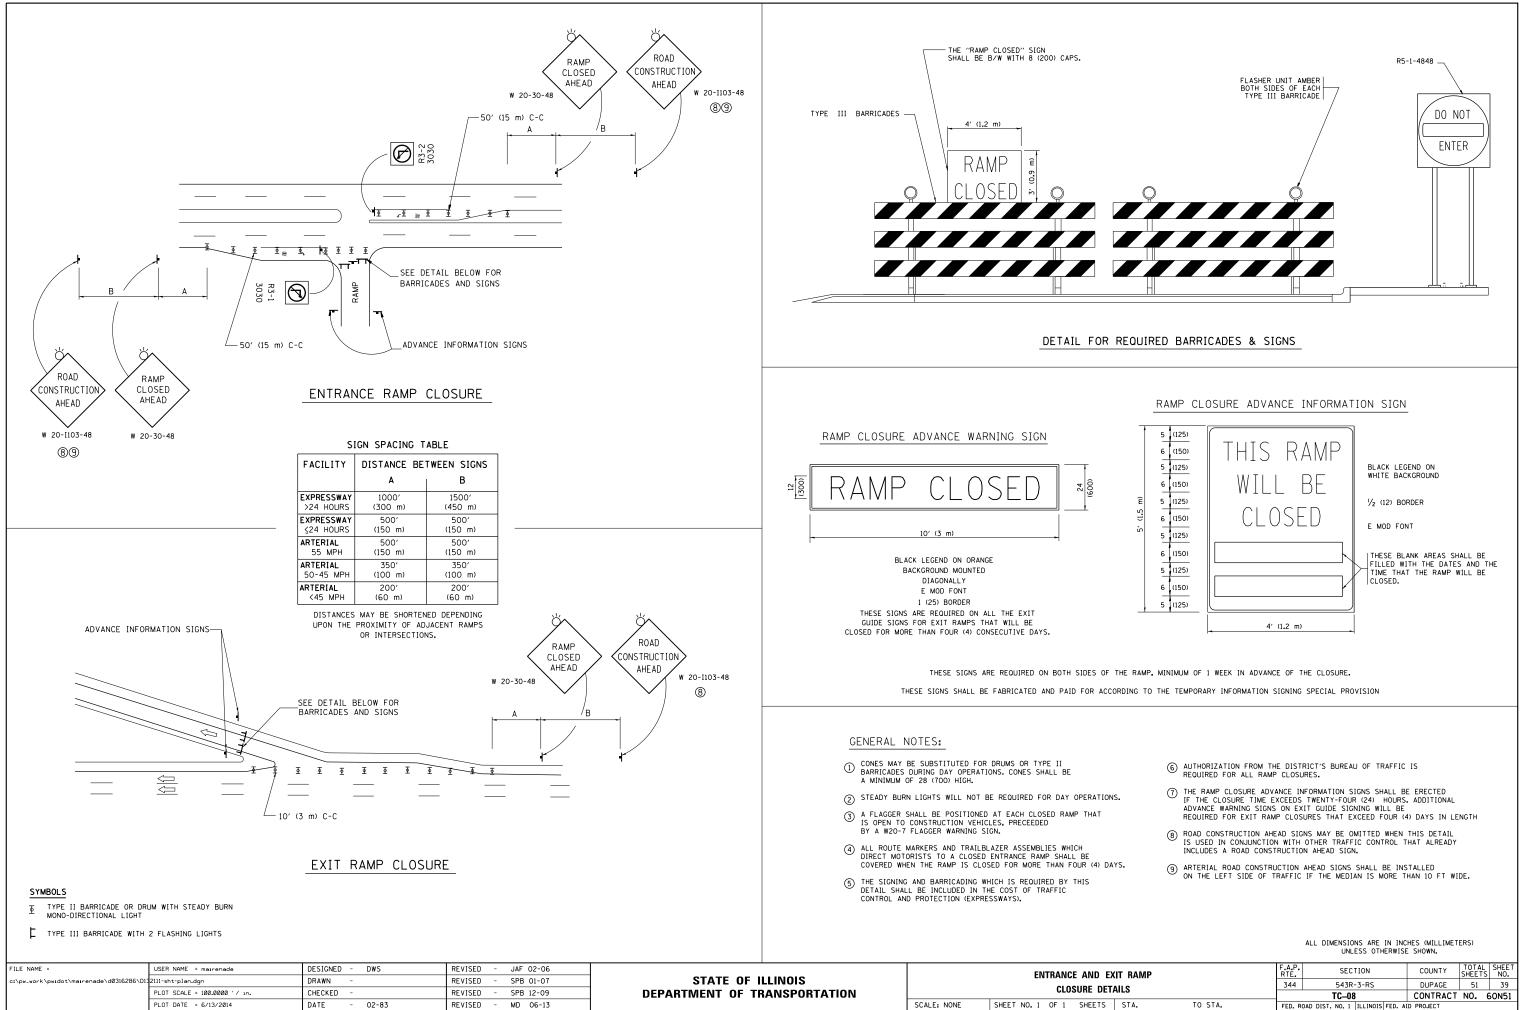

TYPE III BAR WITH TWO FL IS (380) 21 (530) 21 (530) 21 (530) 3 UN HEAD UN HEAD	ASHING ACH. 200 [°]
TRAFFIC CONTROL AND PROTECTION H	FOR
A. FOR NO LANE RESTRICTION ON THE SIDE ROAD OR DRIVEWAYS	
1. SIDE ROAD WITH A SPEED LIMIT OF 40 MPH (60 km/h) OR LESS AS SHOWN ON THE DRAWING AND AS DIRECTED BY THE ENGINEER:	
Q) ONE ROAD CONSTRUCTION AHEAD SIGN 36 x 36 (900x900) WITH A FLA AND FLAG MOUNTED ON IT APPROXIMATELY 200' (60 m) IN ADVANCE OF THE MAIN ROUTE.	SHER
b) THE CLOSED PORTION OF THE MAIN ROUTE SHALL BE PROTECTED BY BLOCKING WITH TYPE I, TYPE II OR TYPE III BARRICADES, 1/3 OF THE CROSS SECTION OF THE CLOSED PORTION.	
2. SIDE ROAD WITH A SPEED LIMIT GREATER THAN 40 MPH (60 km/h) AS SHOWN ON THE DRAWING AND AS DIRECTED BY THE ENGINEER:	
a) ONE ROAD CONSTRUCTION AHEAD SIGN 48 x 48 (1.2 m x 1.2 m) WITH A FLASHER MOUNTED ON IT APPROXIMATELY 500' (150 m) IN ADVANCE OF THE MAIN ROUTE.	
b) THE CLOSED PORTION OF THE MAIN ROUTE SHALL BE PROTECTED BY BLOCKING WITH TYPE III BARRICADES, 1/2 OF THE CROSS SECTION OF THE CLOSED PORTION.	
3. WHEN THE SIDE ROAD LIES BETWEEN THE BEGINNING OF THE MAINLINE SIGNING AND THE WORK ZONE, A SINGLE HEADED ARROW (M6-1) SHALL BE USED IN LIEU OF THE DOUBLE HEADED ARROW (M6-4).	
1	

FILE NAME =	USER NAME = mairenade	DESIGNED - LHA	REVISED - J. OBERLE 10-18-95			IROL AND PROTECTION FOR	F.A.P.	SECTION	COUNTY TOTAL SHEET
c:\pw_work\pwidot\mairenade\d0316286\D1	2111-sht-plan.dgn	DRAWN -	REVISED - A. HOUSEH 03-06-96	STATE OF ILLINOIS		ERSECTIONS, AND DRIVEWAYS	344	543R-3-RS	DUPAGE 51 40
	PLOT SCALE = 100.0000 ' / 10.	CHECKED -	REVISED - A. HOUSEH 10-15-96	DEPARTMENT OF TRANSPORTATION	SIDE RUADS, INT	ERSECTIONS, AND DRIVEWATS		TC-10	CONTRACT NO. 60N51
	PLOT DATE = 6/13/2014	DATE - 06-89	REVISED -T. RAMMACHER 01-06-00		SCALE: NONE SHEET NO. 1 OF	1 SHEETS STA. TO STA.	FED. ROA	AD DIST. NO. 1 ILLINOIS FED. A	NID PROJECT

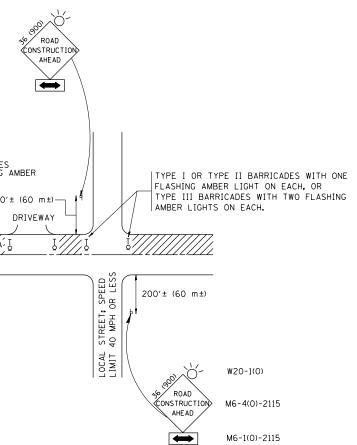


SIDE ROADS, INTERSECTIONS, AND DRIVEWAYS


B. FOR A LANE CLOSURE ON A SIDE ROAD OR DRIVEWAY:
USE APPLICABLE PORTIONS OF THE TYPICAL APPLICATION OF TRAFFIC
CONTROL DEVICES (STD. 701501, STD. 701606 OR THE APPROPRIATE STANDARD).
THE SPACING OF SIGNS AND BARRICADES SHALL BE ADJUSTED FOR FIELD
CONDITIONS AS DIRECTED BY THE ENGINEER. THE DIRECTIONAL ARROW
SHALL BE COVERED OR REMOVED WHEN NO LONGER CONSISTENT WITH THE
SIDE ROAD LANE CLOSURE.


- C. ADVANCE WARNING SIGNS ARE TO BE OMITTED ON DRIVEWAY UNLESS OTHERWISE NOTED.
- D. THE TRAFFIC CONTROL AND PROTECTION FOR SIDE ROADS, INTERSECTIONS, AND DRIVEWAYS SHALL BE INCIDENTAL TO THE COST OF SPECIFIED TRAFFIC CONTROL STANDARDS OR ITEMS.


All dimensions are	in millimeters (inches)
unless otherwise	shown.

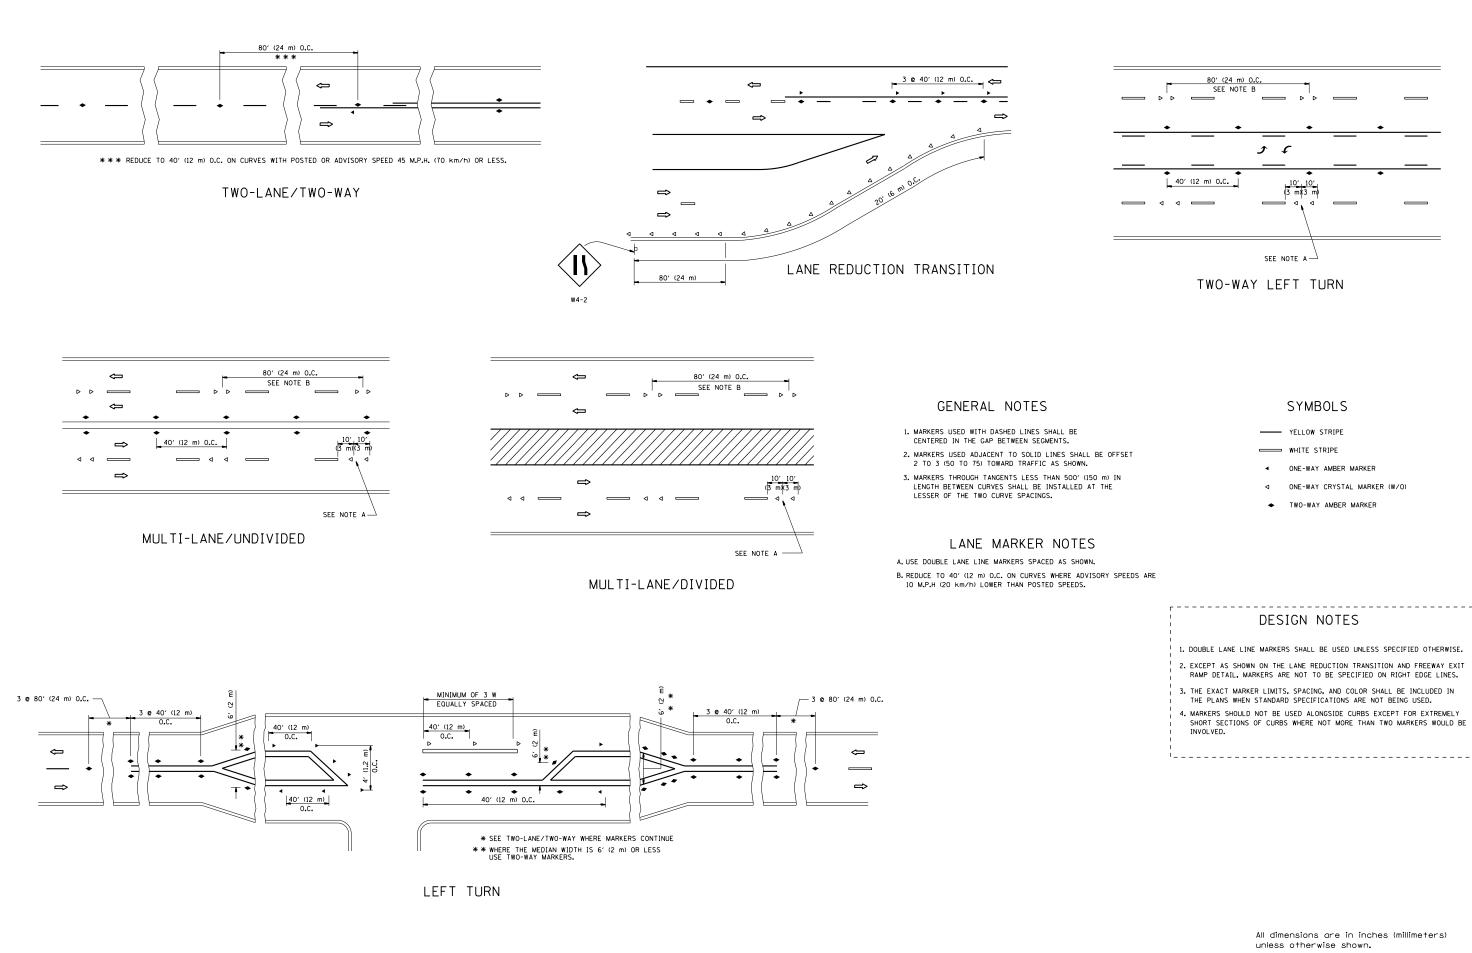

ſ	FILE NAME =	USER NAME = mairenade	DESIGNED -	REVISED	-T. RAMMACHER 09-19-	-94			TYPICAL APPLICATIONS	F.A.P. RTE.	SECTION	COUNTY S	TOTAL SHEET SHEETS NO.
	c:\pw_work\pwidot\mairenade\d0316286\D13	2111-sht-plan.dgn	DRAWN -	REVISED	-T. RAMMACHER 03-12-	-99	STATE OF ILLINOIS	DAIOED		344	543R-3-RS	DUPAGE	51 41
		PLOT SCALE = 100.0000 ' / in.	CHECKED -	REVISED	-T. RAMMACHER 01-06-	-00	DEPARTMENT OF TRANSPORTATION	KAISED	REFLECTIVE PAVEMENT MARKERS (SNOW-PLOW RESISTANT)		TC-11	CONTRACT N	NO. 60N51
		PLOT DATE = 6/13/2014	DATE -	REVISED	- C. JUCIUS 09-09-	-09		SCALE: NONE	SHEET NO. 1 OF 1 SHEETS STA. TO STA.	FED. ROAD		D. AID PROJECT	

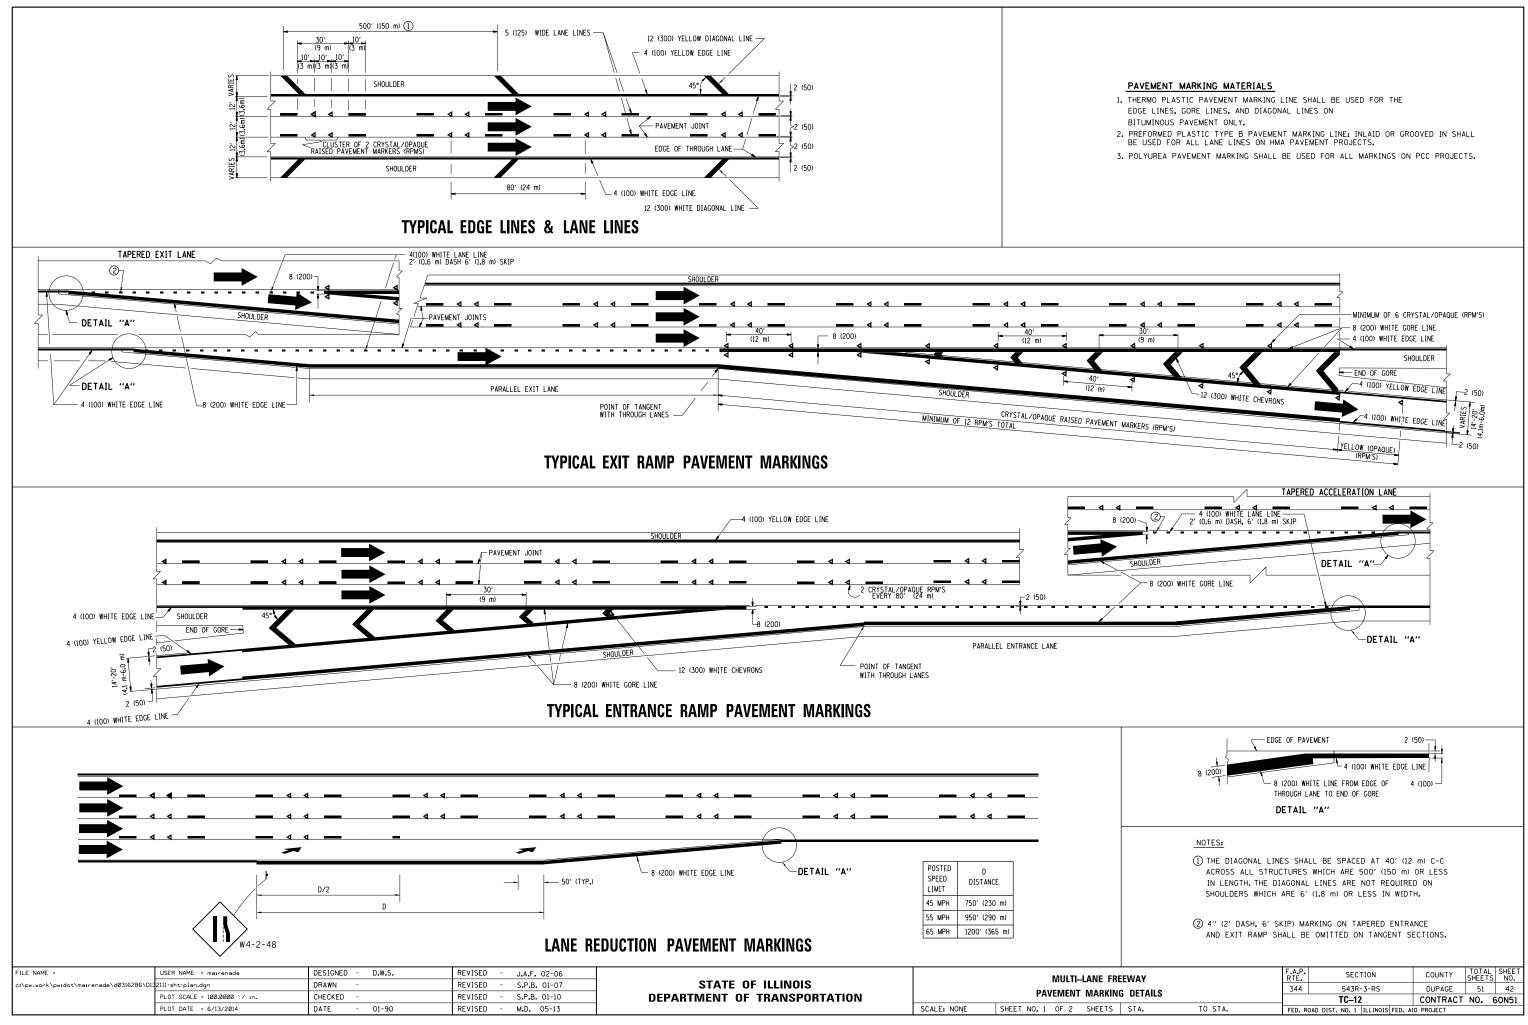

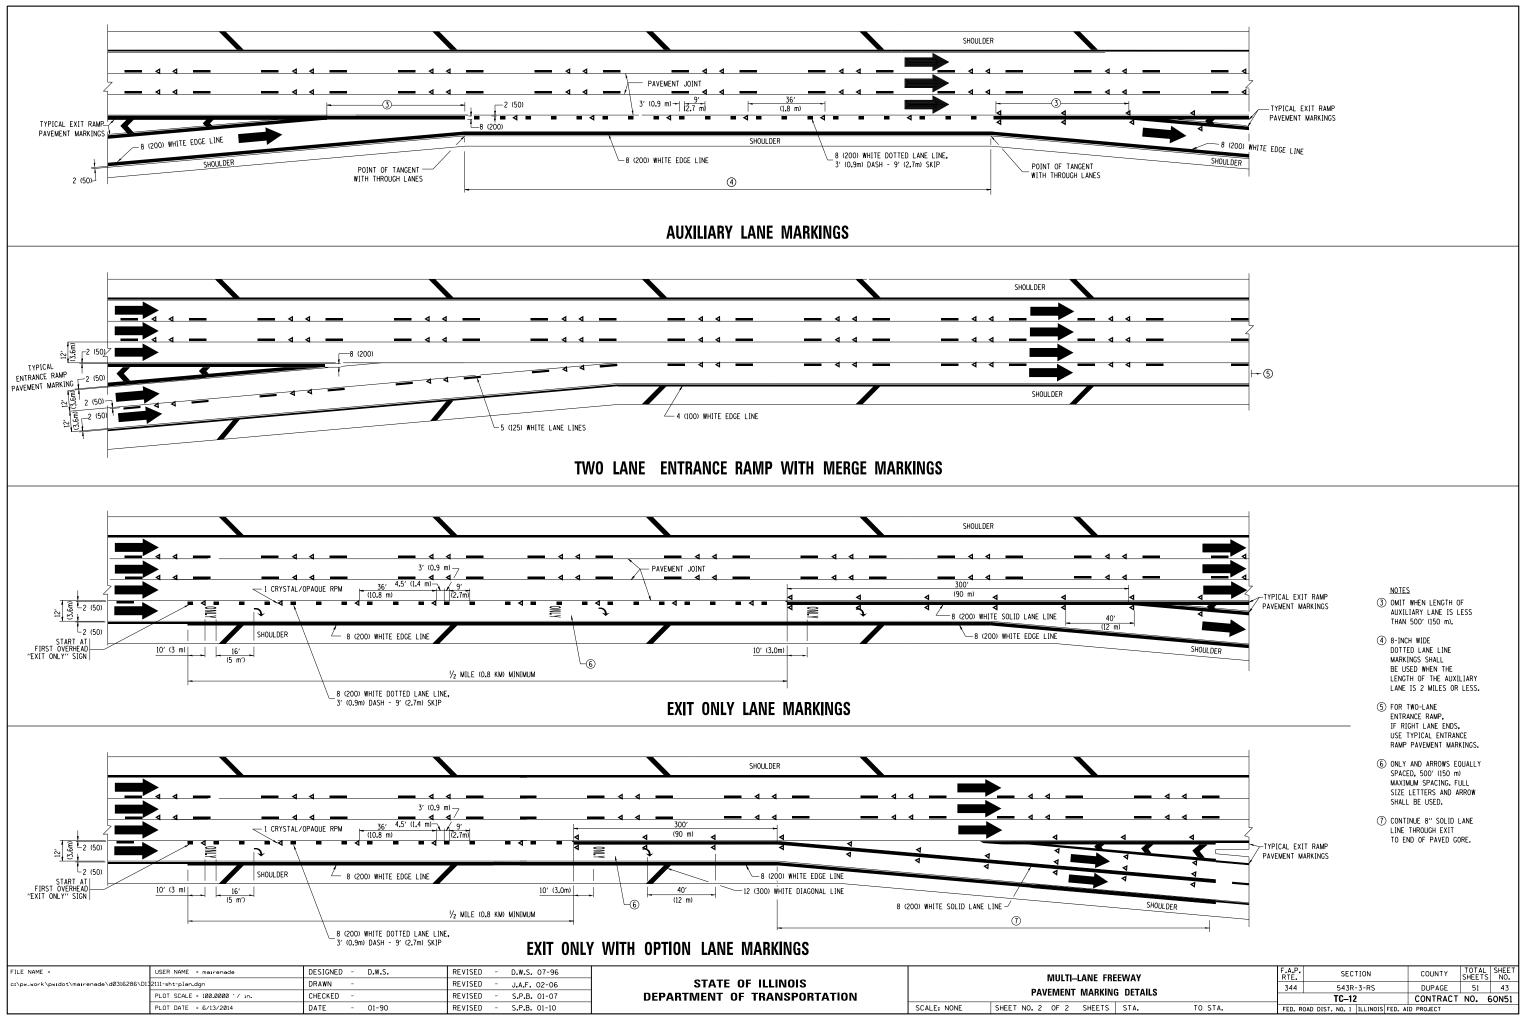

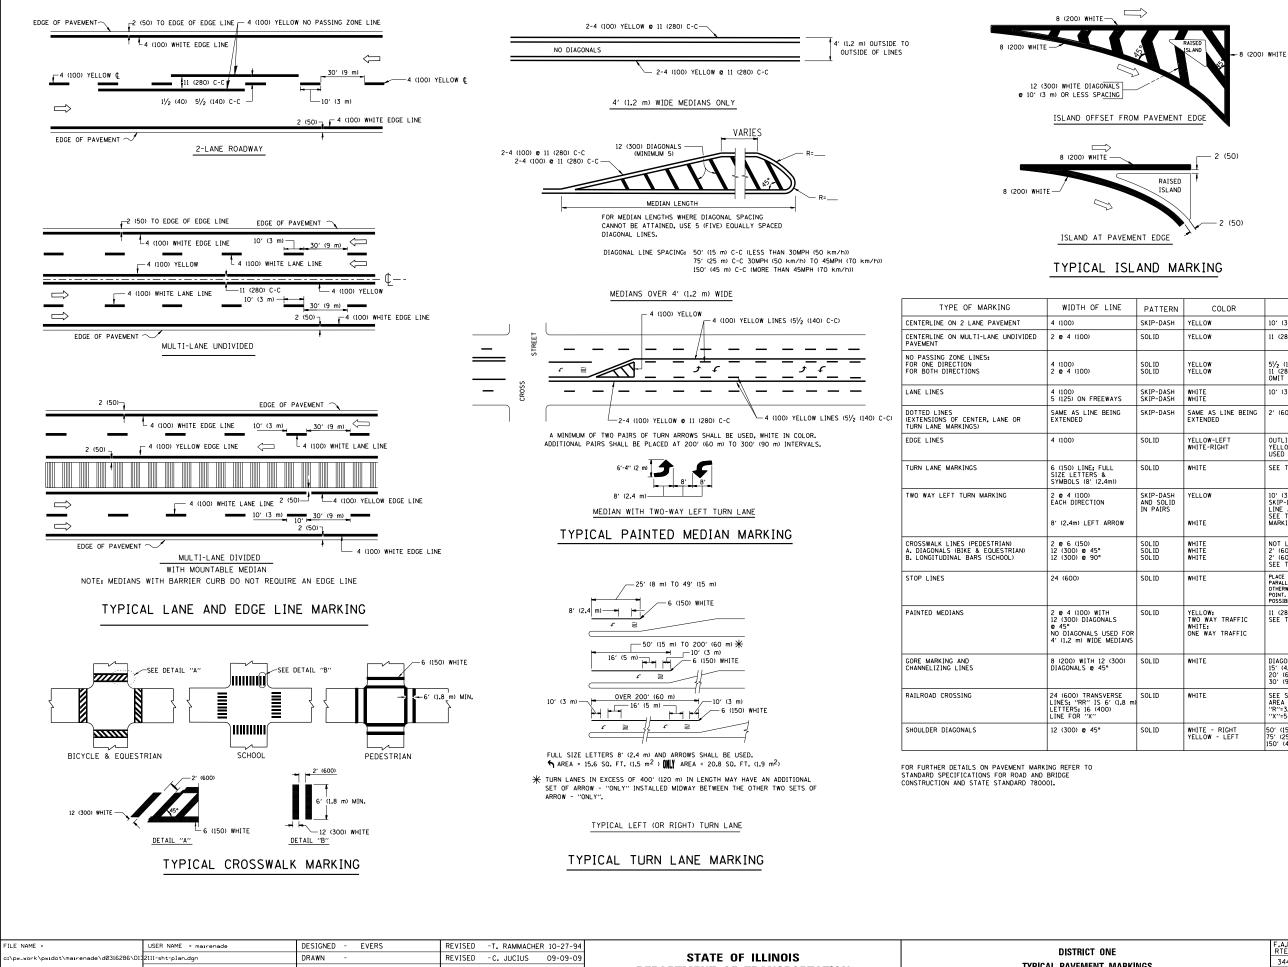


									F.A.P. RTE.			
maırenade\d0316286\D13	USER NAME = mairenade	DESIGNED - EVERS	REVISED -T. RAMMACHER 10-27-94	DISTRICT ONE						SECTION	COUNTY	TOTAL SHEET
	2111-sht-plan.dgn	DRAWN -	REVISED - C. JUCIUS 09-09-09	STATE OF ILLINOIS						543R-3-RS	DUPAGE	51 44
	PLOT SCALE = 100.0000 ' / in.	CHECKED -	REVISED -	DEPARTMENT OF TRANSPORTATION	TYPICAL PAVEMENT MARKINGS					TC-13	CONTRACT	NO. 60N51
	PLOT DATE = 6/13/2014	DATE - 03-19-90	REVISED -		SCALE: NONE	SHEET NO. 1 OF 1 SHEETS	STA.	TO STA.	FED. ROAD DI		. AID PROJECT	

LINE	PATTERN	COLOR	SPACING / REMARKS
	SKIP-DASH	YELLOW	10' (3 m) LINE WITH 30' (9 m) SPACE
	SOLID	YELLOW	11 (280) C-C
	SOL ID SOL ID	YELLOW YELLOW	5½ (140) C-C FROM SKIP-DASH CENTERLINE 11 (280) C-C OMIT SKIP-DASH CENTERLINE BETWEEN
EWAYS	SKIP-DASH SKIP-DASH	WHITE WHITE	10' (3 m) LINE WITH 30' (9 m) SPACE
BEING	SKIP-DASH	SAME AS LINE BEING EXTENDED	2' (600) LINE WITH 6' (1.8 m) SPACE
	SOLID	YELLOW-LEFT WHITE-RIGHT	OUTLINE MOUNTABLE MEDIANS IN YELLOW; EDGE LINES ARE NOT USED NEXT TO BARRIER CURB
ULL & .4m))	SOLID	WHITE	SEE TYPICAL TURN LANE MARKING DETAIL
N	SKIP-DASH AND SOLID IN PAIRS	YELLOW	10' (3 m) LINE WITH 30' (9 m) SPACE FOR SKIP-DASHE 5½ (140) C-C BETWEEN SOLID LINE AND SKIP-DASH LINE SEE TYPICAL TWO-WAY LEFT TURN MARKING DETAIL
	SOL ID SOL ID SOL ID	WHITE WHITE WHITE	NOT LESS THAN 6' (1.8 m) APART 2' (600) APART 2' (600) APART SEE TYPICAL CROSSWALK MARKING DETAILS.
	SOLID	WHITE	PLACE 4' (1,2 m) IN ADVANCE OF AND PARALLEL TO CROSSWALK, IF PRESENT, OTHERWISE, PLACE AT DESINED STOPPING POINT, PARALLEL TO CROSSROAD CENTERLINE, WHERE POSSIBLE
TH NALS USED FOR MEDIANS	SOLID	YELLOW: TWO WAY TRAFFIC WHITE: ONE WAY TRAFFIC	11 (280) C-C FOR THE DOUBLE LINE SEE TYPICAL PAINTED MEDIAN MARKING.
2 (300) 5°	SOLID	WHITE	DIAGONALS: 15'(4,5 m) C-C (LESS THAN 30MPH (50 km/h)) 20'(6 m) C-C 30MPH (50 km/h) TO 45MPH (70 km/h)) 30'(9 m) C-C (0VER 45MPH (70 km/h))
VERSE 6' (1.8 m) 00)	SOLID	WHITE	SEE STATE STANDARD 780001 AREA OF: "%"=3.6 SO. FT. (0.33 m ²) EACH "%"=54.0 SO. FT. (5.0 m ²)
	SOLID	WHITE - RIGHT YELLOW - LEFT	50' (15 m) C-C (LESS THAN 30MPH (50 km/h)) 75' (25 m) C-C (30 MPH (50 km/h) TO 45MPH (70 km/h)) 150' (45 m) C-C (0VER 45MPH (70 km/h))

All dimensions are in inches (millimeters) unless otherwise shown.

	CONFLICTING PAVEMENT MARKING — REMOVAL	WHITE REF MARKING T	LECTORIZED APE
		YELLOW RE MARKING T.	FLECTORIZED APE 1. CONES DAY O ARE BI HEIGH1 2. STEAD OPERA 3. REFLEO THE B THAN
			4. THIS A AND T LANE'' 5. THESE
		LEGEND	6.LONGI
		WORK AREA	7. FORM 8. IF A E NCHRP THE B
		LANE OPEN TO TRAFFIC	9. TRAFF SHALL ITEMS.
		TYPE I OR II BARRICADE WITH STEADY BURN LIGHT	
	Q	DRUM WITH STEADY BURN LIGHT	
	•	DRUM WITH SIGN (WITH OPTIONAL FLASHI LIGHT) SEE DETAIL	٩C
	н	TYPE I OR II CHECK BARRICADE WITH FL.	ASHING LIGH
STATE OF I	LLINOIS	TRAFFIC CONTROL AND	PROTECTION

FILE NAME =	USER NAME = mairenade	REVISED -T. RAMMACHER 09-08-94	REVISED - R. BORO 09-14-09			TRAFFIC CONTROL AND PROTEC	TION AT THRN RAVS	F.A.P. BTE	SECTION	COUNTY TOTAL SHEET
c:\pw_work\pwidot\mairenade\d0316286\D13		REVISED - A. HOUSEH 11-07-95		STATE OF ILLINOIS	(TO REMAIN OPEN TO TRAFFIC)		344	543R-3-RS	DUPAGE 51 45	
	PLOT SCALE = 100.0000 '/ in.	REVISED - A. HOUSEH 10-12-96	REVISED -	DEPARTMENT OF TRANSPORTATION				TC-14	CONTRACT NO. 60N51	
	PLOT DATE = 6/13/2014	REVISED -T. RAMMACHER 01-06-00	REVISED -		SCALE: NONE	SHEET NO. 1 OF 1 SHEETS	STA. TO STA.	FED. RO	AD DIST. NO. 1 ILLINOIS FED. A	

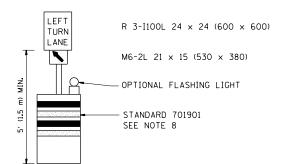

ED PAV'T

ZED PAV'T

GENERAL NOTES

ES MAY BE SUBSTITUTED FOR BARRICADES OR DRUMS AT HALF THE SPACING DURING DEPENDING USED, THE "LEFT TURN LANE" SIGN MAY BE SKID MOUNTED AT A MINIMUM HT OF 5' (1.5 m).

ADY BURNING LIGHTS WILL NOT BE REQUIRED ON BARRICADES OR DRUMS FOR DAY RATIONS. ALL LIGHTS SHALL BE MONODIRECTIONAL.

LECTORIZED TEMPORARY PAVEMENT MARKING TAPE SHALL BE PLACED THROUGHOUT BARRICADED AREA OF EACH TURN BAY WHERE THE CLOSURE TIME IS GREATER N FOURTEEN DAYS.

APPLICATION ALSO APPLIES WHEN WORK IS BEING PERFORMED IN THE RIGHT LANE(S) THE RIGHT TURN BAY IS TO REMAIN OPEN. UNDER THIS CONDITION, "RIGHT TURN " R3-100 24 x 24 (600 x 600) AND M6-2R 21 x 15 (530 x 380) SHALL BE USED.

SE CONTROLS SHALL SUPPLEMENT MAINLINE TRAFFIC CONTROL FOR LANE CLOSURES.

ITUDINAL DIMENSIONS MAY BE ADJUSTED TO FIT FIELD CONDITIONS.


OPER 725 IS REQUIRED.

DRUM OR TYPE II BARRICADE WITH AN ATTACHED SIGN PANEL WHICH MEETS RP 350 REQUIREMENTS IS NOT AVAILABLE, THE SIGNS SHALL BE MOUNTED, ABOVE BARRICADES, ON SEPARATE SIGNS SUPPORTS THAT MEET NCHR 350 PREQUIREMENTS.

FFIC CONTROL AND PROTECTION AT TURN BAYS (TO REMAIN OPEN TO TRAFFIC) LL BE INCLUDED IN THE COST SPECIFIED TRAFFIC CONTROL STANDARDS OR 1S.

> All dimensions are in inches (millimeters) unless otherwise shown.


GHT

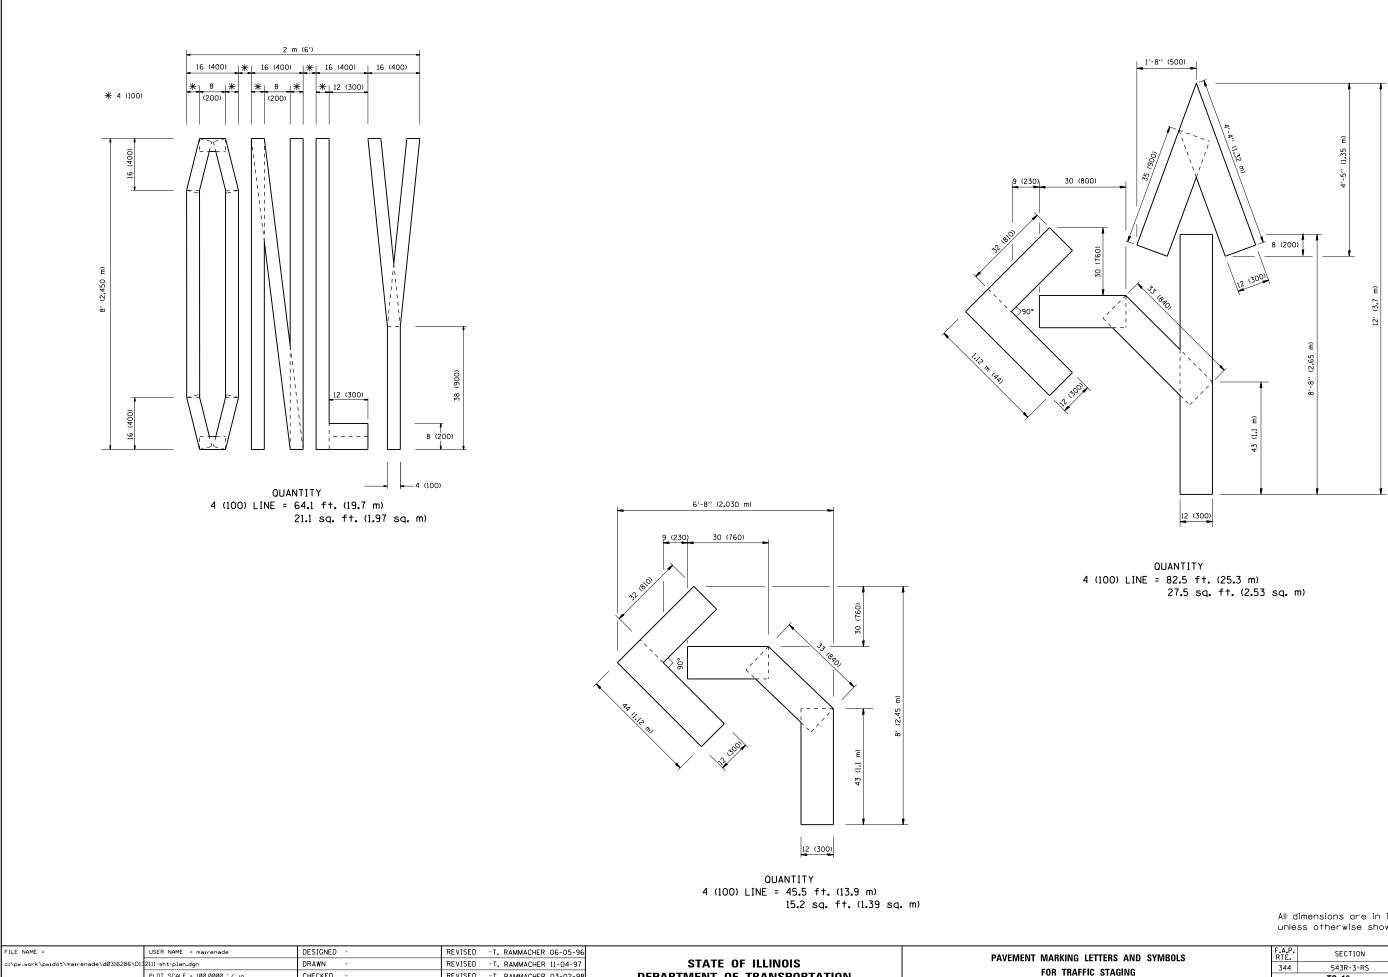

						PAVEMENT MARKING L	ETTEDC	٨
work\pwidot\mairenade\d0316286\D13	2111-sht-plan.dgn	DRAWN -	REVISED -T. RAMMACHER 11-04-97	STATE OF ILLINOIS		FAVEIVIENT WARKING L	LETTENS	'
	PLOT SCALE = 100.0000 '/ in.	CHECKED -	REVISED -T. RAMMACHER 03-02-98	DEPARTMENT OF TRANSPORTATION	FOR TRAFFIC STA			
	PLOT DATE = 6/13/2014	DATE - 09-18-94	REVISED - E. GOMEZ 08-28-00		SCALE: NONE	SHEET NO. 1 OF 1 SHE	ETS	

All dimensions are in inches (millimeters) unless otherwise shown.

ERS AND SYMBOLS Staging		F.A.P. RTE.	SECTION	COUNTY	TOTAL SHEETS	SHEET NO.			
		344	543R-3-RS	DUPAGE	51	46			
			TC-16	CONTRACT	NO. 6	50N51			
	STA.	TO STA.	FED. ROAD DIST. NO. 1 ILLINOIS FED. AID PROJECT						

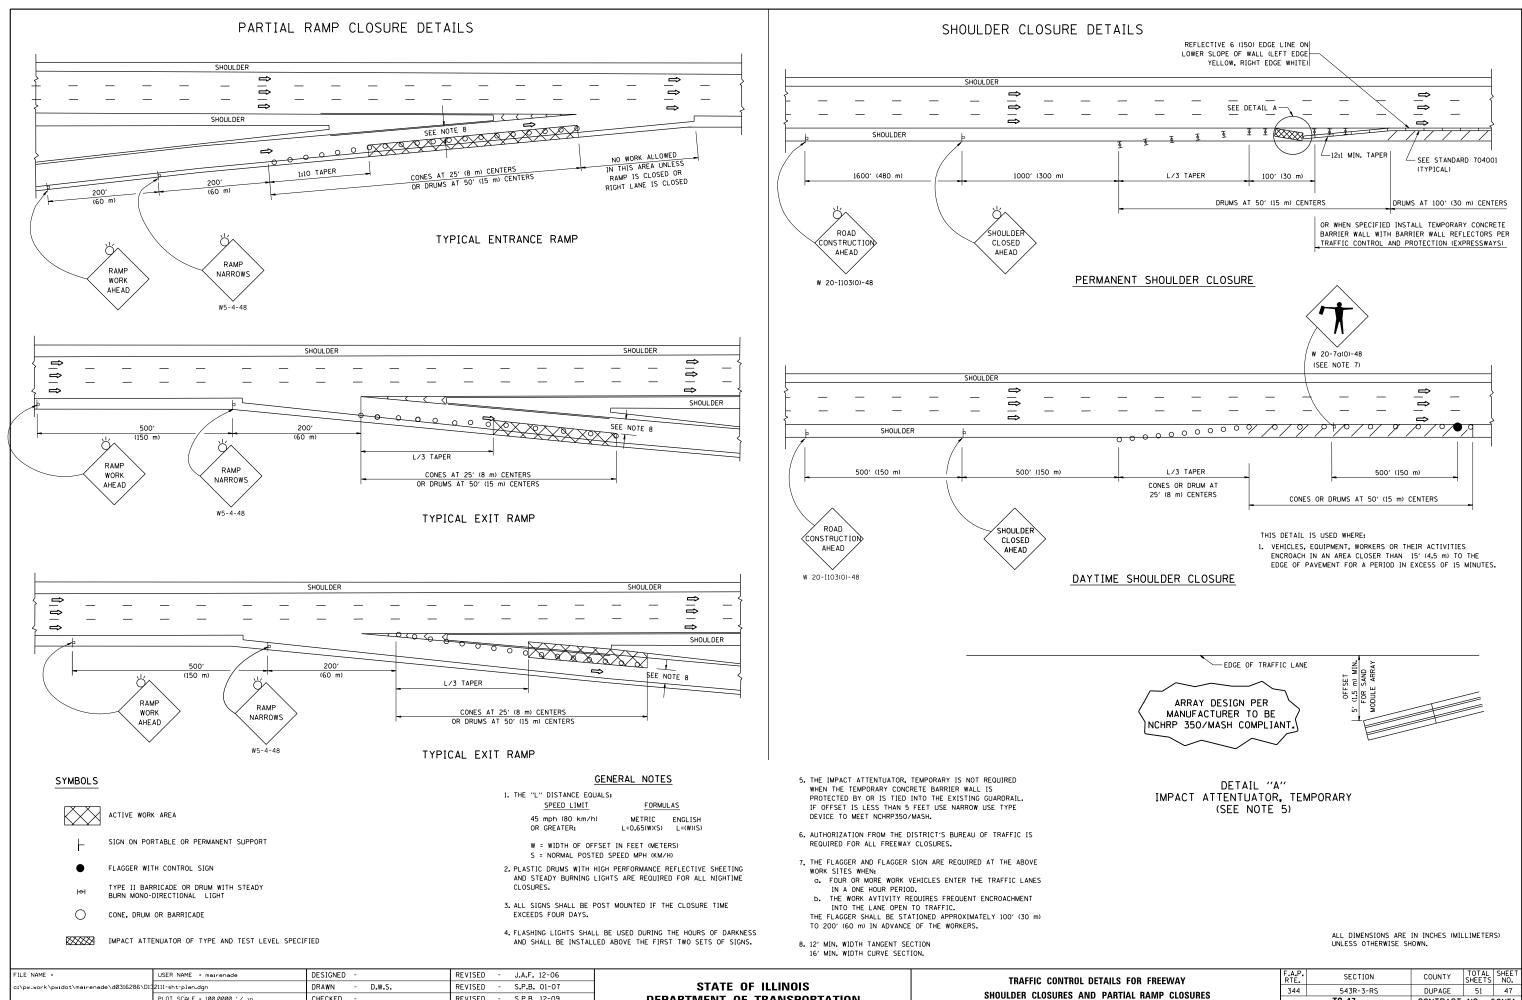


TC-17

FED. ROAD DIST. NO. 1 ILLINOIS FED. AID PROJECT

TO STA.

CONTRACT NO. 60N51

FILE NAME =	USER NAME = mairenade	DESIGNED -	REVISED - J.A.F. 12-06			TRAFFIC CONTROL DETAILS	
c:\pw_work\pwidot\mairenade\d0316286\D1	32111-sht-plan.dgn	DRAWN - D.W.S.	REVISED - S.P.B. 01-07	STATE OF ILLINOIS			
	PLOT SCALE = 100.0000 ' / 10.	CHECKED -	REVISED - S.P.B. 12-09	DEPARTMENT OF TRANSPORTATION	S	HOULDER CLOSURES AND PAR	TIAL RAN
	PLOT DATE = 6/13/2014	DATE - 11-96	REVISED - M.D. 06-13		SCALE: NONE	SHEET NO. 1 OF 1 SHEETS	STA.

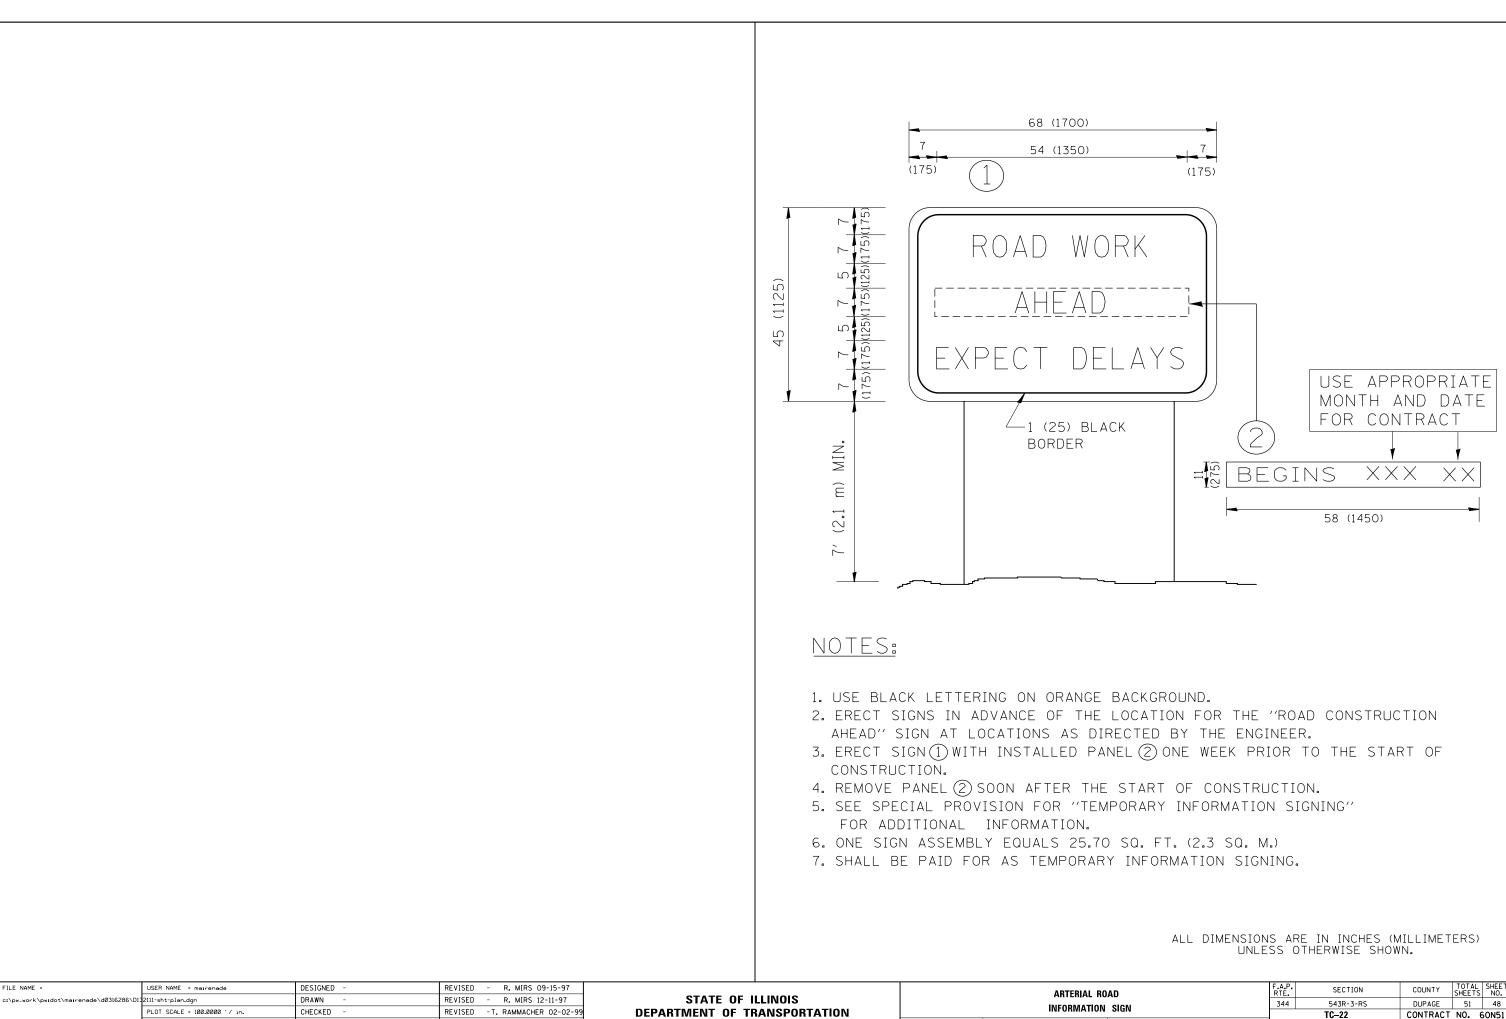

PLOT DATE = 6/13/2014

DATE


REVISED - C. JUCIUS 01-31-07

SPURIATION				
	SCALE: NONE	SHEET NO. 1	OF 1	SHEETS

ROAD N SIGN		F.A.P. RTE.	SECTION	COUNTY	TOTAL SHEETS	SHEET NO.		
		344	51	48				
		TC-22 CONTRACT NO. 60N						
	STA.	TO STA.	FED. ROAD DIST. NO. 1 ILLINOIS FED. AID PROJECT					

TRAFFIC SIGNAL LEGEND

ITEM	REMOVAL	EXISTING	PROPOSED	ITEM	REMOVAL	EXISTING	PROPOSED		REMOVAL	EXISTING	PROPOSED
CONTROLLER CABINET	\bowtie^{R}	\bowtie		EMERGENCY VEHICLE LIGHT DETECTOR	R	\bowtie	•	ELECTRIC CABLE IN CONDUIT, TRACER, NO. 14 1/C, UNLESS NOTED OTHERWISE			
RAILROAD CONTROL CABINET	_			CONFIRMATION BEACON	Ro-J	0()				đ	—(C)—
COMMUNICATIONS CABINET	C C R	ECC	СС	HANDHOLE	R			COAXIAL CABLE			
MASTER CONTROLLER		EMC	MC	HEAVY DUTY HANDHOLE	R _H	н	Η	VENDOR CABLE FOR CAMERA			—(v)—
	R UPS	EMMC EUPS	MMC UPS	DOUBLE HANDHOLE	R			COPPER INTERCONNECT CABLE.		. ,	-
UNINTERRUPTABLE POWER SUPPLY SERVICE INSTALLATION,				JUNCTION BOX	R	Ø		NO. 18 3 PAIR TWISTED, SHIELDED			-6
(P) POLE OR (G) GROUND MOUNT	- <u></u> R	- _ _	- -	UNDERGROUND CONDUIT,				FIBER OPTIC CABLE NO. 62.5/125, MM12F		- <u>12</u> F	
TELEPHONE CONNECTION (P) POLE OR (G) GROUND MOUNT	R	P	P T	GALVANIZED STEEL (UC) TEMPORARY SPAN WIRE, TETHER WIRE,	_R			FIBER OPTIC CABLE NO. 62.5/125, MM12F SM12F		24F	
STEEL MAST ARM ASSEMBLY AND POLE	R	0	•	AND CABLE							
ALUMINUM MAST ARM ASSEMBLY AND POLE	R	0		COMMON TRENCH			CT	FIBER OPTIC CABLE NO. 62.5/125, MM12F SM24F		—36F—	
STEEL COMBINATION MAST ARM ASSEMBLY AND POLE WITH LUMINAIRE	^R ⊖¤	0-¤	• *	COILABLE NONMETALLIC CONDUIT (EMPTY) SYSTEM ITEM		S	CNC S	GROUND ROD AT (C) CONTROLLER, (H) HANDHOLE, (P) POST, (M) MAST ARM,		с, _I —о	C _{ulter}
STEEL COMBINATION MAST ARM ASSEMBLY AND POLE WITH PTZ CAMERA			●	INTERSECTION ITEM		I	IP	OR (S) SERVICE			n⊫
SIGNAL POST	R	0	•	REMOVE ITEM	R			CONTROLLER CABINET AND FOUNDATION TO BE REMOVED	RCF		
TEMPORARY WOOD POLE (CLASS 5 OR	⊂ R⊗	\otimes	٢	RELOCATE ITEM	RL			FOUNDATION TO BE REMOVED			
BETTER) 45 FOOT (13.7m) MINIMUM		~		ABANDON ITEM	А			STEEL MAST ARM POLE AND FOUNDATION TO BE REMOVED	O ^{RMF}		
GUY WIRE	R	>	\succ	12" (300mm) TRAFFIC SIGNAL SECTION		R	R	ALUMINUM MAST ARM POLE AND	RMF		
SIGNAL HEAD	->	\rightarrow	-	12" (300mm) RED WITH 8" (200mm)		R		FOUNDATION TO BE REMOVED			
SIGNAL HEAD CONSTRUCTION STAGES (NUMBERS INDICATE THE CONSTRUCTION STAGE)			→ ²	YELLOW AND GREEN TRAFFIC SIGNAL FACE		Ŕ	R	STEEL COMBINATION MAST ARM ASSEMBLY AND POLE WITH LUMINAIRE AND FOUNDATION TO BE REMOVED	RMF O→¤────		
SIGNAL HEAD WITH BACKPLATE		$+ \triangleright$	+►			Y	Y				
SIGNAL HEAD OPTICALLY PROGRAMMED		->''P''	- ►"P"	SIGNAL FACE		Q	G 4 Y	SIGNAL POST AND FOUNDATION TO BE REMOVED	RPF		
FLASHER INSTALLATION (S DENOTES SOLAR POWER)	0-₽>′′F′′	O+⊃″F″	• -> "F"				 4 € 	INTERSECTION & SAMPLING (SYSTEM) DETECTOR			IS
PEDESTRIAN SIGNAL HEAD	R -[]	-0	-			R	R	SAMPLING (SYSTEM) DETECTOR			S
PEDESTRIAN PUSHBUTTON DETECTOR	R	۲	۲	SIGNAL FACE WITH BACKPLATE. "P" INDICATES PROGRAMMED HEAD) C	Y G	QUEUE DETECTOR			
ACCESSIBLE PEDESTRIAN PUSHBUTTON DETECTOR	R @ aps	@aps	APS APS	"RB" INDICATES REFLECTIVE BACKPLATE		€	← Y ← G			·	
ILLUMINATED SIGN	R	R				"P"	"P"	PREFORMED QUEUE DETECTOR		Î <u>Poj</u>	PO
"NO LEFT TURN"	Ø	I		12" (300mm) PEDESTRIAN SIGNAL HEAD WALK/DON'T WALK SYMBOL		(W) W)		PREFORMED INTERSECTION AND SAMPLING		PIS	PIS
ILLUMINATED SIGN "NO RIGHT TURN"		\bigcirc		12" (300mm) PEDESTRIAN SIGNAL HEAD				PREFORMED SAMPLING (SYSTEM) DETECTOR		← →	↓ [PS]
DETECTOR LOOP, TYPE I				INTERNATIONAL SYMBOL, OUTLINED				FREFORMED SAMFLING (SISTEM) DETECTOR		IPSI	<u>الاعا</u>
PREFORMED DETECTOR LOOP		 אריייייייייייייייייייייייייייייייייייי	└─┘ Ì₽Ì	12" (300mm) PEDESTRIAN SIGNAL HEAD INTERNATIONAL SYMBOL, SOLID			P	RAILROAI		אופ	
	R	ه – « ا	+							JLJ	
MICROWAVE VEHICLE SENSOR	R	۲ س		PEDESTRIAN SIGNAL HEAD, INTERNATIONAL SYMBOL, WITH COUNTDOWN TIMER		C C D	₽ C ★ D			EXISTING	PROPOSED
VIDEO DETECTION CAMERA	R		V	RADIO INTERCONNECT				RAILROAD CONTROL CABINET			
VIDEO DETECTION ZONE				RADIO REPEATER	RERR	ERR	RR	RAILROAD CANTILEVER MAST ARM	Σ	X OX X X	
PAN, TILT, ZOOM CAMERA	R PTZJ	PIZA	PTZ	DENOTES NUMBER OF CONDUCTORS, ELECTRIC				FLASHING SIGNAL		XoX	XoX
WIRELESS DETECTOR SENSOR	R	Ŵ	(W)	CABLE NO. 14, UNLESS NOTED OTHERWISE, All detector loop cable to be shielded		5	(5)	CROSSING GATE		XoX >	XOX
WIRELESS ACCESS POINT	R			GROUND CABLE IN CONDUIT NO. 6 SOLID COPPER (GREEN)			(1)	CROSSBUCK		¥	\mathbf{F}
FILE NAME = USER NAME = mairenade		ESIGNED - DAG/BCK	REVISED -	DAG 1-1-14		/			F.A.P. RTE.	SECTION	COUNTY TOTAL SHEETS
ci\pw_work\pwidot\mairenade\d0316286\D132111-sht-plan.dgn PLOT_SCALE = 100.0000 ′ /		RAWN - BCK HECKED - DAD	REVISED - REVISED -	STATE DEPARTMENT	OF ILLINOIS			DISTRICT ONE Standard traffic signal design details	344	543R-3-RS	DUPAGE 51
PLOT DATE = 6/13/2014		ATE - 10-28-09	REVISED -				SCALE: NO	NE SHEET NO. 1 OF 7 SHEETS STA. TO S	A. FED. ROA	TS-05 AD DIST. NO. 1 ILLINOIS FE	CONTRACT NO. 60

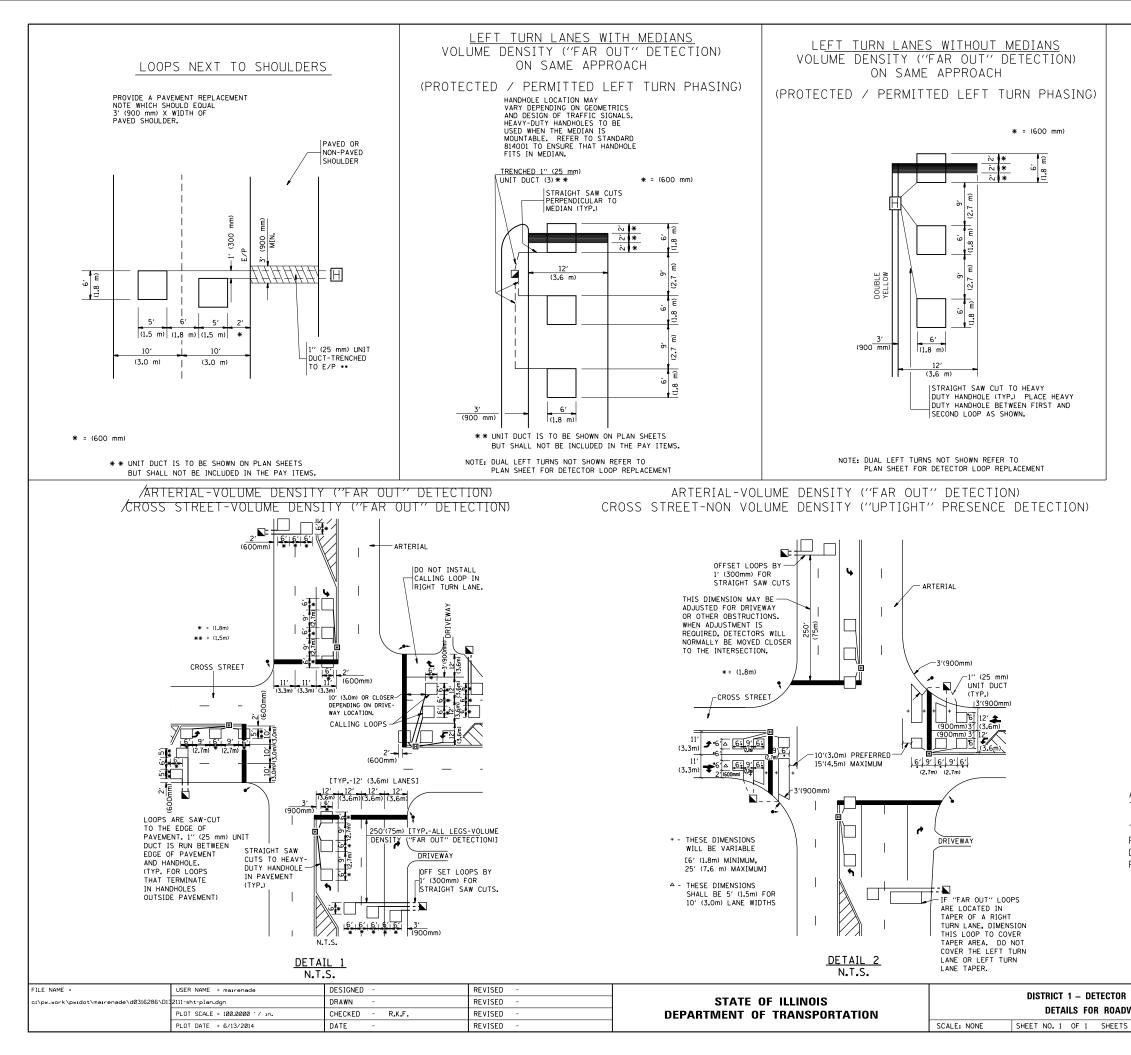

NOTES:

VEHICLES LOOP DETECTORS

- * ALL LEAD IN CABLE SHALL BE TWO CONDUCTOR NO. 14 TWISTED, SHIELDED.
- * EACH DETECTOR LOOP SHALL HAVE ITS OWN SAW CUT FROM THE LOOP TO THE EDGE OF PAVEMENT OR TO A HANDHOLE IN THE PAVEMENT.
- * EACH DETECTOR LOOP SHALL HAVE ITS OWN ONE INCH (25 mm) UNIT DUCT BETWEEN THE EDGE OF PAVEMENT AND THE FIRST HANDHOLE OR JUNCTION BOX. EACH UNIT DUCT RUN SHALL BE SHOWN ON THE PLANS BY THE DESIGNER, BUT SHALL NOT BE PAID FOR SEPARATLY. THIS ITEM IS INCIDENTAL TO THE PAY ITEM FOR DETECTOR LOOPS.
- * ONE DIMENSION OF <u>ALL</u> DETECTOR LOOPS SHALL BE SIX FEET (1.8 m)
- * EACH LANE OF NON-LOCKING, PRESENCE DETECTION AND EACH LANE OF A DOUBLE LEFT TURN LANE REQUIRES A SEPARATE INDUCTIVE LOOP DETECTOR AND LEAD IN CABLE.
- * WHEN NON-LOCKING, PRESENCE DETECTION IS USED, <u>MORE</u> THAN ONE LOOP PER LANE IS REQUIRED BEHIND THE STOP BAR (i.e. 1-1/2, 1-3/4, 2).
- * WHEN SYSTEM LOOPS ARE REQUIRED ON AN APPROACH OF AN INTERSECTION, THE LOOPS USED FOR VOLUME DENSITY AND INTERSECTION TIMING SHALL ALSO BE USED AS SYSTEM DETECTORS. <u>EACH</u> ONE OF THESE TYPE OF LOOPS REQUIRES A <u>SEPARATE</u> TWO CONDUCTOR NO. 14 TWISTED SHIELDED CABLE AND A <u>SEPARATE</u> INDUCTIVE LOOP DETECTOR WHEN NEW CONTROLLERS ARE UTILIZED. THE DESIGNER SHALL LABEL THESE TYPES OF LOOPS AS "INTERSECTION AND SAMPLING (SYSTEM) DETECTORS" ON THE SIGNAL LAYOUT, THE INTERCONNECT PLAN AND THE SYSTEM CABLE PLAN. WHEN AN EXISTING CONTROLLER IS UTILIZED FOR THIS TYPE OF DETECTION, THE PAY ITEM "INDUCTIVE LOOP DETECTOR WITH SYSTEM OUTPUT" SHOULD BE USED.

PLACEMENT OF DETECTORS

THE FOLLOWING FIGURES REPRESENT THE MOST COMMON DETECTOR LOOP LOCATIONS AND SIZES. ADJUSTMENTS WILL BE NECESSARY FOR SPECIFIC GEOMETRIC CONSIDERATIONS.

LOCATIONS AND DEMENSIONS OF DETECTOR LOOPS ARE REQUIRED ON \underline{ALL} SIGNAL LAYOUT PLAN SHEETS.


"FAR OUT" DETECTION REFERS TO LOCKING, PRESENCE TYPE DETECTION LOCATED IN THRU LANES, RIGHT TURN LANES, AND RIGHT TURN LANE TAPER AREAS (IF APPLICABLE), USUALLY 250' (75 m) IN ADVANCE OF STOP BARS. "UPTIGHT" DETECTION REFERS TO NON-LOCKING PRESENCE TYPE DETECTION LOCATED IN ALL LANES AND 10'-15' (3.0 m-4.5 m) BEHIND THE CROSSING STREET'S EDGE OF PAVEMENT EXTENDED.

NOTE:

ALL DETAILS AND NOTES SHOWN ARE FROM THE I.D.O.T. DISTRICT 1 TRAFFIC SIGNAL DESIGN GUIDELINES DATED JANUARY 1995

THIS DRAWING HAS BEEN PREPARED TO ASSIST THE RESIDENT ENGINEER FOR ALL ROADWAY RESURFACING OR S.M.A.R.T. PROJECTS WHERE THE DIMENSIONS ARE NOT SHOWN ON THE PLANS AND THE FINAL LOCATIONS FOR CROSSWALKS OR STOP BARS ARE NOT DETERMINED.

L	OOP INSTA	ALLATION	F.A.P. RTE.	SECTION	COUNTY	TOTAL SHEETS	SHEET NO.	
WAY RESURFACING		344	543R-3-RS	DUPAGE	51	50		
			TS-07 CONTRACT NO. 60N51					
	STA.	TO STA.	FED. ROAD DIST. NO. 1 ILLINOIS FED. AID PROJECT					

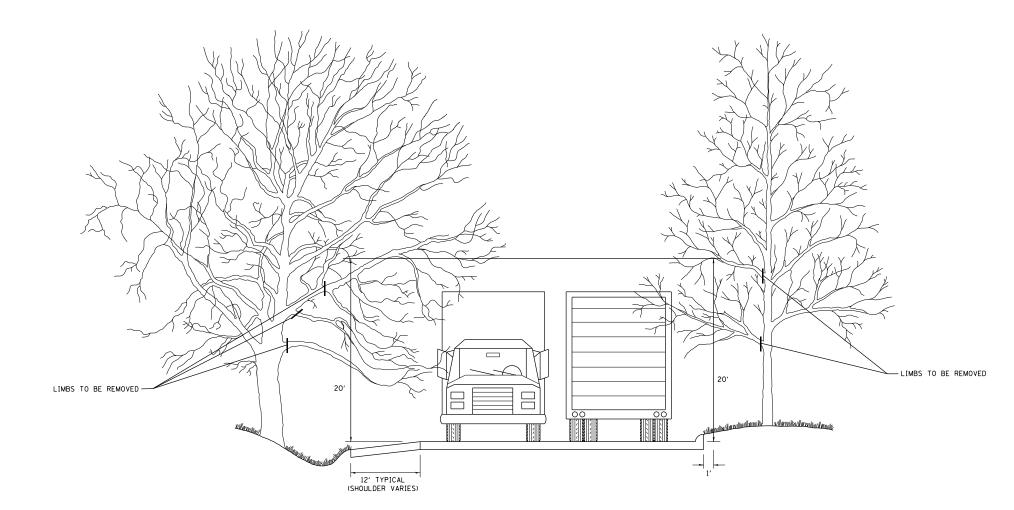

FILE NAME =	USER NAME = mairenade	DESIGNED -	REVISED - R. BORO 10-31-06		PRUNING FOR SAFETY AND	F.A.P	SECTION	COUNTY TOTAL SHEET
c:\pw_work\pwidot\mairenade\d0316286\D13	2111-sht-plan.dgn	DRAWN -	REVISED -	STATE OF ILLINOIS		344	543R-3-RS	DUPAGE 51 51
	PLOT SCALE = 100.0000 '/ in.	CHECKED -	REVISED -	DEPARTMENT OF TRANSPORTATION	EQUIPMENT CLEARANCE		BM-20	CONTRACT NO. 60N51
	PLOT DATE = 6/13/2014	DATE -	REVISED -		SCALE: NONE SHEET NO. 1 OF 1 SHEETS STA. TO STA.	FED.	ROAD DIST. NO. 1 ILLINOIS FED. 4	