


- ②6 STA 52+00.00, 36.69' LT
PROPOSED INLETS, TYPE A
W/ TYPE 3V FRAME AND GRATE
PIPE DRAINS, 15"
METAL END SECTIONS, 15"
CONCRETE THRUST BLOCKS
CONCRETE ANCHORS
GR ELEV 602.60
FL ELEV 600.27
15" OUT 600.44
- ②7 STA 52+00.00, 36.69' RT
PROPOSED INLETS, TYPE A
W/ TYPE 3V FRAME AND GRATE
PIPE DRAINS, 15"
METAL END SECTIONS, 15"
CONCRETE THRUST BLOCKS
CONCRETE ANCHORS
GR ELEV 602.60
FL ELEV 600.27
15" OUT 600.44
- ②8 STA 53+60.00, 36.69' LT
PROPOSED INLETS, TYPE A
W/ TYPE 3V FRAME AND GRATE
PIPE DRAINS, 15"
METAL END SECTIONS, 15"
GR ELEV 599.80
FL ELEV 597.47
15" OUT 597.64
- ②9 STA 53+60.00, 36.69' RT
PROPOSED INLETS, TYPE A
W/ TYPE 3V FRAME AND GRATE
PIPE DRAINS, 15"
METAL END SECTIONS, 15"
GR ELEV 599.80
FL ELEV 597.47
15" OUT 597.64

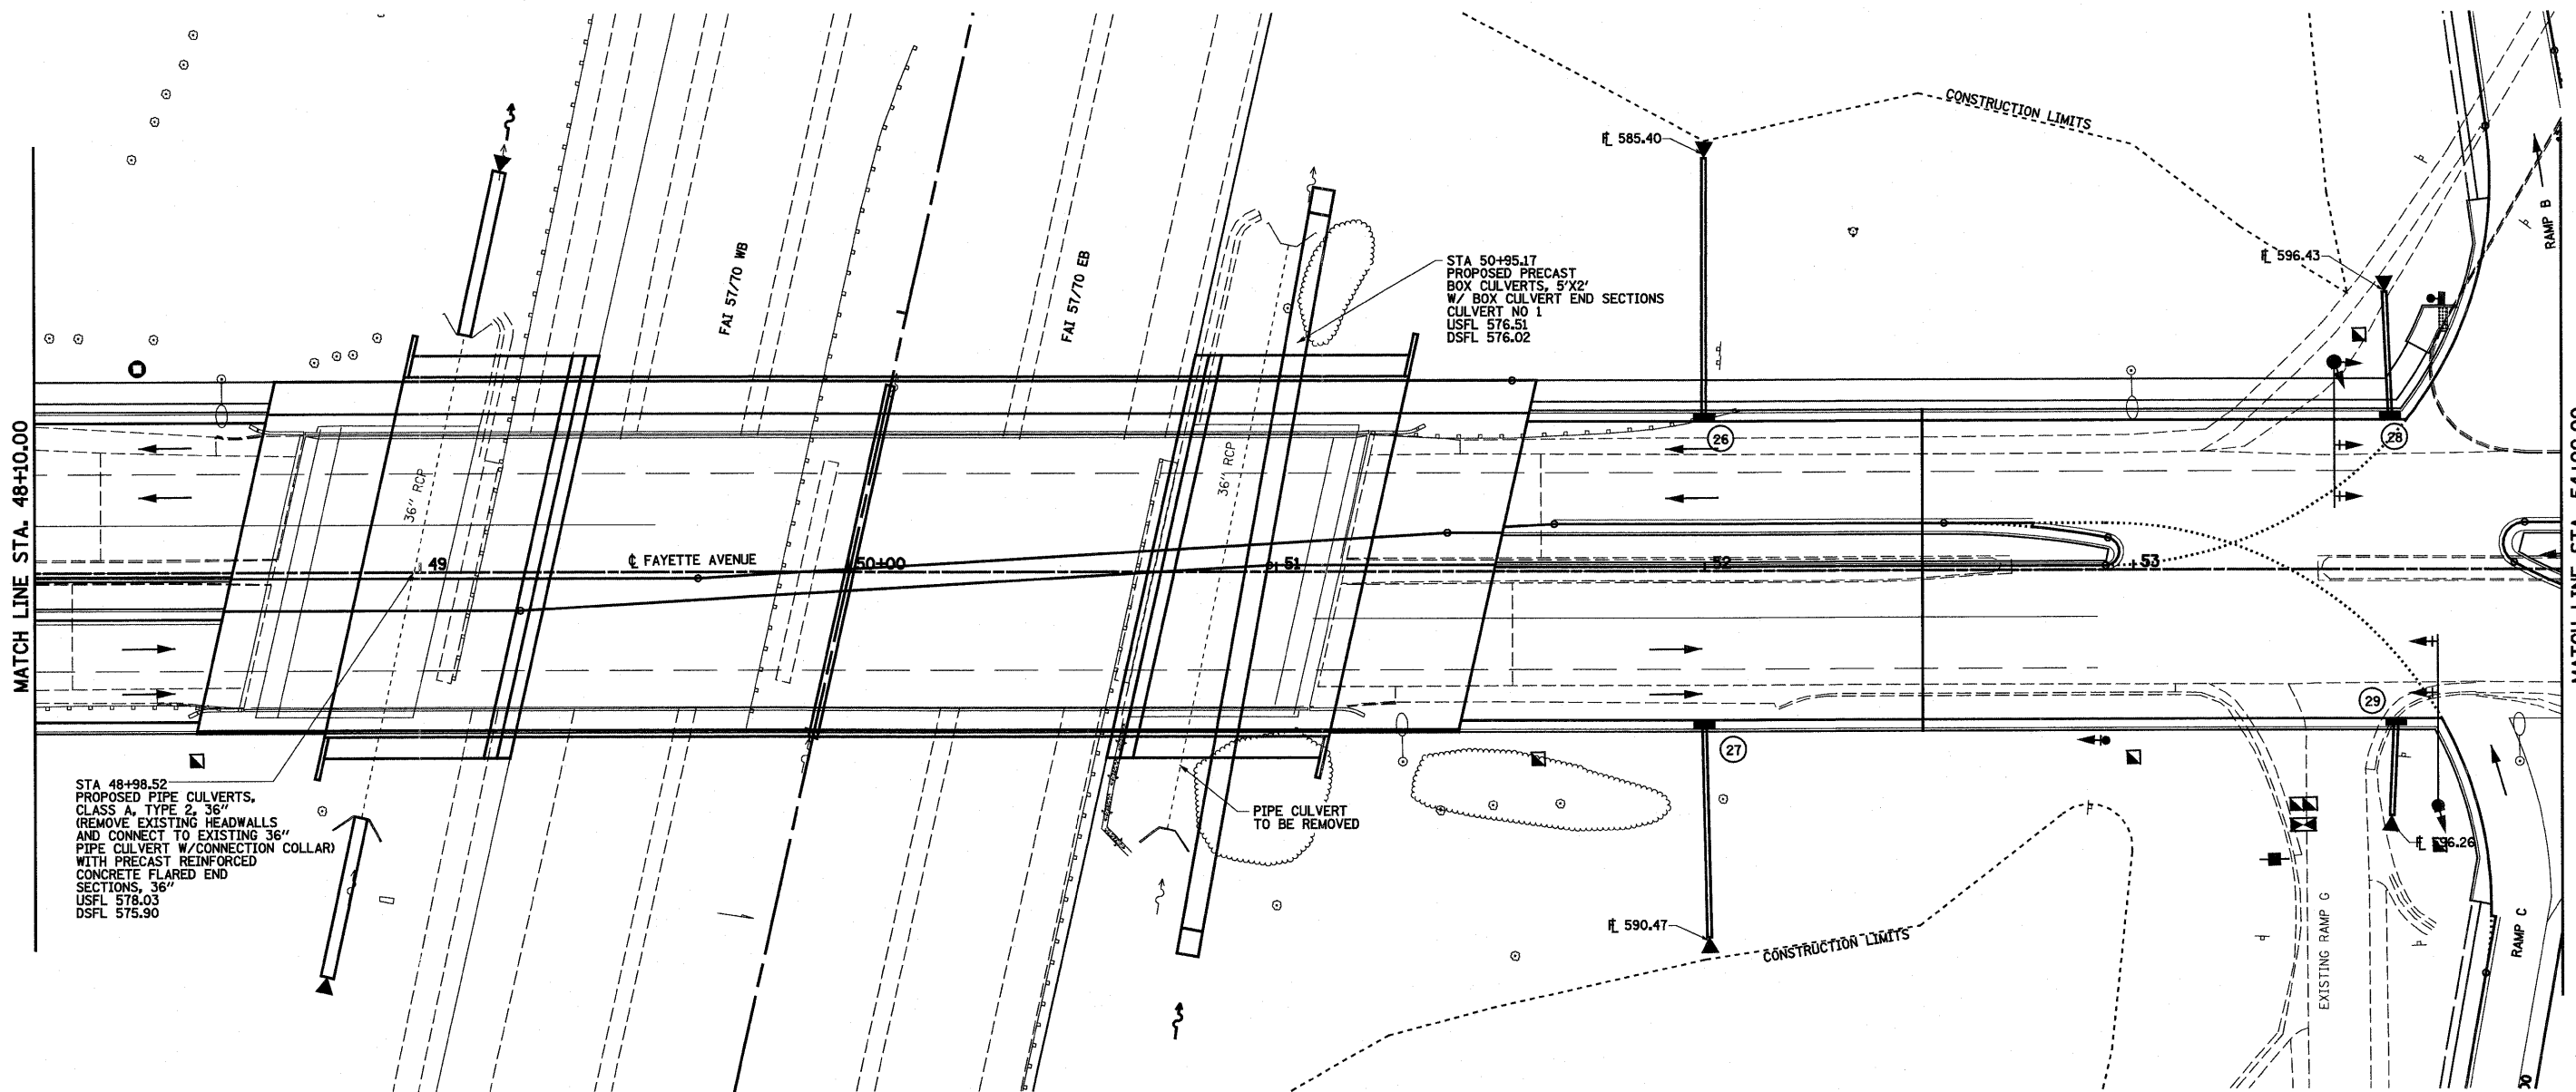


STA 48+98.52
PROPOSED PIPE CULVERTS,
CLASS A, TYPE 2, 36"
(REMOVE EXISTING HEADWALLS
AND CONNECT TO EXISTING 36"
PIPE CULVERT W/ CONNECTION COLLAR)
WITH PRECAST REINFORCED
CONCRETE FLARED END
SECTIONS, 36"
USFL 578.03
DSFL 575.90

STA 50+95.17
PROPOSED PRECAST
BOX CULVERTS, 5'X2'
W/ BOX CULVERT END SECTIONS
CULVERT NO 1
USFL 576.51
DSFL 576.02

PIPE CULVERT
TO BE REMOVED

NOTE:
ALL PIPES ENTER AND EXIT STRUCTURE
AT STRUCTURE FLOW LINE ELEVATION
UNLESS OTHERWISE NOTED.

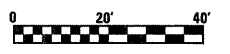

FILE NAME = <small>S:\Projects\403-00072-57-70\dgn\Fayette\dmn.pln.dgn</small>	USER NAME = paul	DESIGNED - JWS	REVISED -	STATE OF ILLINOIS DEPARTMENT OF TRANSPORTATION	DRAINAGE PLAN, FAYETTE AVENUE	F.A.I. RTE. 57/70	SECTION (25-3)I-6	COUNTY EFFINGHAM	TOTAL SHEETS 839	SHEET NO. 157
PLOT SCALE = 40.0000' / IN.		DRAWN - PDB		SCALE: 1"=20' SHEET NO. 3 OF 8 SHEETS STA. 48+10.00 TO STA. 54+00.00		CONTRACT NO. 74293				
PLOT DATE = 6/24/2010		CHECKED - BRM				FED. ROAD DIST. NO. ILLINOIS FED. AID PROJECT				
		DATE - 11-05-07								