



CENTERLINE CURVE DATA
 $\Delta = 40'11''00''$
 $R = 208.46'$
 $T = 76.25'$
 $L = 146.20'$
 P.C. STA. 10+48.53
 P.I. STA. 11+24.78
 P.T. STA. 11+94.73
 S.E. = NONE

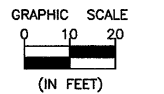

BENCHMARK:
 RAILROAD SPIKE IN POWER POLE
 SOUTH SIDE OTTAWA AVE. AND
 DIRECTLY SOUTH OF GEBHART WOODS
 RANGERS OFFICE.
 ELEV. 507.91

* CLASS D PATCHES,
 TYPE III, 9 INCH

■ SIDEWALK REMOVAL AND
 REPLACEMENT

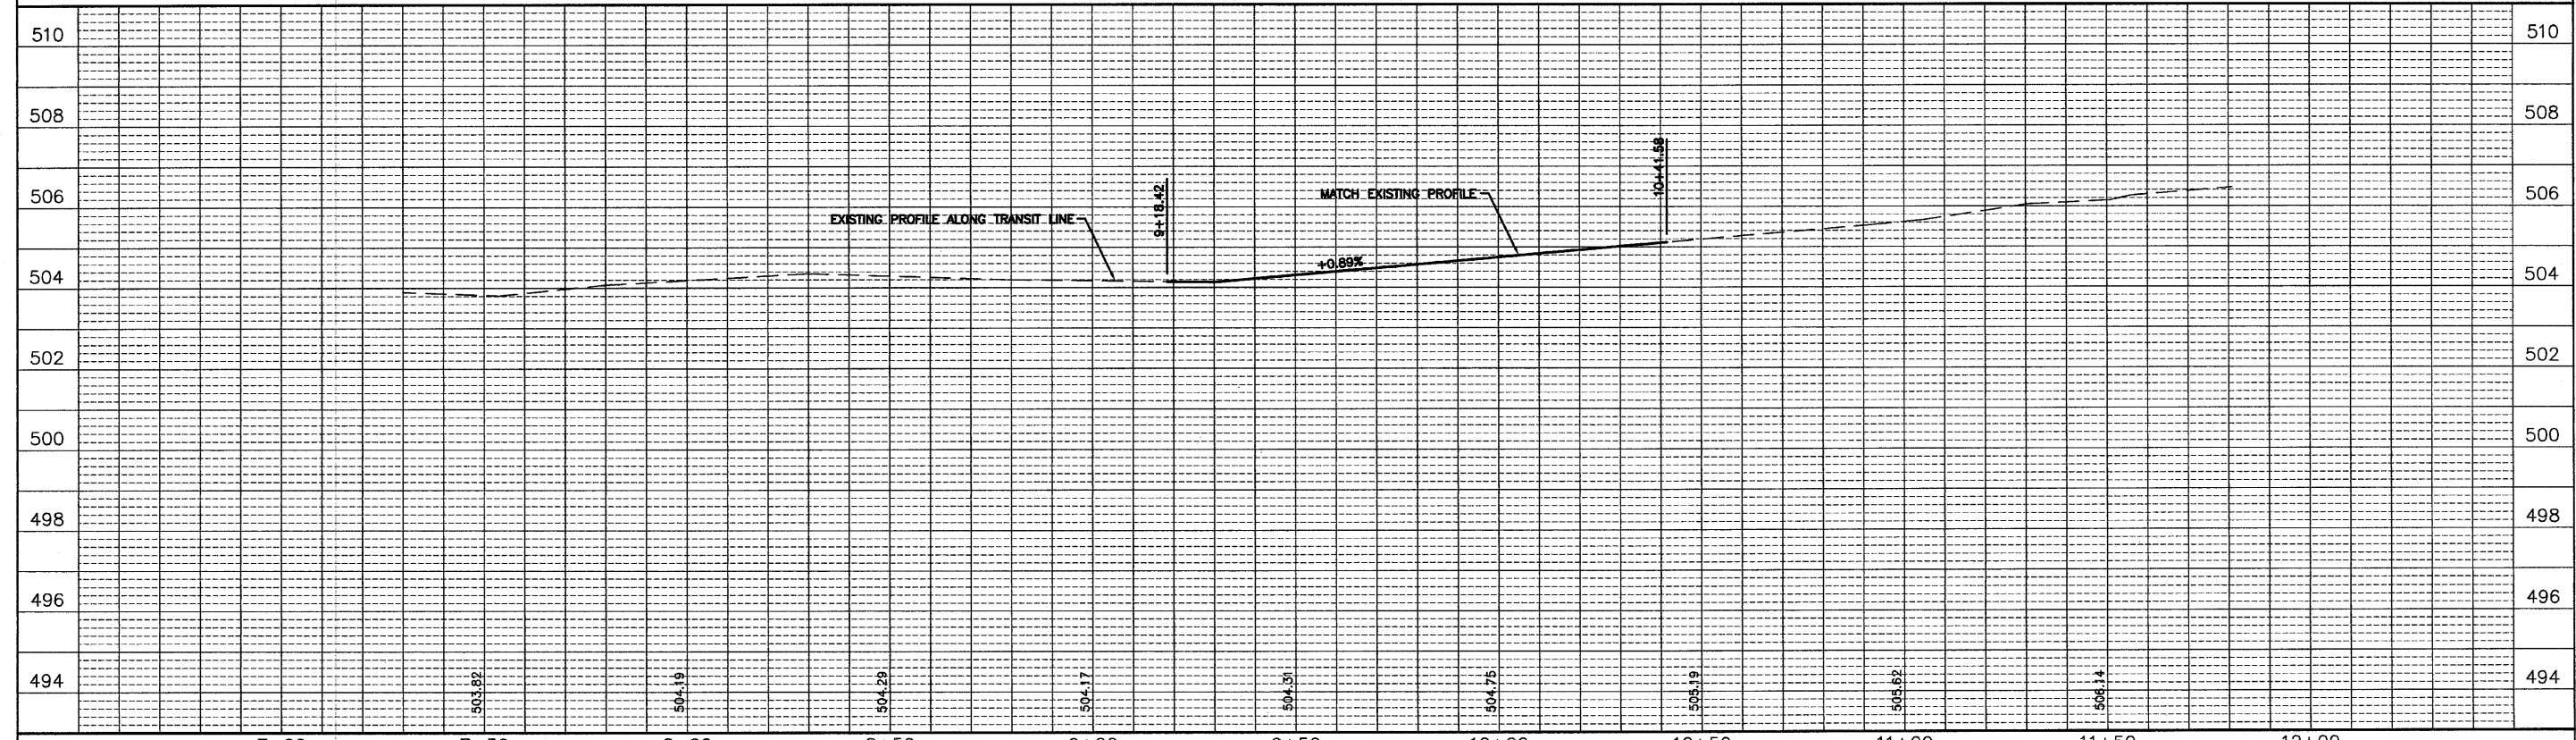

FILE NAME = 004-PLAN-PROF.DWG	USER NAME =	DESIGNED - J.K.C.	REVISED -	FAU 5958 (OTTAWA AVENUE) SECTION 07-00137-00-BR GRUNDY COUNTY	PLAN AND PROFILE		F.A.U. RTE. 5958	SECTION 07-00137-00-BR	COUNTY GRUNDY	TOTAL SHEETS 11	SHEET NO. 4	
	PLOT SCALE = 1"=40'	DRAWN - L.A.G.	REVISED -		SCALE: AS NOTED	SHEET NO. 4 OF 11 SHEETS	STA. _____ TO STA. _____	CONTRACT NO. 87463		ILLINOIS FED. AID PROJECT		
	PLOT DATE = 04/18	CHECKED - J.K.C.	REVISED -									
		DATE - 04/10	REVISED -									