#### 09-19-2025 LETTING ITEM 001

#### **INDEX OF SHEETS**

47-48

49-50

51-52

53-54

55-56

57-58

59-60

21130

9240

12094

20323

4605

10955

10952

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TITLE SHEET

2	LOCATION	N MAP									
3	GENERAL	GENERAL NOTES									
4	SUMMAR	SUMMARY OF QUANTITIES									
5-11	DISTRICT	ONE STANDARD TRAFFIC SIGNAL DESIGN DETAILS									
87-89	DISTRICT	DISTRICT ONE STANDARD TRAFFIC CONTROL & PROTECTION DETA									
SHT. NO.	TS.NO.	INTERSECTION NAME									
12-13	7290	IL RTE 31 AT IL RTE 120									
14-15	14965	BELVIDERE STAT GENESEE RD									
16-17	6708	IL RTE 21 AT CASEY RD									
18-19	7239	US RTE 14 AT DOTY RD									
20-21	21490	IL RTE 21 AT LAKE ST									
22-23	21410	IL RTE 21 AT CORPORATE WOODS PKWY									
24-25	11282	LAKE COOK RD AT APPLEBEE ST									
26-27	1160	US RTE 12 AT OLD HICKS RD									
28-29	3137	IL RTE 58 AT ANTHONY TRAIL									
30-31	4325	IL RTE 25 AT ROBIN RD									
32-33	405	US RTE 12 AT KENNICOTT DR									
34-35	885	IL RTE 72 AT RIVER ST									
36-40	9645	U2 RTE 12 AT BUSINESS CENTER DR									
41-42	9690	US RTE 14 AT PROSPECT RD									
43-44	2865	IL RTE 58 AT WOLF RD									
45-46	5157	IL RTE 58 AT WOODS DR									

BARRINGTON RD AT OLD CHURCH RD

TOUHY AVE AT BUSSE HWY

IL RTE 31 AT MCLEAN BLVD

IL RTE 31 AT SILVER GLEN RD

IL RTE 38 AT ANDERSON BLVD

IL RTE 38 AT 7TH ST

US RTE 20 AT NORTH CIRCLE AVE

61-62 IL RTE 38 AT S. CARLTON AVE 63-64 IL RTE 25 (WASHINGTON ST.) AT WILSON ST 785 65-66 HIGHLAND AVE AT EASTGATE RD 982 67-68 31ST ST AT GOLF VIEW RD 69-70 DES PLAINES AVE AT 31ST ST US RTE 12-20-45 AT HOMESTEAD RD 71-72 13920 73-74 11655 IL RTE 53 AT MAIN ST 75-76 3850 55TH ST AT JOLIET RD 77-78 IL RTE 7 (WOLF RD) AT 153RD ST 79-80 US RTE 45 AT 171ST ST IL RTE 50 AT N GATEWAY DR 83-84 PALATINE RD AT SMITH ST MEACHAM RO AT OLD PLUM GROVE RD

# 0 100' 200' 300' — 1"= 100' 0 50' 100' — 1"= 50' 0 50' 100' — 1"= 40' 0 50' 100' — 1"= 30' 0 50' 100' — 1"= 20'

FULL SIZE PLANS HAVE BEEN PREPARED USING STANDARD ENGINEERING SCALES. REDUCED SIZED PLANS WILL NOT CONFORM TO STANDARD SCALES. IN MAKING MEASUREMENTS ON REDUCED PLANS, THE ABOVE SCALES MAY BE USED.

J.U.L.I.E.
JOINT UTILITY LOCATION INFORMATION FOR EXCAVATION
1-800-892-0123
OR 811


PROJECT ENGINEER: DOUG BRAZELTON PROJECT MANAGER: NICHOLAS BUTLER

## STATE OF ILLINOIS DEPARTMENT OF TRANSPORTATION

## PROPOSED HIGHWAY PLANS


SECTION NO.: 2024-964-TS PROJECT NO.: HSIP-IMTV(030)

VARIOUS ROUTES
APS AND LPI PEDESTRIAN IMPROVEMENTS
DISTRICT 1

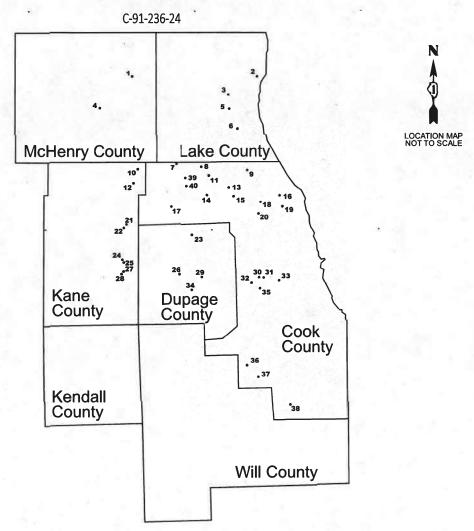

**SEE LOCATION LEGEND ON SHEET 2** 




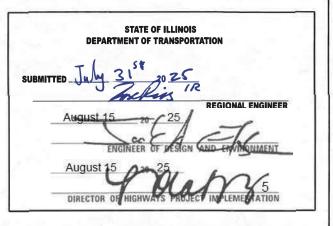

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**REV-SEP** 

**CONTRACT NO. 62W89** 



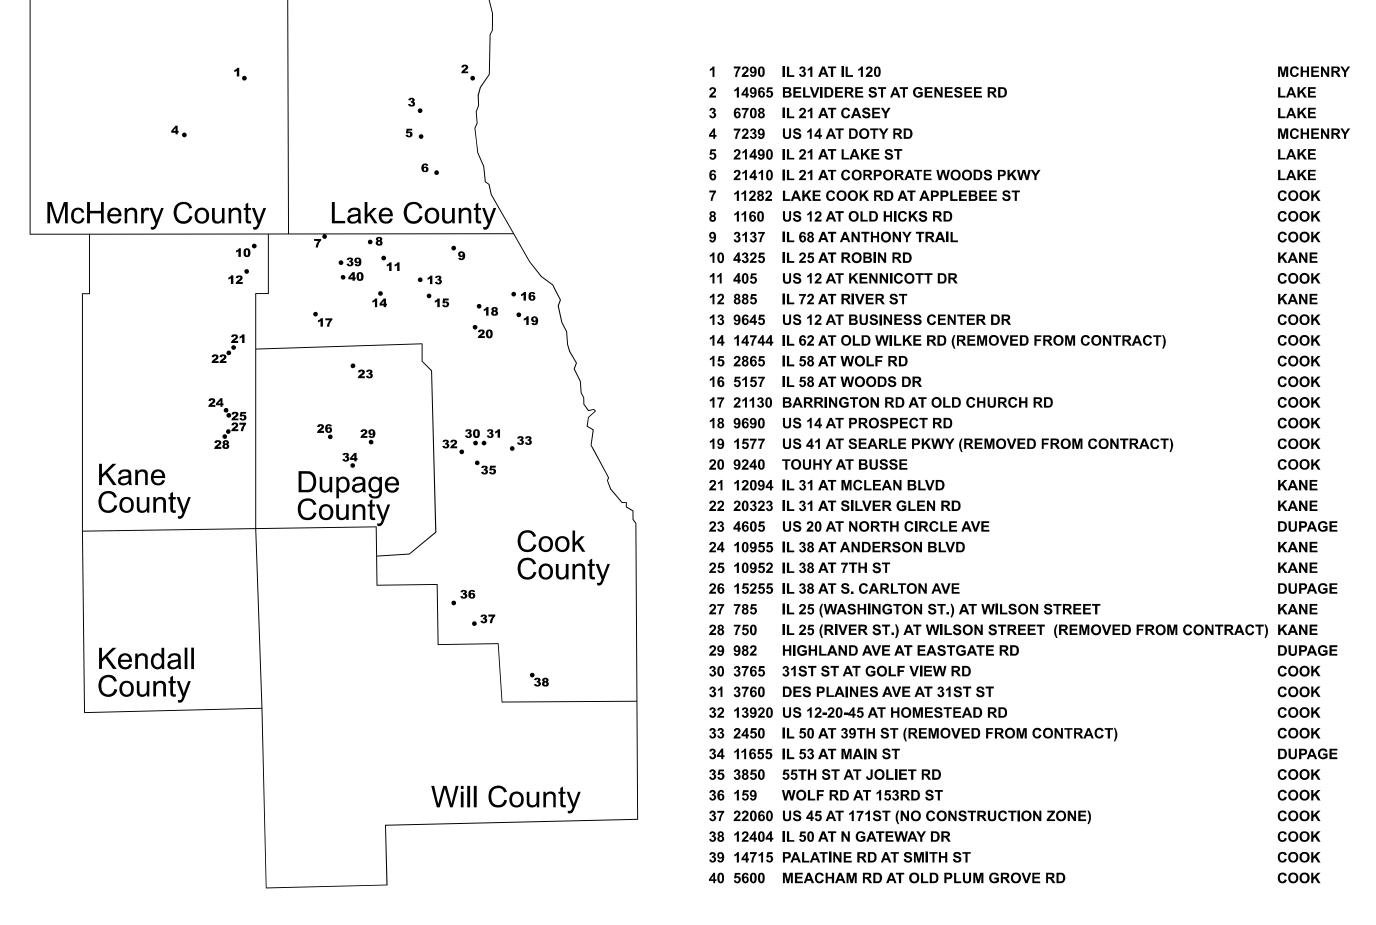

USER NAME = dbriones	DESIGNED - E	DLB	REVISED -
	DRAWN - J	JK	REVISED -
PLOT SCALE = 200.000 ' / in.	CHECKED - E	DB	REVISED -
PLOT DATE = 7/31/2025	DATE - C	07/31/2025	REVISED -

STATE	E 01	F ILLINOIS
DEPARTMENT	0F	TRANSPORTATION

SCALE: N.T.S.

	LOCATIONS MAP						RTE SECTION			COUNTY TOTAL SHEETS		SHEET NO.		
							XXX	2024-9	VARIOUS	89	2			
							MAP-	-1		CONTRACT	NO. 62V	W89		
	SHEET 1 OF 1 SHEETS STA. TO STA.						ILLINOIS	FED. All	D PROJECT					

#### **GENERAL NOTES:**

BEFORE STARTING ANY EXCAVATION, THE CONTRACTOR SHALL CALL "J,U,L,I,E," AT (800) 892-0123 OR 811 FOR FIELD LOCATIONS OF BURIED ELECTRIC, TELEPHONE AND GAS. 45 HOUR NOTIFICATION IS REQUIRED.

THE CONTRACTOR SHALL CONTACT THE TRAFFIC CONTROL SUPERVISOR AT KALPANA.KANNAN-HOSADURGA@ILLINOIS.GOV, 72 HOURS IN ADVANCE OF BEGINNING OF WORK.

IT SHALL BE THE CONTRACTOR'S RESPONSIBILITY TO VERIFY ALL DIMENSIONS AND CONDITIONS EXISTING IN THE FIELD PRIOR TO ORDERING MATERIALS AND BEGINNING CONSTRUCTION. THIS SHALL INCLUDE LOCATING THE MAST ARM FOUNDATIONS AND VERIFYING THE MAST ARM

THE EXACT LOCATION OF ALL UTILITIES SHALL BE FIELD VERIFIED BY THE CONTRACTOR BEFORE ORDERING ANY MATERIALS AND STARTING ANY WORK. FOR LOCATIONS OF UTILITIES, LOCALLY OWNED EQUIPMENT. I EASED ENFORCEMENT CAMERA SYSTEM FACILITIES AND IDOT UNDERGROUND FACILITIES, CONTACT THE LOCAL COUNTIES, MUNICIPALITIES AND IDOT FOR LOCATES. THE CONTRACTOR SHALL CALL"JULIE" AT (800) 892-0123 OR 811, IN THE CITY OF CHICAGO CONTACT DIGGER AT (312) 744-7000 FOR FIELD LOCATIONS OF BURIED UTILITIES (48 HOURS NOTIFICATION REQUIRED).

IF THIS CONTRACT REQUIRES THE SERVICE OF AN ELECTRICAL CONTRACTORS, THE CONTRACTOR SHALL BE RESPONSIBLE AT HIS/HER OWN EXPENSE FOR LOCATING EXISTING IDOT ELECTRICAL FACILITIES PRIOR TO PERFORMING ANY WORK, IF THE CONTRACT DOES NOT REQUIRE THE SERVICE OF AN ELECTRICAL CONTRACTOR, THE CONTRACTOR MAY REQUEST ONE FREE LOCATE FOR EXISTING IDOT ELECTRICAL FACILITIES FROM THE DISTRICT ONE ELECTRICAL MAINTENANCE CONTRACTOR PRIOR TO THE START OF ANY WORK. ADDITIONAL REQUESTS MAY BE AT THE EXPENSE OF THE CONTRACTOR, THE LOCATION OF UNDERGROUND TRAFFIC FACILITIES DOES NOT RELIEVE THE CONTRACTOR OF THEIR RESPONSIBILITY TO REPAIR ANY FACILITIES DAMAGED DURING CONSTRUCTIONS AT THEIR EXPENSE.

THE CONTRACTOR SHALL CHECK THE PROPOSED TRAFFIC SIGNAL EQUIPMENT LOCATIONS FOR UNDERGROUND AND OVERHEAD UTILITY CONFLICTS. THE CONTRACTOR SHALL NOTIFY THE AREA ENGINEER. THE RESIDENT ENGINEER AND ANY IMPACTED UTILITY COMPANY OF CONFLICT. AND SHALL COORDINATE AND RESOLVE THE ISSUE PRIOR TO ORDERING MATERIALS, AND PRIOR TO POURING FOUNDATIONS.

THE CONTRACTOR SHALL COORDINATE CONSTRUCTION ACTIVITIES WITH UTILITY COMPANIES, LOCAL GOVERNMENT AGENCIES AND IDOT.

RESTORATION OF TRAFFIC SIGNAL WORK AREA SHALL BE INCLUDED IN THE RELATED PAY ITEM SUCH AS FOUNDATION, CONDUIT, HANDHOLE, ETC., AND NO EXTRA COMPENSATION SHALL BE ALLOWED. ALL ROADWAY SURFACES SUCH AS SHOULDERS, MEDIAN, SIDEWALKS, PAVEMENT ETC. SHALL BE REPLACED IN KIND. ALL DAMAGE TO MOWED LAWNS SHALL BE REPLACED WITH AN APPROVED SOD, AND ALL DAMAGE TO UNMOWED FIELDS SHALL BE SEEDED IN ACCORDANCE WITH STANDARD SPECIFICATIONS 252 AND 250 RESPECTIVELY.

PARTIAL PAYMENT AS DESCRIBED IN ARTICLE 109.09(b) OF STANDARD SPECIFICATIONS WILL NOT BE ALLOWED FOR ITEMS INCLUDED IN THIS CONTRACTS.

MAINLINE AND SIDE ROAD "ROAD CONSTRUCTION AHEAD" SIGNS SHALL REMAIN INSTALLED AT LOCATIONS WHERE ROADWAY HAZARDS WITHIN THE WORK ZONE WILL REMAIN OVERNIGHT.

#### **HIGHWAY STANDARDS**

886001-01

STD. NO.	TITLE
000001-08	STANDARD SYMBOLS, ABBREVIATIONS AND PATTERNS
001006	DECIMAL OF AN INCH AND OF A FOOT
280001-07	TEMPORARY EROSION CONTROL SYSTEMS
701001-02	OFF-ROAD OPERATIONS 2L, 2W, MORE THAN 15' AWAY
701006-05	OFF-ROAD OPERATIONS 2L, 2W, 15' TO 24" FROM PAVEMENT EDGE
701101-05	OFF-ROAD OPERATIONS MULTILANE, 15' TO 24" FROM PAVEMENT EDGE
701106-02	OFF-ROAD OPERATIONS, MULTILANE, MORE THAN 15' AWAY
701501-06	URBAN LANE CLOSURE, 2L, 2W, UNDIVIDED
701502-09	URBAN LANE CLOSURE, 2L, 2W, WITH BIDIRECTIONAL LEFT TURN LANE
701601-09	URBAN LANE CLOSURE, MULTILANE, TW OR 2W WITH NONTRAVERSABLE MEDIAN
701606-10	URBAN SINGLE LANE CLOSURE, MULTILANE, 2W WITH MOUNTABLE MEDIAN
701701-10	URBAN LANE CLOSURE, MULTILANE INTERSECTION
701801-06	SIDEWALK, CORNER OR CROSSWALK CLOSURE
720001-01	SIGN PANEL MOUNTING DETAILS
720006-04	SIGN PANEL ERECTION DETAILS
701901-10	TRAFFIC CONTROL DEVICES
805001-01	ELECTRICAL SERVICE INSTALLATION DETAILS
857001-01	STANDARD PHASE DESIGNATION DIAGRAMS AND PHASE SEQUENES
857006-04	SUPERVISED RAILROAD INTERCONNECT CIRCUIT
862001-01	UNINTERRUPTABLE POWER SUPPLY (UPS)
873001-02	TRAFFIC SIGNAL GROUNDING & BONDING
876001-04	PEDESTRIAN PUSH BUTTON POST
878001-11	CONCRETE FOUNDATION DETAILS
880006-01	TRAFFIC SIGNAL MOUNTING DETAILS

DETECTOR LOOP INSTALLATIONS

TYPICAL LAYOUT FOR DETECTION LOOPS

ATLAS
TTI LAS
ATLAS TECHNICAL CONSULTANTS, LLC
100 S. WACKER DRIVE, SUITE 400
CHICAGO, IL 60606

USER NAME = dbriones	DESIGNED	-	DLB	REVISED -
	DRAWN	-	JK	REVISED -
PLOT SCALE = 40.000 '/in.	CHECKED	-	DB	REVISED -
PLOT DATE = 7/31/2025	DATE	-	07/31/2025	REVISED -

STATE OF ILLINOIS **DEPARTMENT OF TRANSPORTATION** 

SCALE: N.A.

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APS A	ND	LPI P	FDF	STRIAN	IMPROVEMENT:	3	F.A.U. RTE.	SECTION	COUNTY	TOTAL SHEETS	SHEET NO.
	GENERAL NOTES						xxx	2024-964-TS	VARIOUS	89	3
							ļ	GEN-1	CONTRACT NO. 62W89		
SHEET 1 OF 1 SHEETS STA.					STA.	TO STA.		ILLINOIS FED. AL	D PROJECT		

#### **SUMMARY OF QUANTITIES**

CONSTRUCTION CODE HSIP FUNDS

				90% FED / 10% STATE
0005			TOTAL	TRAFFIC SIGNALS
CODE NO.	ITEM	UNIT	QUANTITY	0021
110.			QUANTITI	URBAN
28000400	PERIMETER EROSION BARRIER	FOOT	496	496
66900200	NON-SPECIAL WASTE DISPOSAL	CU YD	70	70
66900530	SOIL DISPOSAL ANALYSIS	EACH	5	5
66901001	REGULATED SUBSTANCES PRE-CONSTRUCTION PLAN	LSUM	1	1
66901003	REGULATED SUBSTANCES FINAL CONSTRUCTION REPORT	LSUM	1	1
66901006	REGULATED SUBSTANCES MONITORING	CAL DA	56	56
67000400	ENGINEER'S FIELD OFFICE, TYPE A	CAL MO	9	9
67100100	MOBILIZATION	LSUM	1	1
70102620	TRAFFIC CONTROL AND PROTECTION, STANDARD 701501	LSUM	1	1
70102622	TRAFFIC CONTROL AND PROTECTION, STANDARD 701502	LSUM	1	1
70102630	TRAFFIC CONTROL AND PROTECTION, STANDARD 701601	L SUM	1	1
70102625	TRAFFIC CONTROL AND PROTECTION, STANDARD 701606	L SUM	1	1
70102635	TRAFFIC CONTROL AND PROTECTION, STANDARD 701701	L SUM	1	1
70102640	TRAFFIC CONTROL AND PROTECTION, STANDARD 701801	LSUM	1	1
72000100	SIGN PANEL - TYPE 1	SQ FT	5	5
81028200	UNDERGROUND CONDUIT, GALVANIZED STEEL, 2" DIA.	FOOT	1048	1048
81028220	UNDERGROUND CONDUIT, GALVANIZED STEEL, 3" DIA.	FOOT	48	48
85000200	MAINTENANCE OF EXISTING TRAFFIC SIGNAL INSTALLATION	EACH	35	35
87301215	ELECTRIC CABLE IN CONDUIT, SIGNAL NO. 14 2C	FOOT	8148	8148
87301225	ELECTRIC CABLE IN CONDUIT, SIGNAL NO. 14 3C	FOOT	839	839
87301245	ELECTRIC CABLE IN CONDUIT, SIGNAL NO. 14 5C	FOOT	195	195
87301255	ELECTRIC CABLE IN CONDUIT, SIGNAL NO. 14 7C	FOOT	129	129
87501200	TRAFFIC SIGNAL POST, 16 FT.	EACH	2	2
87301305	ELECTRIC CABLE IN CONDUIT, LEAD-IN, NO. 14 1 PAIR	FOOT	13131	13131
87301805	ELECTRIC CABLE IN CONDUIT, SERVICE, NO. 6 2 C	FOOT	549	549
87301900	ELECTRIC CABLE IN CONDUIT, EQUIPMENT GROUNDING CONDUCTOR, NO. 6 1C	FOOT	2170	2170
87800100	CONCRETE FOUNDATION, TYPE A	FOOT	60	60
87900200	DRILL EXISTING HANDHOLE	EACH	52	52
88030020	SIGNAL HEAD, LED, 1-FACE, 3-SECTION, MAST-ARM MOUNTED	EACH	4	4
88030050	SIGNAL HEAD, LED, 1-FACE, 3-SECTION, BRACKET MOUNTED	EACH	4	4
88030100	SIGNAL HEAD, LED, 1-FACE, 5-SECTION, BRACKET MOUNTED	EACH	2	2
88030110	SIGNAL HEAD, LED, 1-FACE, 5-SECTION, MAST-ARM MOUNTED	EACH	2	2
88102717	PEDESTRIAN SIGNAL HEAD, LED, 1-FACE, BRACKET MOUNTED WITH COUNTDOWN TIMER	EACH	18	18
88200410	TRAFFIC SIGNAL BACKPLATE, LOUVERED, FORMED PLASTIC	EACH	6	6
88500100	INDUCTIVE LOOP DETECTOR	EACH	37	37
88600100	DETECTOR LOOP, TYPE I	FOOT	194	194
89501250	RELOCATE EXISTING TRAFFIC SIGNAL EQUIPMENT	EACH	6	6
89501230	RELOCATE EXISTING TRAFFIC SIGNAL EQUIPMENT  RELOCATE EXISTING EMERGENCY VEHICLE PRIORITY SYSTEM, PHASING UNIT	EACH	8	8
89502200	MODIFY EXISTING CONTROLLER	EACH	6	6
	REMOVE ELECTRIC CABLE FROM CONDUIT			
89502300 89502375	REMOVE EXISTING TRAFFIC SIGNAL EQUIPMENT	FOOT EACH	4761	4761 35
	REBUILD EXISTING HANDHOLE	!	35	
89502376		EACH	2	2
89502385	REMOVE EXISTING CONCRETE FOUNDATION	EACH	4	4
X1400144	UNINTERRUPTABLE POWER SUPPLY AND CABINET, SPECIAL	EACH	6	6
X1400150	SERVICE INSTALLATION, GROUND MOUNTED, METERED	EACH	15	15
X1400367	PEDESTRIAN SIGNAL POST, 10 FT.	EACH	5	5
X1400378	PEDESTRIAN SIGNAL POST, 5 FT.	EACH	45	45
X1400486	UNINTERRUPTABLE POWER SUPPLY-UPS	EACH	2	2
X2010516	SELECTIVE CLEARING	UNIT	3	3
X7200061	TEMPORARY INFORMATION SIGNING	SQ FT	2853	2853

Μ					CONSTRUCTION CODE
					HSIP FUNDS
Ξ					90% FED / 10% STATE
	0005			TOTAL	TRAFFIC SIGNALS
	CODE NO.	ITEM	UNIT	QUANTITY	0021
	140.			QUANTITY	URBAN
	X8040108	ELECTRIC METER	EACH	1	1
	X8510204	PAINT NEW PEDESTRIAN PUSH-BUTTON POST	EACH	24	24
	X8570215	FULL-ACTUATED CONTROLLER IN EXISTING CABINET	EACH	11	11
	X8570226	FULL-ACTUATED CONTROLLER AND TYPE IV CABINET (SPECIAL)	EACH	6	6
	X8571215	RAILROAD, FULL-ACTUATED CONTROLLER AND TYPE IV CABINET (SPECIAL)	EACH	1	1
	X8620200	UNINTERRUPTABLE POWER SUPPLY (SPECIAL)	EACH	2	2
	X8620310	REMOVE AND REPLACE BATTERIES FOR UNINTERUPTABLE POWER SUPPLY, EXTENDED	EACH	17	17
	X8760200	ACCESSIBLE PEDESTRIAN SIGNALS	EACH	136	136
	X8780012	CONCRETE FOUNDATION, TYPE A 12-INCH DIAMETER	FOOT	200	200
	X8809005	LED SIGNAL FACE, LENS COVER	EACH	13	13
	Z0013798	CONSTRUCTION LAYOUT	L SUM	1	1
	Z0033044	RE-OPTIMIZE TRAFFIC SIGNAL SYSTEM LEVEL 1	EACH	34	34
	Z0033046	RE-OPTIMIZE TRAFFIC SIGNAL SYSTEM LEVEL 2	EACH	2	2
	Z0048665	RAILROAD PROTECTIVE LIABILITY INSURANCE	L SUM	1	1
	Ø Z0076600	TRAINEES	HOUR	500	500
	Ø Z0076604	TRAINEES-TRAINING PROGRAM GRADUATE	HOUR	500	500

ATLAS
ATLAS TECHNICAL CONSULTANTS, LLC
100 S. WACKER DRIVE, SUITE 400

USER NAME = dbriones	DESIGNED -	DLB	REVISED -	
	DRAWN -	JK	REVISED -	
PLOT SCALE = 40.000 '/in.	CHECKED -	DB	REVISED -	
PLOT DATE = 8/4/2025	DATE -	07/31/2025	REVISED -	

STATE OF ILLINOIS
DEPARTMENT OF TRANSPORTATION

		•						F.A.U. RTE.	SEC	TION		COUNTY	SH
SUMMARY OF QUANTITIES								XXX	2024-9	64-TS		VARIOUS	Г
								ļ	S0Q-	1		CONTRACT	N
SCALE: N.A.	SHEET	1	OF	1	SHEETS	STA.	TO STA.	ILLINOIS FED. AJI			D PROJECT		

### TRAFFIC SIGNAL LEGEND

(NOT TO SCALE)

				(NOT TO SCALE)				
пем	<u>EXISTING</u>	PROPOSED	ITEM	EXISTING	PROPOSED	ІТЕМ	EXISTING	PROPOSED
CONTROLLER CABINET	$\boxtimes$	$\blacksquare$	HANDHOLE -SQUARE			SIGNAL HEAD -(P) PROGRAMMABLE SIGNAL HEAD	R Y	R
COMMUNICATION CABINET	ECC	CC	-ROUND			-(F) FROGRAMMABLE SIGNAL HEAD		Y G G G G G G G G G G G G G G G G G G G
MASTER CONTROLLER	ЕМС	MC	HEAVY DUTY HANDHOLE -SQUARE -ROUND	H H	⊞ ⊕		E E E E E E E E E E E E E E E E E E E	4Y 4G 4G
MASTER MASTER CONTROLLER	EMMC	ммс	DOUBLE HANDHOLE			SIGNAL HEAD WITH BACKPLATE		R R R
UNINTERRUPTABLE POWER SUPPLY	4	7	JUNCTION BOX		•	-(P) PROGRAMMABLE SIGNAL HEAD -(RB) RETROREFLECTIVE BACKPLATE		YYY
SERVICE INSTALLATION	-D-P	- <b>■</b> -	RAILROAD CANTILEVER MAST ARM	X <del>OX X</del> X	IOI I	de destro de la respectación e e tropica destruír. Esta transcriptura de la composición del composición de la composición de la composición del composición de la composición de la composición de la composición del composición de la composición de la composición del composició		C ← Y ← Y ← G ← G
-(P) POLE MOUNTED  SERVICE INSTALLATION			RAILROAD FLASHING SIGNAL	<del>∑⊙</del> ∑	<b>Y</b> ◆¥		P RB	P RB
-(G) GROUND MOUNTED -(GM) GROUND MOUNTED METERED	⊠ <sup>G</sup> ⊠ <sup>GM</sup>	■ G ■ GM	RAILROAD CROSSING GATE	<del>₹0</del> ₹>	X•¥	PEDESTRIAN SIGNAL HEAD		
TELEPHONE CONNECTION	ET	T	RAILROAD CROSSBUCK	五	*	AT RAILROAD INTERSECTIONS	<b>©</b> <b>S</b>	Ā
STEEL MAST ARM ASSEMBLY AND POLE	O	•	RAILROAD CONTROLLER CABINET		<b>≯</b> ∢	PEDESTRIAN SIGNAL HEAD WITH COUNTDOWN TIMER	<b>(</b>	<b>₽</b> C <b>★</b> D
ALUMINUM MAST ARM ASSEMBLY AND POLE			UNDERGROUND CONDUIT (UC), GALVANIZED STEEL	· ·	2 <u>4</u> 2)			
STEEL COMBINATION MAST ARM ASSEMBLY AND POLE WITH LUMINAIRE	o <del>`</del> ¤—	•*	TEMPORARY SPAN WIRE, TETHER WIRE, AND CABLE	/	* <u>********</u> ***	ILLUMINATED SIGN "NO LEFT TURN"/"NO RIGHT TURN"		<b>(9)</b>
SIGNAL POST -(BM) BARREL MOUNTED - TEMPORARY	0	<ul> <li>● BM</li> </ul>	SYSTEM ITEM	S	SP	NUMBER OF CONDUCTORS, ELECTRIC CABLE NO. 14, UNLESS NOTED OTHERWISE.	_5_	
WOOD POLE	$\otimes$	•	INTERSECTION ITEM	1	IP	ALL DETECTOR LOOP CABLE TO BE SHIELDED  GROUND CABLE IN CONDUIT,		_
GUY WIRE	>-	>-	REMOVE ITEM  RELOCATE ITEM		R RL	NO. 6 SOLID COPPER (GREEN)	1#6	146
SIGNAL HEAD	>		ABANDON ITEM		A	ELECTRIC CABLE IN CONDUIT, TRACER NO. 14 1/C	<u>—</u> 1	
SIGNAL HEAD WITH BACKPLATE	+6>	+	CONTROLLER CABINET AND		RCF	COAXIAL CABLE	<u> </u>	—c—
SIGNAL HEAD OPTICALLY PROGRAMMED	> <sup>P</sup> +-> <sup>P</sup>	→ P + → P	FOUNDATION TO BE REMOVED		RCF	VENDOR CARLE	F	
FLASHER INSTALLATION -(FS) SOLAR POWERED	o⇔ <sup>F</sup> o⇔ <sup>FS</sup>	•►F •►FS	MAST ARM POLE AND FOUNDATION TO BE REMOVED		RMF	VENDOR CABLE	—	_ <u>_</u>
-(F3) SOLAR POWERED	DH> <sup>F</sup> DH> <sup>FS</sup>	<b>₽</b> → FS	SIGNAL POST AND FOUNDATION TO BE REMOVED		RPF	COPPER INTERCONNECT CABLE, NO. 18, 3 PAIR TWISTED, SHIELDED	6#18	<del></del>
PEDESTRIAN SIGNAL HEAD	-0	$\mathbf{H}$	DETECTOR LOOP, TYPE I			FIBER OPTIC CABLE -NO. 62.5/125, MM12F	12F	—(12F)—
PEDESTRIAN PUSH BUTTON -(APS) ACCESSIBLE PEDESTRIAN PUSH BUTTON	⊚		PREFORMED DETECTOR LOOP	PP	PP	NO. 62.5/125, MM12F SM12F -NO. 62.5/125, MM12F SM24F		
RADAR DETECTION SENSOR	R	R	SAMPLING (SYSTEM) DETECTOR	s s	s s			
VIDEO DETECTION CAMERA		<b>○</b>	INTERSECTION AND SAMPLING (SYSTEM) DETECTOR	15 (15)	IS (IS)	GROUND ROD	C M D C	C M D S
RADAR/VIDEO DETECTION ZONE			QUEUE AND SAMPLING (SYSTEM) DETECTOR	QS QS	QS QS	-(C) CONTROLLER -(M) MAST ARM	$\stackrel{\dot{=}}{\overline{\downarrow}}^C  \stackrel{\dot{=}}{\overline{\downarrow}}^M  \stackrel{\dot{=}}{\overline{\downarrow}}^P  \stackrel{\dot{=}}{\overline{\downarrow}}^S$	Ť Ť Ť
PAN, TILT, ZOOM (PTZ) CAMERA	PTZ	PIZ	WIRELESS DETECTOR SENSOR	(10)	<b>o</b>	-(P) POST -(S) SERVICE		
EMERGENCY VEHICLE LIGHT DETECTOR	$\triangleleft$	-	WIRELESS ACCESS POINT		-			
CONFIMATION BEACON	<b>⊶</b> (1	-4						
WIRELESS INTERCONNECT	○ <del>+   </del>	••••						
WIRELESS INTERCONNECT RADIO REPEATER	ERR	RR						

ATLAS
ATLAS
ATLAS TECHNICAL CONSULTANTS, LLC
100 S. WACKER DRIVE, SUITE 400

	USER NAME = dbriones	DESIGNED	-	DLB	REVISED -	
,		DRAWN	×	JK	REVISED -	
.c	PLOT SCALE - 40.000 ' / in.	CHECKED	-	DB	REVISED -	
	PLOT DATE = 7/31/2025	DATE	-	07/31/2025	REVISED -	

STATE 0	F ILLINOIS
DEPARTMENT OF	TRANSPORTATION


SCALE: NONE

8377	DISTRICT ONE				F.A.U. RTE.	SECTION	COUNTY	TOTAL SHEETS	SHEET NO.	
STANDAR	STANDARD TRAFFIC SIGNAL DESIGN DETAILS					XXX	2024-964-TS	VARIOUS	89	5
OTATIONID THATTIC CIGINE DECIGIT DETAILS							TS-5	CONTRACT	NO. 62\	V89
SHEET	1 OF	7	SHEETS	STA	TO STA		ILLINOIS FED AL	D DDO JECT		


#### LOOP DETECTOR NOTES

- 1. EACH PAIR OF LOOP WIRES SHALL BE PLACED IN A SEPARATE EMPTY COILABLE NONMETALLIC CONDUIT FROM THE EDGE OF PAVEMENT TO THE HANDHOLE. SPACING BETWEEN THE HOLES DRILLED IN THE PAVEMENT SHALL NOT BE LESS THAN 6" (150 mm). EMPTY COILABLE NONMETALLIC CONDUIT SHALL BE INCLUDED IN THE COST OF THE LOOP WIRE.
- 2. THE NUMBER OF LOOP TURNS SHALL BE AS RECOMMENDED BY THE AMPLIFIER MANUFACTURER. ALL ADJACENT SIDES OF THE LOOPS SHALL BE INSTALLED IN SUCH A WAY THAT THE CURRENT FLOW IS IN THE SAME DIRECTION TO REINFORCE ITS MAGNETIC FIELDS FOR SMALL VEHICLE DETECTION.
- 3. EACH LOOP LEAD-IN SHALL BE IDENTIFIED AND PERMANENTLY TAGGED IN THE HANDHOLE. EACH LEAD-IN CABLE TAG SHALL INDICATE THE LOCATION OF THE LOOP, LOOP ROTATION (CLOCKWISE/COUNTERCLOCKWISE), LOOP LEAD-IN DIRECTION (IN OR OUT), LOOP CABLE NUMBER AND LOCATION IN CABINET, AND NUMBER OF TURNS IN THE DETECTOR LOOPS IN WATER PROOF INK AS INDICATED ON THE DISTRICT 1 STANDARD TRAFFIC SIGNAL DESIGN DETAIL. THE CONTRACTOR SHALL MARK LOOP LOCATIONS ON RECORD DRAWINGS AND PRESENT TO THE ENGINEER AFTER FINAL INSPECTION. LOOPS SHALL BE MARKED BY LANE AND LOOP NUMBER. SEE DETAIL BELOW.
- 4. ALL LOOP CABLE SHALL BE FASTENED WITH PLASTIC TIE WRAP TO THE HANDHOLE HOOKS.
- 5. IN ASPHALT PAVEMENT, LOOPS SHOULD BE PLACED IN THE BINDER AND DIVEHOLES MARKED AT THE CURB WITH A SAW-CUT. THE SAW-CUT SHALL BE CUT IN ACCORDANCE WITH LOCAL AND E.P.A. DUST CONTROL REQUIREMENTS. DETECTOR LOOP(S) SHALL NOT BE INSTALLED IN WET CONDITIONS AND THE SAW-CUTS MUST BE FREE OF DEBRIS AND RESIDUE SUCH AS DUST AND WATER WHICH IS TO BE ACHIEVED BY THE USE OF COMPRESSED AIR, WIRE BRUSHING AND HEAT DRYING ACCORDING TO SEALANT MANUFACTURER REQUIREMENTS. THE DETECTOR WIRE SHALL BE HELD IN PLACE BY THE USE OF FORM WEDGES. WEDGES SHALL BE SPACED NO MORE THAN 18" (450 mm) APART.
- 6. LOOP SPLICES SHALL BE SOLDERED USING A SOLDERING IRON. BLOW TORCHES OR OTHER DEVICES WHICH OXIDIZE COPPER CABLE SHALL NOT BE ALLOWED FOR SOLDERING OPERATIONS. SEE DETAIL BELOW RIGHT.
- 7. PREFORMED DETECTOR LOOPS SHALL BE USED, AS SHOWN ON THE PLANS, WHERE NEW CONCRETE PAVEMENT IS PROPOSED. THE INSTALLATION OF PREFORMED LOOPS SHALL BE IN ACCORDANCE WITH THE DISTRICT 1 SPECIFICATIONS OR AS DIRECTED BY THE ENGINEER.

#### LOOP LEAD-IN CABLE TAG

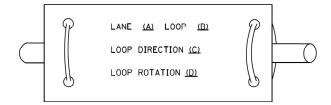



- A. LANE 1 IS THE LANE CLOSEST TO THE CENTERLINE OF THE ROADWAY
- B. LOOP #1 IS THE LOOP IN THE LANE CLOSEST TO THE INTERSECTION.
- C. LABEL LOOP CABLE "IN" OR LOOP CABLE "OUT".
- D. LABEL LOOP CABLE CLOCKWISE OR LOOP CABLE COUNTERCLOCKWISE.

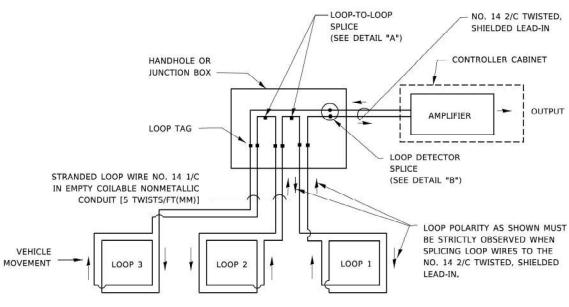

#### **DETECTOR LOOP WIRING SCHEMATIC**

- LOOPS SHALL BE SPLICED IN SERIES. SAW-CUTS SHALL BE A MINIMUM WIDTH OF 5/16" (8 mm).
- SAW-CUT DEPTHS SHALL BE 3" (75 mm), IF IN CONCRETE.
- . THE SAW-CUT DEPTH SHALL BE TO THE TOP OF THE REINFORCEMENT.
- LOOP CORNERS SHALL BE DRILLED WITH A 2" (50 mm) DIAMETER CORE.

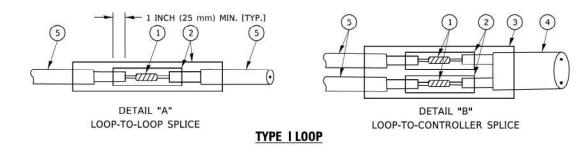

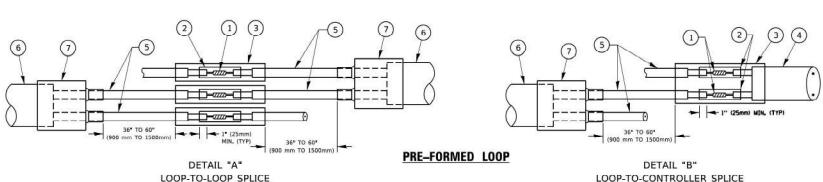

#### LOOP DETECTOR SPLICE

- WESTERN UNION SPLICE SOLDERED WITH ROSIN CORE FLUX. ALL EXPOSED SURFACES OF THE SOLDER SHALL BE SMOOTH. THE WESTERN UNION SPLICES SHALL BE STAGGERED.
- (2) WCSMW 30/100 HEAT SHRINK TUBE, MINIMUM LENGTH 3" (75 mm), UNDERWATER GRADE.
- 3) WCS 200/750 HEAT SHRINK TUBE, MINIMUM LENGHT 6" (150 mm), UNDERWATER GRADE

SCALE: NONE

(4) NO. 14 2/C TWISTED, SHIELDED CABLE.

- 5 LOOP CONDUCTOR WITH FLEXIBLE PLASTIC TUBE. PRE-FORMED LOOP
- (6) XL POLYOLEFIN 2 CONDUCTOR
- (7) BREAKOUT SEALS. TYCO CBR-2 OR APPROVED EQUAL




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DISTRICT ONE				F.A.U. RTE.	SECTION	COUNTY	TOTAL SHEETS	SHEET NO.			
STANDARD TRAFFIC SIGNAL DESIGN DETAILS					XXX	2024-964-TS	VARIOUS	89	6		
OTATIONIS THATTO SIGNAL DESIGN DETAILS						22171120	_	TS-5	CONTRACT	NO. 62\	V89
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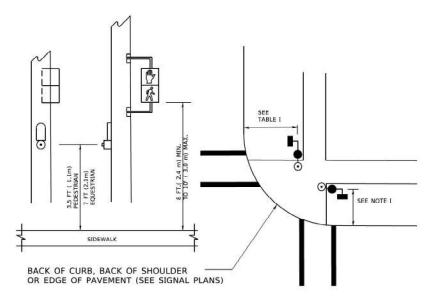
#### TRAFFIC SIGNAL MAST ARM AND SIGNAL POST

MAST ARM MOUNTED SIGNALS IN EXISTING, PROPOSED OR FUTURE SIDEWALK/BICYCLE PATH AREA. INTERSECTION SHOWN WITH PEDESTRIAN SIGNALS AND




- 2. REFER TO THE TRAFFIC SIGNAL EQUIPMENT OFFSET TABLE.
- PROVIDE A LEVEL ALL-WEATHER SURFACE (CONCRETE SIDEWALK, ASPHALT BICYCLE PATH SURFACE OR MATCHING MATERIAL TO THE ADJACENT SURFACE) UP TO THE MAST ARM SHAFT OR THE SIGNAL POST.
- THE FACE OF THE PEDESTRIAN PUSHBUTTON SHALL BE PARALLEL TO THE CROSSWALK TO BE USED.
- THE LOCATIONS AND INSTALLATION OF PEDESTRIAN SIGNAL HEADS AND PEDESTRIAN PUSHBUTTONS SHALL MEET THE REQUIREMENTS OF THE MUTCD AND INFORMATION FOUND IN THE "AMERICANS WITH DISABILITIES ACT ACCESSIBILITY GUIDELINES FOR BUILDINGS AND FACILITIES."
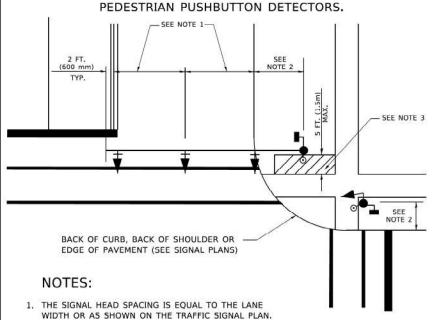
## PEDESTRIAN SIGNAL POST AND PEDESTRIAN PUSH BUTTON POST



#### NOTES:

- 1. REFER TO THE TRAFFIC SIGNAL EQUIPMENT OFFSET TABLE.
- PROVIDE A LEVEL ALL-WEATHER SURFACE (CONCRETE SIDEWALK, ASPHALT BICYCLE PATH SURFACE OR MATCHING MATERIAL TO THE ADJACENT SURFACE) UP TO THE PEDESTRIAN SIGNAL POST OR THE PEDESTRIAN PUSH BUTTON POST.
- THE FACE OF THE PEDESTRIAN PUSHBUTTON SHALL BE PARALLEL TO THE CROSSWALK TO BE USED.
- 4. THE LOCATIONS AND INSTALLATION OF PEDESTRIAN SIGNAL HEADS AND PEDESTRIAN PUSHBUTTONS SHALL MEET THE REQUIREMENTS OF THE MUTCD AND INFORMATION FOUND IN THE "AMERICANS WITH DISABILITIES ACT ACCESSIBILITY GUIDELINES FOR BUILDINGS AND FACILITIES."

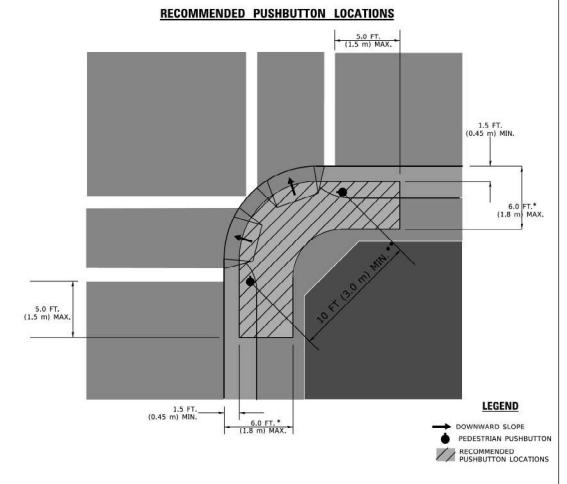

- \* WHERE THERE ARE CONSTRAINTS THAT MAKE IT IMPRACTICAL TO PLACE THE PEDESTRIAN PUSHBUTTON BETWEEN 1.5 FT (0.45 m) AND 6 FT ( 1.8 m) FROM THE EDGE OF THE CURB, SHOULDER, OR PAVEMENT, IT SHOULD NOT BE FURTHER THAN 10 FT (3 m) FROM THE EDGE OF CURB, SHOULDER, OR PAVEMENT.
- \*\* WHERE THERE ARE CONSTRAINTS ON A PARTICULAR CORNER THAT MAKE IT IMPRACTICAL TO PROVIDE THE 10 FT (3 m) SEPERATION BETWEEN THE TWO PEDESTRIAN PUSHBUTTONS, THE PUSHBUTTONS MAY BE PLACED CLOSER TOGETHER OR ON THE SAME POLE.

#### NOTES:

- PEDESTRIAN SIGNAL HEADS SHALL BE MOUNTED WITH THE BOTTOM OF THE SIGNAL HOUSING INCLUDING BRACKETS NOT LESS THAN 8 FT (2.4 m) OR MORE THAN 10 FT (3 m) ABOVE SIDEWALK LEVEL, AND SHALL BE POSITIONED AND ADJUSTED TO PROVIDE MAXIMUM VISIBILITY AT THE BEGINNING OF THE CONTROLLED CROSSWALK.
- THE BOTTOM OF THE SIGNAL HOUSING (INCLUDING BRACKETS) OF A VEHICULAR SIGNAL FACE THAT IS NOT LOCATED OVER A HIGHWAY SHALL BE AT LEAST 8 FT (2.4 m) BUT NOT MORE THAN 19 FT (5.8 m) ABOVE THE SIDEWALK OR, IF THERE IS NO SIDEWALK, ABOVE THE PAVEMENT GRADE AT THE CENTER OF THE ROADWAY.
- 3. THE BOTTOM OF THE SIGNAL HOUSING AND ANY RELATED ATTACHMENTS TO A SIGNAL FACE LOCATED OVER ANY PORTION OF A HIGHWAY SHALL BE ACCORDING TO CURRENT STATE STANDARDS 877001, 877002, 877006, 877011 AND 877012 WITH A MINIMUM OF 16 FT (5.0 m) AND A MAXIMUM OF 18 FT. (5.5 m) FROM THE HIGHEST POINT OF PAVEMENT.
- 4. THE BOTTOM OF THE TEMPORARY SPAN WIRE MOUNTED SIGNAL HOUSING AND ANY RELATED ATTACHMENTS TO A SIGNAL FACE LOCATED OVER ANY PORTION OF A HIGHWAY SHALL BE ACCORDING TO CURRENT STATE STANDARD 880001 WITH A MINIMUM OF 17 FT (5.18 m) FROM THE HIGHEST POINT OF PAVEMENT.
- THE TOP OF THE SIGNAL HOUSING OF A SIGNAL FACE LOCATED OVER ANY PORTION OF A HIGHWAY SHALL NOT BE MORE THAN 25.6 FT (7.8 m) ABOVE THE PAVEMENT.

#### TRAFFIC SIGNAL EQUIPMENT OFFSET

		ADE STATE OF THE S
TRAFFIC SIGNAL EQUIPMENT	COMBINATION CONCRETE CURB AND GUTTER (MINIMUM DISTANCE FROM BACK OF CURB TO CENTERLINE OF FOUNDATION)	SHOULDER/NON-CURBED AREA (MINIMUM DISTANCE FROM EDGE OF PAVEMENT TO CENTERLINE OF FOUNDATION)
TRAFFIC SIGNAL MAST ARM POLE	6 FT (1.8m)	SHOULDER WIDTH + 2 FT (0.6m), MINIMUM 10 FT (3.0m)
TRAFFIC SIGNAL POST	4 FT (1.2m)	SHOULDER WIDTH + 2 FT (0.6m), MINIMUM 10 FT (3.0m)
PEDESTRIAN SIGNAL POST	4 FT (1.2m)	SHOULDER WIDTH + 2 FT (0.6m), MINIMUM 10 FT (3.0m)
PEDESTRIAN PUSHBUTTON POST	4 FT (1.2m)	SHOULDER WIDTH + 2 FT (0.6m), MINIMUM 10 FT (3.0m)
TEMPORARY WOOD POLE	6 FT (1.8m)	SHOULDER WIDTH + 2 FT (0.6m), MINIMUM 10 FT (3.0m)
CONTROLLER CABINET	6 FT (1.8m) MINIMUM DISTANCE SEE NOTE 2	SHOULDER WIDTH + 6 FT (1.8m), MINIMUM 16 FT (4.9m) SEE NOTE 3.
SERVICE INSTALLATION, GROUND MOUNT	6 FT (1.8m) MINIMUM DISTANCE SEE NOTE 2	SHOULDER WIDTH + 6 FT (1.8m), MINIMUM 16 FT (4.9m) SEE NOTE 3.

#### NOTES:

- 1. CONTACT THE "AREA TRAFFIC SIGNAL MAINTENANCE AND OPERATIONS ENGINEER" FOR ASSISTANCE IN LOCATING THE TRAFFIC SIGNAL EQUIPMENT WHEN THERE ARE CONFLICTS WITH DITCHES OR THE MINIMUM OFFSET DISTANCES CANNOT BE MET.
- 2. MINIMUM DISTANCE FROM THE BACK OF CURB TO THE ROADWAY SIDE OF THE FOUNDATION.
- 3. MINIMUM DISTANCE FROM THE EDGE OF PAVEMENT TOTHE ROADWAY SIDE OF THE FOUNDATION.
- 4. ANY CHANGES TO THE OFFSETS OF THE FOUNDATIONS, FROM THE MINIMUM DISTANCES LISTED IN THE "TRAFFIC SIGNAL EQUIPMENT OFFSET" CHART AND THE TRAFFIC SIGNAL INSTALLATION PLAN, COULD EFFECT THE PLACEMENT OF THE SIGNAL HEADS, PEDESTRIAN SIGNAL HEADS AND THE PEDESTRIAN PUSHBUTTONS. THE SIGNAL HEAD PLACEMENT ON THE MAST ARMS SHALL REMAIN AS PER THE TRAFFIC SIGNAL INSTALLATION PLAN AND THE "TRAFFIC SIGNAL MAST ARM AND SIGNAL POST" DETAIL ABOVE. THE PROPOSED MAST ARM LENGTHS MAY NEED TO BE REVISED TO MEET THE ABOVE REQUIREMENTS. THE PEDESTRIAN SIGNAL HEADS AND PEDESTRIAN PUSHBUTTONS MUST MEET THE REQUIREMENTS UNDER THE DETAILS ON THIS SHEET.


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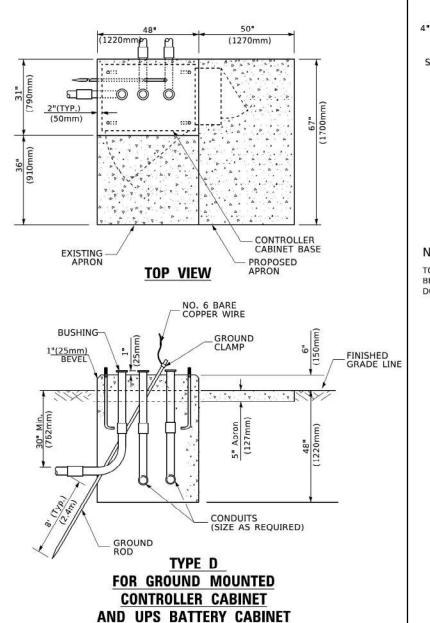
ATLAS
ATLAS TECHNICAL CONSULTANTS, LLC
100 S. WACKER DRIVE, SUITE 400
CHICAGO, IL 60606


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### STATE OF ILLINOIS DEPARTMENT OF TRANSPORTATION

DISTRICT ONE	F.A.U. RTE.	SECTION	COUNTY	TOTAL SHEETS	SHEET NO.	
STANDARD TRAFFIC SIGNAL DESIGN DETAILS	XXX	XXX 2024-964-TS VARIOUS 89		89	7	
OFFICE TIME OF STREET PROPERTY.		TS-5	CONTRAC	F NO. 62\	V89	
SHEET 3 OF 7 SHEETS STA. TO STA.		ILLINOIS FED. AI	D PROJECT			





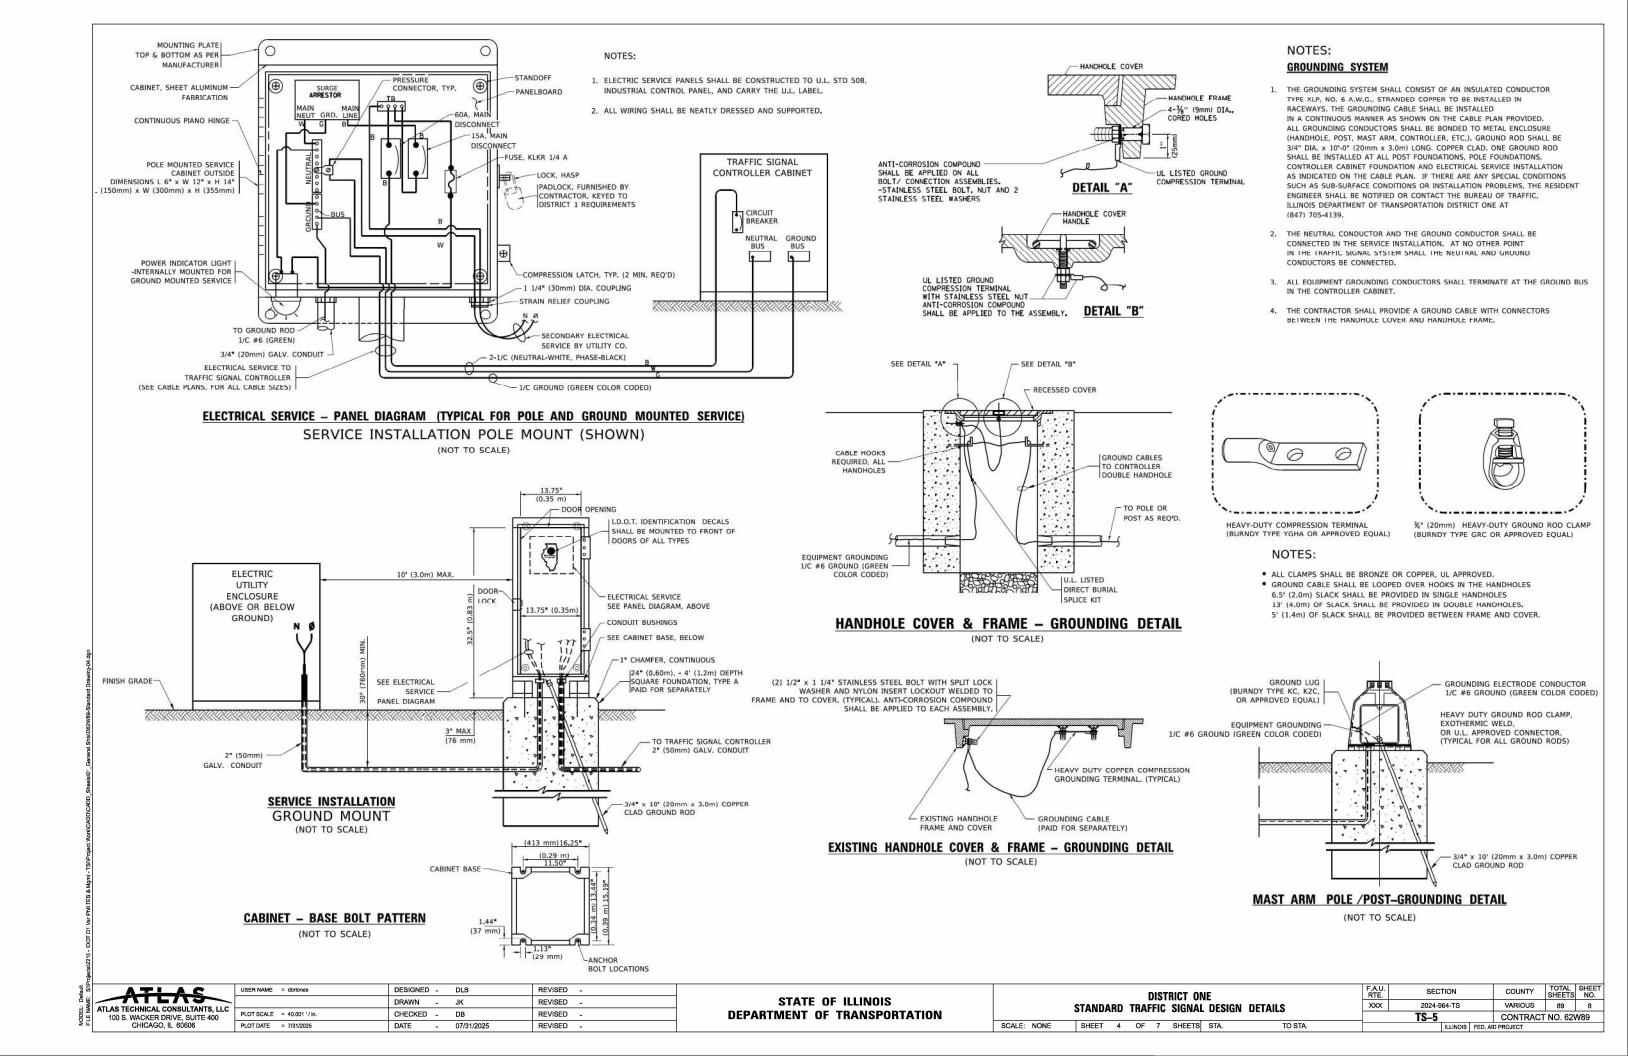

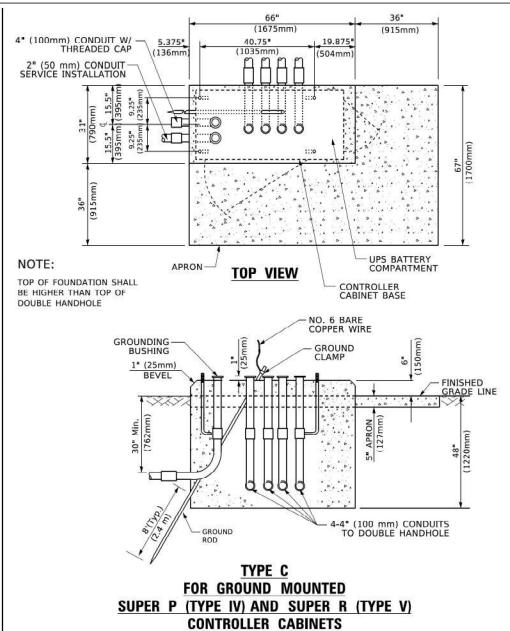3. PLATFORM SIZE FOR CONTROLLER CABINET TYPE IV. 4. PLATFORM SIZE FOR CONTROLLER CABINET TYPE IV AND UNINTERRUPTIBLE POWER SUPPLY CABINET. 5. DRILLED HOLES THROUGH THE PLATFORM BASE TO MATCH THE CONTROLLER CABINET BOLT TEMPLATE, FASTEN THE CONTROLLER CABINET TO THE PLATFORM WITH CARRIAGE BOLTS, WASHERS AND NUTS. 6. FASTEN ALL SUPPORT WOOD FRAMING TO THE WOOD POSTS WITH 2 LAG SCREWS FOR EACH CONNECTION. TEMPORARY SIGNAL CONTROLLER WOOD SUPPORT PLATFORM Quantity of Rebars Foundation Depth Foundation Diameter Spiral Diameter Mast Arm Length Less than 30' (9.1 m) 10'-0" (3.0 m) 30" (750mm) 24" (600mm) Greater than or equal to 30' (9.1 m) and less than 40' (12.2 m) and less than 50' (15.2 m) and less than 50' (15.2 m) and less than 50' (15.2 m) and up to 50' (15.2 m) and up to 55' (16.8 m) Greater than or equal to 6(19) 30" (750mm) 24" (600mm 13'-6" (4.1 m) 11'-0" (3.4 m) 36" (900mm) 30" (750mm) 12 7(22) 13'-0" (4.0 m) 7(22) 30" (750mm) 36" (900mm) 15'-0" (4.6 m) 36" (900mm) 30" (750mm) 12 7(22) Greater than or equal to 56' (16.8 m) and less than 65' (19.8 m) 21'-0" (6.4 m) 42" (1060mm) 36" (900mm 8(25) Greater than or equal to 65' (19.8 m) and up to 75' (22.9 m) 25'-0" (7.6 m) 42" (1060mm) 36" (900mm) 8(25)

65" (SEE NOTE 4) (1651mm)

> 2" x 6" (51mm x 152mm) WOOD FRAMING (TYP.)

CABINET

49" (SEE NOTE 3) (1245mm)

SEE NOTE 5-

CONTROLLER CABINET

¾" (19mm) TREATED PHYWOOD DECK

2<u>" x 6" (51mm x 152mm)</u> TREATED WOOD

> 6" x 6" (152mm x 152mm) TREATED WOOD POSTS

BASED ON CONTROLLER CABINET TYPE IV WITH BASE DIMENSIONS OF 26" x 44" (660mm x 1118mm).
 ADJUST PLATFORM SIZE TO FIT CABINET BASE DIMENSIONS BEING SUPPLIED

BASED ON UNINTERRUPTIBLE POWER SUPPLY CABINET WITH BASE DIMENSIONS OF 16" x 25" (406mm x 635mm).
ADJUST PLATFORM SIZE TO FIT CABINET BASE DIMENSIONS BEING SUPPLIED.

CABLE SLACK LENGTH	FEET	METER
HANDHOLE	6.5	2.0
DOUBLE HANDHOLE	13.0	4.0
SIGNAL POST	2.0	0.6
MAST ARM	2.0	0.6
CONTROLLER CABINET	1.5	0.5
FIBER OPTIC AT CABINET	13.0	4.0
ELECTRIC SERVICE AT (CABINET OR SERVICE LOCATION)	1.5	0.5
GROUND CABLE (SIGNAL POST, MAST ARM, CABINET)	1.5	0.5
GROUND CABLE (BETWEEN FRAME AND COVER)	5.0	1.6

VERTICAL CABLE LENGTH	FEET	METER
MAST ARM POLE ( MAST ARM MOUNTED SIGNAL HEAD) (L = MAST ARM LENGTH - DISTANCE TO SIGNAL HEAD FROM END OF ARM)	20.0+L	6.0+L
BRACKET MOUNTED (MAST ARM POLE OR SIGNAL POLE)	13.0	4.0
PEDESTRIAN PUSH BUTTON	6.0	2.0
SERVICE INSTALLATION POLE MOUNT TO SERVICE DROP	13.5	4.1
SERVICE INSTALLATION POLE MOUNT TO GROUND	13.5	4.1
SERVICE INSTALLATION GROUND MOUNT	6.0	2.0
FOUNDATION (SIGNAL POST, MAST ARM POLE, CONTROLLER CABINET, SERVICE-GROUND MOUNT)	3.0	1.0

#### **VERTICAL CABLE LENGTH**

#### CABLE SLACK

CHICAGO, IL 60606

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## STATE OF ILLINOIS DEPARTMENT OF TRANSPORTATION

DEPTH OF MAST ARM	FOUN	DATIONS, TYPE	<u>E</u>		
DISTRICT ONE	F.A.U. RTE.	SECTION	COUNTY	TOTAL SHEETS	SHEET NO.
TANDARD TRAFFIC SIGNAL DESIGN DETAILS		2024-964-TS	VARIOUS	89	9
		TS-5	CONTRACT	NO. 62\	N89

TO STA

OUNDATION	DEPTH		
TYPE A - Signal Post	4'-0" (1.2m)		
TYPE C - CONTROLLER W/ UPS	4'-0" (1.2m)		
TYPE D - CONTROLLER	4'-0" (1.2m)		
SERVICE INSTALLATION, GROUND MOUNT, TYPE A - SQUARE	4'-0" (1.2m)		


#### **DEPTH OF FOUNDATION**

SCALE: NONE

#### MOTES.

SHEET 5 OF 7 SHEETS STA.

- 1. These foundation depths are for sites which have cohesive soils (clayey silt, sandy clay, etc.) along the length of the shaft, with an average Unconfined Compressive Strength (Ou) > 1.0 tsf (100 kpa). This strength shall be verified by boring data prior to construction or with testing by the Engineer during foundation drilling. The Bureau of Bridges & structures should be contacted for a revised design if other conditions are encountered.
- 2. Combination most arm assemblies under 55 feet (16.8 m) shall use 36" (900 mm) diameter foundations.
- 3. Combination most arm assemblies under 56 feet (16.8 m) through 75 feet (22.9 m) shall use 42" (1060 mm) diameter foundations
- 4. For mast arm assemblies with dual arms refer to state standard 878001...

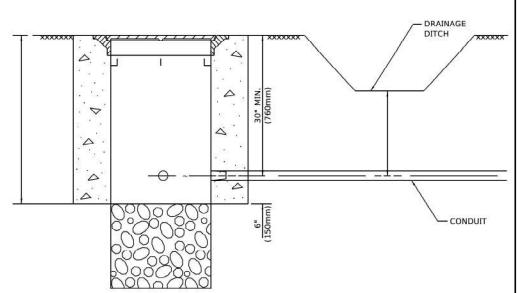


100 S. WACKER DRIVE, SUITE 400

CHICAGO, IL 60606


- CONDUIT DEPTH SHALL BE A MINIMUM OF 30" (760mm) BELOW THE BOTTOM OF THE DRAINAGE DITCH OR ANY SLOPING GROUND
- THE MINIMUM CONDUIT DEPTH APPLIES TO ALL CONDUIT PLACED UNDER ROADWAY PAVEMENT, MULTI-USE PATHS, SIDEWALKS AND SOIL SURFACES.
- THE MINIMUM CONDUIT DEPTH APPLIES TO ALL HANDHOLES, HEAVY DUTY HANDHOLES AND DOUBLE HANDHOLES.

#### HANDHOLE WITH MINIMUM CONDUIT DEPTH

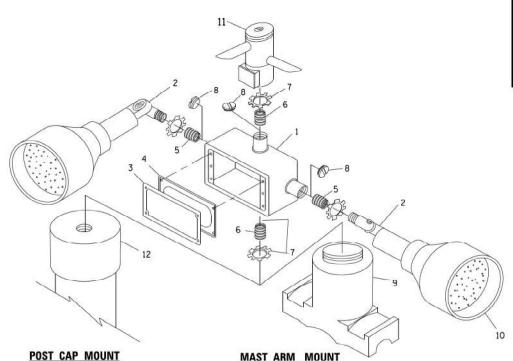


## MAST ARM MOUNT EMERGENCY VEHICLE DETECTOR WITH CONFIRMATION

(1675mm) (915mm) 19.875" (1035mm) (504mm) CONTROLLER CABINET BASE PROPOSED-**TOP VIEW** APRON (NOT TO SCALE) -NO. 3 DOWEL 18" (450mm) NO. 6 BARE COPPER WIRE LONG (8 REQ.) BUSHING-GROUND EXISTING ANCHOR BOLTS FINISHED GRADE LINE BEVEL (300mm (225mm) EXISTING CONDUITS EXISTING GROUND ROD MODIFY EXISTING TYPE "D" FOUNDATION TO TYPE "C" FOUNDATION (NOT TO SCALE)

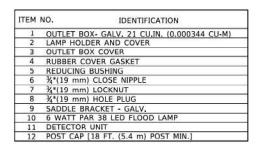

#### NOTES:

- 1. ALL ELECTRICAL ITEMS, EXCEPT ITEMS #2 AND #11 SHALL BE ALUMINUM OR
- 2, ITEM #1- OZ/GEDNEY FSX-1-50 OR EQUIVALENT ITEM #2- MULBERRY CON-O-SHADE LAMP SHIELD OR EQUIVALENT ITEM #9- "BAND-IT" SADDLE BRACKET OR EQUIVALENT
- 3. WHEN POST MOUNTING IS SPECIFIED, ITEM #9 SHALL NOT BE REQUIRED. THE DETECTION UNIT SHALL BE MOUNTED DIRECTLY ON TOP OF THE CAP BY DRILLING AND TAPPING A 3/4 "(19 mm) HOLE WITH PIPE THREADS. THE POST CAP SHALL EITHER BE SCREWED TO THE TOP OF THE POST OR A MINIMUM OF 3 TIGHTENING SCREWS SHALL BE REQUIRED ON EACH CAP.

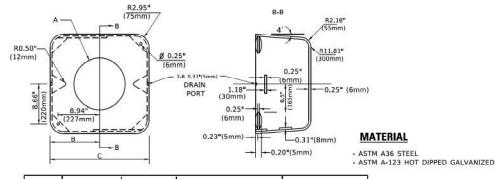



Α	В	С	HEIGHT	WEIGHT
VARIES	9.5"(241mm)	19*(483mm)	7" (178mm) - 12" (300mm)	53 lbs (24kg)
VARIES	10.75"(273mm)	21.5"(546mm)	7" (178mm) - 12" (300mm)	68 lbs (31 kg)
VARIES	13.0"(330mm)	26"(660mm)	7" (178mm) - 12" (300mm)	81 lbs (37 kg)
VARIES	18.5"(470mm)	37"(940mm)	7" (178mm) - 12" (300mm)	126 lbs (57 kg)

#### SHROUD

#### NOTES:

- DIMENSION "A" IS EQUAL TO THE DIAMETER OF THE MAST ARM POLE AT THE TOP OF THE SHROUD.
  THE SHROUD SHALL BE TIGHT TO THE MAST ARM POLE.
- 2. THE SUPPLIER SHALL VERIFIED THE ABOVE DIMENSIONS BASED ON MAST ARM REQUIREMENTS.
- 3. THE HEIGHT OF THE SHROUD SHALL COVER THE ANCHOR BOLTS, NUTS AND MAST ARM POLE BASE.

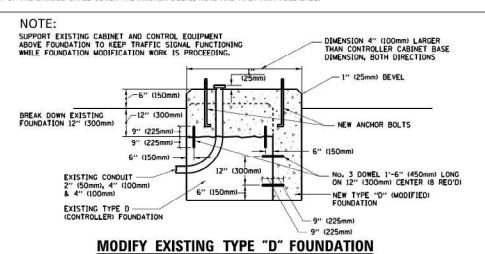

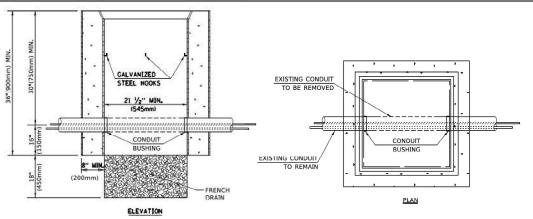


#### NOTES:

SCALE: NONE

- 1. HANDHOLE CONSTRUCTED PER STATE STANDARD 814001.
- REMOVAL OF THE EXISTING CONDUIT FROM THE HANDHOLE AND THE INSTALLATION OF THE CONDUIT BUSHINGS SHALL BE INCLUDED WITH THE COST OF THE HANDHOLE.

#### HANDHOLE TO INTERCEPT EXISTING CONDUIT


STATE OF ILLINOIS
DEPARTMENT OF TRANSPORTATION

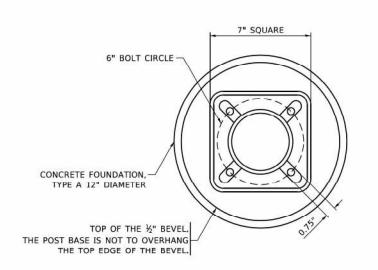

#### **BOLT PATTERN**

#### NOTE:

1. IF THE PEDESTRIAN SIGNAL POST FOUNDATION IS INSTALLED WITHIN OR BEHIND A BARRIER CURB, THE TOP OF THE FOUNDATION SHALL BE INSTALLED FLUSH WITH THE TOP OF THE BARRIER CURB.

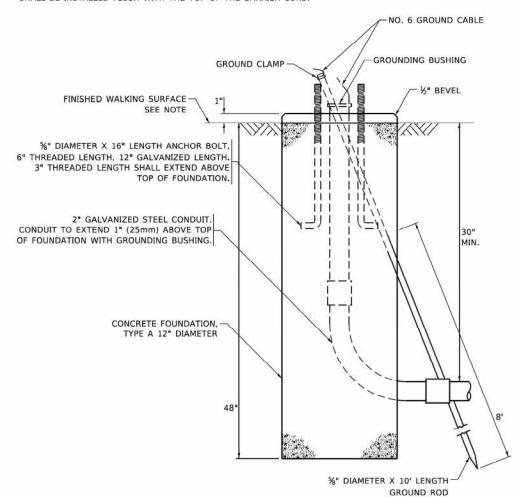

### TYPE A 12-INCH DIAMETER

#### PEDESTRIAN SIGNAL POST, 10 FT.

#### PEDESTRIAN SIGNAL POST, 5 FT.







R10-3b


R10-3d

R10-3e

#### SIGN TABLE

SIGN	DIMENSIONS			
R10-3b (RAILROAD ONLY)	9" X 12"			
R10-3d (RAILROAD ONLY)	9" X 12"			
R10-3e	9" X 12"			

- 1. THE SIGN PANELS SHALL BE TYPE AP SHEETING.
- 2. THE ARROW ON SIGNS FOR PUSH-BUTTONS SERVING TWO DIRECTIONS ON THE SAME PHASE SHALL BE BI-DIRECTIONAL.
- 3, THE SIGN FOR DUAL-CALL PUSH-BUTTONS SHALL HAVE NO ARROW.

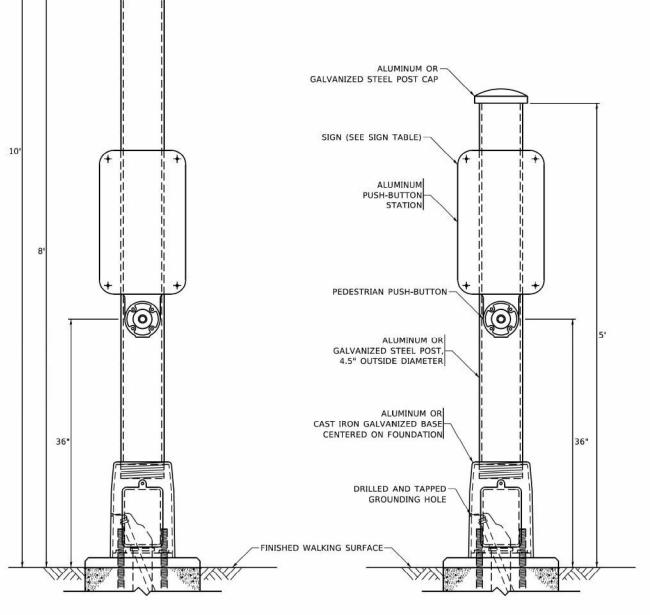

PEDESTRIAN SIGNAL HEAD

COUNTDOWN PEDESTRIAN SIGNAL HEADS ARE NOT TO BE USED AT RAILROAD INTERSECTIONS

CONCRETE FOUNDATION,




1	USER NAME = dbriones	DESIGNED	-	DLB	REVISED	-
		DRAWN	-	JK	REVISED	-
	PLOT SCALE = 40.001 ' / in.	CHECKED	-	DB	REVISED	
	PLOT DATE = 7/31/2025	DATE	-	07/31/2025	REVISED	-

**STATE OF ILLINOIS DEPARTMENT OF TRANSPORTATION** 

	STANDA	RD	_		RICT ON SIGNAL		DETAILS
SCALE: NONE	SHEET	7	OF	7	SHEETS	STA.	TO STA.

F.A.U. RTE.	SEC.	SECTION			TOTAL SHEETS	SHEE NO.	
XXX	2024-964-TS			VARIOUS	89	11	
TS-5				CONTRACT NO. 62W89			
		ILLINOIS	FED. AI	D PROJECT			

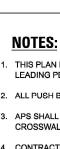


- THIS PLAN IS FOR THE INSTALLATION OF APS PUSH BUTTONS AND LEADING PEDESTRIAN INTERVAL PROGRAMMING.
- 2. ALL PUSH BUTTONS SHALL BE APS.
- 3. APS SHALL BE PLACED PARALLEL TO THE CORRESPONDING
- 4. CONTRACTOR SHALL CONFIRM THE FINAL LOCATION OF THE PEDESTRIAN EQUIPMENT WITH THE TRAFFIC SIGNAL ENGINEER BEFORE INSTALLATION.
- 5. ALL EXISTING TRAFFIC SIGNAL CABLE NO LONGER REQUIRED SHALL BE REMOVED.
- 6. SIDEWALK TO BE BROUGHT UP TO PROWAG STANDARDS ON A FUTURE CONTRACT.


#### **REMOVAL NOTES:**

THE FOLLOWING ITEMS SHALL BE REMOVED BY THE CONTRACTOR AND SHALL BE DISPOSED OF BY THEM OUTSIDE THE RIGHT-OF-WAY AT THEIR EXPENSE. THE SALVAGE VALUE OF THE REMOVED EQUIPMENT SHALL BE REFLECTED IN THE CONTRACT BID PRICE.

2 EACH PEDESTRIAN PUSH-BUTTON

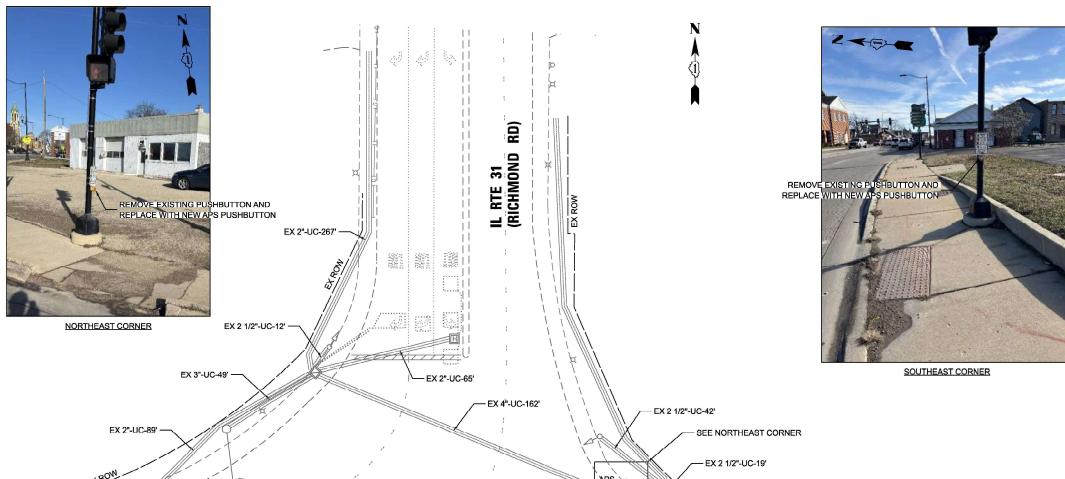

SCALE: 1"=20'

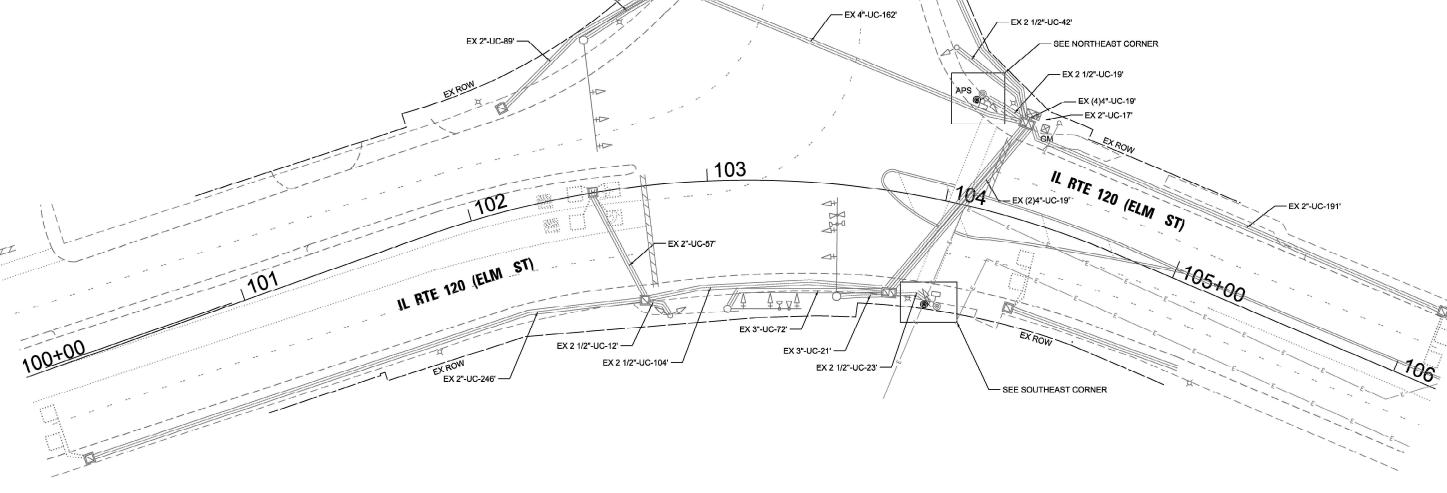

ATLAS TECHNICAL CONSULTANTS, LLC
100 S. WACKER DRIVE, SUITE 400
CHICAGO, II. 60606

 USER NAME
 = dbfrones
 DESIGNED
 DLB
 REVISED

 DRAWN
 JK
 REVISED

 PLOT GCALE
 - 40.000 '/ in.
 CHECKED
 DB
 REVISED

 PLOT DATE
 = 7/31/2025
 DATE
 07/31/2025
 REVISED

STATE OF ILLINOIS
DEPARTMENT OF TRANSPORTATION


TRAFFIC SIGNAL INSTALLATION PLAN
ILLINOIS ROUTE 31 AT ILLINOIS ROUTE 120

SHEET 1 OF 2 SHEETS STA. TO STA.

SCALE IN FEET

TS 7290

EAGLE 40

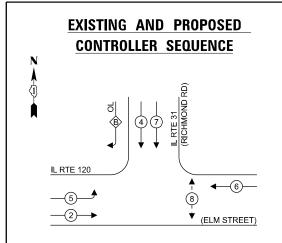

#### **LEGEND:**

PROTECTED PHASE

PROTECTED/PERMITTED PHASE

PEDESTRIAN PHASE

**♦** OL OVERLAP

#### TRAFFIC SIGNAL **ELECTRICAL SERVICE REQUIREMENTS**

	QUANTITY	UNIT	TOTAL						
TYPE	QUANTITY	WATTAGE	WATTAGE						
SIGNAL HEAD 3 - SECTION	12	11	132.0						
4 - SECTION	-	14	-						
5 - SECTION	3	13	39.0						
PROGRAMMABLE SIGNALS									
3 - SECTION	-	22	-						
4 - SECTION	-	32	-						
5 - SECTION	-	28	-						
PED. SIGNAL	2	15	30.0						
CONTROLLER	1	150	150.0						
MASTER CONTROLLER	-	100	-						
UPS	1	25	25.0						
DETECTION RADAR	-	20	-						
VIDEO	-	20	-						
BLANK-OUT SIGN	-	25	-						
NETWORK SWITCH II OR III	-	35	-						
CELLULAR MODEM	-	15	-						
TOTA	AL UPS SIZIN	NG = 37	6.0						
UPS CHARGING	1	225	225.0						
BATTERY HEATER MAT	1	180	180.0						
CABINET HEATER	1	200	200.0						
FLASHER	-	15	-						
LED STREET NAME SIGN	-	120	-						
LUMINAIRE	-	240	-						
TOTAL SERVIC	E WIRE SIZII	NG = 98	1.0						

ENERGY COSTS TO:

ILLINOIS DEPARTMENT OF TRANSPORTATION

201 W CENTER COURT SCHAUMBURG, IL 60196-1096

ENERGY SUPPLY: CONTACT: CASSIE EVANS

ACCOUNT NUMBER: \_\_\_ - 5254846166

PHONE: 773-241-0741 COMPANY: COMMONWEALTH EDISON

#### **EXISTING AND PROPOSED EMERGENCY VEHICLE PREEMPTION SEQUENCE**

(5)

RIGHT TURN OVERLAP

OVERLAP PERMISSIVE PROTECTED

1. TIMING CONSULTANT SHALL PROGRAM LEADING

PEDESTRIAN INTERVAL FOR PHASE 8. THIS WORK SHALL BE PAID FOR UNDER RE-OPTIMIZE TRAFFIC SIGNAL SYSTEM

\_\_PHASE\_\_\_\_PHASE\_\_ 4 +

PHASE DESIGNATION:

IL RTE 120

\_3→

LETTER

**NOTES:** 

LEVEL 1.

STATE OF ILLINOIS **DEPARTMENT OF TRANSPORTATION** 

#### CABLE PLAN, PHASE DESIGNATION DIAGRAM, AND EMERGENCY VEHICLE PREEMPTION SEQUENCE ILLINOIS ROUTE 31 AT ILLINOIS ROUTE 120 SHEET 2 OF 2 SHEETS STA.

SECTION COUNTY 2024-964-TS MCHENRY 89 13 XXX CONTRACT NO. 62W89

TS 7290

EAGLE 40

EXISTING

TRACER CABLE

EXISTING

EXISTING

INTERCONNECT TO

GREEN STREET

TRACER CABLE

EXISTING

INTERCONNECT TO PEARL STREET

IL RTE 31 (RICHMOND ROAD)

### **SCHEDULE OF QUANTITIES**

ITEM DESCRIPTION	UNITS	TOTAL QTY
MAINTENANCE OF EXISTING TRAFFIC SIGNAL INSTALLATION	EACH	1
REMOVE EXISTING TRAFFIC SIGNAL EQUIPMENT	EACH	1
ACCESSIBLE PEDESTRIAN SIGNALS	EACH	2
RE-OPTIMIZE TRAFFIC SIGNAL SYSTEM LEVEL 1	EACH	1

EXISTING

**EXISTING** 

MA

**IL RTE 120** 

TO IL RTE 31

TRACER CABLE

INTERCONNECT

(FRONT STREET)

(ELM STREET)

(a) < (7) (ELM STREET) **⋒**≺\\\\ 

**CABLE PLAN** (NOT TO SCALE)

ATLAS TECHNICAL CONSULTANTS, LLC 100 S. WACKER DRIVE, SUITE 400 CHICAGO, IL 60606


DESIGNED - DLB REVISED -DRAWN - JK REVISED -CHECKED - DB REVISED PLOT DATE = 7/31/2025 REVISED -DATE - 07/31/2025

- 1. THIS PLAN IS FOR THE INSTALLATION OF APS PUSH BUTTONS AND LEADING PEDESTRIAN INTERVAL PROGRAMMING.
- 2. ALL PUSH BUTTONS SHALL BE APS.
- 3. APS SHALL BE PLACED PARALLEL TO THE CORRESPONDING CROSSWALKS.
- 4. CONTRACTOR SHALL CONFIRM THE FINAL LOCATION OF THE PEDESTRIAN EQUIPMENT WITH THE TRAFFIC SIGNAL ENGINEER BEFORE INSTALLATION.
- 5. ALL EXISTING TRAFFIC SIGNAL CABLE NO LONGER REQUIRED SHALL BE
- 6. SIDEWALK TO BE BROUGHT UP TO PROWAG STANDARDS ON A FUTURE CONTRACT.
- 7. THE GROUND MOUNTED, METERED SERVICE SHALL BE CONSTRUCTED ADJACENT TO THE EXISTING SERVICE CONDUIT PRIOR TO DISCONNECTING THE EXISTING SERVICE. INCLUDE A 5' STUB OF 2" CONDUIT FROM THE GM FOR FUTURE CONNECTION. THE COST OF THE 5' STUB, 2" UNDERGROUND CONDUIT AND SPLICE TO EXISTING SERVICE CONDUIT SHALL BE INCLUDED IN THE COST OF CONCRETE FOUNDATION. TYPE A. THE TRAFFIC SIGNALS SHALL REMAIN OPERATIONAL THE ENTIRE TIME THE SWITCH OVER BETWEEN EXISTING SERVICE AND PROPOSED SERVICE IS MADE.


#### **REMOVAL NOTES:**

THE FOLLOWING ITEMS SHALL BE REMOVED BY THE CONTRACTOR AND SHALL BE DISPOSED OF BY THEM OUTSIDE THE RIGHT-OF-WAY AT THEIR EXPENSE. THE SALVAGE VALUE OF THE REMOVED EQUIPMENT SHALL BE REFLECTED IN THE CONTRACT BID PRICE.

PEDESTRIAN PUSHBUTTON EACH CONTROLLER (ASC/2S-1000) EACH SERVICE INSTALLATION EACH

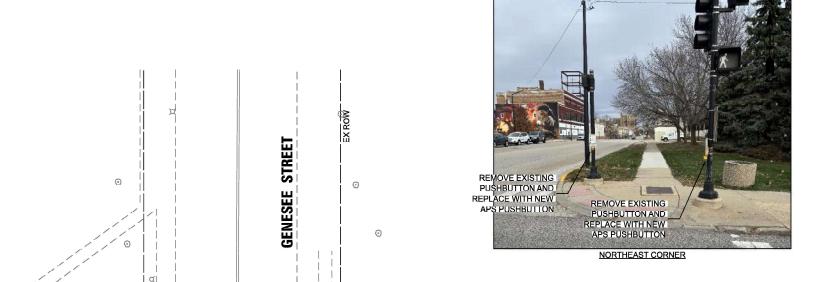

SEE NORTHEAST CORNER

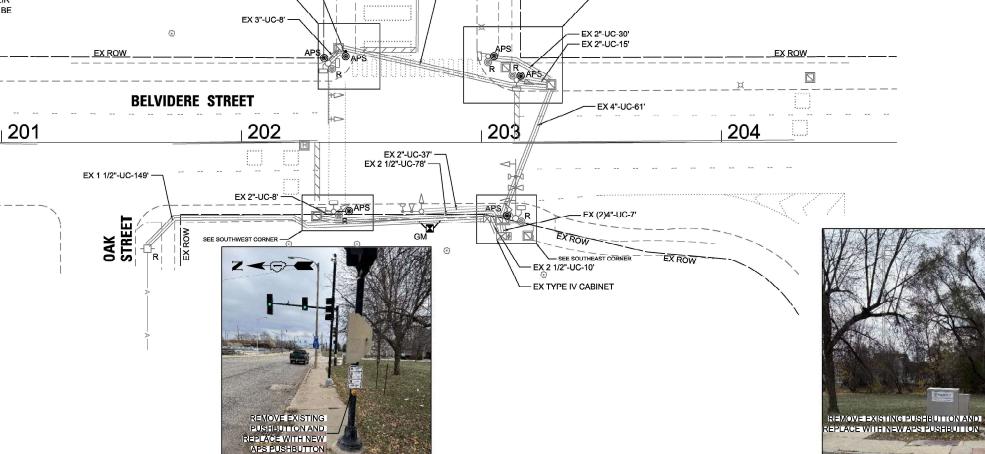

2"-UC-3

SOUTHEAST CORNER

SCALE IN FEET

TS 14965 **ECON 204** LAKE CO - CENTRACS

CHICAGO, IL 60606

USER NAME = dbriones	DESIGNED	-	DLB	REVISED	-
	DRAWN	$\times$	JK	REVISED	Η
PLOT SCALE - 40.000 '/ in.	CHECKED	-	DB	REVISED	-
PLOT DATE = 7/31/2025	DATE	-	07/31/2025	REVISED	-

STATE OF ILLINOIS **DEPARTMENT OF TRANSPORTATION** 

SOUTHWEST CORNER

TRAF	FIC	SIG	NAL	INSTA	LLATION	PLAN	
BELVII	DER	E ST	REE	T AT G	ENESEE	STREET	
SHEET	1	OF	2	SHEETS	STA.		TO STA.

SCALE: 1"=20'


F.A.U. RTE:	SECTION	COUNTY	TOTAL SHEETS	SHEE NO.	
XXX	2024-964-TS	LAKE	89	14	
			CONTRACT	NO. 62\	N89
ILLINOIS FED. AID PROJECT					

REMOVE EXISTING
PUSHBUTTON AND
REPLACE WITH NEW

APS PUSHBUTTON

NORTHWEST CORNER

HANDHOLE 3'-UC-2" —

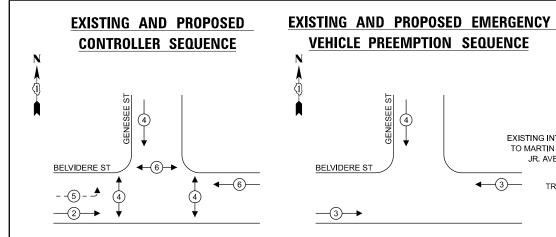

#### LEGEND:

PROTECTED PHASE

PROTECTED/PERMITTED PHASE

PEDESTRIAN PHASE

#### **♦**OL OVERLAP

#### TRAFFIC SIGNAL **ELECTRICAL SERVICE REQUIREMENTS**

OLIANITITY	UNIT	TOTAL
QUANTITY	WATTAGE	WATTAGE
10	11	110.0
-	14	-
2	13	26.0
-	22	-
-	32	-
-	28	-
6	15	180
1	150	150.0
-	100	-
1	25	25.0
-	20	-
-	20	-
-	25	-
-	35	-
-	15	-
AL UPS SIZIN	IG = 49	1.0
1	225	225.0
1	180	180.0
1	200	200.0
-	15	-
-	120	-
-	240	-
E WIRE SIZI	NG = 109	96.0
	- 2 - 6 1 - 1	QUANTITY WATTAGE  10 11 14 14 13 22 32 28 28 15 100 100 20 20 20 20 25 35 15 15 1180 1 180 1 180 15 1 200 15 120 240

ENERGY COSTS TO: CITY OF WAUKEGAN 100 N MARTIN LUTHER KING JR. AVE WAUKEGAN, IL 60085

ENERGY SUPPLY: CONTACT: DANIEL MENDEZ PHONE: 773-799-6111

COMPANY: COMMONWEALTH EDISON ACCOUNT NUMBER: - 7114128111

> DESIGNED - DLB REVISED -DRAWN - JK REVISED -CHECKED -DB REVISED PLOT DATE = 7/31/2025 DATE - 07/31/2025 REVISED -

ACCESSIBLE PEDESTRIAN SIGNALS

CONCRETE FOUNDATION, TYPE A 12-INCH DIAMETER

RE-OPTIMIZE TRAFFIC SIGNAL SYSTEM LEVEL 1

**VEHICLE PREEMPTION SEQUENCE** 

(4)

1. TIMING CONSULTANT SHALL PROGRAM LEADING PEDESTRIAN

INTERVAL FOR PHASE 4. THIS WORK SHALL BE PAID FOR

ECONOLITE TO MATCH THE EXISTING ADJACENT SYSTEM.

UNDER RE-OPTIMIZE TRAFFIC SIGNAL SYSTEM LEVEL 1. 2. THE TRAFFIC SIGNAL CONTROL EQUIPMENT FOR THIS

BELVIDERE ST

**—**(3)**→** 

NOTES:

LOCATION SHALL BE

STATE OF ILLINOIS **DEPARTMENT OF TRANSPORTATION**  CABLE PLAN, PHASE DESIGNATION DIAGRAM, AND EMERGENCY VEHICLE PREEMPTION SEQUENCE BELVIDERE STREET AT GENESEE STREET SHEET 2 OF 2 SHEETS STA.

SECTION COUNTY 2024-964-TS LAKE 89 15 XXX CONTRACT NO. 62W89

SCHEDULE OF QUANTITIES TOTAL ITEM DESCRIPTION UNITS QTY UNDERGROUND CONDUIT, GALVANIZED STEEL, 2" DIA. FOOT MAINTENANCE OF EXISTING TRAFFIC SIGNAL INSTALLATION EACH ELECTRIC CABLE IN CONDUIT, SIGNAL NO. 14 2C FOOT 200 FLECTRIC CABLE IN CONDUIT, SERVICE, NO. 6, 2 C. FOOT 49 ELECTRIC CABLE IN CONDUIT, EQUIPMENT GROUNDING CONDUCTOR, NO. 6 1C FOOT 24 CONCRETE FOUNDATION, TYPE A FOOT DRILL EXISTING HANDHOLE EACH REMOVE ELECTRIC CABLE FROM CONDUIT 165 FOOT REMOVE EXISTING TRAFFIC SIGNAL EQUIPMENT EACH SERVICE INSTALLATION, GROUND MOUNTED, METERED EACH PEDESTRIAN SIGNAL POST, 5 FT. EACH FULL-ACTUATED CONTROLLER IN EXISTING CABINET EACH

EXISTING INTERCONNECT

TO MARTIN LUTHER KING -

JR. AVE./COUNTY ST.

TRACER CABLE

EXISTING

\_\_\_\_\_\_24F

**BELVIDERE ST** 

EXISTING - INTERCONNECT TO ILL. RTE. 137 **EXISTING** 24F TRACER CABLE - EXISTING TYPE IV CABINET (1#6) REPLACE EXISTING CONTROLLER WITH FULLY-ACTUATED CONTROLLER **CABLE PLAN** 

<del>-(1#6)-</del>

2

APS

O

ST

GENESEE

(3)

**₹** 

APS

TS 14965 **ECON 204** LAKE CO - CENTRACS

#### TLAS TECHNICAL CONSULTANTS, LLC 100 S. WACKER DRIVE, SUITE 400 CHICAGO, IL 60606

EACH

FOOT


EACH


- 1. THIS PLAN IS FOR THE INSTALLATION OF APS PUSH BUTTONS AND LEADING PEDESTRIAN INTERVAL PROGRAMMING.
- 2. ALL PUSH BUTTONS SHALL BE APS.
- 3. APS SHALL BE PLACED PARALLEL TO THE CORRESPONDING CROSSWALKS.
- 4. CONTRACTOR SHALL CONFIRM THE FINAL LOCATION OF THE PEDESTRIAN EQUIPMENT WITH THE TRAFFIC SIGNAL ENGINEER BEFORE INSTALLATION.
- 5. ALL EXISTING TRAFFIC SIGNAL CABLE NO LONGER REQUIRED SHALL BE
- 6. SIDEWALK TO BE BROUGHT UP TO PROWAG STANDARDS ON A FUTURE CONTRACT.

#### **REMOVAL NOTES:**

THE FOLLOWING ITEMS SHALL BE REMOVED BY THE CONTRACTOR AND SHALL BE DISPOSED OF BY THEM OUTSIDE THE RIGHT-OF-WAY AT THEIR EXPENSE. THE SALVAGE VALUE OF THE REMOVED EQUIPMENT SHALL BE REFLECTED IN THE CONTRACT BID PRICE.

PEDESTRIAN PUSHBUTTON PEDESTRIAN SIGNAL HEAD

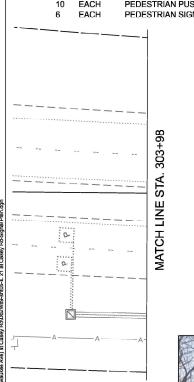

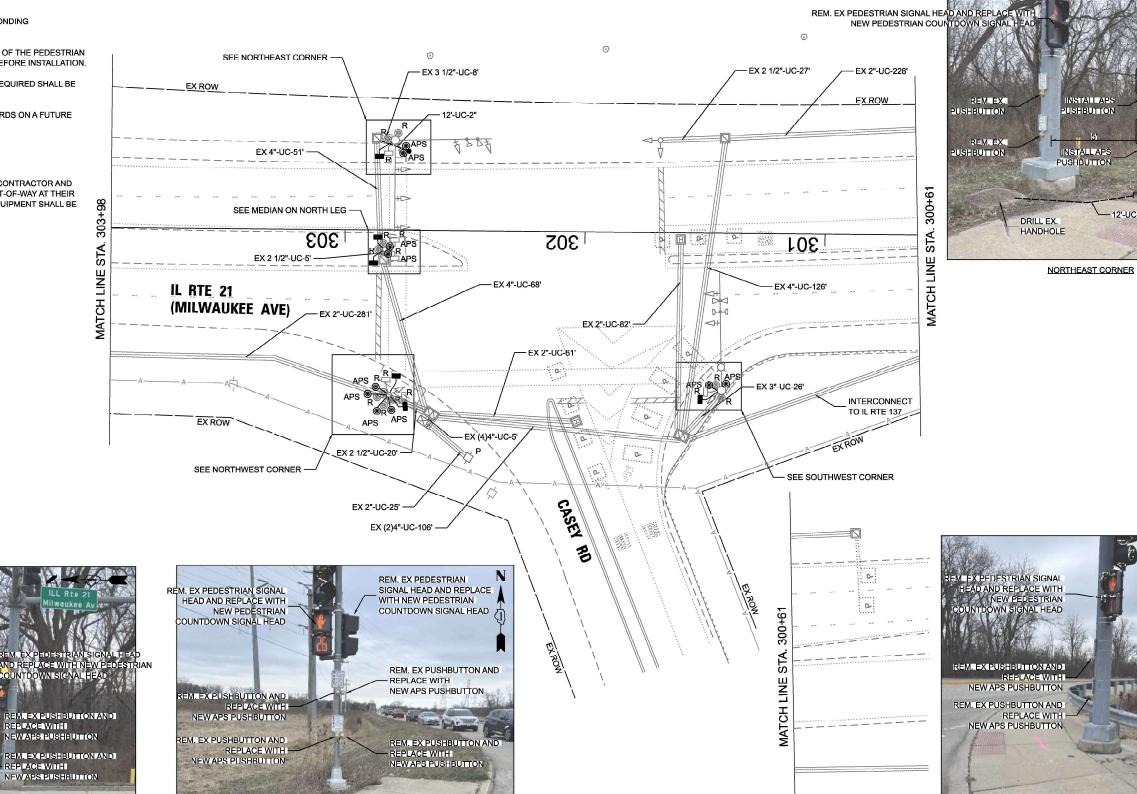



DESIGNED - DLB REVISED -USER NAME = dbriones DRAWN REVISED CHECKED -REVISED PLOT SCALE - 40.000 ' / in. DB PLOT DATE = 7/31/2025 DATE 07/31/2025 REVISED

MEDIAN ON NORTH LEG

STATE OF ILLINOIS **DEPARTMENT OF TRANSPORTATION** 

TRAFFIC SIGNAL INSTALLATION PLAN ILLINOIS ROUTE 21 (MILWAUKEE AVE) AT CASEY ROAD SHEET 1 OF 2 SHEETS STA. SCALE: 1"=20'

SCALE IN FEET

LAKE CONTRACT NO. 62W89


LAKE COUNTY - CENTRACS

TS 6708

SOUTHWEST CORNER

NORTHWEST CORNER


#### **EXISTING AND PROPOSED** CONTROLLER SEQUENCE

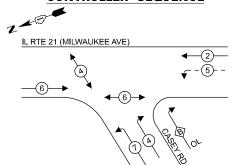

#### **EXISTING AND PROPOSED EMERGENCY**

#### **VEHICLE PREEMPTION SEQUENCE**



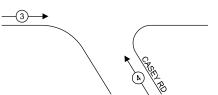

#### **RIGHT TURN OVERLAP**

OVERLAP PERMISSIVE PROTECTED  $\frac{\text{ETTER}}{\text{B}} = \frac{\text{PHASE}}{4} + \frac{\text{PHASE}}{5}$ 

PHASE DESIGNATION:

#### **LEGEND:**

TYPF

SIGNAL HEAD

PED. SIGNAL

CONTROLLER

DETECTION

BLANK-OUT SIGN

CELLULAR MODEM

BATTERY HEATER MAT

LED STREET NAME SIGN

ENERGY COSTS TO:

118 W COOK AVE LIBERTYVILLE, IL 60048

UPS CHARGING

CABINET HEATER

FLASHER

LUMINAIRE

UPS

MASTER CONTROLLER

NETWORK SWITCH II OR III

PROGRAMMABLE SIGNALS

**★**PROTECTED PHASE

PROTECTED/PERMITTED PHASE

TRAFFIC SIGNAL

**ELECTRICAL SERVICE REQUIREMENTS** 

QUANTITY

UNIT

13

22

32

28

15

150

100

25

20

20

25

35

15

225

180

200

15

120

240

TOTAL UPS SIZING = 425.0

TOTAL SERVICE WIRE SIZING = 1030.0

PHONE: 773-799-6111 COMPANY: COMMONWEALTH EDISON

TOTAL

88.0

52.0

90.0

150.0

25.0

20.0

225.0

180.0

200.0

WATTAGE | WATTAGE

PEDESTRIAN PHASE

OL OVERLAP

3 - SECTION

4 - SECTION

5 - SECTION

3 - SECTION

4 - SECTION

5 - SECTION


RADAR

VIDEO

#### **NOTES:**

FOR PHASE 4. THIS WORK SHALL BE PAID FOR UNDER RE-OPTIMIZE TRAFFIC SIGNAL SYSTEM LEVEL 1.

TIMING CONSULTANT SHALL PROGRAM LEADING PEDESTRIAN INTERVAL

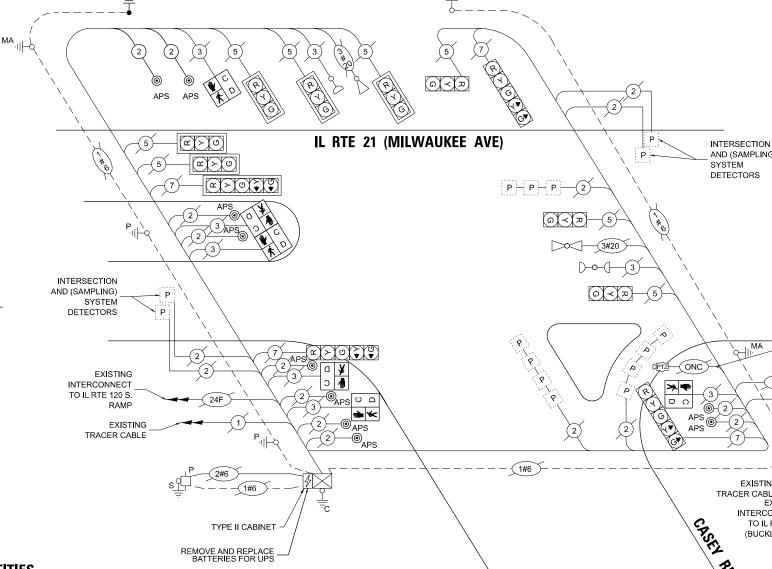

**CABLE PLAN** 

#### **SCHEDULE OF QUANTITIES**

ITEM DESCRIPTION	UNITS	TOTAL QTY
UNDERGROUND CONDUIT, GALVANIZED STEEL, 2" DIA.	FOOT	12
MAINTENANCE OF EXISTING TRAFFIC SIGNAL INSTALLATION	EACH	1
ELECTRIC CABLE IN CONDUIT, SIGNAL NO. 14 2C	FOOT	355
ELECTRIC CABLE IN CONDUIT, EQUIPMENT GROUNDING CONDUCTOR, NO. 6 1C	FOOT	65
DRILL EXISTING HANDHOLE	EACH	1
PEDESTRIAN SIGNAL HEAD, LED, 1-FACE, BRACKET MOUNTED WITH COUNTDOWN TIMER	EACH	6
REMOVE ELECTRIC CABLE FROM CONDUIT	FOOT	160
REMOVE EXISTING TRAFFIC SIGNAL EQUIPMENT	EACH	1
PEDESTRIAN SIGNAL POST, 10 FT.	EACH	1
REMOVE AND REPLACE BATTERIES FOR UNINTERUPTABLE POWER SUPPLY, EXTENDED	EACH	1
ACCESSIBLE PEDESTRIAN SIGNALS	EACH	10
CONCRETE FOUNDATION, TYPE A 12-INCH DIAMETER	FOOT	4
RE-OPTIMIZE TRAFFIC SIGNAL SYSTEM LEVEL 1	EACH	1

TS 6708 LAKE COUNTY - CENTRACS

- NO. 20 VIDEO

EXISTING

INTERCONNECT

TO IL RTE 137

(BUCKLEY RD)

EXISTING

TRACER CABLE

AND (SAMPLING)



VILLAGE OF LIBERTYVILLE

ENERGY SUPPLY: CONTACT: DANIEL MENDEZ

ACCOUNT NUMBER: \_\_ - 0220462222

SER NAME = dbriones	DESIGNED	-	DLB	REVISED	-
	DRAWN	-	JK	REVISED	-
OT SCALE = 40.000'/in.	CHECKED	-	DB	REVISED	-
OT DATE = 7/31/2025	DATE	-	07/31/2025	REVISED	-

STATE OF ILLINOIS **DEPARTMENT OF TRANSPORTATION** 

EXISTING CA	TIND I D	RTE.	SECT	ION		COUNTY	TOTAL SHEETS	SHEET NO.		
EMERGENCY VEH	JANIIIIES X	XXX	2024-96	64-TS		LAKE	89	17		
						CONTRACT	NO. 62\	N89		
SCALE: N.T.S.	SHEET 2 OF 2 SHEE	S STA. TO STA.				ILLINOIS	FED. AIC	PROJECT		

- THIS PLAN IS FOR THE INSTALLATION OF APS PUSH BUTTONS AND LEADING PEDESTRIAN INTERVAL PROGRAMMING.
- 2. ALL PUSH BUTTONS SHALL BE APS.
- 3. APS SHALL BE PLACED PARALLEL TO THE CORRESPONDING CROSSWALKS.
- 4. CONTRACTOR SHALL CONFIRM THE FINAL LOCATION OF THE PEDESTRIAN EQUIPMENT WITH THE TRAFFIC SIGNAL ENGINEER BEFORE INSTALLATION.
- 5. ALL EXISTING TRAFFIC SIGNAL CABLE NO LONGER REQUIRED SHALL BE
- 6. SIDEWALK TO BE BROUGHT UP TO PROWAG STANDARDS ON A FUTURE CONTRACT.

#### **REMOVAL NOTES:**

THE FOLLOWING ITEMS SHALL BE REMOVED BY THE CONTRACTOR AND SHALL BE DISPOSED OF BY THEM OUTSIDE THE RIGHT-OF-WAY AT THEIR EXPENSE. THE SALVAGE VALUE OF THE REMOVED EQUIPMENT SHALL BE

2 EACH





SOUTHWEST CORNER

USER NAME = dbriones	DESIGNED	-	DLB	REVISED -	
	DRAWN	-	JK	REVISED -	
PLOT SCALE - 40.000 '/ in.	CHECKED	-	DB	REVISED -	
PLOT DATE = 7/31/2025	DATE	_	07/31/2025	REVISED -	

STATE OF ILLINOIS **DEPARTMENT OF TRANSPORTATION** 

- SEE NORTHWEST CORNER

EX (2)4"-UC-1040

DOTY

ROAD

EX 4"-UC-25' EX 2 1/2"-UC-40'

EX 2 1/2"-UC-26'

404

-EX 3"-UC-107'

-EX 2 1/2"-UC-7

TRAFFIC SIGNAL INSTALLATION PLAN US ROUTE 14 AT DOTY ROAD

COUNTY TOTAL SHEETS NO.

MCHENRY 89 18 2024-964-TS

SCALE IN FEET

TS 7239

**ECON 195** 

CONTRACT NO. 62W89 SHEET 1 OF 2 SHEETS STA. SCALE: 1"=20" TO STA.

REFLECTED IN THE CONTRACT BID PRICE. PEDESTRIAN PUSHBUTTON REM. EX. PUSHBUTTON AND INSTALL APS PUSHBUTTON NORTHWEST CORNER

CHICAGO II 60606

US ROUTE 14


SEE SOUTHWEST CORNER -

EX 2 1/2"-UC-24'

EX (4)4"-VC-5'—

EX 2"-UC-54'

EX 2"-UC-277'

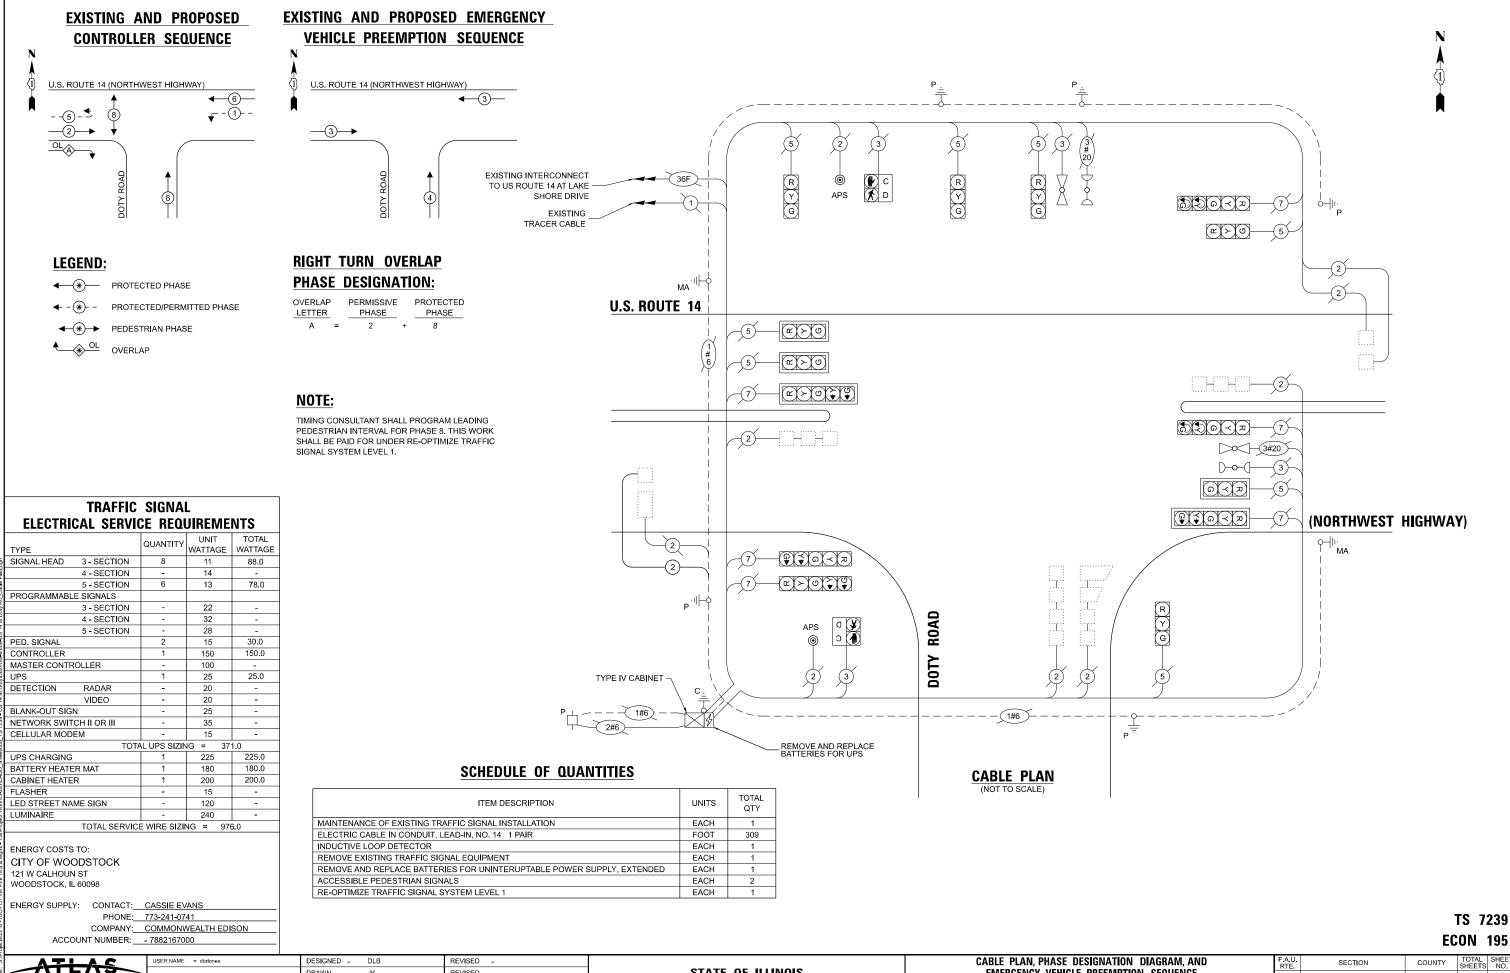

AODEL: Default TLE NAME: S:\Projects\

ATLAS

ATLAS TECHNICAL CONSULTANTS, LLC

100 S. WACKER DRIVE, SUITE 400

CHICAGO, IL 60606

STATE OF ILLINOIS DEPARTMENT OF TRANSPORTATION

CABLE PLAN, PHASE DESIGNATION DIAGRAM, AND EMERGENCY VEHICLE PREEMPTION SEQUENCE US ROUTE 14 AT DOTY ROAD


SHEET 2 OF 2 SHEETS STA. TO STA.

- 1. THIS PLAN IS FOR THE INSTALLATION OF LEADING PEDESTRIAN INTERVAL
- 2. ALL EXISTING TRAFFIC SIGNAL CABLE NO LONGER REQUIRED SHALL BE
- 3. SIDEWALK TO BE BROUGHT UP TO PROWAG STANDARDS ON A FUTURE CONTRACT.

#### **REMOVAL NOTES:**

THE FOLLOWING ITEMS SHALL BE REMOVED BY THE CONTRACTOR AND SHALL BE DISPOSED OF BY THEM OUTSIDE THE RIGHT-OF-WAY AT THEIR EXPENSE. THE SALVAGE VALUE OF THE REMOVED EQUIPMENT SHALL BE REFLECTED IN THE CONTRACT BID PRICE.

CONTROLLER (ASC/2s-1000)

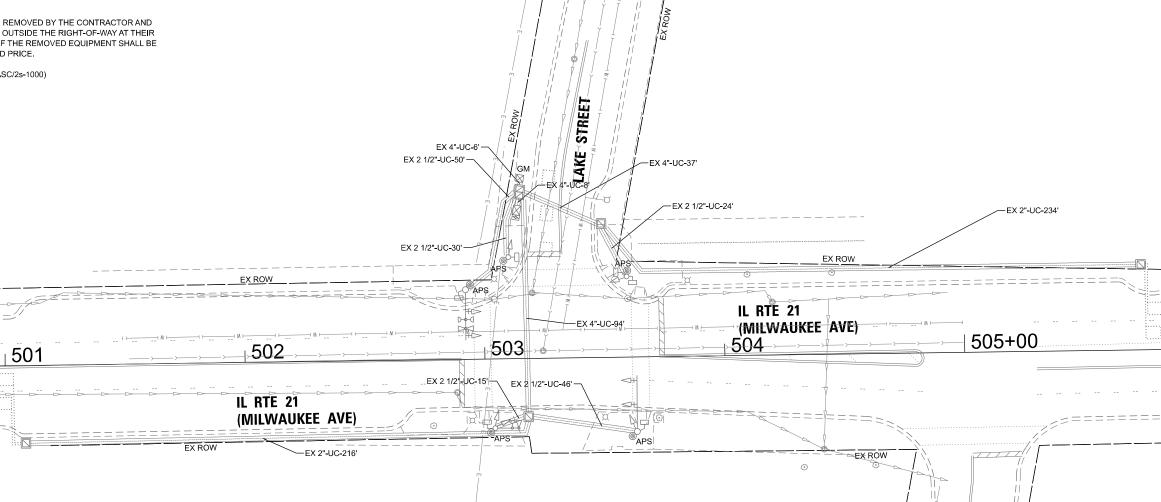




TS 21490 ECON 7

SCALE IN FEET (LAKE CO - CENTRACS)



JSER NAME = dbriones	DESIGNED - DLB	REVISED -
	DRAWN - JK	REVISED -
PLOT SCALE = 40.000 '/in.	CHECKED - DB	REVISED -
PLOT DATE = 7/31/2025	DATE - 07/31/2025	REVISED -

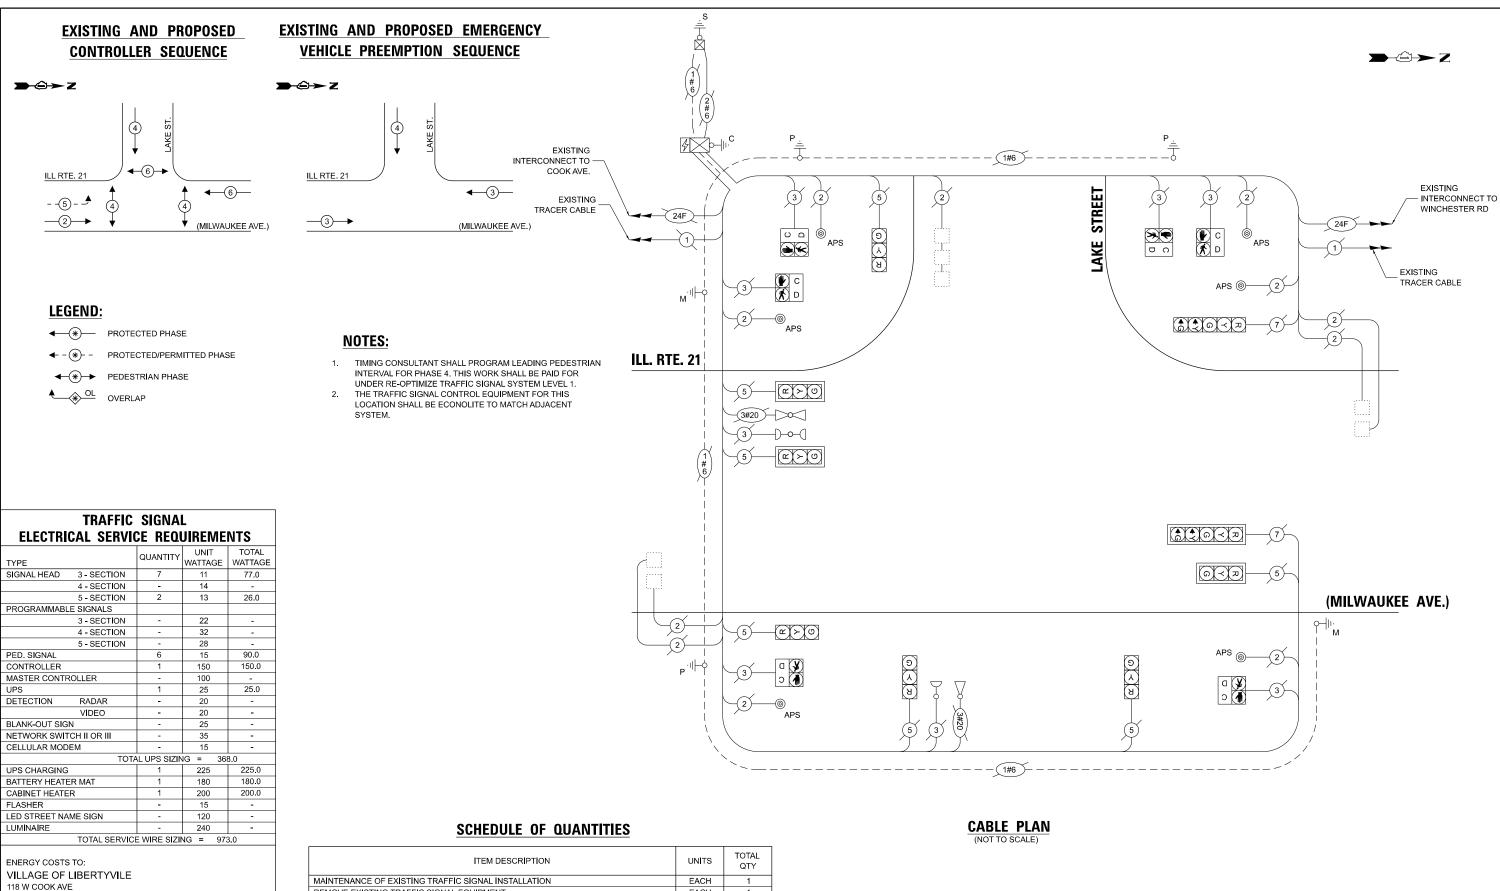

ENERGY SUPPLY: CONTACT: DANIEL MENDEZ

PHONE: 773-799-6111 COMPANY: COMMONWEALTH EDISON ACCOUNT NUMBER: \_\_\_ - 0220462222

ITEM DESCRIPTION	UNITS	TOTAL QTY
MAINTENANCE OF EXISTING TRAFFIC SIGNAL INSTALLATION	EACH	1
REMOVE EXISTING TRAFFIC SIGNAL EQUIPMENT	EACH	1
FULL-ACTUATED CONTROLLER IN EXISTING CABINET	EACH	1
RE-OPTIMIZE TRAFFIC SIGNAL SYSTEM LEVEL 1	EACH	1

TS 21490 ECON 7 (LAKE CO - CENTRACS)

ATLAS TECHNICAL CONSULTANTS, LLC 100 S. WACKER DRIVE, SUITE 400 CHICAGO, IL 60606

LIBERTYVILLE, IL 60048

JSER NAME = dbriones	DESIGNED	-	DLB	REVISED -	
	DRAWN	-	JK	REVISED -	
PLOT SCALE = 40.000 '/in.	CHECKED	-	DB	REVISED -	
PLOT DATE = 7/31/2025	DATE	-	07/31/2025	REVISED -	

STATE OF ILLINOIS **DEPARTMENT OF TRANSPORTATION** 

CABLE PLAN, PHASE DESIGNATION DIAGRAM, AND									
EMERGENCY VEHICLE PREEMPTION SEQUENCE									
ILLINOIS	ROUTE	21	(MILV	VAI	JKEE AV	/ENUE)	AND LAKE STREET		
SCALE: N.T.S.	SHEET	2	OF	2	SHEETS	STA.	TO STA.		

A.U. RTE.	SECTION	COUNTY	TOTAL SHEETS	SHEET NO.			
ΚΧΧ	2024-964-TS		LAKE	89	21		
			CONTRACT	NO. 62\	V89		
	ILLINOIS FED. AID PROJECT						

- THIS PLAN IS FOR THE INSTALLATION OF APS PUSH BUTTONS AND LEADING PEDESTRIAN INTERVAL PROGRAMMING.
- 2. ALL PUSH BUTTONS SHALL BE APS.
- 3. APS SHALL BE PLACED PARALLEL TO THE CORRESPONDING
- 4. CONTRACTOR SHALL CONFIRM THE FINAL LOCATION OF THE PEDESTRIAN EQUIPMENT WITH THE TRAFFIC SIGNAL ENGINEER BEFORE INSTALLATION.
- 5. ALL EXISTING TRAFFIC SIGNAL CABLE NO LONGER REQUIRED SHALL BE
- 6. SIDEWALK TO BE BROUGHT UP TO PROWAG STANDARDS ON A FUTURE CONTRACT.

#### **REMOVAL NOTES:**

THE FOLLOWING ITEMS SHALL BE REMOVED BY THE CONTRACTOR AND SHALL BE DISPOSED OF BY THEM OUTSIDE THE RIGHT-OF-WAY AT THEIR EXPENSE. THE SALVAGE VALUE OF THE REMOVED EQUIPMENT SHALL BE REFLECTED IN THE CONTRACT BID PRICE.

PEDESTRIAN PUSHBUTTON EACH

EACH

- SEE SOUTHWEST CORNER IL RTE 21 AVEI EX 2"-UC-276" EX 3"-UC-54" EX 3",-UC-35'-EX 3",-UC-16'-EX 3"-UC-47 EX 3"-UC-40'-SEE SOUTHEAST CORNER -EX 4"-UC-53' EX 2 1/2"-UC-11" EX 2"-UC-22' -EX 2 1/2"-UC-44' IL RTE 21 (MILWAUKEE AVE) EX 2"-UC-10' -EX 2"-UC-247' REM. EX. PUSHBUTTON AND REPLACE WITH NEW APS PUSHBUTTON REM. EX. PUSHBUTTON AND REPLACE WITH NEW APS PUSHBUTTON TS 21410

NORTHWEST CORNER

CHICAGO II 60606

USER NAME = dbriones	DESIGNED	-	DLB	REVISED -
	DRAWN	$\times$	JK	REVISED -
PLOT SCALE - 40.000 '/ in.	CHECKED	-	DB	REVISED -
PLOT DATE = 7/31/2025	DATE	-	07/31/2025	REVISED -


STATE OF ILLINOIS **DEPARTMENT OF TRANSPORTATION** 

SOUTHWEST CORNER

	SCALE IN FEET		LAKE COUNT	ГУ – СЕ	NTR#	CS
I	TRAFFIC SIGNAL INSTALLATION PLAN	F.A.U. RTE.	SECTION	COUNTY	TOTAL SHEETS	SHEET NO.
	ILLINOIS ROUTE 21 (MILWAUKEE AVE) AT CORPORATE WOODS PKWY	XXX	2024-964-TS	LAKE	89	22
				CONTRACT	NO. 62V	N89
١	SCALE: 1"=20' SHEET 1 OF 20 SHEETS STA. TO STA.		ILLINOIS FED. AI	D PROJECT		

 $\rightarrow \ominus \rightarrow Z$ 

ECON 24

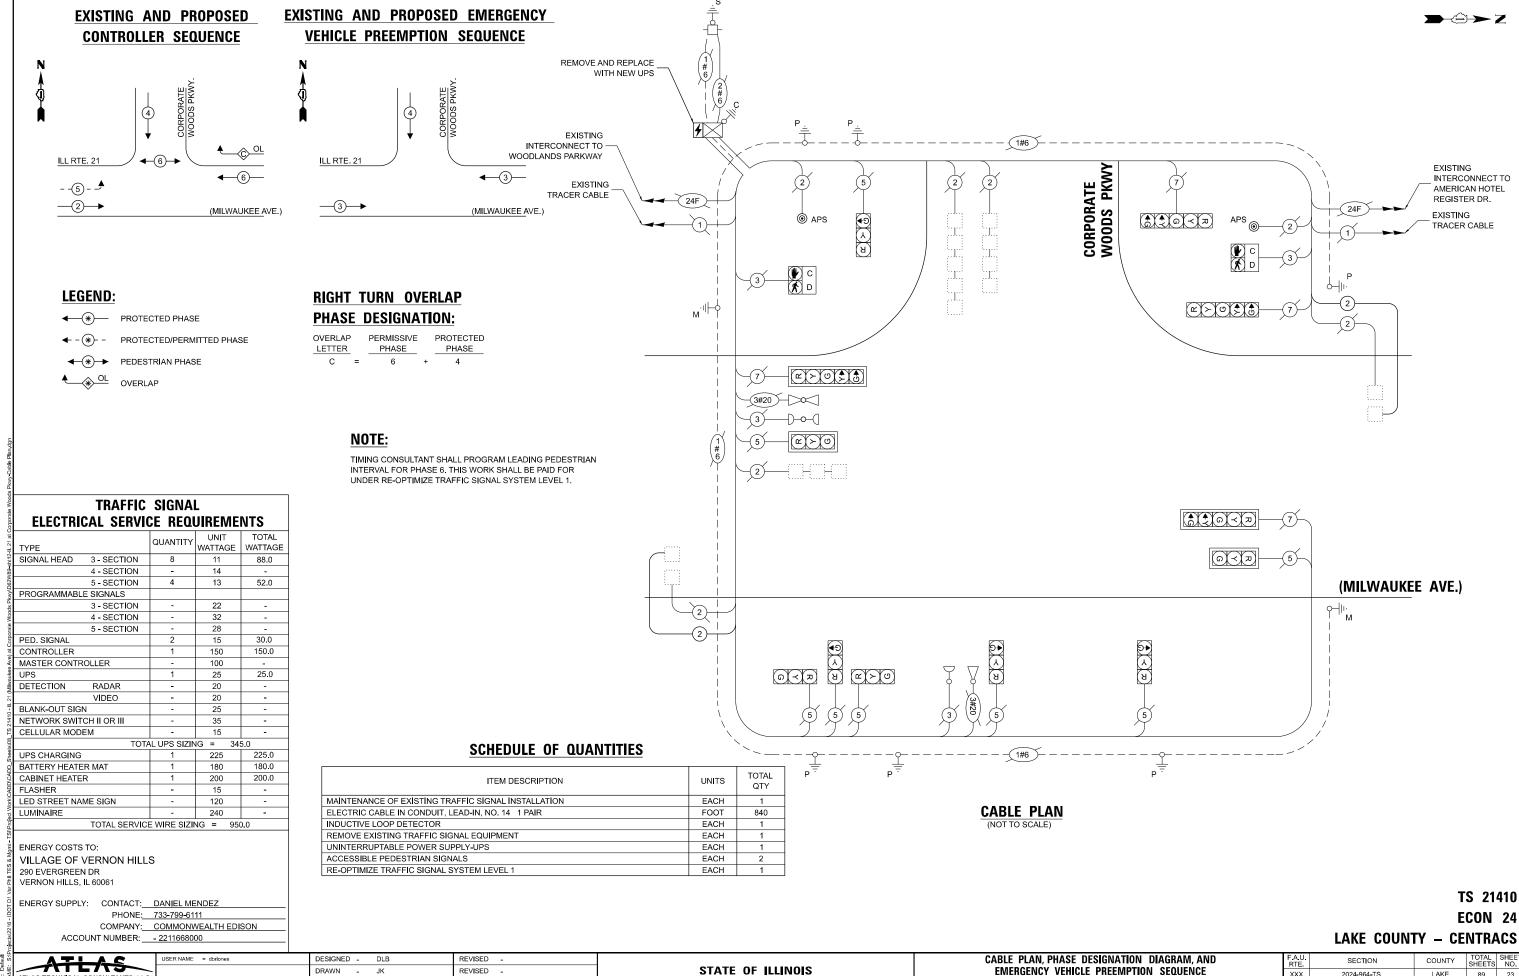

**DEPARTMENT OF TRANSPORTATION** 

XXX

ILLINOIS ROUTE 21 (MILWAUKEE AVE) AT CORPORATE WOODS PKWY

SHEET 2 OF 2 SHEETS STA.

SCALE: NTS

2024-964-TS

LAKE 89 23

CONTRACT NO. 62W89

TLAS TECHNICAL CONSULTANTS, LLC

100 S. WACKER DRIVE, SUITE 400 CHICAGO, IL 60606

PLOT DATE = 7/31/2025

DB

- 07/31/2025

DATE

REVISED

REVISED .

- 1. THIS PLAN IS FOR THE INSTALLATION OF APS PUSH BUTTONS AND LEADING PEDESTRIAN INTERVAL PROGRAMMING.
- 2. ALL PUSH BUTTONS SHALL BE APS.
- 3. APS SHALL BE PLACED PARALLEL TO THE CORRESPONDING CROSSWALKS.
- 4. CONTRACTOR SHALL CONFIRM THE FINAL LOCATION OF THE PEDESTRIAN EQUIPMENT WITH THE TRAFFIC SIGNAL ENGINEER BEFORE INSTALLATION.
- 5. ALL EXISTING TRAFFIC SIGNAL CABLE NO LONGER REQUIRED SHALL BE
- 6. SIDEWALK TO BE BROUGHT UP TO PROWAG STANDARDS ON A FUTURE CONTRACT.


#### **REMOVAL NOTES:**

THE FOLLOWING ITEMS SHALL BE REMOVED BY THE CONTRACTOR AND SHALL BE DISPOSED OF BY THEM OUTSIDE THE RIGHT-OF-WAY AT THEIR EXPENSE. THE SALVAGE VALUE OF THE REMOVED EQUIPMENT SHALL BE REFLECTED IN THE CONTRACT BID PRICE.


PEDESTRIAN PUSHBUTTON 4 EACH





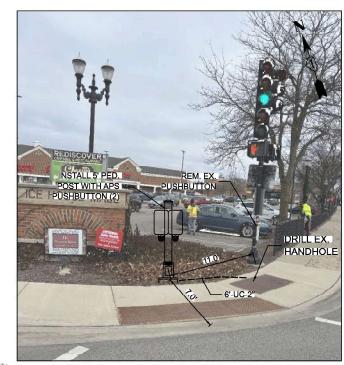

EX 2 1/2"-UC-6' -2"-UC-10' — SEE NORTHWEST CORNER - SEE NORTHEAST CORNER EX 3 1/2"-UC-25' EX 3"-UC-56' – ĖX 2"-UC-36' 701 703 702

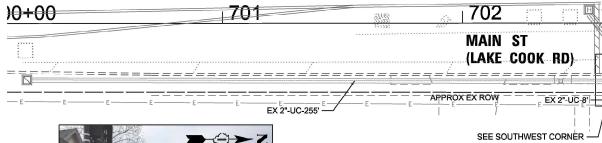



SOUTHWEST CORNER

705+00 <sub>⊥</sub>704

NORTHEAST CORNER

**MAIN ST** (LAKE COOK RD)

APPROX EX ROW

- EX 3 1/2"-UC-62'

SOUTHEAST CORNER

SCALE IN FEET

TS 11282 **EAGLE 1D** LAKE CO - CENTRACS

CHICAGO II 60606

USER NAME = dbriones	DESIGNED -	DLB	REVISED -
	DRAWN -	JK	REVISED -
PLOT SCALE - 40.000 '/ in.	CHECKED -	DB	REVISED -
PLOT DATE = 7/31/2025	DATE -	07/31/2025	REVISED -

STATE OF ILLINOIS **DEPARTMENT OF TRANSPORTATION** 


EX 2"-UC-17'

EX 2"-UC-45"

- EX 1 1/2"-UC-55'

TRAFFIC SIGNAL INSTALLATION PLAN										
	MAIN	STREET	(LA	KE	COOK	ROAD	) AT	APPLEBEE	STREET	
SCALE:	1"=20'	SHEET	1	OF	2	SHEETS	STA.		TO STA.	

ijΈ	SECTION		COUNTY	TOTAL SHEETS	SHEET NO.
X	2024-964-TS		COOK	89	24
			CONTRACT	NO. 62\	N89
	ILLINOIS	FED. Al	D PROJECT		

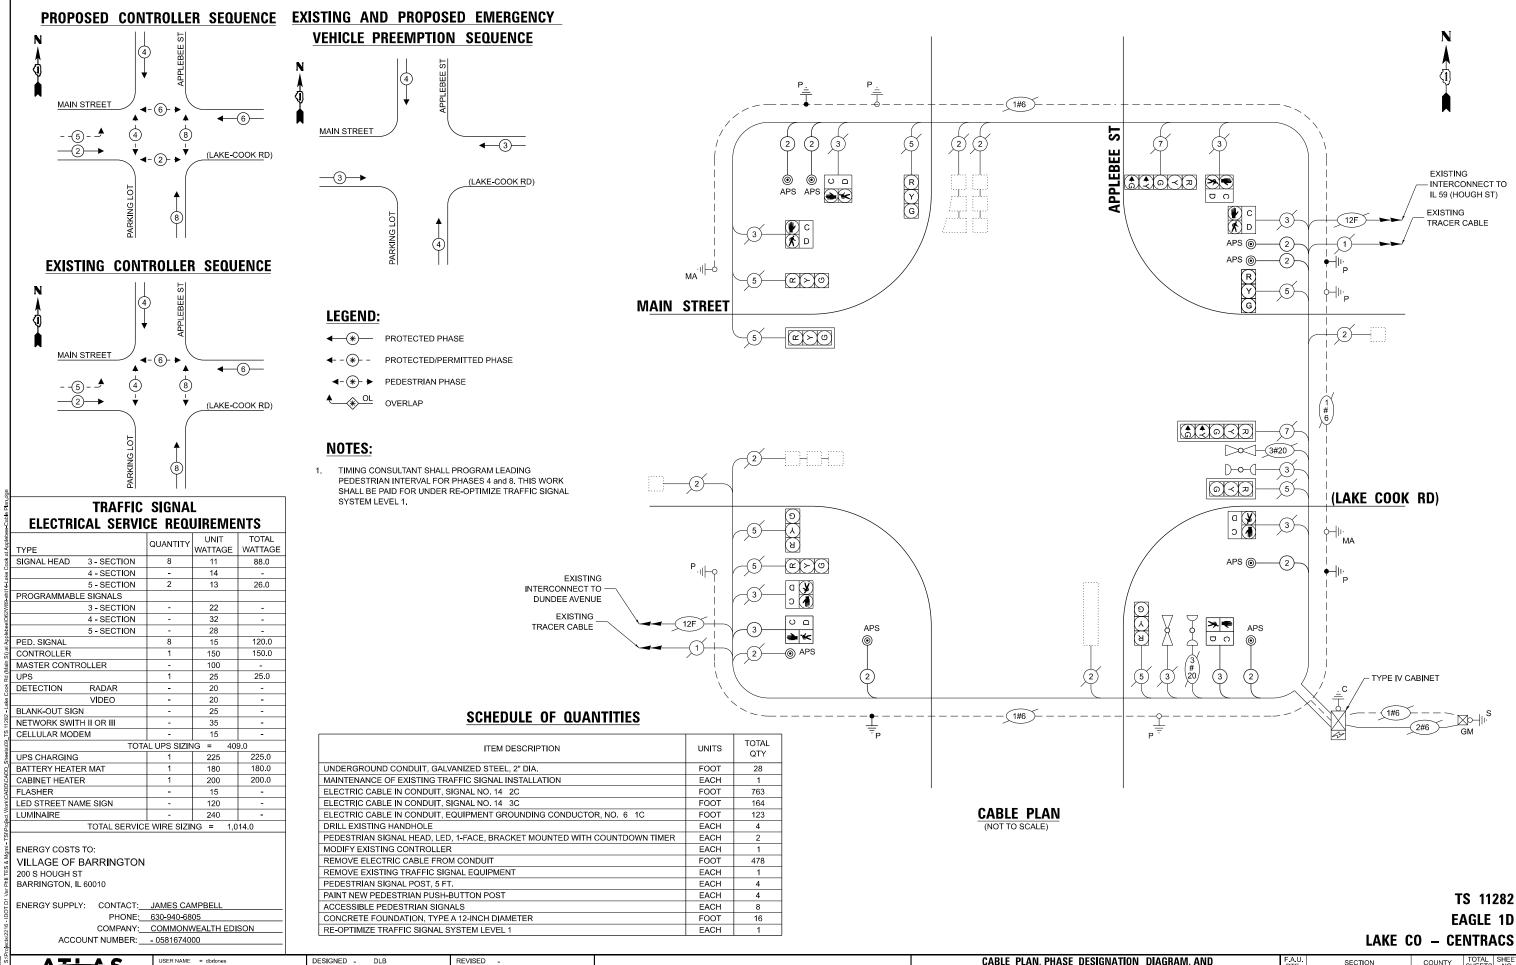

STATE OF ILLINOIS

**DEPARTMENT OF TRANSPORTATION** 

**EMERGENCY VEHICLE PREEMPTION SEQUENCE** 

MAIN STREET (LAKE COOK ROAD) AT APPLEBEE STREET

SHEET 2 OF 2 SHEETS STA.

XXX

2024-964-TS

COOK 89 25

CONTRACT NO. 62W89

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TLAS TECHNICAL CONSULTANTS, LLC

100 S. WACKER DRIVE, SUITE 400 CHICAGO, IL 60606

PLOT DATE = 7/31/2025

DRAWN - JK

DATE


DB

- 07/31/2025

REVISED -

REVISED -


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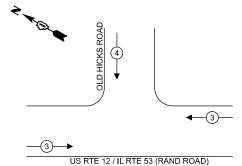

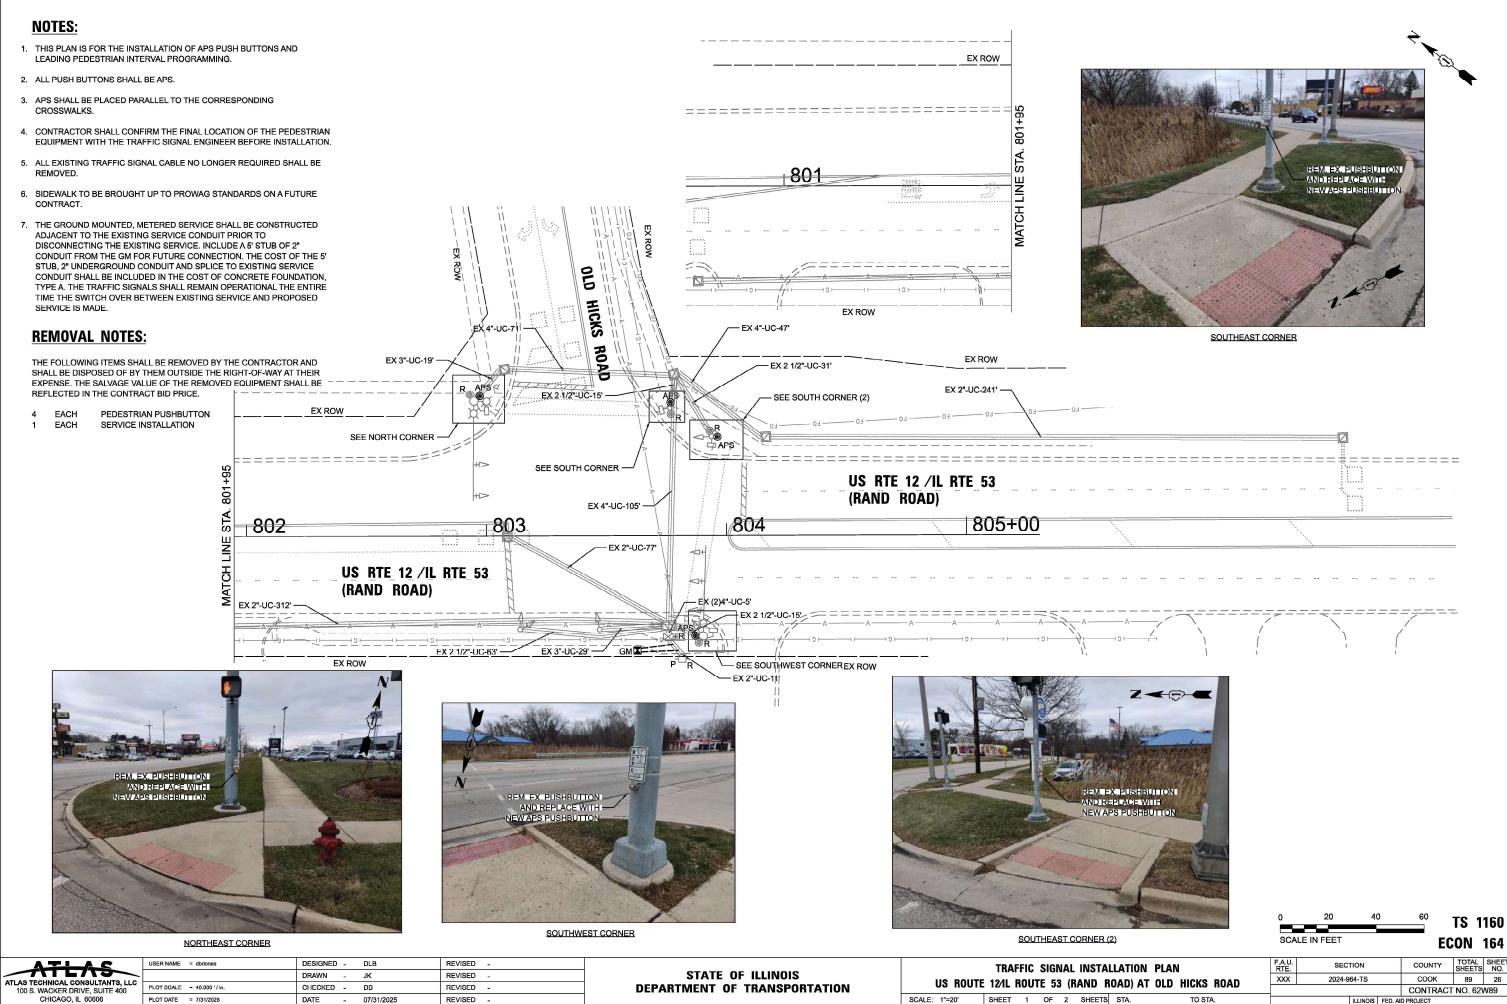
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#### **EXISTING AND PROPOSED CONTROLLER SEQUENCE**

#### **EXISTING AND PROPOSED EMERGENCY VEHICLE PREEMPTION SEQUENCE**



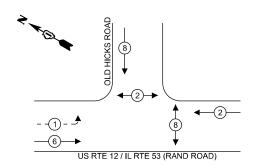

#### LEGEND:

**★** PROTECTED PHASE

← -(\*)- - PROTECTED/PERMITTED PHASE

**◆**(\*)→ PEDESTRIAN PHASE

♦ OL OVERLAP

#### NOTE:

TIMING CONSULTANT SHALL PROGRAM LEADING PEDESTRIAN INTERVAL FOR PHASE 8. THIS WORK SHALL BE PAID FOR UNDER RE-OPTIMIZE TRAFFIC SIGNAL SYSTEM LEVEL 1.

#### TRAFFIC SIGNAL **ELECTRICAL SERVICE REQUIREMENTS**

TYPE		QUANTITY	UNIT WATTAGE	TOTAL WATTAGE		
SIGNAL HEAD	3 - SECTION	8	11	88.0		
	4 - SECTION	-	14	-		
	5 - SECTION	2	13	26.0		
PROGRAMMABL	E SIGNALS					
	3 - SECTION	-	22	-		
	4 - SECTION	-	32	-		
	5 - SECTION	-	28	-		
PED. SIGNAL		4	15	60.0		
CONTROLLER		1	150	150.0		
MASTER CONTR	OLLER	-	100	-		
UPS		1	25	25.0		
DETECTION	RADAR	-	20	-		
	VIDEO	-	20	-		
BLANK-OUT SIG	N	-	25	-		
NETWORK SWIT	CH II OR III	-	35	-		
CELLULAR MODI	EM	-	15	-		
	TOTA	L UPS SIZIN	IG = 349	9.0		
UPS CHARGING		1	225	225.0		
BATTERY HEATE	R MAT	1	180	180.0		
UPS CHARGING BATTERY HEATE CABINET HEATE FLASHER	R	1	200	200.0		
FLASHER		-	15	-		
LED STREET NA	ME SIGN	-	120	-		
LUMINAIRE		-	240	-		
TOTAL SERVICE WIRE SIZING = 954.0						

ENERGY COSTS TO: VILLAGE OF PALATINE 200 E WOOD ST PALATINE, IL 60067


ENERGY SUPPLY: CONTACT: JAMES CAMPBELL

PHONE: 630-940-6805 COMPANY: COMMONWEALTH EDISON

ACCOUNT NUMBER: - 6366886000





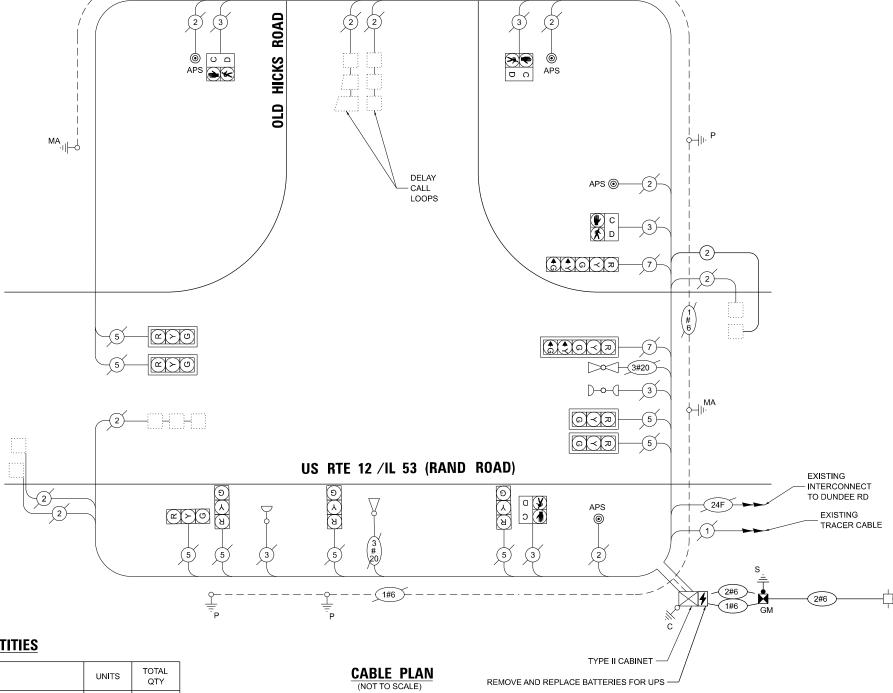

#### SCHEDULE OF QUANTITIES

ITEM DESCRIPTION	UNITS	TOTAL QTY
MAINTENANCE OF EXISTING TRAFFIC SIGNAL INSTALLATION	EACH	1
ELECTRIC CABLE IN CONDUIT, LEAD-IN, NO. 14 1 PAIR	FOOT	439
ELECTRIC CABLE IN CONDUIT, SERVICE, NO. 6 2 C	FOOT	42
CONCRETE FOUNDATION, TYPE A	FOOT	4
INDUCTIVE LOOP DETECTOR	EACH	1
REMOVE EXISTING TRAFFIC SIGNAL EQUIPMENT	EACH	1
UNINTERRUPTABLE POWER SUPPLY AND CABINET, SPECIAL	EACH	1
SERVICE INSTALLATION, GROUND MOUNTED, METERED	EACH	1
REMOVE AND REPLACE BATTERIES FOR UNINTERUPTABLE POWER SUPPLY, EXTENDED	EACH	1
ACCESSIBLE PEDESTRIAN SIGNALS	EACH	4
RE-OPTIMIZE TRAFFIC SIGNAL SYSTEM LEVEL 1	EACH	1

TS 1160 **ECON 164** 



ER NAME = dbriones	DESIGNED - DLB	REVISED -
	DRAWN - JK	REVISED -
DT SCALE = 40.000'/in.	CHECKED - DB	REVISED -
DT DATE = 7/31/2025	DATE - 07/31/2025	REVISED -

STATE OF ILLINOIS				
DEPARTMENT	0F	TRANSPORTATION		

CABLE PLAN, PHASE DESIGNATION DIAGRAM, AND EMERGENCY VEHICLE PREEMPTION SEQUENCE									
US ROUT	TE 12/1L	ROUT	E 53	(RA	AND R	(0AD)	AT OLD	HICKS ROAD	)
SCALE: N.T.S.	SHEET	2	OF	2	SHEETS	STA.		TO STA.	

U. E.	SEC.	TION		COUNTY	TOTAL SHEETS	SHEE NO.
X	2024-9	2024-964-TS			89	27
				CONTRACT	NO. 62\	V89
		ILLINOIS	FED. Al	D PROJECT		

- THIS PLAN IS FOR THE INSTALLATION OF APS PUSH BUTTONS AND LEADING PEDESTRIAN INTERVAL PROGRAMMING.
- 2. ALL PUSH BUTTONS SHALL BE APS.
- 3. APS SHALL BE PLACED PARALLEL TO THE CORRESPONDING CROSSWALKS.
- 4. CONTRACTOR SHALL CONFIRM THE FINAL LOCATION OF THE PEDESTRIAN EQUIPMENT WITH THE TRAFFIC SIGNAL ENGINEER BEFORE INSTALLATION.
- ALL EXISTING TRAFFIC SIGNAL CABLE NO LONGER REQUIRED SHALL BE REMOVED.
- 6. SIDEWALK TO BE BROUGHT UP TO PROWAG STANDARDS ON A FUTURE CONTRACT.

#### **REMOVAL NOTES:**

THE FOLLOWING ITEMS SHALL BE REMOVED BY THE CONTRACTOR AND SHALL BE DISPOSED OF BY THEM OUTSIDE THE RIGHT-OF-WAY AT THEIR EXPENSE. THE SALVAGE VALUE OF THE REMOVED EQUIPMENT SHALL BE REFLECTED IN THE CONTRACT BID PRICE.

3 EACH PEDESTRIAN PUSHBUTTON

EACH TRAFFIC SIGNAL CONTROLLER (ASC/2S-2100) AND

CABINET (TS-2) COMPLETE


**REMOVAL AND RELOCATION NOTES:** 

THE FOLLOWING EXISTING TRAFFIC SIGNAL EQUIPMENT SHALL BE REMOVED BY THE CONTRACTOR, SAFELY STORED AND RELOCATED TO THE PROPOSED MAST ARMS, POSTS, AND TRAFFIC SIGNAL CONTROLLER CABINET.

1 EACH LIGHT DETECTOR AMPLIFIER






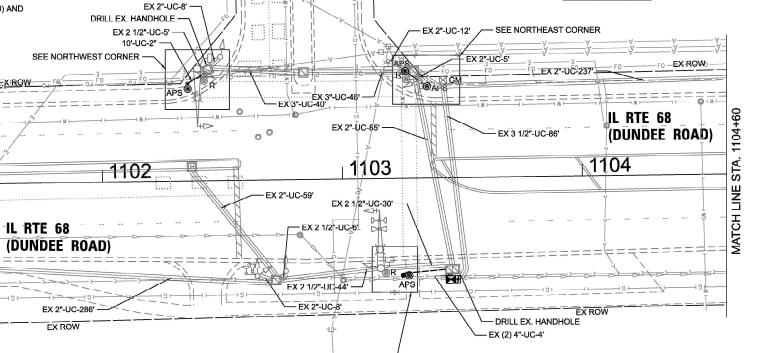

ANTHONY

SEE SOUTHEAST CORNER

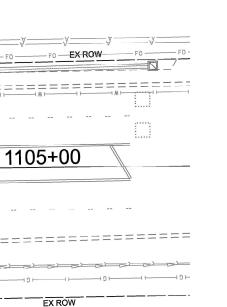



NORTHEAST CORNER



SOUTHEAST CORNER

0	20	40	60	TS 313	7
SCALE	IN FEET			ECON 8	6

ECON 86

ATLAS TECHNICAL CONSULTANTS, LLC 100 S. WACKER DRIVE, SUITE 400 CHICAGO, IL 60606

 USER NAME
 = dbriones
 DESIGNED
 DLB
 REVISED

 DRAWN
 JK
 REVISED


 PLOT GCALL
 - 40.000 '/ in.
 CHECKED
 DD
 REVISED

 PLOT DATE
 = 7/31/2025
 DATE
 07/31/2025
 REVISED

STATE OF ILLINOIS
DEPARTMENT OF TRANSPORTATION

TRAFFIC SIGNAL INSTALLATION PLAN
ANTHONY TRAIL AND ILLINOIS ROUTE 68 (DUNDEE ROAD)

SCALE: 1"=20" SHEET 1 OF 2 SHEETS STA. TO STA.

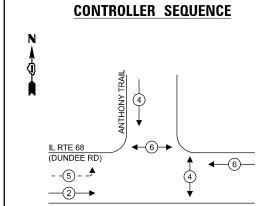

**LEGEND**:

**←**(\*)**→** 

OL OVERLAP


**★**PROTECTED PHASE

PROTECTED/PERMITTED PHASE

PEDESTRIAN PHASE


**EXISTING AND PROPOSED** 

## EXISTING AND PROPOSED EMERGENCY VEHICLE PREEMPTION SEQUENCE

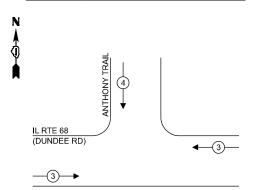

#### NOTES:

- TIMING CONSULTANT SHALL PROGRAM LEADING PEDESTRIAN INTERVAL FOR PHASE 4. THIS WORK SHALL BE PAID FOR UNDER RE-OPTIMIZE TRAFFIC SIGNAL SYSTEM LEVEL 1.
- 2. THE TRAFFIC SIGNAL CONTROL EQUIPMENT FOR THIS LOCATION SHALL BE ECONOLITE TO MATCH EXISTING ADJACENT SYSTEM.

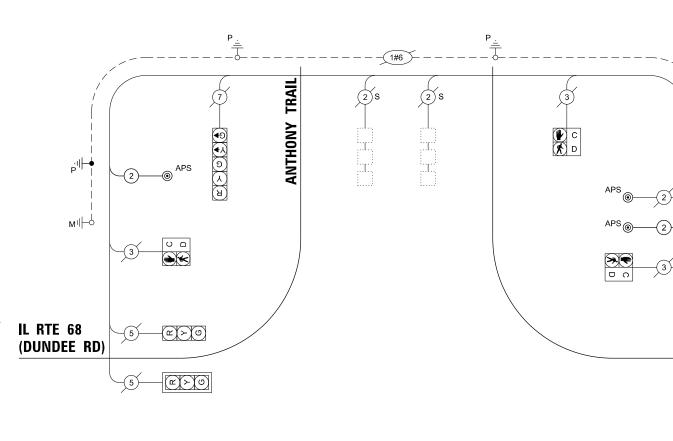

## TRAFFIC SIGNAL ELECTRICAL SERVICE REQUIREMENTS QUANTITY UNIT TOTAL WATTAGE WATTAGE

SIGNAL HEAD 3 - SECTION 5 11 55.0

0.0	_		00.0
4 - SECTION	-	14	-
5 - SECTION	3	13	39.0
PROGRAMMABLE SIGNALS			
3 - SECTION	-	22	-
4 - SECTION	-	32	-
5 - SECTION	-	28	-
PED. SIGNAL	4	15	60.0
CONTROLLER	1	150	150.0
MASTER CONTROLLER	-	100	-
UPS	1	25	25.0
DETECTION RADAR	-	20	-
VIDEO	-	20	-
BLANK-OUT SIGN	-	25	-
NETWORK SWITH II OR III	-	35	-
CELLULAR MODEM	-	15	-
TOTA	AL UPS SIZIN	IG = 329	9.0
UPS CHARGING	1	225	225.0
BATTERY HEATER MAT	1	180	180.0
CABINET HEATER	1	200	200.0
FLASHER	-	15	-
LED STREET NAME SIGN	-	120	-
LUMINAIRE	-	240	-
TOTAL SERVICE	E WIRE SIZI	NG = 934	4.0


ENERGY COSTS TO:
VILLAGE OF NORTHBROOK
1225 CEDAR LANE
NORTHBROOK, IL 60062

ENERGY SUPPLY: CONTACT: AXL DAVI

CONTACT: <u>AXL DAVIS</u> PHONE: <u>773-231-2969</u>

COMPANY: COMMONWEALTH E
ACCOUNT NUMBER: - 5090906000

AVIS	
1-2969	
ONWEALTH EDISON	
906000	

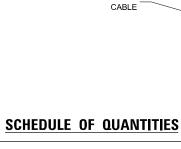

EXISTING

INTERCONNECT TO LANDWEAR RD

EXISTING TRACER

ITEM DESCRIPTION	UNITS	TOTAL QTY
UNDERGROUND CONDUIT, GALVANIZED STEEL, 2" DIA.	FOOT	31
MAINTENANCE OF EXISTING TRAFFIC SIGNAL INSTALLATION	EACH	1
ELECTRIC CABLE IN CONDUIT, SIGNAL NO. 14 2C	FOOT	405
ELECTRIC CABLE IN CONDUIT, LEAD-IN, NO. 14 1 PAIR	FOOT	721
ELECTRIC CABLE IN CONDUIT, EQUIPMENT GROUNDING CONDUCTOR, NO. 6 1C	FOOT	79
DRILL EXISTING HANDHOLE	EACH	2
INDUCTIVE LOOP DETECTOR	EACH	2
RELOCATE EXISTING EMERGENCY VEHICLE PRIORITY SYSTEM, PHASING UNIT	EACH	2
REMOVE ELECTRIC CABLE FROM CONDUIT	FOOT	264
REMOVE EXISTING TRAFFIC SIGNAL EQUIPMENT	EACH	1
UNINTERRUPTABLE POWER SUPPLYAND CABINET, SPECIAL	EACH	1
PEDESTRIAN SIGNAL POST, 5 FT.	EACH	2
FULL-ACTUATED CONTROLLER AND TYPE IV CABINET (SPECIAL)	EACH	1
ACCESSIBLE PEDESTRIAN SIGNALS	EACH	4
CONCRETE FOUNDATION, TYPE A 12-INCH DIAMETER	FOOT	8
RE-OPTIMIZE TRAFFIC SIGNAL SYSTEM LEVEL 1	EACH	1

CABLE PLAN (NOT TO SCALE)

1#6

APS (®)

TS 3137 ECON 86

EXISTING INTERCONNECT TO

PFINGSTEN RD

EXISTING TRACER

ATLAS TECHNICAL CONSULTANTS, LLC
100 S. WACKER DRIVE, SUITE 400
CHICAGO, IL 60606

| DESIGNED | DLB | REVISED | - | DRAWN | - | JK | REVISED | - | | DRAWN | - | JK | REVISED | - | | DRAWN | - | DB | REVISED | - | | DRAWN | - | DB | REVISED | - | DRAWN | - | DATE | - | O7/31/2025 | REVISED | - | | DATE | - | O7/31/2025 | REVISED | - | DRAWN | - | DRAWN

STATE OF ILLINOIS
DEPARTMENT OF TRANSPORTATION

EXISTING CABLE PLAN, EXISTING PHASE DESIGNATION DIAGRAM AND EMERGENCY VEHICLE PREEMPTION SEQUENCE, AND SCHEDULE OF QUANTITIES

IL RTE 68 (DUNDEE ROAD) AT ANTHONY TRAIL

SCALE: N.T.S. | SHEET | 2 OF 2 SHEETS | STA. TO STA.

)	F.A.U. RTE	SECTION		COUNTY	TOTAL SHEETS	SHEE NO.
ITIES	XXX	2024-964-TS		соок	89	29
				CONTRACT	NO. 62\	N89
		ILLINOIS	FED. A	D PROJECT		

TYPE IV CABINET (SPECIAL)

- 1. THIS PLAN IS FOR THE INSTALLATION OF APS PUSH BUTTONS AND LEADING PEDESTRIAN INTERVAL PROGRAMMING.
- 2. ALL PUSH BUTTONS SHALL BE APS.
- 3. APS SHALL BE PLACED PARALLEL TO THE CORRESPONDING CROSSWALKS.
- 4. CONTRACTOR SHALL CONFIRM THE FINAL LOCATION OF THE PEDESTRIAN EQUIPMENT WITH THE TRAFFIC SIGNAL ENGINEER BEFORE INSTALLATION.
- 5. ALL EXISTING TRAFFIC SIGNAL CABLE NO LONGER REQUIRED SHALL BE
- 6. SIDEWALK TO BE BROUGHT UP TO PROWAG STANDARDS ON A FUTURE CONTRACT.
- 7. THE GROUND MOUNTED, METERED SERVICE SHALL BE CONSTRUCTED ADJACENT TO THE EXISTING SERVICE CONDUIT PRIOR TO DISCONNECTING THE EXISTING SERVICE. INCLUDE A 5' STUB OF 2" CONDUIT FROM THE GM FOR FUTURE CONNECTION. THE COST OF THE 5' STUB, 2" UNDERGROUND CONDUIT AND SPLICE TO EXISTING SERVICE CONDUIT SHALL BE INCLUDED IN THE COST OF CONCRETE FOUNDATION, TYPE A. THE TRAFFIC SIGNALS SHALL REMAIN OPERATIONAL THE ENTIRE TIME THE SWITCH OVER BETWEEN EXISTING SERVICE AND PROPOSED SERVICE IS MADE.

#### **REMOVAL AND RELOCATION NOTES:**

THE FOLLOWING ITEMS SHALL BE REMOVED BY THE CONTRACTOR AND SHALL BE DISPOSED OF BY THEM OUTSIDE THE RIGHT-OF-WAY AT THEIR EXPENSE. THE SALVAGE VALUE OF THE REMOVED EQUIPMENT SHALL BE REFLECTED IN THE CONTRACT BID PRICE.

PEDESTRIAN PUSHBUTTON EACH

TRAFFIC SIGNAL CONTROLLER (EPAC 300 M40) AND EACH


CABINET (TS-2) COMPLETE

THE FOLLOWING EXISTING TRAFFIC SIGNAL EQUIPMENT SHALL BE REMOVED BY THE CONTRACTOR AND RELOCATED TO THE PROPOSED GROUND MOUNTED SERVICE:

SERVICE METER 1 EACH

THE FOLLOWING EXISTING TRAFFIC SIGNAL EQUIPMENT SHALL BE REMOVED BY THE CONTRACTOR, SAFELY STORED AND RELOCATED TO THE PROPOSED MAST ARMS, POSTS, AND TRAFFIC SIGNAL CONTROLLER

1 EACH LIGHT DETECTOR AMPLIFIER

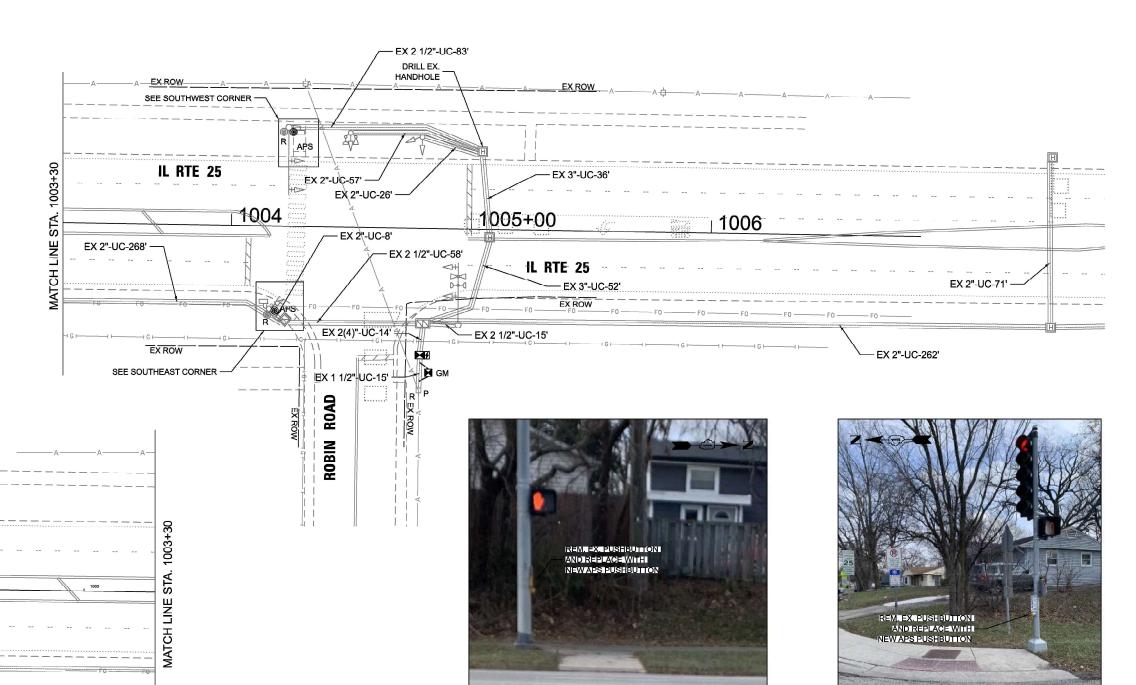

SOUTHWEST CORNER

SCALE: 1"=20'



SER NAME = dbriones	DESIGNED	-	DLB	REVISED -	Г
	DRAWN	×	JK	REVISED -	
LOT SCALE - 40.000 '/ in.	CHECKED	-	DB	REVISED -	
LOT DATE = 7/31/2025	DATE	_	07/31/2025	REVISED -	

STATE OF ILLINOIS **DEPARTMENT OF TRANSPORTATION** 

TRAFFIC SIGNAL INSTALLATION PLAN IL ROUTE 25 AT ROBIN ROAD SHEET 1 OF 2 SHEETS STA. TO STA.

**EAGLE 5G** TOTAL SHEET NO. SECTION COUNTY 2024-964-TS KANE CONTRACT NO. 62W89

TS 4325

SOUTHEAST CORNER


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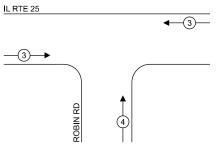
#### **EXISTING AND PROPOSED** CONTROLLER SEQUENCE

#### **EXISTING AND PROPOSED EMERGENCY VEHICLE PREEMPTION SEQUENCE**





#### 

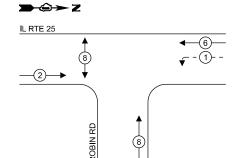

#### **LEGEND:**

**★**PROTECTED PHASE

PROTECTED/PERMITTED PHASE

**←**(\*)**→** PEDESTRIAN PHASE

OL OVERLAP

#### NOTES:

- TIMING CONSULTANT SHALL PROGRAM LEADING PEDESTRIAN INTERVAL FOR PHASE 8. THIS WORK SHALL BE PAID FOR UNDER RE-OPTIMIZE TRAFFIC SIGNAL SYSTEM LEVEL 1.
- THE TRAFFIC SIGNAL CONTROL EQUIPMENT FOR THIS LOCATION SHALL BE EAGLE TO MATCH EXISTING ADJACENT SYSTEM.

#### TRAFFIC SIGNAL **ELECTRICAL SERVICE REQUIREMENTS**

	QUANTITY	UNIT	TOTAL
TYPE	QUANTITI	WATTAGE	WATTAGE
SIGNAL HEAD 3 - SECTION	6	11	66.0
4 - SECTION	-	14	-
5 - SECTION	2	13	26.0
PROGRAMMABLE SIGNALS			
3 - SECTION	-	22	-
4 - SECTION	-	32	-
5 - SECTION	-	28	-
PED. SIGNAL	2	15	30.0
CONTROLLER	1	150	150.0
MASTER CONTROLLER	-	100	-
UPS	1	25	25.0
DETECTION RADAR	-	20	-
VIDEO	-	20	-
BLANK-OUT SIGN	-	25	-
NETWORK SWITCH II OR III	-	35	-
CELLULAR MODEM	-	15	-
TOTA	AL UPS SIZIN	NG = 29	7.0
UPS CHARGING	1	225	225.0
BATTERY HEATER MAT	1	180	180.0
CABINET HEATER	1	200	200.0
FLASHER	-	15	-
LED STREET NAME SIGN	-	120	-
LUMINAIRE	-	240	-
TOTAL SERVICE	E WIRE SIZII	NG = 902	2.0

ENERGY COSTS TO: VILLAGE OF CARPENTERSVILLE 1200 L.W. BESINGER DR CARPENTERSVILLE, IL 60110

ENERGY SUPPLY: CONTACT: CASSIE EVANS

ACCOUNT NUMBER: - 4285848000

PHONE: 773-241-0741 ACCESSIBLE PEDESTRIAN SIGNALS COMPANY: COMMONWEALTH EDISON RE-OPTIMIZE TRAFFIC SIGNAL SYSTEM LEVEL 1

IL RTE 25 EXISTING INTERCONNECT TO HAZARD RD LAKE MARIAN RD EXISTING 24F TRACER CABLE

ITEM DESCRIPTION QTY MAINTENANCE OF EXISTING TRAFFIC SIGNAL INSTALLATION ELECTRIC CABLE IN CONDUIT, LEAD-IN, NO. 14 1 PAIR FOOT 713 ELECTRIC CABLE IN CONDUIT, SERVICE, NO. 6 2 C FOOT 18 CONCRETE FOUNDATION, TYPE A FOOT 4 INDUCTIVE LOOP DETECTOR EACH RELOCATE EXISTING TRAFFIC SIGNAL EQUIPMENT EACH 1 RELOCATE EXISTING EMERGENCY VEHICLE PRIORITY SYSTEM, PHASING UNIT FACH REMOVE EXISTING TRAFFIC SIGNAL EQUIPMENT EACH UNINTERRUPTABLE POWER SUPPLY AND CABINET, SPECIAL SERVICE INSTALLATION, GROUND MOUNTED, METERED EACH FULL-ACTUATED CONTROLLER AND TYPE IV CABINET (SPECIAL) EACH

EXISTING - INTERCONNECT TO KINGS RD EXISTING TRACER CABLE SCHEDULE OF QUANTITIES TYPE IV (SPECIAL) CABINET -ROBIN TOTAL

**CABLE PLAN** 

(1#6)

 $\bigcirc$ 

TS 4325 **EAGLE 5G** 

COOK 89 31

CONTRACT NO. 62W89

COUNTY



SER NAME = dbriones	DESIGNED - DLB	REVISED -
	DRAWN - JK	REVISED -
LOT SCALE = 40.000'/in.	CHECKED - DB	REVISED -
LOT DATE = 7/31/2025	DATE - 07/31/2025	REVISED -

STATE OF ILLINOIS **DEPARTMENT OF TRANSPORTATION** 

EACH

EACH

							GNATION DIAGRAM AND	F.A.U. RTE	SECTIO	ON	_
EMERGENCY VEH	EMERGENCY VEHICLE PREEMPTION SEQUENCE, AND SCHEDULE OF QUANTITIES							XXX	2024-964	1-TS	
			LKIE	: Z5	AI KU	RIN K	טו				
SCALE: N.T.S.	SHEET	1	OF	2	SHEETS	STA.	TO STA.		IL.	LINOIS	FE

- THIS PLAN IS FOR THE INSTALLATION OF APS PUSH BUTTONS AND LEADING PEDESTRIAN INTERVAL PROGRAMMING.
- 2. ALL PUSH BUTTONS SHALL BE APS.
- 3. APS SHALL BE PLACED PARALLEL TO THE CORRESPONDING CROSSWALKS.
- 4. CONTRACTOR SHALL CONFIRM THE FINAL LOCATION OF THE PEDESTRIAN EQUIPMENT WITH THE TRAFFIC SIGNAL ENGINEER BEFORE INSTALLATION.
- 5. ALL EXISTING TRAFFIC SIGNAL CABLE NO LONGER REQUIRED SHALL BE
- 6. SIDEWALK TO BE BROUGHT UP TO PROWAG STANDARDS ON A FUTURE CONTRACT.


#### **REMOVAL NOTES:**

THE FOLLOWING ITEMS SHALL BE REMOVED BY THE CONTRACTOR AND SHALL BE DISPOSED OF BY THEM OUTSIDE THE RIGHT-OF-WAY AT THEIR EXPENSE. THE SALVAGE VALUE OF THE REMOVED EQUIPMENT SHALL BE REFLECTED IN THE CONTRACT BID PRICE.


PEDESTRIAN PUSHBUTTON EACH CONTROLLER (ASC 2-2100)



NORTHEAST CORNER

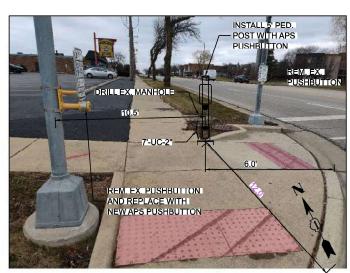

NORTHWEST CORNER

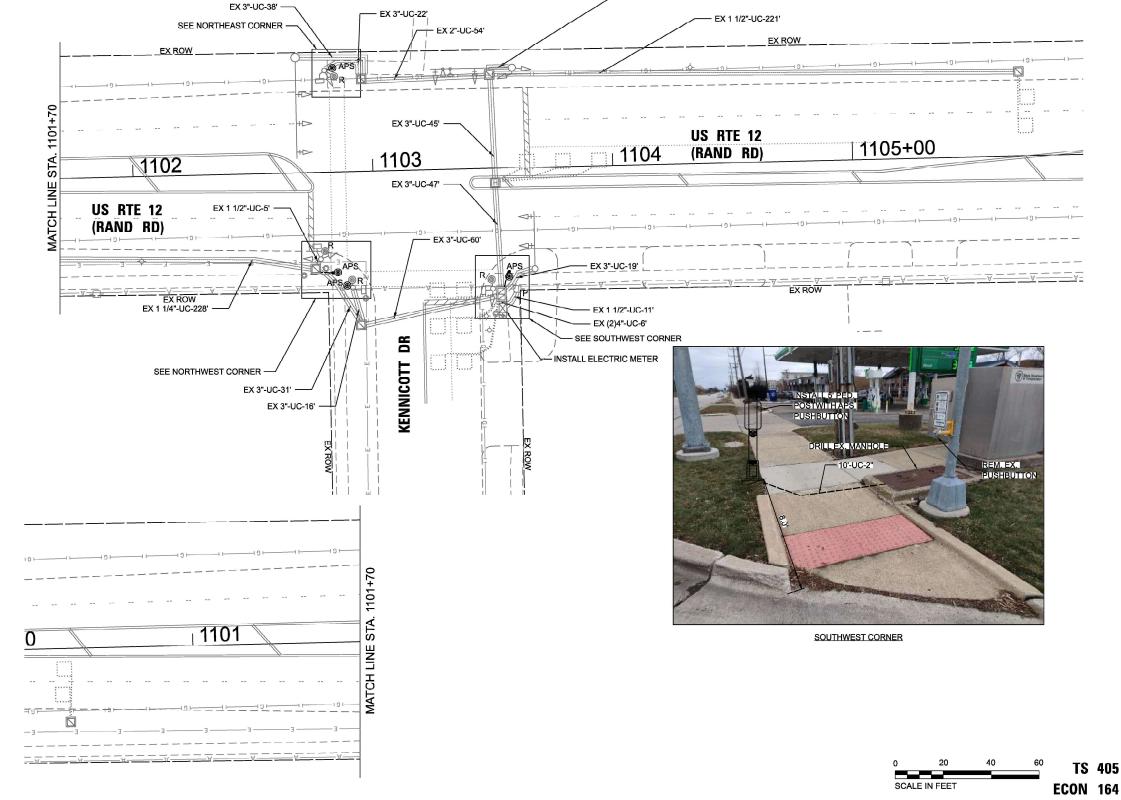

SCALE: 1"=20'

EX 3"-UC-13'


LAS TECHNICAL CONSULTANTS, LLC 100 S. WACKER DRIVE, SUITE 400 CHICAGO, IL 60606

DESIGNED - DLB REVISED -USER NAME = dbriones DRAWN REVISED CHECKED -DB REVISED PLOT SCALE - 40.000 ' / in. PLOT DATE = 7/31/2025 DATE 07/31/2025 REVISED

STATE OF ILLINOIS **DEPARTMENT OF TRANSPORTATION** 

TRAFFIC SIGNAL INSTALLATION PLAN US ROUTE 12 (RAND RD) AT KENNICOTT DR SHEET 1 OF 2 SHEETS STA.

TOTAL SHEET NO. 89 32 SECTION COUNTY 2024-964-TS COOK CONTRACT NO. 62W89

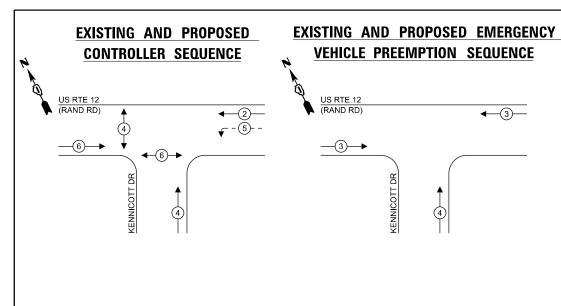

#### **LEGEND**:

**◆ (\*)** PROTECTED PHASE

← - \*\* - PROTECTED/PERMITTED PHASE

◆ \* PEDESTRIAN PHASE

OL OVERLAP

#### NOTES:

- TIMING CONSULTANT SHALL PROGRAM LEADING PEDESTRIAN INTERVAL FOR PHASE 4. THIS WORK SHALL BE PAID FOR UNDER RE-OPTIMIZE TRAFFIC SIGNAL SYSTEM LEVEL 1.
- THE TRAFFIC SIGNAL CONTROL EQUIPMENT FOR THIS LOCATION SHALL BE ECONOLITE TO MATCH EXISTING ADJACENT SYSTEM.

		QUANTITY	UNIT	TOTAL
TYPE		QUANTITY	WATTAGE	WATTAGE
SIGNAL HEAD	3 - SECTION	11	11	121.0
	4 - SECTION	-	14	-
	5 - SECTION	2	13	26.0
PROGRAMMABL	E SIGNALS			
	3 - SECTION	-	22	-
	4 - SECTION	-	32	-
	5 - SECTION	-	28	-
PED. SIGNAL		4	15	60.0
CONTROLLER		1	150	150.0
MASTER CONTR	OLLER	-	100	-
UPS		1	25	25.0
DETECTION	RADAR	-	20	-
	VIDEO	-	20	-
BLANK-OUT SIGI	N	-	25	-
NETWORK SWIT	CH II OR III	-	35	-
CELLULAR MOD		-	15	-
	TOT	AL UPS SIZIN	IG = 38	2.0
UPS CHARGING		1	225	225.0
BATTERY HEATE	R MAT	1	180	180.0
CABINET HEATE	R	1	200	200.0
FLASHER		-	15	-
LED STREET NA	ME SIGN	-	120	-
LUMINAIRE		-	240	-
	TOTAL SERVIC	E WIRE SIZI	NG = 98	7.0
ENERGY COSTS ILLINOIS DEF 201 W CENTER O SCHAUMBURG,	PARTMENT OF	TRANSPO	ORTATION	1
ENERGY SUPPL	V. CONTACT.	JAMES CA	MDDELL	

PHONE: 630-940-6805


ACCOUNT NUMBER: \_ - 7016200461

TLAS TECHNICAL CONSULTANTS. LLC

100 S. WACKER DRIVE, SUITE 400 CHICAGO, IL 60606

COMPANY: COMMONWEALTH EDISON

PLOT DATE = 7/31/2025

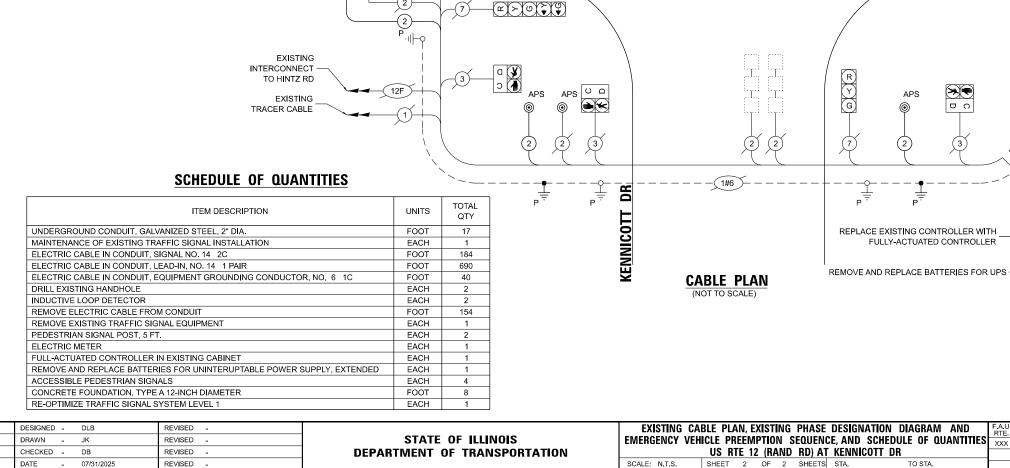

-(G)(<del>Z</del>)

US RTE 12

(RAND RD)

(5)

(a) (7)

TYPE II CABINET

SECTION

2024-964-TS

TS 405

**ECON 164** 

COOK 89 33

CONTRACT NO. 62W89

COUNTY

RYG

- 1. THIS PLAN IS FOR THE INSTALLATION OF APS PUSH BUTTONS AND LEADING PEDESTRIAN INTERVAL PROGRAMMING.
- 2. ALL PUSH BUTTONS SHALL BE APS.
- 3. APS SHALL BE PLACED PARALLEL TO THE CORRESPONDING CROSSWALKS.
- 4. CONTRACTOR SHALL CONFIRM THE FINAL LOCATION OF THE PEDESTRIAN EQUIPMENT WITH THE TRAFFIC SIGNAL ENGINEER BEFORE INSTALLATION.
- 5. ALL EXISTING TRAFFIC SIGNAL CABLE NO LONGER REQUIRED SHALL BE
- 6. SIDEWALK TO BE BROUGHT UP TO PROWAG STANDARDS ON A FUTURE CONTRACT.


#### **REMOVAL NOTES:**

THE FOLLOWING ITEMS SHALL BE REMOVED BY THE CONTRACTOR AND SHALL BE DISPOSED OF BY THEM OUTSIDE THE RIGHT-OF-WAY AT THEIR EXPENSE. THE SALVAGE VALUE OF THE REMOVED EQUIPMENT SHALL BE REFLECTED IN THE CONTRACT BID PRICE.


PEDESTRIAN PUSHBUTTON 6 EACH



NORTHWEST CORNER

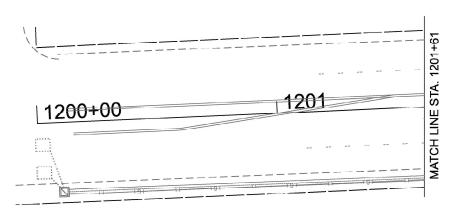


INSTALL W25-2 SIGN "ONCOMING TRAFFIC

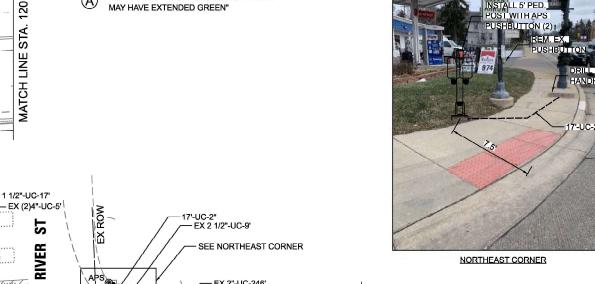



SOUTHEAST CORNER MIDBLOCK

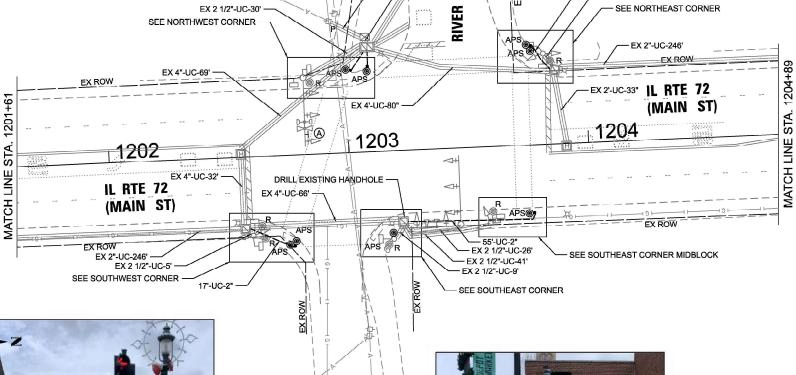

EX 1 1/2"-UC-17'

ST

REM. EX. PUSHBUTTONI
AND REPLACE WITH **NEW APS PUSH-BUTTON** 

SOUTHEAST CORNER

SCALE: 1"=20'

1205+00

SOUTHWEST CORNER

USER NAME = dbriones	DESIGNED	-	DLB	REVISED	-
	DRAWN	×	JK	REVISED	=
PLOT SCALE - 40.000 '/ in.	CHECKED	-	DB	REVISED	•
PLOT DATE = 7/31/2025	DATE	-	07/31/2025	REVISED	-


STATE OF ILLINOIS **DEPARTMENT OF TRANSPORTATION** 

TRAFFIC SIGNAL INSTALLATION PLAN IL ROUTE 72 AT RIVER STREET SHEET 1 OF 20 SHEETS STA. TO STA. SCALE IN FEET **EAGLE 2A** TOTAL SHEET NO. SECTION COUNTY 2024-964-TS KANE

TS 885

CHICAGO, IL 60606

CONTRACT NO. 62W89

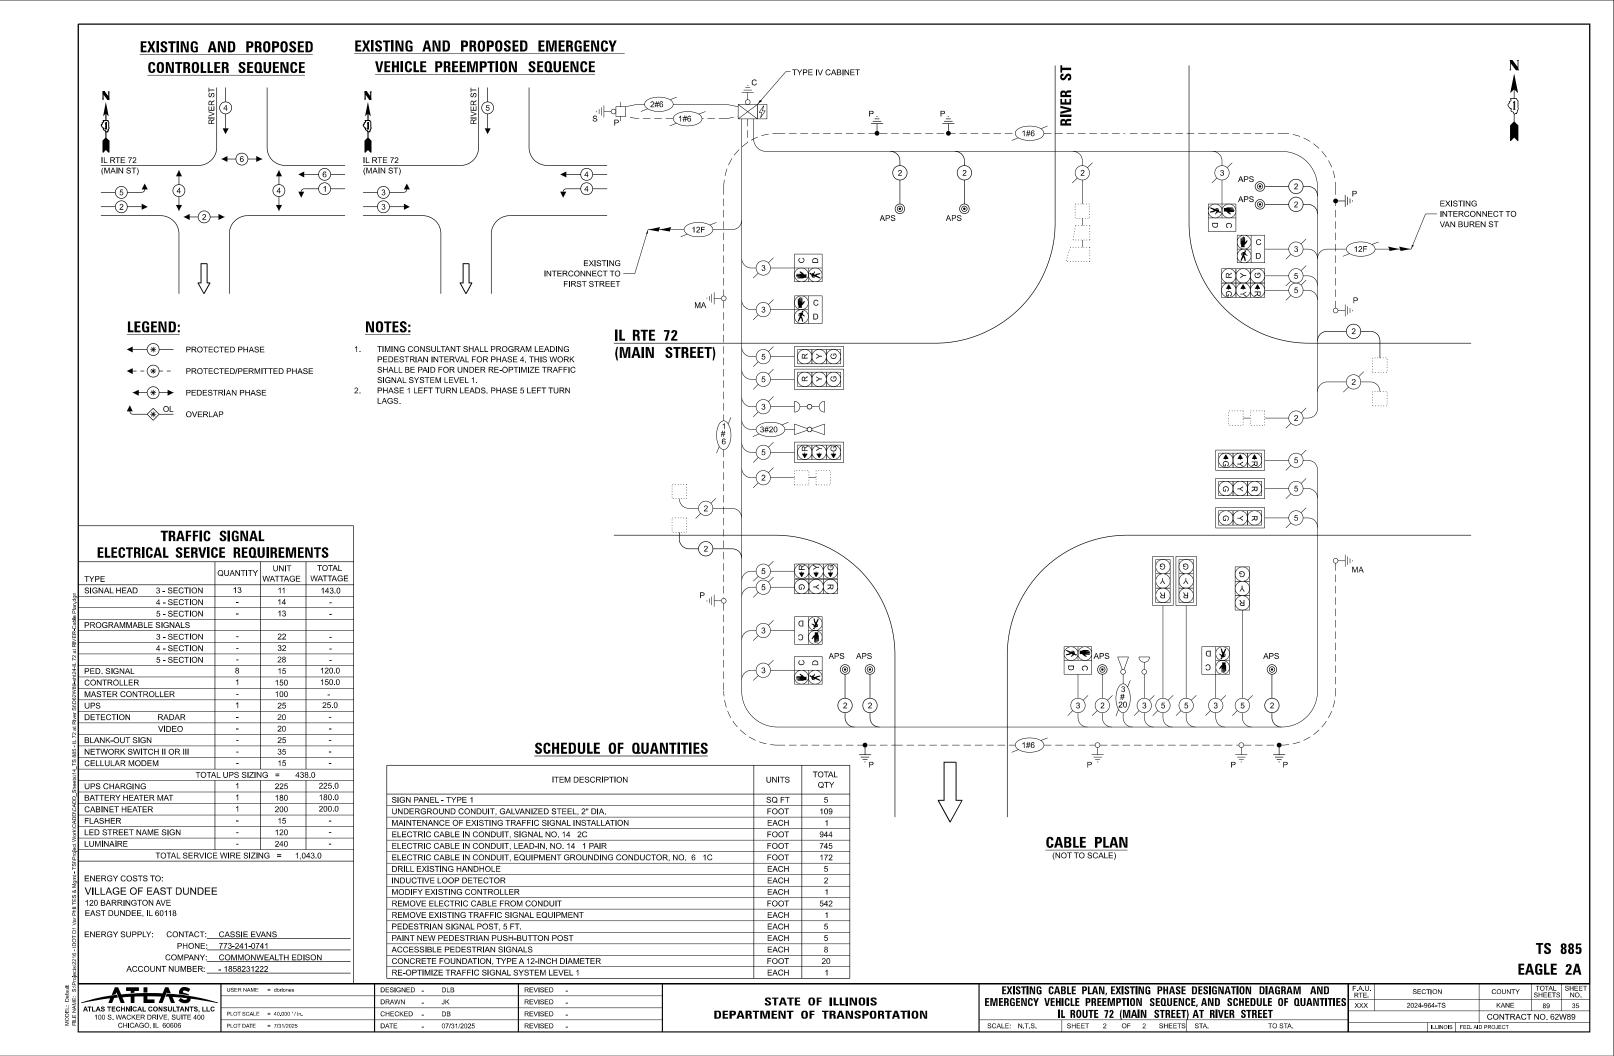

- 1. THIS PLAN IS FOR THE INSTALLATION OF APS PUSH BUTTONS AND LEADING PEDESTRIAN INTERVAL PROGRAMMING.
- 2. ALL PUSH BUTTONS SHALL BE APS.
- 3. APS SHALL BE PLACED PARALLEL TO THE CORRESPONDING CROSSWALKS.
- 4. CONTRACTOR SHALL CONFIRM THE FINAL LOCATION OF THE PEDESTRIAN EQUIPMENT WITH THE TRAFFIC SIGNAL ENGINEER BEFORE INSTALLATION.
- 5. ALL EXISTING TRAFFIC SIGNAL CABLE NO LONGER REQUIRED SHALL BE
- 6. SIDEWALK TO BE BROUGHT UP TO PROWAG STANDARDS ON A FUTURE CONTRACT.
- 7. THE GROUND MOUNTED, METERED SERVICE SHALL BE CONSTRUCTED ADJACENT TO THE EXISTING SERVICE CONDUIT PRIOR TO DISCONNECTING THE EXISTING SERVICE. INCLUDE A 5' STUB OF 2" CONDUIT FROM THE GM FOR FUTURE CONNECTION. THE COST OF THE 5' STUB, 2" UNDERGROUND CONDUIT AND SPLICE TO EXISTING SERVICE CONDUIT SHALL BE INCLUDED IN THE COST OF CONCRETE FOUNDATION, TYPE A. THE TRAFFIC SIGNALS SHALL REMAIN OPERATIONAL THE ENTIRE TIME THE SWITCH OVER BETWEEN EXISTING SERVICE AND PROPOSED SERVICE IS MADE.

#### **REMOVAL NOTES:**


THE FOLLOWING ITEMS SHALL BE REMOVED BY THE CONTRACTOR AND SHALL BE DISPOSED OF BY THEM OUTSIDE THE RIGHT-OF-WAY AT THEIR EXPENSE. THE SALVAGE VALUE OF THE REMOVED EQUIPMENT SHALL BE REFLECTED IN THE CONTRACT BID PRICE.

PEDESTRIAN PUSHBUTTON EACH

EACH CONTROLLER SIGNAL POST EACH



SOUTHEAST CORNER

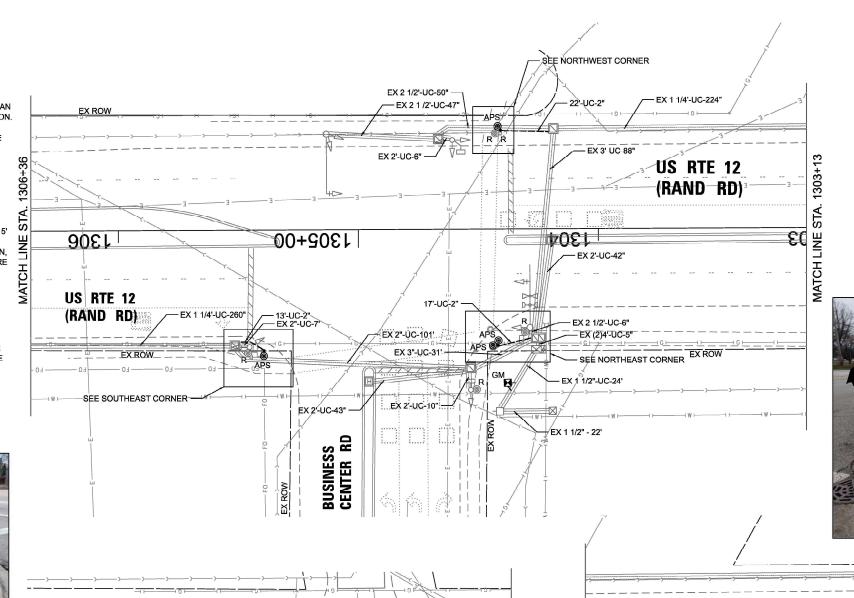



NORTHWEST CORNER



TS 9645 SCALE IN FEET



USER NAME = dbriones	DESIGNED	-	DLB	REVISED	
	DRAWN	-	JK	REVISED	χ.
PLOT SCALE - 40.000 '/ in.	CHECKED	-	DB	REVISED	-
PLOT DATE = 7/31/2025	DATE	-	07/31/2025	REVISED	-

1308

STATE OF ILLINOIS **DEPARTMENT OF TRANSPORTATION** 

1307


STA.

MATCH LINE

SCALE: 1"=20'

TRAFFIC SIGNAL INSTALLATION PLAN US ROUTE 12 AT BUSINESS CENTER DRIVE SHEET 1 OF 2 SHEETS STA.

F.A.U. RTE.	SECTION	COUNTY	TOTAL SHEETS	SHEE NO.			
XXX	2024-964-TS	соок	89	36			
CONTRACT NO. 62W89							
ILLINOIS FED AID PROJECT							

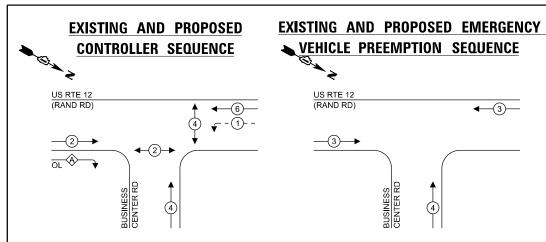

# **RIGHT TURN OVERLAP**

US RTE 12

PAID FOR UNDER RE-OPTIMIZE TRAFFIC SIGNAL SYSTEM

**4**—3)—

LOCATION SHALL BE ECONOLITE TO MATCH EXISTING

## LEGEND:

**★**PROTECTED PHASE

PROTECTED/PERMITTED PHASE

**←**(\*)**→** PEDESTRIAN PHASE

OL OVERLAP

## TRAFFIC SIGNAL **ELECTRICAL SERVICE REQUIREMENTS**

1		QUANTITY	UNIT	TOTAL
3	TYPE	QOANTITT	WATTAGE	WATTAGE
i	SIGNAL HEAD 3 - SECTION	7	11	77.0
3	4 - SECTION	-	14	-
2	5 - SECTION	4	13	52.0
3	PROGRAMMABLE SIGNALS			
	3 - SECTION	-	22	-
5	4 - SECTION	-	32	-
	5 - SECTION	-	28	-
3	PED. SIGNAL	4	15	60.0
	CONTROLLER	1	150	150.0
í	MASTER CONTROLLER	-	100	-
2	UPS	1	25	25.0
	DETECTION RADAR	-	20	-
	VIDEO	-	20	-
í	BLANK-OUT SIGN	-	25	-
	NETWORK SWITCH II OR III	-	35	-
2	CELLULAR MODEM	-	15	-
	TOTA	L UPS SIZIN	IG = 36	4.0
2	UPS CHARGING	1	225	225.0
	BATTERY HEATER MAT	1	180	180.0
	CABINET HEATER	1	200	200.0
	FLASHER	-	15	-
	LED STREET NAME SIGN	-	120	-
5	LUMINAIRE	-	240	-
	TOTAL SERVICE	WIRE SIZI	NG = 969	9.0


ENERGY COSTS TO:

VILLAGE OF MOUNT PROSPECT 500 S EMERSON ST

MOUNT PROSPECT. IL 60056

ENERGY SUPPLY: CONTACT: JAMES CAMPBEL

PHONE: 630-940-6805 COMPANY: COMMONWEALTH EDISON ACCOUNT NUMBER: \_\_\_ - 9673056000

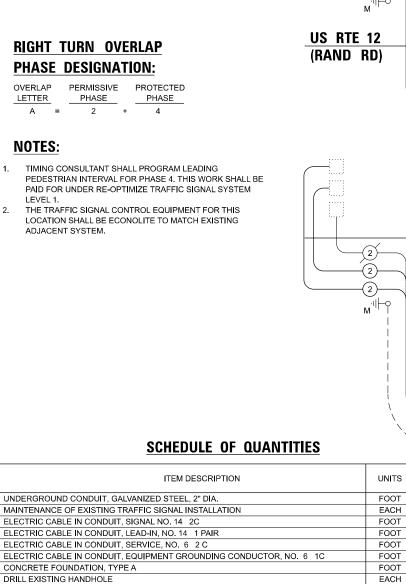

1#6 (13) © C  $O(\sqrt{x})$  R(x) P(y)(G) <del>-</del>2)- $\mathbb{R}^{\mathbb{Z}} > 0$  $\mathbf{M}_{\mathbf{M}} = \mathbf{M}_{\mathbf{M}}$ **F** O D APS APS REPLACE EXISTING CONTROLLER WITH FULLY-ACTUATED CONTROLLER TYPE II CABINET 1#6 BUSINESS CENTER RD TOTAL QTY FOOT 52 548 FOOT 1215 27 **CABLE PLAN** 85 4 EACH EACH FOOT 265 EACH 1 EACH EACH EACH 1 EACH 4 FOOT 12 EACH

TS 9645



USER NAME = dbriones	DESIGNED	-	DLB	REVISED	-
	DRAWN	-	JK	REVISED	-
PLOT SCALE = 40.000 '/in.	CHECKED	-	DB	REVISED	-
PLOT DATE = 7/31/2025	DATE	-	07/31/2025	REVISED	-

INDUCTIVE LOOP DETECTOR

PEDESTRIAN SIGNAL POST, 5 FT.

ACCESSIBLE PEDESTRIAN SIGNALS

REMOVE ELECTRIC CABLE FROM CONDUIT

REMOVE EXISTING TRAFFIC SIGNAL EQUIPMENT

SERVICE INSTALLATION, GROUND MOUNTED, METERED

FULL-ACTUATED CONTROLLER IN EXISTING CABINET

CONCRETE FOUNDATION, TYPE A 12-INCH DIAMETER

RE-OPTIMIZE TRAFFIC SIGNAL SYSTEM LEVEL 1

 THIS PLAN IS FOR THE INSTALLATION OF LEADING PEDESTRIAN INTERVAL PROGRAMMING.

#### **REMOVAL AND RELOCATION NOTES:**

THE FOLLOWING EXISTING TRAFFIC SIGNAL EQUIPMENT SHALL BE REMOVED BY THE CONTRACTOR, SAFELY STORED AND RELOCATED TO THE PROPOSED MAST ARMS, POSTS, AND TRAFFIC SIGNAL CONTROLLER CABINET.

1 EACH LIGHT DETECTOR AMPLIFLIER

#### **REMOVAL NOTES:**

EACH EACH

THE FOLLOWING ITEMS SHALL BE REMOVED BY THE CONTRACTOR AND SHALL BE DISPOSED OF BY THEM OUTSIDE THE RIGHT-OF-WAY AT THEIR EXPENSE. THE SALVAGE VALUE OF THE REMOVED EQUIPMENT SHALL BE REFLECTED IN THE CONTRACT BID PRICE.

US 14 (NORTHWEST HWY) SERVICE INSTALLATION TRAFFIC SIGNAL CONTROLLER (ASC/2S-1000) AND CABINET (TS2) COMPLETE CENTRAL RD **CENTRAL RD** EX (4)2"-UC-5' PROSPECT AVE REPLACE WITH TYPE IV CABINET






JSER NAME = dbriones	DESIGNED -	DLB	REVISED -	
	DRAWN -	JK	REVISED -	
PLOT SCALE = 40.000 '/in.	CHECKED -	DB	REVISED -	
PLOT DATE = 7/31/2025	DATE -	07/31/2025	REVISED -	

STATE	E OF	F ILLINOIS
DEPARTMENT	0F	TRANSPORTATION

SCALE: 1"=20'

							I PLAN	F.A.U. RTE.	SEC 2024-9			COUNTY	TOTAL SHEETS	SHEET NO.
US F	ROUTE 1	4 A	r ce	NTR	AL ROA	D / PRO	SPECT AVENUE	^^^	2024-9	04-13		CONTRACT		
20'	SHEET	1	OF	5	SHEETS	STA.	TO STA.			ILLINOIS	FED. A	D PROJECT		

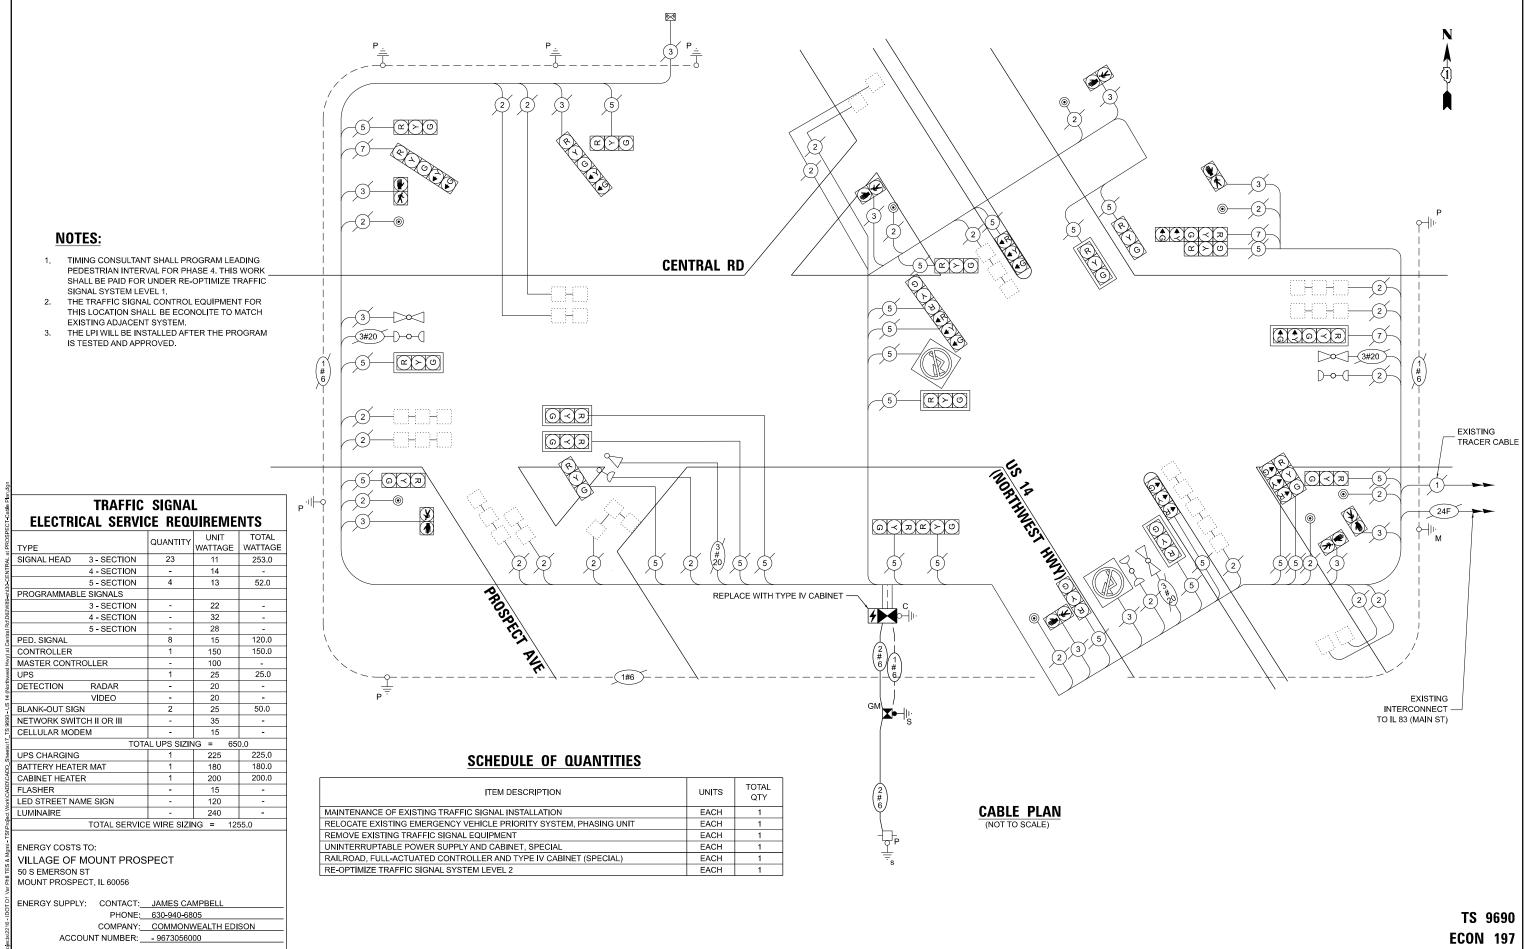

ATLAS TECHNICAL CONSULTANTS, LLC
100 S, WACKER DRIVE, SUITE 400
CHICAGO, IL 60606

 USER NAME
 = doillones
 DESIGNED
 DLB
 REVISED

 DRAWN
 JK
 REVISED

 PLOT SCALE
 = 40,000 °/ In.
 CHECKED
 DB
 REVISED

 PLOT DATE
 = 7/31/2025
 DATE
 07/31/2025
 REVISED

STATE OF ILLINOIS
DEPARTMENT OF TRANSPORTATION

EXISTING CABLE PLAN, EXISTING PHASE DESIGNATION DIAGRAM AND EMERGENCY VEHICLE PREEMPTION SEQUENCE, AND SCHEDULE OF QUANTITIES US ROUTE 14 AT CENTRAL ROAD / PROSPECT AVENUE

SCALE: N.T.S. | SHEET | 2 OF 5 SHEETS | STA. TO STA.

#### **EXISTING SEQUENCE OF OPERATIONS**

					*//				02 02	31	/&	\$ 1 1 1 1 1 1 1 1 1 1 1 1 1 1 1 1 1 1 1	1	× /							RO Control of the con								,		***	1	/								,			F
MOVEMENT → → Z			, §*/	CENTRALF				\$270	CENTRAL		ş		CENTRAL						\$	*/	CENTRAL									37	<b>∤</b>   :	CENTRAL							\$*/	1	CENTRAL			A
PHASE				1 + 5	5				1 + 6			2 +	5							2 -	⊦ 6										3 +	- 8								4				s
INTERVAL	1	2A	2E	3A	3B	4A	4B	5	6A	6B	7	8	9A	9B	10	11	12A	12B	13A	13B	14A	14B	15A	15B	15C	15D	16	17	18A	18B	18C	18D	19A	19B	19C	19D	20	21	22	23A	23B	23C	23D	] н
CHANGE TO		1	+ 6	2	+ 5	2	+ 6		2	+ 6	Ø	ø	2 +	6			1 + 3 +		1	+ 6	2 +	+ 5		4			/	/		1 + 1 + 2 + 2 +	6 5			4	1						1 · 2 ·	+ 5 + 6 + 5 + 6		
US RTE 14 (NORTHWEST HWY) NW/B NEAR RIGHT, FAR RIGHT AND MAST ARM SIGNALS	R	R	R	R	R	R	R	R	R	R	G	G	G	G	G	G	Υ	R	Υ	R	G	G	Y	R	R	R	R	R	R	R	R	R	R	R	R	R	R	R	R	R	R	R	R	R
US RTE 14 (NORTHWEST HWY) NW/B FAR LEFT AND MEDIAN SIGNALS	<b>⊸</b> G	<b>⊸</b> Y	-	R <del>-</del> G	<b>⊸</b> G	<b>⊸</b> Y	⊸R	⊸R	⊸R	⊸R	⊸G	<b>⊸</b> G	⊸Y	⊸R	<del>-</del> R	⊸R	<b>⊸</b> R	⊸R	⊸R	⊸R	<b>→</b> R	⊸R	⊸R	⊸R	⊸R	<del>-</del> R	⊸R	⊸R	⊸R	≺R	<del>-</del> R	⊸R	⊸R	⊸R	⊸R	⊸R	⊸R	⊸R	⊸R	R	R	⊸R	⊸R	⊸R
US RTE 14 (NORTHWEST HWY) SE/B NEAR RIGHT, FAR RIGHT AND MAST ARM SIGNALS	R	R	R	R	R	R	R	G	G	G	R	R	R	R	G	G	Υ	R	Υ	R	G	G	Υ	R	R	R	R	R	R	R	R	R	R	R	R	R	R	R	R	R	R	R	R	R
US RTE 14 (NORTHWEST HWY) SE/B FAR LEFT AND MEDIAN SIGNALS	⊸G	⊸G	3	G <del>-</del> Y	⊸R	<b>⊸</b> Y	⊸R	⊸G	⊸Y	⊸R	⊸R	<b>⊸</b> R	<b>⊸</b> R	<b>⊸</b> R	⊸R	⊸R	<b>⊸</b> R	<b>⊸</b> R	⊸R	⊸R	<b>→</b> R	⊸R	⊸R	<b>⊸</b> R	⊸R	⊸R	⊸R	⊸R	<b>⊸</b> R	⊸R	⊸R	⊸R	⊸R	⊸R	<b>⊸</b> R	<b>⊸</b> R	⊸R	⊸R	⊸R	R	R	⊸R	⊸R	⊸R
CENTRAL RD AT US RTE 14 W/B ALL SIGNALS	R	R	R	R	R	R	R	R	R	R	R	R	R	R	R	R	R	R	R	R	R	R	R	R	R	R	G	G	Υ	R	R	R	Υ	R	R	R	R	R	R	R	R	R	R	R
CENTRAL RD AT US RTE 14 E/B NEAR AND FAR RIGHT SIGNALS	R	R	R	R	R	R	R	R	R	R	R	R	R	R	R	R	R	R	R	R	R	R	R	R	R	R	G	G	G	G	Y	R	G	G	G	G	R	G	G	G	G	Y	R	R
CENTRAL RD AT US RTE 14 E/B FAR LEFT AND MAST ARM SIGNALS	R	R	G	G	G	G	Y	R	G	G	G	G	R	G <del>∢</del> G	G <del></del> G	G <del>⊸</del> G	G <del>∢</del> G	Y	R	R
CENTRAL RD AT PROSPECT AVE W/B ALL SIGNALS	Ġ	Ġ	Ğ	Ġ G	Ğ	Ğ	Ğ	Ğ	Ġ	Ğ	Ğ	Ğ	Ğ	Ğ	Ġ	Ğ	Ğ	Ġ	Ġ G	Ġ G	<b>→</b> G	Ġ	Ġ	Ġ	Υ	R	Ğ	Ğ	Ğ	Ġ	Ġ G	Ğ	Ġ	Ğ	Y	R	R	R	R	R	R	R	R	R
CENTRAL RD AT PROSPECT AVE E/B ALL SIGNALS	R	R	R	R	R	R	R	R	R	R	R	R	R	R	R	R	R	R	R	R	R	R	R	R	R	R	G	G	Υ	R	R	R	R	R	R	R	R	R	R	R	R	R	R	R
PROSPECT AVE NW/B NEAR RIGHT SIGNAL	R	R	R	R	R	R	R	R	R	R	R	R	R	R	R	R	R	R	R	R	R	R	R	R	R	R	R	R	R	R	R	R	R	R	R	R	R	G	G	Y	R	R	R	R
PROSPECT AVE NW/B FAR LEFT AND FAR RIGHT SIGNALS	R	R	R	R	R	R	R	R	R	R	R	R	R	R	R	R	R	R	R	R	R	R	R	R	R	R	R	R	R	R	R	R	R	R	R	R	R	G	G	Y	R	R	R	
PEDESTRIAN SIGNALS CROSSING US RTE 14 ON NORTH SIDE OF CENTRAL RD	Н	Н	Н	н	Н	Н	Н	н	н	н	н	Н	Н	Н	н	Н	Н	н	н	н	Н	н	н	Н	н	н	*P	**FH	Н	н	н	Н	н	Н	Н	Н	Н	Н	н	н	Н	Н	Н	D
PEDESTRIAN SIGNALS CROSSING CENTRAL RD ON WEST SIDE OF PROSPECT AVE	Н	Н	Н	Н	Н	Н	Н	Н	Н	Н	Н	Н	Н	Н	Н	Н	Н	Н	Н	Н	Н	Н	Н	Н	Н	Н	Н	Н	Н	Н	Н	Н	Н	Н	Н	Н	*LPI	*P	**F	1 н	Н	Н	Н	A R
PEDESTRIAN SIGNALS CROSSING US RTE 14 ON SOUTH SIDE OF CENTRAL RD	н	н	Н	н	н	н	н	н	н	н	н	н	н	н	н	н	Н	н	н	н	н	н	н	н	н	н	*P	**FH	н	н	н	н	н	н	н	н	н	н	н	н	н	н	н	K
PEDESTRIAN SIGNALS CROSSING CENTRAL RD ON EAST SIDE OF US RTE 14	н	н	Н	н	н	Н	н	н	н	н	*P	**FH	н	н	*P	**FH	Н	н	н	н	Н	н	н	Н	н	н	н	н	Н	н	н	н	н	Н	н	н	н	н	н	н	Н	н	н	

- \* TO APPEAR ONLY UPON PUSHBUTTON ACTIVATION
- \*\* FLASHING "DON'T WALK" IS TO TERMINATE AT THE COMPLETION OF THE PEDESTRIAN INTERVAL CLEARANCE.

LPI = LEADING PEDESTRIAN INTERVAL WITH DELAYED VEHICULAR GREEN
P = "WALK" FH = FLASHING "DON'T WALK"

H = "DON'T WALK"

Ø THIS " 

OR FLASHING " 

"INTERVAL MAY FINISH TIMING IN THE BIDIRECTIONAL STRAIGHT THROUGH MOVEMENT IF THE LEFT ARROW TIME IS NOT SUFFICIENT TO COMPLETE " 

" 

" INTERVALS. " 

AND FLASHING " 

" TIMINGS TO BE SET ONLY ON PHASES WHERE " 

AND FLASHING " 

" ARE INDICATED IN SEQUENCE OF OPERATION.

PHASE 2+6 SHALL BE PLACED ON RECALL

TS 9690 **ECON 197** 

IE: S:VE	ATLAS
NAME:	ATLAS TECHNICAL CONSULTANTS, LLC
H	100 S. WACKER DRIVE, SUITE 400
ш	CHICAGO, IL 60606

USER NAME = dbriones	DESIGNED	-	DLB	REVISED -
	DRAWN	-	JK	REVISED -
PLOT SCALE = 40.000 '/in.	CHECKED	-	DB	REVISED -
PLOT DATE = 7/31/2025	DATE	-	07/31/2025	REVISED -



PROPOSED RAILROAD PREEMPTION SEQUEN	CE OF	OPE	RATI	ONS												PREEN NUME		PREEM NUME		PREEN NUME	BER 5		MPTOR BER 6	PREEMPTOR NUMBER 2				
CHANGE FROM NORMAL SEQUENCE OF OPERATION INTERVAL	1	1		5	,	7	1	0	1	6		20		2	1													
NUMBER		-				•	_		_					_	-													
CHANGE FROM EMERGENCY VEHICLE PREEMPTION SEQUENCE OF																	2	3		4	4		5					
OPERATION INTERVAL NUMBER																												
RAILROAD PREEMPTION SEQUENCE OF OPERATION INTEVAL	1A	18	1C	1D	1E	1F	1G	1H	IJ	1K	1L	1N	1L	1N	1P	1Q	1R	18	11	10	1V	1W	1X	2	3	4	5	CLEAR TO
NUMBER	ı.			10		11	10	111		-11		-114		214		14	211	10		10		244	±n	_	ŭ	~	ŭ	NORMAL
CHANGE TO RAILROAD PREEMPTION SEQUENCE OF OPERATION	18	2	1D	2	1F	2	1H	2	1K	2	1M	1P	1M	1P	2	1R	2	17	2	1V	2	1X	2	3	4	5		SEQUENCE
INTERVAL NUMBER	10		10		11	2	111	4	In		T1-5	1	11-1	11	2	In	-	11	2	10	-	17		3	4	3		SEGOLINGE
U.S. RTE. 14 (NORTHWEST HWY.) NW/B	R	R	R	R	γ	R	γ	R	R	R	R	R	R	R	R	Υ	R	R	R	R	R	R	R	R	R	R	G	۸
NEAR RIGHT, FAR RIGHT AND MAST ARM SIGNALS	n	n	ĸ	n	•	ĸ	•	ĸ	ĸ	n	n	ĸ	n	n	ĸ	1	n	n	n	n	n	n	n	n	n	n	G	Δ
U.S. RTE. 14 (NORTHWEST HWY.) NW/B	÷γ	←R	←R	÷R	-γ	←R	←R	←R	←R	- n		←R	←R	←R	. D	÷γ	←R	←R	←R	←R	←R	←R	←R	←R	←R	←R	. n	Λ.
FAR LEFT AND MEDIAN SIGNALS	4.1	4.K	44	₹H.	41	₹K	~κ	~K	44	←R	←R	+H	₹K	₹K	←R	41	44	~K	₹H.	~K	+κ	~κ	+κ	+κ	78	-H	←R	Δ
U.S. RTE. 14 (NORTHWEST HWY.) SE/B	_		γ	R	R	,	v	_		_	_		_	_		_	,	٧		_	R	-	_		_		_	^
NEAR RIGHT, FAR RIGHT AND MAST ARM SIGNALS	R	R	Y	к	к	R	Y	R	R	R	R	R	R	R	R	R	R	Y	R	R	к	R	R	R	R	R	G	Δ
U.S. RTE. 14 (NORTHWEST HWY.) SE/B	- 25																											Δ.
FAR LEFT AND MEDIAN SIGNALS	←Υ	←R	÷γ	←R	←R	←R	←R	←R	←R	←R	←R	←R	←R	←R	←R	←R	←R	÷Υ	←R	←R	÷R	←R	÷R	←R	←R	÷R	←R	Δ
CENTRAL ROAD AT U.S. RTE. 14 W/B	_	_	_	_	_		_	_		_	_	_			_	_	_	_			_		_	_	_	_	_	Δ.
ALL SIGNALS	R	R	R	R	R	R	R	R	Y	R	R	R	R	R	R	R	R	R	R	Y	R	R	R	R	R	R	R	Δ
CENTRAL ROAD AT U.S. RTE. 14 E/B	_	_	_		_	_	_	_	_		_	_	_	_	_		_	_	_	_	_	_	_	_				_
NEAR AND FAR RIGHT SIGNALS	R	R	R	R	R	R	R	R	G	G	G	G	G	G	G	R	R	R	R	G	G	G	G	G	Y	R	R	Δ
CENTRAL ROAD AT U.S. RTE. 14 E/B											G	G	G	G	G							G	G	G				_
FAR LEFT AND MAST ARM SIGNALS	R	R	R	R	R	R	R	R	G	G	←G	÷G	÷G	÷G	←G	R	R	R	R	G	G	←G	÷G	÷G	Y	R	R	Δ
CENTRAL ROAD AT PROSPECT AVENUE W/B	Ť	ተ	Φ	Φ	Φ.	Φ	Ť	4	4	Ť						Φ	Φ	Φ	ተ	Φ	ተ			Φ.				_
ALL SIGNALS	G	G	G	G	G	G	G	G	G	G	R	R	R	R	R	G	G	G	G	G	G	R	R	G	Y	R	R	Δ
CENTRAL ROAD AT PROSPECT AVENUE E/B																												_
ALL SIGNALS	R	R	R	R	R	R	R	R	Y	R	R	R	R	R	R	R	R	R	R	Y	R	R	R	R	R	R	R	Δ
PROSPECT AVENUE NW/B																												_
NEAR RIGHT SIGNAL	R	R	R	R	R	R	R	R	R	R	G	Y	R	Y	R	R	R	R	R	R	R	Y	R	R	R	R	R	Δ
PROSPECT AVENUE NW/B																											R	
FAR LEFT AND FAR RIGHT SIGNALS	R	R	R	R	R	R	R	R	R	R	G	Y	R	Y	R	R	R	R	R	R	R	Y	R	R	R	R	÷G	Δ
PED. SIGNALS X-ING U.S. RTE. 14																											_	
ON NORTH SIDE OF CENTRAL ROAD	н	н	H	H	н	н	н	н	**FH	н	н	Н	н	Н	H	н	H	н	н	н	н	н	н	н	н	н	Н	Δ
PED, SIGNALS X-ING CENTRAL ROAD																												-
ON WEST SIDE OF PROSPECT AVENUE	н	н	н	н	н	н	н	н	н	н	**FH	**FH	н	**FH	Н	н	н	н	н	н	н	н	н	н	H	н	н	Δ
PED. SIGNALS X-ING U.S. RTE. 14																												
ON SOUTH SIDE OF CENTRAL ROAD	H	н	н	н	н	н	н	Н	**FH	Н	н	Н	н	н	Н	н	н	H	Н	н	н	H	н	н	н	н	Н	Δ
PED. SIGNALS X-ING CENTRAL ROAD																												_
ON EAST SIDE OF U.S. RTE. 14	н	н	Н	Н	**FH	н	**FH	Н	Н	Н	н	Н	Н	Н	Н	н	н	н	Н	н	н	н	н	н	н	н	Н	Δ
	-																		-									
INTERNALLY ILLUMINATED NRT SIGNS	NRT	NRT	NRT	NRT	NRT	NRT	NRT	NRT	NRT	NRT	NRT	NRT	NRT	NRT	NRT	NRT	NRT	NRT	NRT	NRT	NRT	NRT	NRT	NRT	NRT	NRT	NRT	Δ

 $^{\triangle}$  RAILROAD PREEMPTION SEQUENCE SHALL PROVIDE THE PROPER CLEARANCE INTERVAL TO RESUME THE NORMAL SEQUENCE OF OPERATION OR PROPER CLEARANCE INTERVAL TO DISPLAY AN EMERGENCY VEHICLE INTERVAL (IF APPLICABLE) AFTER RAILROAD PREEMPTION INTERVAL 5 IS TERMINATED.

 RAILROAD PREEMPTION SEQUENCE SHALL BE CAPABLE OF CYCLING BETWEEN PHASES 1+6 AND 2+6 UNTIL RAILROAD PREEMPTION IS TERMINATED.

NRT = "NO RIGHT TURN" OR



TS 9690 **ECON 197** 



USER NAME = dbriones	DESIGNED	-	DLB	REVISED -
	DRAWN	-	JK	REVISED -
PLOT SCALE - 40.000 ' / in.	CHECKED	-	DB	REVISED -
PLOT DATE = 7/31/2025	DATE	-	07/31/2025	REVISED -

#### PROPOSED EMERGENCY VEHICLE PREEMPTION

SEQUENCE OF OPERATIONS																																									
CHANGE FROM NORMAL SEQUENCE OF OPERATION INTERVAL NUMBER		1		1		1		-	1			5	5			5		7			7				7				10			10			10				10		
EMERGENCY VEHICLE PREEMPTION SEQUENCE OF OPERATION INTEVAL NUMBER	1A	1B	10	1D	1E	1F	16	1H	1)	1K	1L	1M	1N	1P	10	1R	15	17	10	J 1V	1W	/ 1	X 1	IY 1	Z 1/	IA .	1BB	1CC	1DD	1EE	1FF	166	1HH	111	1KK	1LL	1MM	1NN	1PP	10	Q 1RR
CHANGE TO EMERGENCY VEHICLE PREEMPTION SEQUENCE OF OPERATION INTERVAL NUMBER	1B	2	1D	3	1F	4	1H	1)	1K	5	1M	2 or 4	3	1Q	1R	18	5	2	1۷	1W	/ 3 or	4 1	Υ :	1Z 1A	A 16	B	5	1DD	1EE	2	166	16G	3	1KK	1LL	4	1NN	1PP	100	Q 1RI	R 5
U.S. RTE. 14 (NORTHWEST HWY.) NW/B NEAR RIGHT, FAR RIGHT AND MAST ARM SIGNALS	R	R	R	R	R	R	R	R	R	R	R	R	R	R	R	R	R	G	G	Υ	R	-	G	Y			R	G	G	G	G	γ	R	G	Y	R	G	Y	R	R	R
U.S. RTE. 14 (NORTHWEST HWY.) NW/B FAR LEFT AND MEDIAN SIGNALS	+6	+G	÷Υ	+R	<b>←</b> Y	÷R	÷Υ	÷R	÷R	←R	←R	←R	+R	←R	←R	←R	+R	+G	+0	6 +Y	-F	٠ +	G +	-Y +	R +	R	←R	÷R	+R	←R	←R	t +R									
U.S. RTE. 14 (NORTHWEST HWY.) NEAR RIGHT, FAR RIGHT AND MAST ARM SIGNALS	R	R	R	R	R	R	R	R	R	R	Υ	R	G	Y	R	R	R	R	R	R	R	- 1	R	R F	F	1	R	G	Υ	R	G	G	G	G	Υ	R	6	Y	R	R	R
U.S. RTE. 14 (NORTHWEST HWY.) SE/B FAR LEFT AND MEDIAN SIGNALS	÷Υ	÷R	+G	÷G	÷γ	←R	÷Υ	+R	÷R	←R	÷Υ	←R	+G	÷Υ	←R	←R	←R	←R	+R	t en	t er	t +	R e	-R +	R +	R	←R	←R	←R	←R	←R	←R	←R	←R	←R	←R	←R	←R	←R	←R	t ←R
CENTRAL ROAD AT U.S. RTE. 14 W/B ALL SIGNALS	R	R	R	R	R	R	R	R	R	R	R	R	R	R	R	R	R	R	R	R	R		R	R F	F	t	R	R	R	R	R	R	R	R	R	R	R	R	R	R	R
CENTRAL ROAD AT U.S. RTE, 14 E/B NEAR AND FAR RIGHT SIGNALS	R	R	R	R	R	R	R	R	R	R	R	R	R	R	R	R	R	R	R	R	R	-	R	R F	F	1	R	R	R	R	R	R	R	R	R	R	R	R	R	R	R
CENTRAL ROAD AT U.S. RTE. 14 E/B FAR LEFT AND MAST ARM SIGNALS	R	R	R	R	R	R	R	R	R	R	R	R	R	R	R	R	R	R	R	R	R		R	R F	F	t	R	R	R	R	R	R	R	R	R	R	R	R	R	R	R
CENTRAL ROAD AT PROSPECT AVENUE W/B ALL SIGNALS	† G	- 3	† G	† G	† G	† G	↑ G	↑ G	Υ	R	† G	† G	† G	† G	÷ G	Y	R	÷ G	† G	† G	Ť G			† 1 G (	,		R	÷ G	† G	÷ G	Ť G	Ť G	† G	Y	R						
CENTRAL ROAD AT PROSPECT AVENUE E/B ALL SIGNALS	R	R	R	R	R	R	R	R	R	R	R	R	R	R	R	R	R	R	R	R	R	0	R	R F	F	t	R	R	R	R	R	R	R	R	R	R	R	R	R	R	R
PROSPECT AVENUE NW/B NEAR RIGHT SIGNAL	R	R	R	R	R	R	R	R	R	R	R	R	R	R	R	R	R	R	R	R	R	-	R	R F	F	t	R	R	R	R	R	R	R	R	R	R	R	R	R	R	R
PROSPECT AVENUE NW/B FAR LEFT AND FAR RIGHT SIGNALS	R	R	R	R	R	R	R	R	R	R	R	R	R	R	R	R	R	R	R	R	R	- 31	R	R F	F	t	R	R	R	R	R	R	R	R	R	R	R	R	R	R	R
PED. SIGNALS X-ING U.S. RTE, 14 ON NORTH SIDE OF CENTRAL ROAD	н	н	н	н	н	н	н	н	н	н	н	н	н	н	н	н	н	н	н	н	н	1	н	н			н	н	н	н	н	н	н	н	н	н	н	н	н	н	н
PED. SIGNALS X-ING CENTRAL ROAD ON WEST SIDE OF PROSPECT AVENUE	н	н	н	н	н	н	н	н	н	н	н	н	н	н	н	н	н	н	н	н	н		н	н			н	н	н	н	н	н	н	н	н	н	н	н	н	н	н
PED. SIGNALS X-ING U.S. RTE, 14 ON SOUTH SIDE OF CENTRAL ROAD	н	н	н	н	н	н	н	н	н	н	н	н	н	н	н	н	н	н	н	н	Н	1	н	н	1	1	н	н	н	н	н	н	н	н	н	н	н	н	н	Н	н
PED. SIGNALS X-ING CENTRAL ROAD	н	н	н	н	н	н	н	н	н	н	н	н	н	н	н	н	н	FH	FH	н	н	F	н	н			н	FH	н	н	FH	н	н	FH	н	н	FH	н	н	н	н



PROPOSED	EMERGENCY	VEHICLE	PREEMPTION
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ON EAST SIDE OF U.S. RTE. 14

SEQUENCE OF OPERATIONS

SEQUENCE OF OPERATIONS																							NOT THE PARTY OF	NOMBEN 4	WOMBERS	NONDERG	1
CHANGE FROM NORMAL SEQUENCE OF OPERATI NUMBER	ION INTERVAL	I		16			16			16					20				2	20		20					ſ
EMERGENCY VEHICLE PREEMPTION SEQUENCE INTEVAL NUMBER	OF OPERATION	155	117	100	1VV	1WW	1XX	177	177	1AAA	1BBB	1CCC	1DDD	1EEE	1FFF	1GGG	11111	11111	1KKK	1111	1МММ	1NNN	2	3	4	5	CLEAR TO
CHANGE TO EMERGENCY VEHICLE PREEMPTION OPERATION INTERVAL NUMBER	SEQUENCE OF	177	100	177	1WW	2 or 3	4	1ZZ	1444	1888	1000	5	1EEE	1FFF	1000	<b>1</b> HHH	2 or 3	1KKK	1111	1МММ	4	5					SEQUENCE
U.S. RTE. 14 (NORTHWEST HWY.) NEAR RIGHT, FAR RIGHT AND MAST ARM SIGNALS	NW/B S	R	R	R	R	R	R	R	R	R	R	R	R	R	R	R	R	R	R	R	R	R	G	R	R	R	٥
U.S. RTE. 14 (NORTHWEST HWY.) FAR LEFT AND MEDIAN SIGNALS	NW/B	←R	←R	←R	←R	←R	←R	e-R	←R	←R	←R	←R	÷R	÷R	←R	÷R	←R	←R	€R	←R	←R	←R	÷G	←R	←R	÷R	٥
U.S. RTE. 14 (NORTHWEST HWY.) NEAR RIGHT , FAR RIGHT AND MAST ARM SIGNAL	SE/B s	R	R	R	R	R	R	R	R	R	R	R	R	R	R	R	R	R	R	R	R	R	R	G	R	R	0
U.S. RTE. 14 (NORTHWEST HWY.) FAR LEFT AND MEDIAN SIGNALS	SE/B	←R	←R	←R	←R	←R	←R	÷R	←R	←R	←R	←R	+R	+R	÷R	+R	÷R	←R	←R	←R	+R	←R	←R	+G	←R	R	٥
CENTRAL ROAD AT U.S. RTE. 14 ALL SIGNALS	W/B	G	γ	R	R	R	G	G	Υ	R	R	R	R	R	R	R	R	R	R	R	R	R	R	R	G	R	٥
CENTRAL ROAD AT U.S. RTE. 14 NEAR AND FAR RIGHT SIGNALS	E/B	G	G	G	γ	R	G	G	G	G	G	G	G	G	G	Y	R	G	G	G	G	G	R	R	G	G	0
CENTRAL ROAD AT U.S. RTE, 14 FAR LEFT AND MAST ARM SIGNALS	E/B	G	G	G	γ	R	G	G	G	G	G	G	6 +6	G +G	G +G	Y	R	G +G	-G +G	+G	G +Y	G +G	R	R	G	G +G	٥
CENTRAL ROAD AT PROSPECT AVENUE ALL SIGNALS	W/B	† G	† G	† G	† G	† G	↑ G	† G	† G	† G	γ	R	R	R	R	R	R	R	R	R	R	R	† G	† G	Ť G	R	0
CENTRAL ROAD AT PROSPECT AVENUE ALL SIGNALS	E/B	G	γ	R	R	R	G	G	Y	R	R	R	R	R	R	R	R	R	R	R	R	R	R	R	G	R	٥
PROSPECT AVENUE NEAR RIGHT SIGNAL	NW/B	R	R	R	R	R	R	R	R	R	R	R	G	Υ	R	R	R	G	Υ	R	R	G	R	R	R	G	٥
PROSPECT AVENUE FAR LEFT AND FAR RIGHT SIGNALS	NW/B	R	R	R	R	R	R	R	R	R	R	R	G	Υ	R	R	R	G	γ	R	R	G	R	R	R	G	0
PED, SIGNALS X-ING U.S, RTE, 14 ON NORTH SIDE OF CENTRAL ROAD		FH	н	н	н	н	FH	FH	н	н	н	н	н	н	н	н	н	н	н	н	н	н	н	Н	н	н	٥
PED. SIGNALS X-ING CENTRAL ROAD ON WEST SIDE OF PROSPECT AVENUE		н	н	н	н	н	н	н	н	н	н	н	FH	н	н	н	н	FH	н	н	н	FH	н	н	н	н	٥
PED. SIGNALS X-ING U.S. RTE, 14 ON SOUTH SIDE OF CENTRAL ROAD		FH	н	н	н	н	FH	FH	н	н	н	н	н	н	н	н	н	н	н	н	н	н	н	н	н	н	٥
PED, SIGNALS X-ING CENTRAL ROAD		н	н	н	н	н	н	н	н	н	н	н	н	н	н	н	н	н	н	н	н	н	н	н	н	н	٥

 $\Diamond$   $\;$  EMERGENCY VEHICLE SEQUENCE SHALL PROVIDE THE PROPER CLEARANCE INTERVAL TO RESUME THE NORMAL SEQUENCE OF OPERATION OR PROPER CLEARANCE INTERVAL TO DISPLAY A DIFFERENT EMERGENCY INTERVAL AFTER EMERGENCY VEHICLE 2, 3, 4 OR 5 IS TERMINATED.

> TS 9690 **ECON 197**



USER NAME = dbriones	DESIGNED	-	DLB	REVISED	-
	DRAWN	-	JK	REVISED	-
PLOT SCALE = 40.000 ' / in.	CHECKED	-	DB	REVISED	-
PLOT DATE = 7/31/2025	DATE	-	07/31/2025	REVISED	-


- 1. THIS PLAN IS FOR THE INSTALLATION OF APS PUSH BUTTONS AND LEADING PEDESTRIAN INTERVAL PROGRAMMING.
- 2. ALL PUSH BUTTONS SHALL BE APS.
- 3. APS SHALL BE PLACED PARALLEL TO THE CORRESPONDING CROSSWALKS.
- 4. CONTRACTOR SHALL CONFIRM THE FINAL LOCATION OF THE PEDESTRIAN EQUIPMENT WITH THE TRAFFIC SIGNAL ENGINEER BEFORE INSTALLATION.
- 5. ALL EXISTING TRAFFIC SIGNAL CABLE NO LONGER REQUIRED SHALL BE
- 6. SIDEWALK TO BE BROUGHT UP TO PROWAG STANDARDS ON A FUTURE CONTRACT.
- 7. THE GROUND MOUNTED, METERED SERVICE SHALL BE CONSTRUCTED ADJACENT TO THE EXISTING SERVICE CONDUIT PRIOR TO DISCONNECTING THE EXISTING SERVICE. INCLUDE A 5' STUB OF 2" CONDUIT FROM THE GM FOR FUTURE CONNECTION. THE COST OF THE 5' STUB, 2" UNDERGROUND CONDUIT AND SPLICE TO EXISTING SERVICE CONDUIT SHALL BE INCLUDED IN THE COST OF CONCRETE FOUNDATION. TYPE A. THE TRAFFIC SIGNALS SHALL REMAIN OPERATIONAL THE ENTIRE TIME THE SWITCH OVER BETWEEN EXISTING SERVICE AND PROPOSED SERVICE IS MADE.

#### **REMOVAL NOTES:**


THE FOLLOWING ITEMS SHALL BE REMOVED BY THE CONTRACTOR AND SHALL BE DISPOSED OF BY THEM OUTSIDE THE RIGHT-OF-WAY AT THEIR EXPENSE. THE SALVAGE VALUE OF THE REMOVED EQUIPMENT SHALL BE REFLECTED IN THE CONTRACT BID PRICE.

PEDESTRIAN PUSHBUTTON EACH CONTROLLER EACH

EACH SERVICE INSTALLATION

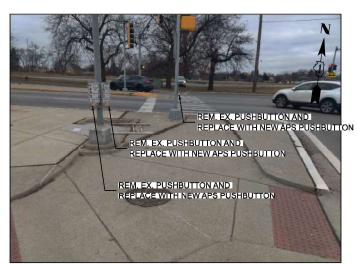

SOUTHWEST ISLAND

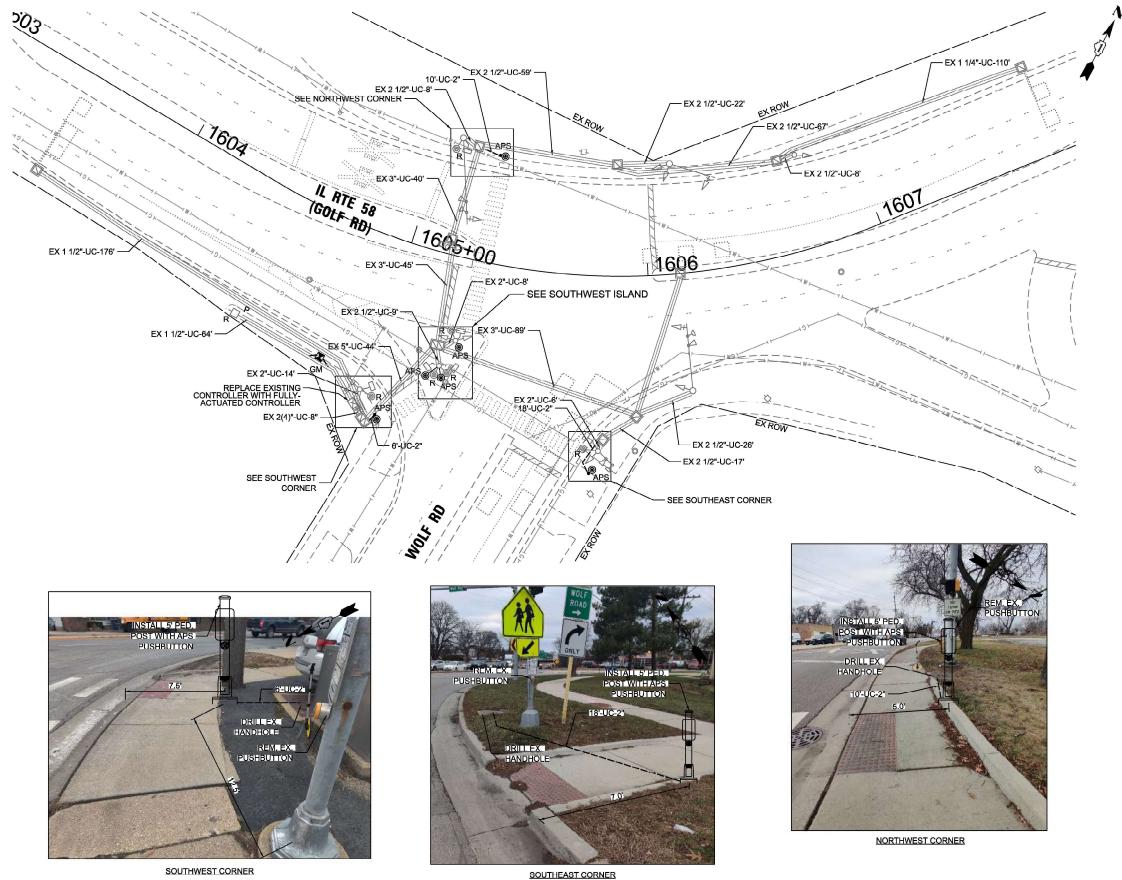

SCALE: 1"=20'

100 S. WACKER DRIVE, SUITE 400 CHICAGO, IL 60606

DESIGNED - DLB REVISED -USER NAME = dbriones DRAWN REVISED CHECKED -REVISED DB PLOT DATE = 7/31/2025 07/31/2025 REVISED

STATE OF ILLINOIS **DEPARTMENT OF TRANSPORTATION** 


TRAFFIC SIGNAL INSTALLATION PLAN IL ROUTE 58 (GOLF ROAD) AT WOLF ROAD SHEET 1 OF 20 SHEETS STA.

TOTAL SHEET NO. 89 43 SECTION COUNTY 2024-964-TS COOK CONTRACT NO. 62W89


SCALE IN FEET

TS 2865

**ECON 204** 

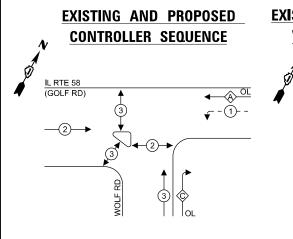

#### **EXISTING AND PROPOSED EMERGENCY VEHICLE PREEMPTION SEQUENCE**

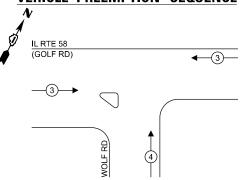

#### **LEGEND:**

**★**PROTECTED PHASE

PROTECTED/PERMITTED PHASE

**←**(\*)**→** PEDESTRIAN PHASE

# OL OVERLAP

# **RIGHT TURN OVERLAP** PHASE DESIGNATION:

VERLAP	PERMISSIV	E	PROTECTE	Į
LETTER	PHASE		PHASE	
Α	= 2	+	1	
С	= 3	+	1	
A	= 2	+ +	1 1	SE

## **NOTES:**

- TIMING CONSULTANT SHALL PROGRAM LEADING PEDESTRIAN INTERVAL FOR PHASE 3. THIS WORK SHALL BE PAID FOR UNDER RE-OPTIMIZE TRAFFIC SIGNAL SYSTEM LEVEL 1. THE TRAFFIC SIGNAL CONTROL EQUIPMENT FOR THIS
- LOCATION SHALL BE ECONOLITE TO MATCH EXISTING ADJACENT SYSTEM.

TRAFFIC SIGNAL

ı	ELECTRICA	AL SERVIC	CE REQU	- Jireme	NTS
5			QUANTITY	UNIT	TOTAL
an,d	TYPE		QUANTITI	WATTAGE	WATTAGE
e P	SIGNAL HEAD	3 - SECTION	8	11	88.0
Ö		4 - SECTION	-	14	-
Ş		5 - SECTION	4	13	52.0
3 at	PROGRAMMABLE	SIGNALS			
ÿ ≓		3 - SECTION	-	22	-
sht35		4 - SECTION	-	32	-
789 89		5 - SECTION	-	28	-
9620	PED. SIGNAL		6	15	90
Rd	CONTROLLER		1	150	150.0
٥ ۸	MASTER CONTROL	LLER	-	100	-
d) at	UPS		1	25	25.0
00	DETECTION	RADAR	-	20	-
98		VIDEO	-	20	-
-	BLANK-OUT SIGN		-	25	-
2865	NETWORK SWITCH	HII OR III	-	35	-
2	CELLULAR MODEN	1	-	15	-
ts/18		TOTA	L UPS SIZIN	IG = 40	5.0
Shee	UPS CHARGING		1	225	225.0
8	BATTERY HEATER	MAT	1	180	180.0
/ork(CADD)CADD Sneets/18_TS 2865 - IL 58 (Golf Rd) at Wolf Rd\D62W89-sht35-IL 58 at WOLF Cable Plan dgn	CABINET HEATER		1	200	200.0
ğ	FLASHER		-	15	-
ork)	LED STREET NAME	ESIGN	-	120	-

ENERGY COSTS TO:

LUMINAIRE

ILLINOIS DEPARTMENT OF TRANSPORTATION

201 W CENTER COURT SCHAUMBURG. IL 60196-1096

ENERGY SUPPLY: CONTACT: JAMES CAMPBELI PHONE: 630-940-6805

TOTAL SERVICE WIRE SIZING = 1010.0

240

COMPANY: COMMONWEALTH EDISON ACCOUNT NUMBER: - 6015004000

ATLAS TECHNICAL CONSULTANTS, LLC 100 S. WACKER DRIVE, SUITE 400 CHICAGO, IL 60606

ISER NAME = dbriones	DESIGNED	-	DLB	REVISED	-
	DRAWN	-	JK	REVISED	-
LOT SCALE = 40.000'/in.	CHECKED	-	DB	REVISED	-
LOT DATE = 7/31/2025	DATE	-	07/31/2025	REVISED	-

STATE OF ILLINOIS **DEPARTMENT OF TRANSPORTATION** 

M

IL RTE 58 (GOLF RD)

3#20

EXISTING CABLE PLAN, EXISTING PHASE DESIGNATION DIAGRAM AND EMERGENCY VEHICLE PREEMPTION SEQUENCE, AND SCHEDULE OF QUANTITIES IL ROUTE 58 (GOLF ROAD) AT WOLF ROAD SHEET 2 OF 2 SHEETS STA.

SECTION COUNTY 2024-964-TS COOK 89 44 CONTRACT NO. 62W89

2#6	GM	2#6

TYPE II CABINET

SCHEDULE OF QUANTITIES  ITEM DESCRIPTION	UNITS	TOTAL QTY
UNDERGROUND CONDUIT, GALVANIZED STEEL, 2" DIA.	FOOT	34
MAINTENANCE OF EXISTING TRAFFIC SIGNAL INSTALLATION	EACH	1
ELECTRIC CABLE IN CONDUIT, SIGNAL NO. 14 2C	FOOT	553
ELECTRIC CABLE IN CONDUIT, LEAD-IN, NO. 14 1 PAIR	FOOT	636
ELECTRIC CABLE IN CONDUIT, SERVICE, NO. 6 2 C	FOOT	38
ELECTRIC CABLE IN CONDUIT, EQUIPMENT GROUNDING CONDUCTOR, NO. 6 1C	FOOT	288
CONCRETE FOUNDATION, TYPE A	FOOT	4
DRILL EXISTING HANDHOLE	EACH	3
INDUCTIVE LOOP DETECTOR	EACH	2
REMOVE ELECTRIC CABLE FROM CONDUIT	FOOT	66
REMOVE EXISTING TRAFFIC SIGNAL EQUIPMENT	EACH	1
SERVICE INSTALLATION, GROUND MOUNTED, METERED	EACH	1
PEDESTRIAN SIGNAL POST, 5 FT.	EACH	3
FULL-ACTUATED CONTROLLER IN EXISTING CABINET	EACH	1
REMOVE AND REPLACE BATTERIES FOR UNINTERUPTABLE POWER SUPPLY, EXTENDED	EACH	1
ACCESSIBLE PEDESTRIAN SIGNALS	EACH	6
CONCRETE FOUNDATION, TYPE A 12-INCH DIAMETER	FOOT	12
RE-OPTIMIZE TRAFFIC SIGNAL SYSTEM LEVEL 1	EACH	1

(a) < 72) 0 0 - 1#6 REPLACE EXISTING CONTROLLER WITH WOLF RD FULLY-ACTUATED CONTROLLER REMOVE AND REPLACE BATTERIES FOR UPS

R > G \$ 6


(n) ≺ (z) R


**CABLE PLAN** 

TS 2865

**ECON 204** 

SEEGERS RD

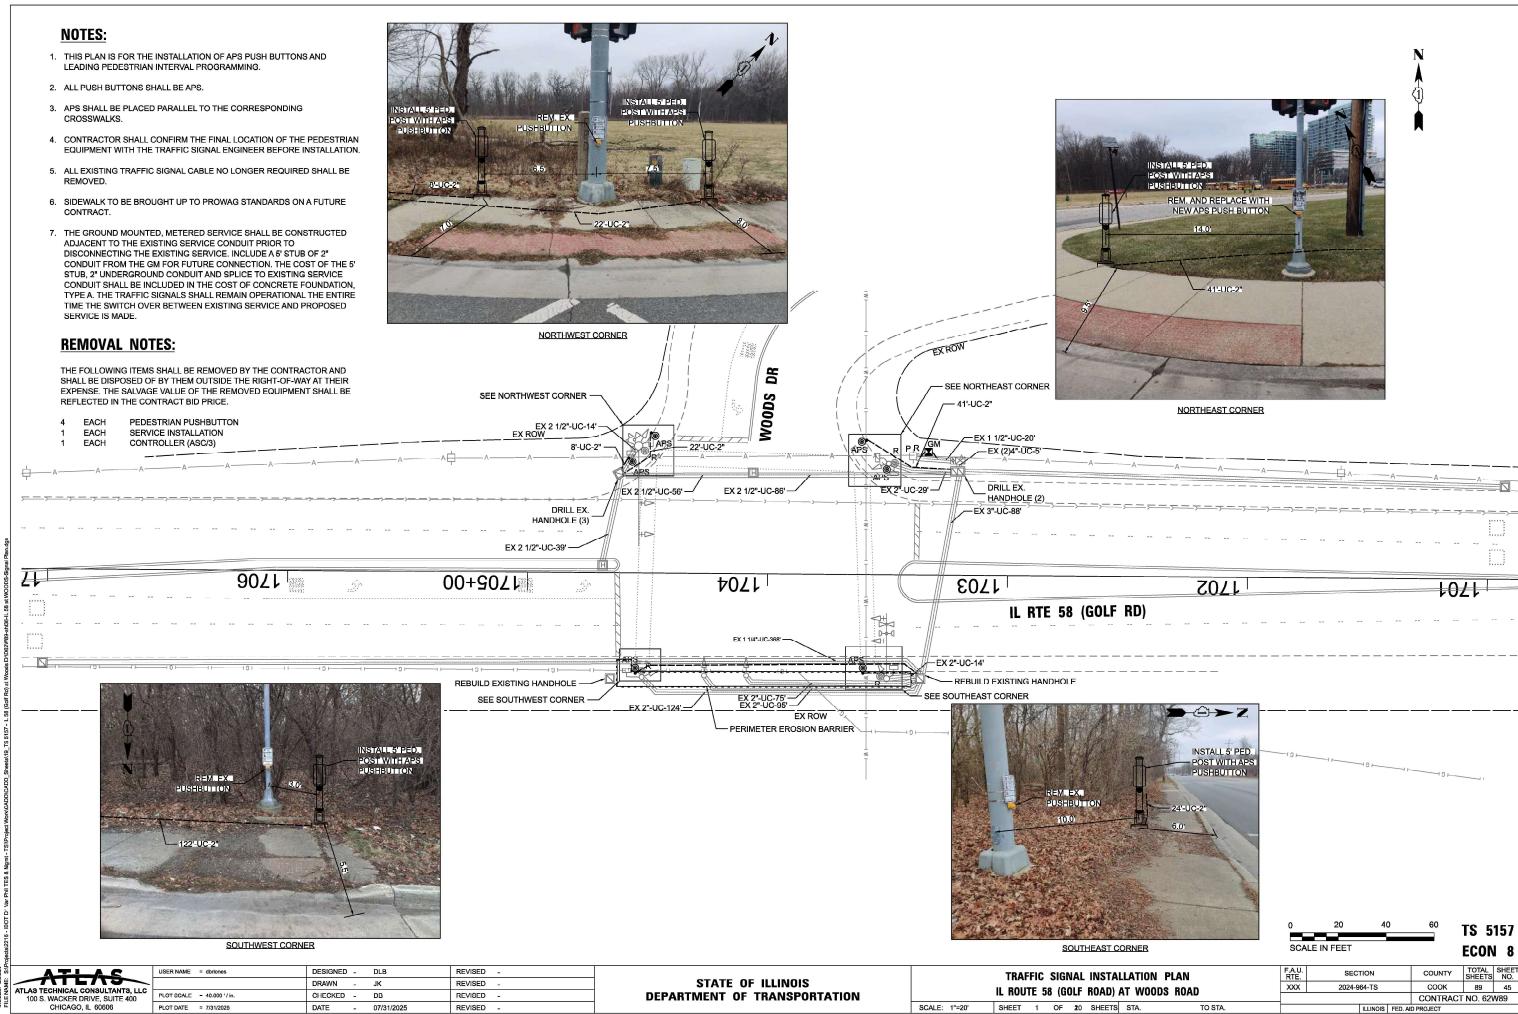

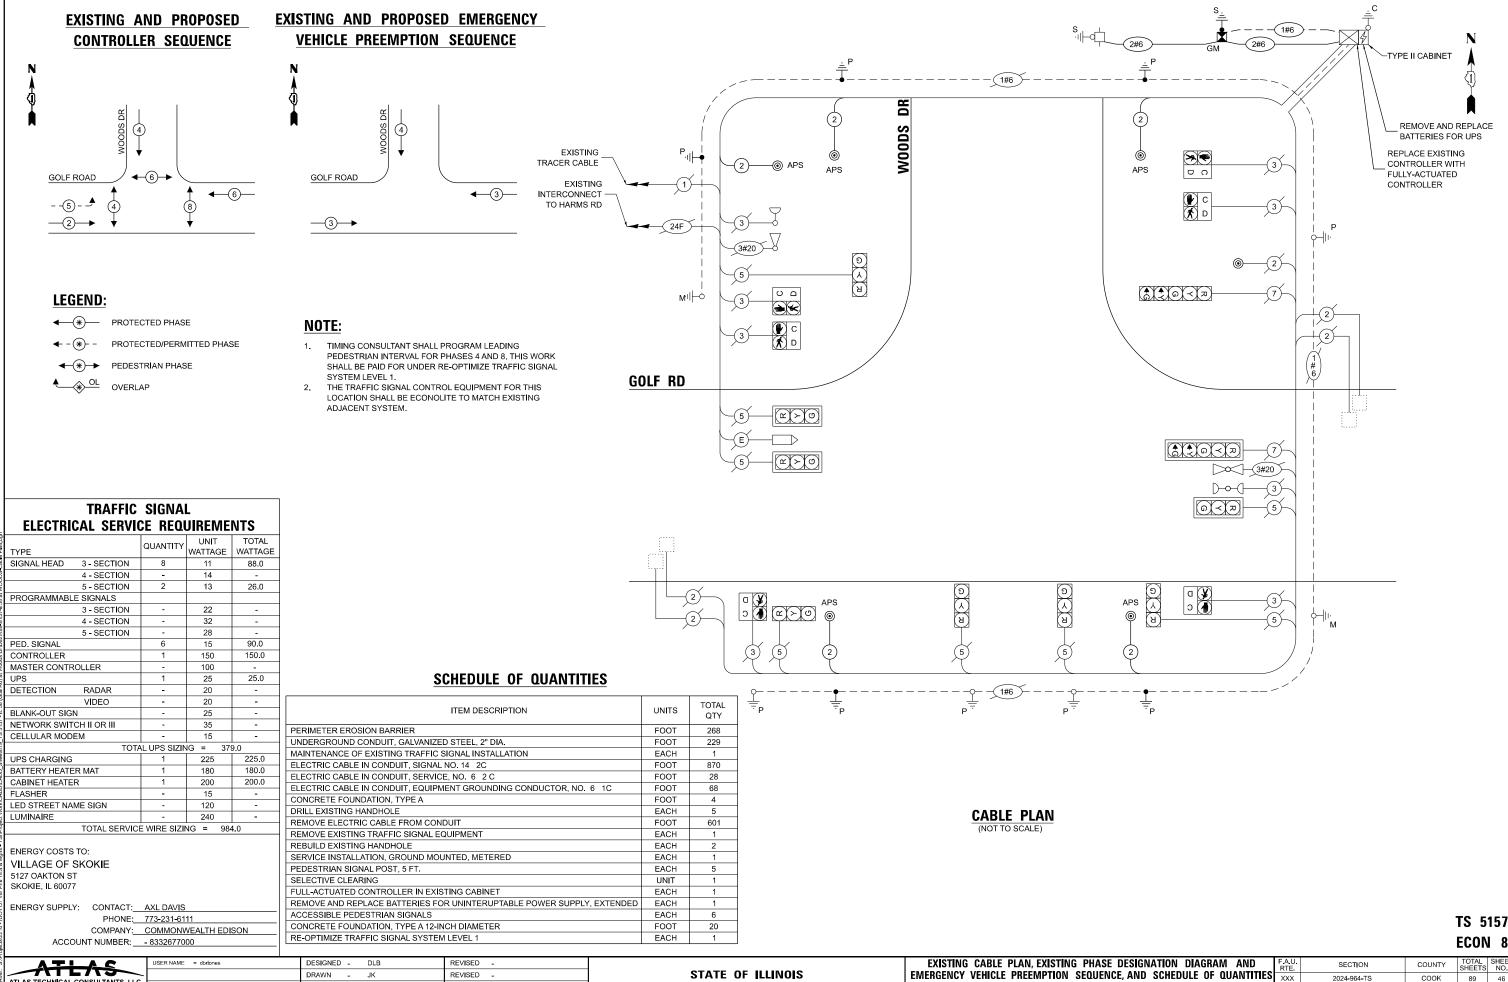

**DEPARTMENT OF TRANSPORTATION** 

IL ROUTE 58 (GOLF ROAD) AT WOODS DRIVE

SHEET 2 OF 2 SHEETS STA.

CONTRACT NO. 62W89

TLAS TECHNICAL CONSULTANTS, LLC

100 S. WACKER DRIVE, SUITE 400 CHICAGO, IL 60606

PLOT DATE = 7/31/2025

DB

- 07/31/2025

DATE

REVISED

REVISED .

- 1. THIS PLAN IS FOR THE INSTALLATION OF APS PUSH BUTTONS AND LEADING PEDESTRIAN INTERVAL PROGRAMMING.
- 2. ALL PUSH BUTTONS SHALL BE APS.
- 3. APS SHALL BE PLACED PARALLEL TO THE CORRESPONDING CROSSWALKS.
- 4. CONTRACTOR SHALL CONFIRM THE FINAL LOCATION OF THE PEDESTRIAN EQUIPMENT WITH THE TRAFFIC SIGNAL ENGINEER BEFORE INSTALLATION.
- 5. ALL EXISTING TRAFFIC SIGNAL CABLE NO LONGER REQUIRED SHALL BE
- 6. SIDEWALK TO BE BROUGHT UP TO PROWAG STANDARDS ON A FUTURE CONTRACT.
- 7. THE GROUND MOUNTED, METERED SERVICE SHALL BE CONSTRUCTED ADJACENT TO THE EXISTING SERVICE CONDUIT PRIOR TO DISCONNECTING THE EXISTING SERVICE. INCLUDE A 5' STUB OF 2" CONDUIT FROM THE GM FOR FUTURE CONNECTION. THE COST OF THE 5' STUB, 2" UNDERGROUND CONDUIT AND SPLICE TO EXISTING SERVICE CONDUIT SHALL BE INCLUDED IN THE COST OF CONCRETE FOUNDATION. TYPE A. THE TRAFFIC SIGNALS SHALL REMAIN OPERATIONAL THE ENTIRE TIME THE SWITCH OVER BETWEEN EXISTING SERVICE AND PROPOSED SERVICE IS MADE.

#### **REMOVAL NOTES:**

THE FOLLOWING ITEMS SHALL BE REMOVED BY THE CONTRACTOR AND SHALL BE DISPOSED OF BY THEM OUTSIDE THE RIGHT-OF-WAY AT THEIR EXPENSE. THE SALVAGE VALUE OF THE REMOVED EQUIPMENT SHALL BE REFLECTED IN THE CONTRACT BID PRICE.

PEDESTRIAN PUSHBUTTON EACH EACH SERVICE INSTALLATION

REM. EX. PUSHBUTTON AND REPLACE \_\_\_\_\_\_\_WITH NEW APS PUSH-BUTTON

SOUTHWEST CORNER

1802

BARRINGTON RD

SEE SOUTHWEST CORNER

EX 2 1/2"-UC-20' -

EX 1 1/4"-UC-255'



- \$EE NORTHWEST CORNER (2)

EX 2"-UC-31"



 $\rightarrow \bigcirc \rightarrow Z$ 

13'-UC-2" DRILL EX. NORTHWEST CORNER (1) HANDHOLE — EX (2))4"-UC-9' EX 1 1/4"-UC-234' - FX 4/1/2"-UC-20" - SEE NORTHWEST CORNER (1) - EX 2 1/2"-UC-79 180 1804



NORTHEAST CORNER

SCALE IN FEET

TS 21130 **ECON 150** 

100 S. WACKER DRIVE, SUITE 400

DESIGNED - DLB REVISED -USER NAME = dbriones DRAWN REVISED CHECKED -REVISED PLOT SCALE - 40.000 ' / in. DB PLOT DATE = 7/31/2025 DATE 07/31/2025 REVISED

STATE OF ILLINOIS **DEPARTMENT OF TRANSPORTATION** 

CHURCH

95

EX 2 1/2"-UC-38' EX 2"-UC-14'

6'-UC-2"

APS

1803

EX ROW

- EX 2 1/2"-UC-44'

- EX 3 1/2"-UC-73"

EX 4"-UC-18'

TRAFFIC SIGNAL INSTALLATION PLAN BARRINGTON ROAD AT OLD CHURCH ROAD

TOTAL SHEET NO. 89 47 SECTION COUNTY 2024-964-TS COOK CONTRACT NO. 62W89

CHICAGO, IL 60606

SCALE: 1"=20'

SEE NORTHEAST CORNER


EX 2 1/2"-UC-12'

SHEET 1 OF 2 SHEETS STA.


#### **EXISTING AND PROPOSED** CONTROLLER SEQUENCE

#### **EXISTING AND PROPOSED EMERGENCY VEHICLE PREEMPTION SEQUENCE**

#### **>**-->≥

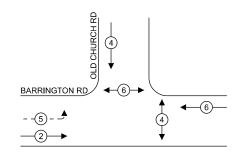



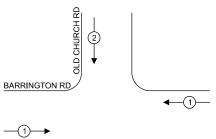

#### **LEGEND**:

**★**PROTECTED PHASE

PROTECTED/PERMITTED PHASE

**←**(\*)**→** PEDESTRIAN PHASE

OL OVERLAP

#### NOTE:

TIMING CONSULTANT SHALL PROGRAM LEADING PEDESTRIAN INTERVAL FOR PHASE 4. THIS WORK SHALL BE PAID FOR UNDER RE-OPTIMIZE TRAFFIC SIGNAL SYSTEM LEVEL 1.

#### TRAFFIC SIGNAL **ELECTRICAL SERVICE REQUIREMENTS**

TYPE	QUANTITY	WATTAGE	WATTAGE
SIGNAL HEAD 3 - SECTION	6	11	66.0
4 - SECTION	-	14	-
5 - SECTION	2	13	26.0
PROGRAMMABLE SIGNALS			
3 - SECTION	-	22	-
4 - SECTION	-	32	-
5 - SECTION	-	28	-
PED. SIGNAL	4	15	60.0
CONTROLLER	1	150	150.0
MASTER CONTROLLER	-	100	-
UPS	1	25	25.0
DETECTION RADAR	-	20	-
VIDEO	-	20	-
BLANK-OUT SIGN	-	25	-
NETWORK SWITCH II OR III	-	35	-
CELLULAR MODEM	-	15	-
	L UPS SIZIN	IG = 32	
UPS CHARGING	1	225	225.0
BATTERY HEATER MAT	1	180	180.0
CABINET HEATER	1	200	200.0
FLASHER	-	15	-
LED STREET NAME SIGN	-	120	-
LUMINAIRE	-	240	-
TOTAL SERVICE	WIRE SIZIN	VG = 933	2.0

ENERGY COSTS TO: VILLAGE OF STREAMWOOD 301 E IRVING PARK RD

ATLAS TECHNICAL CONSULTANTS, LLC 100 S. WACKER DRIVE, SUITE 400 CHICAGO, IL 60606

PHONE: 773-241-0741 COMPANY: COMMONWEALTH EDISON

TVDE		QUANTITY	UNII	IOIAL
TYPE		_	WATTAGE	WATTAGE
SIGNAL HEAD	3 - SECTION	6	11	66.0
	4 - SECTION	-	14	-
	5 - SECTION	2	13	26.0
PROGRAMMABLE	E SIGNALS			
	3 - SECTION	-	22	-
	4 - SECTION	-	32	-
	5 - SECTION	-	28	-
PED. SIGNAL		4	15	60.0
CONTROLLER		1	150	150.0
MASTER CONTRO	OLLER	-	100	-
UPS		1	25	25.0
DETECTION	RADAR	-	20	-
	VIDEO	-	20	-
BLANK-OUT SIGN	I	-	25	-
NETWORK SWITC	CH II OR III	-	35	-
CELLULAR MODE	M	-	15	-
	TOTA	L UPS SIZIN	IG = 32	7.0
UPS CHARGING		1	225	225.0
BATTERY HEATE	R MAT	1	180	180.0
CABINET HEATER	₹	1	200	200.0
FLASHER		-	15	-
LED STREET NAM	ΛΕ SIGN	-	120	-
LUMINAIRE		-	240	-
	TOTAL SERVICE	WIRE SIZIN	NG = 932	2.0

STREAMWOOD, IL 60107 ENERGY SUPPLY: CONTACT: CASSIE EVANS

ACCOUNT NUMBER: \_\_\_ - 8091045733

#### DESIGNED - DLB REVISED DRAWN - JK REVISED -CHECKED - DB REVISED PLOT DATE = 7/31/2025 DATE - 07/31/2025 REVISED -

#### STATE OF ILLINOIS **DEPARTMENT OF TRANSPORTATION**

#### EXISTING CABLE PLAN, EXISTING PHASE DESIGNATION DIAGRAM AND EMERGENCY VEHICLE PREEMPTION SEQUENCE, AND SCHEDULE OF QUANTITIES BARRINGTON ROAD AT OLD CHURCH ROAD

SECTION COUNTY 2024-964-TS COOK 89 48 CONTRACT NO. 62W89 SHEET 2 OF 2 SHEETS STA.

**CABLE PLAN** 

**BARRINGTON RD** 

OLD CHURCH RD

(3)

○ □ **→** 

# SCHEDULE OF QUANTITIES

ми⊢ф

ITEM DESCRIPTION	UNITS	TOTAL QTY
UNDERGROUND CONDUIT, GALVANIZED STEEL, 2" DIA.	FOOT	19
MAINTENANCE OF EXISTING TRAFFIC SIGNAL INSTALLATION	EACH	1
ELECTRIC CABLE IN CONDUIT, SIGNAL NO. 14 2C	FOOT	198
ELECTRIC CABLE IN CONDUIT, SERVICE, NO. 6 2 C	FOOT	28
ELECTRIC CABLE IN CONDUIT, EQUIPMENT GROUNDING CONDUCTOR, NO. 6 1C	FOOT	67
CONCRETE FOUNDATION, TYPE A	FOOT	4
DRILL EXISTING HANDHOLE	EACH	2
REMOVE ELECTRIC CABLE FROM CONDUIT	FOOT	207
REMOVE EXISTING TRAFFIC SIGNAL EQUIPMENT	EACH	1
SERVICE INSTALLATION, GROUND MOUNTED, METERED	EACH	1
PEDESTRIAN SIGNAL POST, 5 FT.	EACH	2
ACCESSIBLE PEDESTRIAN SIGNALS	EACH	4
CONCRETE FOUNDATION, TYPE A 12-INCH DIAMETER	FOOT	8
RE-OPTIMIZE TRAFFIC SIGNAL SYSTEM LEVEL 1	EACH	1

TS 21130 **ECON 150** 

EXISTING - INTERCONNECT TO BODE RD EXISTING

TRACER CABLE

TYPE II CABINET

3#20

**>>** €

(a) < (7)

- THIS PLAN IS FOR THE INSTALLATION OF APS PUSH BUTTONS AND LEADING PEDESTRIAN INTERVAL PROGRAMMING.
- 2. ALL PUSH BUTTONS SHALL BE APS.
- 3. APS SHALL BE PLACED PARALLEL TO THE CORRESPONDING CROSSWALKS.
- 4. CONTRACTOR SHALL CONFIRM THE FINAL LOCATION OF THE PEDESTRIAN EQUIPMENT WITH THE TRAFFIC SIGNAL ENGINEER BEFORE INSTALLATION.
- 5. ALL EXISTING TRAFFIC SIGNAL CABLE NO LONGER REQUIRED SHALL BE
- 6. SIDEWALK TO BE BROUGHT UP TO PROWAG STANDARDS ON A FUTURE CONTRACT.

#### **REMOVAL NOTES:**

THE FOLLOWING ITEMS SHALL BE REMOVED BY THE CONTRACTOR AND SHALL BE DISPOSED OF BY THEM OUTSIDE THE RIGHT-OF-WAY AT THEIR EXPENSE. THE SALVAGE VALUE OF THE REMOVED EQUIPMENT SHALL BE REFLECTED IN THE CONTRACT BID PRICE.

EX 2 1/2"-UC-119'


EX 2 1/2"-UC-47' ----

CONTROLLER

PEDESTRIAN SIGNAL HEAD EACH

**EACH** 3-SECTION SIGNAL HEAD

EACH 5-SECTION SIGNAL HEAD EACH PEDESTRIAN PUSH-BUTTON

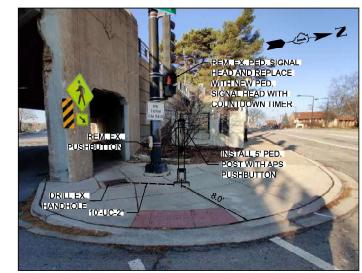

NORTHWEST CORNER

REPLACE EXISTING CONTROLLER WITH FULLY-ACTUATED CONTROLLER

- EX 3"-UC-194' EX 3 1/2"-UC-26'

DRILL EX.

- 36'-UC-2"

- EX 2"-UC-22'

EX 3 1/2"-UC-75

REMOVE AND REPLACE SIGNAL HEAD (TYP.)

SEE NORTHEAST

EX 2"-UC-108'

X

EX ROW

- ÈX 3 1/2"-UC-166'

REM. EX. PED. SIGNAL-HEAD AND REPLACE WITH NEW PED. ISIGNAL HEAD WITH COUNTDOWN TIMER INSTALL 5' PED.
POST WITH APS

SCALE: 1"=20'

SCALE IN FEET

TS 9240 **ECON 190** 

CHICAGO, IL 60606

USER NAME = dbriones	DESIGNED -	DLB	REVISED -	
	DRAWN -	JK	REVISED -	
PLOT SCALE - 40.000 '/ in.	CHECKED -	DB	REVISED -	
PLOT DATE = 7/31/2025	DATE -	07/31/2025	REVISED -	

STATE OF ILLINOIS **DEPARTMENT OF TRANSPORTATION** 

EX 1 1/2"-UC-58"

**TOUHY AVE** 

REMOVE AND REPLACE SIGNAL HEAD (TYP.)

SEE NORTHWEST CORNER

EX ROW


10'-UC-2"

EX 1 1/2"-UC-5'

TRAFFIC SIGNAL INSTALLATION PLAN **BUSSE HIGHWAY AT TOUHY AVENUE** SHEET 1 OF 20 SHEETS STA.

NORTHEAST CORNER


.A.U. RTE.	SECTION		COUNTY	TOTAL SHEETS	SHE		
XXX	2024-964-TS		COOK	89	49		
			CONTRACT NO. 62W89				
	ILLINOIS	D PROJECT					

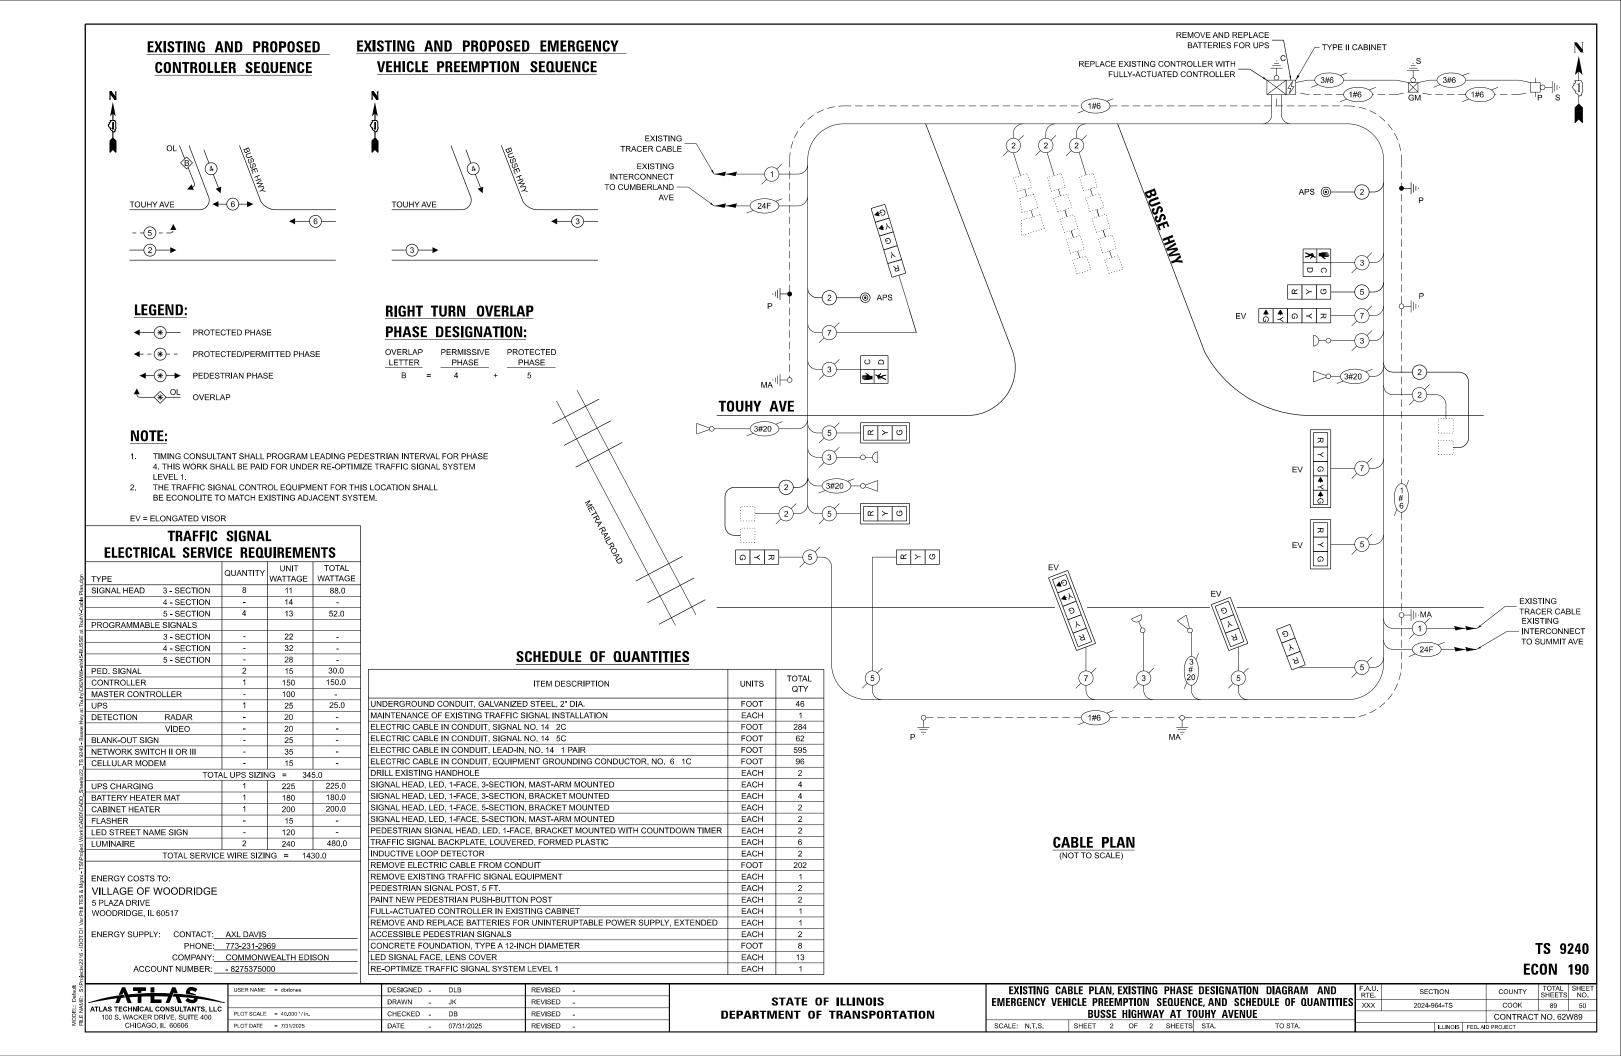

- THIS PLAN IS FOR THE INSTALLATION OF APS PUSH BUTTONS AND LEADING PEDESTRIAN INTERVAL PROGRAMMING.
- 2. ALL PUSH BUTTONS SHALL BE APS.
- 3. APS SHALL BE PLACED PARALLEL TO THE CORRESPONDING CROSSWALKS.
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- 5. ALL EXISTING TRAFFIC SIGNAL CABLE NO LONGER REQUIRED SHALL BE
- 6. SIDEWALK TO BE BROUGHT UP TO PROWAG STANDARDS ON A FUTURE CONTRACT.


#### **REMOVAL NOTES:**

THE FOLLOWING ITEMS SHALL BE REMOVED BY THE CONTRACTOR AND SHALL BE DISPOSED OF BY THEM OUTSIDE THE RIGHT-OF-WAY AT THEIR EXPENSE. THE SALVAGE VALUE OF THE REMOVED EQUIPMENT SHALL BE

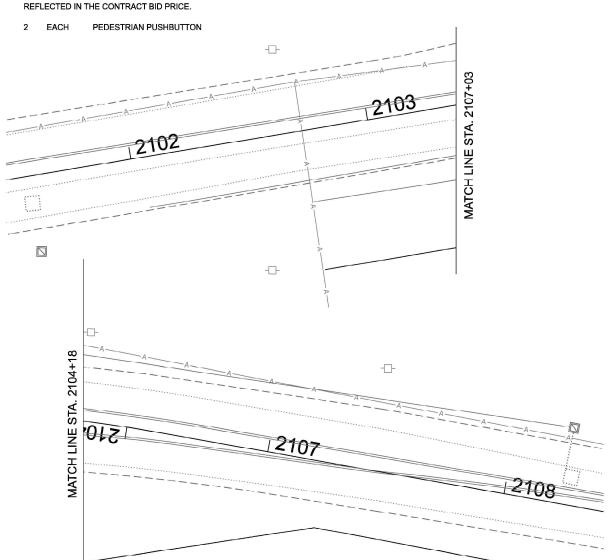



NORTHEAST CORNER

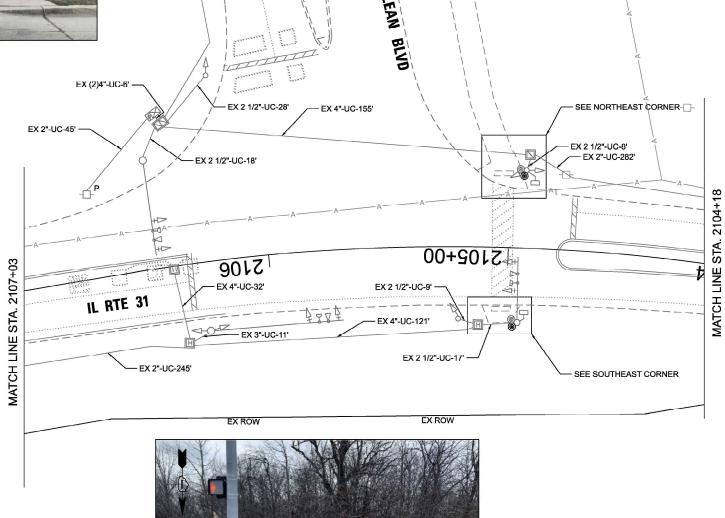

EX 2"-UC-326"

CHICAGO II 60606

USER NAME = dbriones	DESIGNED	-	DLB	REVISED -
	DRAWN	-	JK	REVISED -
PLOT SCALE - 40.000 '/ in.	CHECKED	-	DB	REVISED -
PLOT DATE = 7/31/2025	DATE	-	07/31/2025	REVISED -

STATE OF ILLINOIS **DEPARTMENT OF TRANSPORTATION** 

TRAF	FIC	SIGN	IAL	INSTA	LLATION	PLAN	
					N BOULI	EVARD	
SHEET	1	OF	20	SHEETS	STA.		TO STA

SOUTHEAST CORNER


SCALE: 1"=20'

REM. EX. PUSHBUTTON AND REPLACE


F.A.U. RTE.	SECT	SECTION 2024-964-TS		COUNTY	TOTAL SHEETS	SHEET NO.
XXX	2024-9	64-TS		KANE	89	51
				CONTRACT	NO. 62\	N89
		ILLINOIS	FED. Al	D PROJECT		

SCALE IN FEET KANE CO - TRANSUITE

TS 12094

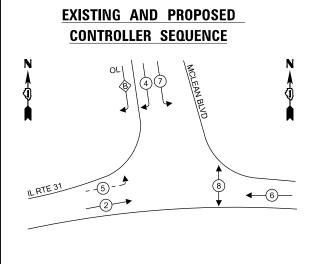

### **EXISTING AND PROPOSED EMERGENCY VEHICLE PREEMPTION SEQUENCE**

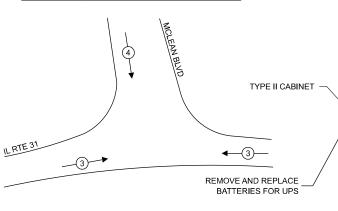

## **LEGEND:**

**◆**PROTECTED PHASE

PROTECTED/PERMITTED PHASE

**◆**(\*)**→** PEDESTRIAN PHASE

♦ OL OVERLAP

## TRAFFIC SIGNAL **ELECTRICAL SERVICE REQUIREMENTS**

	QUANTITY	UNIT	TOTAL
TYPE	Q0/111111	WATTAGE	WATTAGE
SIGNAL HEAD 3 - SECTION	8	11	88.0
4 - SECTION	-	14	-
5 - SECTION	4	13	52.0
PROGRAMMABLE SIGNALS			
3 - SECTION	-	22	-
4 - SECTION	-	32	-
5 - SECTION	-	28	-
PED. SIGNAL	2	15	30.0
CONTROLLER	1	150	150.0
MASTER CONTROLLER	-	100	-
UPS DETECTION RADAR	1	25	25.0
DETECTION RADAR	-	20	-
VIDEO	-	20	-
BLANK-OUT SIGN	-	25	-
NETWORK SWITCH II OR III	-	35	-
CELLULAR MODEM	-	15	-
TOTA	L UPS SIZIN	IG = 34	5.0
UPS CHARGING	1	225	225.0
BATTERY HEATER MAT	1	180	180.0
CABINET HEATER	1	200	200.0
FLASHER	-	15	-
LED STREET NAME SIGN	-	120	-
LUMINAIRE	-	240	-
TOTAL SERVICE	E WIRE SIZI	NG = 950	0.0

ENERGY COSTS TO:

ILLINOIS DEPARTMENT OF TRANSPORTATION

201 W CENTER COURT SCHAUMBURG, IL 60196-1096

PHONE: 773-241-0741

COMPANY: COMMONWEALTH EDISON ACCOUNT NUMBER: \_\_\_ - 7897646000


ENERGY SUPPLY: CONTACT: CASSIE EVANS

#### **RIGHT TURN OVERLAP** PHASE DESIGNATION:

OVERLAP PERMISSIVE PROTECTED  $\frac{\text{LETTER}}{\text{B}} = \frac{\text{PHASE}}{4} + \frac{\text{PHASE}}{5}$ 

#### NOTE:

 TIMING CONSULTANT SHALL PROGRAM LEADING PEDESTRIAN INTERVAL FOR PHASE 8. THIS WORK SHALL BE PAID FOR UNDER RE-OPTIMIZE TRAFFIC SIGNAL SYSTEM LEVEL 1.

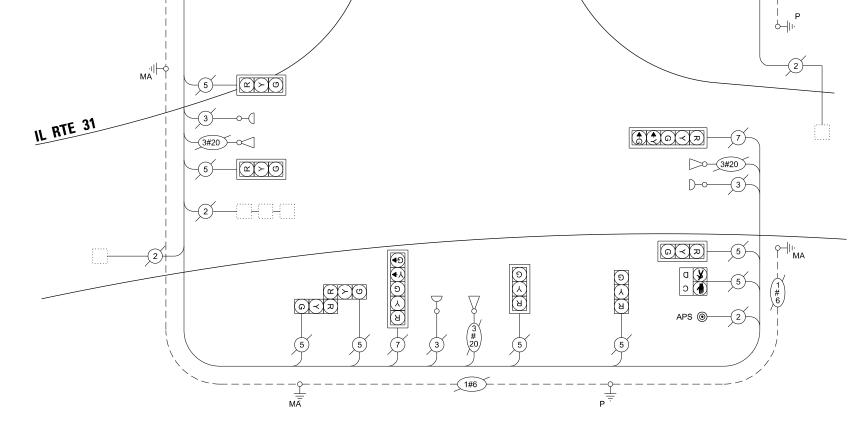

EXISTING - TRACER CABLE

2

(2)

NO. 14

@(X)@(X)Z

**EXISTING** INTERCONNECT

TO STEARNS RD

#### SCHEDULE OF QUANTITIES

ITEM DESCRIPTION	UNITS	TOTAL QTY
MAINTENANCE OF EXISTING TRAFFIC SIGNAL INSTALLATION	EACH	1
REMOVE EXISTING TRAFFIC SIGNAL EQUIPMENT	EACH	1
REMOVE AND REPLACE BATTERIES FOR UNINTERUPTABLE POWER SUPPLY, EXTENDED	EACH	1
ACCESSIBLE PEDESTRIAN SIGNALS	EACH	2
RE-OPTIMIZE TRAFFIC SIGNAL SYSTEM LEVEL 1	EACH	1

#### CABLE PLAN (NOT TO SCALE)

TS 12094 **EAGLE 9P** KANE CO - TRANSUITE



USER NAME = dbriones	DESIGNED	-	DLB	REVISED	-
	DRAWN	-	JK	REVISED	-
PLOT SCALE = 40.000 '/in.	CHECKED	-	DB	REVISED	-
PLOT DATE = 7/31/2025	DATE	-	07/31/2025	REVISED	-

STATE OF ILLINOIS **DEPARTMENT OF TRANSPORTATION** 

							NATION DIAGRAM AND	FF
EMERGENCY					SEQUENO MCLEAI		SCHEDULE OF QUANTITIE	S
	II.	. noo	IE 31	AI	IVICLEA	N DUU	LEVAND	
SCALE: N.T.S.	SHEE	T 2	OF	2	SHEETS	STA.	TO STA.	

MICLEAN BLUD


F.A.U. RTE	SECTION		COUNTY	TOTAL SHEETS	SHEE NO.
XXX	2024-964-TS		KANE	89	52
			CONTRACT	NO. 62\	N89
	ILLINOIS FE	ED. AI	D PROJECT		

- THIS PLAN IS FOR THE INSTALLATION OF APS PUSH BUTTONS AND LEADING PEDESTRIAN INTERVAL PROGRAMMING.
- 2. ALL PUSH BUTTONS SHALL BE APS.
- 3. APS SHALL BE PLACED PARALLEL TO THE CORRESPONDING CROSSWALKS.
- 4. CONTRACTOR SHALL CONFIRM THE FINAL LOCATION OF THE PEDESTRIAN EQUIPMENT WITH THE TRAFFIC SIGNAL ENGINEER BEFORE INSTALLATION.
- 5. ALL EXISTING TRAFFIC SIGNAL CABLE NO LONGER REQUIRED SHALL BE REMOVED.
- 6. SIDEWALK TO BE BROUGHT UP TO PROWAG STANDARDS ON A FUTURE CONTRACT.

#### **REMOVAL NOTES:**

THE FOLLOWING ITEMS SHALL BE REMOVED BY THE CONTRACTOR AND SHALL BE DISPOSED OF BY THEM OUTSIDE THE RIGHT-OF-WAY AT THEIR EXPENSE. THE SALVAGE VALUE OF THE REMOVED EQUIPMENT SHALL BE REFLECTED IN THE CONTRACT BID PRICE.

2 EACH PEDESTRIAN PUSH-BUTTON

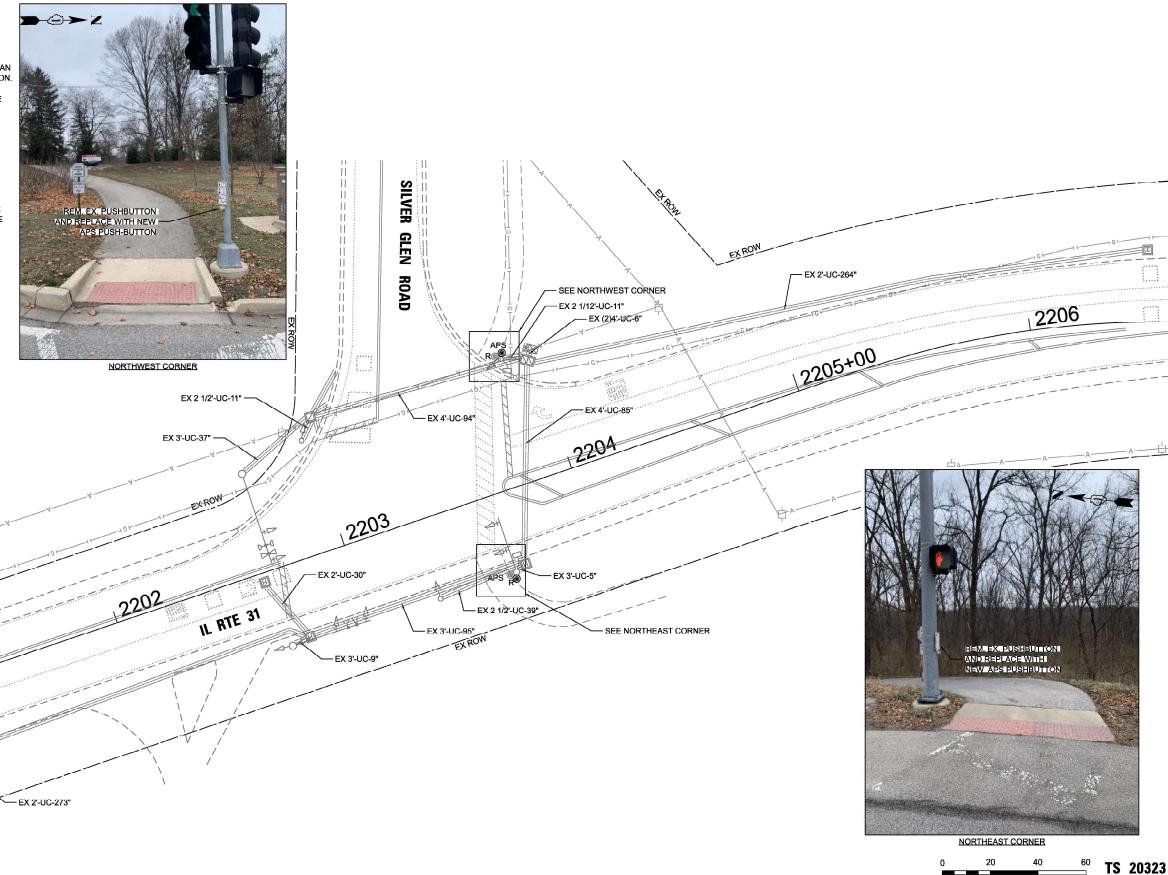

SCALE: 1"=20'

ATLAS TECHNICAL CONSULTANTS, LLC
100 S. WACKER DRIVE, SUITE 400
CHICAGO, IL 60606

 USER NAME
 = dbriones
 DESIGNED
 DLB
 REVISED

 DRAWN
 JK
 REVISED

 PLOT SCALE
 - 40.000 '/ in.
 CHECKED
 DB
 REVISED

 PLOT DATE
 = 7/31/2025
 DATE
 07/31/2025
 REVISED

STATE OF ILLINOIS
DEPARTMENT OF TRANSPORTATION

TRAFFIC SIGNAL INSTALLATION PLAN
IL ROUTE 31 AT SILVER GLEN ROAD


SHEET 1 OF 20 SHEETS STA. TO STA.


**→**⊕→Z

#### **EXISTING AND PROPOSED CONTROLLER SEQUENCE**

#### **EXISTING AND PROPOSED EMERGENCY VEHICLE PREEMPTION SEQUENCE**



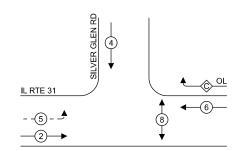

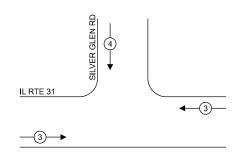

**RIGHT TURN OVERLAP** 

**PHASE DESIGNATION:** 

#### **LEGEND**:

← -(\*)- - PROTECTED/PERMITTED PHASE

**◆**(\*)**→** PEDESTRIAN PHASE

OL OVERLAP

#### **★**PROTECTED PHASE

## OVERLAP PERMISSIVE PROTECTED LETTER PHASE PHASE C = 4 + 6

### **NOTES:**

<del>></del>-©→Z

TIMING CONSULTANT SHALL PROGRAM LEADING PEDESTRIAN INTERVAL FOR PHASE 8. THIS WORK SHALL BE PAID FOR UNDER RE-OPTIMIZE TRAFFIC SIGNAL SYSTEM LEVEL 1.

ELECTRICAL SERVICE	CE REQU	JIREME	NTS
TYPE	QUANTITY	UNIT WATTAGE	TOTAL WATTAGE
SIGNAL HEAD 3 - SECTION	8	11	88.0
4 - SECTION	-	14	-
5 - SECTION	4	13	52.0
PROGRAMMABLE SIGNALS			
3 - SECTION	-	22	-
4 - SECTION	-	32	-
5 - SECTION	-	28	-
PED. SIGNAL	2	15	30.0
CONTROLLER	1	150	150.0
MASTER CONTROLLER	-	100	-
UPS	1	25	25.0
DETECTION RADAR	-	20	-
VIDEO	-	20	-
BLANK-OUT SIGN	-	25	-
NETWORK SWITCH II OR III	-	35	-
CELLULAR MODEM	-	15	-
TOTA	AL UPS SIZIN	IG = 34	5.0
UPS CHARGING	1	225	225.0
BATTERY HEATER MAT	1	180	180.0
CABINET HEATER	1	200	200.0
FLASHER	-	15	-
LED STREET NAME SIGN	-	120	-
LUMINAIRE	-	240	-
TOTAL SERVICE	E WIRE SIZII	NG = 950	0.0

ENERGY COSTS TO:

ILLINOIS DEPARTMENT OF TRANSPORTATION

201 W CENTER COURT SCHAUMBURG, IL 60196-1096

ENERGY SUPPLY: CONTACT: CASSIE EVANS

PHONE: 773-241-0741

COMPANY: COMMONWEALTH EDISON

ACCOUNT NUMBER: \_\_\_ - 7897646000

ATLAS TECHNICAL CONSULTANTS, LLC 100 S. WACKER DRIVE, SUITE 400 CHICAGO, IL 60606

ISER NAME = dbriones	DESIGNED	-	DLB	REVISED	-
	DRAWN	-	JK	REVISED	-
LOT SCALE = 40.000 '/in.	CHECKED	-	DB	REVISED	-
LOT DATE = 7/31/2025	DATE	-	07/31/2025	REVISED	-


STATE OF ILLINOIS **DEPARTMENT OF TRANSPORTATION** 

EXISTING CABLE PLAN, EXISTING PHASE DESIGNATION DIAGRAM AND EMERGENCY VEHICLE PREEMPTION SEQUENCE, AND SCHEDULE OF QUANTITIES IL ROUTE 31 AT SILVER GLEN ROAD SHEET 2 OF 2 SHEETS STA.

SECTION COUNTY 2024-964-TS KANE 89 54 CONTRACT NO. 62W89

# SCHEDULE OF QUANTITIES

ITEM DESCRIPTION	UNITS	TOTAL QTY
MAINTENANCE OF EXISTING TRAFFIC SIGNAL INSTALLATION	EACH	1
ELECTRIC CABLE IN CONDUIT, LEAD-IN, NO. 14 1 PAIR	FOOT	294
INDUCTIVE LOOP DETECTOR	EACH	1
REMOVE EXISTING TRAFFIC SIGNAL EQUIPMENT	EACH	1
REMOVE AND REPLACE BATTERIES FOR UNINTERUPTABLE POWER SUPPLY, EXTENDED	EACH	1
ACCESSIBLE PEDESTRIAN SIGNALS	EACH	2
RE-OPTIMIZE TRAFFIC SIGNAL SYSTEM LEVEL 1	EACH	1

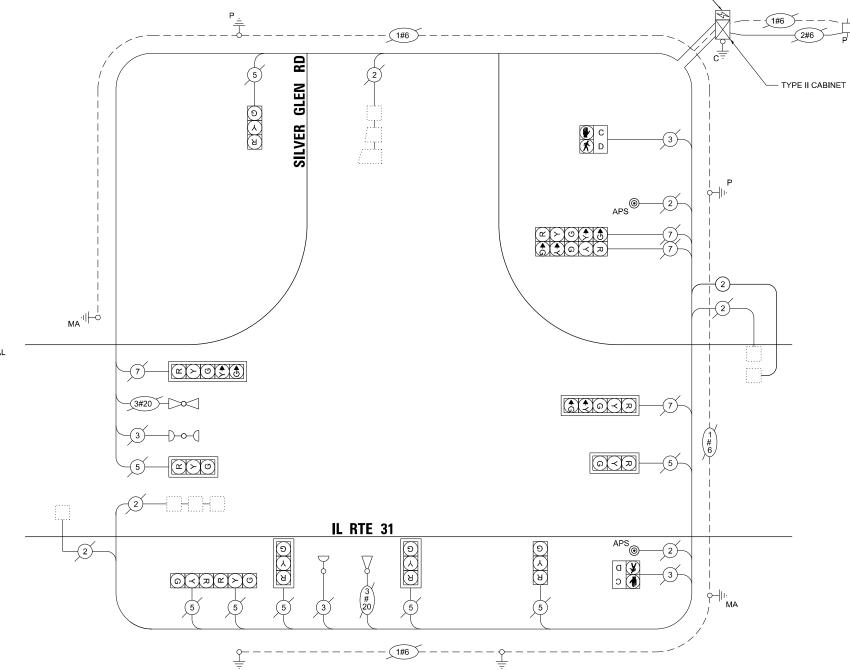

REMOVE AND REPLACE BATTERIES FOR UPS

**CABLE PLAN** 

TS 20323

# **NOTES:** 1. THIS PLAN IS FOR THE INSTALLATION OF APS PUSH BUTTONS AND LEADING PEDESTRIAN INTERVAL PROGRAMMING. 2. ALL PUSH BUTTONS SHALL BE APS. 3. APS SHALL BE PLACED PARALLEL TO THE CORRESPONDING CROSSWALKS. 4. CONTRACTOR SHALL CONFIRM THE FINAL LOCATION OF THE PEDESTRIAN EQUIPMENT WITH THE TRAFFIC SIGNAL ENGINEER BEFORE INSTALLATION. 5. ALL EXISTING TRAFFIC SIGNAL CABLE NO LONGER REQUIRED SHALL BE 6. SIDEWALK TO BE BROUGHT UP TO PROWAG STANDARDS ON A FUTURE CONTRACT. 7. EACH DETECTOR LOOP SHALL HAVE ITS OWN 1" COILABLE NON-METALLIC CONDUIT BETWEEN THE EDGE OF PAVEMENT AND THE ADJACENT HANDHOLE AS SHOWN ON THE PLANS AND AS STATED IN THE TRAFFIC

## **REMOVAL AND RELOCATION NOTES:**

THE FOLLOWING ITEMS SHALL BE REMOVED BY THE CONTRACTOR AND SHALL BE DISPOSED OF BY THEM OUTSIDE THE RIGHT-OF-WAY AT THEIR EXPENSE. THE SALVAGE VALUE OF THE REMOVED EQUIPMENT SHALL BE REFLECTED IN THE CONTRACT BID PRICE.


CONTROLLER (ASC/2C-2100) AND CABINET (TS1) **EACH** COMPLETE

EACH PEDESTRIAN PUSH-BUTTON

EACH

EACH

EX 2"-UC-270'

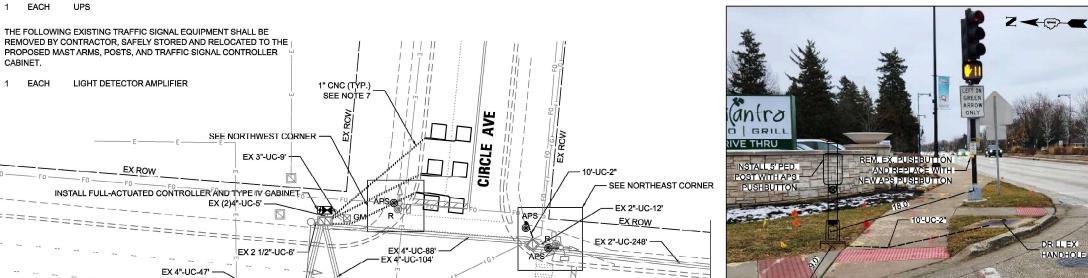

SCALE: 1"=20'

2304

- SEE SOUTHEAST CORNER

NORTHEAST CORNER



SOUTHEAST CORNER

US RTE 20

EX ROW

NORTHWEST CORNER

SCALE IN FEET

TS 4605 ECON 47

CHICAGO II 60606

JSER NAME = dbriones	DESIGNED	-	DLB	REVISED -	•
	DRAWN	×	JK	REVISED -	
PLOT SCALE - 40.000 ' / in.	CHECKED	-	DB	REVISED -	•
PLOT DATE = 7/31/2025	DATE	-	07/31/2025	REVISED -	•

STATE OF ILLINOIS **DEPARTMENT OF TRANSPORTATION** 


2303

- EX 3"-UC-68" 61'-UC-2"

- DRILL EX. HANDHOLE EX 2 1/2"-UC-8'

TRAFFIC SIGNAL INSTALLATION PLAN								
U	8 R(	UTE	20	AT CIRC	LE AVEN	IUE		
SHEET	1	OF	20	SHEETS	STA.		TO STA.	

	F.A.U. RTE.	SECTION	COUNTY	TOTAL SHEETS	SHEE NO.		
	XXX	2024-964-TS	DUPAGE	89	55		
_					CONTRACT	NO. 62V	N89
		ILLINO	S FE	D. Al	D PROJECT		

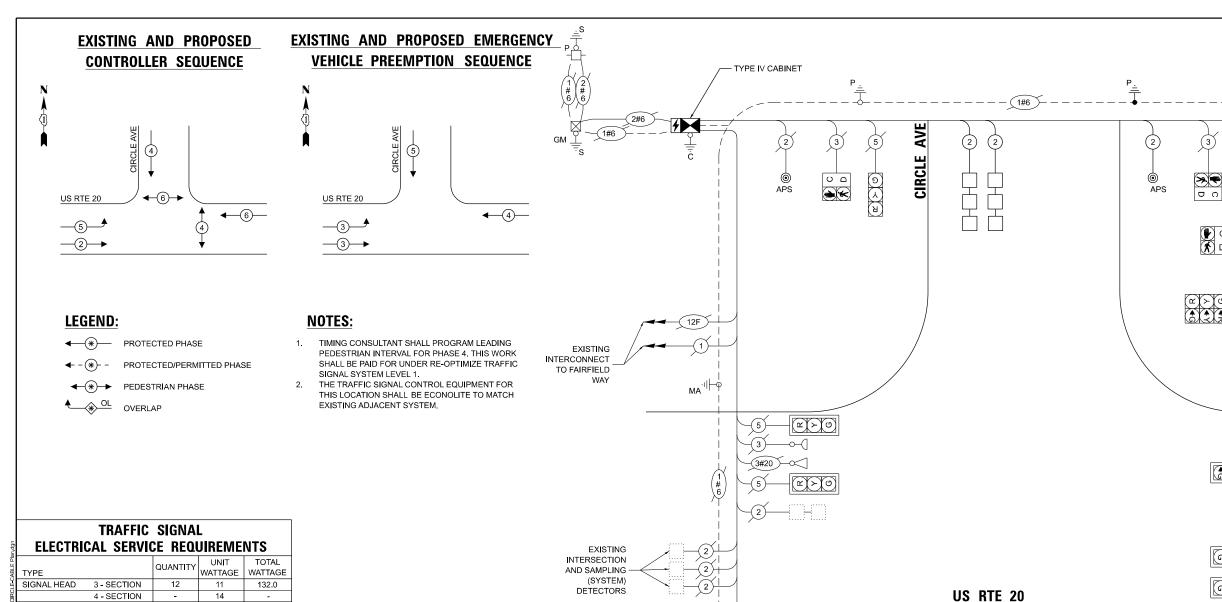

TYPE	QUANTITY	UNIT	TOTAL
	QUANTITY	WATTAGE	WATTAGE
SIGNAL HEAD 3 - SECTION 4 - SECTION 5 - SECTION	12	11	132.0
4 - SECTION	-	14	-
5 - SECTION	-	13	-
PROGRAMMABLE SIGNALS			
3 - SECTION	-	22	-
4 - SECTION	-	32	-
5 - SECTION PED. SIGNAL CONTROLLER MASTER CONTROLLER UPS DETECTION RADAR VIDEO	-	28	-
PED. SIGNAL	4	15	60.0
CONTROLLER	1	150	150.0
MASTER CONTROLLER	-	100	-
UPS	1	25	25.0
DETECTION RADAR	-	20	-
	-	20	-
BLANK-OUT SIGN	-	25	-
NETWORK SWITCH II OR III	-	35	-
CELLULAR MODEM	-	15	-
TOTA UPS CHARGING	L UPS SIZIN	IG = 36	7.0
UPS CHARGING	1	225	225.0
	1	180	180.0
CABINET HEATER FLASHER	1	200	200.0
FLASHER	-	15	-
LED STREET NAME SIGN	-	120	-
LUMINAIRE	-	240	-
TOTAL SERVICE	E WIRE SIZI	NG = 972	2.0

ENERGY COSTS TO: VILLAGE OF BLOOMINGDALE 201 S BLOOMINGDALE RD BLOOMINGDALE, IL 60108

ENERGY SUPPLY: CONTACT: ANTONIO RIOS

PHONE:_	630-696-6855	
COMPANY:_	COMMONWEALTH EDISON	
ACCOUNT NUMBER: _	- 0687629000	

SCHEDULE OF QUANTITIES		``
ITEM DESCRIPTION	UNITS	TOTAL QTY
UNDERGROUND CONDUIT, GALVANIZED STEEL, 2" DIA.	FOOT	71
MAINTENANCE OF EXISTING TRAFFIC SIGNAL INSTALLATION	EACH	1
ELECTRIC CABLE IN CONDUIT, SIGNAL NO. 14 2C	FOOT	321
ELECTRIC CABLE IN CONDUIT, LEAD-IN, NO. 14 1 PAIR	FOOT	198
ELECTRIC CABLE IN CONDUIT, EQUIPMENT GROUNDING CONDUCTOR, NO. 6 1C	FOOT	112
DRILL EXISTING HANDHOLE	EACH	2
INDUCTIVE LOOP DETECTOR	EACH	2
DETECTOR LOOP, TYPE I	FOOT	194
RELOCATE EXISTING EMERGENCY VEHICLE PRIORITY SYSTEM, PHASING UNIT	EACH	1
REMOVE ELECTRIC CABLE FROM CONDUIT	FOOT	180
REMOVE EXISTING TRAFFIC SIGNAL EQUIPMENT	EACH	1
UNINTERRUPTABLE POWER SUPPLY AND CABINET, SPECIAL	EACH	1
PEDESTRIAN SIGNAL POST, 5 FT.	EACH	2
PAINT NEW PEDESTRIAN PUSH-BUTTON POST	EACH	2
FULL-ACTUATED CONTROLLER AND TYPE IV CABINET (SPECIAL)	EACH	1
ACCESSIBLE PEDESTRIAN SIGNALS	EACH	4
CONCRETE FOUNDATION, TYPE A 12-INCH DIAMETER	FOOT	8
RE-OPTIMIZE TRAFFIC SIGNAL SYSTEM LEVEL 1	EACH	1

CABLE PLAN

- <u>o</u> 1#6

TS 4605 ECON 47

EXISTING INTERCONNECT

**EXISTING** INTERCONNECT

AND SAMPLING (SYSTEM) DETECTORS

TO EUCLID DR / LAKEVIEW DR



ISER NAME = dbriones	DESIGNED	-	DLB	REVISED	-
	DRAWN	-	JK	REVISED	-
LOT SCALE = 40.000 '/in.	CHECKED	-	DB	REVISED	-
LOT DATE = 7/31/2025	DATE	-	07/31/2025	REVISED	-

STATE OF ILLINOIS **DEPARTMENT OF TRANSPORTATION** 

EXISTING C	ABLE PLA	AN, I	EXISTI	NG	PHASE	DESIG	NATION DIAGRAM AND	F.
EMERGENCY VE							SCHEDULE OF QUANTITIES	Х
US ROUTE 20 AT CIRCLE AVENUE								
SCALE: N.T.S.	SHEET	2	OF	2	SHEETS	STA.	TO STA.	

(Z)

(a) < (72)

	F.A.U. RTE	SECTION		COUNTY	TOTAL SHEETS	SHEET NO.		
ES	XXX	2024-964-TS		DUPAGE 89 56				
				CONTRACT	NO. 62\	V89		
		ILLINOIS	FED. Al	D PROJECT				

- 1. THIS PLAN IS FOR THE INSTALLATION OF APS PUSH BUTTONS AND LEADING PEDESTRIAN INTERVAL PROGRAMMING.
- 2. ALL PUSH BUTTONS SHALL BE APS.
- 3. APS SHALL BE PLACED PARALLEL TO THE CORRESPONDING
- 4. CONTRACTOR SHALL CONFIRM THE FINAL LOCATION OF THE PEDESTRIAN EQUIPMENT WITH THE TRAFFIC SIGNAL ENGINEER BEFORE INSTALLATION.
- 5. ALL EXISTING TRAFFIC SIGNAL CABLE NO LONGER REQUIRED SHALL BE
- 6. SIDEWALK TO BE BROUGHT UP TO PROWAG STANDARDS ON A FUTURE CONTRACT.
- 7. THE GROUND MOUNTED, METERED SERVICE SHALL BE CONSTRUCTED ADJACENT TO THE EXISTING SERVICE CONDUIT PRIOR TO DISCONNECTING THE EXISTING SERVICE. INCLUDE A 5' STUB OF 2" CONDUIT FROM THE GM FOR FUTURE CONNECTION. THE COST OF THE 5' STUB, 2" UNDERGROUND CONDUIT AND SPLICE TO EXISTING SERVICE CONDUIT SHALL BE INCLUDED IN THE COST OF CONCRETE FOUNDATION, TYPE A. THE TRAFFIC SIGNALS SHALL REMAIN OPERATIONAL THE ENTIRE TIME THE SWITCH OVER BETWEEN EXISTING SERVICE AND PROPOSED SERVICE IS MADE.


#### **REMOVAL AND RELOCATION NOTES:**

THE FOLLOWING ITEMS SHALL BE REMOVED BY THE CONTRACTOR AND SHALL BE DISPOSED OF BY THEM OUTSIDE THE RIGHT-OF-WAY AT THEIR EXPENSE. THE SALVAGE VALUE OF THE REMOVED EQUIPMENT SHALL BE REFLECTED IN THE CONTRACT BID PRICE.

PEDESTRIAN PUSH-BUTTON EACH PEDESTRIAN POST EACH EACH SERVICE INSTALLATION

THE FOLLOWING EXISTING TRAFFIC SIGNAL EQUIPMENT SHALL BE REMOVED BY THE CONTRACTOR AND SHALL BE RELOCATED TO THE PROPOSED TRAFFIC SIGNAL EQUIPMENT INDICATED IN THE PLAN.

EACH PEDESTRIAN SIGNAL HEAD

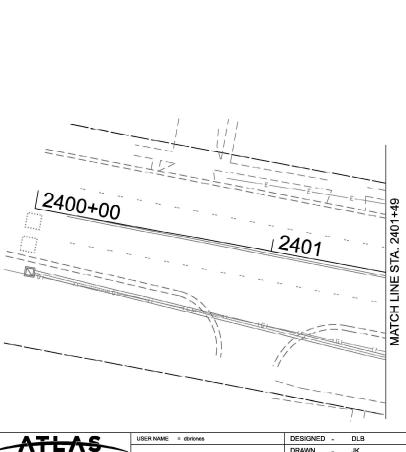


PLOT SCALE - 40.000 '/ in.

PLOT DATE = 7/31/2025

CHECKED -

DB

07/31/2025

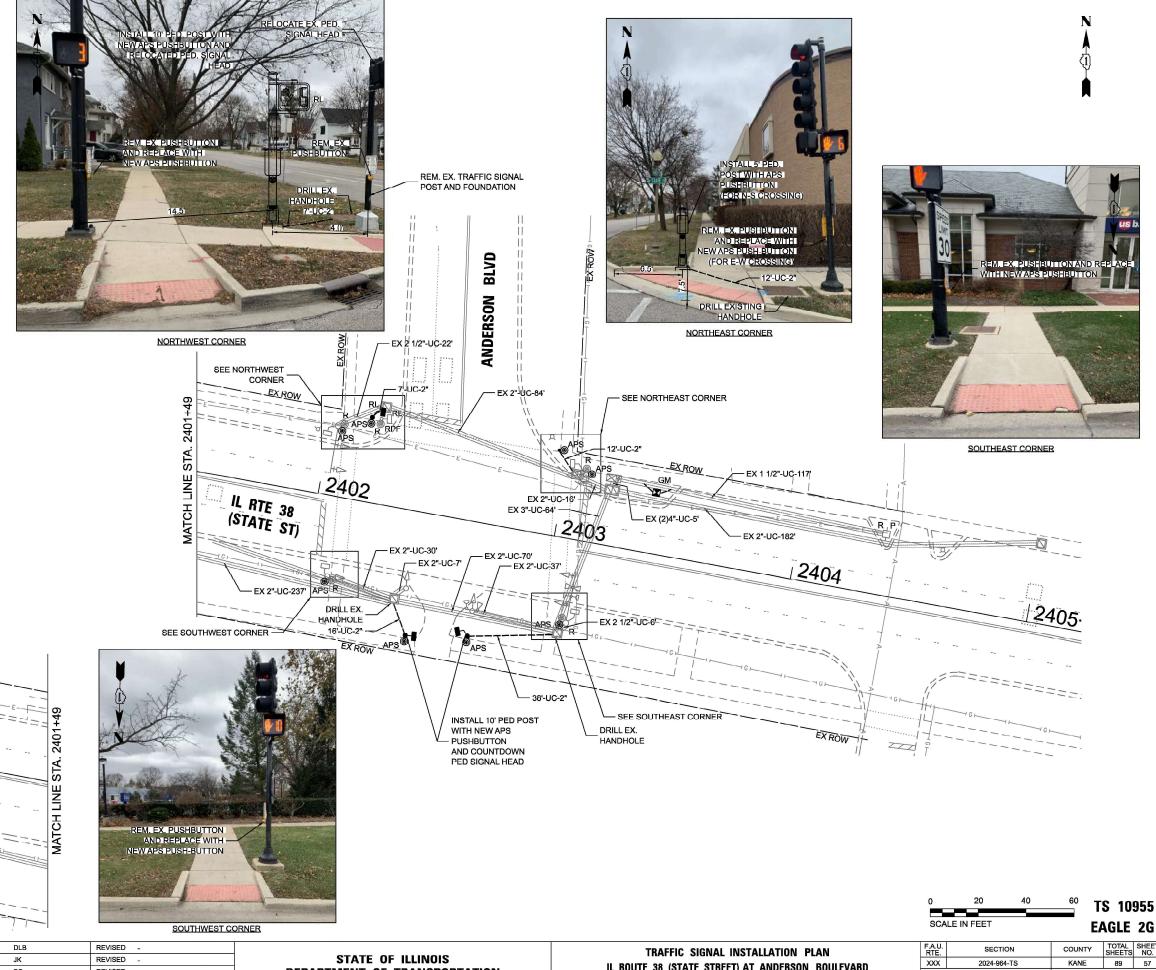

2024-964-TS

IL ROUTE 38 (STATE STREET) AT ANDERSON BOULEVARD

SHEET 1 OF 2 SHEETS STA.

SCALE: 1"=20'

KANE

CONTRACT NO. 62W89


STATE OF ILLINOIS

**DEPARTMENT OF TRANSPORTATION** 

REVISED

REVISED

REVISED

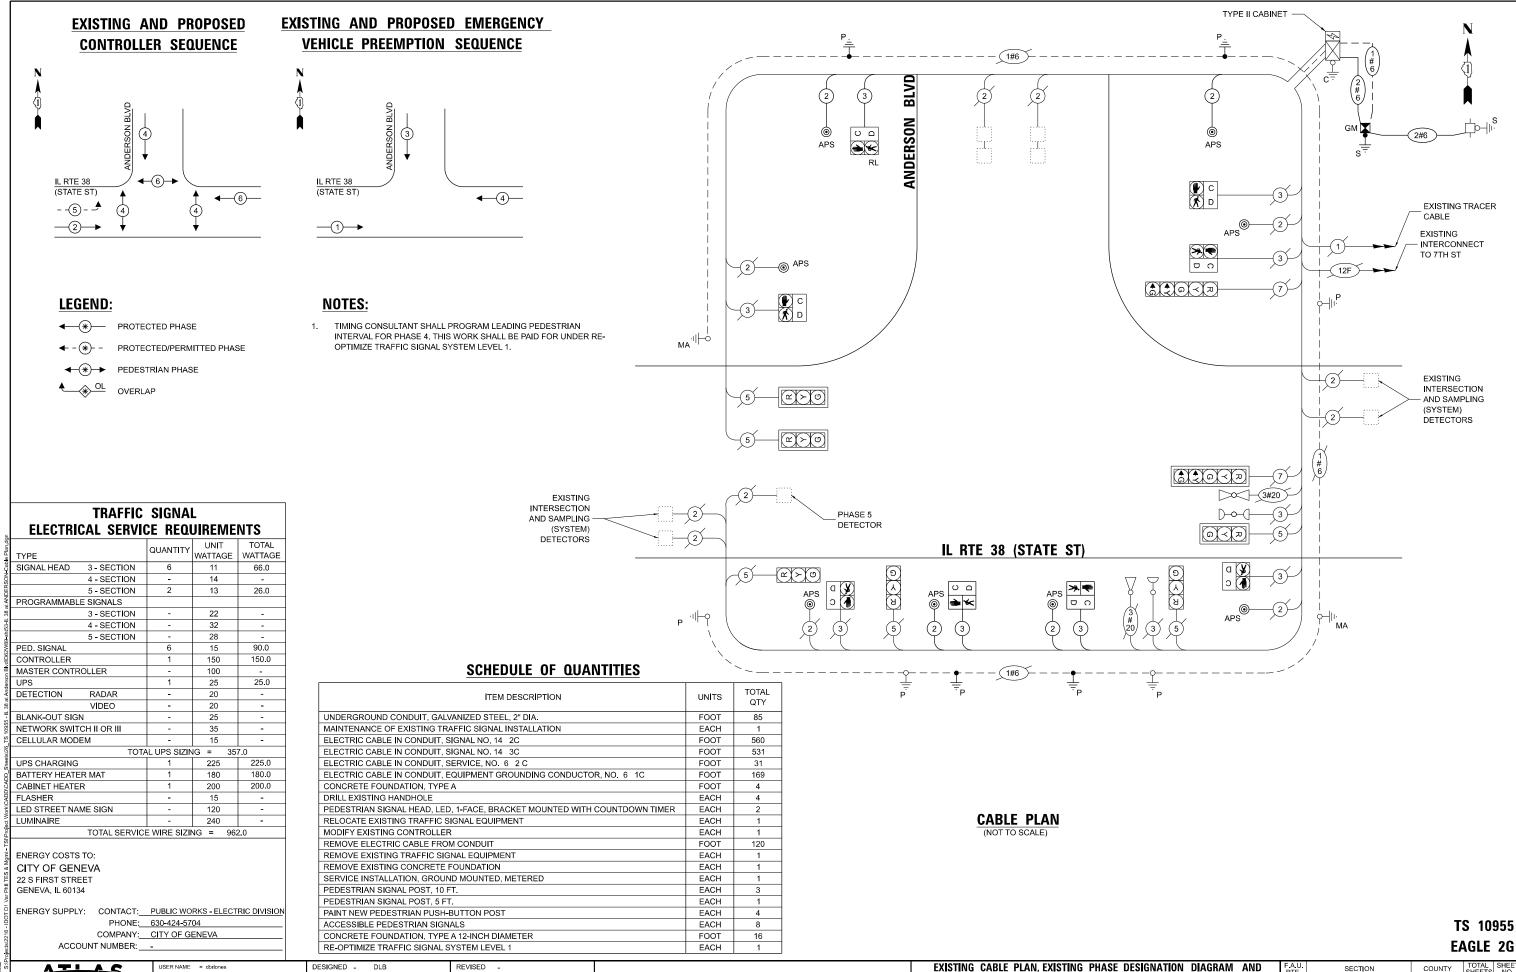

STATE OF ILLINOIS

**DEPARTMENT OF TRANSPORTATION** 

EMERGENCY VEHICLE PREEMPTION SEQUENCE, AND SCHEDULE OF QUANTITIES

IL ROUTE 38 (STATE STREET) AT ANDERSON BOULEVARD

SHEET 2 OF 2 SHEETS STA.

2024-964-TS

KANE 89 58

CONTRACT NO. 62W89

AODEL: Default

TLAS TECHNICAL CONSULTANTS, LLC

100 S. WACKER DRIVE, SUITE 400 CHICAGO, IL 60606

PLOT DATE = 7/31/2025

DRAWN - JK


DB

- 07/31/2025

REVISED -

REVISED

REVISED .

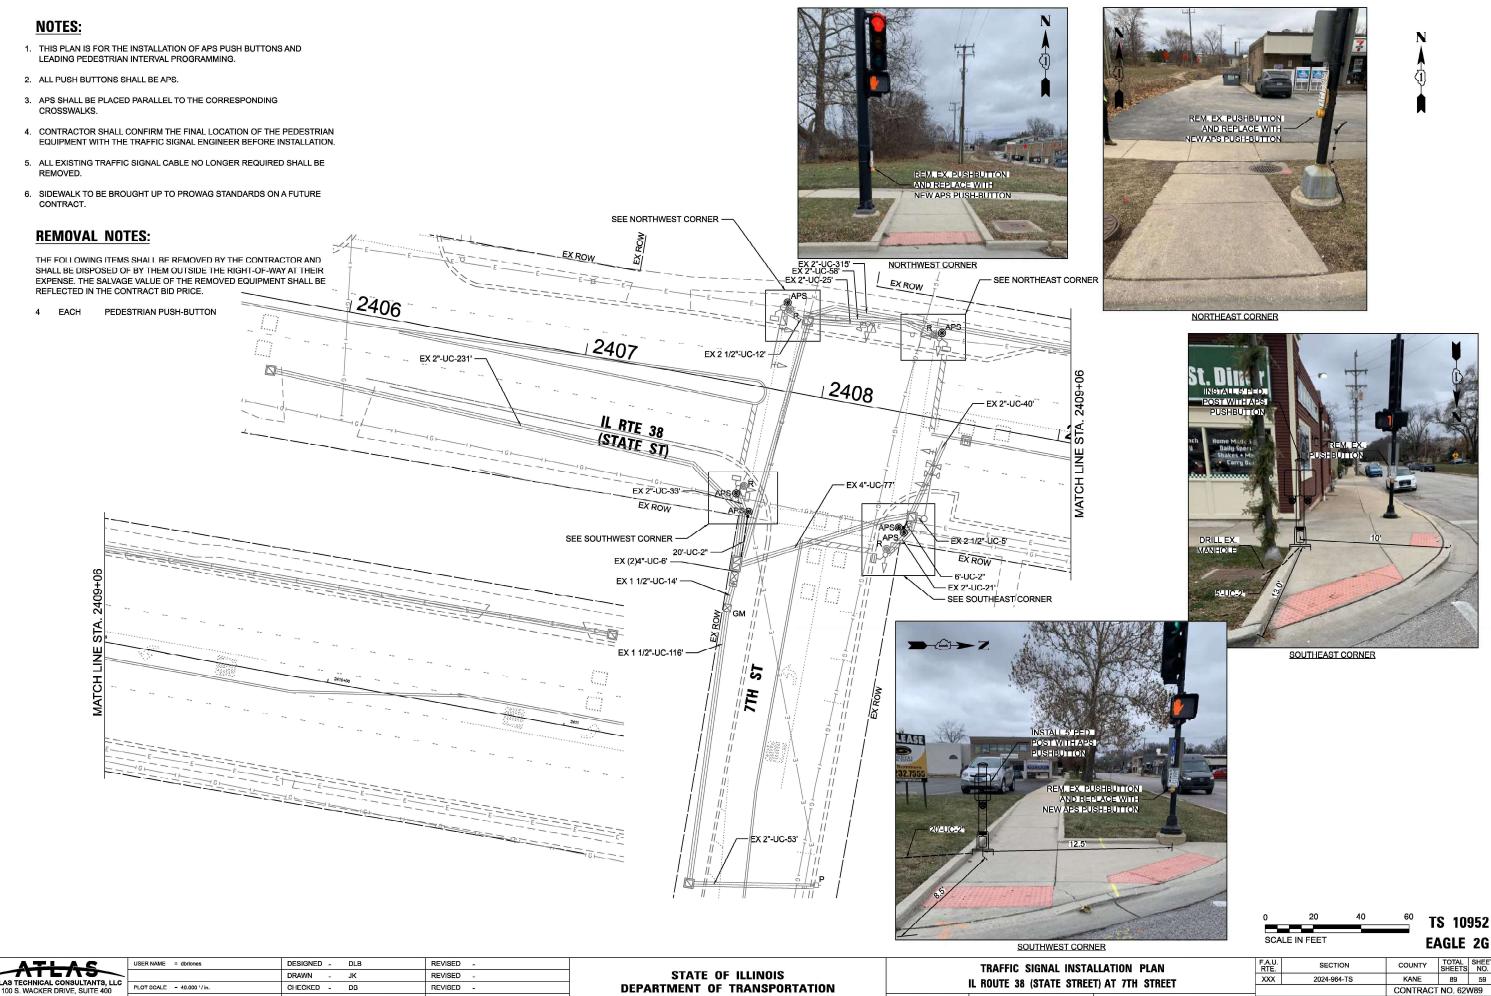

CHICAGO, IL 60606


PLOT SCALE - 40.000 '/ in. CHECKED -DB REVISED PLOT DATE = 7/31/2025 DATE 07/31/2025 REVISED

**DEPARTMENT OF TRANSPORTATION** 

SHEET 1 OF 2 SHEETS STA.

SCALE: 1"=20'

TOTAL SHEET NO. 89 59 CONTRACT NO. 62W89

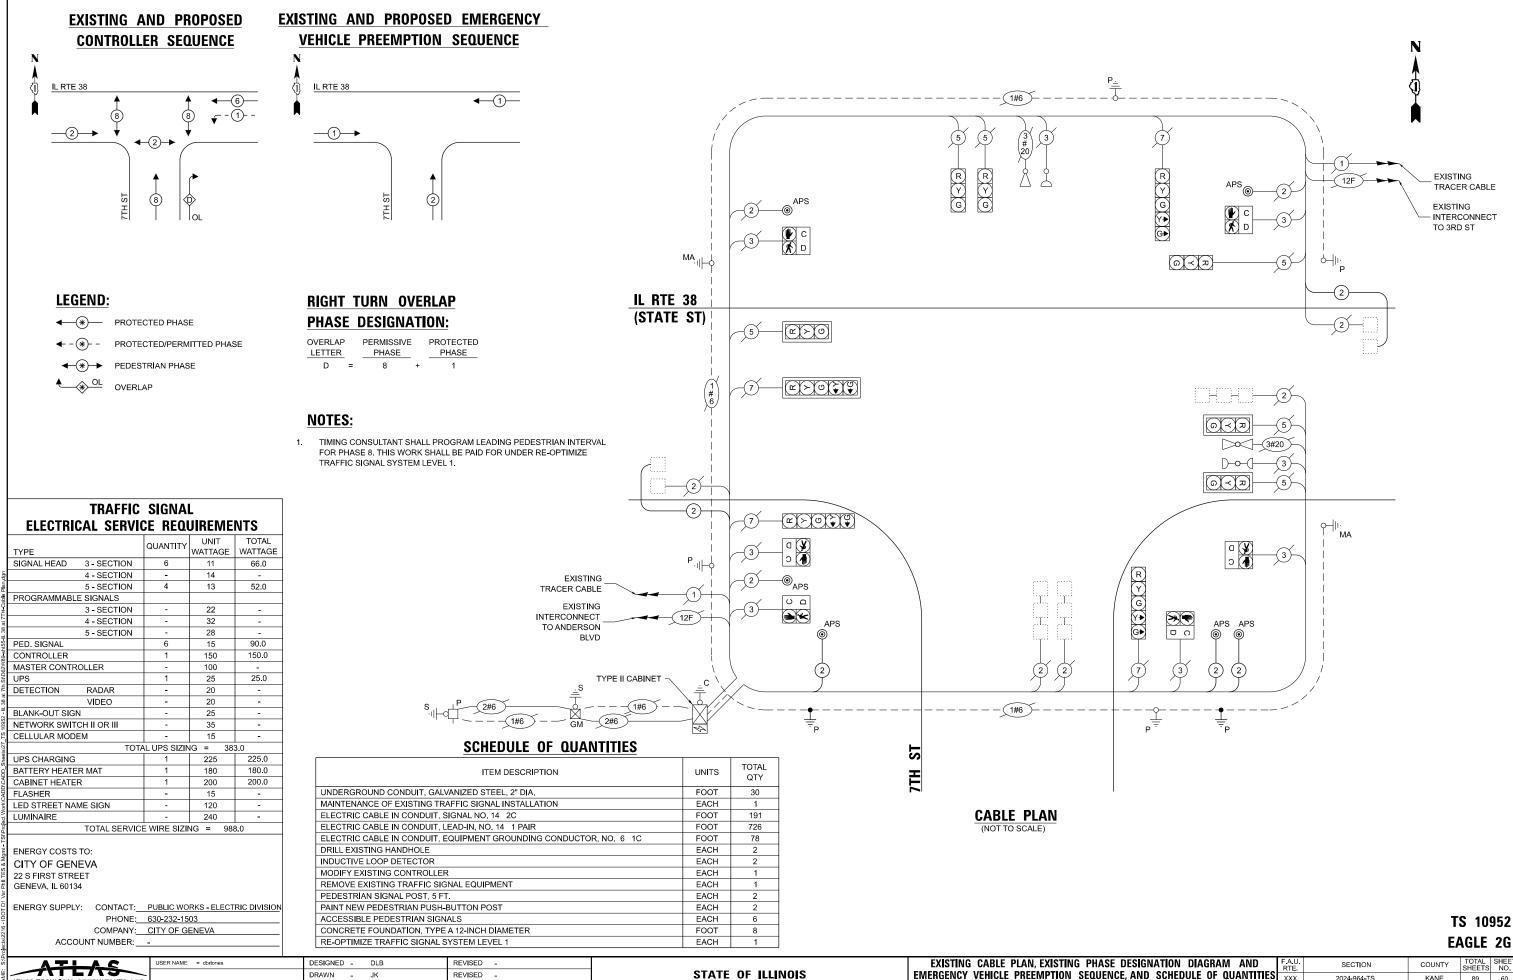

**DEPARTMENT OF TRANSPORTATION** 

2024-964-TS

IL RTE 38 (STATE ST) AT 7TH ST

SHEET 2 OF 2 SHEETS STA.

KANE 89 60

CONTRACT NO. 62W89

TLAS TECHNICAL CONSULTANTS, LLC

100 S. WACKER DRIVE, SUITE 400 CHICAGO, IL 60606


PLOT DATE = 7/31/2025

CHECKED - DB

DATE - 07/31/2025

REVISED

REVISED -

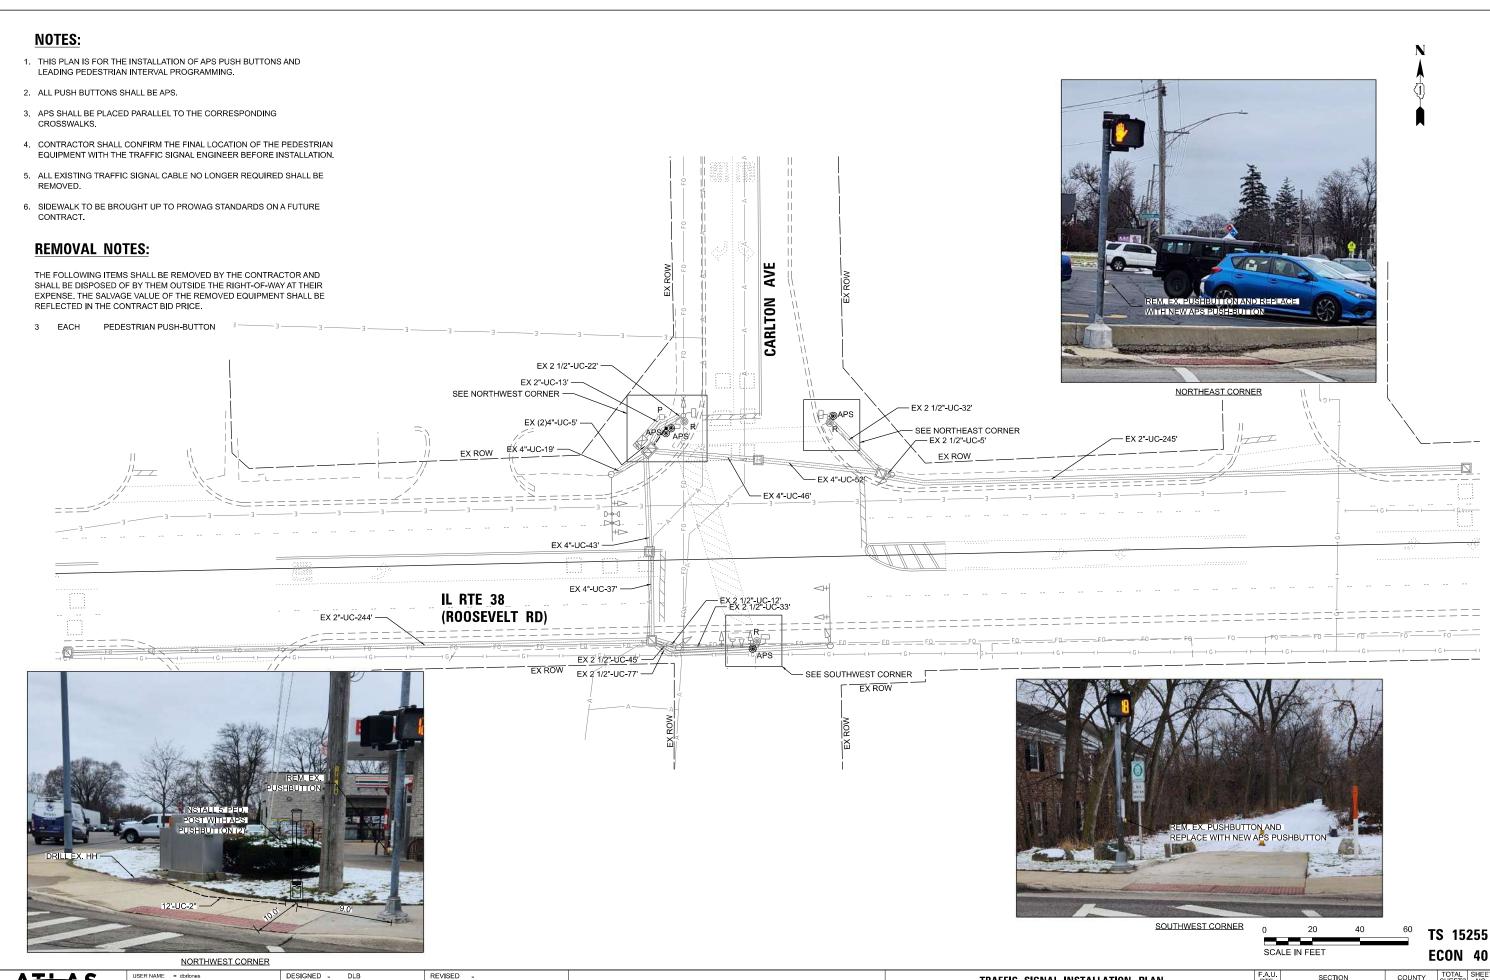

MODEL: Detault FILE NAME: S:/Projecti

ATLAS TECHNICAL CONSULTANTS, LLC
100 S. WACKER DRIVE, SUITE 400
CHICAGO, IL 60606


STATE OF ILLINOIS
DEPARTMENT OF TRANSPORTATION

TRAFFIC SIGNAL INSTALLATION PLAN

IL ROUTE 38 (ROOSEVELT ROAD) AT CARLTON AVENUE

SHEET 1 OF 20 SHEETS STA. TO STA.

SCALE: 1"=20'

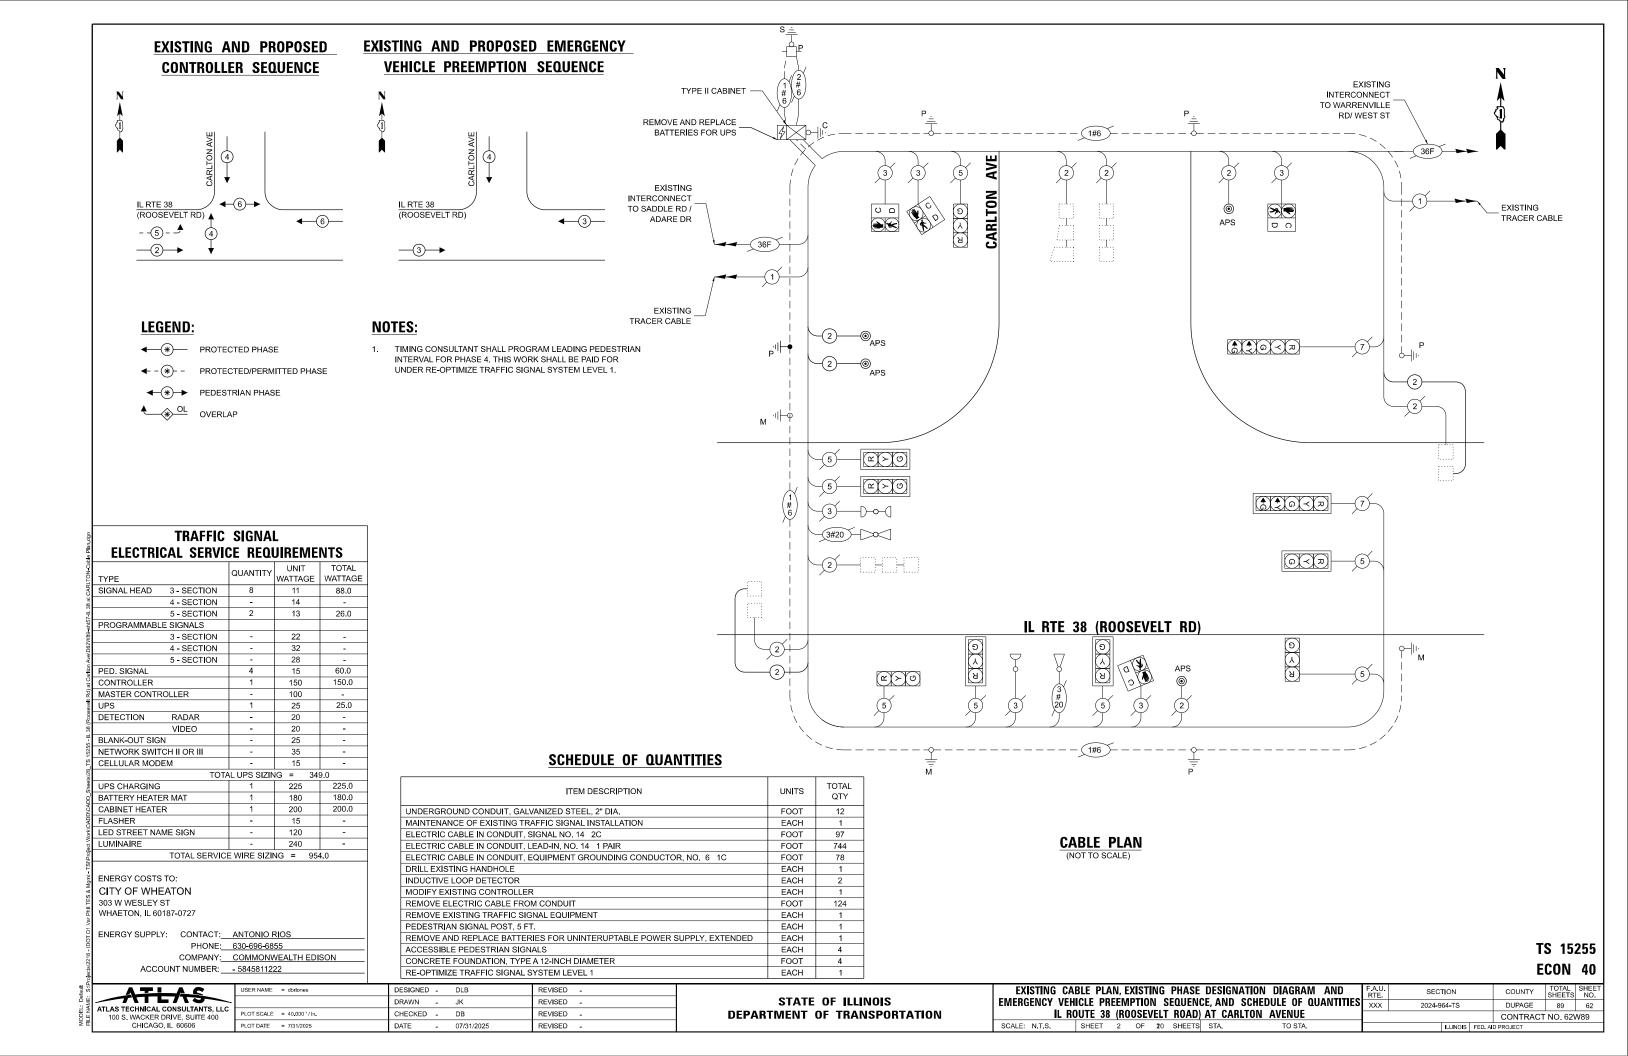


- 1. THIS PLAN IS FOR THE INSTALLATION OF APS PUSH BUTTONS AND LEADING PEDESTRIAN INTERVAL PROGRAMMING.
- 2. ALL PUSH BUTTONS SHALL BE APS.
- 3. APS SHALL BE PLACED PARALLEL TO THE CORRESPONDING CROSSWALKS.
- 4. CONTRACTOR SHALL CONFIRM THE FINAL LOCATION OF THE PEDESTRIAN EQUIPMENT WITH THE TRAFFIC SIGNAL ENGINEER BEFORE INSTALLATION.
- 5. ALL EXISTING TRAFFIC SIGNAL CABLE NO LONGER REQUIRED SHALL BE
- 6. SIDEWALK TO BE BROUGHT UP TO PROWAG STANDARDS ON A FUTURE CONTRACT.
- 7. THE GROUND MOUNTED, METERED SERVICE SHALL BE CONSTRUCTED ADJACENT TO THE EXISTING SERVICE CONDUIT PRIOR TO DISCONNECTING THE EXISTING SERVICE. INCLUDE A 5' STUB OF 2" CONDUIT FROM THE GM FOR FUTURE CONNECTION. THE COST OF THE 5' STUB, 2" UNDERGROUND CONDUIT AND SPLICE TO EXISTING SERVICE CONDUIT SHALL BE INCLUDED IN THE COST OF CONCRETE FOUNDATION. TYPE A. THE TRAFFIC SIGNALS SHALL REMAIN OPERATIONAL THE ENTIRE TIME THE SWITCH OVER BETWEEN EXISTING SERVICE AND PROPOSED SERVICE IS MADE.

#### **REMOVAL NOTES:**

THE FOLLOWING ITEMS SHALL BE REMOVED BY THE CONTRACTOR AND SHALL BE DISPOSED OF BY THEM OUTSIDE THE RIGHT-OF-WAY AT THEIR EXPENSE. THE SALVAGE VALUE OF THE REMOVED EQUIPMENT SHALL BE REFLECTED IN THE CONTRACT BIT DESCRI REFLECTED IN THE CONTRACT BID PRICE.

PEDESTRIAN PUSH-BUTTON 4 EACH EACH

SERVICE INSTALLATION

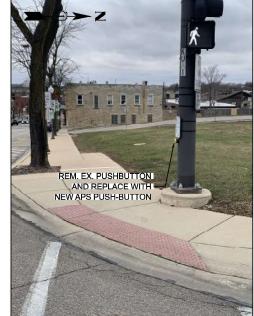

- SEE NORTHEAST CORNER

- EX 4"-UC-85'

2707

AND REPLACE WITH NEW APS PUSH-BUTTON

SOUTHEAST CORNER

NORTHEAST CORNER

SCALE IN FEET

ECON 26 TOTAL SHEET NO. 89 63 SECTION COUNTY 2024-964-TS KANE

TS 785

NORTHWEST CORNER - EX 2"-UC-222' 2708







(WILSON ST) EX 2 1/2"-UC-12"

EX 2"-UC-79' —

EX 2"-UC-139'

EX 3"-UC-40"

SEE NORTHWEST CORNER -

EX 2"-UC-272' -SEE SOUTHEAST CORNER

WASHINGTON AV

川

- EX 4"-UC-99'

- EX 3"-UC-37'


CHICAGO, IL 60606

SER NAME	= dbriones	DESIGNED	-	DLB	REVISED -	Ī
		DRAWN	×	JK	REVISED -	
OT SCALE	- 40.000 ' / in.	CHECKED	-	DB	REVISED -	
OT DATE	= 7/31/2025	DATE	-	07/31/2025	REVISED -	

STATE OF ILLINOIS **DEPARTMENT OF TRANSPORTATION** 

	TRAFF	IC SIGNAL	<b>INSTALLATIO</b>	N PLAN	F.
IL ROUTE 25	(WILSON	STREET) AT	IL ROUTE 25	(WASHINGTON AVENUE)	х
			0		$\neg$

CONTRACT NO. 62W89

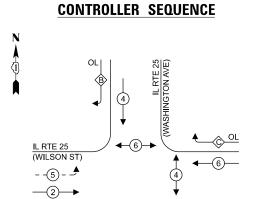

**LEGEND:** 

**←**(\*)**→** 

TYPF

SIGNAL HEAD

PED. SIGNAL

CONTROLLER

DETECTION

BLANK-OUT SIGN

CELLULAR MODEM

BATTERY HEATER MAT

LED STREET NAME SIGN

UPS CHARGING

CABINET HEATER

ENERGY COSTS TO: CITY OF BATAVIA 100 N ISLAND AVE BATAVIA, IL 60510

FLASHER

LUMINAIRE

UPS

MASTER CONTROLLER

NETWORK SWITCH II OR III

PROGRAMMABLE SIGNALS

OL OVERLAP

3 - SECTION

4 - SECTION

5 - SECTION

3 - SECTION

4 - SECTION

5 - SECTION

RADAR

VIDEO

**★**PROTECTED PHASE

PROTECTED/PERMITTED PHASE

PEDESTRIAN PHASE


TRAFFIC SIGNAL

**ELECTRICAL SERVICE REQUIREMENTS** 

QUANTITY

**EXISTING AND PROPOSED** 

#### **EXISTING AND PROPOSED EMERGENCY VEHICLE PREEMPTION SEQUENCE**

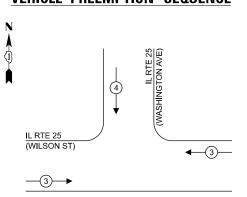



APS 🞯-

# RIGHT TURN OVERLAP

OVERLAP		PERMISSI\	/E	PROTECTED	
LETTER		PHASE		PHASE	
В	=	4	+	5	
С	=	4	+	6	

BE PAID FOR UNDER RE-OPTIMIZE TRAFFIC SIGNAL SYSTEM LEVEL 1.

# **PHASE DESIGNATION:**

OVERLAP		PERMISSIVE		PROTECTED	
LETTER	2	PHASE		PHAS	βE
В	=	4	+	5	
С	=	4	+	6	

#### **NOTES:**

TOTAL

55.0

78.0

60.0

150.0

25.0

225.0

180.0

200.0

WATTAGE WATTAGE

UNIT

13

22

32 28

15

150

100

25

20

20

25

35

15

225

180

200

15

120

240


TOTAL UPS SIZING =

TOTAL SERVICE WIRE SIZING = 973.0

ENERGY SUPPLY: CONTACT: <u>UTILITY BILLING DEPARTMENT</u> PHONE: 630-454-2020

COMPANY: CITY OF BATAVIA

TIMING CONSULTANT SHALL PROGRAM LEADING PEDESTRIAN INTERVAL FOR PHASE 4. THIS WORK SHALL

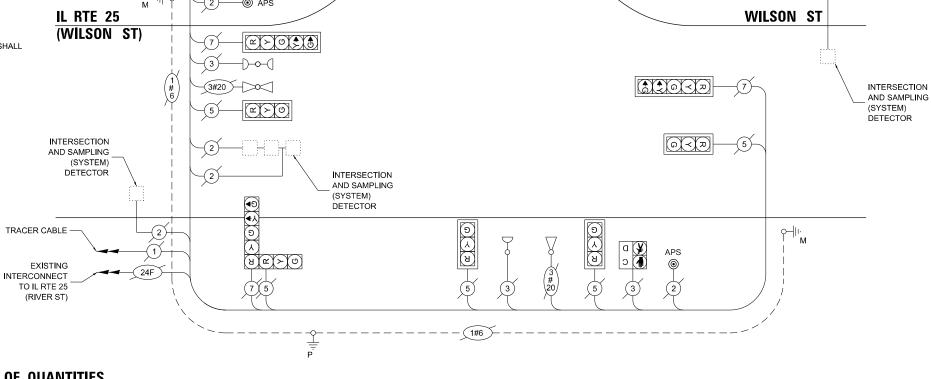

IL RTE 25 (WASHINGTON AVE)

#### SCHEDULE OF QUANTITIES

TYPE II CABINET

REMOVE AND REPLACE

BATTERIES FOR UPS

ITEM DESCRIPTION	UNITS	TOTAL QTY
MAINTENANCE OF EXISTING TRAFFIC SIGNAL INSTALLATION	EACH	1
ELECTRIC CABLE IN CONDUIT, SERVICE, NO. 6 2 C	FOOT	36
CONCRETE FOUNDATION, TYPE A	FOOT	4
REMOVE ELECTRIC CABLE FROM CONDUIT	FOOT	165
REMOVE EXISTING TRAFFIC SIGNAL EQUIPMENT	EACH	1
SERVICE INSTALLATION, GROUND MOUNTED, METERED	EACH	1
REMOVE AND REPLACE BATTERIES FOR UNINTERUPTABLE POWER SUPPLY, EXTENDED	EACH	1
ACCESSIBLE PEDESTRIAN SIGNALS	EACH	4
RE-OPTIMIZE TRAFFIC SIGNAL SYSTEM LEVEL 1	EACH	1

**CABLE PLAN** 

ATLAS TECHNICAL CONSULTANTS, LLC 100 S. WACKER DRIVE, SUITE 400 CHICAGO, IL 60606

ACCOUNT NUMBER:


SER NAME = dbriones	DESIGNED	-	DLB	REVISED	-
	DRAWN	-	JK	REVISED	-
LOT SCALE = 40.000 '/in.	CHECKED	-	DB	REVISED	-
LOT DATE = 7/31/2025	DATE	-	07/31/2025	REVISED	-

STATE OF ILLINOIS **DEPARTMENT OF TRANSPORTATION** 

			NATION DIAGRAM AND	F.A RT
			SCHEDULE OF QUANTITIES	XX
IL ROUTE 25	(WILSON STREET)	) AT IL ROUTE 25	(WASHINGTON AVENUE)	
SCALE: N.T.S.	SHEET 2 OF	2 SHEETS STA.	TO STA.	

				E	CON	26
F.A.U. RTE	SEC.	TION		COUNTY	TOTAL SHEETS	SHEET NO.
XXX	2024-9	2024-964-TS			89	64
			CONTRACT NO. 62W89			
		ILLINOIS	FED. AID PROJECT			


TS 785

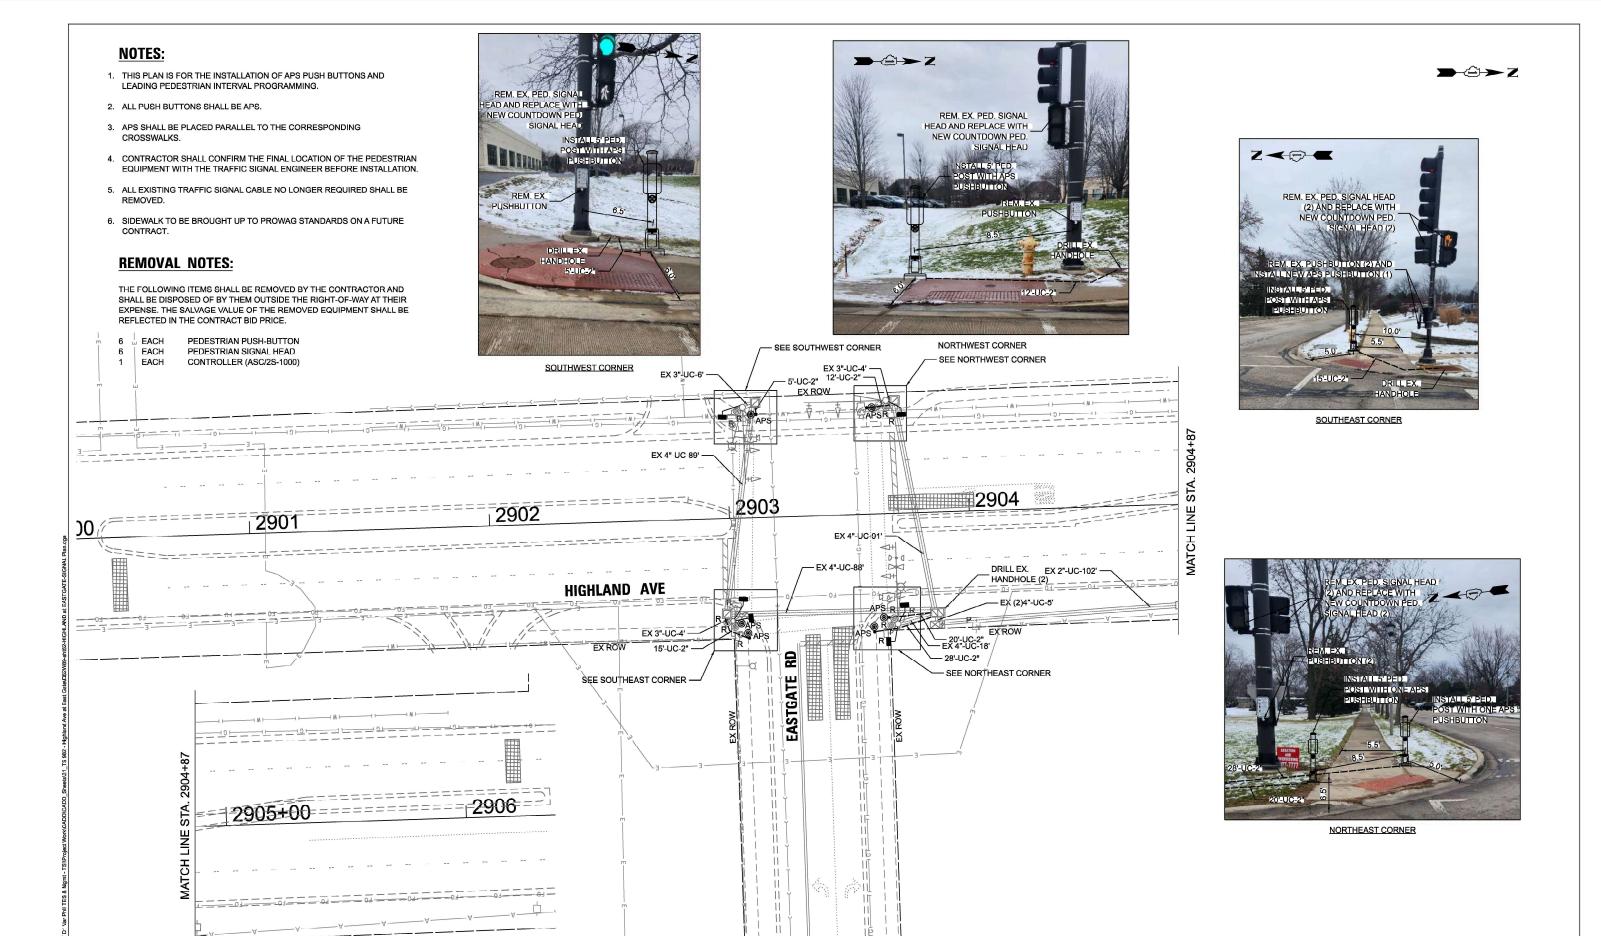

SCALE IN FEET TS 982 TOTAL SHEET NO. 89 65 DESIGNED - DLB REVISED -USER NAME = dbriones SECTION COUNTY TRAFFIC SIGNAL INSTALLATION PLAN STATE OF ILLINOIS DRAWN REVISED 2024-964-TS DUPAGE AS TECHNICAL CONSULTANTS, LLC 100 S. WACKER DRIVE, SUITE 400 HIGHLAND AVENUE AT EASTGATE ROAD CHECKED -DB REVISED **DEPARTMENT OF TRANSPORTATION** PLOT SCALE - 40.000 ' / in. CONTRACT NO. 62W89 SHEET 1 OF 2 SHEETS STA. SCALE: 1"=20' CHICAGO, IL 60606 PLOT DATE = 7/31/2025 DATE 07/31/2025 REVISED



#### **→**⊕→Z

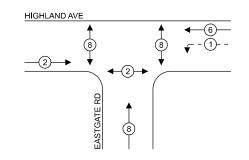

#### LEGEND:

**★**PROTECTED PHASE

PROTECTED/PERMITTED PHASE

PEDESTRIAN PHASE

♦ OL OVERLAP

#### TRAFFIC SIGNAL **ELECTRICAL SERVICE REQUIREMENTS** CHANTITY UNIT TOTAL

TYPE	QUANTITY	WATTAGE	WATTAGE
SIGNAL HEAD 3 - SECTION	7	11	77.0
4 - SECTION	-	14	-
5 - SECTION	2	13	26.0
PROGRAMMABLE SIGNALS			
3 - SECTION	-	22	-
4 - SECTION	-	32	-
5 - SECTION	-	28	-
PED. SIGNAL	6	15	90.0
CONTROLLER	1	150	150.0
MASTER CONTROLLER	-	100	-
UPS	1	25	25.0
DETECTION RADAR	-	20	-
VIDEO	2	20	40.0
BLANK-OUT SIGN	-	25	-
NETWORK SWITCH II OR III	-	35	-
CELLULAR MODEM	-	15	-
TOTA	L UPS SIZIN	IG = 40	8.0
UPS CHARGING	1	225	225.0
BATTERY HEATER MAT	1	180	180.0
CABINET HEATER	1	200	200.0
FLASHER	-	15	-
LED STREET NAME SIGN	-	120	-
LUMINAIRE	2	240	480.0
TOTAL SERVICE	E WIRE SIZI	NG = 149	93.0
II .			

ENERGY COSTS TO:

ILLINOIS DEPARTMENT OF TRANSPORTATION

201 W CENTER COURT SCHAUMBURG, IL 60196-1096

ENERGY SUPPLY: CONTACT: ANTONIO RIOS PHONE: 630-696-6855 COMPANY: COMMONWEALTH EDISON

ACCOUNT NUMBER:

TLAS TECHNICAL CONSULTANTS, LLC

#### DESIGNED - DLB REVISED -DRAWN - JK REVISED -DB REVISED PLOT DATE = 7/31/2025 DATE - 07/31/2025 REVISED -

CONCRETE FOUNDATION, TYPE A 12-INCH DIAMETER

RE-OPTIMIZE TRAFFIC SIGNAL SYSTEM LEVEL 1

**EXISTING AND PROPOSED EMERGENCY** 

STATE OF ILLINOIS **DEPARTMENT OF TRANSPORTATION** 

FOOT


EACH

20


EXISTING CABLE PLAN. EXISTING PHASE DESIGNATION DIAGRAM AND EMERGENCY VEHICLE PREEMPTION SEQUENCE, AND SCHEDULE OF QUANTITIES HIGHLAND AVENUE AT EASTGATE ROAD SHEET 2 OF 2 SHEETS STA.

SECTION COUNTY 2024-964-TS DUPAGE 89 66 CONTRACT NO. 62W89


TS 982

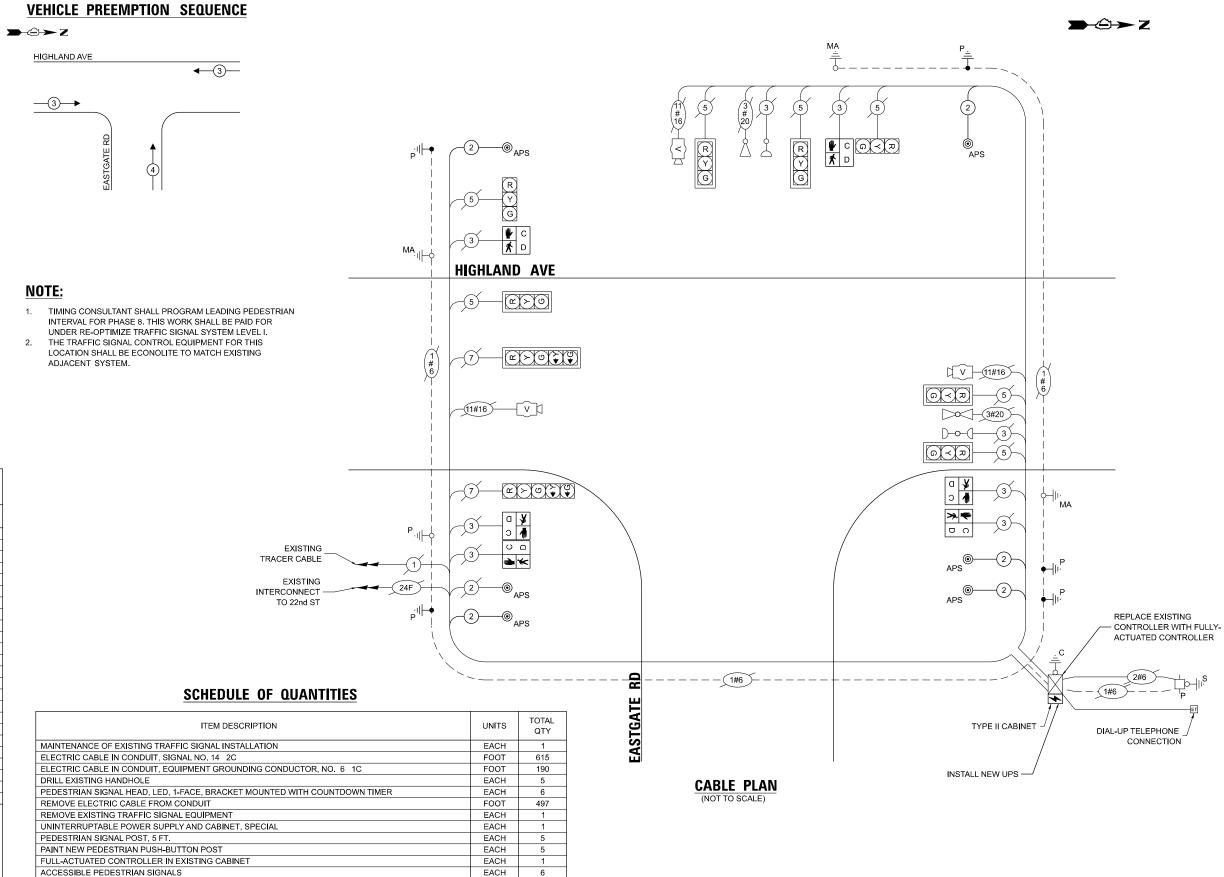

100 S. WACKER DRIVE, SUITE 400 CHICAGO, IL 60606

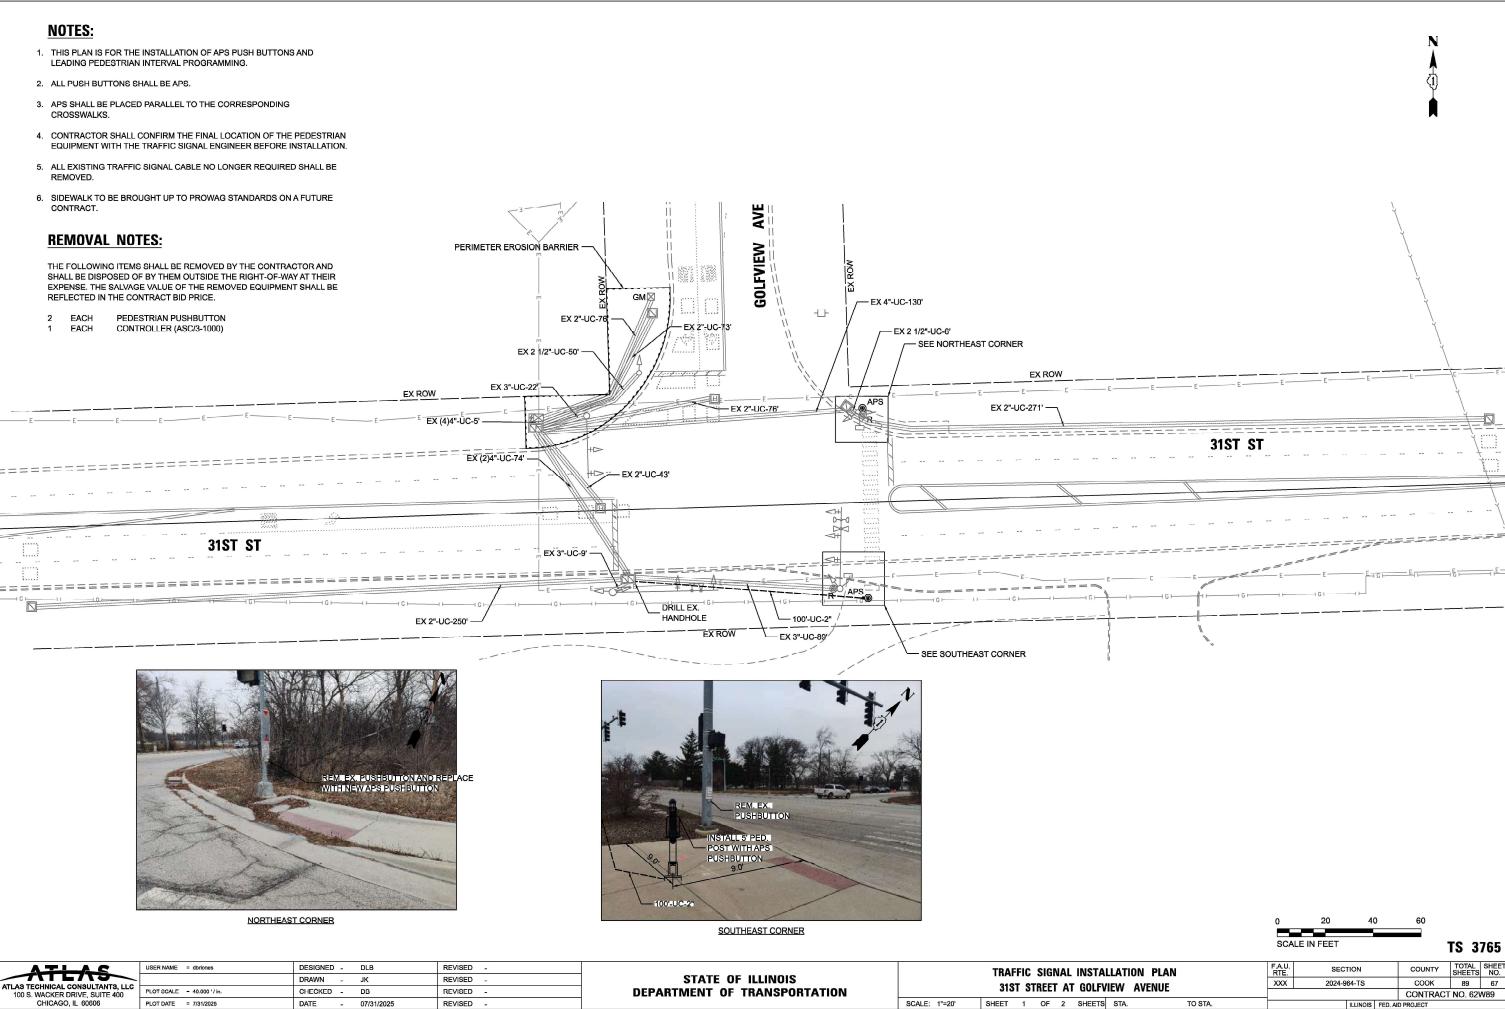

CONTRACT NO. 62W89

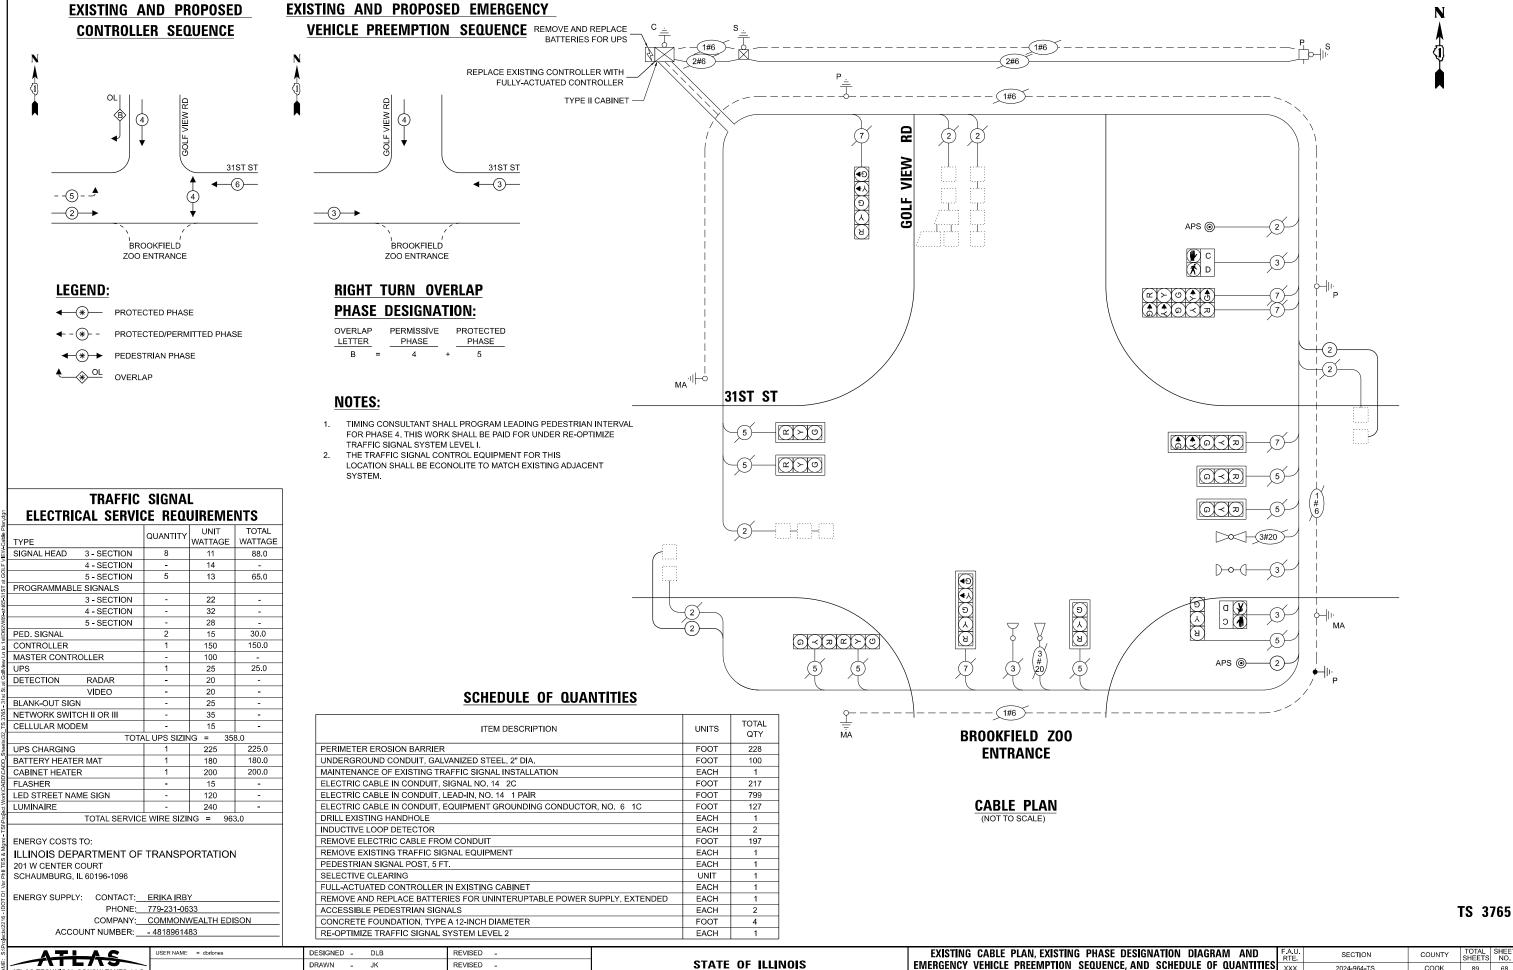

**DEPARTMENT OF TRANSPORTATION** 

2024-964-TS

31ST STREET AT GOLFVIEW AVENUE

SHEET 2 OF 2 SHEETS STA.

COOK

CONTRACT NO. 62W89

89 68

TLAS TECHNICAL CONSULTANTS, LLC

100 S. WACKER DRIVE, SUITE 400 CHICAGO, IL 60606

PLOT DATE = 7/31/2025

CHECKED - DB

- 07/31/2025

DATE

REVISED


REVISED .

- 1. THIS PLAN IS FOR THE INSTALLATION OF APS PUSH BUTTONS AND LEADING PEDESTRIAN INTERVAL PROGRAMMING.
- 2. ALL PUSH BUTTONS SHALL BE APS.
- 3. APS SHALL BE PLACED PARALLEL TO THE CORRESPONDING CROSSWALKS.
- 4. CONTRACTOR SHALL CONFIRM THE FINAL LOCATION OF THE PEDESTRIAN EQUIPMENT WITH THE TRAFFIC SIGNAL ENGINEER BEFORE INSTALLATION.
- 5. ALL EXISTING TRAFFIC SIGNAL CABLE NO LONGER REQUIRED SHALL BE
- 6. SIDEWALK TO BE BROUGHT UP TO PROWAG STANDARDS ON A FUTURE CONTRACT.
- 7. THE GROUND MOUNTED, METERED SERVICE SHALL BE CONSTRUCTED ADJACENT TO THE EXISTING SERVICE CONDUIT PRIOR TO DISCONNECTING THE EXISTING SERVICE. INCLUDE A 5' STUB OF 2" CONDUIT FROM THE GM FOR FUTURE CONNECTION. THE COST OF THE 5' STUB, 2" UNDERGROUND CONDUIT AND SPLICE TO EXISTING SERVICE CONDUIT SHALL BE INCLUDED IN THE COST OF CONCRETE FOUNDATION. TYPE A. THE TRAFFIC SIGNALS SHALL REMAIN OPERATIONAL THE ENTIRE TIME THE SWITCH OVER BETWEEN EXISTING SERVICE AND PROPOSED SERVICE IS MADE.

THE FOLLOWING ITEMS SHALL BE REMOVED BY THE CONTRACTOR AND SHALL BE DISPOSED OF BY THEM OUTSIDE THE RIGHT-OF-WAY AT THEIR EXPENSE. THE SALVAGE VALUE OF THE REMOVED EQUIPMENT SHALL BE

EACH EACH **EACH** SERVICE INSTALLATION

THE FOLLOWING EXISTING TRAFFIC SIGNAL EQUIPMENT SHALL BE REMOVED BY THE CONTRACTOR, SAFELY STORED AND RELOCATED TO THE PROPOSED MAST ARMS, POSTS, AND TRAFFIC SIGNAL CONTROLLER

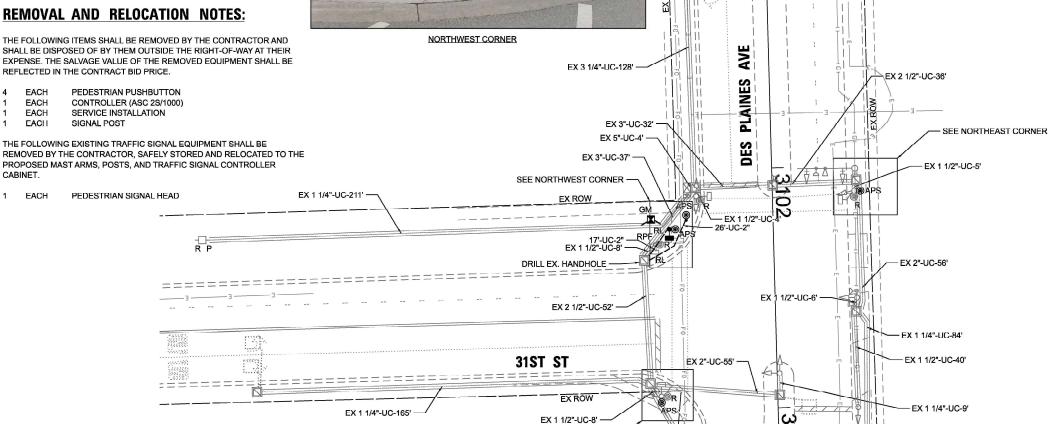

SEE SOUTHEAST CORNER

EX 3"-UC-36'

WITH APS

PUSHBUTTON AND RELOCATED PED. SIGNAL HEAD

REM. AND RELOCATE

26'-UC-2'



NORTHEAST CORNER



SOUTHWEST CORNER

SCALE IN FEET

**TS 3760** 

CHICAGO, IL 60606

USER NAME = dbriones	DESIGNED	-	DLB	REVISED	-
	DRAWN	-	JK	REVISED	H
PLOT SCALE - 40.000 ' / in.	CHECKED	-	DB	REVISED	=
PLOT DATE = 7/31/2025	DATE	-	07/31/2025	REVISED	-


STATE OF ILLINOIS **DEPARTMENT OF TRANSPORTATION** 

0

TRAFFIC SIGNAL			. INSTA	LLATI0	N PLAN		
31ST	STF	REET	ΑT	DES PL	AINES.	AVENUE	
SHEET	1	OF	2	SHEETS	STA.		TO STA.

SCALE: 1"=20'

	F.A.U. RTE.	SECTION	COUNTY	TOTAL SHEETS	SHEET NO.
	XXX	2024-964-TS	соок	89	69
_			CONTRACT	NO. 62\	N89
		ILLINOIS FED. AI	D PROJECT		

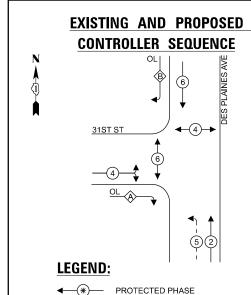

#### TRAFFIC SIGNAL **ELECTRICAL SERVICE REQUIREMENTS**

PROTECTED/PERMITTED PHASE

PEDESTRIAN PHASE

OVERLAP

TYPE	QUANTITY	UNIT WATTAGE	TOTAL WATTAGE			
SIGNAL HEAD 3 - SECTION	6	11	66.0			
4 - SECTION	-	14	-			
5 - SECTION	6	13	78.0			
PROGRAMMABLE SIGNALS						
3 - SECTION	-	22	-			
4 - SECTION	-	32	-			
5 - SECTION	-	28	-			
PED. SIGNAL	4	15	30.0			
CONTROLLER	1	150	150.0			
MASTER CONTROLLER	-	100	-			
UPS	1	25	25.0			
DETECTION RADAR	-	20	-			
VIDEO	-	20	-			
BLANK-OUT SIGN	-	25	-			
NETWORK SWITCH II OR III	-	35	-			
CELLULAR MODEM	-	15	-			
TOTA	AL UPS SIZIN	IG = 34				
UPS CHARGING	1	225	225.0			
BATTERY HEATER MAT	1	180	180.0			
CABINET HEATER	1	200	200.0			
FLASHER	-	15	-			
LED STREET NAME SIGN	-	120	-			
LUMINAIRE	-	240	-			
TOTAL SERVICE WIRE SIZING = 954.0						

ENERGY COSTS TO: VILLAGE OF NORTH RIVERSIDE 2401 S DES PLAINES AVE NORTH RIVERSIDE, IL 60546

ENERGY SUPPLY: CONTACT: ERICKA IRBY PHONE: 779-231-0633 COMPANY: COMMONWEALTH EDISON

ACCOUNT NUMBER: \_ - 7423861222

**EXISTING AND PROPOSED EMERGENCY** 

DESIGNED - DLB REVISED -DRAWN - JK REVISED -DB REVISED DATE - 07/31/2025 REVISED -

CONCRETE FOUNDATION, TYPE A 12-INCH DIAMETER

RE-OPTIMIZE TRAFFIC SIGNAL SYSTEM LEVEL 1

ACCESSIBLE PEDESTRIAN SIGNALS


#### STATE OF ILLINOIS **DEPARTMENT OF TRANSPORTATION**

EACH

FOOT

EACH

EXISTING CABLE PLAN, EXISTING PHASE DESIGNATION DIAGRAM AND EMERGENCY VEHICLE PREEMPTION SEQUENCE, AND SCHEDULE OF QUANTITIES 31ST STREET AT DES PLAINES AVENUE SHEET 2 OF 2 SHEETS STA.

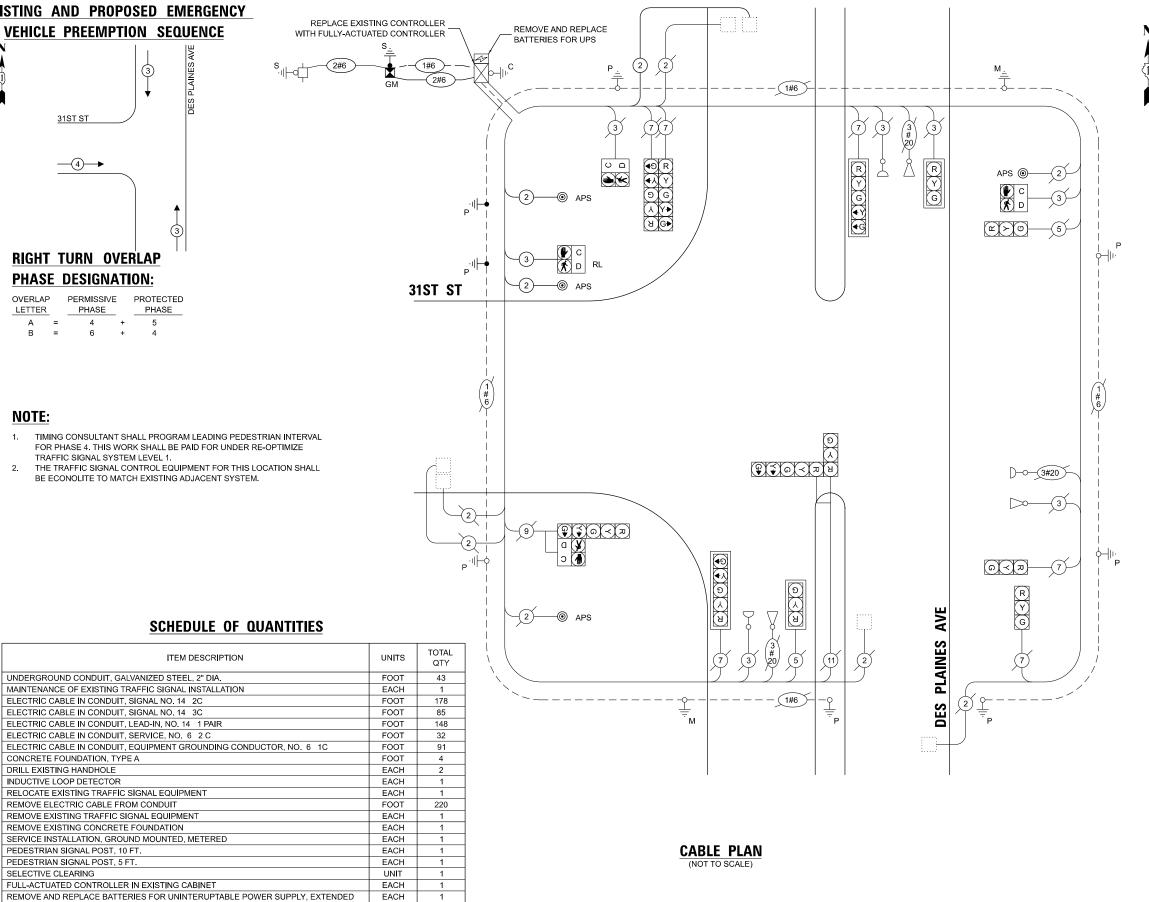

TS 3760

TLAS TECHNICAL CONSULTANTS, LLC 100 S. WACKER DRIVE, SUITE 400 CHICAGO, IL 60606 PLOT DATE = 7/31/2025

SECTION COUNTY 2024-964-TS COOK 89 70 CONTRACT NO. 62W89

- 1. THIS PLAN IS FOR THE INSTALLATION OF APS PUSH BUTTONS AND LEADING PEDESTRIAN INTERVAL PROGRAMMING.
- 2. ALL PUSH BUTTONS SHALL BE APS.
- 3. APS SHALL BE PLACED PARALLEL TO THE CORRESPONDING CROSSWALKS.
- 4. CONTRACTOR SHALL CONFIRM THE FINAL LOCATION OF THE PEDESTRIAN EQUIPMENT WITH THE TRAFFIC SIGNAL ENGINEER BEFORE INSTALLATION.
- 5. ALL EXISTING TRAFFIC SIGNAL CABLE NO LONGER REQUIRED SHALL BE
- 6. SIDEWALK TO BE BROUGHT UP TO PROWAG STANDARDS ON A FUTURE CONTRACT.
- 7. THE GROUND MOUNTED, METERED SERVICE SHALL BE CONSTRUCTED ADJACENT TO THE EXISTING SERVICE CONDUIT PRIOR TO DISCONNECTING THE EXISTING SERVICE. INCLUDE A 5' STUB OF 2" CONDUIT FROM THE GM FOR FUTURE CONNECTION. THE COST OF THE 5' STUB, 2" UNDERGROUND CONDUIT AND SPLICE TO EXISTING SERVICE CONDUIT SHALL BE INCLUDED IN THE COST OF CONCRETE FOUNDATION, TYPE A. THE TRAFFIC SIGNALS SHALL REMAIN OPERATIONAL THE ENTIRE TIME THE SWITCH OVER BETWEEN EXISTING SERVICE AND PROPOSED SERVICE IS MADE.

#### **REMOVAL AND RELOCATION NOTES:**

THE FOLLOWING ITEMS SHALL BE REMOVED BY THE CONTRACTOR AND SHALL BE DISPOSED OF BY THEM OUTSIDE THE RIGHT-OF-WAY AT THEIR EXPENSE. THE SALVAGE VALUE OF THE REMOVED EQUIPMENT SHALL BE REFLECTED IN THE CONTRACT BID PRICE.

PEDESTRIAN PUSH-BUTTON EACH


TRAFFIC SIGNAL POST EACH


TRAFFIC CONTROLLER (M40) AND CABINET (TS1) COMPLETE EACH

SERVICE INSTALLATION

THE FOLLOWING EXISTING TRAFFIC SIGNAL EQUIPMENT SHALL BE REMOVED

		RACTOR AND SHALL BE RELOCATED TO THE PROPOSED MENT INDICATED IN THE PLAN.
1	EACH	3-SECTION SIGNAL HEAD
1	EACH	5-SECTION SIGNAL HEAD

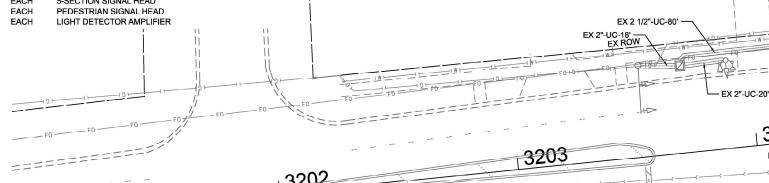


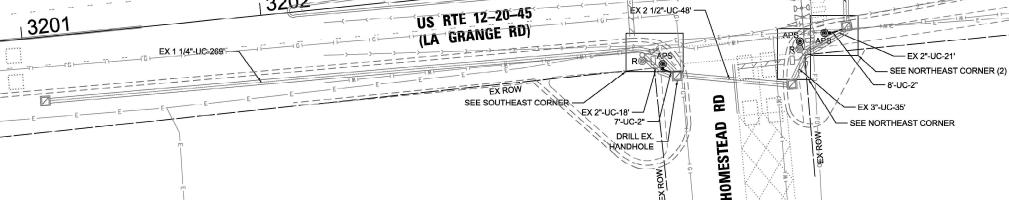






NORTHEAST CORNER

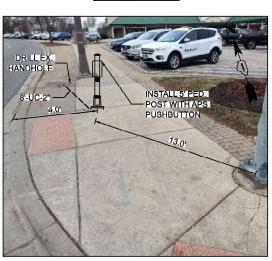

NORTHEAST CORNER (2)

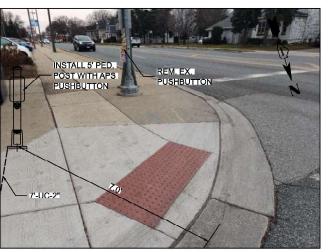

SOUTHEAST CORNER

SCALE IN FEET

TS 13920 **EAGLE 5M** 



USER NAME = dbriones	DESIGNED	-	DLB	REVISED -	
	DRAWN	-	JK	REVISED -	
PLOT SCALE - 40.000 ' / in.	CHECKED	-	DB	REVISED -	
PLOT DATE = 7/31/2025	DATE	-	07/31/2025	REVISED -	

STATE OF ILLINOIS **DEPARTMENT OF TRANSPORTATION** 

SEE NORTHWEST CORNER

PED. SIGNAL HEAD, AND RELOCATED 3 SECTION AND

5 SECTION SIGNAL HEADS

NORTHWEST CORNER

EX 1 1/4"-UC-152' -

EX 2"-UG-12"

20'-UC-3" ·

3204

EX 3 1/2"-UC-26


3205+

EX 1 1/4"-UC-198

MATCH LINE

TRAFFIC SIGNAL INSTALLATION PLAN US ROUTE 12-20-45 (LA GRANGE ROAD) AT HOMESTEAD ROAD SCALE: 1"=20' SHEET 1 OF 2 SHEETS STA.

TOTAL SHEET NO. SECTION COUNTY 2024-964-TS COOK CONTRACT NO. 62W89

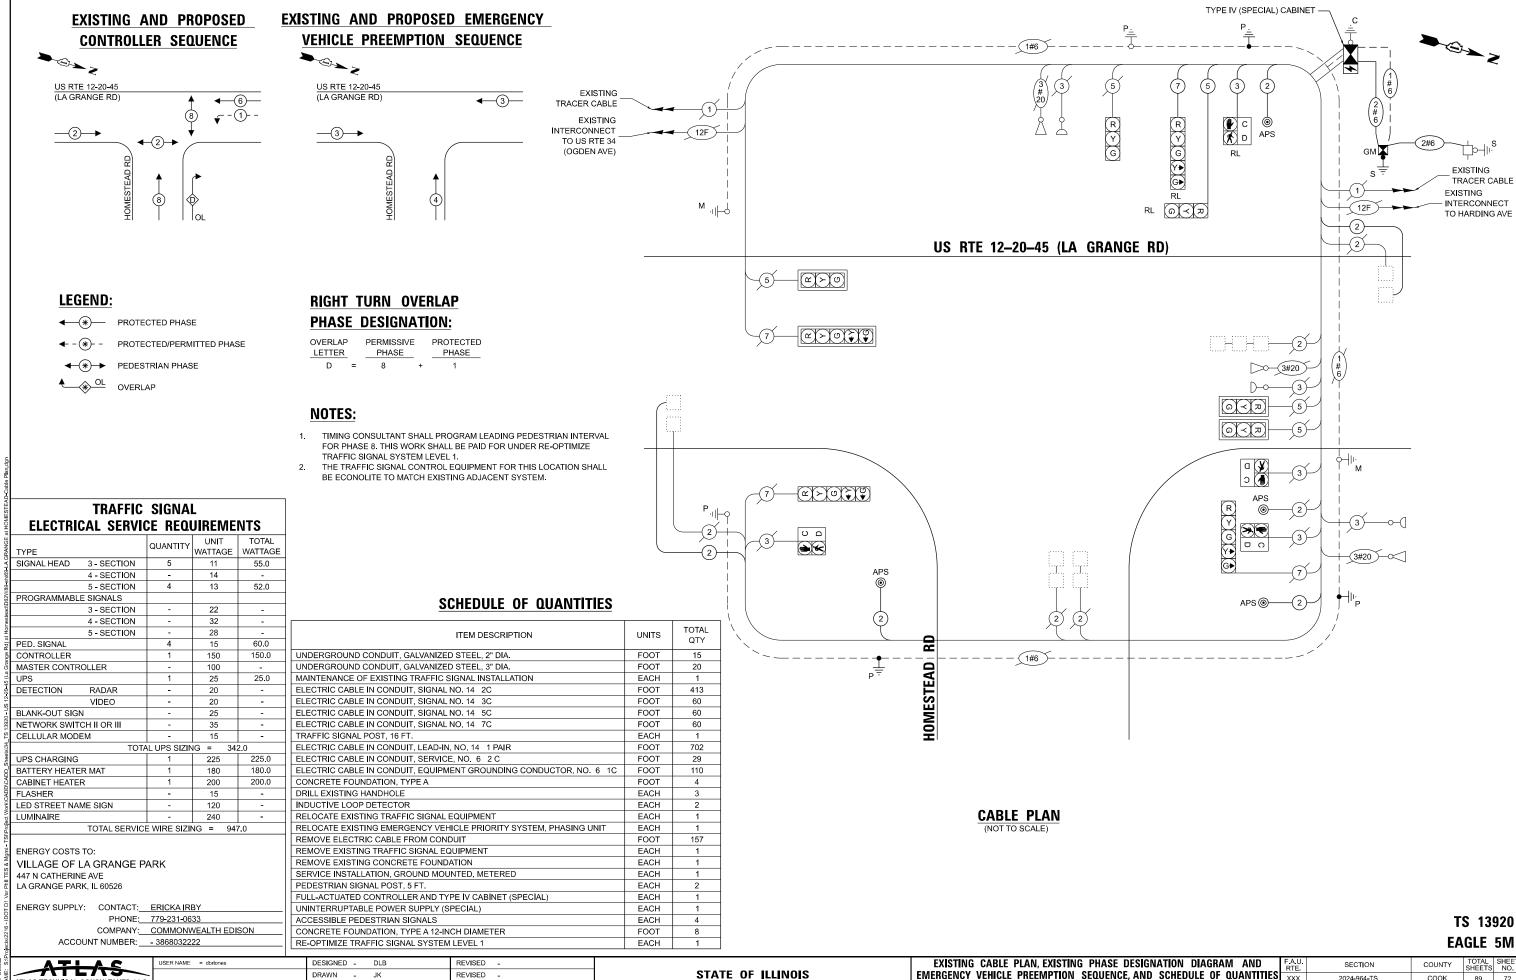

**DEPARTMENT OF TRANSPORTATION** 

2024-964-TS

US ROUTE 12-20-45 (LA GRANGE ROAD) AT HOMESTEAD ROAD

SHEET 2 OF 2 SHEETS STA.

SCALE: N.T.S.

COOK 89 72

CONTRACT NO. 62W89

TLAS TECHNICAL CONSULTANTS, LLC

100 S. WACKER DRIVE, SUITE 400 CHICAGO, IL 60606

PLOT DATE = 7/31/2025

DB


- 07/31/2025

DATE

REVISED

REVISED .

#### **NOTES:** 1. THIS PLAN IS FOR THE INSTALLATION OF LEADING PEDESTRIAN INTERVAL 2. THE GROUND MOUNTED, METERED SERVICE SHALL BE CONSTRUCTED ADJACENT TO THE EXISTING SERVICE CONDUIT PRIOR TO DISCONNECTING THE EXISTING SERVICE. INCLUDE A 5' STUB OF 2" EX 2"-UC-68' -CONDUIT FROM THE GM FOR FUTURE CONNECTION. THE COST OF THE 5' STUB, 2" UNDERGROUND CONDUIT AND SPLICE TO EXISTING SERVICE CONDUIT SHALL BE INCLUDED IN THE COST OF CONCRETE FOUNDATION, TYPE A. THE TRAFFIC SIGNALS SHALL REMAIN OPERATIONAL THE ENTIRE TIME THE SWITCH OVER BETWEEN EXISTING SERVICE AND PROPOSED SERVICE IS MADE. **REMOVAL AND RELOCATION NOTES:** — EX 2"-UC-254' THE FOLLOWING ITEMS SHALL BE REMOVED BY THE CONTRACTOR AND SHALL BE DISPOSED OF BY THEM OUTSIDE THE RIGHT-OF-WAY AT THEIR EXPENSE. THE SALVAGE VALUE OF THE REMOVED EQUIPMENT SHALL BE REFLECTED IN THE CONTRACT BID PRICE. TRAFFIC CABINET (TS-1) AND CONTROLLER (ASC/2S-2100) COMPLETE SERVICE INSTALLATION THE FOLLOWING EXISTING TRAFFIC SIGNAL EQUIPMENT SHALL BE REMOVED BY THE CONTRACTOR AND RELOCATED TO THE PROPOSED GROUND MOUNTED SERVICE: SERVICE METER 1 EACH THE FOLLOWING EXISTING TRAFFIC SIGNAL EQUIPMENT SHALL BE REMOVED BY THE CONTRACTOR AND RELOCATED TO THE PROPOSED 1 EACH LIGHT DETECTOR AMPLIFIER MATCH LINE STA. 3400+00 - EX 2"-UC-52' - EX (2)4"-UC-5' EX 2"-UC-32' \ EX 3"-UC-40' EX 3"-UC-46' EX 3"-UC-16' - EX 2"-UC-15' - EX 2"-UC-60' EX 2 1/2"-UC-61' EX 2 1/2"-UC-81' -- EX 2"-UC-6' - EX 2"-UC-274' 53 RTE TS 11655 MATCH LINE STA. 3400+00 SCALE IN FEET ECON 37 USER NAME = dbriones DESIGNED - DLB REVISED SECTION COUNTY TRAFFIC SIGNAL INSTALLATION PLAN STATE OF ILLINOIS DRAWN -REVISED XXX 2024-964-TS DUPAGE 89 73 ATLAS TECHNICAL CONSULTANTS, LLC IL ROUTE 53 AT MAIN STREET DB REVISED **DEPARTMENT OF TRANSPORTATION** 100 S. WACKER DRIVE, SUITE 400 CHICAGO, IL 60606 CONTRACT NO. 62W89 SHEET 1 OF 2 SHEETS STA. SCALE: 1"=20' TO STA. PLOT DATE = 7/31/2025 DATE 07/31/2025 REVISED

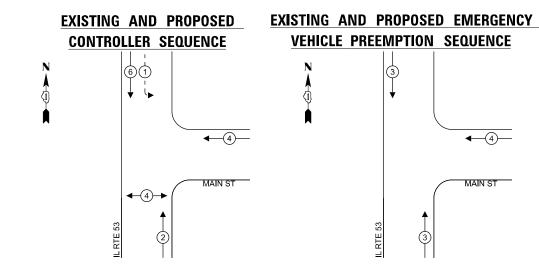

**LEGEND**:

**←**(\*)**→** 

OL OVERLAP

**★**PROTECTED PHASE

PROTECTED/PERMITTED PHASE

PEDESTRIAN PHASE

#### NOTES:

TIMING CONSULTANT SHALL PROGRAM LEADING PEDESTRIAN INTERVAL FOR PHASE 4. THIS WORK SHALL BE PAID FOR UNDER RE-OPTIMIZE TRAFFIC SIGNAL SYSTEM LEVEL 1.

4—4—

MAIN ST

THE TRAFFIC SIGNAL CONTROL EQUIPMENT FOR THIS LOCATION SHALL BE ECONOLITE TO MATCH EXISTING ADJACENT SYSTEM.

## TRAFFIC SIGNAL **ELECTRICAL SERVICE REQUIREMENTS**


	QUANTITY	UNIT	TOTAL
TYPE	QUANTITI	WATTAGE	WATTAGE
SIGNAL HEAD 3 - SECTION	10	11	110.0
4 - SECTION	-	14	-
5 - SECTION	2	13	26.0
PROGRAMMABLE SIGNALS			
3 - SECTION	-	22	-
4 - SECTION	-	32	-
5 - SECTION	-	28	-
PED. SIGNAL	2	15	30.0
CONTROLLER	1	150	150.0
MASTER CONTROLLER	-	100	-
UPS	1	25	25.0
DETECTION RADAR	-	20	-
VIDEO	-	20	-
BLANK-OUT SIGN	-	25	-
NETWORK SWITH II OR III	-	35	-
CELLULAR MODEM	-	15	-
TOTA	L UPS SIZIN	IG = 34	1.0
UPS CHARGING	1	225	225.0
BATTERY HEATER MAT	1	180	180.0
CABINET HEATER	1	200	200.0
FLASHER	-	15	-
LED STREET NAME SIGN	-	120	-
LUMINAIRE	-	240	-
TOTAL SERVICE	WIRE SIZI	NG = 946	6.0


ENERGY COSTS TO: VILLAGE OF LISLE 925 BURLINGTON AVE LISLE. IL 60532

ENERGY SUPPLY: CONTACT: NICK TULEJA

PHONE: 440-976-8979

COMPANY: COMMONWEALTH EDISON ACCOUNT NUMBER: \_\_- 4244068000

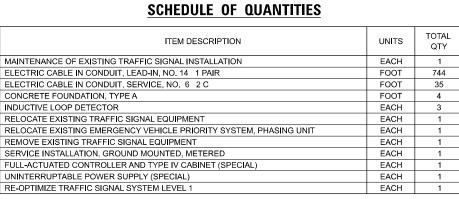

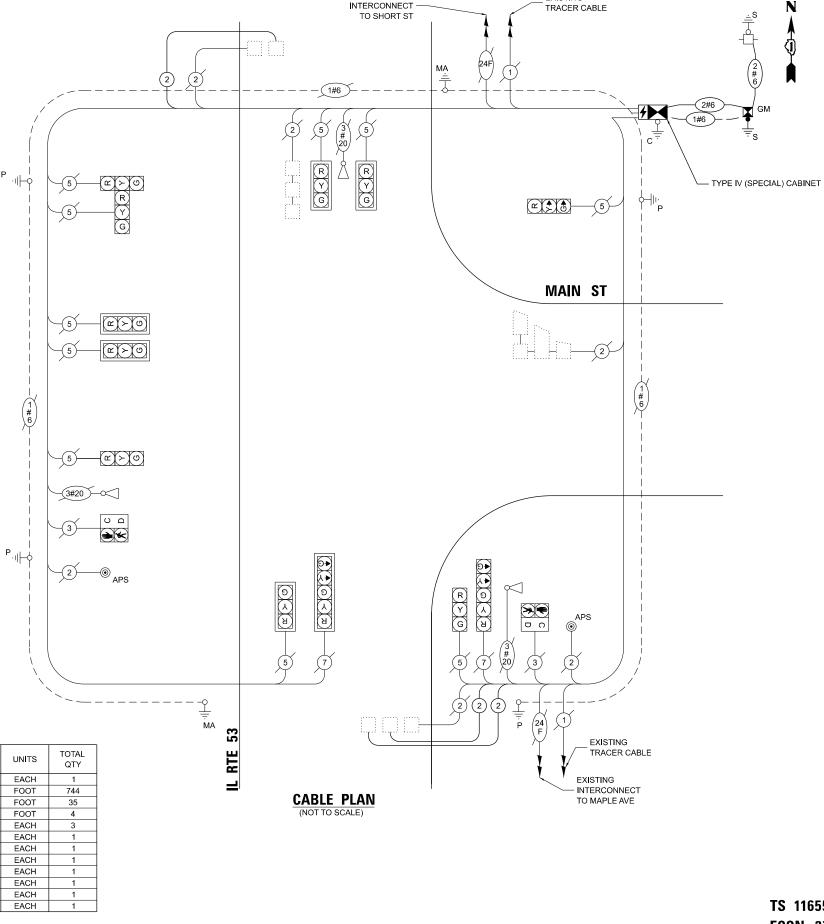

**EXISTING** 

**EXISTING** 

TS 11655 ECON 37



USER NAME = dbriones	DESIGNED	-	DLB	REVISED	-
	DRAWN	-	JK	REVISED	-
PLOT SCALE = 40.000 '/in.	CHECKED	-	DB	REVISED	-
PLOT DATE = 7/31/2025	DATE	-	07/31/2025	REVISED	-

STATE OF ILLINOIS **DEPARTMENT OF TRANSPORTATION** 

	BLE PLAN, EXISTING PHAS	. DESIGNATION DIAGNAM AND	F.A.U. RTE	SECTION	COUNTY	TOTAL SHEETS	SHEET NO.
EMERGENCY VEH		CE, AND SCHEDULE OF QUANTITIES	XXX	2024-964-TS	DUPAGE	89	74
	IL ROUTE 53 AT MA	AIN STREET			CONTRACT	NO. 62\	N89
SCALE: N.T.S.	SHEET 2 OF 2 SHEETS	S STA. TO STA.		ILLINOIS FED. AI	D PROJECT		

- THIS PLAN IS FOR THE INSTALLATION OF APS PUSH BUTTONS AND LEADING PEDESTRIAN INTERVAL PROGRAMMING.
- 2. ALL PUSH BUTTONS SHALL BE APS.
- 3. APS SHALL BE PLACED PARALLEL TO THE CORRESPONDING CROSSWALKS.
- 4. CONTRACTOR SHALL CONFIRM THE FINAL LOCATION OF THE PEDESTRIAN EQUIPMENT WITH THE TRAFFIC SIGNAL ENGINEER BEFORE INSTALLATION.
- 5. ALL EXISTING TRAFFIC SIGNAL CABLE NO LONGER REQUIRED SHALL BE
- 6. SIDEWALK TO BE BROUGHT UP TO PROWAG STANDARDS ON A FUTURE CONTRACT.

#### **REMOVAL NOTES:**

THE FOLLOWING ITEMS SHALL BE REMOVED BY THE CONTRACTOR AND SHALL BE DISPOSED OF BY THEM OUTSIDE THE RIGHT-OF-WAY AT THEIR EXPENSE. THE SALVAGE VALUE OF THE REMOVED EQUIPMENT SHALL BE REFLECTED IN THE CONTRACT BID PRICE.


PEDESTRIAN PUSH-BUTTON 2 EACH




SEE NORTHWEST CORNER

SEE SOUTHWEST CORNER

EX 3"-UC-22'

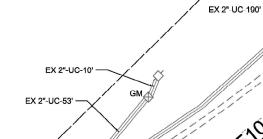

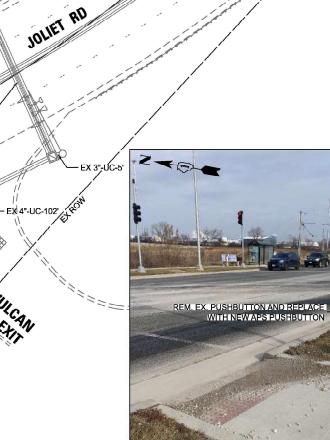



USER NAME = dbriones	DESIGNED	-	DLB	REVISED -	Π
	DRAWN	×	JK	REVISED -	
PLOT SCALE - 40.000 1/ in.	CHECKED	-	DB	REVISED -	
PLOT DATE = 7/31/2025	DATE	-	07/31/2025	REVISED -	

STATE OF ILLINOIS **DEPARTMENT OF TRANSPORTATION** 

ΓRA	FFIC	SIGI	VAL	INSTAL	.LATI	ON	PLAN	
	55TH	STF	REET	AT JO	LIET	ROA	D	
FFT	1	OF	2	SHEETS	STA.			TO STA.

A.U. SECTION COUNTY TOTAL SHEETS	SHE					
XX 2024-964-TS COOK 89	75					
CONTRACT NO. 62W8	89					
ILLINOIS FED. AID PROJECT						

TS 3850

**EAGLE 2B** 

SOUTHWEST CORNER

SCALE IN FEET

CHICAGO II 60606

EX 2"-UC-257"

SHE SCALE: 1"=20'


EX (4)4"-UC-10".

EX (2)4"-UC-69'

- EX 2-1/2"-UC-15'

EX 3"-UC-127" EX 2 1/2"-UC-9'

EX 2 1/2"-UC-18'

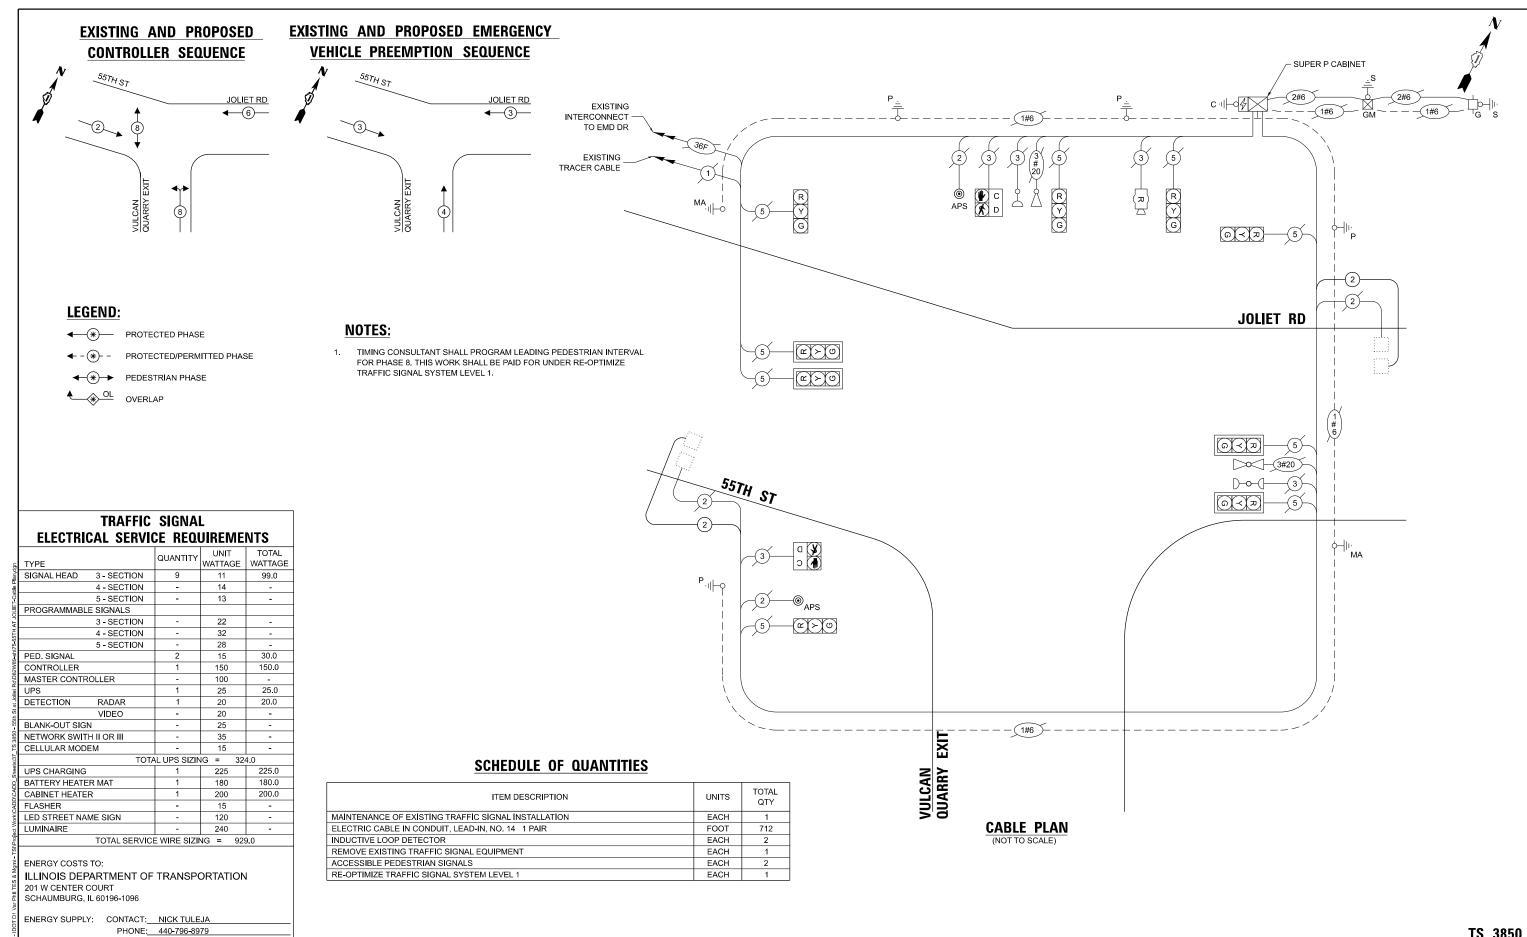

TS 3850 EAGLE 2B

ATLAS

ATLAS TECHNICAL CONSULTANTS, LLC

100 S. WACKER DRIVE, SUITE 400

CHICAGO, IL 60606

COMPANY: COMMONWEALTH EDISON

ACCOUNT NUMBER: \_\_\_ 3149721621

 USER NAME
 = doillones
 DESIGNED
 DLB
 REVISED

 DRAWN
 JK
 REVISED

 PLOT SCALE
 = 40.000 '/ in.
 CHECKED
 DB
 REVISED

 PLOT DATE
 = 7/31/2025
 DATE
 07/31/2025
 REVISED

STATE OF ILLINOIS
DEPARTMENT OF TRANSPORTATION

						AND	F.A.U. RTE	SEC	TION		COUNTY	TOTAL SHEETS	SHEET NO.
						XXX	2024-9	64-TS		COOK	89	76	
55TH STREET AT JOLIET ROAD										CONTRACT	NO. 62\	W89	
SCALE:	SHEET	OF '	SHEETS	STA.	TO STA.				ILLINOIS	FED. All	D PROJECT		


- 1. THIS PLAN IS FOR THE INSTALLATION OF LEADING PEDESTRIAN INTERVAL
- 2. ALL EXISTING TRAFFIC SIGNAL CABLE NO LONGER REQUIRED SHALL BE REMOVED.
- 3. SIDEWALK TO BE BROUGHT UP TO PROWAG STANDARDS ON A FUTURE
- 4. THE GROUND MOUNTED, METERED SERVICE SHALL BE CONSTRUCTED ADJACENT TO THE EXISTING SERVICE CONDUIT PRIOR TO DISCONNECTING THE EXISTING SERVICE. INCLUDE A 5' STUB OF 2" CONDUIT FROM THE GM FOR FUTURE CONNECTION. THE COST OF THE 5' STUB, 2" UNDERGROUND CONDUIT AND SPLICE TO EXISTING SERVICE CONDUIT SHALL BE INCLUDED IN THE COST OF CONCRETE FOUNDATION, TYPE A. THE TRAFFIC SIGNALS SHALL REMAIN OPERATIONAL THE ENTIRE TIME THE SWITCH OVER BETWEEN EXISTING SERVICE AND PROPOSED SERVICE IS MADE.

#### **REMOVAL NOTES:**

THE FOLLOWING ITEMS SHALL BE REMOVED BY THE CONTRACTOR AND SHALL BE DISPOSED OF BY THEM OUTSIDE THE RIGHT-OF-WAY AT THEIR EXPENSE. THE SALVAGE VALUE OF THE REMOVED EQUIPMENT SHALL BE REFLECTED IN THE CONTRACT BID PRICE.

1 EACH

TRAFFIC CONTROLLER (ASC/2S-1000) SERVICE INSTALLATION

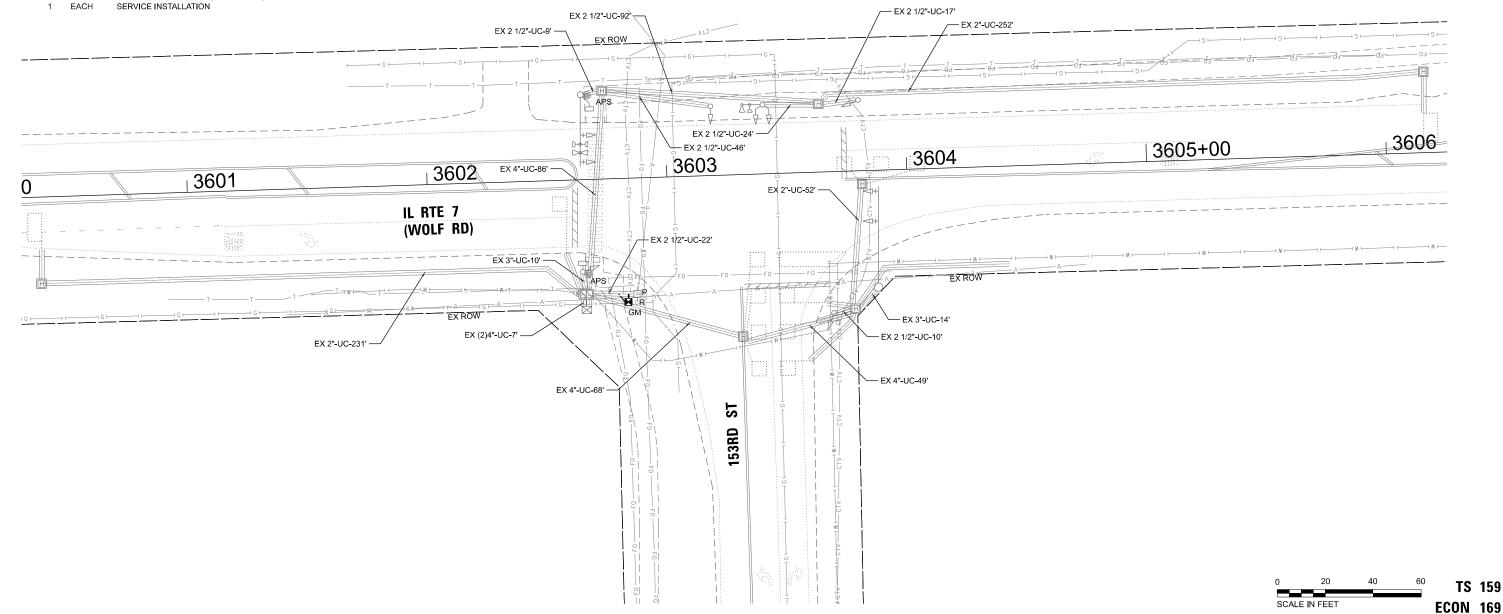

ATLAS TECHNICAL CONSULTANTS, LLC 100 S. WACKER DRIVE, SUITE 400 CHICAGO, IL 60606

DESIGNED - DLB REVISED -DRAWN - JK REVISED . DB REVISED PLOT DATE = 7/31/2025 DATE 07/31/2025 REVISED


STATE OF ILLINOIS **DEPARTMENT OF TRANSPORTATION** 

TRAFFIC SIGNAL INSTALLATION PLAN IL ROUTE 7 (WOLF ROAD) AT 153RD STREET SHEET 1 OF 2 SHEETS STA.

SCALE: 1"=20'

SECTION COUNTY COOK 89 77 XXX 2024-964-TS CONTRACT NO. 62W89

**→**©→Z

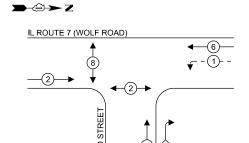

#### **LEGEND**:

PROTECTED PHASE

PROTECTED/PERMITTED PHASE

PEDESTRIAN PHASE

**♦** OL OVERLAP

#### TRAFFIC SIGNAL **ELECTRICAL SERVICE REQUIREMENTS**

		QUANTITY	UNIT	TOTAL
5	TYPE	QUANTITI	WATTAGE	WATTAGE
	SIGNAL HEAD 3 - SECTION	8	11	88.0
	4 - SECTION	-	14	-
5	5 - SECTION	3	13	39.0
3	PROGRAMMABLE SIGNALS			
	3 - SECTION	-	22	-
	4 - SECTION	-	32	-
2	5 - SECTION	-	28	-
	PED. SIGNAL	4	15	60.0
	CONTROLLER	1	150	150.0
	MASTER CONTROLLER	-	100	-
í	UPS	1	25	25.0
2	DETECTION RADAR	-	20	-
:	VIDEO	-	20	-
ì	BLANK-OUT SIGN	-	25	-
3	NETWORK SWITH II OR III	-	35	-
	CELLULAR MODEM	-	15	-
	TOTA	L UPS SIZIN	IG = 36	
i	UPS CHARGING	1	225	225.0
3	BATTERY HEATER MAT	1	180	180.0
	CABINET HEATER	1	200	200.0
	FLASHER	-	15	-
	LED STREET NAME SIGN	-	120	-
	LUMINAIRE	-	240	-
	TOTAL SERVICE	WIRE SIZI	NG = 967	7.0

ENERGY COSTS TO:

ILLINOIS DEPARTMENT OF TRANSPORTATION


201 W CENTER COURT SCHAUMBURG, IL 60196-1096

ENERGY SUPPLY: CONTACT: PAUL EDWARDS PHONE: 773-573-8637

COMPANY: COMMONWEALTH EDISON ACCOUNT NUMBER: \_\_ - 65713-64111

> DESIGNED - DLB DRAWN - JK CHECKED - DB PLOT DATE = 7/31/2025 DATE - 07/31/2025

**EXISTING AND PROPOSED EMERGENCY VEHICLE PREEMPTION SEQUENCE** 

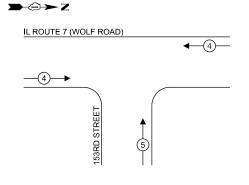


#### **RIGHT TURN OVERLAP PHASE DESIGNATION:**

OVERLAP PERMISSIVE PROTECTED PHASE PHASE LETTER 8

#### **NOTES:**

TIMING CONSULTANT SHALL PROGRAM LEADING PEDESTRIAN INTERVAL FOR PHASE 8. THIS WORK SHALL BE PAID FOR UNDER RE-OPTIMIZE TRAFFIC SIGNAL SYSTEM LEVEL 1.

THE TRAFFIC SIGNAL CONTROL EQUIPMENT FOR THIS LOCATION SHALL BE ECONOLITE TO MATCH EXISTING ADJACENT SYSTEM.

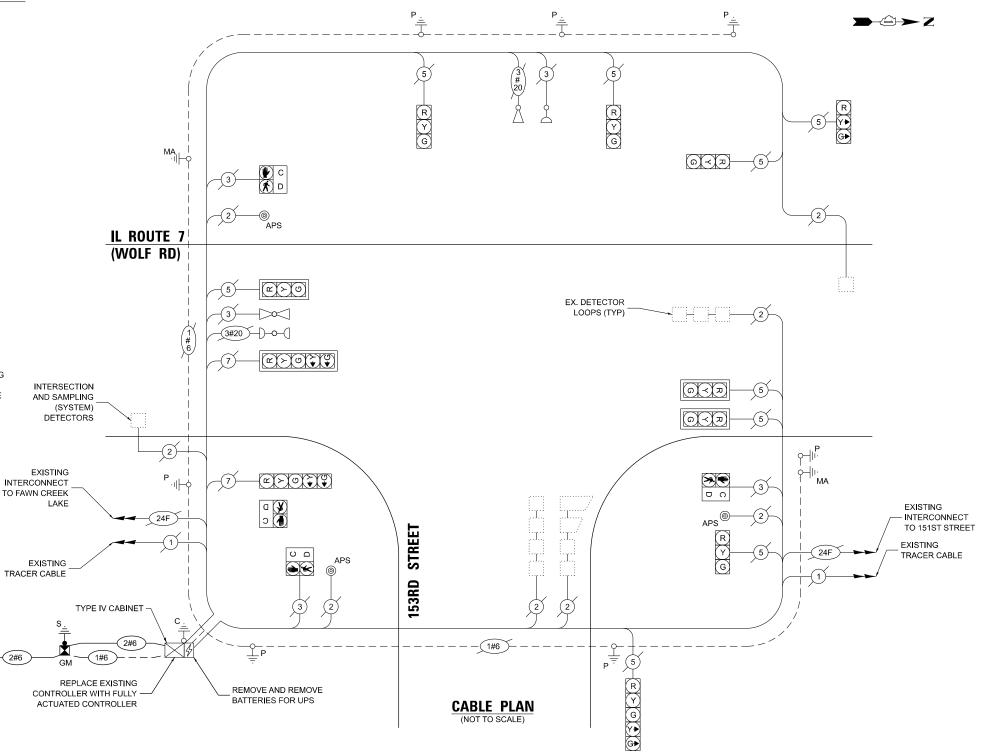

#### SCHEDULE OF QUANTITIES

ITEM DESCRIPTION	UNITS	TOTAL QTY
ELECTRIC CABLE IN CONDUIT, SERVICE, NO. 6 2 C	FOOT	36
CONCRETE FOUNDATION, TYPE A	FOOT	4
REMOVE EXISTING TRAFFIC SIGNAL EQUIPMENT	EACH	1
SERVICE INSTALLATION, GROUND MOUNTED, METERED	EACH	1
FULL-ACTUATED CONTROLLER IN EXISTING CABINET	EACH	1
REMOVE AND REPLACE BATTERIES FOR UNINTERUPTABLE POWER SUPPLY, EXTENDED	EACH	1
RE-OPTIMIZE TRAFFIC SIGNAL SYSTEM LEVEL 1	EACH	1


TS 159 **ECON 169** 


EXISTING CABLE PLAN. EXISTING PHASE DESIGNATION DIAGRAM AND STATE OF ILLINOIS EMERGENCY VEHICLE PREEMPTION SEQUENCE, AND SCHEDULE OF QUANTITIES **DEPARTMENT OF TRANSPORTATION** IL ROUTE 7 (WOLF ROAD) AT 153RD STREET SHEET 2 OF 2 SHEETS STA.

SECTION COUNTY 2024-964-TS COOK 89 78 CONTRACT NO. 62W89


ATLAS TECHNICAL CONSULTANTS, LLC 100 S. WACKER DRIVE, SUITE 400 CHICAGO, IL 60606

REVISED -REVISED -REVISED REVISED .

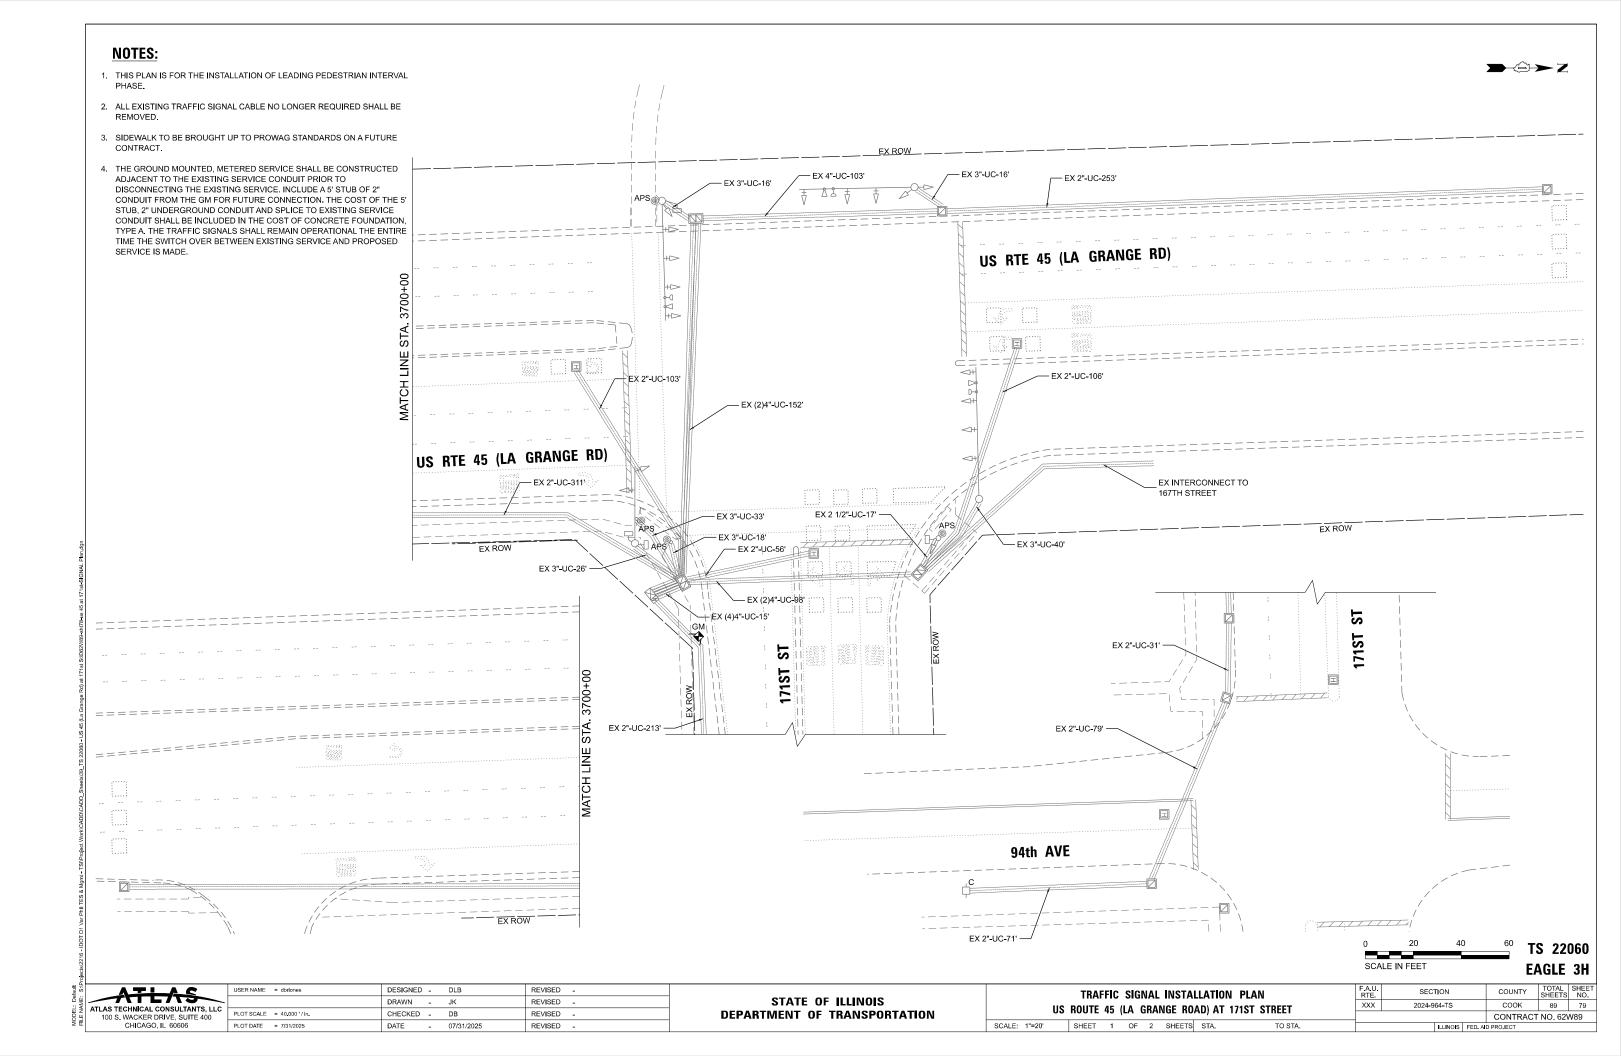

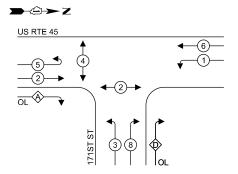

#### **EXISTING AND PROPSED EMERGENCY VEHICLE PREEMPTION SEQUENCE**

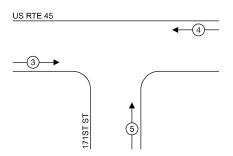

#### LEGEND:

**★**PROTECTED PHASE

PROTECTED/PERMITTED PHASE

**←**(\*)**→** PEDESTRIAN PHASE

OL OVERLAP

OVERLAP		PERMISSIVE		PROTECTED		
LETTER		PHASE		PHASE		
Α	=	2	+	3		
D	=	8	+	1		

#### **NOTES:**

**→**⇒Z

TIMING CONSULTANT SHALL PROGRAM LEADING PEDESTRIAN INTERVAL FOR PHASE 8. THIS WORK SHALL BE PAID FOR UNDER RE-OPTIMIZE TRAFFIC

ELECTRICAL SERVIC	CE REQU	JIREME	NTS
TYPE	QUANTITY	UNIT WATTAGE	TOTAL WATTAGE
SIGNAL HEAD 3 - SECTION	13	11	143.0
4 - SECTION	-	14	-
5 - SECTION	4	13	52.0
PROGRAMMABLE SIGNALS			
3 - SECTION	-	22	-
4 - SECTION	-	32	-
5 - SECTION	-	28	-
PED. SIGNAL	4	15	60.0
CONTROLLER	1	150	150.0
MASTER CONTROLLER	-	100	-
UPS	1	25	25.0
DETECTION RADAR	-	20	-
VIDEO	-	20	-
BLANK-OUT SIGN	-	25	-
NETWORK SWITH II OR III	-	35	-
CELLULAR MODEM	-	15	-
TOTA	AL UPS SIZIN	IG = 431	0.0
UPS CHARGING	1	225	225.0
BATTERY HEATER MAT	1	180	180.0
CABINET HEATER	1	200	200.0
FLASHER	-	15	-

TRAFFIC SIGNAL

ENERGY COSTS TO:

LUMINAIRE

LED STREET NAME SIGN

ILLINOIS DEPARTMENT OF TRANSPORTATION 201 W CENTER COURT

SCHAUMBURG, IL 60196-1096


ENERGY SUPPLY: CONTACT: PAUL EDWARDS

PHONE: 773-573-8637 COMPANY: COMMONWEALTH EDISON ACCOUNT NUMBER: \_\_ - 1154806000

TOTAL SERVICE WIRE SIZING = 1035.0

120

240

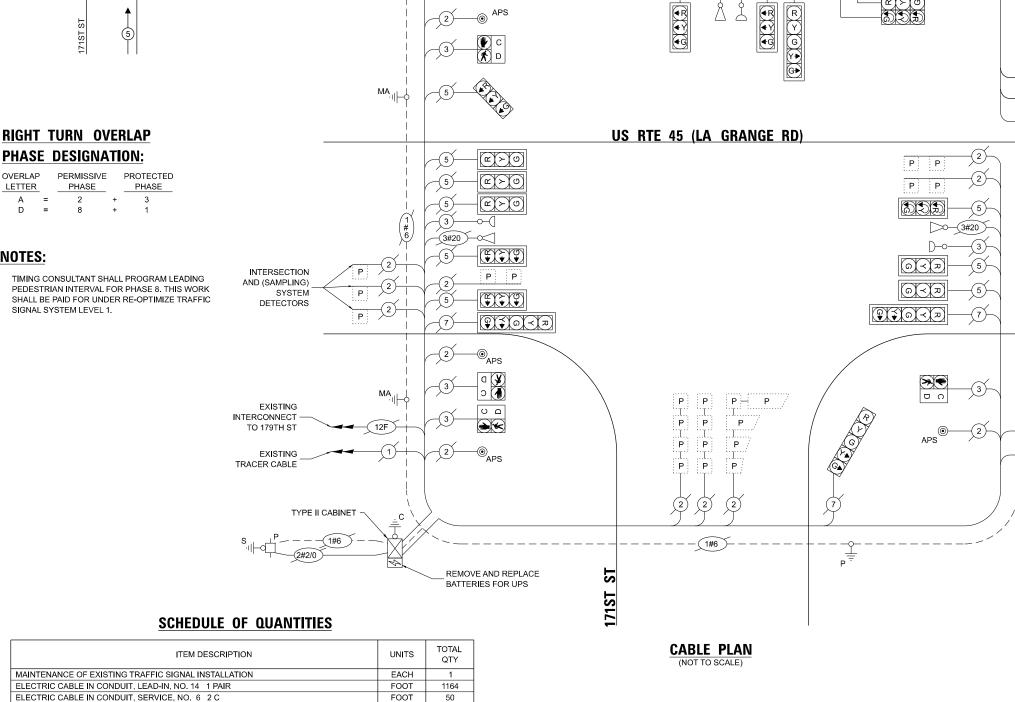

· (1#6 )

---------

TS 22060 EAGLE 3H

COOK 89 80

COUNTY

MA

EXISTING - INTERCONNECT

**EXISTING** 

TO 167TH ST

TRACER CABLE

TLAS TECHNICAL CONSULTANTS, LLC 100 S. WACKER DRIVE, SUITE 400 CHICAGO, IL 60606

DESIGNED - DLB REVISED DRAWN - JK REVISED -DB REVISED PLOT DATE = 7/31/2025 DATE - 07/31/2025 REVISED .

CONCRETE FOUNDATION, TYPE A

SERVICE INSTALLATION, GROUND MOUNTED, METERED

RE-OPTIMIZE TRAFFIC SIGNAL SYSTEM LEVEL 1

REMOVE AND REPLACE BATTERIES FOR UNINTERUPTABLE POWER SUPPLY, EXTENDED

INDUCTIVE LOOP DETECTOR

STATE OF ILLINOIS **DEPARTMENT OF TRANSPORTATION** 

2

1

FOOT


EACH

EACH

EACH

EACH


EXISTING CABLE PLAN. EXISTING PHASE DESIGNATION DIAGRAM AND SECTION EMERGENCY VEHICLE PREEMPTION SEQUENCE, AND SCHEDULE OF QUANTITIES 2024-964-TS US ROUTE 45 (LA GRANGE ROAD) AT 171ST STREET CONTRACT NO. 62W89 SHEET 2 OF 2 SHEETS STA.

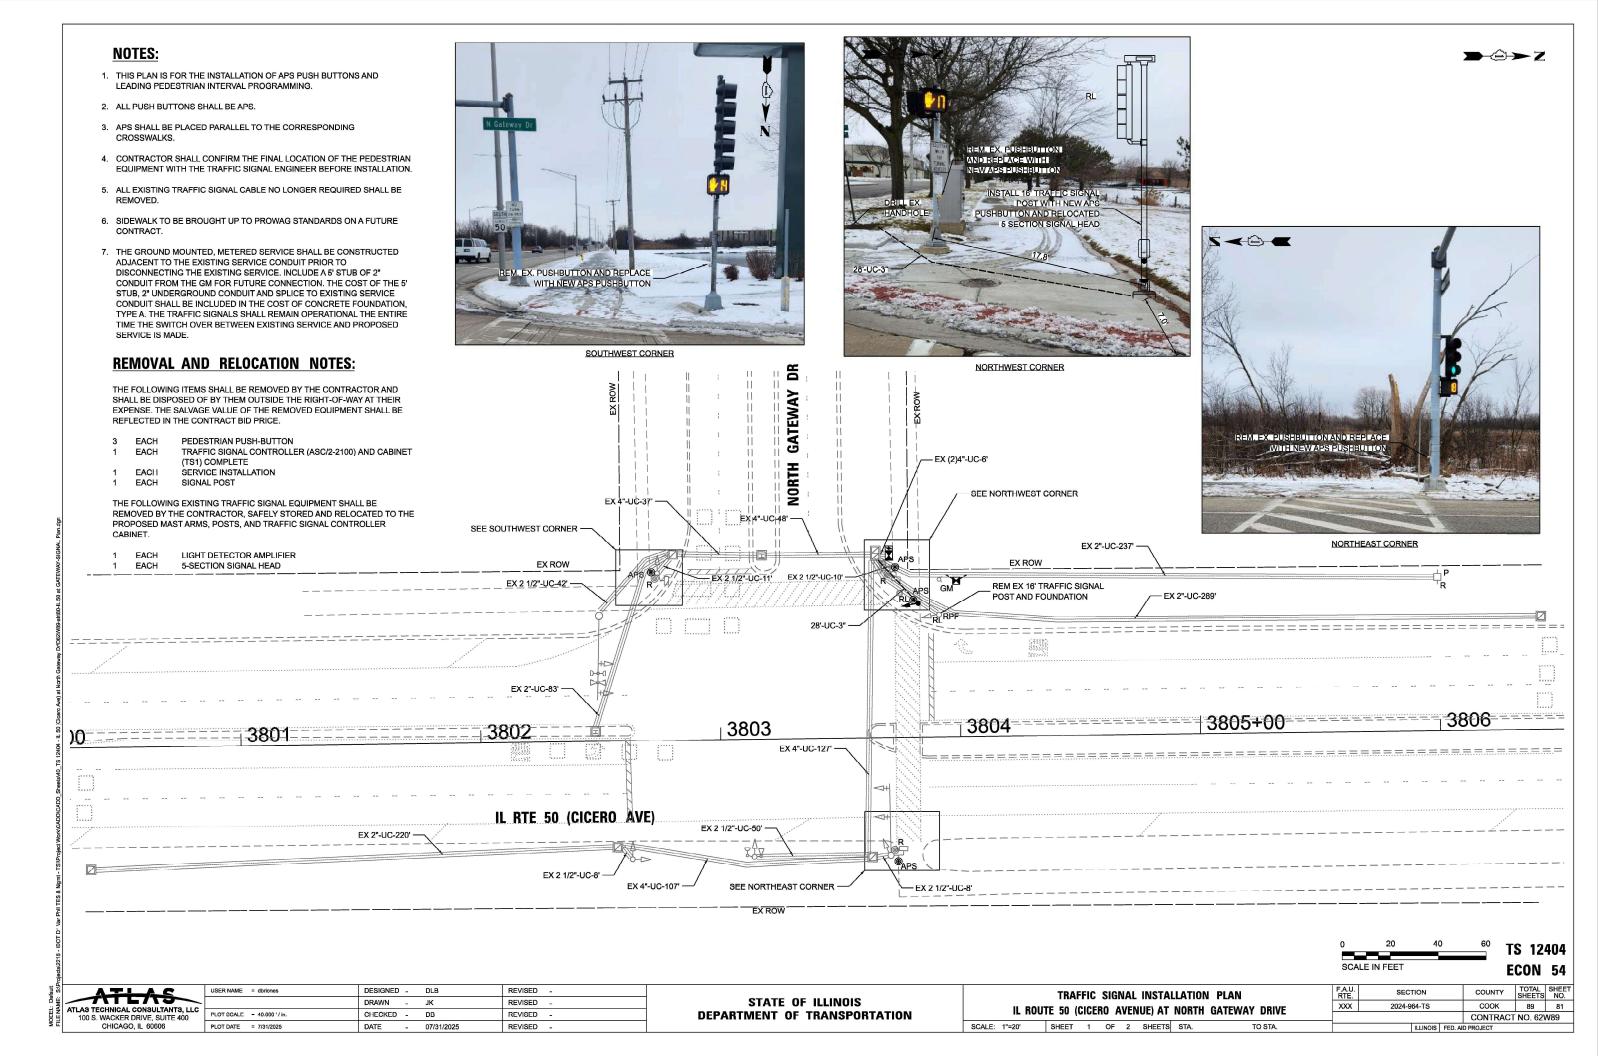




#### **EXISTING AND PROPOSED EMERGENCY VEHICLE PREEMPTION SEQUENCE**



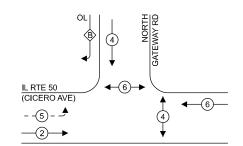

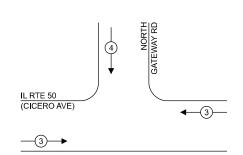

#### **LEGEND**:

**★**PROTECTED PHASE

PROTECTED/PERMITTED PHASE

**←**(\*)**→** PEDESTRIAN PHASE

OL OVERLAP

#### TRAFFIC SIGNAL **ELECTRICAL SERVICE REQUIREMENTS**

TYPE	QUANTITY	UNIT WATTAGE	TOTAL WATTAGE					
ITPE								
SIGNAL HEAD 3 - SECTION	6	11	66.0					
4 - SECTION	-	14	-					
5 - SECTION PROGRAMMABLE SIGNALS	4	13	52.0					
PROGRAMMABLE SIGNALS								
3 - SECTION	-	22	-					
4 - SECTION	-	32	-					
5 - SECTION	-	28	-					
PED. SIGNAL	4	15	60.0					
CONTROLLER	1	150	150.0					
MASTER CONTROLLER	-	100	-					
UPS	1	25	25.0					
5 - SECTION PED. SIGNAL CONTROLLER MASTER CONTROLLER UPS DETECTION RADAR VIDEO	-	20	-					
	-	20	-					
BLANK-OUT SIGN	-	25	-					
NETWORK SWITH II OR III	-	35	-					
CELLULAR MODEM	-	15	-					
TOTA	AL UPS SIZIN	IG = 35	3.0					
UPS CHARGING	1	225	225.0					
BATTERY HEATER MAT	1	180	180.0					
UPS CHARGING BATTERY HEATER MAT CABINET HEATER FLASHER	1	200	200.0					
	-	15	-					
LED STREET NAME SIGN	-	120	-					
LED STREET NAME SIGN LUMINAIRE	-	240	-					
TOTAL SERVICE WIRE SIZING = 958.0								

ENERGY COSTS TO: **VILLAGE OF MATTESON** 4900 VILLAGE COMMONS MATTESON, IL 60443

ENERGY SUPPLY: CONTACT: PAUL EDWARDS PHONE: 773-573-8637

COMPANY: COMMONWEALTH EDISON ACCOUNT NUMBER: \_\_\_ - 582401222


#### RIGHT TURN OVERLAP **PHASE DESIGNATION:**

OVERLAP		PERMISSIVE	PROTECTED	
LETTER		PHASE		PHASE
В	=	4	+	5

#### **NOTES:**

<del>></del>-©→Z

- 1. TIMING CONSULTANT SHALL PROGRAM LEADING PEDESTRIAN INTERVAL FOR PHASE 4. THIS WORK SHALL BE PAID FOR UNDER RE-OPTIMIZE TRAFFIC SIGNAL SYSTEM LEVEL 1.
- THE TRAFFIC SIGNAL CONTROL EQUIPMENT FOR THIS LOCATION SHALL BE ECONOLITE TO MATCH EXISTING ADJACENT SYSTEM.

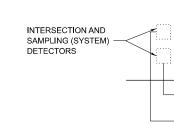

MA ·II

#### SCHEDULE OF QUANTITIES

ITEM DESCRIPTION	UNITS	TOTAL QTY
UNDERGROUND CONDUIT, GALVANIZED STEEL, 3" DIA.	FOOT	26
MAINTENANCE OF EXISTING TRAFFIC SIGNAL INSTALLATION	EACH	1
ELECTRIC CABLE IN CONDUIT, SIGNAL NO. 14 2C	FOOT	63
ELECTRIC CABLE IN CONDUIT, SIGNAL NO. 14 7C	FOOT	70
TRAFFIC SIGNAL POST, 16 FT.	EACH	1
ELECTRIC CABLE IN CONDUIT, SERVICE, NO. 6 2 C	FOOT	70
ELECTRIC CABLE IN CONDUIT, EQUIPMENT GROUNDING CONDUCTOR, NO. 6 1C	FOOT	60
CONCRETE FOUNDATION, TYPE A	FOOT	4
DRILL EXISTING HANDHOLE	EACH	1
RELOCATE EXISTING TRAFFIC SIGNAL EQUIPMENT	EACH	1
RELOCATE EXISTING EMERGENCY VEHICLE PRIORITY SYSTEM, PHASING UNIT	EACH	1
REMOVE EXISTING TRAFFIC SIGNAL EQUIPMENT	EACH	1
REMOVE EXISTING CONCRETE FOUNDATION	EACH	1
SERVICE INSTALLATION, GROUND MOUNTED, METERED	EACH	1
UNINTERRUPTABLE POWER SUPPLY-UPS	EACH	1
FULL-ACTUATED CONTROLLER AND TYPE IV CABINET (SPECIAL)	EACH	1
ACCESSIBLE PEDESTRIAN SIGNALS	EACH	4
RE-OPTIMIZE TRAFFIC SIGNAL SYSTEM LEVEL 1	EACH	1



IL RTE 50 (CICERO AVE)

1#6

1#6

NORTH GATEWAY

(L) \( \sigma \)

TS 12404 ECON 54

EXISTING TRACER CABLE

EXISTING

INTERCONNECT TO WALMART ACCESS DR

TYPE II CABINET -

(3)

RL (A) (A) (A)

(a)(¬)



ISER NAME = dbriones	DESIGNED	-	DLB	REVISED	-
	DRAWN	-	JK	REVISED	-
LOT SCALE = 40.000 '/in.	CHECKED	-	DB	REVISED	-
LOT DATE = 7/31/2025	DATE	-	07/31/2025	REVISED	-

STATE OF ILLINOIS **DEPARTMENT OF TRANSPORTATION** 

EXISTING CA	BLE PL	AN, EX	ISTIN	G PHASE	DESIGN	IATION DIAGRAM AND	F.A.U. RTE	
EMERGENCY VEH	ICLE PI TE 50 (	KEEIVIP (CICER(	NOII VA C	SEQUENO ENUE) AT	CE, AND NORTH	SCHEDULE OF QUANTITIES GATEWAY DRIVE	XXX	
SCALE: N.T.S.	SHEET	2	OF 2	2 SHEETS	STA.	TO STA.		-

(A)

	F.A.U. RTE	SECTION	COUNTY	TOTAL SHEETS	SHEET NO.	
IES	XXX	2024-964-TS		соок	89	82
			CONTRACT NO. 62W89			
		ILLINOIS	FED. A	D PROJECT		

- THIS PLAN IS FOR THE INSTALLATION OF APS PUSH BUTTONS AND LEADING PEDESTRIAN INTERVAL PROGRAMMING.
- 2. ALL PUSH BUTTONS SHALL BE APS.
- 3. APS SHALL BE PLACED PARALLEL TO THE CORRESPONDING CROSSWALKS.
- 4. CONTRACTOR SHALL CONFIRM THE FINAL LOCATION OF THE PEDESTRIAN EQUIPMENT WITH THE TRAFFIC SIGNAL ENGINEER BEFORE INSTALLATION.
- 5. ALL EXISTING TRAFFIC SIGNAL CABLE NO LONGER REQUIRED SHALL BE
- 6. SIDEWALK TO BE BROUGHT UP TO PROWAG STANDARDS ON A FUTURE CONTRACT.

#### **REMOVAL NOTES:**

THE FOLLOWING ITEMS SHALL BE REMOVED BY THE CONTRACTOR AND SHALL BE DISPOSED OF BY THEM OUTSIDE THE RIGHT-OF-WAY AT THEIR EXPENSE. THE SALVAGE VALUE OF THE REMOVED EQUIPMENT SHALL BE REFLECTED IN THE CONTRACT BID PRICE.

EX 2"-UC-142' -

PEDESTRIAN PUSHBUTTON 6 EACH



NORTHWEST CORNER



NORTHEAST CORNER

- EX 2",-UC-55" SEE NORTHWEST CORNER -

EX 2 1/2"-UC-16'

EX 2"-UC-73' -

SMITH

— EX 2 1/2"-UC-11' EX 4"-UC-60'

EX 3"-UC-84' —

EX 1 1/2"-UC-5' -— EX 2"-UC-6' EX 2"-UC-7' — EX 2"-UC-34' —

EX ROW

EX (2)4"-UC-5' -

SEE SOUTHEAST CORNER

SOUTHEAST CORNER

SCALE IN FEET

ECON 9 COUNTY

TS 14715

LAS TECHNICAL CONSULTANTS, LLC 100 S. WACKER DRIVE, SUITE 400 CHICAGO, IL 60606

DESIGNED - DLB USER NAME = dbriones REVISED -DRAWN REVISED PLOT SCALE - 40.000 '/ in. CHECKED -DB REVISED PLOT DATE = 7/31/2025 DATE 07/31/2025 REVISED

STATE OF ILLINOIS **DEPARTMENT OF TRANSPORTATION**  TRAFFIC SIGNAL INSTALLATION PLAN PALATINE ROAD AT SMITH STREET TO STA.

TOTAL SHEET NO. SECTION 2024-964-TS COOK CONTRACT NO. 62W89

SEE SOUTHWEST CORNER

PALATINE RD

- EX 1 1/4"-UC-108'

SOUTHWEST CORNER


SCALE: 1"=20'

- SEE NORTHEAST CORNER


EX 2 1/2"-UC-19'

- EX 2 1/2"-ŬC-36'

SHEET 1 OF 2 SHEETS STA.

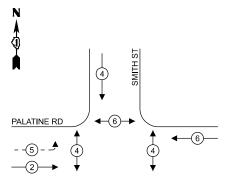

#### **EXISTING AND PROPOSED EMERGENCY VEHICLE PREEMPTION SEQUENCE**

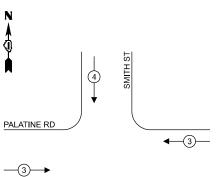

#### **LEGEND**:

**◆**PROTECTED PHASE

PROTECTED/PERMITTED PHASE

PEDESTRIAN PHASE **←**(\*)**→** 

♦ OL OVERLAP

#### **NOTES:**

INTERVAL FOR PHASE 4. THIS WORK SHALL BE PAID FOR UNDER RE-OPTIMIZE TRAFFIC SIGNAL SYSTEM LEVEL 1.

#### (2) 2 (3) (3) (K) X **≫**€ APS 0 0 SMITH (m/>/o) TIMING CONSULTANT SHALL PROGRAM LEADING PEDESTRIAN EXISTING INTERSECTION AND SAMPLING (SYSTEM) DETECTOR EXISTING INTERSECTION AND SAMPLING ( SYSTEM) DETECTOR **PALATINE RD** - O < Z (K) > (D) EXISTING 24F TRACER CABLE EXISTING INTERCONNECT TO BROADWAY ST REMOVE AND REPLACE BATTERIES FOR UNINTERRUPTABLE POWER SUPPLY, EXTENDED SCHEDULE OF QUANTITIES CABLE PLAN

#### TRAFFIC SIGNAL **ELECTRICAL SERVICE REQUIREMENTS**

TYPE	QUANTITY	UNIT WATTAGE	TOTAL WATTAGE		
SIGNAL HEAD 3 - SECTION	7	11	77.0		
4 - SECTION	-	14	-		
5 - SECTION	2	13	26.0		
PROGRAMMABLE SIGNALS					
3 - SECTION	-	22	-		
4 - SECTION	-	32	-		
5 - SECTION	-	28	-		
PED. SIGNAL	6	15	90.0		
CONTROLLER	1	150	150.0		
MASTER CONTROLLER	-	100	-		
UPS	1	25	25.0		
DETECTION RADAR	-	20	-		
VIDEO	-	20	-		
BLANK-OUT SIGN	-	25	-		
NETWORK SWITCH II OR III	-	35	-		
CELLULAR MODEM	-	15	-		
TOTA	L UPS SIZIN	IG = 36	3.0		
UPS CHARGING	1	225	225.0		
BATTERY HEATER MAT	1	180	180.0		
CABINET HEATER	1	200	200.0		
FLASHER	-	15	-		
LED STREET NAME SIGN	-	120	-		
LUMINAIRE	-	240	-		
TOTAL SERVICE WIRE SIZING = 973.0					

ENERGY COSTS TO: VILLAGE OF PALATINE 200 E WOOD ST PALATINE, IL 60067

ENERGY SUPPLY: CONTACT: JAMES CAMPBELL

PHONE: 630-940-6805

COMPANY: COMMONWEALTH EDISON ACCOUNT NUMBER: \_\_\_ - 04074-13000

ITEM DESCRIPTION	UNITS	TOTAL QTY
MAINTENANCE OF EXISTING TRAFFIC SIGNAL INSTALLATION	EACH	1
REMOVE EXISTING TRAFFIC SIGNAL EQUIPMENT	EACH	1
REMOVE AND REPLACE BATTERIES FOR UNINTERUPTABLE POWER SUPPLY, EXTENDED	EACH	1
ACCESSIBLE PEDESTRIAN SIGNALS	EACH	6
RE-OPTIMIZE TRAFFIC SIGNAL SYSTEM LEVEL 1	EACH	1


TS 14715 ECON 9



SER NAME = dbriones	DESIGNED -	DLB	REVISED -
	DRAWN -	JK	REVISED -
LOT SCALE = 40.000'/in.	CHECKED -	DB	REVISED -
LOT DATE = 7/31/2025	DATE -	07/31/2025	REVISED -

STATE OF ILLINOIS **DEPARTMENT OF TRANSPORTATION** 


			1110	F.A.U. RTE	SECTION	COUNTY	TOTAL SHEETS	SHEET NO.
EINERGENCY VEHI		ICE, AND SCHEDULE OF QUAN	AIIIIES	XXX	2024-964-TS	соок	89	84
	PALATINE ROAD AT	SMITH STREET				CONTRACT	NO. 62\	N89
SCALE: N.T.S.	SHEET 2 OF 2 SHEET	SI STA. TO STA.			ILLINOIS FED. A	ID PROJECT		

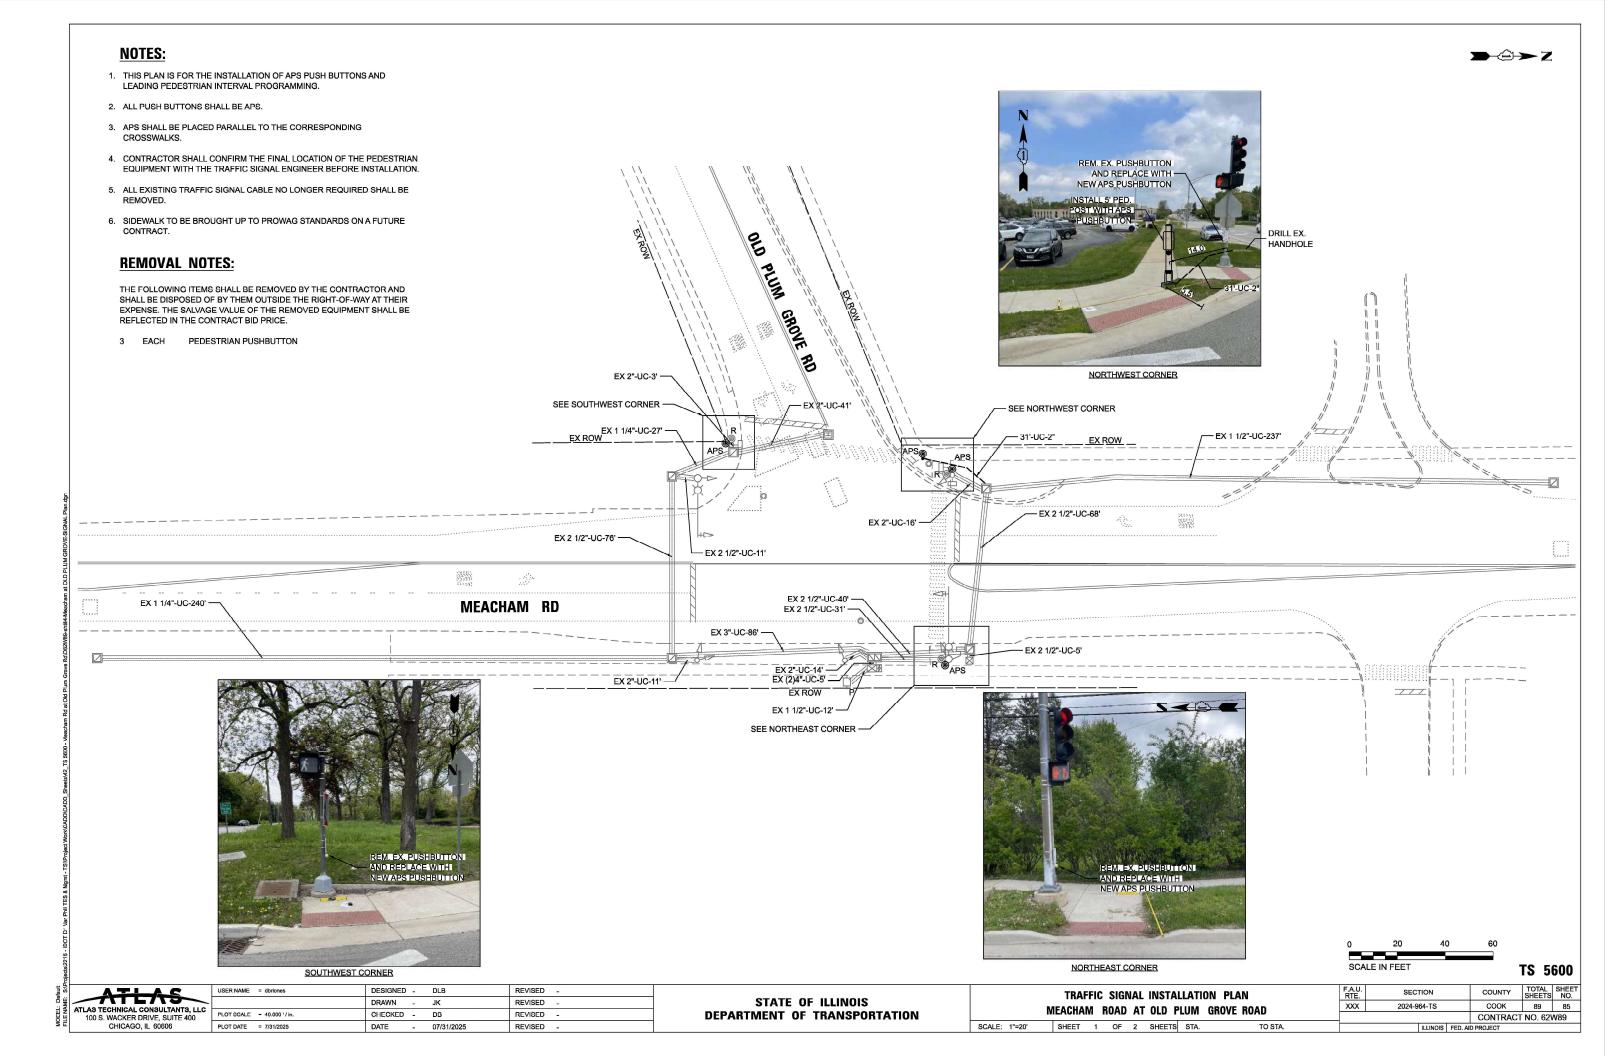


#### EXISTING AND PROPOSED EMERGENCY **VEHICLE PREEMPTION SEQUENCE**





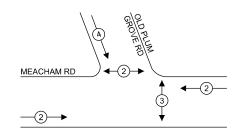

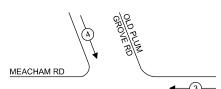

#### LEGEND:

**★** PROTECTED PHASE

← -(\*)- - PROTECTED/PERMITTED PHASE

**◆**(\*)→ PEDESTRIAN PHASE

♦ OL OVERLAP

#### TRAFFIC SIGNAL **ELECTRICAL SERVICE REQUIREMENTS** QUANTITY UNIT TOTAL


TYPE	QUANTITI	WATTAGE	WATTAGE		
SIGNAL HEAD 3 - SECTION	8	11	88.0		
4 - SECTION	-	14	-		
5 - SECTION	-	13	-		
PROGRAMMABLE SIGNALS					
3 - SECTION	-	22	-		
4 - SECTION	-	32	-		
5 - SECTION	-	28	-		
PED. SIGNAL	4	15	60.0		
CONTROLLER	1	150	150.0		
MASTER CONTROLLER	-	100	-		
UPS	1	25	25.0		
DETECTION RADAR	-	20	-		
VIDEO  BLANK-OUT SIGN	-	20	-		
BLANK-OUT SIGN	-	25	-		
NETWORK SWITCH II OR III	-	35	-		
CELLULAR MODEM	-	15	-		
TOTA	AL UPS SIZING = 323.0				
UPS CHARGING	1	225	225.0		
BATTERY HEATER MAT	1	180	180.0		
CABINET HEATER	1	200	200.0		
FLASHER	-	15	-		
LED STREET NAME SIGN	-	120	-		
LED STREET NAME SIGN LUMINAIRE	-	240	-		
TOTAL SERVICE WIRE SIZING = 928.0					

ENERGY COSTS TO: CITY OF ROLLING MEADOWS 3600 KIRCHOFF RD ROLLING MEADOWS, IL 60008

ENERGY SUPPLY: CONTACT: JAMES CAMPBELL PHONE: 630-940-6805

COMPANY:\_


ACCOUNT NUMBER: \_ - 87673-35000

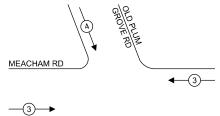

#### **NOTES:**

**>**-->≥ Z

TIMING CONSULTANT SHALL PROGRAM LEADING PEDESTRIAN INTERVAL FOR PHASE 2. THIS WORK SHALL BE PAID FOR UNDER RE-OPTIMIZE TRAFFIC SIGNAL SYSTEM LEVEL 1.

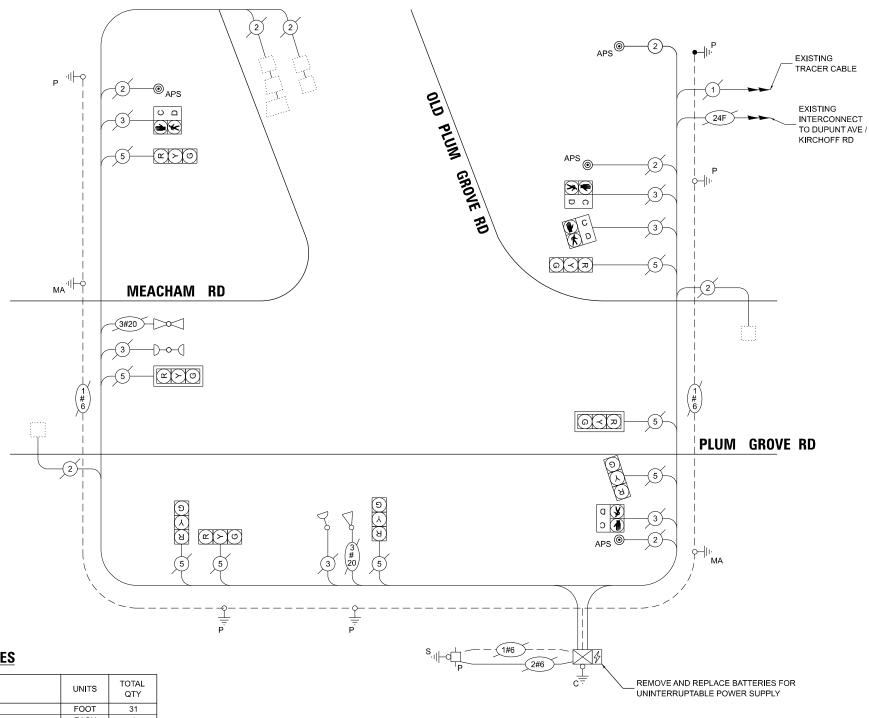

#### SCHEDULE OF QUANTITIES

ITEM DESCRIPTION	UNITS	TOTAL QTY
UNDERGROUND CONDUIT, GALVANIZED STEEL, 2" DIA.	FOOT	31
MAINTENANCE OF EXISTING TRAFFIC SIGNAL INSTALLATION	EACH	1
ELECTRIC CABLE IN CONDUIT, SIGNAL NO. 14 2C	FOOT	194
ELECTRIC CABLE IN CONDUIT, EQUIPMENT GROUNDING CONDUCTOR, NO. 6 1C	FOOT	52
DRILL EXISTING HANDHOLE	EACH	1
MODIFY EXISTING CONTROLLER	EACH	1
REMOVE EXISTING TRAFFIC SIGNAL EQUIPMENT	EACH	1
PEDESTRIAN SIGNAL POST, 5 FT.	EACH	1
REMOVE AND REPLACE BATTERIES FOR UNINTERUPTABLE POWER SUPPLY, EXTENDED	EACH	1
ACCESSIBLE PEDESTRIAN SIGNALS	EACH	4
CONCRETE FOUNDATION, TYPE A 12-INCH DIAMETER	FOOT	4
RE-OPTIMIZE TRAFFIC SIGNAL SYSTEM LEVEL 1	EACH	1

**CABLE PLAN** 


TS 5600



ER NAME = dbriones	DESIGNED - DLB	REVISED -
	DRAWN - JK	REVISED -
DT SCALE = 40.000'/in.	CHECKED - DB	REVISED -
DT DATE = 7/31/2025	DATE - 07/31/2025	REVISED -

STATE OF	ILLINOIS
DEPARTMENT OF T	TRANSPORTATION

EXISTING CABLE PLAN, EXISTING PHASE DESIGNATION DIAGRAM AND	F.A.U. RTE	SECTION	COUNTY	TOTAL SHEETS	SHEET NO.
EMERGENCY VEHICLE PREEMPTION SEQUENCE, AND SCHEDULE OF QUANTITIES	XXX	2024-964-TS	COOK	89	86
MEACHAM ROAD AT OLD PLUM GROVE ROAD			CONTRACT	NO. 62V	V89
SCALE: N.T.S.   SHEET 2 OF 2 SHEETS STA. TO STA.		ILLINOIS FED. AI	ID PROJECT		

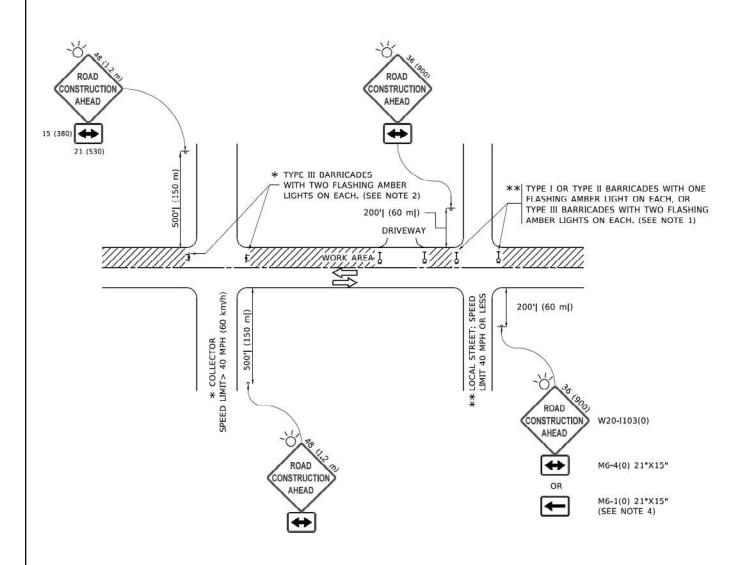

- SIDE ROAD WITH A SPEED LIMIT OF 40 MPH (60 km/h) OR LESS AS SHOWN ON THE DRAWING AND AS DIRECTED BY THE ENGINEER;
- a) ONE "ROAD CONSTRUCTION AHEAD" SIGN 36 x 36 (900x900) WITH A FLASHER MOUNTED ON IT APPROXIMATELY 200' (60 m) IN ADVANCE OF THE MAIN ROUTE.
- b) THE CLOSED PORTION OF THE MAIN ROUTE SHALL BE PROTECTED BY BLOCKING WITH TYPE I, TYPE II OR TYPE III BARRICADES, 1/3 OF THE CROSS SECTION OF THE CLOSED PORTION.
- SIDE ROAD WITH A SPEED LIMIT GREATER THAN 40 MPH (60 km/h) AS SHOWN ON THE DRAWING AND AS DIRECTED BY THE ENGINEER:
  - a) ONE "ROAD CONSTRUCTION AHEAD" SIGN 48 x 48 (1.2 m x 1.2 m) WITH A FLASHER MOUNTED ON IT APPROXIMATELY 500' (150 m) IN ADVANCE OF THE MAIN ROUTE.
  - THE CLOSED PORTION OF THE MAIN ROUTE SHALL BE PROTECTED BY
    b) BLOCKING WITH TYPE III BARRICADES, 1/2 OF THE CROSS SECTION
    OF THE CLOSED PORTION.
- CONES MAY BE SUBSTITUTED FOR BARRICADES OR DRUMS AT HALF THE SPACING DURING DAY OPERATIONS. CONES SHALL BE A MINIMUM OF 28 (710) IN HEIGHT.
- WHEN THE SIDE ROAD LIES BETWEEN THE BEGINNING OF THE MAINLINE
  4. SIGNING AND THE WORK ZONE, A SINGLE HEADED ARROW (M6-1) SHALL
  BE USED IN LIEU OF THE DOUBLE HEADED ARROW (M6-4).

- WHEN WORK IS BEING PERFORMED ON A SIDE ROAD OR DRIVEWAY, FOLLOW THE APPLICABLE STANDARD(S), THE DIRECTIONAL ARROW (M6-1 OR M6-4) SHALL BE COVERED OR REMOVED WHEN NO LONGER CONSISTENT WITH THE TRAFFIC CONTROL SET-UP.
- ADVANCE WARNING SIGNS ARE TO BE OMITTED ON DRIVEWAYS UNLESS OTHERWISE SPECIFIED IN THE PLANS OR BY THE ENGINEER.
- THE TRAFFIC CONTROL AND PROTECTION FOR SIDE ROADS, INTERSECTIONS, AND DRIVEWAYS SHALL BE INCLUDED IN THE COST OF SPECIFIED TRAFFIC CONTROL STANDARDS OR ITEMS.


All dimensions are in inches (millimeters) unless otherwise shown.



USER NAME = dbriones	DESIGNED .	-	DLB	REVISED	-
	DRAWN -	-	JK	REVISED	=
PLOT SCALE - 40.000 '/ in.	CHECKED -	-	DB	REVISED	•
PLOT DATE = 7/31/2025	DATE -	-	07/31/2025	REVISED	-

# TURN BAY ENTRANCE AT START


# OF LANE CLOSURE TAPER

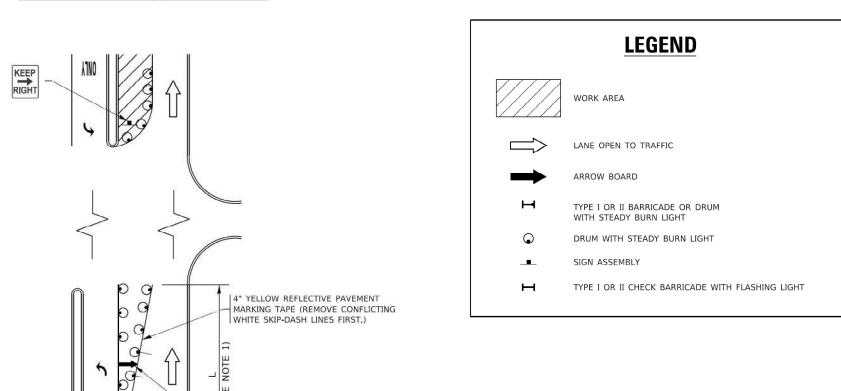



- 1. A) WHEN "L" IS ≤ THE STORAGE LENGTH OF THE TURN LANE (AS SHOWN IN FIG. 1), USE FIGURE 1.
  - B) WHEN "L" IS > THE STORAGE LENGTH OF THE TURN LANE OR THE TURN LANE IS WITHIN THE LANE CLOSURE, USE FIGURE 2.
- 2. CONES MAY BE SUBSTITUTED FOR BARRICADES OR DRUMS AT HALF THE SPACING DURING DAY OPERATIONS. CONES SHALL BE A MINIMUM OF 28 (710) IN HEIGHT.
- 3. LIGHTS WILL NOT BE REQUIRED ON BARRICADES OR DRUMS FOR DAY OPERATIONS. ALL LIGHTS SHALL BE MONODIRECTIONAL.
- 4. REFLECTIVE TEMPORARY PAVEMENT MARKINGS SHALL BE PLACED THROUGHOUT THE BARRICADED AREAS OF EACH TURN BAY AS SHOWN WHERE THE CLOSURE TIME IS GREATER THAN FOURTEEN (14) DAYS.
- 5. THIS APPLICATION ALSO APPLIES WHEN WORK IS BEING PERFORMED IN THE RIGHT LANE(S) AND THE RIGHT TURN BAY IS TO REMAIN OPEN. UNDER THIS CONDITION, "RIGHT TURN LANE" R3-I100R 24 x 24 (600 x 600) AND M6-2R 21 x 15 (530 x 380) SHALL BE USED.
- 6. THESE CONTROLS SHALL SUPPLEMENT MAINLINE TRAFFIC CONTROL FOR LANE CLOSURES.
- 7. THE SIGNS SHALL BE MOUNTED ABOVE THE BARRICADES/DRUMS ON SEPARATE SIGN SUPPORTS THAT MEET NCHRP 350 OR MASH
- 8. TRAFFIC CONTROL AND PROTECTION AT TURN BAYS (TO REMAIN OPEN TO TRAFFIC) SHALL BE INCLUDED IN THE COST OF SPECIFIED TRAFFIC CONTROL STANDARDS OR ITEMS.

### **TURN BAY ENTRANCE** WITHIN A LANE CLOSURE

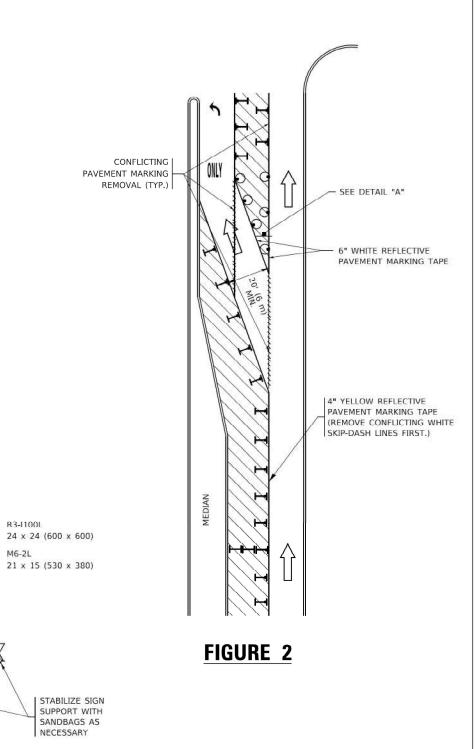

**DETAIL A** 

SCALE: NONE

TURN

LANE

K

M6-2L

All dimensions are in inches (millimeters) unless otherwise shown.



24"X30"


SEE DETAIL "A" -

USER NAME = dbriones	DESIGNED - DLB	REVISED -
	DRAWN - JK	REVISED -
PLOT SCALE - 40.000 '/in.	CHECKED - DB	REVISED -
PLOT DATE = 7/31/2025	DATE - 07/31/2025	REVISED -

FIGURE 1

ARROW BOARD

DISTRICT ONE STANDARD TRAFFIC CONTROL AND PROTECTION DETAIL						F.A.U. RTE.	SEC	TION	COUNTY	TOTAL SHEETS	SHEE NO.			
						XXX	XXX 2024-964-TS		VARIOUS	89	88			
OTANDAND MARTIN CONTINUE AND PROTECTION DETAIL							_	TC-14	l	CONTRACT	NO. 62\	N89		
ONE	SHEET	1	OF	1	SHEETS	STA		TO STA.			ILLINOIS EED A	ID DDO IECT		

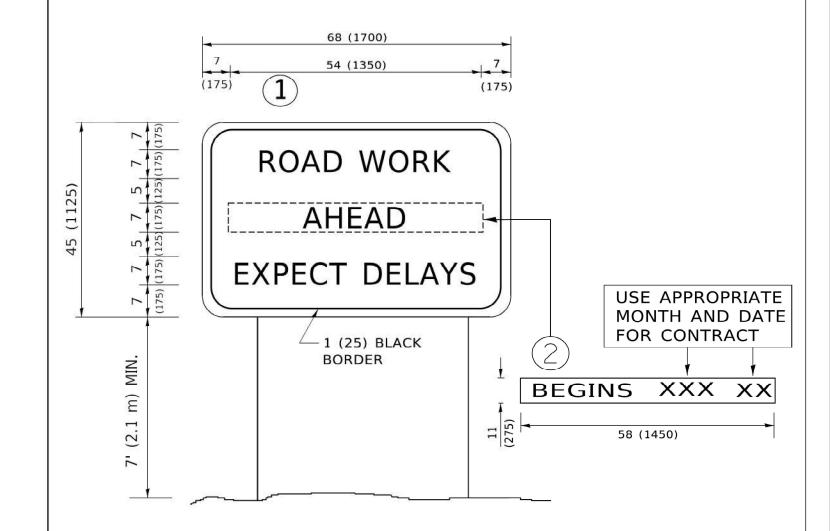

- 1. USE BLACK LETTERING ON ORANGE BACKGROUND.
- 2. ERECT SIGNS IN ADVANCE OF THE LOCATION FOR THE "ROAD CONSTRUCTION AHEAD" SIGN AT LOCATIONS AS DIRECTED BY THE ENGINEER.
- 3. ERECT SIGN 1 WITH INSTALLED PANEL 2 ONE WEEK PRIOR TO THE START OF CONSTRUCTION.
- 4. REMOVE PANEL 2 SOON AFTER THE START OF CONSTRUCTION.
- 5. SEE SPECIAL PROVISION FOR "TEMPORARY INFORMATION SIGNING" FOR ADDITIONAL INFORMATION.
- 6. ONE SIGN ASSEMBLY EQUALS 25.70 SQ. FT. (2.3 SQ. M.)

SCALE: NONE

7. SHALL BE PAID FOR AS TEMPORARY INFORMATION SIGNING.

ALL DIMENSIONS ARE IN INCHES (MILLIMETERS)
UNLESS OTHERWISE SHOWN.



USER NAME = dbriones	DESIGNED	-	DLB	REVISED	-
	DRAWN	-	JK	REVISED	H
PLOT SCALE - 40.000 '/ in.	CHECKED	-	DB	REVISED	-
PLOT DATE = 7/31/2025	DATE	-	07/31/2025	REVISED	_

STATI	E OI	F ILLINOIS
DEPARTMENT	0F	TRANSPORTATION

DISTRICT ONE STANDARD TRAFFIC CONTROL AND PROTECTION DETAIL							F.A.U. RTE.	SECT	TION		COUNT	
						DETAIL	XXX	2024-9	64-TS		VARIO	
CIANDAND HIAITIC CONTINCE AND INCIDENCE DETAIL									TC-22	!		CONTR
ONE	SHEET	1	OF	1	SHEETS	STA.	TO STA.			ILLINOIS	FED. All	PROJECT