09-19-2025 LETTING ITEM 045

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0


# STATE OF ILLINOIS DEPARTMENT OF TRANSPORTATION

FOR INDEX OF SHEETS, SEE SHEET NO. 2
FOR SUMMARY OF QUANTITIES, SEE SHEET NO. 3 - 4

## PROPOSED HIGHWAY PLANS

FAP ROUTE 322 (US 51)
SECTION HMLT2025-1
PROJECT NHPP-Y07P(898)
LIGHTING
MCLEAN COUNTY
C-95-035-25

US 51 & I-74 LOCATION

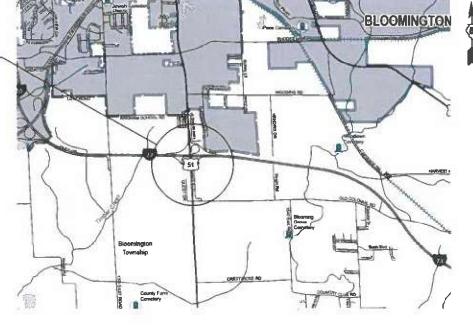

100' 200' 300' — 1"= 100'

0 50' 100' — 1"= 10'

1"= 50'

100' — 1"= 40'

50' — 1"= 30' — 1"= 20'

FULL SIZE PLANS HAVE BEEN PREPARED USING STANDARD ENGINEERING SCALES. REDUCED SIZED PLANS WILL NOT CONFORM TO STANDARD SCALES. IN MAKING MEASUREMENTS ON REDUCED PLANS, THE ABOVE SCALES MAY BE USED.

J.U.L.I.E.
JOINT UTILITY LOCATION INFORMATION FOR EXCAVATION
1-800-892-0123
OR 811

PROJECT ENGINEER: JEFF ALLEN PHONE NUMBER: (217)465-4181

CONTRACT NO. 70H51

#### P-95-009-25



## STATE OF ILLINOIS DEPARTMENT OF TRANSPORTATION

BMITTED 06/27 20 25

Konsel & Flore Hong REGIONAL ENGINEER

ENGINEER OF PESIGN AND ENVIRONMENT

DIRECTOR OF HIGHWAYS PROJECT IN LEMENTATION

PRINTED BY THE AUTHORITY
OF THE STATE OF ILLINOIS

### **INDEX OF SHEETS**

| SHEET NO. | DESCRIPTION                               |
|-----------|---|
| 1         | COVER SHEET                               |
| 2         | INDEX OF SHEETS                           |
| 2         | LIST OF STANDARDS                         |
| 2         | GENERAL NOTES                             |
| 3 - 4     | SUMMARY OF QUANTITIES                     |
| 5 - 11    | LIGHTING REMOVAL PLAN SHEETS              |
| 12 - 18   | PROPOSED LIGHTING PLAN SHEETS             |
| 19        | WIRING DIAGRAMS                           |
| 20        | LUMINARE PERFORMANCE TABLE                |
| 21        | RODENT SHEILD FOR ALUMINUM POLE           |
| 22        | NIGHT TIME INSPECTION OF ROADWAY LIGHTING |

### **GENERAL NOTES**

#### G.N.-100A

ELECTRONIC FILES AND/OR ELECTRONIC SURVEY INFORMATION INCLUDING CADD FILES WILL NOT BE AVAILABLE TO THE CONTRACTOR.

#### G.N. 105.07C

EXISTING STATE-OWNED AND MAINTAINED UNDERGROUND UTILITY FACILITIES EXIST WITHIN THE ROW. THE DEPARTMENT IS NOT A MEMBER OF JULIE AND DOES NOT LOCATE IT'S OWN FACILITIES. THE CONTRACTOR SHALL BE RESPONSIBLE AT THEIR OWN EXPENSE FOR SECURING AN APPROVED LOCATING FIRM TO LOCATE ALL EXISTING IDOT UNDERGROUND FACILITIES PRIOR TO COMMENCING ANY EXCAVATION, PER THE REQUIREMENTS OF ARTICLE 803 OF THE STARDARD SPECIFICATIONS. UTILITY LOCATES MAY ALSO BE REQUIRED OUTSIDE THE PROJECT LIMITS, SUCH AS FOR TRAFFIC CONTROL SIGNING AND OTHER ITEMS THE CONTRACTOR MAY OBTAIN, ON REQUEST, PLANS OF EXISTING ELECTRICAL FACILITIES FROM THE DEPARTMENT FOR FURTHER INFORMATION. THE CONTRACTOR MAY CONTACT THE DISTRICT TRAFFIC OPERATIONS ENGINEER, ROBERT HODGSON, 217-712-9018.

THE CONTRACTOR SHALL ALSO BE RESPONSIBLE FOR LOCATING AND PROVIDING PROTECTION FOR FACILITIES DURING ALL PHASES OF CONSTRUCTION. IF, AT ANY TIME, THE FACILITIES ARE DAMAGED, THE CONTRACTOR SHALL IMMEDIATELY NOTIFY THE DEPARTMENT AND MAKE ALL NECESSARY ARRANGEMENTS FOR REPAIR TO THE SATISFACTION OF THE ENGINEER. THIS WORK SHALL BE INCLUDED IN THE CONTRACT BID PRICE AND NO ADDITIONAL COMPENSATION WILL BE ALLOWED.

#### MISC. ELECTRICAL GENERAL NOTES

- THE CONTRACTOR IS RESPONSIBLE FOR UNCOVERING OR HAND DIGGING AROUND UTILITIES AS NECESSARY.
   THE COST OF THIS WORK IS TO BE INCLUDED WITH THE APPLICABLE UNDERGREOUND CONDUIT OR UNIT DUCT PAY ITEM.
- 2. EXISTING SIGN LIGHTING TO REMAIN IN PLACE AND BE REMOVED BY OTHERS

## **LIST OF HIGHWAY STANDARDS**

| STANDARD NO. | DESCRIPTION   |
|--------------|---|
| 000001-08    | STANDARD SYMBOLS, ABBREVIATIONS AND PATTERNS                                      |
| 001006       | DECIMAL OF AN INCH AND OF A FOOT  |
| 701101-05    | OFF-RD OPERATIONS, MULTILANE, 15' (4.5M) TO 24" (600MM) FROM PAVEMENT EDGE        |
| 701400-12    | APPROACH TO LANE CLOSURE, FREEWAY/EXPRESSWAY                                      |
| 701406-13    | LANE CLOSURE, FREEWAY/EXPRESSWAY, DAY OPERATIONS ONLY                             |
| 701421-08    | LANE CLOSURE, MULTILANE, DAY OPERATIONS ONLY, FOR SPEEDS $\geq$ 45 MPH TO 55 MPH. |
| 701456-05    | PARTIAL EXIT RAMP CLOSURE, FREEWAY/EXPRESSWAY                                     |
| 701701-10    | URBAN LANE CLOSURE, MULTILANE INTERSECTION  |
| 701901-10    | TRAFFIC CONTROL DEVICES   |
| 805001-01    | ELETRIC SERVICE INSTALLATION DETAILS  |
| 821101-03    | LUMINAIRE WIRING IN POLE  |
| 825011-04    | LIGHTING CONTROLLER PEDESTAL MOUNTED, 240V  |
| 830006-05    | LIGHT POLE ALUMINUM DAVIT ARM   |
| 836001-05    | LIGHT POLE FOUNDATION   |
| 838001-01    | BREAKAWAY DEVICES   |

#### **LEGEND**

| R                | EXISTING ELECTRIC SERVICE TO BE REMOVED.  |
|------------------|---|
| R                | EXISTING LIGHTING CONTROLLER TO BE REMOVED.   |
|                  | PROPOSED LIGHTING CONTROLLER, 240V, 60A.  |
| ○—○ <sup>R</sup> | EXISTING LIGHTING UNIT TO BE REMOVED.   |
| O J O R          | EXISTING HIGHMAST TOWER LIGHTING UNIT TO BE REMOVED.  |
| •••              | PROPOSED LIGHTING UNIT, LUMINAIRE, LED, ROADWAY,<br>OUTPUT DESIGNATION H, 45 FT ALUMINUM POLE,<br>15 FT MAST ARM, BREAKAWAY COUPLINGS WITH SS SCREEN,<br>ON METAL FOUNDATION. |
| ~ ~ ~            | EXISTING ELECTRIC CABLE IN CONDUIT TO BE REMOVED.   |
|                  | PROPOSED UNIT DUCT, 600V, 2-1C NO. 8, 1/C NO. 8 GROUND (XLP-TYPE USE), 3/4" DIA. POLYETHYLENE. (UNLESS STATED OTHERWISE)  |
|                  | PROPOSED COILABLE NONMETALLIC CONDUIT 2" DIA.<br>LENGTH AS NOTED.   |

STATE OF ILLINOIS
DEPARTMENT OF TRANSPORTATION

INDEX OF SHEETS, HIGHWAY STANDARDS,
GENERAL NOTES & LEGEND

SHEET 1 OF 1 SHEETS STA. TO STA.

FA.P. SECTION COUNTY TOTAL SHEETS NO.
322 HMLT2025-1 MCLEAN 22 2
CONTRACT NO. 70H51

| FAP 322 / US 51            | LOCATION OF WORK:       |
|----------------------------|-------------------------|
| STA. 2080+60 TO STA. 37+50 |                         |
| FREEWAY                    |                         |
| URBAN                      |                         |
| MCLEAN                     | COUNTY:                 |
| 80% FED / 20% STATE        | FUNDING BREAKOUT:       |
| 0021                       | CONSTRUCTION TYPE CODE: |
|                            |                         |

| CODE NO.               | ITEM  | UNIT     | TOTAL QUANTITY | QUANTITY |
|------------------------|---|----------|----------------|----------|
| 67100100               | MOBILIZATION  | LUMP SUM | 1.0            | 1.0      |
|                        |   |          |                |          |
| 70100700               | TRAFFIC CONTROL AND PROTECTION, STANDARD 701406                                     | LUMP SUM | 1.0            | 1.0      |
| 70100310               | TRAFFIC CONTROL AND PROTECTION, STANDARD 701421                                     | LUMP SUM | 1.0            | 1.0      |
| 70100825               | TRAFFIC CONTROL AND PROTECTION, STANDARD 701456                                     | LUMP SUM | 1.0            | 1.0      |
| 70102635               | TRAFFIC CONTROL AND PROTECTION, STANDARD 701701                                     | LUMP SUM | 1.0            | 1.0      |
| 80400100               | ELECTRIC SERVICE INSTALLATION   | EACH     | 2.0            | 2.0      |
| 80400200               | ELECTRIC UTILITY SERVICE CONNECTION   | LUMP SUM | 1.0            | 1.0      |
| 81028240               | UNDERGROUND CONDUIT, GALVANIZED STEEL, 4" DIA.                                      | FOOT     | 220.0          | 220.0    |
| 81028750               | UNDERGROUND CONDUIT, COILABLE NONMETALLIC, 2" DIA.                                  | FOOT     | 1,030.0        | 1,030.0  |
| 81603000               | UNIT DUCT, 600V, 2-1C NO.8, 1/C NO.8 GROUND, (XLP-TYPE USE), 3/4" DIA. POLYETHYLENE | FOOT     | 14,355.0       | 14,355.0 |
| 82110007               | LUMINAIRE, LED, ROADWAY, OUTPUT DESIGNATION G                                       | EACH     | 61.0           | 61.0     |
| 82500330               | LIGHITNG CONTROLLER, PEDESTAL MOUNTED, 240VOLT, 60AMP                               | EACH     | 2.0            | 2.0      |
| 83003600               | LIGHT POLE, ALUMINUM, 45 FT. M.H., 15 FT. DAVIT ARM                                 | EACH     | 61.0           | 61.0     |
| 83600356               | LIGHT POLE FOUNDATION, METAL, 15" BOLT CIRCLE 8 5/8" X 6"                           | EACH     | 61.0           | 61.0     |
| DENOTES SPECIALTY ITEM |   |          |                |          |

MODEL: SOQ 1 [Sheet]
FILE NAME: c:\pw\_worktpwidot\projects\d10

|     | USER NAME = Justin.Cearlock | DESIGNED  | REVISED _ |  |
|-----|-----------------------------|-----------|-----------|--|
| - J |                             | DRAWN -   | REVISED _ |  |
|     |                             | CHECKED - | REVISED - |  |
|     | PLOT DATE = 1/14/2025       | DATE _    | REVISED _ |  |

| STATE OF ILLINOIS            |
|------------------------------|
| DEPARTMENT OF TRANSPORTATION |

SCALE:

|  | F.A.P.<br>RTE. | SECT     |   |        |      |         |  |  |
|--|----------------|----------|---|--------|------|---------|--|--|
|  | 322            | HMLT2025 |   |        |      |         |  |  |
|  |                |          |   |        |      |         |  |  |
|  | SHEET 1        | OF       | 2 | SHEETS | STA. | TO STA. |  |  |

LOCATION OF WORK: STA. 2080+60 TO STA. 37+50 COUNTY: FUNDING BREAKOUT: 80% FED / 20% STATE

FAP 322 / US 51

FREEWAY URBAN

MCLEAN

0021

CONSTRUCTION TYPE CODE:

| CODE NO.           | <u>ITEM</u>  | <u>UNIT</u> | TOTAL QUANTITY | <u>QUANTITY</u> |
|--------------------|--|-------------|----------------|-----------------|
|                    |  |             |                |                 |
| 83800650           | BREAKAWAY DEVICE, COUPLING WITH STAINLESS STEEL SCREEN | EACH        | 244.0          | 244.            |
| 84200600           | REMOVAL OF LIGHTING UNIT, NO SALVAGE                   | EACH        | 27.0           | 27.             |
| 84200605           | REMOVAL OF LIGHTING TOWER, NO SALVAGE                  | EACH        | 5.0            | 5.              |
| 84200804           | REMOVAL OF POLE FOUNDATION                             | EACH        | 27.0           | 27.             |
| 84500110           | REMOVAL OF LIGHTING CONTROLLER                         | EACH        | 2.0            | 2.              |
| 84500120           | REMOVAL OF ELECTRIC SERVICE INSTALLATION               | EACH        | 2.0            | 2.              |
| 84500130           | REMOVAL OF LIGHTING CONTROLLER FOUNDATION              | EACH        | 1.0            | 1.              |
| 89502300           | REMOVE ELECTRIC CABLE FROM CONDUIT                     | FOOT        | 33,098.0       | 33,098          |
| X8420510           | REMOVAL OF TOWER FOUNDATION                            | EACH        | 5.0            | 5               |
| X8730105           | ELECTRICAL CABLE IN CONDUIT, SIGNAL NO. 10 3C          | FOOT        | 697.0          | 697             |
| X8950450           | REMOVE EXISTING UNDERGROUND CONDUIT                    | FOOT        | 70.0           | 70              |
| Z0013798           | CONSTRUCTION LAYOUT                                    | LUMP SUM    | 1.0            | 1               |
|                    |  |             |                |                 |
| TES SPECIALTY ITEM |  |             |                |                 |

USER NAME = Justin.Cearlock DESIGNED -REVISED -REVISED -DRAWN -CHECKED -REVISED -PLOT DATE = 1/23/2025 DATE REVISED -

STATE OF ILLINOIS
DEPARTMENT OF TRANSPORTATION

SCALE:

F.A.P. RTE. 322 SECTION SUMMARY OF QUANTITIES HMLT2025-1 SHEET 2 OF 2 SHEETS STA. TO STA.



STATE OF ILLINOIS DEPARTMENT OF TRANSPORTATION US-51 AND 1-74
LIGHTING REMOVAL PLAN
LE: SHEET 1 OF 7 SHEETS STA.

 
 F.A.P. RTE.
 SECTION
 COUNTY SHEETS NO.
 TOTAL SHEETS NO.
 SHEET NO.

 322
 HMLT2025-1
 MCLEAN
 22
 5

 CONTRACT NO. 70H51

 LLINOIS FED. AID PROJECT

STATE OF ILLINOIS DEPARTMENT OF TRANSPORTATION

DRAWN -

PLOT DATE = 1/6/2025

CHECKED -

REVISED -

REVISED -

SECTION

CONTRACT NO. 70H51

HMLT2025-1

US-51 AND I-74


LIGHTING REMOVAL PLAN


TO STA.

SHEET 2 OF 7 SHEETS STA.

| USER NAME = Justin.Cearlock | DESIGNED - | REVISED - |                              | US-51 AND I-74        |         |                   |          |      |          |  | SECTION         | COUNTY    | TOTAL SI | HEET<br>NO |  |  |  |  |    |   |
|-----------------------------|------------|-----------|------------------------------|-----------------------|---------|-------------------|----------|------|----------|--|-----------------|-----------|----------|------------|--|--|--|--|----|---|
|                             | DRAWN -    | REVISED - |                              | LIGHTING REMOVAL PLAN |         | STATE OF ILLINOIS |          |      |          |  |                 |           |          |            |  |  |  |  | 22 | 7 |
|                             | CHECKED -  | REVISED - | DEPARTMENT OF TRANSPORTATION |                       |         | G KEINIO          | VAL PLAN |      |          |  | CONTRACT        | NO. 70H5  | ,        |            |  |  |  |  |    |   |
| PLOT DATE = 1/6/2025        | DATE -     | REVISED - |                              | SCALE:                | SHEET 3 | OF 7              | SHEETS   | STA. | TO STA.  |  | ILLINOIS FED. A | D PROJECT |          |            |  |  |  |  |    |   |
| <br><u> </u>                | <u> </u>   | ·         |                              |                       |         |                   |          |      | <u> </u> |  | ·               |           |          |            |  |  |  |  |    |   |

SCALE IN FEET

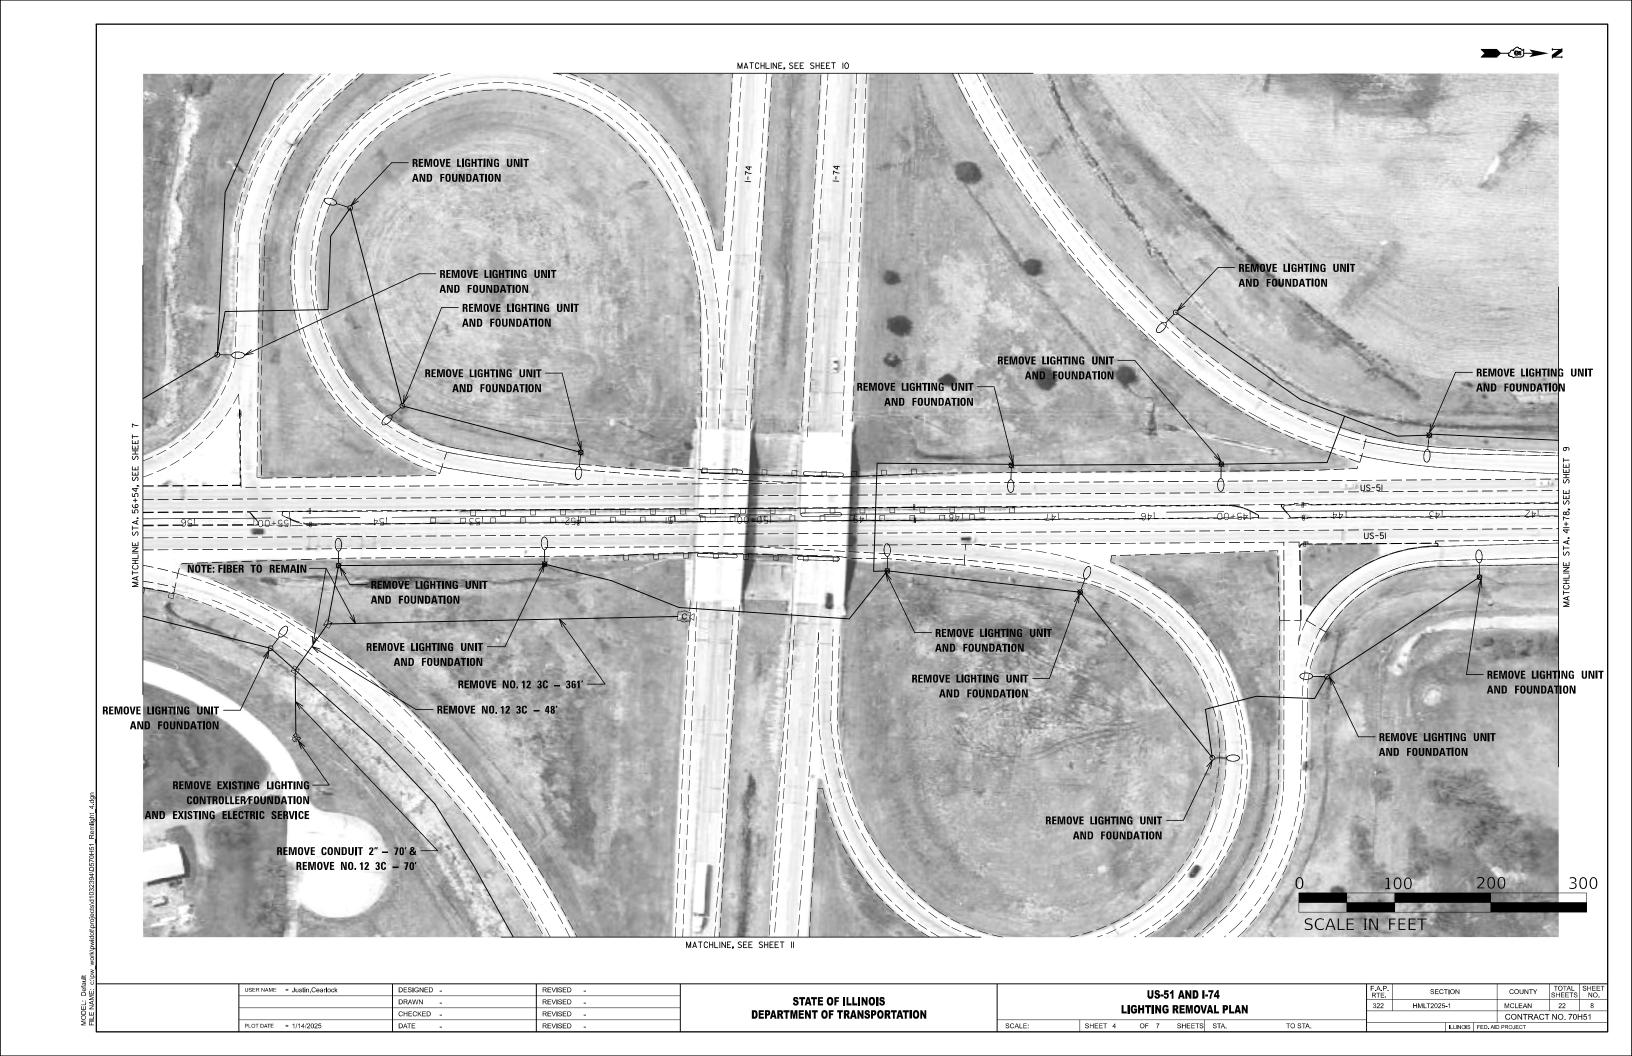

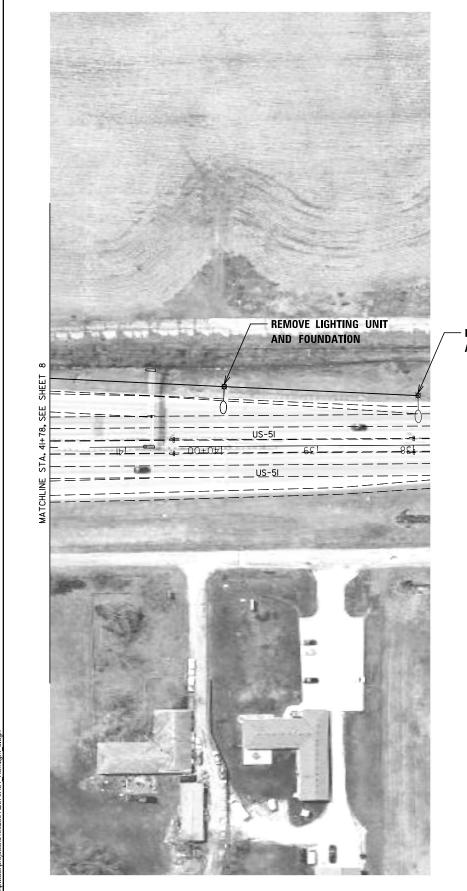


REMOVE LIGHTING UNIT AND FOUNDATION



| USER NAME = Justin.Cearlock | DESIGNED - | REVISED - |                              |
|-----------------------------|------------|-----------|------------------------------|
|                             | DRAWN -    | REVISED - | STATE OF ILLINOIS            |
|                             | CHECKED -  | REVISED - | DEPARTMENT OF TRANSPORTATION |
| PLOT DATE = 1/6/2025        | DATE -     | REVISED - |                              |
|                             |            |           |                              |

| US-51 AND I-74<br>LIGHTING REMOVAL PLAN |                       |    |   |        |      | F.A.P.<br>RTE | SEC                       | TION |        | COUNTY | TOTAL<br>SHEETS | SHEE<br>NO. |     |
|---|-----------------------|----|---|--------|------|---------------|---------------------------|------|--------|--------|-----------------|-------------|-----|
|   |                       |    |   |        |      | 322           | HMLT2025                  |      | MCLEAN | 22     | 9               |             |     |
|   | LIGHTING REMOVAL FLAN |    |   |        |      |               |                           |      |        |        | CONTRAC         | T NO. 701   | H51 |
|   | SHEET 5               | OF | 7 | SHEETS | STA. | TO STA.       | ILLINOIS FED. AID PROJECT |      |        |        |                 |             |     |

SCALE:

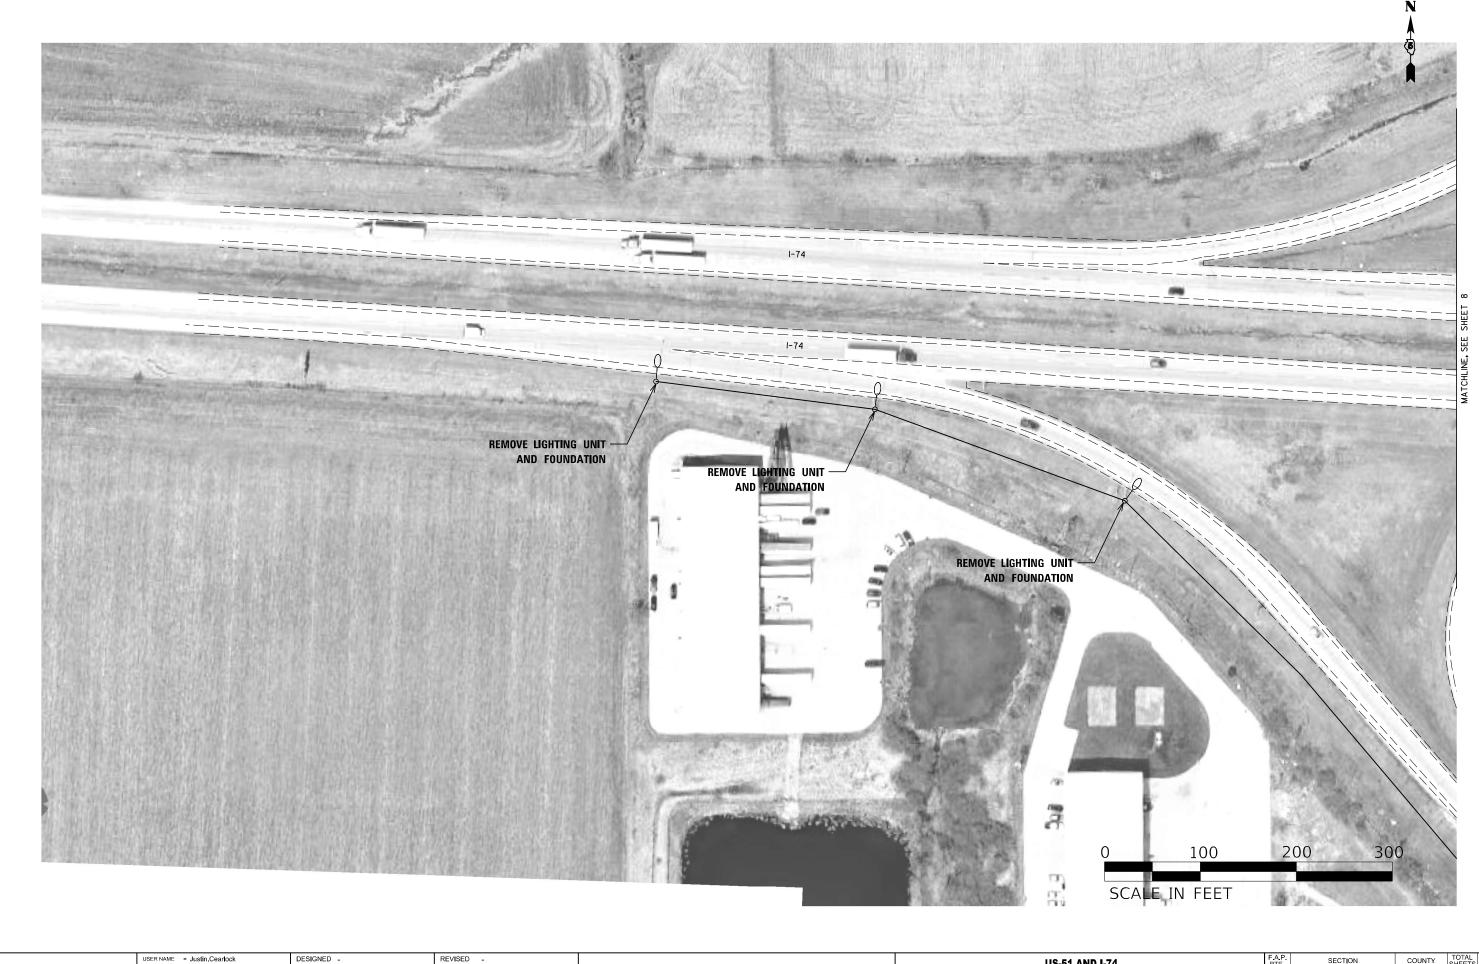


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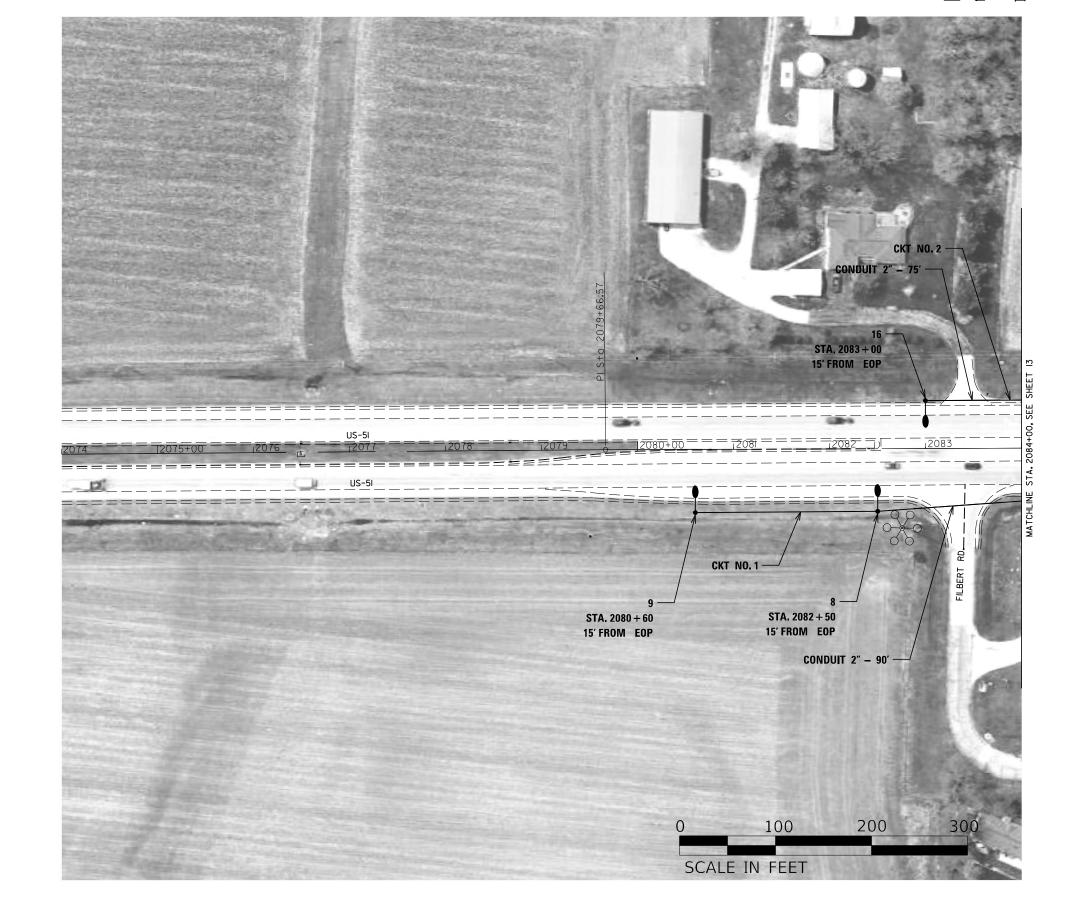
DRAWN -

CHECKED -

PLOT DATE = 1/6/2025

STATE OF ILLINOIS DEPARTMENT OF TRANSPORTATION



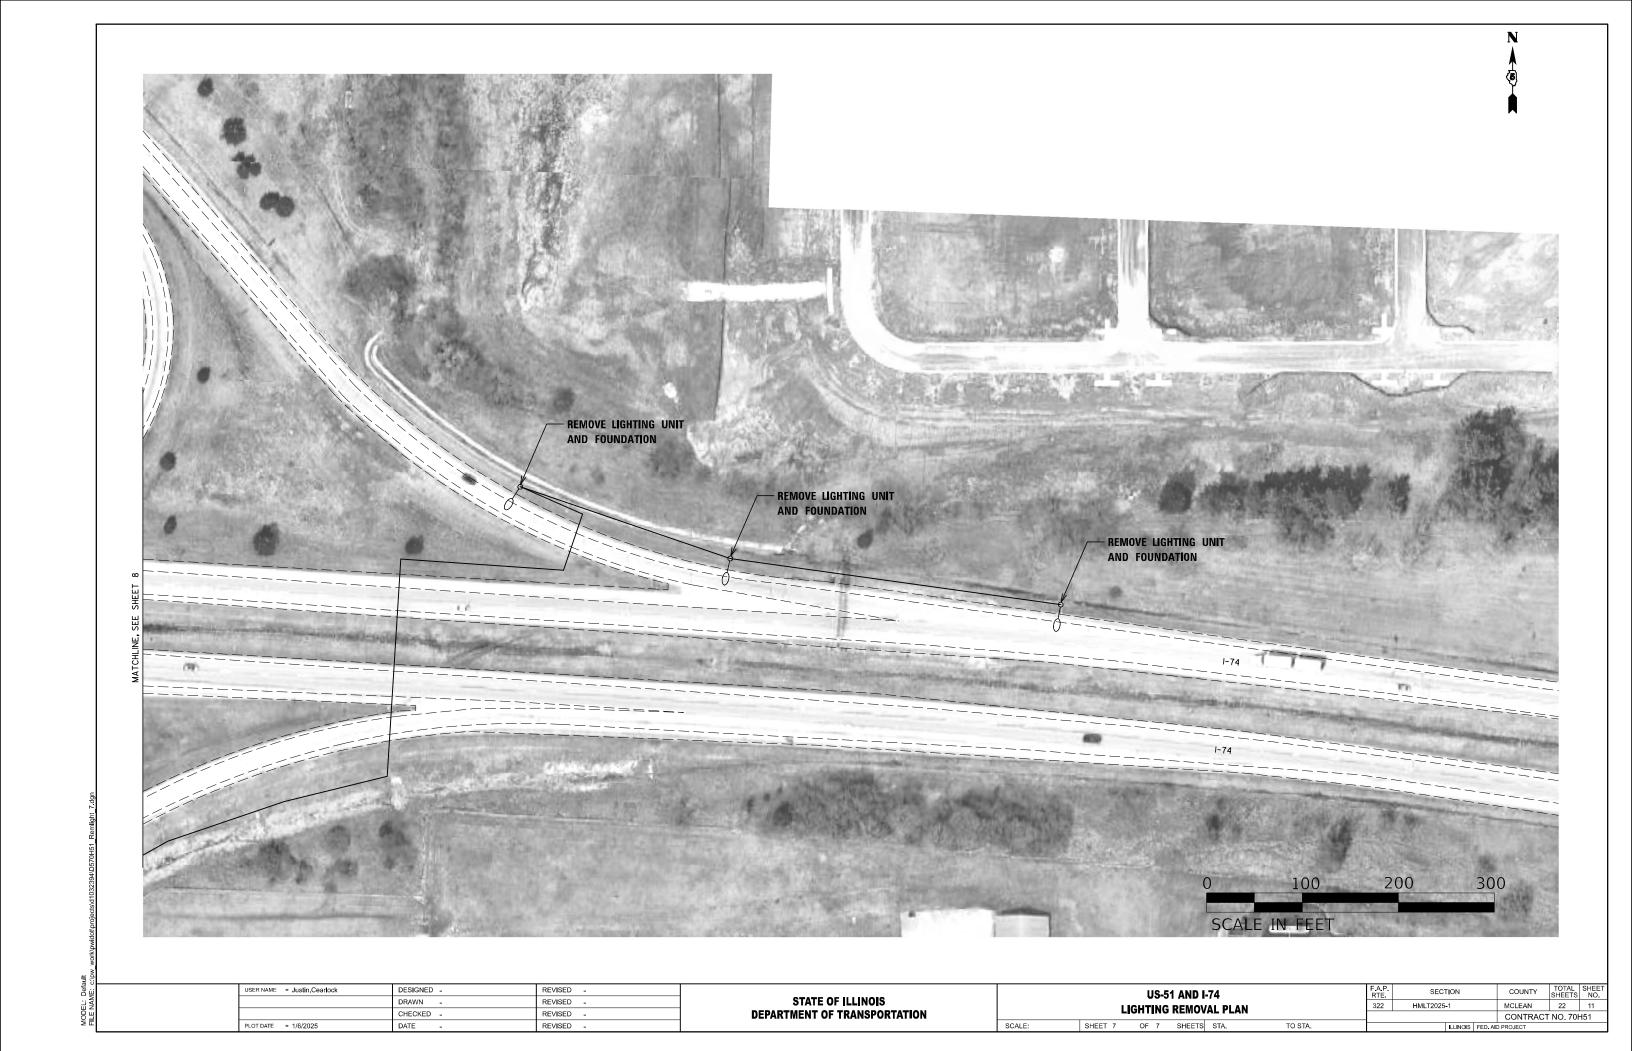

USER NAME = Justin.Cearlock

PLOT DATE = 1/7/2025

 DESIGNED REVISED 

 DRAWN REVISED 

 CHECKED REVISED 

 DATE REVISED

STATE OF ILLINOIS DEPARTMENT OF TRANSPORTATION 
 US-51 AND I-74

 PROPOSED LIGHTING PLAN

 SHEET 1
 OF 7
 SHEETS
 STA.
 TO STA.

DRAWN -

DATE

PLOT DATE = 1/7/2025

CHECKED -


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REVISED -

STATE OF ILLINOIS DEPARTMENT OF TRANSPORTATION

US-51 AND I-74 PROPOSED LIGHTING PLAN SHEET 2 OF 7 SHEETS STA. TO STA.

SECTION COUNTY 322 HMLT2025-1 MCLEAN 22 13 CONTRACT NO. 70H51

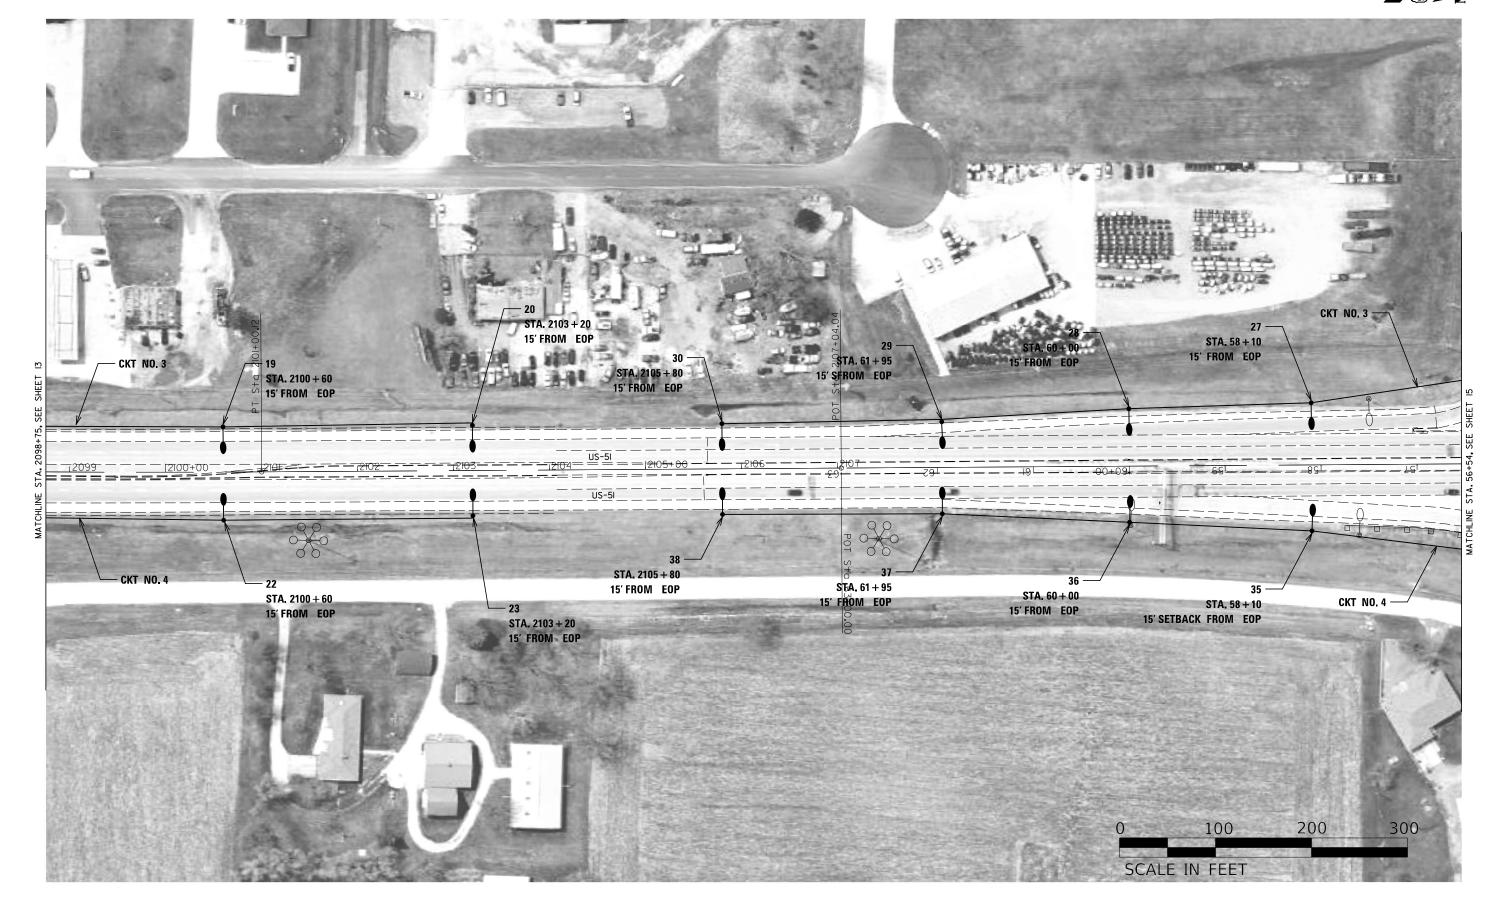

STATE OF ILLINOIS
DEPARTMENT OF TRANSPORTATION

US-51 AND I-74
PROPOSED LIGHTING PLAN

SHEET 3 OF 7 SHEETS STA. TO STA.

F.A.P. SECTION COUNTY TOTAL SHEETS NO.
322 HMLT2025-1 MCLEAN 22 14

CONTRACT NO. 70H51

| ILLINOIS | FED. AID PROJECT


**→**®→Z MATCHLINE, SEE SHEET 17 CONDUIT 2" - 40' CONDUIT 2" - 35' - CONDUIT 2" - 40' STA. 54 + 52 PROPOSED LIGHTING CONTROLLER & FOUNDATION 15' FROM EOP PEDESTAL MOUNT, 240V WITH 15A BREAKER FOR PTZ CAMERA CONDUIT 2" - 330' -1 - NO. 10 3C - 333' STA, 45 + 10 15' FROM EOP PROPOSED | ELECTRIC | SERVICE CKT NO. 3 **CKT NO. 1** STA. 53 + 35 STA, 43 + 20 15' FROM EOP 15' FROM EOP STA. 55 + 73 STA. 51 |+ 55 STA. 45 + 80 15' FROM EOP 15' FROM EOP 15' FROM EOP 15' FROM EOP STA. 56 + 3015' FROM EOP CONDUIT 2" - 95' STA. 54 + 15 - CKT NO. 4 STA. 51 + 55 CONDUIT 2" - 95' 15' FROM EOP STA. 48 + 40 15' FROM EOP 15' FROM EOP STA. 43 + 20 STA, 46 + 50 15' FROM EOP 15' FROM EOP CONDUIT 2" - 40' 1 - NO.10 3C - 364' CKT NO. 2 -STA. 44 + 20 TO BE PLACED IN 15' FROM EOP **EXISTING CONDUIT** STA. 54 + 58 15' FROM EOP STA, 45 + 52 15' FROM EOP **CONDUIT 2" - 35'** STA. 56 + 20**CONDUIT 2" - 35"** 15' FROM EOP 200 300 100 SCALE IN FEET MATCHLINE, SEE SHEET 18 USER NAME = Justin.Cearlock DESIGNED -REVISED -SECTION COUNTY US-51 AND I-74 STATE OF ILLINOIS
DEPARTMENT OF TRANSPORTATION DRAWN -REVISED -322 HMLT2025-1 MCLEAN 22 15 PROPOSED LIGHTING PLAN CHECKED -REVISED -CONTRACT NO. 70H51

SHEET 4 OF 7 SHEETS STA.

TO STA.

PLOT DATE = 1/9/2025

DATE

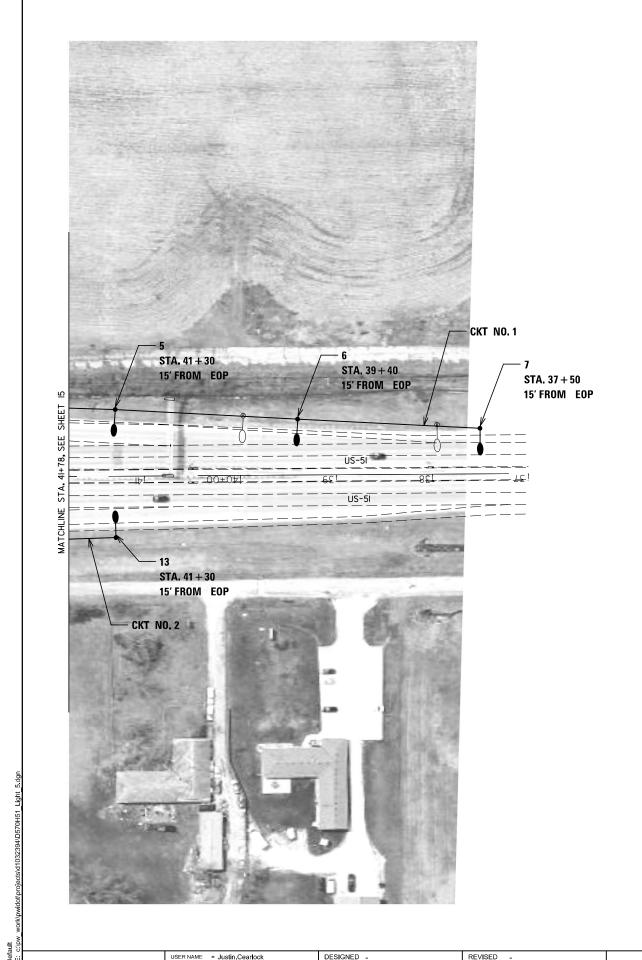


0 100 200 300 SCALE IN FEET

| OSER NAME = JUSTIII. CEARIOCK | DESIGNED - | KEVISED - |  |
|-------------------------------|------------|-----------|--|
|                               | DRAWN -    | REVISED - |  |
|                               | CHECKED -  | REVISED - |  |
| PLOT DATE = 1/6/2025          | DATE -     | REVISED - |  |

| STATE OF ILLINOIS            |
|------------------------------|
| DEPARTMENT OF TRANSPORTATION |

|  | US-51 AND I-74         |   |    |   |        | F.A.P. SECTION |         | COUNTY           | TOTAL<br>SHEETS | SHEE<br>NO. |          |        |     |
|--|------------------------|---|----|---|--------|----------------|---------|------------------|-----------------|-------------|----------|--------|-----|
|  | PROPOSED LIGHTING PLAN |   |    |   |        |                | 322     | HMLT2025-1       |                 | MCLEAN      | 22       | 16     |     |
|  |                        |   |    |   |        |                | -114    |                  |                 |             | CONTRACT | NO. 70 | H51 |
|  | SHEET                  | 5 | OF | 7 | SHEETS | STA.           | TO STA. | ILLINOIS FED. AI |                 |             | PROJECT  |        |     |

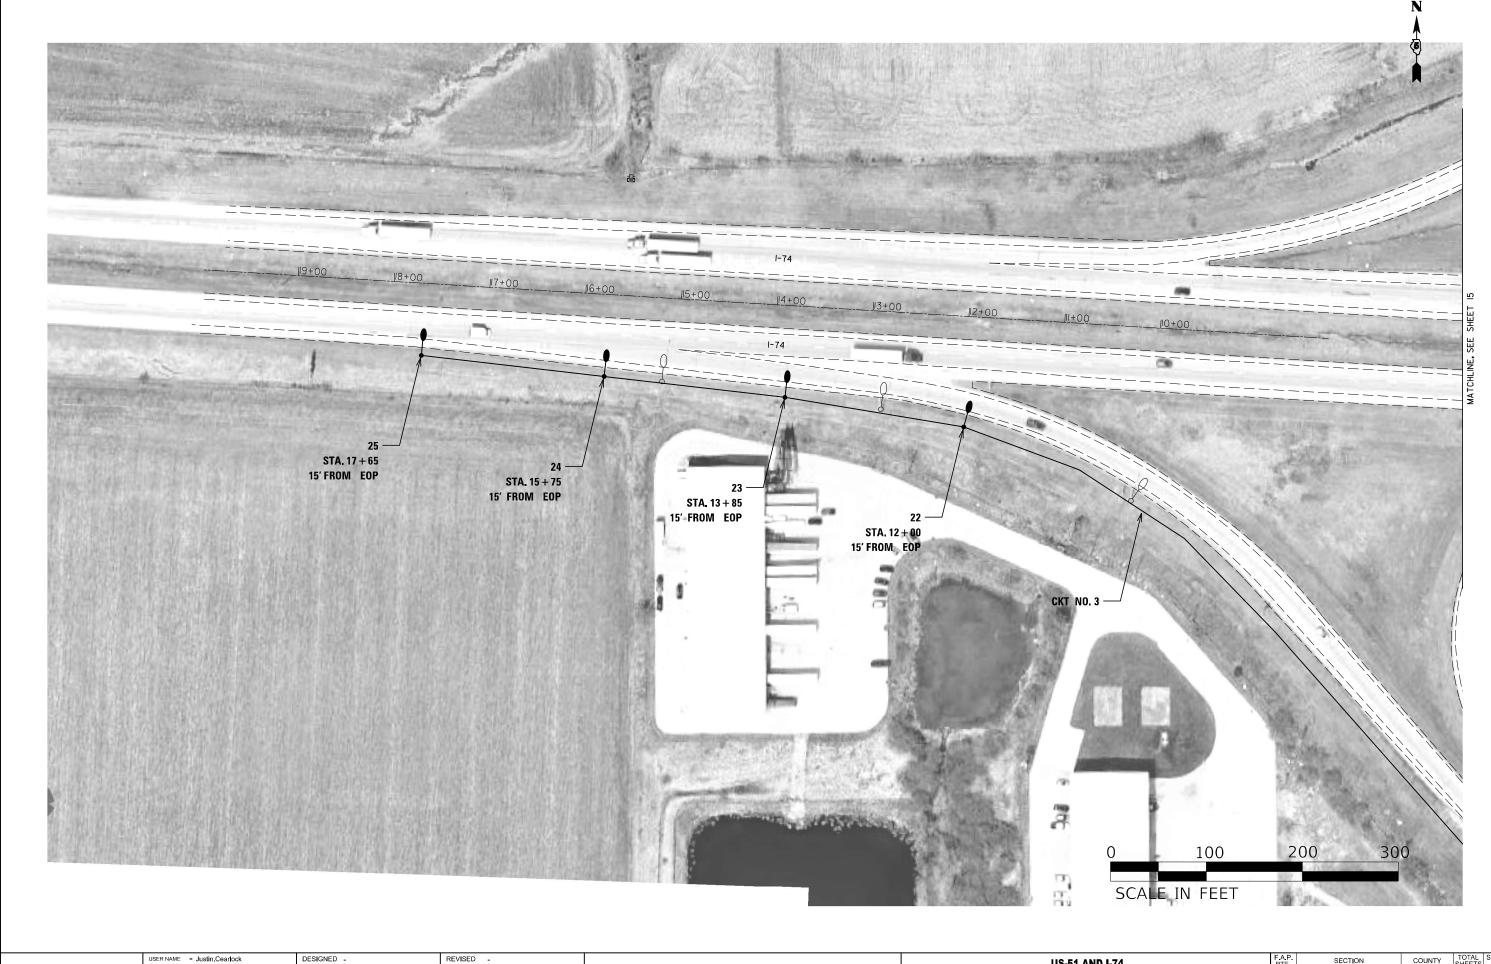

DEPA

DRAWN -

CHECKED -

PLOT DATE = 1/6/2025

REVISED -

REVISED -

STATE OF ILLINOIS DEPARTMENT OF TRANSPORTATION

US-51 AND I-74
PROPOSED LIGHTING PLAN

SHEET 6 OF 7 SHEETS STA.

TO STA.

PLOT DATE = 1/6/2025

DRAWN - REVISED - STATE OF ILLINOIS
CHECKED - REVISED - DEPARTMENT OF TRANSPORTATION


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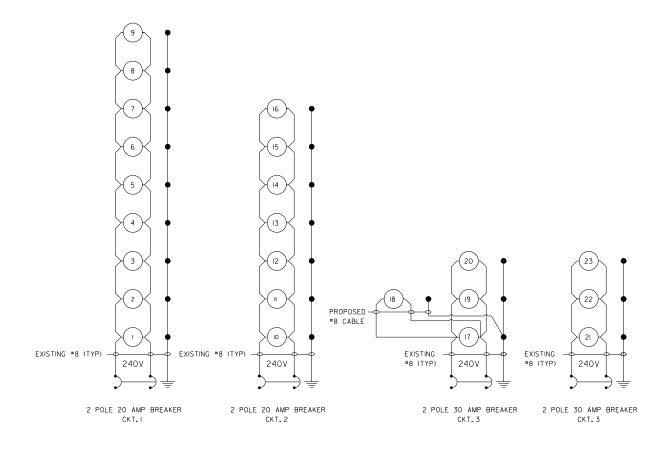
US-51 AND I-74
PROPOSED LIGHTING PLAN

LE: SHEET 7 OF 7 SHEETS STA.

TO STA.

| A.P. | SECTION | COUNTY | TOTAL | SHEET | NO. |
| 322 | HMLT2025-1 | MCLEAN | 22 | 18 |
| CONTRACT NO. 70H51 | |
| LLINOIS | FED. AID PROJECT |



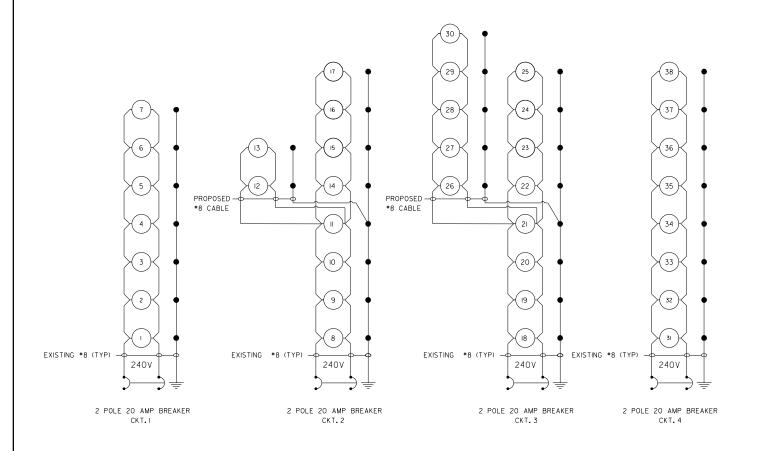

## US-51 AND I-74

PROPOSED LIGHTING CONTROLLER, PEDESTAL MOUNTED, 240V, 60AMP

LEGEND:

PROPOSED LIGHTING UNIT

GROUND ROD

NOTES:

I. ALL NECESSARY REVISIONS TO THE WIRING SHOWN ON THIS SHEET SHALL BE MADE AT NO ADDITIONAL COST TO THE DEPARTMENT AND TO THE SATISFACTION OF THE ENGINEER.

## **US-51 AND CH-30**

PROPOSED LIGHTING CONTROLLER, PEDESTAL MOUNTED, 240V, 60AMP

| USER NAME = Justin.Cearlock | DESIGNED - | REVISED - |  |
|-----------------------------|------------|-----------|--|
|                             | DRAWN -    | REVISED - |  |
|                             | CHECKED -  | REVISED - |  |
| PLOT DATE = 1/6/2025        | DATE -     | REVISED - |  |

| STATE OF ILLINOIS            |  |  |  |  |  |  |  |  |
|------------------------------|--|--|--|--|--|--|--|--|
| DEPARTMENT OF TRANSPORTATION |  |  |  |  |  |  |  |  |

|        |         | WIRING | G DIAGE | F.A.P.<br>RTE | SECTION    | COUNTY                    | TOTAL<br>SHEETS | SHEET<br>NO. |        |     |
|--------|---------|--------|---------|---------------|------------|---------------------------|-----------------|--------------|--------|-----|
|        |         |        |         | 322           | HMLT2025-1 | MCLEAN                    | 22              | 19           |        |     |
|        |         |        |         |               |            |                           |                 | CONTRACT     | NO. 70 | H51 |
| SCALE: | SHEET 1 | OF 1   | SHEETS  | STA.          | TO STA.    | ILLINOIS FED. AID PROJECT |                 |              |        |     |

'\pw\_work\pwidot\projects\d1032394\D570H51\_Wiring Diagram.dgn



mounting height, setback, or arm length.

#### **Luminaire Performance Table**

#### Project

| i roject  |  |   |   |   |  |  |  |  |                           |  |     |
|---|--|---|---|---|--|--|--|--|---------------------------|--|-----|
| Date  | Contract   | Numbe   | r   | Section Nur   | nber   |  | Cou  | nty  |                           |  |     |
| 10/22/24  | 70H51  |   |   | HMLT202   | 5-1  |  | Mcl  | _ean   |                           |  |     |
| Marked Route N  | umber  |   |   |   | Muni   | icipality                                  | k  |  |                           |  |     |
| US-51   |  |   |   |   |  |  |  |  |                           |  |     |
| Roadway   |  |   |   |   |  |  |  |  |                           |  |     |
| Lane Width (see   | note 4)  | Numb  | er and D  | irection of lane  | 5  | Media                                      | n Width  | Surface Clas   | sification                | Q-Zero Value                               |     |
| 12  |  | 3 - In  | One [   | Direction   |  | 16   |  | R3   |                           | 0.07                                       |     |
| Structure   |  |   |   |   |  |  |  |  |                           |  |     |
| Mounting Height   |  |   |   | k (see note 1)  |  | ımber c                                    | of Luminaries  | 3  |                           |  |     |
| 45  | 15   | [   | 15  |   | 1  |  |  |  |                           |  |     |
| Luminaire   |  |   |   |   |  |  |  |  |                           |  |     |
| Description   |  |   |   |   |  |  | Distribution   |  |                           | al Distribution                            |     |
| Roadway Lur   | ninaire C  | Dutput  | Desig   | nation G  | Тур  | e III                                      |  |  | Med                       | ium  |     |
| Total Light Loss  | Factor (LL   | .F)   | B-U-G   | Rating  |  |  | Shields  |  |                           | Dimming Protocol                           |     |
| Refer to Note   | s 6 and  | 7   | U=0   |   |  |  | N/A  |  |                           | 0-10V                                      |     |
| Layout  |  |   |   |   |  |  |  |  |                           |  |     |
| Spacing   |  | Config  | uration   |   |  | 1  |  |  |                           |  |     |
| 260   |  | Oppo  | site  |   |  |  |  |  |                           |  |     |
| Performance (   | see note   | s 5 ar  | nd 6)   |   |  |  |  |  |                           |  |     |
| Average Illumina  | ance, EAVE   | (fc)  |   | Uniformity Ration   | o, Eav   | E/EMIN                                     |  |  | 1                         |  |     |
| 0.6   |  |   |   | 3.0   |  |  |  |  |                           |  |     |
| Average Lumina  | nce, Lave (  | cd/m²)  | 11  | mity Ratio, Lave/   | LMIN   |  |  | Ratio, L <sub>MAX</sub> /L <sub>MII</sub>  | N                         | Veiling Luminance Ratio, L <sub>v</sub> /L | 4VE |
| 8.0   |  |   | 3.5   |   |  |  | 6.0  |  |                           | 0.3  |     |
| Light Tresspa   | ss (see r  | otes !  | 5 and 7   | )   |  |  |  |  |                           |  |     |
| Distance to ROV   | V (behind  |   |   | rizontal Illumina   | nce a  | at ROW                                     | , Ен   |  | al Illumina               | ance at ROW, E√                            |     |
| N/A   |  |   | N/A   |   |  |  |  | N/A  |                           |  |     |
| <ol> <li>Lighting</li> <li>Perform the give</li> <li>Lane w</li> <li>Complia</li> <li>Photom</li> <li>Light transpared a</li> </ol> | g calculation ance requent condition idth is the ance with petric calculation or the condition of the condit | ons sha<br>liremer<br>ns liste<br>width o<br>perform<br>lations<br>culation<br>l calcul | Il be per<br>its shall<br>d above<br>if each in<br>nance cr<br>for roac<br>ns shall<br>ations p | ndividual lane,<br>iteria shall be he<br>lways shall be p<br>be performed w<br>erformed with ca | n acce<br>not to<br>eld to<br>perform<br>ith a falcula | be cor<br>one sig<br>med wit<br>total ligh | standards on the standards of the standards with the standards of the stan | f photometric<br>otal roadway<br>:.<br>t loss factor o<br>of 1.0 and w<br>three feet abo | width. of 0.7 rith horizo | nce for the luminaire, based of            |     |

Printed 10/22/24 BDE 5630 (Draft)


| USER NAME = Justin Cearlock | DESIGNED - | REVISED - |
|-----------------------------|------------|-----------|
|                             | DRAWN -    | REVISED - |
|                             | CHECKED -  | REVISED - |
| PLOT DATE = 12/17/2024      | DATE -     | REVISED - |
|                             |            |           |


| STATE OF ILLINOIS            |  |  |  |  |  |  |  |  |
|------------------------------|--|--|--|--|--|--|--|--|
| DEPARTMENT OF TRANSPORTATION |  |  |  |  |  |  |  |  |

SCALE:


|  | LUMINAIRE PERFORMANCE TABLE |      |        |      |  |         | F.A.P.<br>RTE | SECTION    |          | COUNTY   | TOTAL<br>SHEETS | SHEET<br>NO. |     |
|--|-----------------------------|------|--------|------|--|---------|---------------|------------|----------|----------|-----------------|--------------|-----|
|  |                             |      |        |      |  |         | 322           | HMLT2025-1 |          | MCLEAN   | 22              | 20           |     |
|  |                             |      |        |      |  |         |               |            |          |          | CONTRAC         | NO. 70       | H51 |
|  | SHEET 1                     | OF 1 | SHEETS | STA. |  | TO STA. |               |            | ILLINOIS | FED. All | PROJECT         |              |     |

## **RODENT SHIELD FOR ALUMINUM POLE**

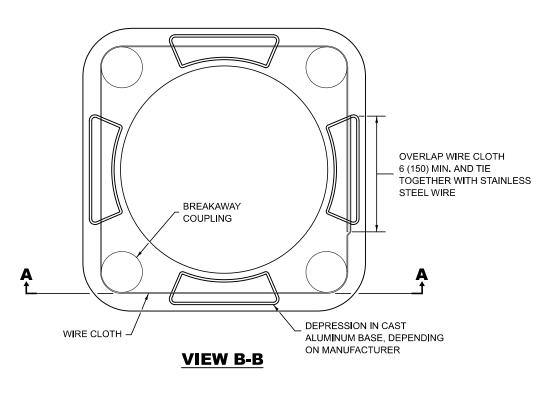

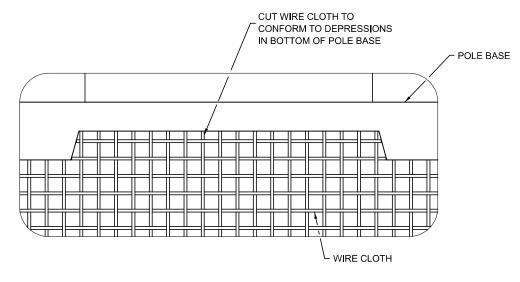

**DETAIL** A

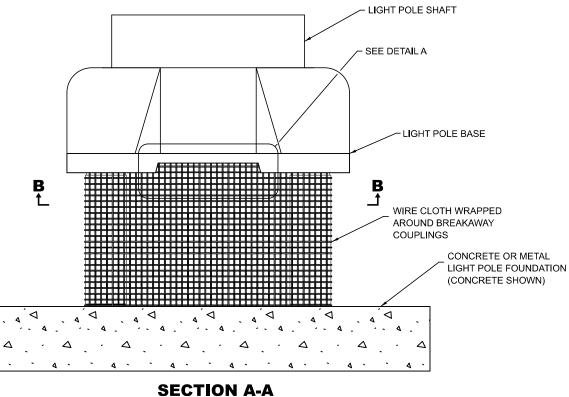

#### **GENERAL NOTES**

WIRE CLOTH SHALL BE STAINLESS STEEL, HAVE A MAXIMUM OPENING OF  $\frac{1}{4}$  (6), AND A MINIMUM WIRE DIAMETER OF AWG NO. 16 (1.6).

ALL DIMENSIONS ARE IN INCHES (MILLIMETERS) UNLESS OTHERWISE SHOWN.


## RODENT SHIELD FOR ALUMINUM POLE

| OSER WANTE - SUSUIT. CEATIOCK | DESIGNED - | KLVIOLD - |     |
|-------------------------------|------------|-----------|-----|
|                               | DRAWN -    | REVISED - |     |
|                               | CHECKED -  | REVISED - | DEP |
| PLOT DATE = 12/17/2024        | DATE -     | REVISED - |     |

SCALE:

|         | RODEN | T SHIEL | D FOR |            | F.A.P.<br>RTE | SECTION    |   |
|---------|-------|---------|-------|------------|---------------|------------|---|
|         | ALUN  |         | 322   | HMLT2025-1 |               |            |   |
|         | ALU!! |         | V-L   |            |               |            |   |
| SHEET 1 | OF 1  | SHEETS  | STA   | TO STA     |               | II I INOIS | _ |

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Note: All dimensions are in INCHES (millimeters) unless otherwise shown.

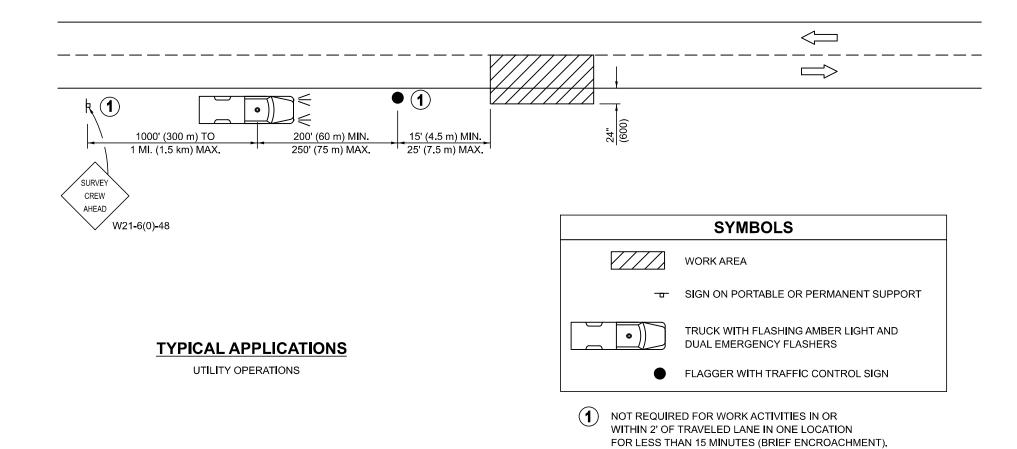DISTRICT 5 DETAIL NO. 71000000

| 10       | NIGHT TIME INSPECTION OF ROADWAY LIGHTING |         |      |        |      |         |                           | SECTION    | COUNTY | TOTAL<br>SHEETS | SHEET<br>NO. |
|----------|---|---------|------|--------|------|---------|---------------------------|------------|--------|-----------------|--------------|
| 15       |   |         |      |        |      |         | 322                       | HMLT2025-1 | MCLEAN | 22              | 22           |
| ORTATION |   |         |      |        |      |         | CONTRACT NO. 70H5         |            |        | H51             |              |
|          | SCALE:                                    | SHEET 1 | OF 1 | SHEETS | STA. | TO STA. | ILLINOIS FED. AID PROJECT |            |        |                 |              |

MODEL: 70100000 [Sheet] FILE NAME: c:\pw work\pwidot\projects\d1032394\D570H51-

| USER NAME = Justin Cearlock | DESIGNED - | REVISED - 11/06 |
|-----------------------------|------------|-----------------|
|                             | DRAWN -    | REVISED -       |
|                             | CHECKED -  | REVISED -       |
| PLOT DATE = 12/17/2024      | DATE -     | REVISED -       |