#### 09-20-2019 LETTING ITEM 008


FOR INDEX OF SHEETS, SEE SHEET NO. 2 FOR INDEX OF HIGHWAY STANDARDS, SEE SHEET NO. 2

#### **STATE OF ILLINOIS DEPARTMENT OF TRANSPORTATION**

## **PLANS FOR PROPOSED FEDERAL AID HIGHWAY**

FAU ROUTE 2406 (BROADWAY AVENUE) **DIVISION STREET TO NORTH AVENUE** RESURFACING SECTION NO.: 19-00141-00-RS **PROJECT NO.:XGUD(791)** VILLAGE OF MELROSE PARK **COOK COUNTY** 


C-91-334-19

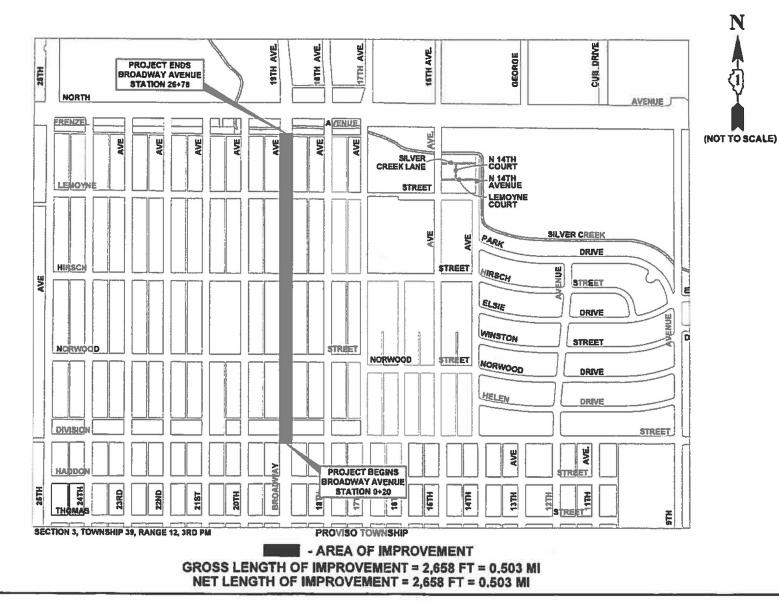

TRAFFIC DATA ADT (2014) = 6.800 POSTED SPEED LIMIT = 25 MPH DESIGN SPEED LIMIT = 25 MPH

**DESIGN DESIGNATION** MAJOR COLLECTOR

PROJECT LOCATED IN THE VILLAGE OF MELROSE PARK

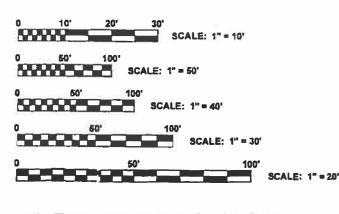


FULL SIZE PLANS HAVE BEEN PREPARED USING STANDARD ENGINEERING SCALES. REDUCED SIZED PLANS WILL NOT CONFORM TO STANDARD SCALES, IN MAKING MEASUREMENTS ON REDUCED PLANS. THE ABOVE SCALES MAY BE USED.



Call before you dig.

CONTRACT NO. 61F93

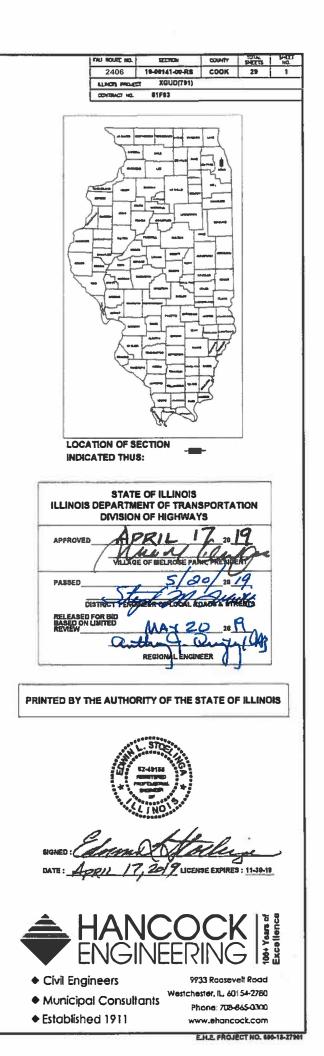

# **INDEX OF SHEETS**

SHEET NO.	DESCRIPTION	STANDARD NO.	DESCRIPTION
1	COVER SHEET, LOCATION MAP	000001-07	STANDARD SYMBOLS, ABBREVIATIONS AND PATTERN
•		280001-07	TEMPORARY EROSION CONTROL SYSTEMS
2	INDEX OF SHEETS, AND IDOT HIGHWAY STANDARDS	424001-11	PERPENDICULAR CURB RAMPS FOR SIDEWALKS
3	GENERAL NOTES	442201-03	CLASS C AND D PATCHES
4-5	M.W.R.D.G.C. GENERAL NOTES	604001-04	FRAME AND LIDS, TYPE 1
6-9	SUMMARY OF QUANTITIES	701006-05	OFF ROAD OPERATION MARKERS, 2L, 2W 15' (4.5m) TO 24'' (600mm) FROM PAVEMENT EDGE
10-11	EXISTING AND PROPOSED TYPICAL SECTIONS	701301-04	LANE CLOSURE, 2-LANE, 2-WAY, SHORT-TIME OPERATIONS
12-13 14-20	RESURFACING/ PAVEMENT MARKING PLAN	701311-03	LANE CLOSURE, 2-LANE, 2-WAY, MOVING OPERATIONS, DAY ONLY
21-22	EROSION CONTROL PLAN	701501-06	URBAN LANE CLOSURE, 2-LANE, 2-WAY, UNDIVIDED
		701701-10	URBAN LANE CLOSURE, MULTILANE INTERSECTION
23	JOB SPECIFIC MELROSE PARK DETAILS	701801-06	SIDEWALK, CORNER, OR CROSSWALK CLOSURE
24	DETAILS FOR FRAME AND LIDS ADJUSTMENT WITH	701901-08	TRAFFIC CONTROL DEVICES
	MILLING (BD-08)	780001-05	TYPICAL PAVEMENT MARKINGS
25	BUTT JOINT AND HMA TAPER DETAILS (BD-32)	781001-04	TYPICAL APPLICATIONS RAISED REFLECTIVE PAVEMENT MARKINGS
26	TRAFFIC CONTROL AND PROTECTION FOR SIDE ROADS, INTERSECTIONS, AND DRIVEWAYS (TC-10)		
27	DISTRICT ONE TYPICAL PAVEMENT MARKINGS (TC-13)		
28	SHORT TERM PAVEMENT MARKING LETTERS AND SYMBOLS (TC-16)		
29	ARTERIAL ROAD INFORMATION SIGN (TC-22)		

9933 Roosevelt Road	DESIGN
Westchester II 40154-9780	DRAWN
Phone: /05-565-0300	CHECK
www.ehancock.com	DATE

DESIGNED -	-	REVISED –
DRAWN -	TG, SFB, DMM	REVISED –
CHECKED -	-	REVISED –
DATE –	5-13-19	REVISED –

# **IDOT HIGHWAY STANDARDS**

#### ATTERNS

HEETS, Y STANDARDS		F.A.U. RTE.	SECTION COL		COUNT	γ	TOTAL SHEETS	. SHEET S NO.
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### **STANDARDS**

ANY REFERENCE TO STANDARDS THROUGHOUT THE PLANS OR SPECIAL PROVISIONS SHALL BE INTERPRETED TO BE THE LATEST STANDARD OF THE ILLINOIS DEPARTMENT OF TRANSPORTATION AS SHOWN ON THE INDEX OF SHEETS IN THE PLANS. ALL CONSTRUCTION SHALL BE DONE IN ACCORDANCE WITH THE STANDARD SPECIFICATIONS FOR ROAD AND BRIDGE CONSTRUCTION ADOPTED APRIL 1, 2016. THE LATEST EDITION OF THE "ILLINOIS MANUAL ON UNIFORM TRAFFIC CONTROL DEVICES FOR STREETS AND HIGHWAYS," "THE STANDARD SPECIFICATIONS FOR WATER AND SEWER MAIN CONSTRUCTION IN ILLINOIS" JULY 2014 7TH EDITION, AND THE "DETAILS" IN THE PLANS AND THE "SPECIAL PROVISIONS" INCLUDED IN THE CONTRACT DOCUMENTS.

### **UNDERGROUND UTILITIES**

BEFORE STARTING ANY EXCAVATION, THE CONTRACTOR SHALL CALL "JULIE" AT 811 FOR FIELD LOCATIONS OF BURIED ELECTRICAL, TELEPHONE AND GAS FACILITIES. (48 HOURS NOTIFICATION IS REQUIRED).

THE LOCATIONS OF THE UNDERGROUND UTILITIES IF SHOWN ON THE PLANS HAVE BEEN OBTAINED BY FIELD SURVEYS AND SEARCHES OF AVAILABLE RECORDS. IT IS BELIEVED THAT DATA IS ESSENTIALLY CORRECT, BUT THE VILLAGE OF MELROSE PARK, THE ILLINOIS DEPARTMENT OF TRANSPORTATION AND/OR OTHER OFFICES AND AGENCIES ASSOCIATED WITH THE DEVELOPMENT OF THESE PLANS DO NOT GUARANTEE THEIR ACCURACY OR COMPLETENESS. THE CONTRACTOR WILL BE REQUIRED TO VERIFY THE EXACT LOCATION OF EACH FACILITY WITH THE UTILITY COMPANY, AND SHALL TAKE DUE CARE IN ALL PHASES OF THE CONSTRUCTION TO PROTECT ANY SUCH FACILITIES WHICH MAY BE AFFECTED BY THE WORK. ANY DAMAGE TO EXISTING UTILITIES SHALL BE REPAIRED.

THE CONTRACTOR SHALL COORDINATE CONSTRUCTION ACTIVITIES WITH UTILITY COMPANIES AND THE VILLAGE OF MELROSE PARK.

### FRAMES AND GRATES

THE TYPE OF FRAMES AND GRATES REQUIRED FOR ALL CATCH BASINS AND MANHOLES LISTED IN THE SUMMARY OF QUANTITIES MAY BE FOUND ON THE PLANS AT THEIR RESPECTIVE LOCATIONS. WHERE LIDS ARE CALLED FOR ON THE PLANS, THEY SHALL BE IN ACCORDANCE WITH ARTICLE 604.01 OF THE STANDARD SPECIFICATIONS AND THE TERM LID IS USED IN LIEU OF GRATE.

ON ALL IMPROVEMENTS, THE FRAMES AND LIDS OF EXISTING CATCH BASINS, INLETS, MANHOLES, AND VALVE VAULTS WHICH ARE TO BE ABANDONED DUE TO CONSTRUCTION OF THIS IMPROVEMENT ARE TO REMAIN THE PROPERTY OF THE VILLAGE OF MELROSE PARK AND BE SALVAGED. THE CONTRACTOR IS TO DELIVER FRAMES AND LIDS TO THE VILLAGE OF MELROSE PARK LOCATED AT 1002 27TH AVENUE, MELROSE PARK, (708) 343-5128.

### **MANHOLE OR VALVE COVERS**

THE WORD "WATER", "SANITARY", OR "STORM" SHALL BE CAST INTO THE LID OF EACH RESPECTIVE MANHOLE OR VALVE VAULT.

### **MAINTENANCE OF SEWER FLOWS**

THE CONTRACTOR SHALL CONDUCT HIS OPERATIONS AS TO MAINTAIN AT ALL TIMES FLOW THROUGH EXISTING STORM AND SANITARY SEWER SYSTEMS. HE/SHE SHALL ALSO PROVIDE AND MAINTAIN AN EFFICIENT PUMPING PLANT IF NECESSARY AND A TEMPORARY OUTLET AND BE PREPARED AT ALL TIMES TO DISPOSE OF THE WATER COLLECTED IN A SAFE MANNER WITHOUT DAMAGE OF ANY KIND TO ADJACENT PROPERTIES. THE ENDS OF EXISTING DRAINAGE LINES THAT ARE NOT TO BE INCORPORATED INTO THE PROJECT SHALL BE SEALED AS SPECIFIED IN THE SPECIAL PROVISIONS. EXISTING STRUCTURES ARE TO BE INSPECTED BEFORE CONSTRUCTION STARTS - ANY ACCUMULATION OF MATERIAL IN THE STRUCTURE DUE TO CONSTRUCTION OPERATIONS <u>SHALL BE REMOVED BY THE CONTRACTOR.</u>

## **TREE PROTECTION**

EXISTING TREES AT PARKWAYS OUTSIDE OF CONSTRUCTION LIMITS SHALL REMAIN DURING THE CONSTRUCTION. ANY DAMAGE TO EXISTING TREES BY THE CONTRACTOR SHALL BE REPLACED IN KIND BY THE CONTRACTOR AT THEIR OWN EXPENSE. NO COMPENSATION IS ALLOWED.

#### **MWRDGC MATERIAL**

THE "MATERIAL" REFERRED TO ON SHEET 4 OF THE MWRDGC GENERAL NOTES ITEM #9, SHALL BE TESTED IN ACCORDANCE WITH THE STANDARD SPECIFICATIONS FOR ROAD AND BRIDGE CONSTRUCTION ADOPTED APRIL 1, 2016. THIS "MATERIAL" INCLUDES BUT IS NOT LIMITED TO HMA SURFACE, COURSE, POLYMERIZED LEVELING BINDER, HMA BINDER, STONE COMPACTION VIA NUCLEAR DENSITY, AND PORTLAND CEMENT CONCRETES.





9933 Roosevelt Road Westchester, IL, 60154-2780 Phone: 708-865-0300 www.ehancock.com

DATE – <b>5-13-19</b>	REVISED -
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DESIGNED – -	REVISED –

# **GENERAL NOTES**

## **OPEN EXCAVATIONS**

THE CONTRACTOR SHALL NOT LEAVE ANY EXCAVATION NECESSARY FOR PAVEMENT PATCHES OR STRUCTURE ADJUSTMENTS OPEN OVERNIGHT. THE CONTRACTOR SHALL BE RESPONSIBLE FOR COMPLETELY BACKFILLING OR INSTALLING A PLATE OVER ALL EXCAVATIONS AT THE END OF EACH DAY.

### **CONCRETE BREAKERS**

WHEN REMOVING PAVEMENT AND/OR OTHER STRUCTURES, THE CONTRACTOR SHALL NOT USE ANY TYPE OF CONCRETE BREAKERS SUCH AS DROP HAMMERS, THAT MIGHT DAMAGE UNDERGROUND PUBLIC OR PRIVATE UTILITIES.

### **SAW CUTTING**

THE CONTRACTOR SHALL SAW CUT ASPHALT PAVEMENT AS INDICATED ON THE PLANS TO SEPARATE THE EXISTING PAVEMENT TO BE REMOVED BY APPROVED MEANS OR AN APPROVED CONCRETE SAW TO A DEPTH AS DIRECTED BY THE ENGINEER. SUITABLE GUIDELINES OR DEVICES SHALL BE USED TO ASSURE CUTTING A NEAT, STRAIGHT LINE AS SHOWN ON THE PLANS. CARE SHALL BE TAKEN BY THE CONTRACTOR AS NOT TO DAMAGE THE REMAINING PAVEMENT DIRECTLY ADJACENT TO THE PAVEMENT TO BE REMOVED. ANY DAMAGE TO THE EXISTING PAVEMENT RESULTING FROM PAVEMENT REMOVAL OPERATIONS SHALL BE REPAIRED.

### FRAMES AND LIDS TO BE ADJUSTED (SPECIAL)

THIS ITEM ONLY PERTAINS TO STRUCTURES LOCATED IN THE CONCRETE OR HOT-MIX ASPHALT ROADWAY PAVEMENT AREAS THAT WILL REQUIRE CONCRETE OR HOT-MIX SURFACE REMOVAL. THE ENGINEER WILL MARK IN THE FIELD ALL STRUCTURES TO BE ADJUSTED UNDER THIS ITEM. SEE DETAIL SHEET FOR "FRAMES AND LIDS ADJUSTMENT WITH MILLING".

### **FIELD OFFICE**

THE CONTRACTOR WILL NOT BE ALLOWED TO SET UP A YARD OR FIELD OFFICE ON STATE OR VILLAGE PROPERTY WITHOUT WRITTEN PERMISSION FROM THE ENGINEER.

### **BUTT JOINTS**

A BUTT JOINT WILL BE INSTALLED AT THE ENDS OF ALL RESURFACING (WHERE RESURFACING MEETS EXISTING PAVEMENT) IN ACCORDANCE WITH THE "BUTT JOINT AND HMA TAPER DETAILS" SHEET INCLUDED IN THE PLANS, UNLESS OTHERWISE SPECIFIED.

### **MILLED PAVEMENT OPEN TO TRAFFIC**

WHEN MILLED PAVEMENT IS OPEN TO TRAFFIC THE MAXIMUM GRADE DIFFERENTIAL BETWEEN PASSES OF THE MILLING MACHINE SHALL NOT EXCEED 1½ INCHES (40 MM) WHERE THE SPEED LIMIT IS 45 MPH (80 KM/H) OR LESS AND 1 INCH (25 MM) WHERE THE SPEED LIMIT IS GREATER THAN 45 MPH (80 KM/H). WITH WRITTEN APPROVAL FROM THE ENGINEER, A MAXIMUM GRADE DIFFERENTIAL OF 3 INCHES (75 MM) MAY BE ALLOWED IF THE EDGE OF THE MILLING IS SLOPED A MINIMUM 1:3 (V:H).

### **PAVING OPERATIONS**

THE CONTRACTOR WILL BE REQUIRED TO SCHEDULE HIS/HER OPERATIONS SO THAT NO SECTIONS OF PAVEMENT ALONG THE CENTERLINE WILL HAVE A COLD JOINT OVERNIGHT.

### **PAVEMENT PATCHING**

LOCATIONS OF D PATCHES ON PLANS ARE APPROXIMATE. EXACT LOCATIONS WILL BE DETERMINED IN FIELD BY ENGINEER. CLASS D PATCHES LOCATED WITHIN THE THROUGH LANES SHALL BE MADE ACCESSIBLE TO TRAFFIC AT THE END OF EACH WORK DAY.

PAVEMENT PATCHING SHALL BE STAGED TO MAINTAIN TWO-WAY TRAFFIC AT ALL TIMES.

### **PAVEMENT MARKING**

TWO WEEKS PRIOR TO PLACEMENT OF PERMANENT PAVEMENT MARKINGS/MARKERS, THE ENGINEER SHALL CONTACT PATRICE HARRIS, AREA TRAFFIC FIELD TECHNICIAN AT (847) 705-4413.

STATE OF ILLINOIS
<b>DEPARTMENT OF TRANSPORTATION</b>

**GENERAL NO** 

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#### A.REFERENCED SPECIFICATIONS

- 1. ALL CONSTRUCTION SHALL BE IN ACCORDANCE WITH THE APPLICABLE SECTIONS OF THE
- FOLLOWING. EXCEPT AS MODIFIED HEREIN OR ON THE PLANS:
- \* STANDARD SPECIFICATIONS FOR ROAD AND BRIDGE CONSTRUCTION (LATEST EDITION), BY THE ILLIN TRANSPORTATION (IDOT SS) FOR ALL IMPROVEMENTS EXCEPT SANITARY SEWER AND WATER MAIL
- \* STANDARD SPECIFICATIONS FOR WATER AND SEWER MAIN CONSTRUCTION IN ILLINOIS, LATEST EDI AND WATER MAIN CONSTRUCTION:
- \* VILLAGE OF MELROSE PARK MUNICIPAL CODE;
- \* THE METROPOLITAN WATER RECLAMATION DISTRICT OF GREATER CHICAGO (MWRD) WATERSHED MANAGEMENT ORDINANCE AND **TECHNICAL GUIDANCE MANUAL:**
- \* IN CASE OF CONFLICT BETWEEN THE APPLICABLE ORDINANCES NOTED, THE MORE STRINGENT SHALL TAKE PRECEDENCE AND SHALL CONTROL ALL CONSTRUCTION.
- **B.NOTIFICATIONS**
- 1. THE MWRD LOCAL SEWER SYSTEMS SECTION FIELD OFFICE MUST BE NOTIFIED AT LEAST TWO (2) WORKING DAYS PRIOR TO THE COMMENCEMENT OF ANY WORK (CALL 708-588-4055).
- 2. THE VILLAGE OF MELROSE PARK ENGINEERING DEPARTMENT AND PUBLIC MUST BE NOTIFIED AT LEAST 24 HOURS PRIOR TO THE START OF CONSTRUCTION AND PRIOR TO EACH PHASE OF WORK. CONTRACTOR SHALL DETERMINE ITEMS REQUIRING INSPECTION PRIOR TO START OF CONSTRUCTION OR EACH WORK PHASE.
- 3. THE CONTRACTOR SHALL NOTIFY ALL UTILITY COMPANIES PRIOR TO BEGINNING CONSTRUCTION FOR THE EXACT LOCATIONS OF UTILITIES AND FOR THEIR PROTECTION DURING CONSTRUCTION. IF EXISTING UTILITIES ARE ENCOUNTERED THAT CONFLICT IN LOCATION WITH NEW CONSTRUCTION, IMMEDIATELY NOTIFY THE ENGINEER SO THAT THE CONFLICT CAN BE RESOLVED. CALL J.U.L.I.E. AT 1-800-892-0123.

**C.GENERAL NOTES** 

ALL ELEVATIONS SHOWN ON PLANS REFERENCE THE NORTH AMERICAN VERTICAL DATUM OF 1988 (NAVD88). CONVERSION FACTOR IS 0.0 FT.

- 4. MWRD. THE MUNICIPALITY AND THE OWNER OR OWNER'S REPRESENTATIVE SHALL HAVE THE AUTHORITY TO INSPECT. APPROVE. AND **REJECT THE CONSTRUCTION IMPROVEMENTS.**
- 5. THE CONTRACTOR(S) SHALL INDEMNIFY THE OWNER, ENGINEER, MUNICIPALITY, MWRD, AND THEIR AGENTS, ETC., FROM ALL LIABILITY INVOLVED WITH THE CONSTRUCTION, INSTALLATION OR TESTING OF THIS WORK ON THE PROJECT.
- 6. THE PROPOSED IMPROVEMENTS MUST BE CONSTRUCTED IN ACCORDANCE WITH THE ENGINEERING PLANS AS APPROVED BY MWRD AND THE MUNICIPALITY UNLESS CHANGES ARE APPROVED BY MWRD, THE MUNICIPALITY, OR AUTHORIZED AGENT. THE CONSTRUCTION DETAILS, AS PRESENTED ON THE PLANS, MUST BE FOLLOWED. PROPER CONSTRUCTION TECHNIQUES MUST BE FOLLOWED ON THE IMPROVEMENTS INDICATED ON THE PLANS.
- 7. THE LOCATION OF VARIOUS UNDERGROUND UTILITIES WHICH ARE SHOWN ON THE PLANS ARE FOR INFORMATION ONLY AND REPRESENT THE BEST KNOWLEDGE OF THE ENGINEER. VERIFY LOCATIONS AND ELEVATIONS PRIOR TO BEGINNING THE CONSTRUCTION OPERATIONS.
- 8. ANY EXISTING PAVEMENT, SIDEWALK, DRIVEWAY, ETC., DAMAGED DURING CONSTRUCTION OPERATIONS AND NOT CALLED FOR TO BE REMOVED SHALL BE REPLACED BY THE CONTRACTOR.
- 9. MATERIAL AND COMPACTION TESTING SHALL BE PERFORMED IN ACCORDANCE WITH THE REQUIREMENTS OF THE MUNICIPALITY, MWRD, AND OWNER.
- 10. THE UNDERGROUND CONTRACTOR SHALL MAKE ALL NECESSARY ARRANGEMENT TO NOTIFY ALL INSPECTION AGENCIES.
- 11. ALL NEW AND EXISTING UTILITY STRUCTURES ON SITE AND IN AREAS DISTURBED DURING CONSTRUCTION SHALL BE ADJUSTED TO FINISH GRADE PRIOR TO FINAL INSPECTION.

12. RECORD DRAWINGS SHALL BE KEPT BY THE CONTRACTOR AND SUBMITTED TO THE ENGINEER AS SOON AS UNDERGROUND IMPROVEMENTS ARE COMPLETED. FINAL PAYMENTS TO THE CONTRACTOR SHALL BE HELD UNTIL THEY ARE RECEIVED. ANY CHANGES IN LENGTH, LOCATION OR ALIGNMENT SHALL BE SHOWN IN RED. ALL WYES OR BENDS SHALL BE LOCATED FROM THE DOWNSTREAM MANHOLE. ALL VALVES, B-BOXES, TEES OR BENDS SHALL BE TIED TO A FIRE HYDRANT.

			9933 Roosevelt Road	DESIGNED -	-	REVISED –
-		<ul> <li>Civil Engineers</li> <li>Municipal Consultants</li> </ul>	Westchester, IL, 60154-2780	DRAWN -	TG, SFB, DMM	REVISED –
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## **M.W.R.D.G.C. GENERAL NOTES**

NOIS DEPARTMENT OF	
N CONSTRUCTION;	
TION (SSWS) FOR SANITARY SEWER	

PIPE MATERIAL	<b>PIPE SPECIFICATIONS</b>	JOINT SPECIFICATIONS
VITRIFIED CLAY PIPE	ASTM C-700	ASTM C-425
REINFORCED CONCRETE SEWER PIPE	ASTM C-76	ASTM C-443
CAST IRON SOIL PIPE	ASTM A-74	ASTM C-564
DUCTILE IRON PIPE	ANSI A21.51	ANSI A21.11
POLYVINYL CHLORIDE (PVC) PIPE		
6-INCH TO 15-INCH DIAMETER SDR 26	ASTM D-3034	ASTM D-3212
18-INCH TO 27-INCH DIAMETER F/DY=46	ASTM F-679	ASTM D-3212
HIGH DENSITY POLYETHYLENE (HDPE)	ASTM D-3350	ASTM D-3261, F-2620 (HEAT FUSION)
	ASTM D-3035	ASTM D-3212, F-477 (GASKETED)
WATER MAIN QUALITY PVC		
4-INCH TO 36-INCH	ASTM D-2241	ASTM D-3139
4-INCH TO 12-INCH	AWWA C900	ASTM D-3139
14-INCH TO 48-INCH	AWWA C905	ASTM D-3139

THE FOLLOWING MATERIALS ARE ALLOWED ON A QUALIFIED BASIS SUBJECT TO DISTRICT REVIEW AND APPROVAL PRIOR TO PERMIT ISSUANCE. A SPECIAL CONDITION WILL BE ADDED TO THE PERMIT WHEN THE PIPE MATERIAL BELOW IS USED FOR SEWER CONSTRUCTION OR A CONNECTION IS MADE.

PIPE SPECIFI
<b>ASTM F-273</b>
ASTM F-276

- TO FINISH GRADE PRIOR TO FINAL INSPECTION.

#### **D.SANITARY SEWER**

- FROM ENTERING THE EXISTING SANITARY SEWERS.
- MUNICIPALITY AND/OR MWRD AFTER THE SEWERS HAVE BEEN TESTED AND ACCEPTED.
- SEWER MAIN CONSTRUCTION IN ILLINOIS (LATEST EDITION).
- 5. ALL FLOOR DRAINS SHALL DISCHARGE TO THE SANITARY SEWER SYSTEM.
- 6. ALL DOWNSPOUTS AND FOOTING DRAINS SHALL DISCHARGE TO THE STORM SEWER SYSTEM.
- AREA) SHALL CONFORM TO THE FOLLOWING:

8. ALL SANITARY SEWER CONSTRUCTION (AND STORM SEWER CONSTRUCTION IN COMBINED SEWER AREAS), REQUIRES STONE BEDDING WITH STONE 1/4" TO 1" IN SIZE, WITH MINIMUM BEDDING THICKNESS EQUAL TO 1/4 THE OUTSIDE DIAMETER OF THE SEWER PIPE, BUT NOT LESS THAN FOUR (4) INCHES NOR MORE THAN EIGHT (8) INCHES. MATERIAL SHALL BE CA-7, CA-11 OR CA-13 AND SHALL BE EXTENDED AT LEAST 12" ABOVE THE TOP OF THE PIPE WHEN USING PVC.

STATE OF ILLINOIS		<b>I.W.R.D.G.C. GENE</b>
DEPARTMENT OF TRANSPORTATION		
	SCALE: NONE	SHEET NO. 1 OF 2 SHEETS

- **ICATIONS** JOINT SPECIFICATIONS
- D-3212, F-477 D-3212, F-477

9. ALL NEW AND EXISTING UTILITY STRUCTURES ON SITE AND IN AREAS DISTURBED DURING CONSTRUCTION SHALL BE ADJUSTED

10. RECORD DRAWINGS SHALL BE KEPT BY THE CONTRACTOR AND SUBMITTED TO THE ENGINEER AS SOON AS UNDERGROUND IMPROVEMENTS ARE COMPLETED. FINAL PAYMENTS TO THE CONTRACTOR SHALL BE HELD UNTIL THEY ARE RECEIVED. ANY CHANGES IN LENGTH. LOCATION OR ALIGNMENT SHALL BE SHOWN IN RED. ALL WYES OR BENDS SHALL BE LOCATED FROM THE DOWNSTREAM MANHOLE. ALL VALVES. B-BOXES. TEES OR BENDS SHALL BE TIED TO A FIRE HYDRANT.

1. THE CONTRACTOR SHALL TAKE MEASURES TO PREVENT ANY POLLUTED WATER, SUCH AS GROUND AND SURFACE WATER,

2. A WATER-TIGHT PLUG SHALL BE INSTALLED IN THE DOWNSTREAM SEWER PIPE AT THE POINT OF SEWER CONNECTION PRIOR TO COMMENCING ANY SEWER CONSTRUCTION. THE PLUG SHALL REMAIN IN PLACE UNTIL REMOVAL IS AUTHORIZED BY THE

3. DISCHARGING ANY UNPOLLUTED WATER INTO THE SANITARY SEWER SYSTEM FOR THE PURPOSE OF SEWER FLUSHING OF LINES FOR THE DEFLECTION TEST SHALL BE PROHIBITED WITHOUT PRIOR APPROVAL FROM THE MUNICIPALITY OR MWRD.

4. ALL SANITARY SEWER CONSTRUCTION SHALL BE IN ACCORDANCE WITH THE STANDARD SPECIFICATIONS FOR WATER AND

7. ALL SANITARY SEWER PIPE MATERIALS AND JOINTS (AND STORM SEWER PIPE MATERIALS AND JOINTS IN A COMBINED SEWER

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9. NON-SHEAR FLEXIBLE-TYPE COUPLINGS SHALL BE USED IN THE CONNECTION OF SEWER PIPES OF DISSIMILAR PIPE MATERIALS.

- 10. ALL MANHOLES SHALL BE PROVIDED WITH BOLTED, WATERTIGHT COVERS, SANITARY LIDS SHALL BE CONSTRUCTED WITH A CONCEALED PICKHOLE AND WATERTIGHT GASKET WITH THE WORD "SANITARY" CAST INTO THE LID.
- 11. WHEN CONNECTING TO AN EXISTING SEWER MAIN BY MEANS OTHER THAN AN EXISTING WYE, TEE, OR AN EXISTING MANHOLE, ONE OF THE FOLLOWING METHODS SHALL BE USED:
- a) A CIRCULAR SAW-CUT OF SEWER MAIN BY PROPER TOOLS AND PROPER INSTALLATION OF HUB-WYE SADDLE OR HUB-TEE SADDLE.
- b) REMOVE AN ENTIRE SECTION OF PIPE (BREAKING ONLY THE TOP OF ONE BELL) AND REPLACE WITH A WYE OR TEE BRANCH SECTION.
- c) WITH PIPE CUTTER, NEATLY AND ACCURATELY CUT OUT DESIRED LENGTH OF PIPE FOR INSERTION OF PROPER FITTING, USING FLEXIBLE NON-SHEAR CONNECTORS TO HOLD IT FIRMLY IN PLACE.
- 12. WHENEVER A SANITARY/COMBINED SEWER CROSSES UNDER A WATER MAIN, THE MINIMUM VERTICAL DISTANCE FROM THE TOP OF THE SEWER TO THE BOTTOM OF THE WATER MAIN SHALL BE 18 INCHES. FURTHERMORE. A MINIMUM HORIZONTAL DISTANCE OF 10 FEET BETWEEN SANITARY/COMBINED SEWERS AND WATER MAINS SHALL BE MAINTAINED UNLESS: THE SEWER IS LAID IN A SEPARATE TRENCH. KEEPING A MINIMUM 18" VERTICAL SEPARATION: OR THE SEWER IS LAID IN THE SAME TRENCH WITH THE WATER MAIN LOCATED AT THE OPPOSITE SIDE ON A BENCH OF UNDISTURBED EARTH, KEEPING A MINIMUM 18" VERTICAL SEPARATION. IF EITHER THE VERTICAL OR HORIZONTAL DISTANCES DESCRIBED CANNOT BE MAINTAINED, OR THE SEWER CROSSES ABOVE THE WATER MAIN, THE SEWER SHALL BE CONSTRUCTED TO WATER MAIN STANDARDS OR IT SHALL BE ENCASED WITH A WATER MAIN QUALITY CARRIER PIPE WITH THE ENDS SEALED.
- 13. ALL EXISTING SEPTIC SYSTEMS SHALL BE ABANDONED. ABANDONED TANKS SHALL BE FILLED WITH GRANULAR MATERIAL OR REMOVED.
- 14. ALL SANITARY MANHOLES, (AND STORM MANHOLES IN COMBINED SEWER AREAS), SHALL HAVE A MINIMUM INSIDE DIAMETER OF 48 INCHES, AND SHALL BE CAST IN PLACE OR PRE-CAST REINFORCED CONCRETE.
- 15. ALL SANITARY MANHOLES, (AND STORM MANHOLES IN COMBINED SEWER AREAS), SHALL HAVE PRECAST "RUBBER BOOTS" THAT CONFORM TO ASTM C-923 FOR ALL PIPE CONNECTIONS. PRECAST SECTIONS SHALL CONSIST OF MODIFIED GROOVE TONGUE AND RUBBER GASKET TYPE JOINTS.
- 16. ALL ABANDONED SANITARY SEWERS SHALL BE PLUGGED AT BOTH ENDS WITH AT LEAST 2 FEET LONG NON-SHRINK CONCRETE OR MORTAR PLUG.
- 17. EXCEPT FOR FOUNDATION/FOOTING DRAINS PROVIDED TO PROTECT BUILDINGS, OR PERFORATED PIPES ASSOCIATED WITH VOLUME CONTROL FACILITIES. DRAIN TILES/FIELD TILES/UNDERDRAINS/PERFORATED PIPES ARE NOT ALLOWED TO BE CONNECTED TO OR TRIBUTARY TO COMBINED SEWERS. SANITARY SEWERS. OR STORM SEWERS TRIBUTARY TO COMBINED SEWERS IN COMBINED SEWER AREAS. CONSTRUCTION OF NEW FACILITIES OF THIS TYPE IS PROHIBITED; AND ALL EXISTING DRAIN TILES AND PERFORATED PIPES ENCOUNTERED WITHIN THE PROJECT AREA SHALL BE PLUGGED OR REMOVED, AND SHALL NOT BE CONNECTED TO COMBINED SEWERS, SANITARY SEWERS, **OR STORM SEWERS TRIBUTARY TO COMBINED SEWERS.**
- 18. A BACKFLOW PREVENTER IS REQUIRED FOR ALL DETENTION BASINS TRIBUTARY TO COMBINED SEWERS. REQUIRED BACKFLOW PREVENTERS SHALL BE INSPECTED AND EXERCISED ANNUALLY BY THE PROPERTY OWNER TO ENSURE PROPER OPERATION, AND ANY NECESSARY MAINTENANCES SHALL BE PERFORMED TO ENSURE FUNCTIONALITY. IN THE EVENT OF A SEWER SURCHARGE INTO AN OPEN DETENTION BASIN TRIBUTARY TO COMBINED SEWERS, THE PERMITTEE SHALL ENSURE THAT CLEAN UP AND WASH OUT OF SEWAGE TAKES PLACE WITHIN 48 HOURS OF THE STORM EVENT.
- **E.EROSION AND SEDIMENT CONTROL**
- 1. THE CONTRACTOR SHALL INSTALL THE EROSION AND SEDIMENT CONTROL DEVICES AS SHOWN ON THE APPROVED EROSION AND SEDIMENT CONTROL PLAN.
- 2. EROSION AND SEDIMENT CONTROL PRACTICES SHALL BE FUNCTIONAL PRIOR TO HYDROLOGIC DISTURBANCE OF THE SITE.
- 3. ALL DESIGN CRITERIA, SPECIFICATIONS, AND INSTALLATION OF EROSION AND SEDIMENT CONTROL PRACTICES SHALL BE IN ACCORDANCE WITH THE ILLINOIS URBAN MANUAL.

4. A COPY OF THE APPROVED EROSION AND SEDIMENT CONTROL PLAN SHALL BE MAINTAINED ON THE SITE AT ALL TIMES. 5. INSPECTIONS AND DOCUMENTATION SHALL BE PERFORMED, AT A MINIMUM:

a) UPON COMPLETION OF INITIAL EROSION AND SEDIMENT CONTROL MEASURES, PRIOR TO ANY SOIL DISTURBANCE.

b) ONCE EVERY SEVEN (7) CALENDAR DAYS AND WITHIN 24 HOURS OF THE END OF A STORM EVENT WITH GREATER THAN 0.5 INCH OF **RAINFALL OR LIQUID EQUIVALENT PRECIPITATION.** 

		9933 Roosevelt Road	DESIGNED -	-	REVISED –
HANCOCK	<ul> <li>Civil Engineers</li> <li>Municipal Consultants</li> </ul>	Westchester, IL, 60154-2780	DRAWN -	TG, SFB, DMM	REVISED –
	Established 1911	Phone: 708-865-0300	CHECKED -	-	REVISED –
		www.ehancock.com	DATE –	5-13-19	REVISED –

## M.W.R.D.G.C. GENERAL NOTES

- SEDIMENT CONTROL MEASURES.
- BE INSTALLED PRIOR TO ANY ON SITE CONSTRUCTION ACTIVITIES INVOLVING CONCRETE.
- AND MORTAR BUILDING ENVELOPE CONSTRUCTION ACTIVITIES.
- **TEMPORARY SEDIMENT BASINS.**
- BE STABILIZED WITH TEMPORARY OR PERMANENT MEASURES WITHIN SEVEN (7) DAYS.
- DOUBLE-ROW OF SILT FENCE (OR EQUIVALENT).
- STABILIZED.
- NOT BE PLACED IN FLOOD PROTECTION AREAS OR THEIR BUFFERS.
- SEDIMENT CONTROL MEASURES.
- TILES ALLOWED IN COMBINED SEWER AREA FOR GREEN INFRASTRUCTURE PRACTICES.
- SITE INSPECTOR MUST BE PRESENT AT THE COMMENCEMENT OF DEWATERING ACTIVITIES.
- AREAS OR THE COMBINED SEWER SYSTEM.
- OF SOIL DISTURBING ACTIVITIES.
- ACHIEVED.
- PERMANENT SITE STABILIZATION.
- MEASURES MAY BE REQUIRED, AS DIRECTED BY THE ENGINEER, SITE INSPECTOR, OR MWRD.

STATE OF ILLINOIS	N	<b>I.W.R.D.G.C. GENE</b>	
DEPARTMENT OF TRANSPORTATION			
	SCALE: NONE	SHEET NO. 2 OF 2 SHEETS	

6. SOIL DISTURBANCE SHALL BE CONDUCTED IN SUCH A MANNER AS TO MINIMIZE EROSION. IF STRIPPING. CLEARING. GRADING. OR LANDSCAPING ARE TO BE DONE IN PHASES, THE CO-PERMITTEE SHALL PLAN FOR APPROPRIATE SOIL EROSION AND

7. A STABILIZED MAT OF CRUSHED STONE MEETING THE STANDARDS OF THE ILLINOIS URBAN MANUAL SHALL BE INSTALLED AT ANY POINT WHERE TRAFFIC WILL BE ENTERING OR LEAVING A CONSTRUCTION SITE. SEDIMENT OR SOIL REACHING AN IMPROVED PUBLIC RIGHT-OF-WAY, STREET, ALLEY OR PARKING AREA SHALL BE REMOVED BY SCRAPING OR STREET CLEANING AS ACCUMULATIONS WARRANT AND TRANSPORTED TO A CONTROLLED SEDIMENT DISPOSAL AREA.

8. CONCRETE WASHOUT FACILITIES SHALL BE CONSTRUCTED IN ACCORDANCE WITH THE ILLINOIS URBAN MANUAL AND SHALL

9. MORTAR WASHOUT FACILITIES SHALL BE CONSTRUCTED IN ADDITION TO CONCRETE WASHOUT FACILITIES FOR ANY BRICK

10. TEMPORARY DIVERSIONS SHALL BE CONSTRUCTED AS NECESSARY TO DIRECT ALL RUNOFF FROM HYDROLOGICALLY DISTURBED AREAS TO AN APPROPRIATE SEDIMENT TRAP OR BASIN. VOLUME CONTROL FACILITIES SHALL NOT BE USED AS

11.DISTURBED AREAS OF THE SITE WHERE CONSTRUCTION ACTIVITIES HAVE TEMPORARILY OR PERMANENTLY CEASED SHALL

12. ALL FLOOD PROTECTION AREAS AND VOLUME CONTROL FACILITIES SHALL, AT A MINIMUM, BE PROTECTED WITH A

13. VOLUME CONTROL FACILITIES SHALL NOT BE CONSTRUCTED UNTIL ALL OF THE CONTRIBUTING DRAINAGE AREA HAS BEEN

14. SOIL STOCKPILES SHALL, AT A MINIMUM, BE PROTECTED WITH PERIMETER SEDIMENT CONTROLS. SOIL STOCKPILES SHALL

15. EARTHEN EMBANKMENT SIDE SLOPES SHALL BE STABILIZED WITH APPROPRIATE EROSION CONTROL BLANKET.

16. STORM SEWERS THAT ARE OR WILL BE FUNCTIONING DURING CONSTRUCTION SHALL BE PROTECTED BY APPROPRIATE

17. THE CONTRACTOR SHALL EITHER REMOVE OR REPLACE ANY EXISTING DRAIN TILES AND INCORPORATE THEM INTO THE DRAINAGE PLAN FOR THE DEVELOPMENT. DRAIN TILES CANNOT BE TRIBUTARY TO A SANITARY OR COMBINED SEWER. DRAIN

18.IF DEWATERING SERVICES ARE USED, ADJOINING PROPERTIES AND DISCHARGE LOCATIONS SHALL BE PROTECTED FROM EROSION AND SEDIMENTATION. DEWATERING SYSTEMS SHOULD BE INSPECTED DAILY DURING OPERATIONAL PERIODS. THE

19. THE CONTRACTOR SHALL BE RESPONSIBLE FOR TRENCH DEWATERING AND EXCAVATION FOR THE INSTALLATION OF SANITARY SEWERS. STORM SEWERS. WATERMAINS AS WELL AS THEIR SERVICES AND OTHER APPURTENANCES. ANY TRENCH DEWATERING, WHICH CONTAINS SEDIMENT SHALL PASS THROUGH A SEDIMENT SETTLING POND OR EQUALLY EFFECTIVE SEDIMENT CONTROL DEVISE. ALTERNATIVES MAY INCLUDE DEWATERING INTO A SUMP PIT, FILTER BAG OR EXISTING VEGETATED UPSLOPE AREA. SEDIMENT LADEN WATERS SHALL NOT BE DISCHARGED TO WATERWAYS. FLOOD PROTECTION

20.ALL PERMANENT EROSION CONTROL PRACTICES SHALL BE INITIATED WITHIN SEVEN (7) DAYS FOLLOWING THE COMPLETION

21.ALL EROSION AND SEDIMENT CONTROL MEASURES SHALL BE MAINTAINED AND REPAIRED AS NEEDED ON A YEAR-ROUND BASIS DURING CONSTRUCTION AND ANY PERIODS OF CONSTRUCTION SHUTDOWN UNTIL PERMANENT STABILIZATION IS

22.ALL TEMPORARY EROSION AND SEDIMENT CONTROL MEASURES SHALL BE REMOVED WITHIN THIRTY (30) DAYS AFTER

23. THE EROSION AND SEDIMENT CONTROL MEASURES SHOWN ON THE PLANS ARE THE MINIMUM REQUIREMENTS. ADDITIONAL

		F.A.U. RTE.		S	ECTIC	N		CO	JNTY	TOTA SHEET		HEET NO.
RAL NO	DIES	2406	19-00141-00-RS			CC	OOK	29		5		
								CON	TRACT	NO.	61F9	3
STA	to sta	FED.	ROAD	DIST.	NO.	1	ILLINOIS	FED. A	AID PR	OJECT		

DESIGNED DRAWN TG, SFE CHECKED	B, DMM	REVISED - REVISED - REVISED -	STATE OF ILLINOIS DEPARTMENT OF TRANSPORTATIO		SUM	MARY OF QUANTITIES	F.A.U. RTE. 2406	SECTION 19-00141-00-RS	COUNTY COOK CONTRACT	SHEETS
		44000200	DRIVEWAY PAVEMENT REMOVAL	SQ YD	200	200				
`		42400800	DETECTABLE WARNINGS	SQ FT	400	400				
		42400200	PORTLAND CEMENT CONCRETE SIDEWALK 5 INCH	SQ FT	12,500	12,500				
		42300300	PORTLAND CEMENT CONCRETE DRIVEWAY PAVEMENT, 7 INCH	SQ YD	200	200				
		-2101300								
		42101200	PROTECTIVE COAT	SQ YD	2,000	2,000				
`		40800050	INCIDENTAL HOT-MIX ASPHALT SURFACING	TON	20	20				
		40603340	HOT-MIX ASPHALT SURFACE COURSE, MIX "D", N70	TON	1,550	1,550				
		40600982	HOT-MIX ASPHALT SURFACE REMOVAL - BUTT JOINT	SQ YD	150	150				
		40600827	POLYMERIZED LEVELING BINDER (MACHINE METHOD), IL-4.75, N5	0 TON	600	600				
		40600400	MIXTURE FOR CRACKS, JOINTS, AND FLANGEWAYS	TON	20	20				
		40600290	BITUMINOUS MATERIALS (TACK COAT)	POUND	9,200	9,200				
`		28000510	INLET FILTERS	EACH	30	30				
		25200200	SUPPLEMENTAL WATERING	UNIT	50	50				
		25200100	SODDING	SQ YD	1,600	1,600				
					1.000	1.500				
		21101610	TOPSOIL FURNISH AND PLACE, 3"	SQ YD	1,600	20%Local 1,600				
S.P	. S.I.	Code No.	Item	Unit	Total Quantity	Const. Type Code Resurfacing 0005 80%Federal				

HANCOCK ENGINEERING	9933 Roosevelt Road Westchester, IL 60154-2780 Phone: 708-865-0300	DESIGNED - DRAWN CHECKED -	TG, SFB, DMM	REVISED - REVISED - REVISED -	······	STATE OF ILLINOIS DEPARTMENT OF TRANSPORTATION		SUMMARY	OF QL	JANT
	www.ehoncock.com	DATE –	5-13-19	REVISED -			SCALE: NONE	SHEET NO. 1 OF 4	SHEETS	STA

S.P.	S.I.	Code No.	Item	Unit	Total Quantity	Const. Type Code Resurfacing 0005 80%Federal 20%Local			
		44000500	COMBINATION CURB AND GUTTER REMOVAL	FOOT	1,550	1,550			
		44000600	SIDEWALK REMOVAL	SQ FT	12,500	12,500			
		44201737	CLASS D PATCHES, TYPE I, 8 INCH	SQ YD	50	50			
		44201741	CLASS D PATCHES, TYPE II, 8 INCH	SQ YD	100	100			
		44201745	CLASS D PATCHES, TYPE III, 8 INCH	SQ YD	350	350			
		44201747	CLASS D PATCHES, TYPE IV, 8 INCH	SQ YD	900	900			
		56500600	DOMESTIC WATER SERVICE BOXES TO BE ADJUSTED	EACH	5	5			
-	·	60266600	VALVE BOXES TO BE ADJUSTED	EACH	3	3			
<b>`</b>		60252800	CATCH BASINS TO BE RECONSTRUCTED	EACH	1	1			
<b>`</b>		60257900	MANHOLES TO BE RECONSTRUCTED	EACH	4	4			
•		60266100	VALVE VAULTS TO BE RECONSTRUCTED	EACH	1	1			
<b>`</b>		60300305	FRAMES AND LIDS TO BE ADJUSTED	EACH	25	25			
<b>`</b>		60406000	FRAMES AND LIDS, TYPE 1, OPEN LID	EACH	5	5			
`		60406100	FRAMES AND LIDS, TYPE 1, CLOSED LID	EACH	20	20			
		60600605	CONCRETE CURB, TYPE B	FOOT	25	25			
		REVISED -			<u> </u>		 F.A.U. RTE.		TOT SHE


	9933 Roowyeit Road	DESIGNED -	•	REVISED –				
	Westchester, IL, 60154-2780	DRAWN	TG, SFB, DMM	REVISED -	STATE OF ILLINOIS		SUMMARY OF	F QUAN
ENGINEERING States	Phone: 708-865-0300	CHECKED -	-	REVISED -	DEPARTMENT OF TRANSPORTATION			
	www.ehancock.com	DATE -	5-13-19	REVISED -		SCALE: NONE	SHEET NO. 2 OF 4 SH	HEETS STA

GINEEKING	5-13-19		REVISED -		SCALE: NO	ONE SHEET NO	. 3 OF 4 SHEETS STA	TO STA FED. RO/	d dist. no. 1   Illinois	
Westchester, IL 601542780	- TG, SFB, 	S, DMM	REVISED -	DEPARTMENT OF TRANSPORTATIO	N	20MI	WART OF QUANTITIES	2406	19-00141-00-RS	COOK 29 CONTRACT NO. 61
			REVISED -	STATE OF ILLINOIS		CIIMI	MARY OF QUANTITIES	F.A.U. RTE.	SECTION	COUNTY TOTAL SHEETS
				· · · ·						
		*	78000200	IERMOPLASTIC PAVEMENT MARKING - LINE 4"	FOOT	8,000	8,000			
	l						· · · · · · · · · · · · · · · · · · ·			
	<u> </u>	<u> </u>				 				
		*	78000100	HERMOPLASTIC PAVEMENT MARKING- LETTERS AND SYMBOLS	SQ FT	20	20			
			1							
	<u> </u>	<u> </u>	70300150	IORT TERM PAVEMENT MARKING REMOVAL	SQ FT	5,000	5,000			
	F		70200150		50 FT	E 000	E 000			
			70300100	IORT TERM PAVEMENT MARKING	FOOT	3,000	3,000			
		<u> </u>								
			70107025	HANGEABLE MESSAGE SIGN	CAL DA	45	45			
		<u> </u>	70102640	RAFFIC CONTROL AND PROTECTION, STANDARD 701801	LSUM	1	1			
			70102640							
			70102635	RAFFIC CONTROL AND PROTECTION, STANDARD 701701	LSUM	1	1			
		1		·						
			70102620	AFFIC CONTROL AND PROTECTION, STANDARD 701501	LSUM	1	1			
· · · · · · ·				•						
			6/100100	OBILIZATION	LSUM	1	1			
		1	67400400							
		<u> </u>								
		*	66900530	DIL DISPOSAL ANALYSIS	EACH	1	1			
		*			LJUIVI	<u> </u>				
			66901003	EGULATED SUBSTANCES FINAL CONSTRUCTION REPORT	LSUM	1	1			
		*	66901002	N-SITE MONITORING OF REGULATED SUBSTANCES	CAL DA	1	1			
		<u> </u>								
	1						-			
		*	66901001	EGULATED SUBSTANCES PRE-CONSTRUCTION PLAN	LSUM	1	1			
		*	66900200	ON-SPECIAL WASTE DISPOSAL	CU YD	5	5			
				MODIFIED)						
	`		60604100	OMBINATION CONCRETE CURB AND GUTTER, TYPE B-6.12	FOOT	1,550	1,550			
						Quantity	80%Federal 20%Local			
	S.P.	S.I.	Code No.	ltem	Unit	Total	Const. Type Code Resurfacing 0005			


DESIGNED – - DRAWN – TG, SFB, DMM CHECKED – -	REVISED – REVISED – REVISED –	STATE OF ILLINOIS DEPARTMENT OF TRANSPORTATION		SUMMARY OF QUA
DATE – 5-13-19	REVISED -		SCALE: NONE	SHEET NO. 3 OF 4 SHEETS S

		S.F	P. S.I.	Code No.	ltem	Unit	Total Quantity	Const. Type Code Resurfacing 0005 80%Federal 20%Local				
			*	78000600	THERMOPLASTIC PAVEMENT MARKING - LINE 12"	FOOT	200	200				
			*	78000650	THERMOPLASTIC PAVEMENT MARKING - LINE 24"	FOOT	240	240				
			*	78001100	PAINT PAVEMENT MARKING - LETTERS AND SYMBOLS	SQ FT	20	20				
			*	78001110	PAINT PAVEMENT MARKING-LINE 4"	FOOT	50	50				
			*	78100100	RAISED REFLECTIVE PAVEMENT MARKER	EACH	35	35				
				X0327611	REMOVE AND REINSTALL BRICK PAVERS	SQ FT	300	300				
		`		X4401198	HOT-MIX ASPHALT SURFACE REMOVAL, VARIABLE DEPTH	SQ YD	13,500	13,500				
				X6030310	FRAMES AND LIDS TO BE ADJUSTED (SPECIAL)	EACH	25	25				
				70030850		SQ FT	52	52				
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HANCOCK ENGINEERING	Civil Engineers     Municipal Consultants     Wetcherfer: LL 4014-2720     DRAW	<u>NED – –</u> <u>N – TG, SP</u> KED – –	FB, DMM	REVISED	STATE OF ILLINOIS DEPARTMENT OF TRANSPORTATIO		SUMM	MARY OF QUANTIT	ES	F.A.U. 2406	SECTION 19-00141-00-RS	COUNTY COOK CONTRACT

HANCOCK	9933 Roosevett Road Westchester, il. 60154-2780 Phone: 708-865-0300	DESIGNED - DRAWN - CHECKED -	- TG, SFB, DMM	REVISED -	STATE OF ILLINOIS		SUMMARY	OF QL	JAN
	www.ehoncock.com	DATE -	- 5-13-19	REVISED	DEPARTMENT OF TRANSPORTATION	SCALE: NONE	SHEET NO. 4 OF 4	SHEETS	STA.

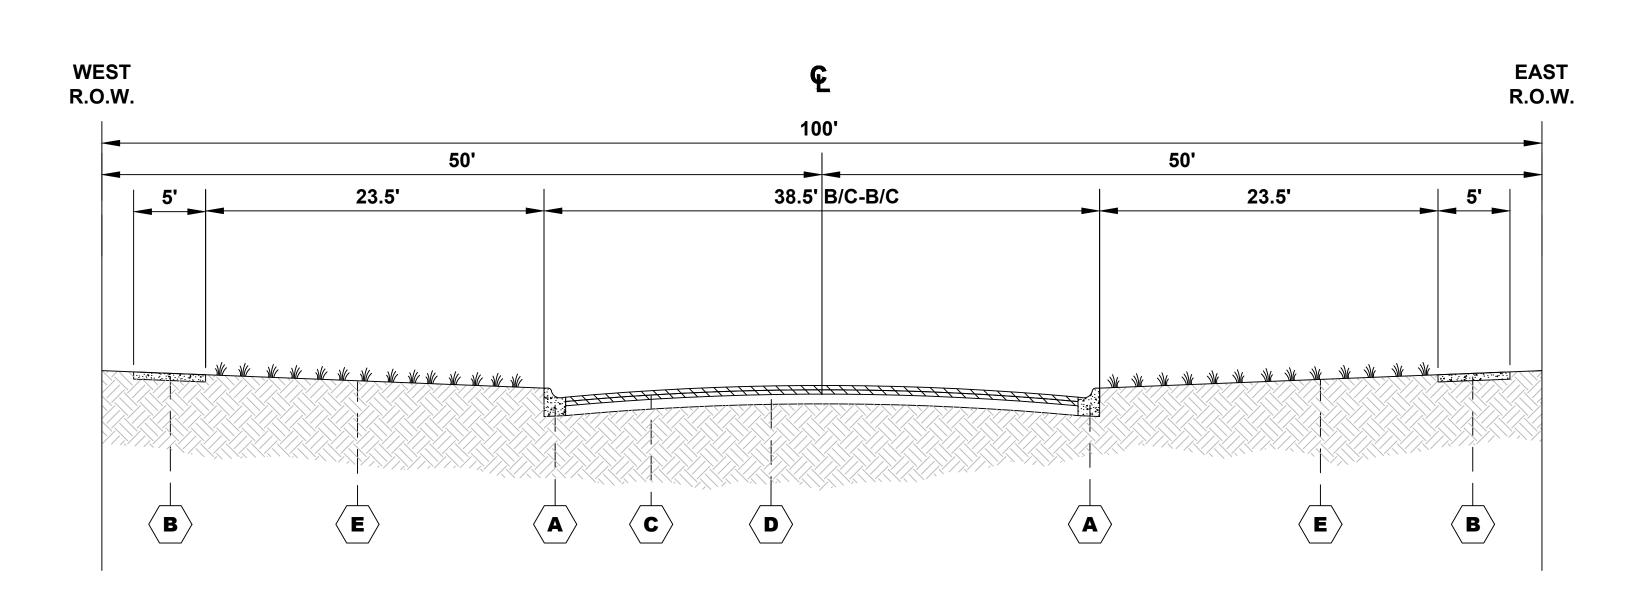

**EXISTING TYPICAL SECTION BROADWAY AVENUE STATION 0+20 TO STATION 21+25** 

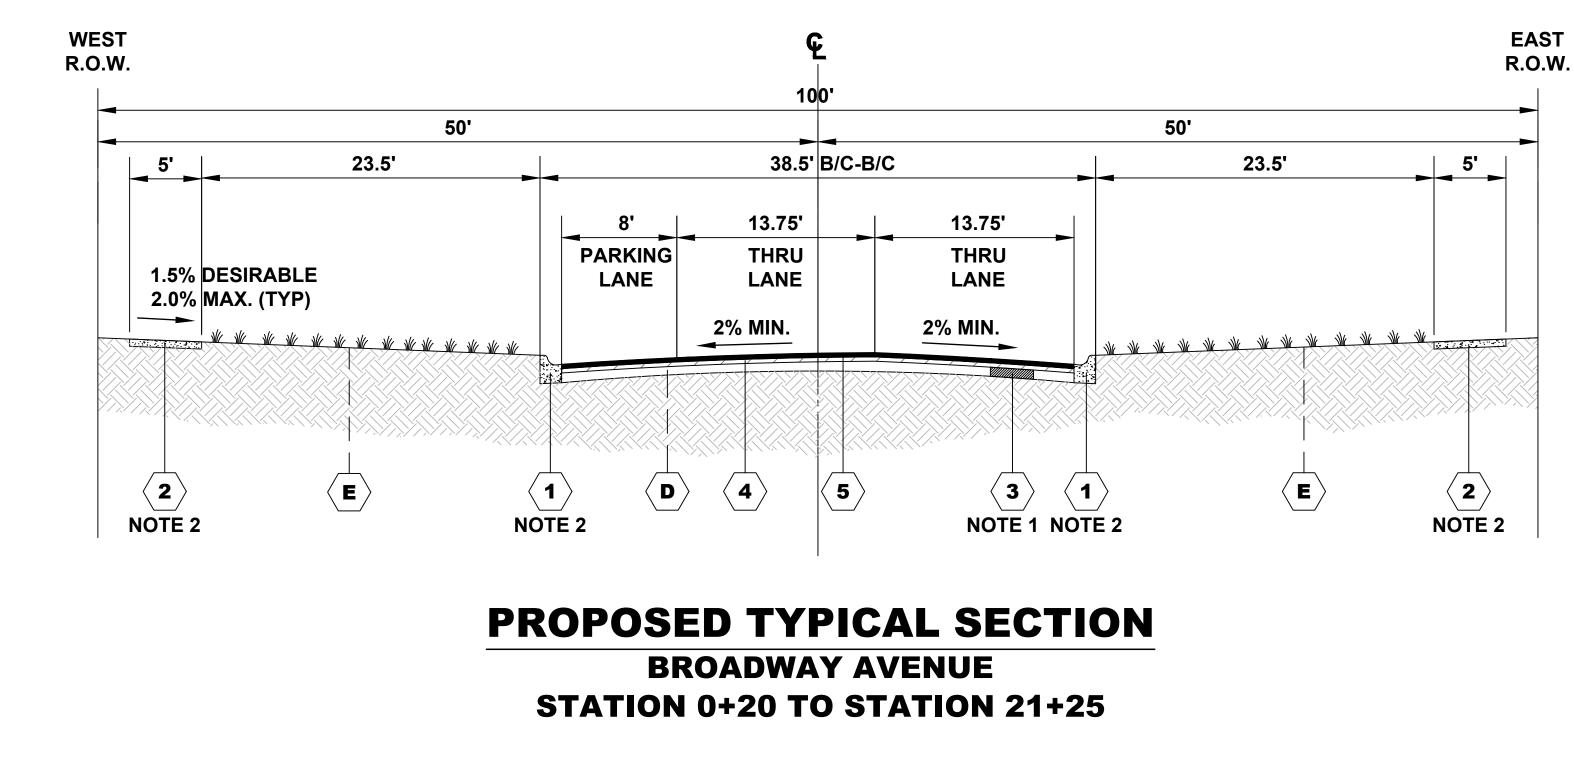



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EXISTING		EXISTING HOT-MI
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P	3	PROPOSED CLAS
PRO	4	PROPOSED POLY
	5	PROPOSED HOT-

HOT-MIX ASPHALT (HMA) MIXTURE REQUIREMENTS					
MIXTURE TYPE	AIR VOIDS @ Ndes				
HOT-MIX ASPHALT SURFACE COURSE, MIX "D", N70, (IL 9.5mm), 2"	4% @ 70 Gyr				
POLYMERIZED LEVELING BINDER (MACHINE METHOD), IL-4.75, N50, 3⁄4"	3.5% @ 50 Gyr				
CLASS D PATCHES (HMA BINDER IL-19mm), 8"	4% @ 70 Gyr				
NCIDENTAL HOT-MIX ASPHALT SURFACING (HMA SURFACE, MIX "D", N50 IL 9.5mm), 3"	4% @ 50 Gyr				

THE UNIT WEIGHT USED TO CALCULATE ALL HMA SURFACE MIXTURE QUANTITIES IS 112 LBS/SQ YD/IN

THE "AC TYPE" FOR POLYMERIZED HMA MIXES SHALL BE "SBS/SBR PG 76-22" AND FOR NON-POLYMERIZED HMA THE "AC TYPE" SHALL BE "PG 64-22" UNLESS MODIFIED BY DISTRICT ONE SPECIAL PROVISIONS.

FOR USE OF RECYCLED MATERIALS SEE SPECIAL PROVISIONS.

### NOTE

- 1. CONTRACTOR SHALL MILL BEFORE PATCHING
- 2. SIDEWALK AND CURB & GUTTER LIMITS AS SHOWN ON PLANS

STATE OF ILLINOIS DEPARTMENT OF TRANSPORTATION		EXISTING AND P TYPICAL SEC
	SCALE: NONE	SHEET NO. 1 OF 2 SHEETS

# END OF SYMBOLS

#### DESCRIPTION

SINATION CONCRETE CURB AND GUTTER, TYPE B-6.12

LAND CEMENT CONCRETE SIDEWALK

MIX ASPHALT BINDER AND SURFACE COURSES

EGATE BASE COURSE

SCAPED PARKWAY

ERMITTENT COMBINATION CONCRETE CURB EMOVAL AND REPLACEMENT, TYPE B-6.12

ERMITTENT PORTLAND CEMENT CONCRETE SIDEWALK, 5"


ASS D PATCHES, 8" (AS LOCATED IN FIELD)

YMERIZED LEVELING BINDER, (MM), IL-4.75, N50,  $\frac{3}{4}$ "


-MIX ASPHALT SURFACE COURSE, MIX D, N70, 2"

3. PAVEMENT PATCHING SHALL BE STAGED TO MAINTAIN TWO-WAY TRAFFIC AT ALL TIMES

ROPOSED TIONS		F.A.U RTE.	· SECTION		COUNTY		TOTAL	SHEET		
		2406		19-0	0141-00	-RS	со	OK	29	10
							CONT	RACT	NO. 6	1F93
STA	TO STA	FED.	ROAD	DIST.	NO. 1	ILLINOIS	FED. A	ID PRO	JECT	

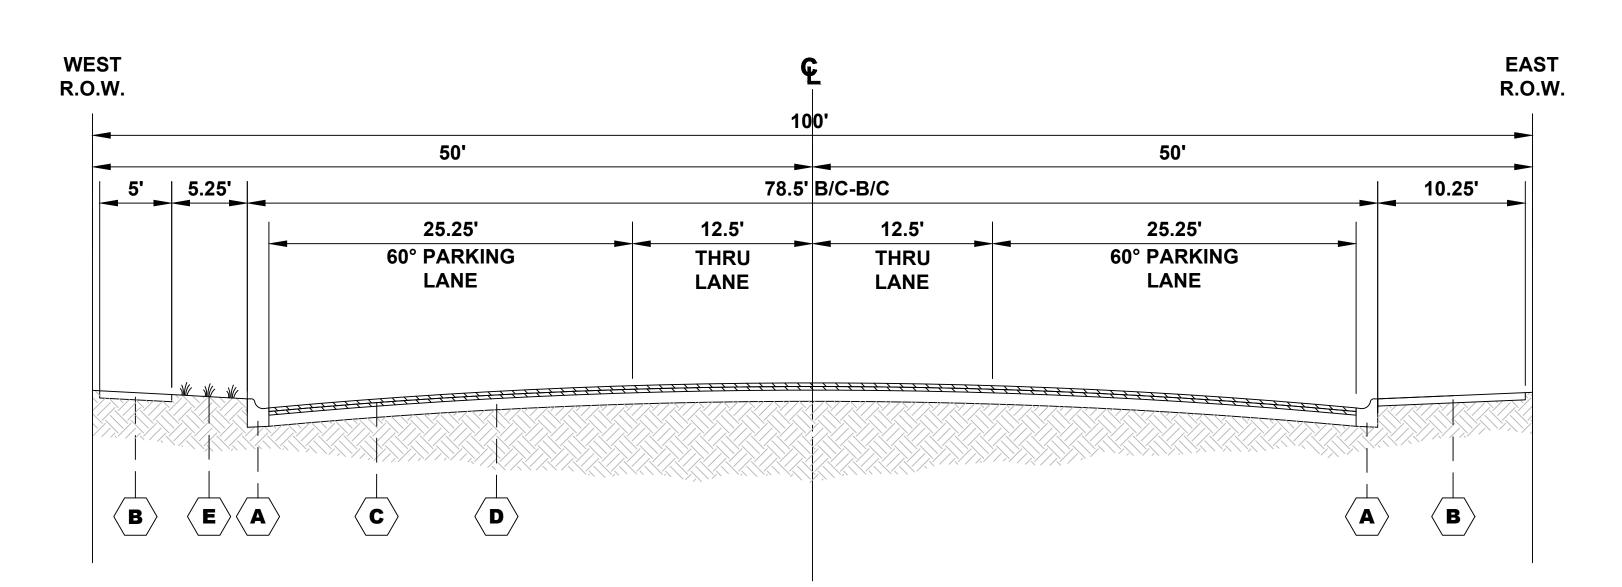

**EXISTING TYPICAL SECTION BROADWAY AVENUE STATION 21+25 TO STATION 26+78** 

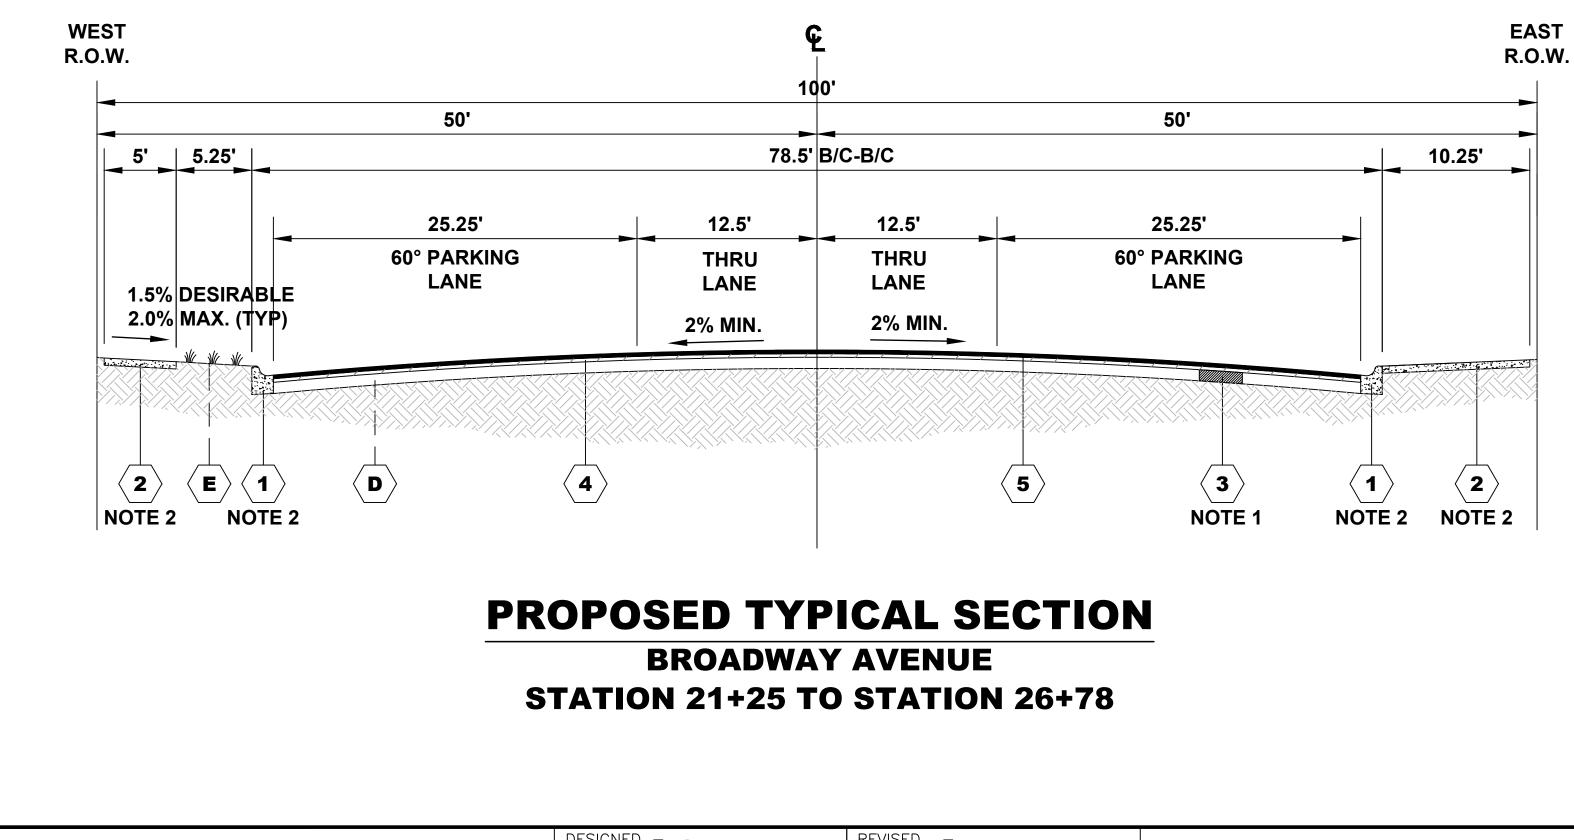

× .:		DESIGNED -		REVISED –			EXISTING AND PROPOSED	F.A.U.	SECTION	COUNTY	TOTAL SHEET
g file	HANCOCK Municipal Consultants Westchester, IL, 60154-2780	DRAWN -	TG, SFB, DMM	REVISED -	STATE OF ILLINOIS		TYPICAL SECTIONS	2406	19-00141-00-RS	СООК	29 11
Irawin	ENGINEERING       Established 1911       Phone: 708-865-0300	CHECKED -		REVISED -	<b>DEPARTMENT OF TRANSPORTATION</b>	SCALE: NONE				CONTRA	CT NO. 61F93
		DATE -	5-13-19	REVISED -		SCALE: NUNE	SHEET NO. 2 OF 2 SHEETS STA TO STA	FED. RO/	AD DIST. NO. 1   ILLIN	NOIS IFED. AID H	

		LEG
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		PROPOSED INTER AND GUTTER REI
SED	2	PROPOSED INTER
PO	3	PROPOSED CLAS
PRO	4	PROPOSED POLY
	5	PROPOSED HOT-

### NOTE

- 1. CONTRACTOR SHALL MILL BEFORE PATCHING
- 2. SIDEWALK AND CURB & GUTTER LIMITS AS SHOWN ON PLANS

# END OF SYMBOLS

#### DESCRIPTION

SINATION CONCRETE CURB AND GUTTER, TYPE B-6.12

LAND CEMENT CONCRETE SIDEWALK

MIX ASPHALT BINDER AND SURFACE COURSES

**REGATE BASE COURSE** 

SCAPED PARKWAY

ERMITTENT COMBINATION CONCRETE CURB EMOVAL AND REPLACEMENT, TYPE B-6.12


ERMITTENT PORTLAND CEMENT CONCRETE SIDEWALK, 5"

ASS D PATCHES, 8" (AS LOCATED IN FIELD)

YMERIZED LEVELING BINDER, (MM), IL-4.75, N50,  $\frac{3}{4}$ "


-MIX ASPHALT SURFACE COURSE, MIX D, N70, 2"

3. PAVEMENT PATCHING SHALL BE STAGED TO MAINTAIN TWO-WAY TRAFFIC AT ALL TIMES

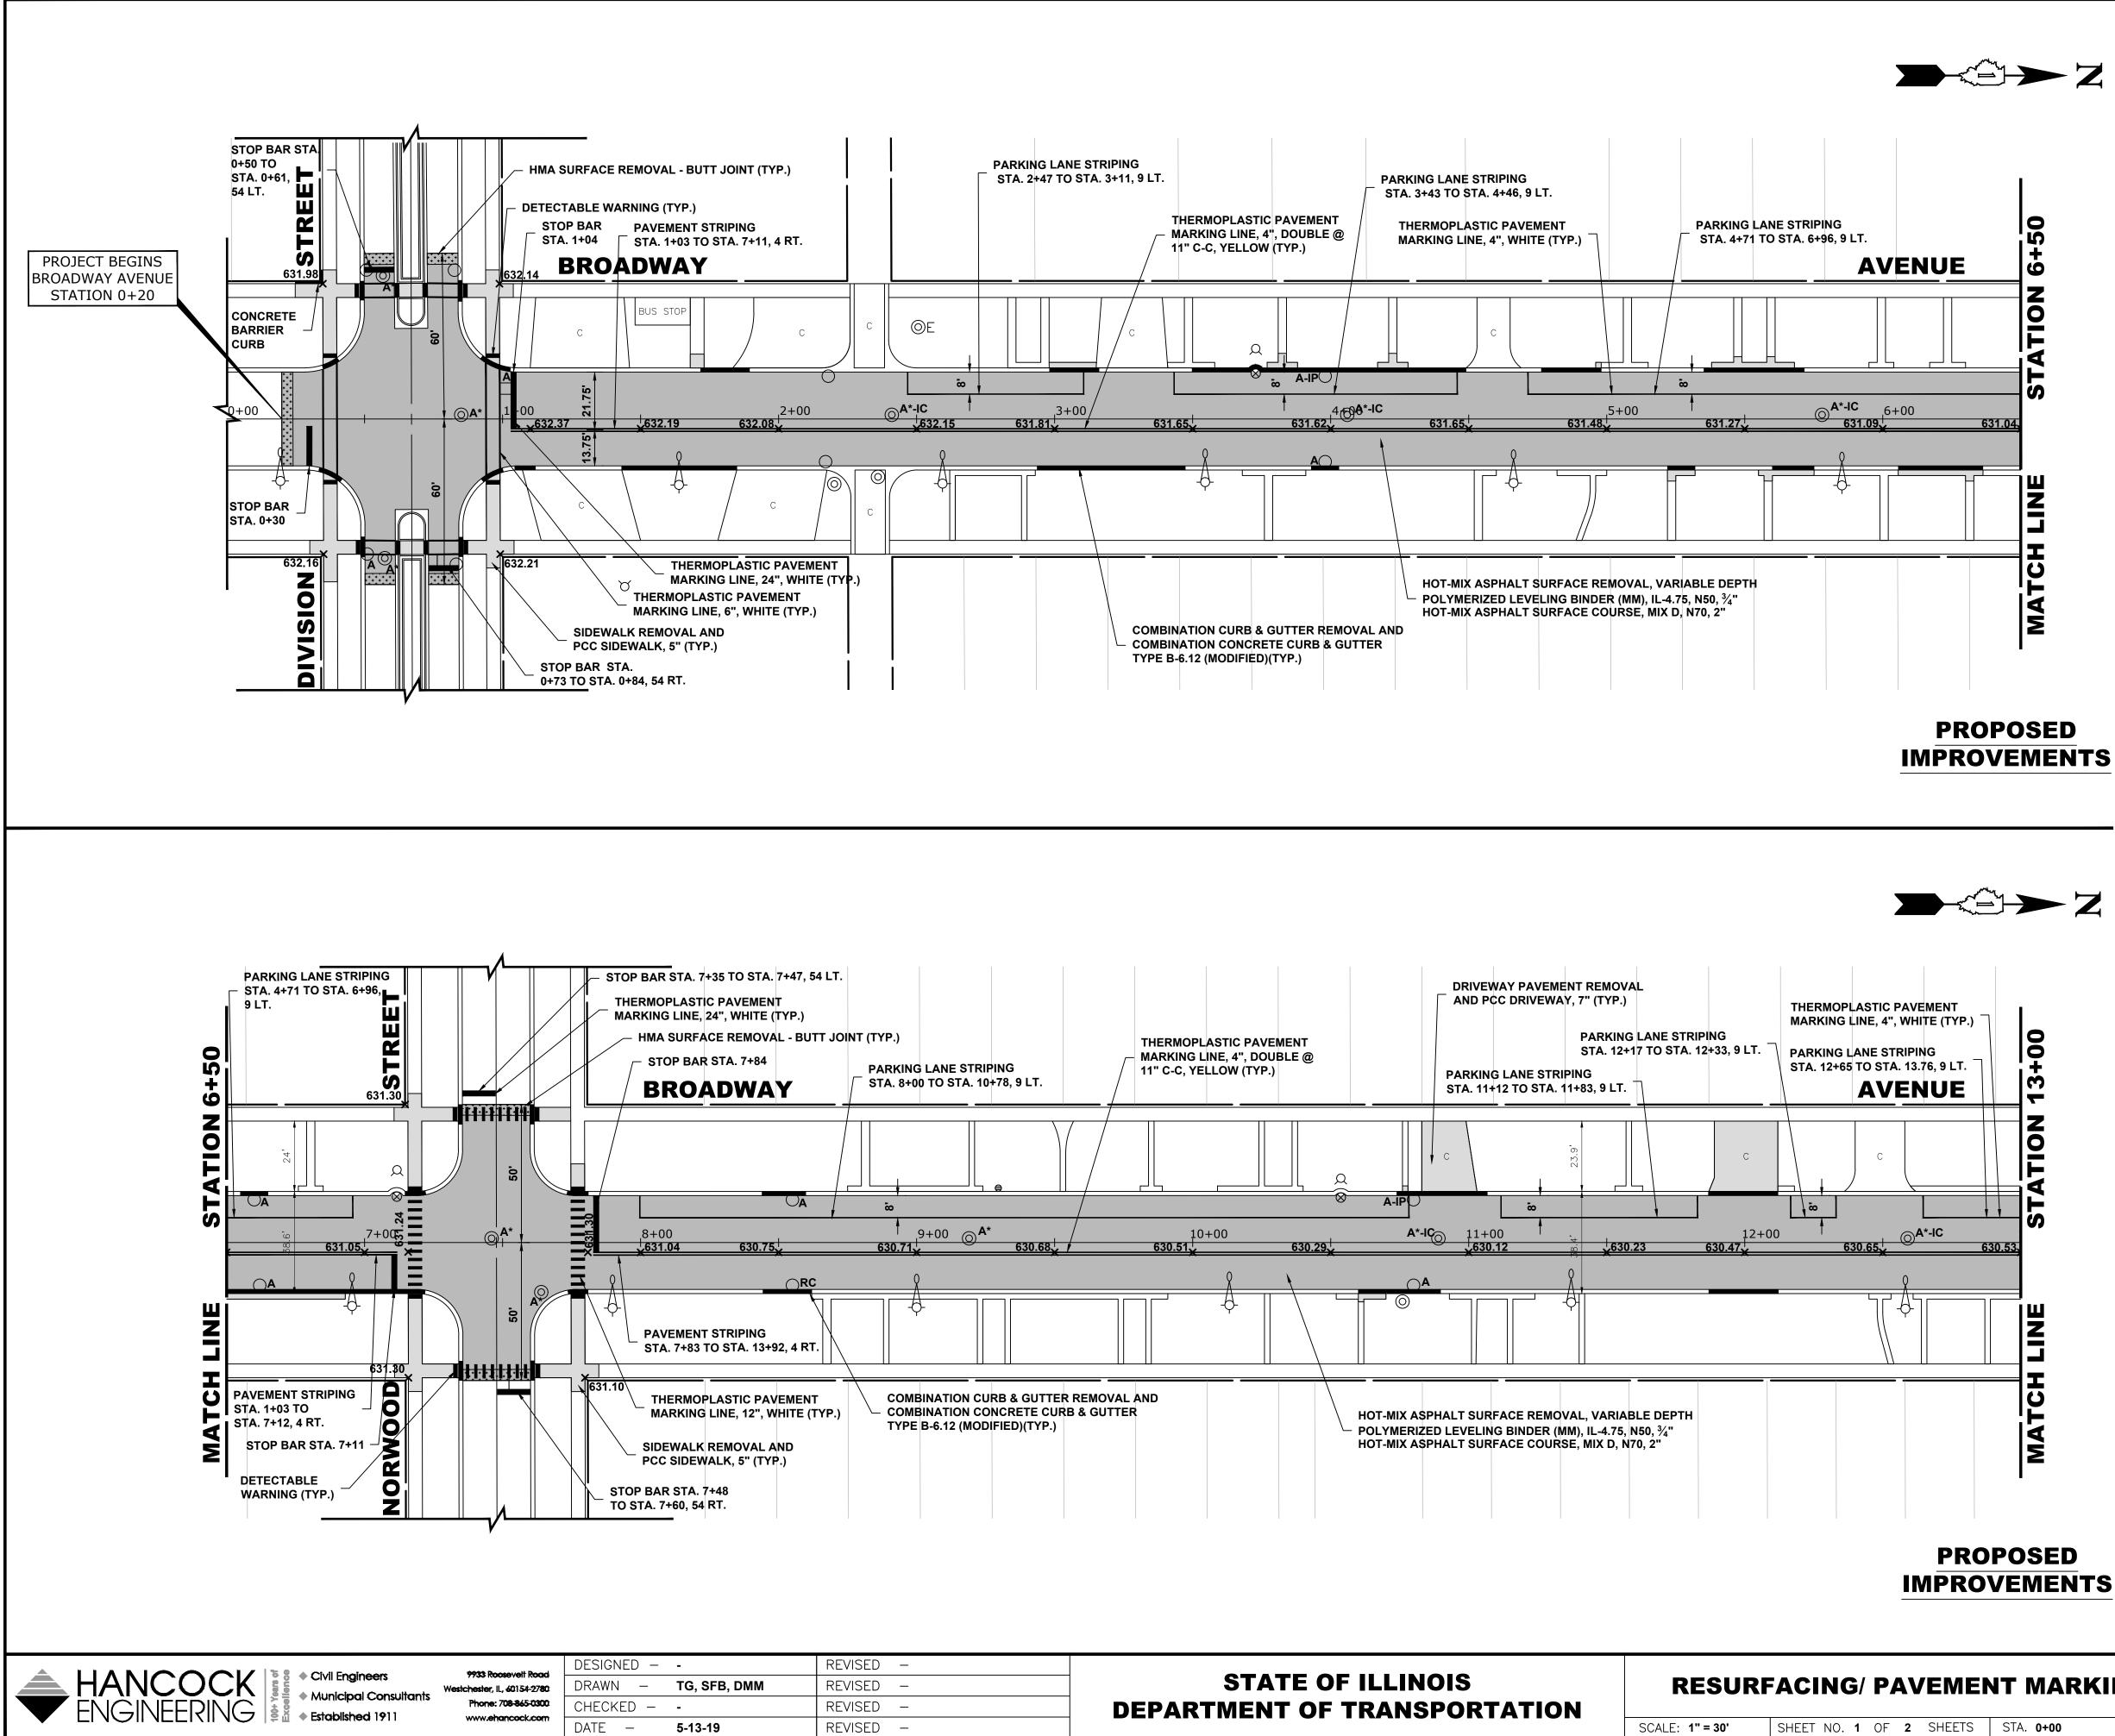


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OF TRANSPORTATION		
••••••••••••••••••	SCALE: <b>1" = 30'</b>	SHEET NO. 1



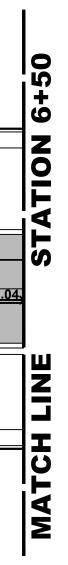




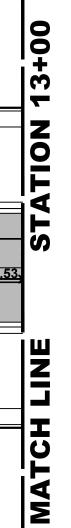

LEGE	END OF	SYMB	OLS
(TO BE USED IN CO	JUNCTION W	ITH I.D.O.T. STA	NDARD 000

	BE USED IN CONJUNCTION WITH I.D.O.T. STANDARD 000001-07)							
<u>SYMBOL</u>	DESCRIPTION							
A	EXISTING HOT-MIX ASPHALT AREA							
C	EXISTING CONCRETE AREA							
G	EXISTING GRASS AREA							
+ + + + + +	PROPOSED HOT-MIX ASPHALT BUTT JOINT							
	REMOVE AND REINSTALL BRICK PAVER							
	PROPOSED CONCRETE AREA, 5" SIDEWALK, 7" DRIVEWAY							
	PROPOSED HOT-MIX ASPHALT RESURFACING AREA							
А	STRUCTURE TO BE ADJUSTED							
A*	STRUCTURE TO BE ADJUSTED (SPECIAL)							
AH	HANDHOLE TO BE ADJUSTED							
1C	NEW FRAME AND LID, TYPE 1, CLOSED LID							
1P	NEW FRAME AND LID, TYPE 1, OPEN LID							
1B	NEW FRAME AND LID, TYPE 1, WATERTIGHT BOLT DOWN LID							
RC	STRUCTURE TO BE RECONSTRUCTED							
Y	EXISTING FIRE HYDRANT							
$\otimes$	EXISTING WATER VALVE BOX							
	EXISTING WATER MAIN VALVE VAULT							
	EXISTING STORM SEWER INLET							
$\bigcirc$	EXISTING STORM SEWER CATCH BASIN							
	PROPOSED STORM SEWER CATCH BASIN							
$\bigcirc$	EXISTING SEWER MANHOLE							
-\$>>0	EXISTING STREET LIGHT POLE							
Ø	EXISTING POWER POLE							
	EXISTING HANDHOLE							
	EXISTING CURB AND GUTTER							
	PROPOSED CONCRETE CURB, TYPE B							
	PROPOSED COMBINATION CONCRETE CURB AND GUTTER REMOVAL AND REPLACEMENT							
>	EXISTING STORM SEWER							
)>	EXISTING COMBINED SEWER							
WI	EXISTING WATER MAIN							

		SECTION	COUNTY	TOTAL SHEETS	SHEET NO.
IT MARKING PLAN	2406	19-00141-00-RS	СООК	29	12
			CONTRACT	NO. 61	F93
STA. 0+00 TO STA. 13+00	FED. I	ROAD DIST. NO. 1 ILLINOIS	FED. AID PRO	JECT	
					40.07004

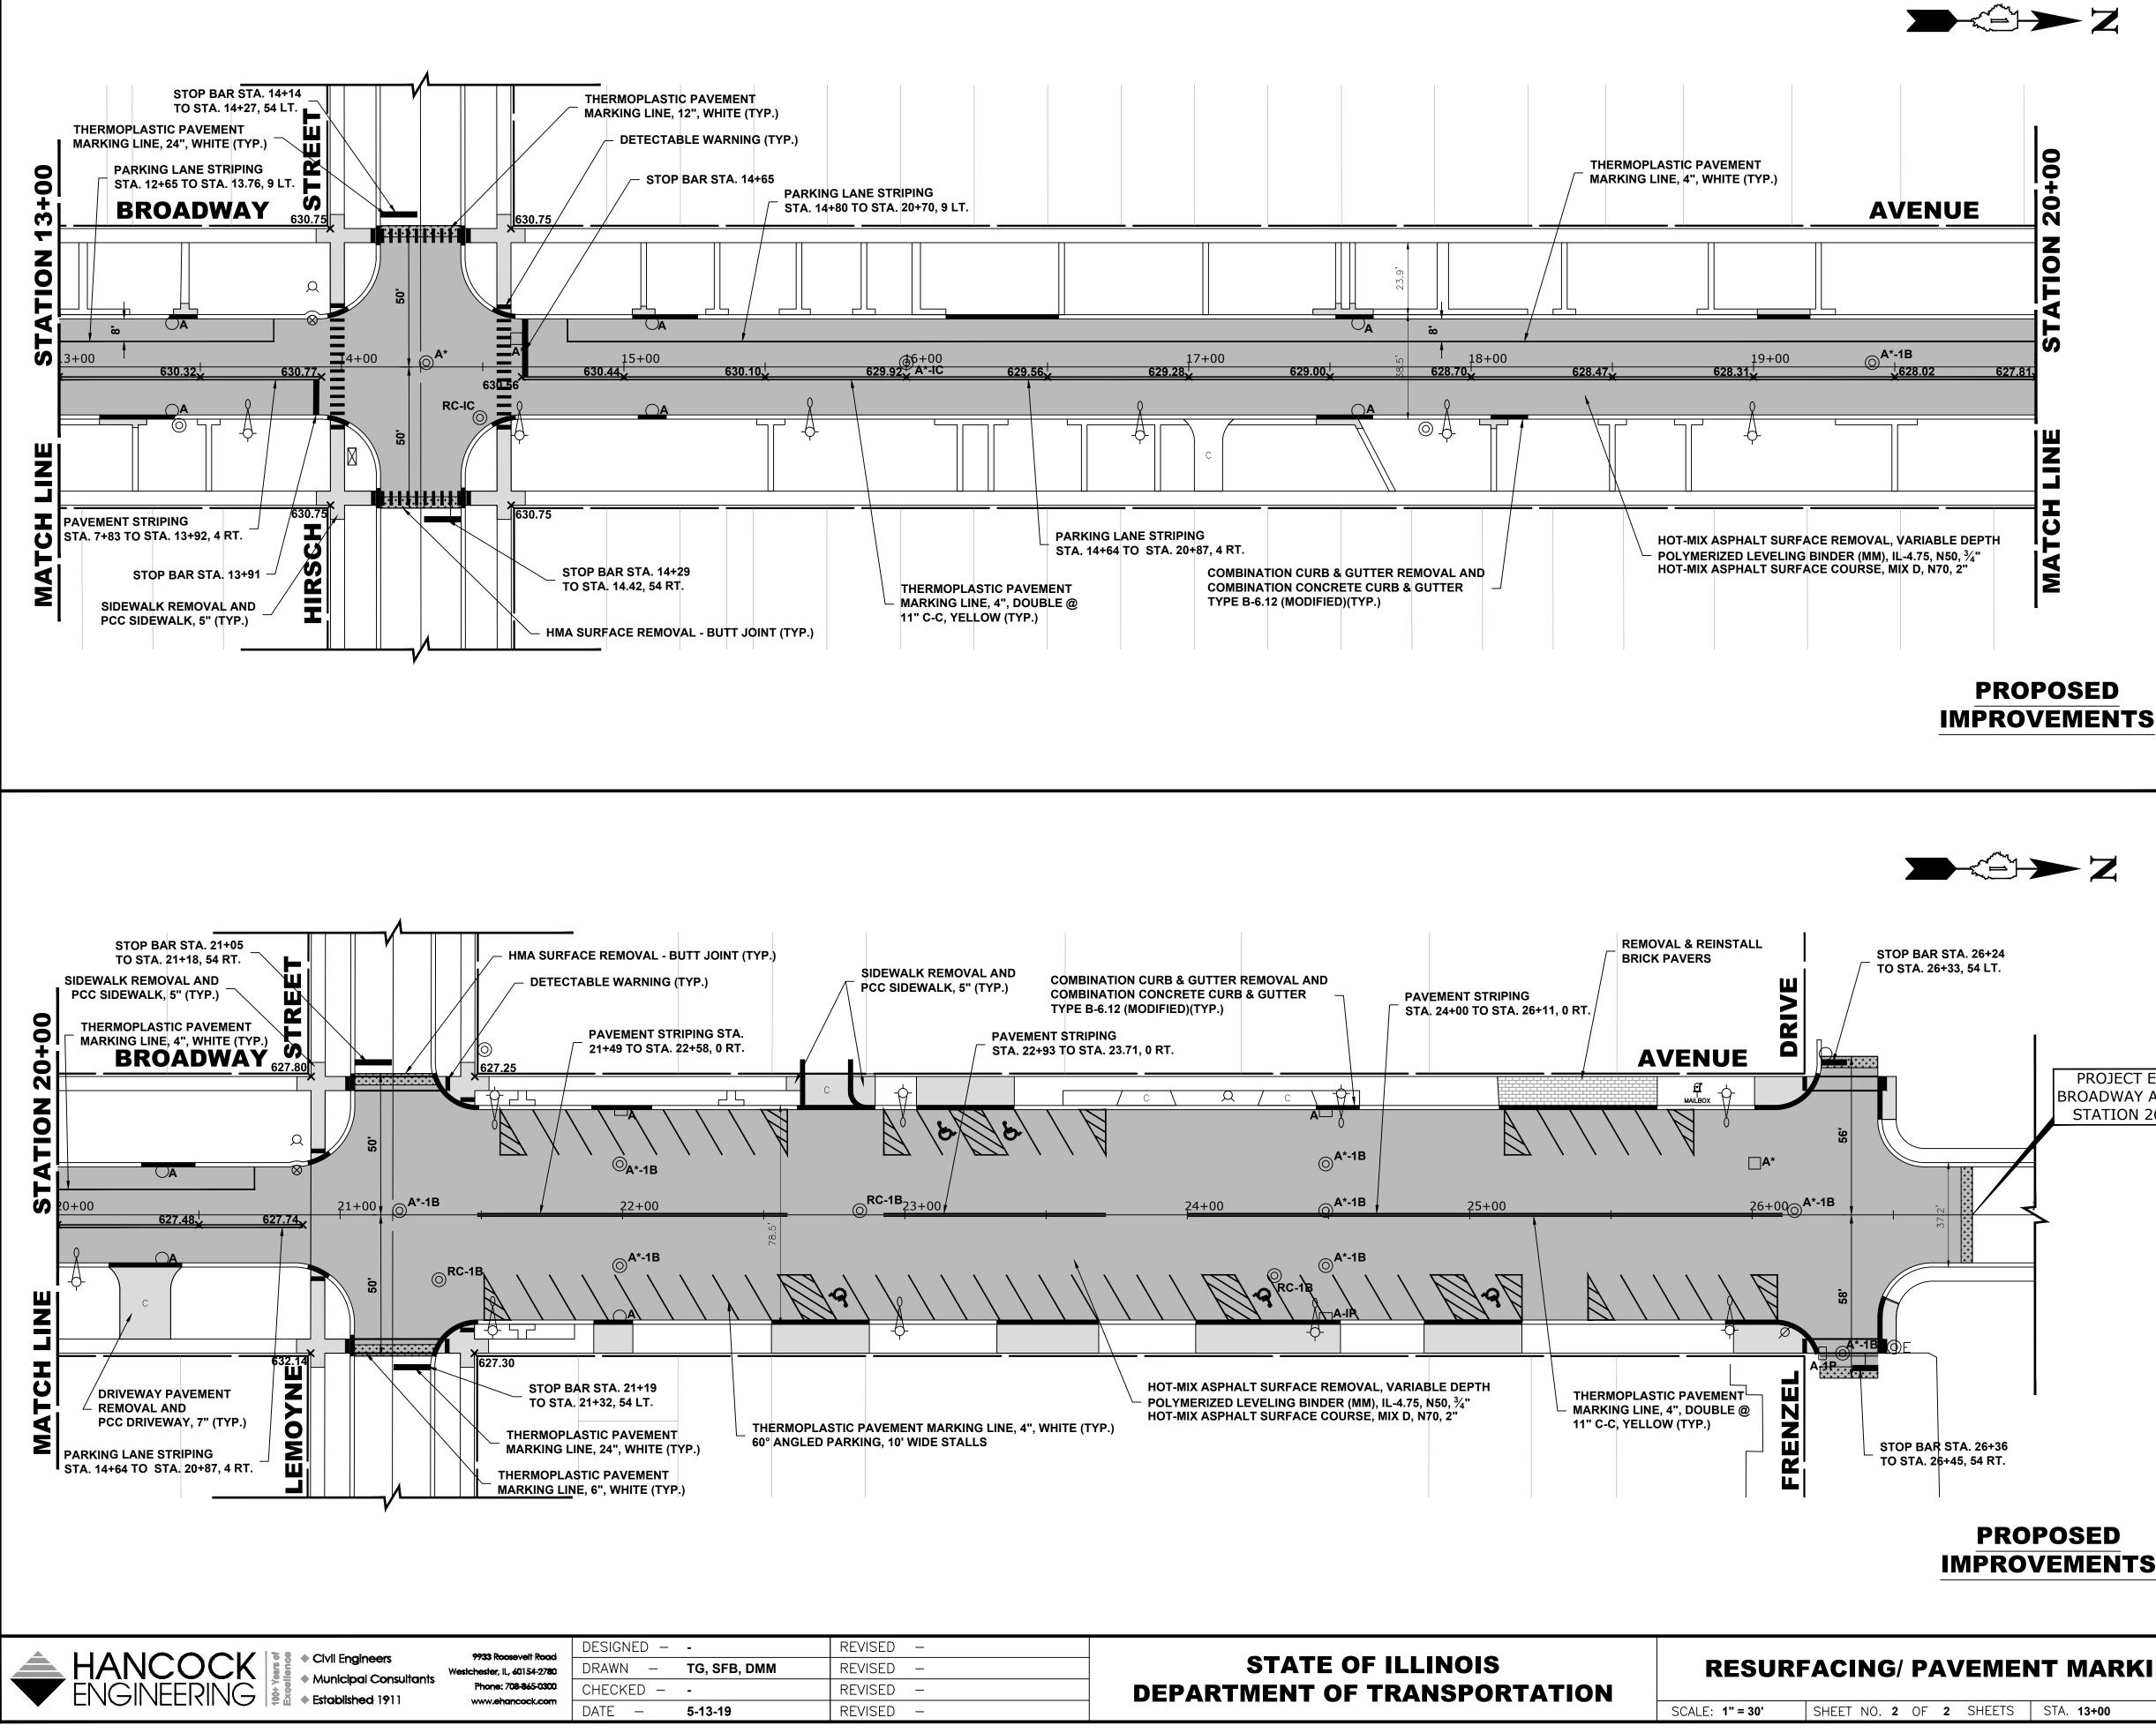




PROJECT ENDS
BROADWAY AVENUE
STATION 26+78

LEGEND	OF	<b>SYMB</b>	OLS


(TO BE USED IN CONJUNCTION WITH I.D.O.T. STANDARD 000001-07)							
SYMBOL	DESCRIPTION						
	EXISTING HOT-MIX ASPHALT AREA						
С	EXISTING CONCRETE AREA						
G	EXISTING GRASS AREA						
  + + + +	PROPOSED HOT-MIX ASPHALT BUTT JOINT						
	REMOVE AND REINSTALL BRICK PAVER						
	PROPOSED CONCRETE AREA, 5" SIDEWALK, 7" DRIVEWAY PROPOSED HOT-MIX ASPHALT RESURFACING AREA						
A	STRUCTURE TO BE ADJUSTED						
A*	STRUCTURE TO BE ADJUSTED (SPECIAL)						
AH	HANDHOLE TO BE ADJUSTED						
1C	NEW FRAME AND LID, TYPE 1, CLOSED LID						
1P	NEW FRAME AND LID, TYPE 1, OPEN LID						
1B	NEW FRAME AND LID, TYPE 1, WATERTIGHT BOLT DOWN LID						
RC	STRUCTURE TO BE RECONSTRUCTED						
Y	EXISTING FIRE HYDRANT						
$\otimes$	EXISTING WATER VALVE BOX						
	EXISTING WATER MAIN VALVE VAULT						
	EXISTING STORM SEWER INLET						
$\bigcirc$	EXISTING STORM SEWER CATCH BASIN						
$\bullet$	PROPOSED STORM SEWER CATCH BASIN						
$\odot$	EXISTING SEWER MANHOLE						
-\$>>>	EXISTING STREET LIGHT POLE						
Ø	EXISTING POWER POLE						
	EXISTING HANDHOLE						
	EXISTING CURB AND GUTTER						
	PROPOSED CONCRETE CURB, TYPE B						
	PROPOSED COMBINATION CONCRETE CURB AND GUTTER REMOVAL AND REPLACEMENT						
<b>&gt;</b>	EXISTING STORM SEWER						
)>	EXISTING COMBINED SEWER						
W+	EXISTING WATER MAIN						

IT MARKING PLAN		F.A.U RTE.				COUNT	γ	TOTAL SHEETS	SHEET NO.	
		2406		19-00141-00-RS			COOM	K	29	13
							CONTRA	ACT	NO. 6	1F93
STA. <b>13+00</b>	TO STA. 27+00	FED.	ROAD	DIST.	NO. 1	ILLINOIS	FED. AID	PRO	JECT	
										40.07004

E.H.E. PROJECT NO. 600-18-27901

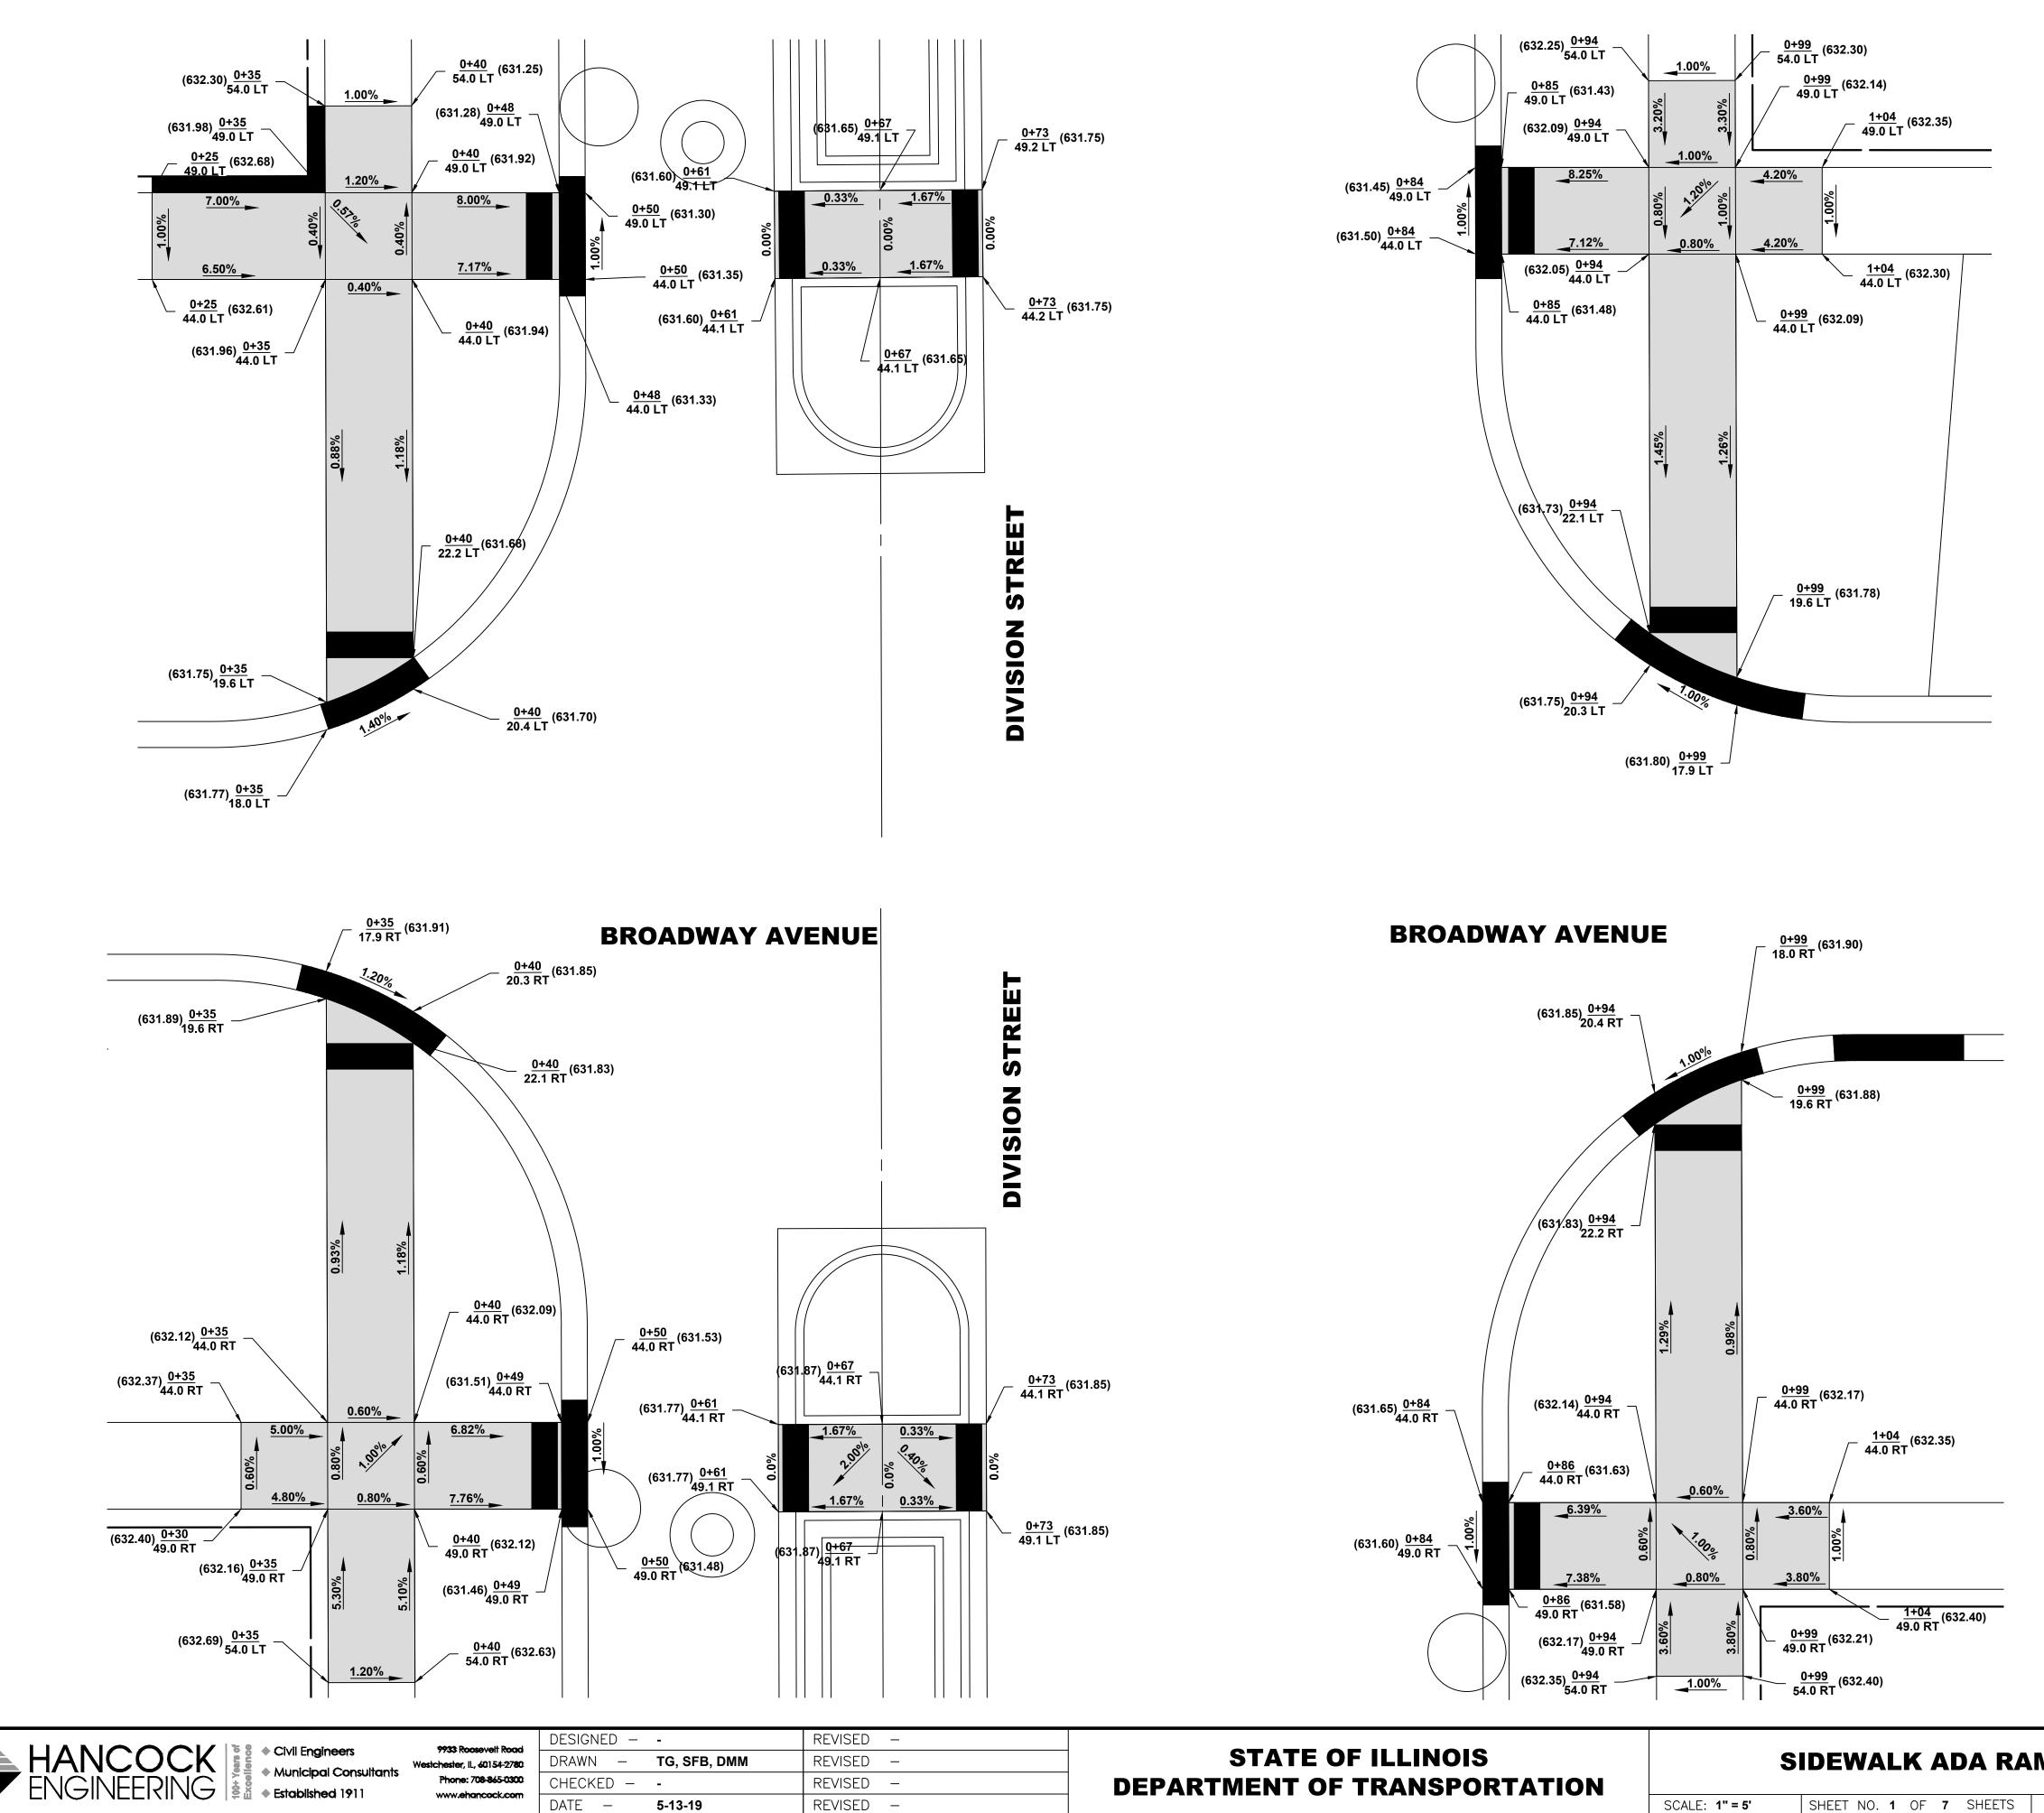


SHEET NO. 1 OF 7 SHEETS SCALE: 1" = 5'

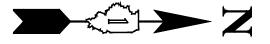

CTION WITH I.D.O.T. STANDARD 000001-07)							
DESCRIPTION							
EXISTING HOT-MIX ASPHALT AREA							
EXISTING CONCRETE AREA							
EXISTING GRASS AREA							
PROPOSED HOT-MIX ASPHALT BUTT JOINT							
REMOVE AND REINSTALL BRICK PAVER							
PROPOSED CONCRETE AREA, 5" SIDEWALK, 7" DRIVEWAY							
PROPOSED HOT-MIX ASPHALT RESURFACING AREA							
STRUCTURE TO BE ADJUSTED							
STRUCTURE TO BE ADJUSTED (SPECIAL)							
HANDHOLE TO BE ADJUSTED							
NEW FRAME AND LID, TYPE 1, CLOSED LID							
NEW FRAME AND LID, TYPE 1, OPEN LID							
NEW FRAME AND LID, TYPE 1, WATERTIGHT BOLT DOWN LID							
STRUCTURE TO BE RECONSTRUCTED							
EXISTING FIRE HYDRANT							
EXISTING WATER VALVE BOX							
EXISTING WATER MAIN VALVE VAULT							
EXISTING STORM SEWER INLET							
EXISTING STORM SEWER CATCH BASIN							
PROPOSED STORM SEWER CATCH BASIN							
EXISTING SEWER MANHOLE							
EXISTING STREET LIGHT POLE							
EXISTING POWER POLE							
EXISTING HANDHOLE							
EXISTING CURB AND GUTTER							
PROPOSED CONCRETE CURB, TYPE B							
PROPOSED COMBINATION CONCRETE CURB AND GUTTER REMOVAL AND REPLACEMENT							
EXISTING STORM SEWER							
EXISTING COMBINED SEWER							
EXISTING WATER MAIN							

MP DETAILS		F.A.U RTE.				CC	UNTY	TOTAI SHEET		SHEET NO.	
		2406		19-00141-00-RS			С	оок	29		14
							CON	TRACT	NO.	61F	93
STA.	TO STA.	FED.	ROAD	DIST.	NO. '	I ILLINOIS	FED.	AID PRC	JECT		

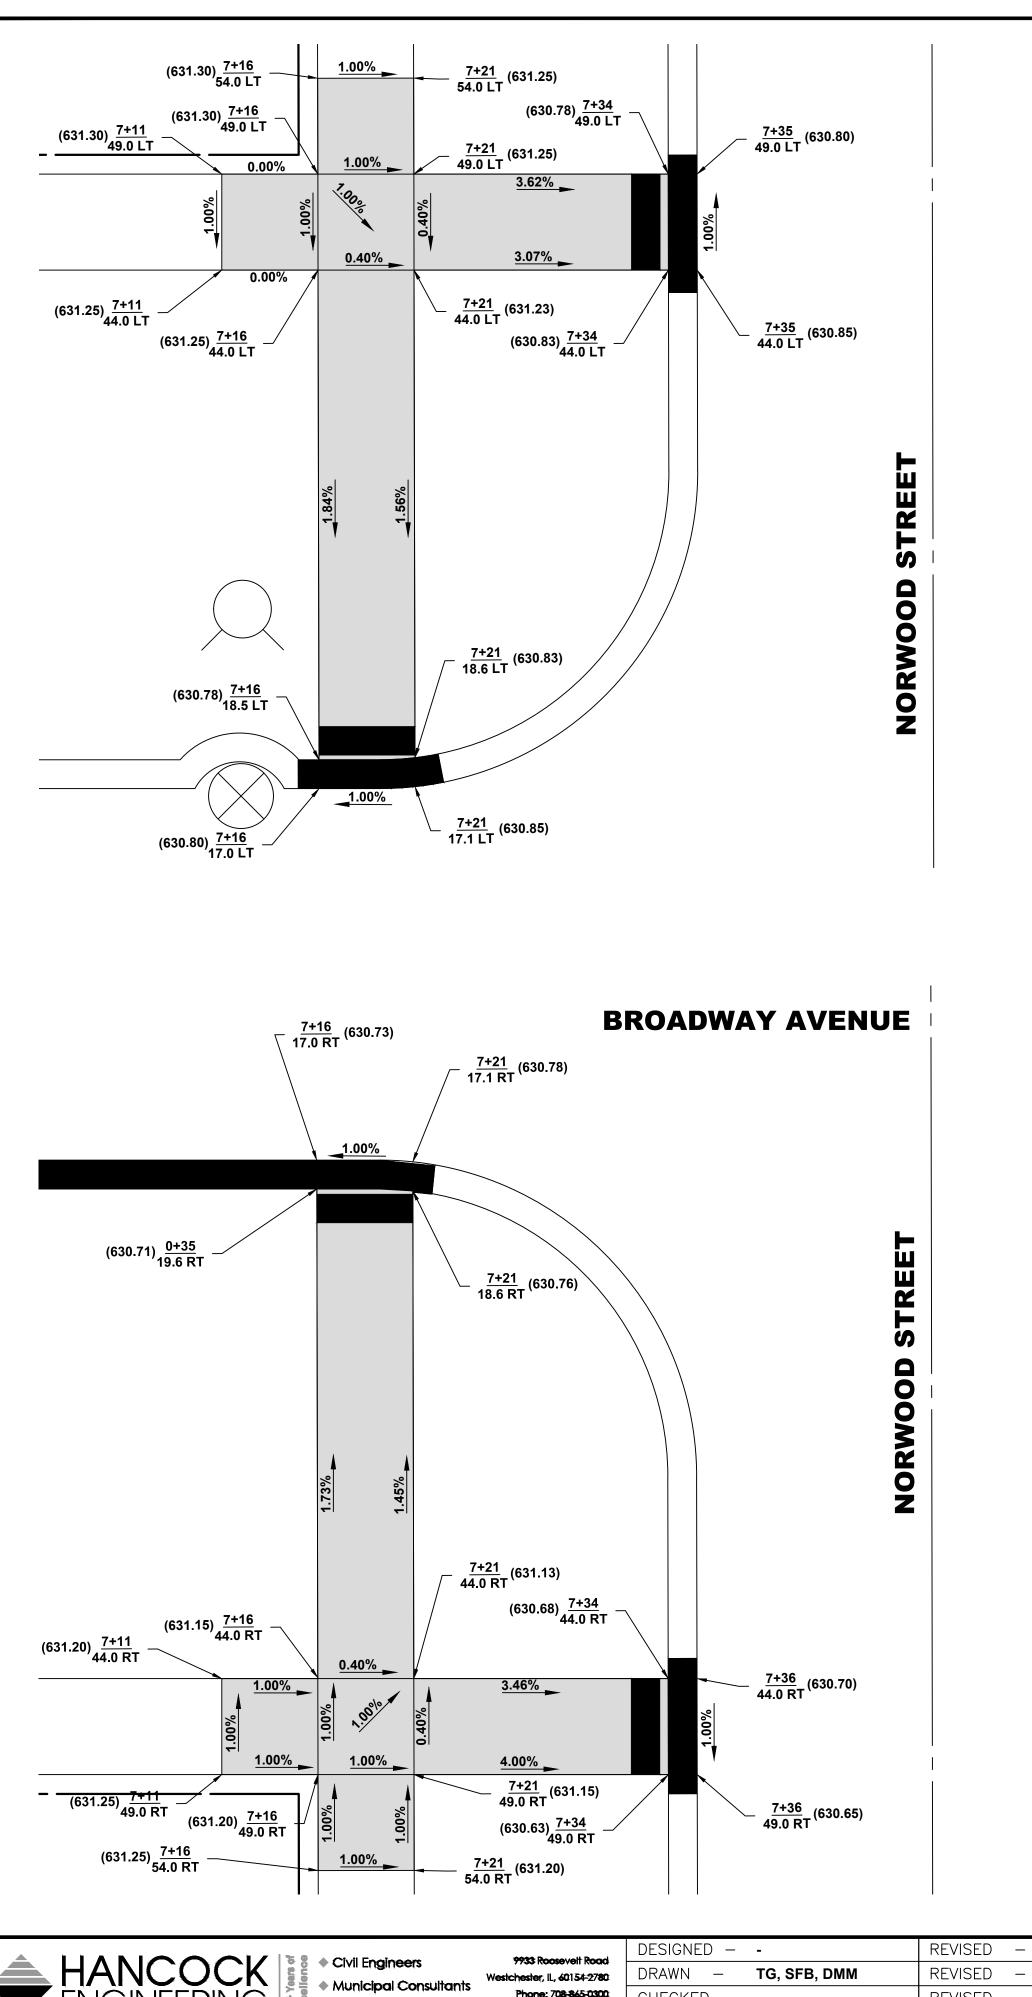

 HANCOCK

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 • REVISED

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 • Established

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 • DRAWN

 • TG, SFB, DMM

 REVISED

 • DESIGNED

 • Established


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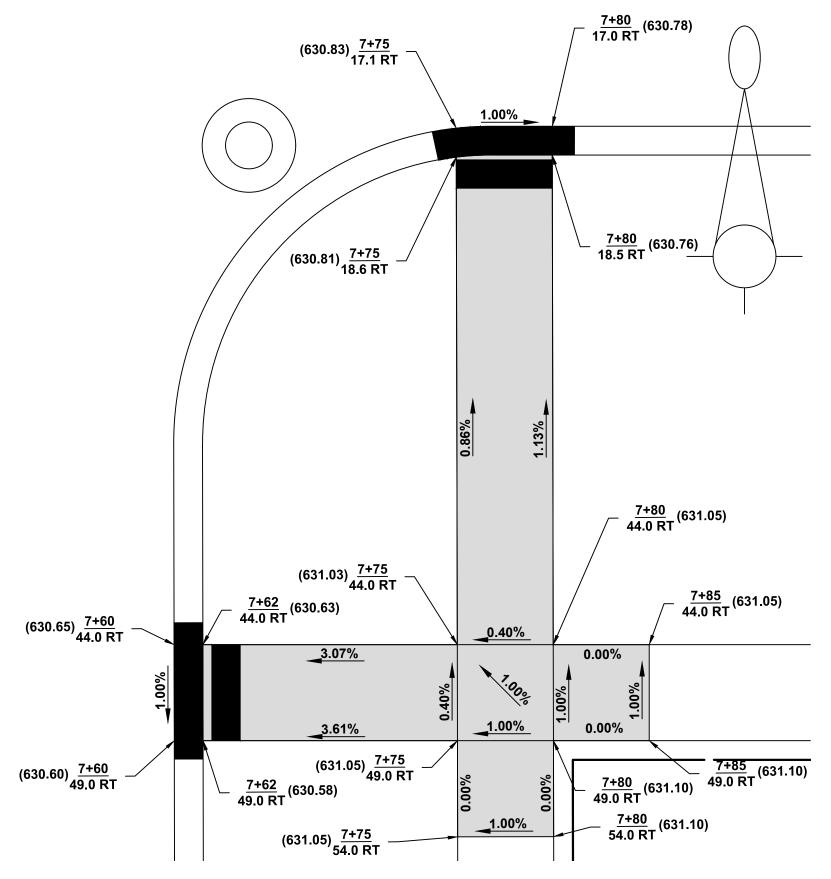
 • DATE

 • TG, SFB, DMM

 REVISED



### **BROADWAY AVENUE**

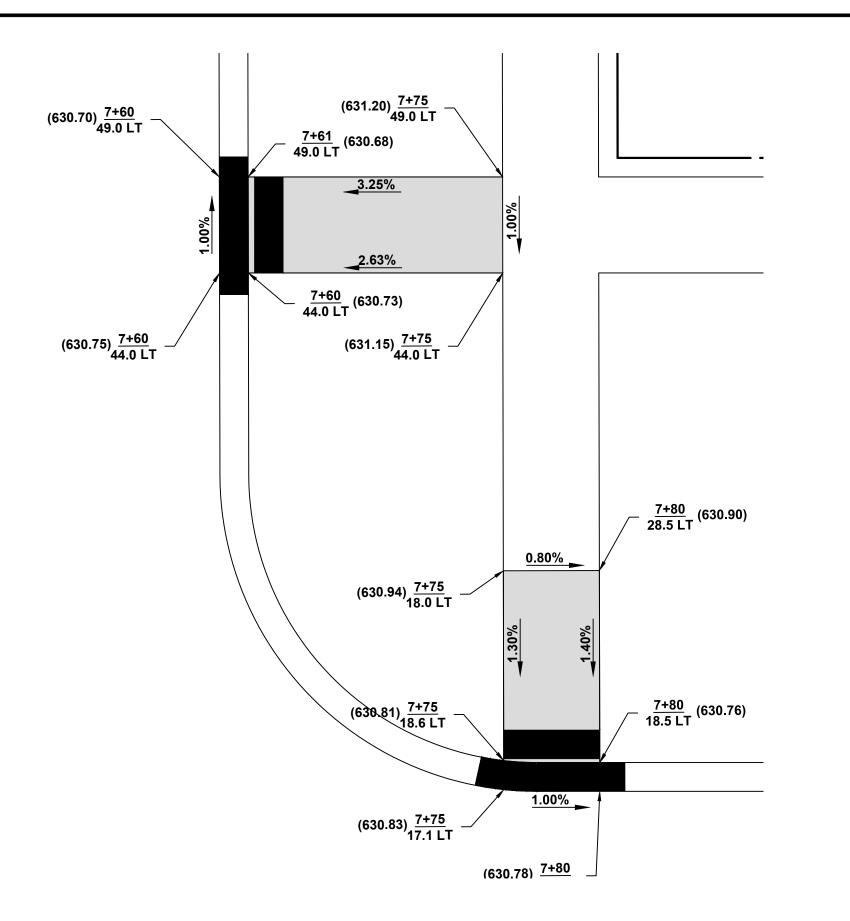

### STATE OF ILLINOIS DEPARTMENT OF TRANSPORTATION


## SIDEWALK ADA RAM

SCALE: 1" = 5' SHEET NO. 2 OF 7 SHEETS

#### LEGEND OF SYMBOLS

	CTION WITH I.D.O.T. STANDARD 000001-07)						
<u>SYMBOL</u>	DESCRIPTION						
A	EXISTING HOT-MIX ASPHALT AREA						
С	EXISTING CONCRETE AREA						
G	EXISTING GRASS AREA						
+ + + +	PROPOSED HOT-MIX ASPHALT BUTT JOINT						
	REMOVE AND REINSTALL BRICK PAVER						
	PROPOSED CONCRETE AREA, 5" SIDEWALK, 7" DRIVEWAY						
	PROPOSED HOT-MIX ASPHALT RESURFACING AREA						
Α	STRUCTURE TO BE ADJUSTED						
A*	STRUCTURE TO BE ADJUSTED (SPECIAL)						
AH	HANDHOLE TO BE ADJUSTED						
1C	NEW FRAME AND LID, TYPE 1, CLOSED LID						
1P	NEW FRAME AND LID, TYPE 1, OPEN LID						
1B	NEW FRAME AND LID, TYPE 1, WATERTIGHT BOLT DOWN LID						
RC	STRUCTURE TO BE RECONSTRUCTED						
X	EXISTING FIRE HYDRANT						
$\otimes$	EXISTING WATER VALVE BOX						
	EXISTING WATER MAIN VALVE VAULT						
	EXISTING STORM SEWER INLET						
$\bigcirc$	EXISTING STORM SEWER CATCH BASIN						
$\bullet$	PROPOSED STORM SEWER CATCH BASIN						
$\bigcirc$	EXISTING SEWER MANHOLE						
-\$>>>	EXISTING STREET LIGHT POLE						
Ø	EXISTING POWER POLE						
	EXISTING HANDHOLE						
	EXISTING CURB AND GUTTER						
	PROPOSED CONCRETE CURB, TYPE B						
	PROPOSED COMBINATION CONCRETE CURB AND GUTTER REMOVAL AND REPLACEMENT						
>	EXISTING STORM SEWER						
)>	EXISTING COMBINED SEWER						
+W+	EXISTING WATER MAIN						

	F.A.U. RTE.	SECTION	COUNTY	TOTAL SHEETS	SHEET NO.
MP DETAILS	2406	19-00141-00-RS	соок	29	15
			CONTRACT	NO. 61F	93
STA. TO STA.	FED. R	ROAD DIST. NO. 1 ILLINOIS	FED. AID PRO	JECT	

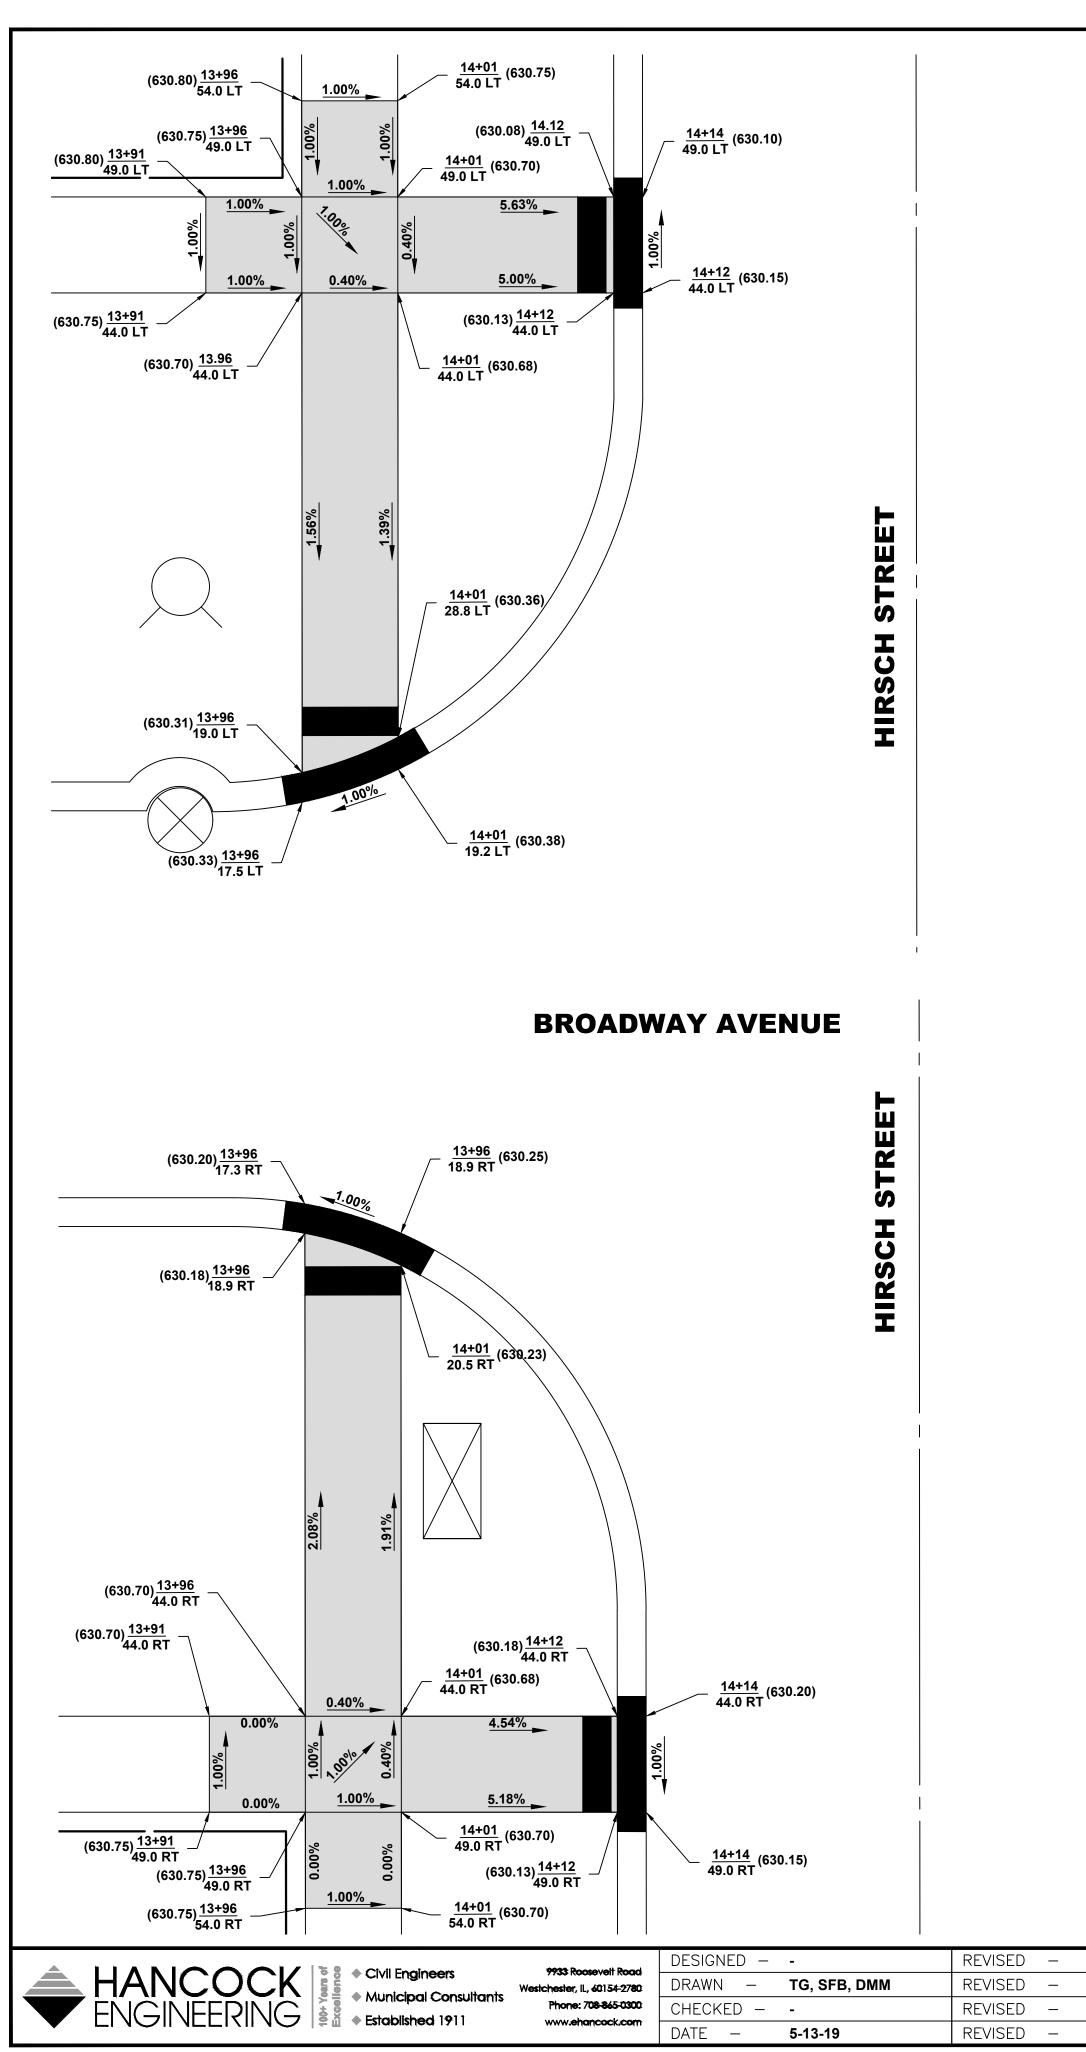


#### STATE OF ILLINOIS DEPARTMENT OF TRANSPORTATION


## SIDEWALK ADA RAN

SCALE: 1" = 5'

SHEET NO. 3 OF 7 SHEETS

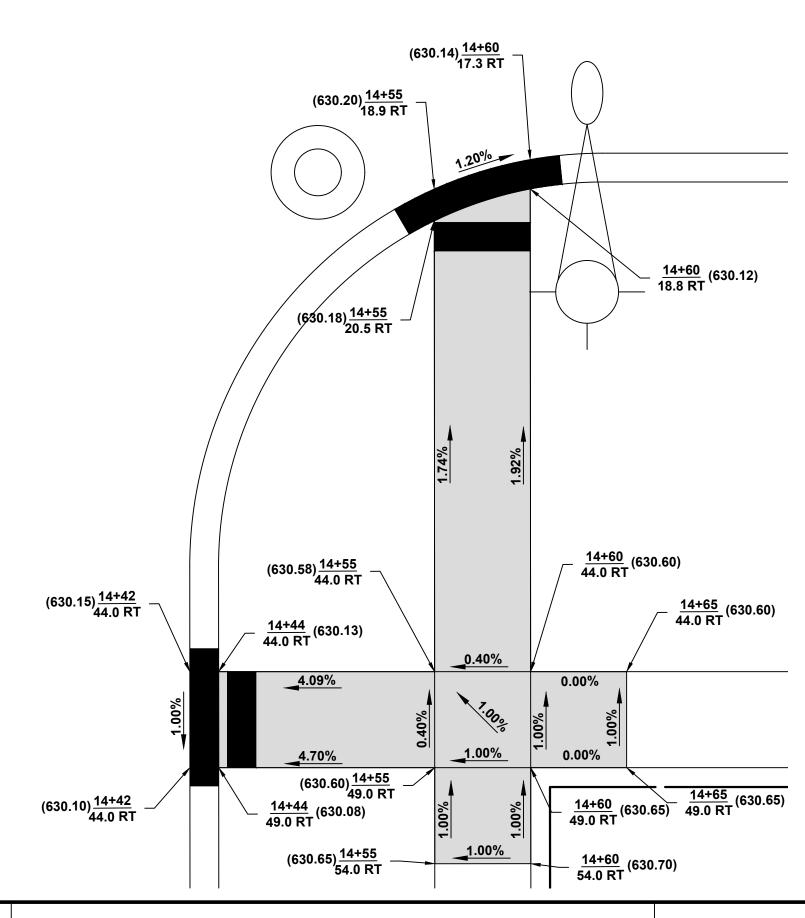


### **BROADWAY AVENUE**

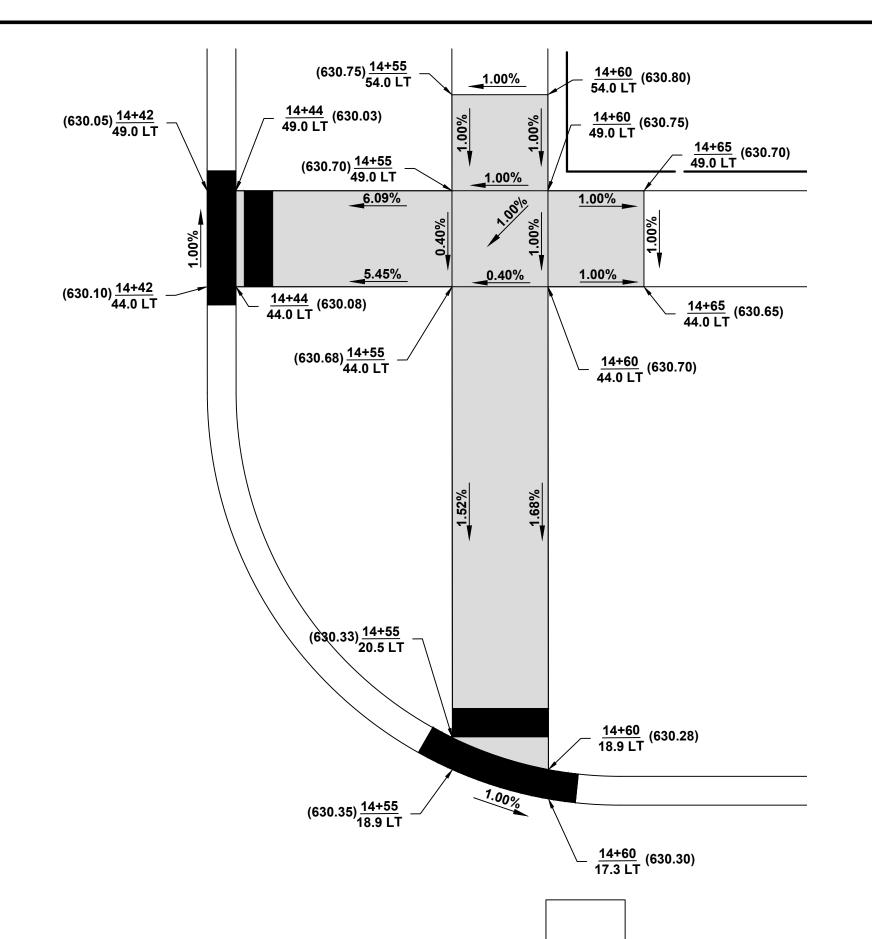



LOLN	
(TO BE USED IN CONJUN	CTION WITH I.D.O.T. STANDARD 000001-07)
<u>SYMBOL</u>	DESCRIPTION
A	EXISTING HOT-MIX ASPHALT AREA
С	EXISTING CONCRETE AREA
G	EXISTING GRASS AREA
+ + + + + +	PROPOSED HOT-MIX ASPHALT BUTT JOINT
	REMOVE AND REINSTALL BRICK PAVER
	PROPOSED CONCRETE AREA, 5" SIDEWALK, 7" DRIVEWAY
	PROPOSED HOT-MIX ASPHALT RESURFACING AREA
А	STRUCTURE TO BE ADJUSTED
A*	STRUCTURE TO BE ADJUSTED (SPECIAL)
AH	HANDHOLE TO BE ADJUSTED
1C	NEW FRAME AND LID, TYPE 1, CLOSED LID
1P	NEW FRAME AND LID, TYPE 1, OPEN LID
1B	NEW FRAME AND LID, TYPE 1, WATERTIGHT BOLT DOWN LID
RC	STRUCTURE TO BE RECONSTRUCTED
Y	EXISTING FIRE HYDRANT
$\otimes$	EXISTING WATER VALVE BOX
	EXISTING WATER MAIN VALVE VAULT
	EXISTING STORM SEWER INLET
$\bigcirc$	EXISTING STORM SEWER CATCH BASIN
$\bullet$	PROPOSED STORM SEWER CATCH BASIN
$\bigcirc$	EXISTING SEWER MANHOLE
-\$>>0	EXISTING STREET LIGHT POLE
Ø	EXISTING POWER POLE
	EXISTING HANDHOLE
	EXISTING CURB AND GUTTER
	PROPOSED CONCRETE CURB, TYPE B
	PROPOSED COMBINATION CONCRETE CURB AND GUTTER REMOVAL AND REPLACEMENT
>	EXISTING STORM SEWER
)>	EXISTING COMBINED SEWER
+W+	EXISTING WATER MAIN

MP DETAILS		F.A.U. RTE.	SECTION			COUNT	Υ <sub>s</sub>	TOTAL SHEETS	SHEET NO.
		2406	19-00141-00-RS			COOK	۲.	29	16
						CONTRA	ACT N	10. <b>6</b>	1F93
STA.	TO STA.	FED. F	ROAD DIST.	NO. 1	ILLINOIS	FED. AID	PROJE	ECT	

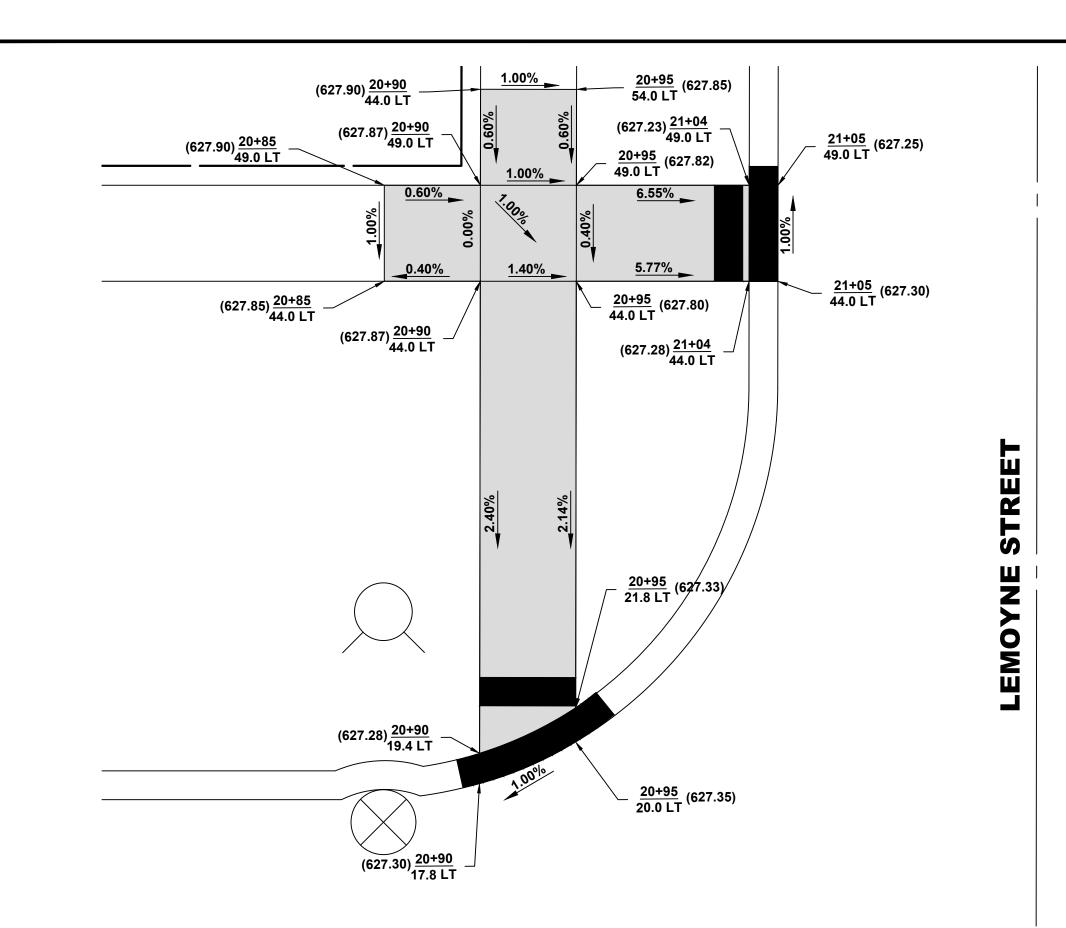


### **BROADWAY AVENUE**

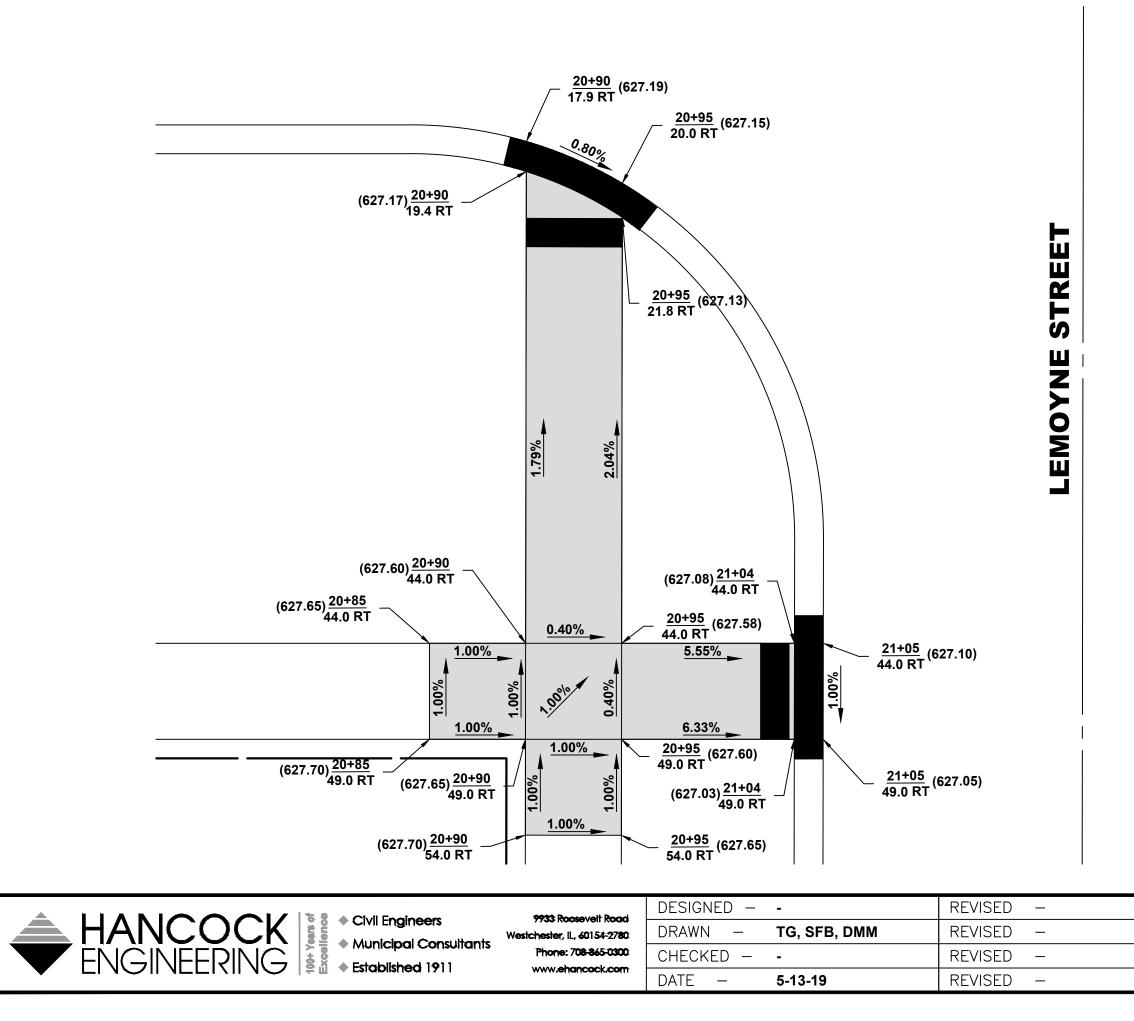

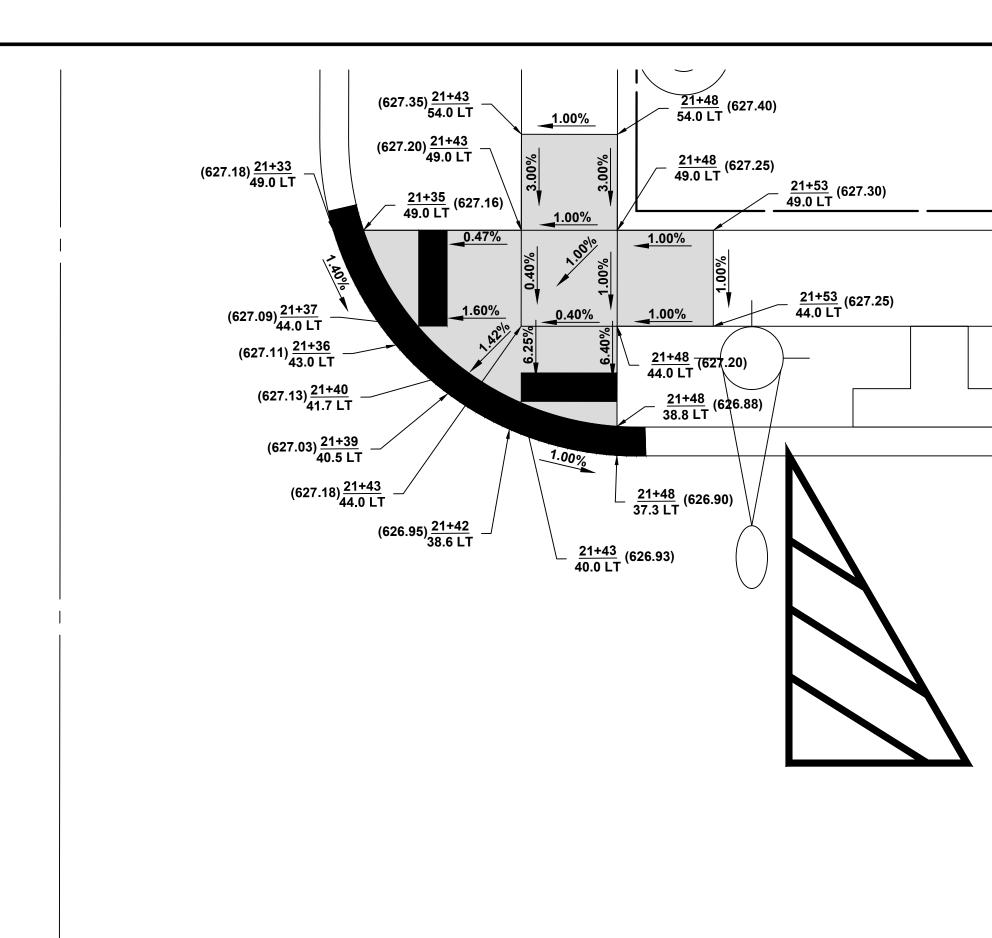

### **BROADWAY AVENUE**

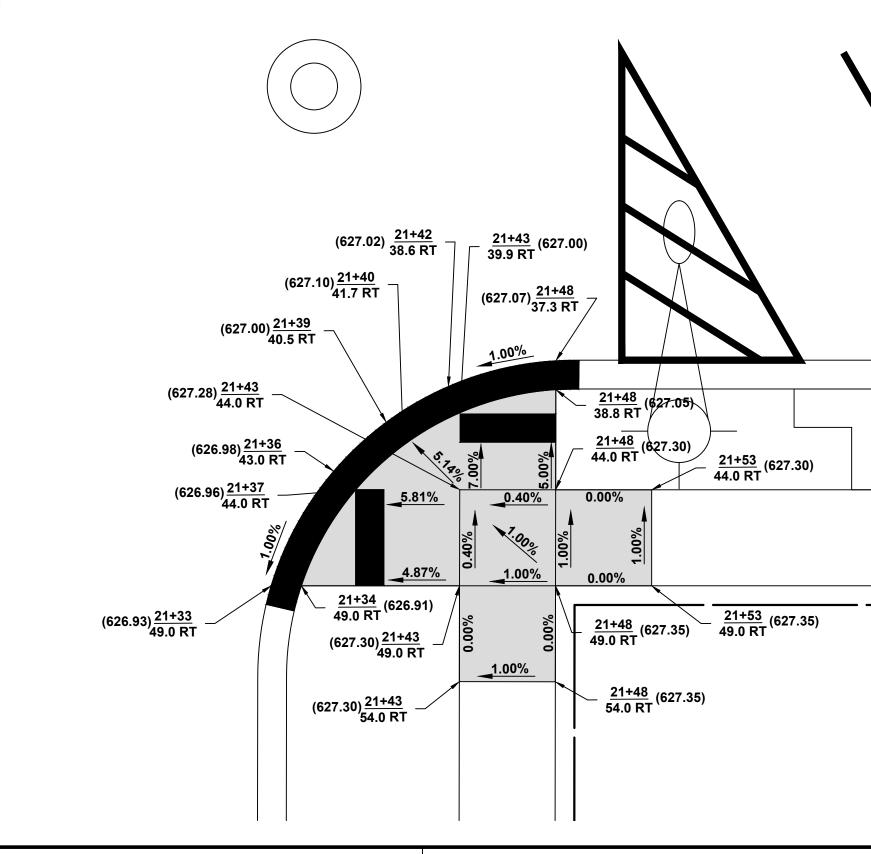

#### STATE OF ILLINOIS DEPARTMENT OF TRANSPORTATION

### SIDEWALK ADA RAM


SCALE: 1" = 5' SHEET NO. 4 OF 7 SHEETS

#### LEGEND OF SYMBOLS

LEGEND OF STMBOLS							
(TO BE USED IN CONJUN	CTION WITH I.D.O.T. STANDARD 000001-07)						
SYMBOL	DESCRIPTION						
A	EXISTING HOT-MIX ASPHALT AREA						
С	EXISTING CONCRETE AREA						
G	EXISTING GRASS AREA						
+ + + + + +	PROPOSED HOT-MIX ASPHALT BUTT JOINT						
	REMOVE AND REINSTALL BRICK PAVER						
	PROPOSED CONCRETE AREA, 5" SIDEWALK, 7" DRIVEWAY						
	PROPOSED HOT-MIX ASPHALT RESURFACING AREA						
А	STRUCTURE TO BE ADJUSTED						
A*	STRUCTURE TO BE ADJUSTED (SPECIAL)						
AH	HANDHOLE TO BE ADJUSTED						
1C	NEW FRAME AND LID, TYPE 1, CLOSED LID						
1P	NEW FRAME AND LID, TYPE 1, OPEN LID						
1B	NEW FRAME AND LID, TYPE 1, WATERTIGHT BOLT DOWN LID						
RC	STRUCTURE TO BE RECONSTRUCTED						
Y	EXISTING FIRE HYDRANT						
$\otimes$	EXISTING WATER VALVE BOX						
	EXISTING WATER MAIN VALVE VAULT						
	EXISTING STORM SEWER INLET						
$\bigcirc$	EXISTING STORM SEWER CATCH BASIN						
$\bullet$	PROPOSED STORM SEWER CATCH BASIN						
$\bigcirc$	EXISTING SEWER MANHOLE						
-\$>>>	EXISTING STREET LIGHT POLE						
Ø	EXISTING POWER POLE						
	EXISTING HANDHOLE						
	EXISTING CURB AND GUTTER						
	PROPOSED CONCRETE CURB, TYPE B						
	PROPOSED COMBINATION CONCRETE CURB AND GUTTER REMOVAL AND REPLACEMENT						
$\longrightarrow$	EXISTING STORM SEWER						
)>	EXISTING COMBINED SEWER						
W	EXISTING WATER MAIN						

MP DETAILS		F.A.U. RTE.	SECTION	COUNTY	TOTAL SHEETS	SHEET NO.
		2406	19-00141-00-RS	СООК	29	17
				CONTRACT	NO. 61	F93
STA.	TO STA.	FED. F	ROAD DIST. NO. 1 ILLINOIS	FED. AID PRO	JECT	



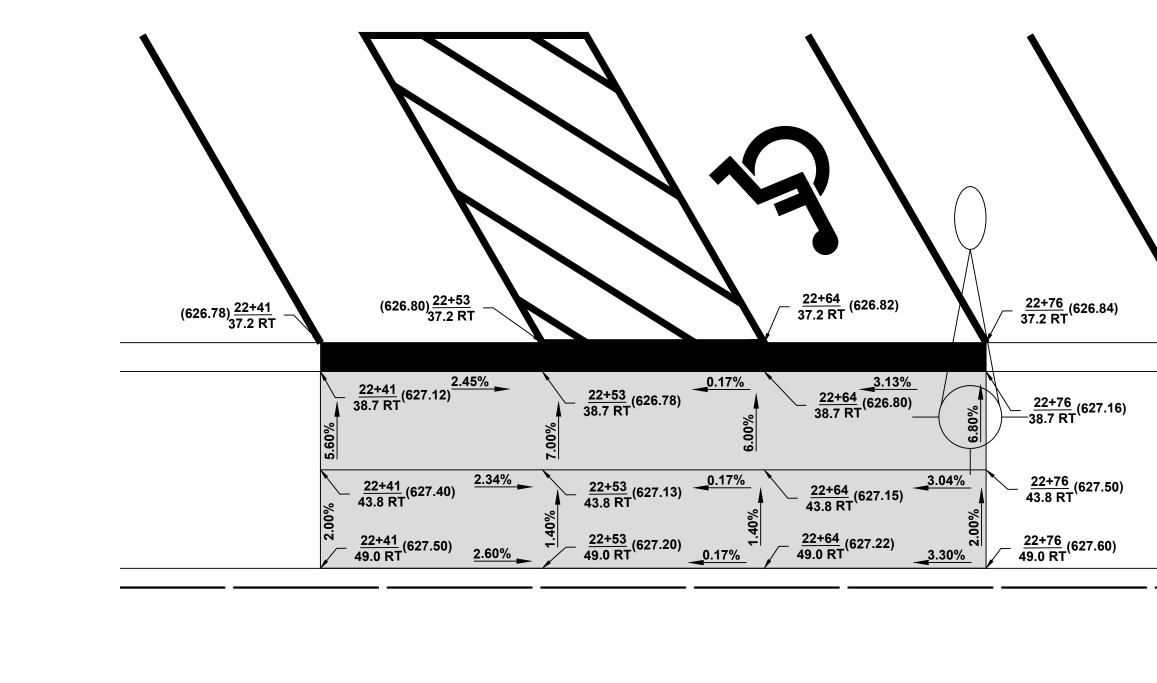


	9933 Roosevelt Road	DESIGNED – -	REVISED –
	Westchester, IL, 60154-2780	DRAWN – <b>TG, SFB, DMM</b>	REVISED –
ENGINEERING Stablished 1911		CHECKED – -	REVISED –
		DATE – <b>5-13-19</b>	REVISED –

(627.60) <u>23+04</u> 49.0 LT	(627.35) <u>23+16</u> 49.0 LT	(627.37) <u>23+27</u> 49.0 LT	(627.74) <u>23+39</u> 49.0 LT	
(627.50) <u>23+04</u> 43.8 LT	<u>2.17%</u> (627.29) <u>23+16</u> <u>43.8 LT</u>	0.16% (627.32) <u>23+27</u> 0.25%	<u>3.21%</u> (627.65) <u>23+39</u> <u>2.86%</u>	
<b>66.80%</b>	$(626.94)\frac{23+16}{38.7 \text{ LT}}$	(626.97) <u>23+27</u> 38.7 LT	(627.27) <u>23+39</u> 38.7 LT <u>2.60%</u>	
	$\frac{22+41}{37.2 \text{ RT}} (626.90) \\ (626.96) \frac{22+41}{37.2 \text{ RT}} $		$\frac{\frac{22+41}{37.2 \text{ RT}}}{(627.02)\frac{22+41}{37.2 \text{ RT}}}$	


### **BROADWAY AVENUE**

### STATE OF ILLINOIS DEPARTMENT OF TRANSPORTATION

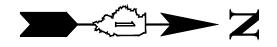

	CTION WITH I.D.O.T. STANDARD 000001-07)					
SYMBOL	DESCRIPTION					
A	EXISTING HOT-MIX ASPHALT AREA					
С	EXISTING CONCRETE AREA					
G	EXISTING GRASS AREA					
+ + +	PROPOSED HOT-MIX ASPHALT BUTT JOINT					
	REMOVE AND REINSTALL BRICK PAVER					
	PROPOSED CONCRETE AREA, 5" SIDEWALK, 7" DRIVEWAY					
	PROPOSED HOT-MIX ASPHALT RESURFACING AREA					
А	STRUCTURE TO BE ADJUSTED					
A*	STRUCTURE TO BE ADJUSTED (SPECIAL)					
AH	HANDHOLE TO BE ADJUSTED					
1C	NEW FRAME AND LID, TYPE 1, CLOSED LID					
1P	NEW FRAME AND LID, TYPE 1, OPEN LID					
1B	NEW FRAME AND LID, TYPE 1, WATERTIGHT BOLT DOWN LID					
RC	STRUCTURE TO BE RECONSTRUCTED					
Ø	EXISTING FIRE HYDRANT					
$\otimes$	EXISTING WATER VALVE BOX					
	EXISTING WATER MAIN VALVE VAULT					
	EXISTING STORM SEWER INLET					
$\bigcirc$	EXISTING STORM SEWER CATCH BASIN					
$\bullet$	PROPOSED STORM SEWER CATCH BASIN					
$\bigcirc$	EXISTING SEWER MANHOLE					
-\$	EXISTING STREET LIGHT POLE					
Ø	EXISTING POWER POLE					
	EXISTING HANDHOLE					
	EXISTING CURB AND GUTTER					
	PROPOSED CONCRETE CURB, TYPE B					
	PROPOSED COMBINATION CONCRETE CURB AND GUTTER REMOVAL AND REPLACEMENT					
	EXISTING STORM SEWER					
)>	EXISTING COMBINED SEWER					
WI	EXISTING WATER MAIN					

		F.A.U. RTE.	· SECTION			COU	NTY	TOTAI SHEET		
MP DET	AILS	2406	19-00141-00-RS		CO	ок	29	18		
							CONT	RACT	NO.	61F93
STA.	TO STA.	FED. F	ROAD	DIST.	NO. 1	ILLINOIS	FED. AI	D PRC	JECT	

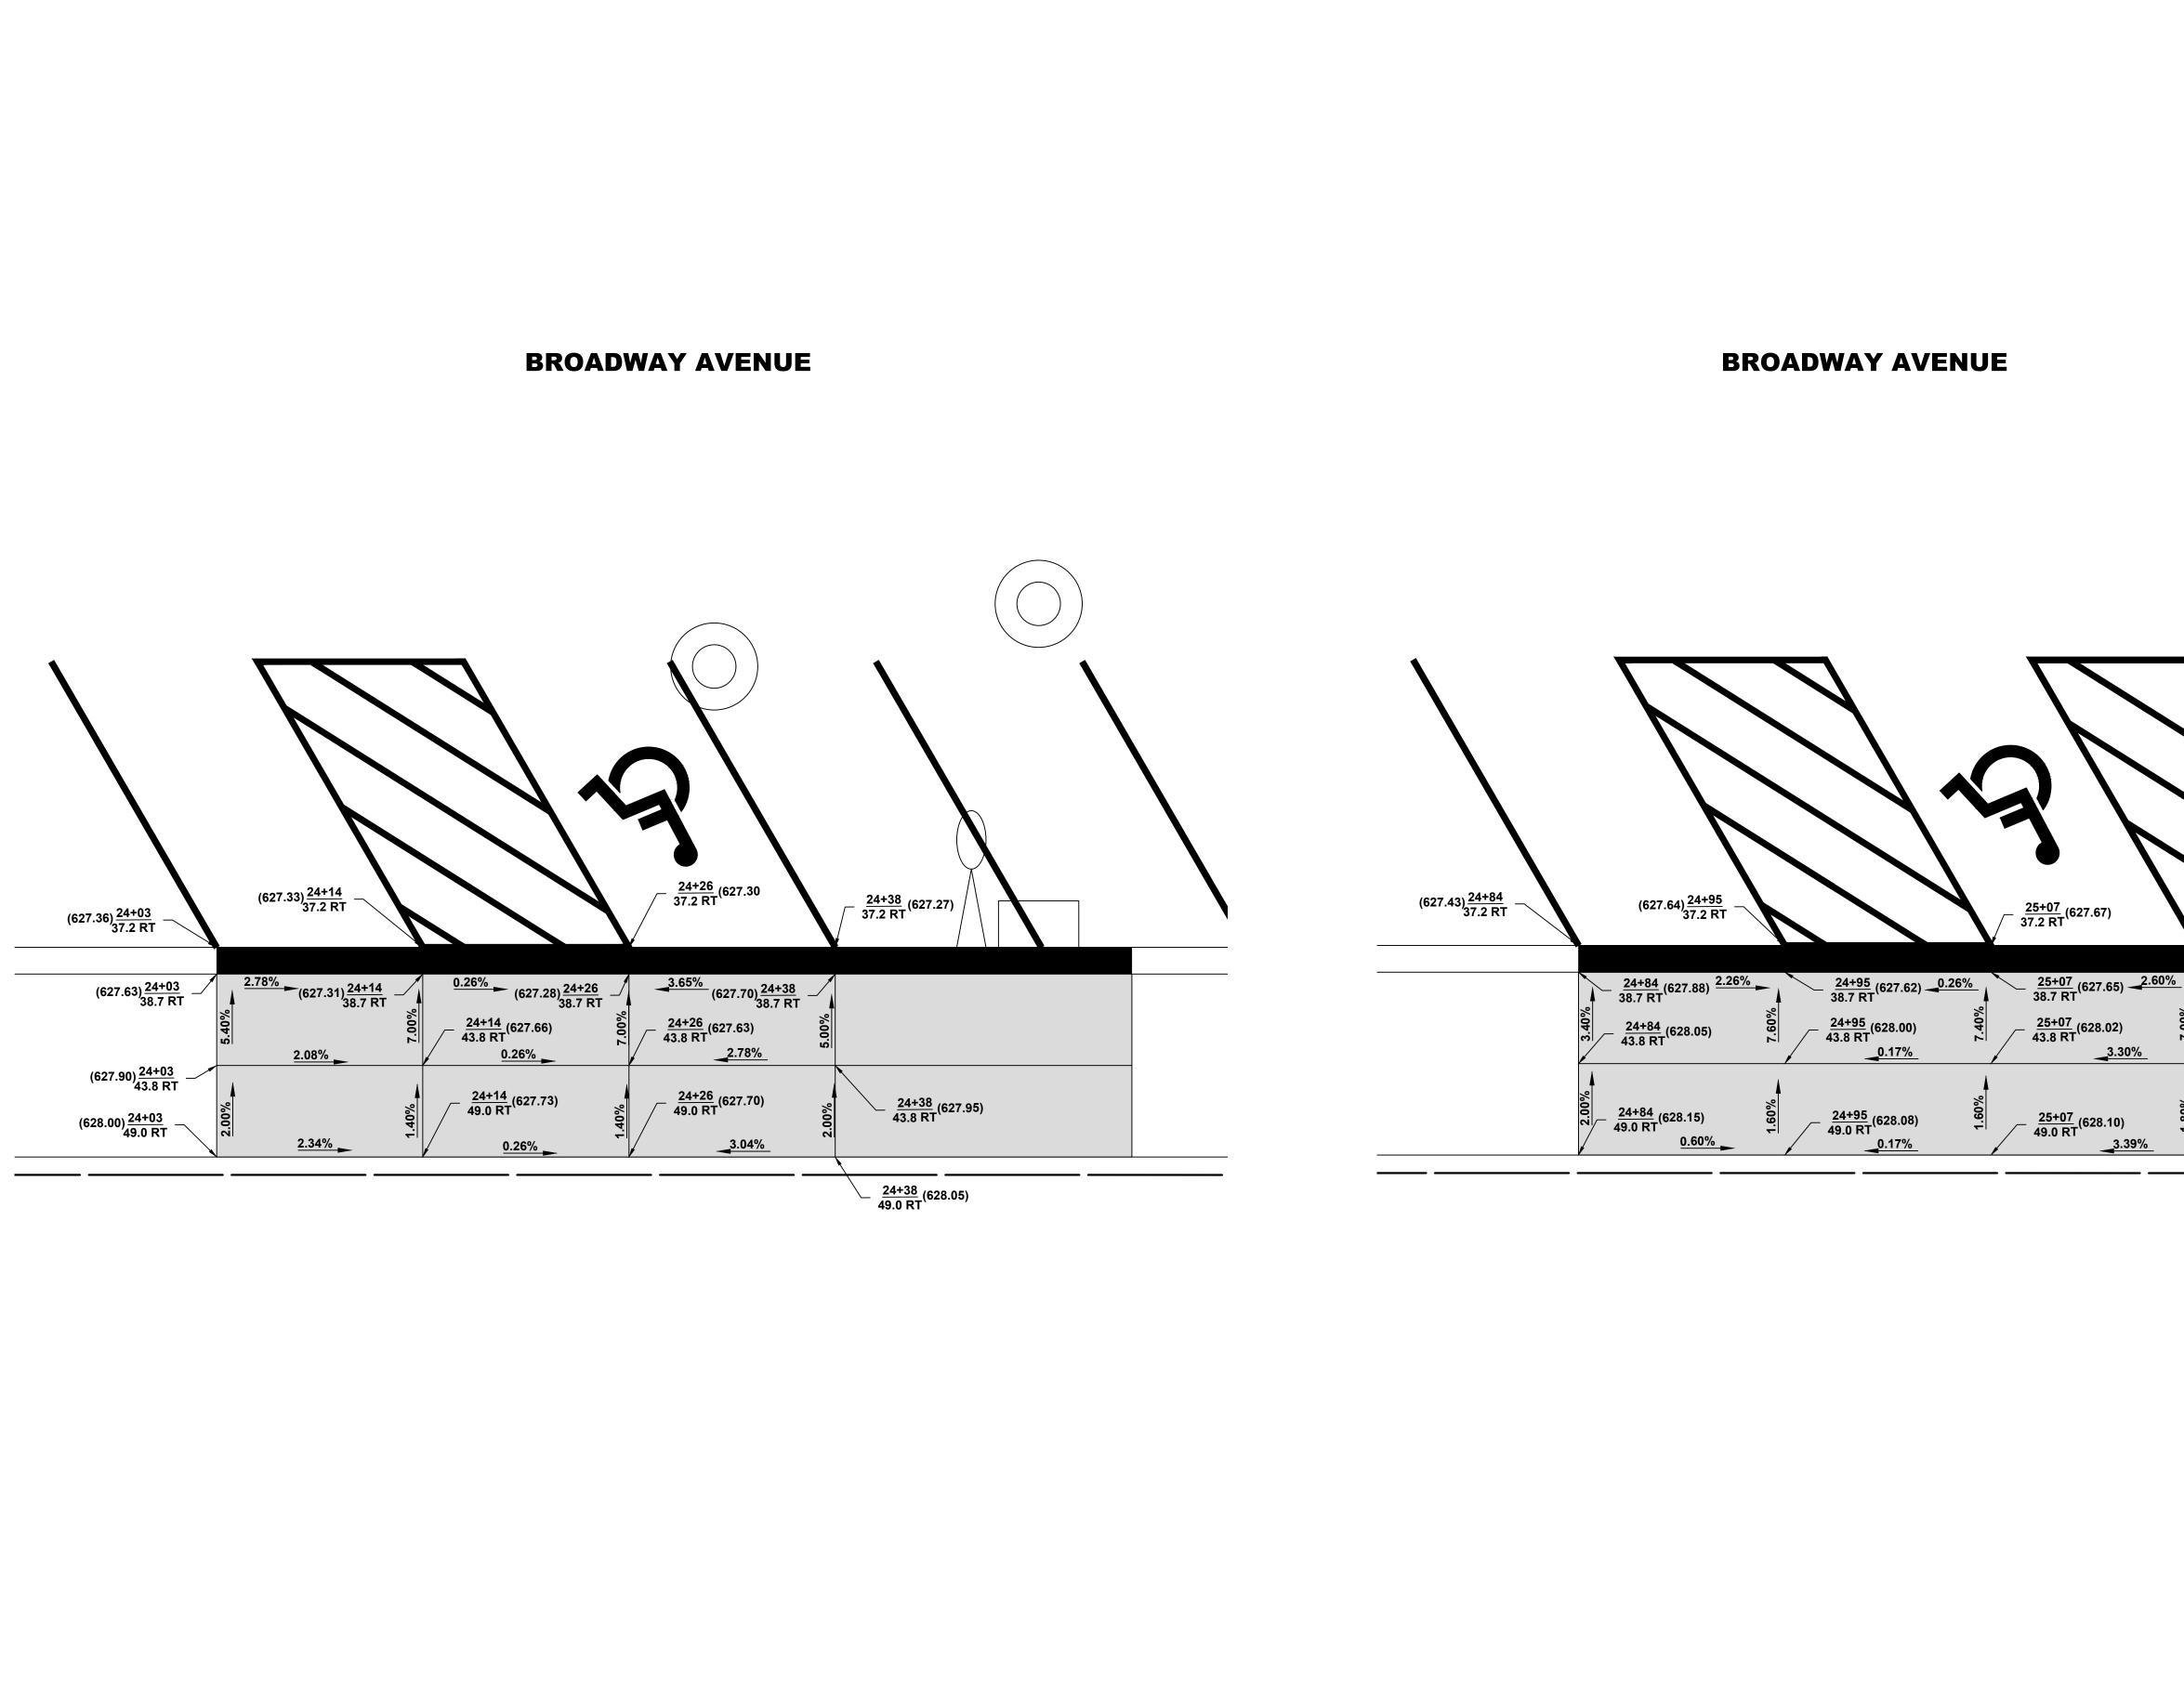


		9933 Roosevelt Road	DESIGNED -	-	REVISED –
	Municipal Consultants	Westchester, IL, 60154-2780 Phone: 708-865-0300	DRAWN -	TG, SFB, DMM	REVISED –
			CHECKED -	-	REVISED –
		www.ehancock.com	DATE –	5-13-19	REVISED –

STATE OF ILLINOIS
DEPARTMENT OF TRANSPORTATION


SIDEWALK ADA RAN

SHEET NO. 6 OF 7 SHEETS SCALE: 1" = 5'

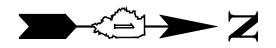

(TO BE USED IN CONJUNCTION WITH I.D.O.T. STANDARD 000001-07)				
	SYMBOL	DESCRIPTION		
	A	EXISTING HOT-MIX ASPHALT AREA		
	С	EXISTING CONCRETE AREA		
	G	EXISTING GRASS AREA		
	+ + +	PROPOSED HOT-MIX ASPHALT BUTT JOINT		
		REMOVE AND REINSTALL BRICK PAVER		
		PROPOSED CONCRETE AREA, 5" SIDEWALK, 7" DRIVEWAY		
		PROPOSED HOT-MIX ASPHALT RESURFACING AREA		
-	А	STRUCTURE TO BE ADJUSTED		
	A*	STRUCTURE TO BE ADJUSTED (SPECIAL)		
	AH	HANDHOLE TO BE ADJUSTED		
	1C	NEW FRAME AND LID, TYPE 1, CLOSED LID		
	1P	NEW FRAME AND LID, TYPE 1, OPEN LID		
	1B	NEW FRAME AND LID, TYPE 1, WATERTIGHT BOLT DOWN LID		
	RC	STRUCTURE TO BE RECONSTRUCTED		
	Q	EXISTING FIRE HYDRANT		
25+18	$\otimes$	EXISTING WATER VALVE BOX		
$-\frac{25+18}{37.2 \text{ RT}}(627.73)$		EXISTING WATER MAIN VALVE VAULT		
		EXISTING STORM SEWER INLET		
$\frac{25+18}{38.7 \text{ RT}}$ (628.05)	$\circ$	EXISTING STORM SEWER CATCH BASIN		
%0		PROPOSED STORM SEWER CATCH BASIN		
$\frac{25+18}{43.8}$ (628.40)	$\bigcirc$	EXISTING SEWER MANHOLE		
	-\$	EXISTING STREET LIGHT POLE		
%	Ø	EXISTING POWER POLE		
$\begin{array}{c c} & & \\ & &$		EXISTING HANDHOLE		
		EXISTING CURB AND GUTTER		
		PROPOSED CONCRETE CURB, TYPE B		
		PROPOSED COMBINATION CONCRETE CURB AND GUTTER REMOVAL AND REPLACEMENT		
		EXISTING STORM SEWER		
	)>	EXISTING COMBINED SEWER		
	WI	EXISTING WATER MAIN		

		F.A.U. RTE.	SECTION			COU	NTY	TOTAL	SHEET NO.	
MP DE	<b>FAILS</b>	2406	06 19-00141-00-RS		CO	ок	29	19		
							CONT	RACT	NO. 6	1F93
STA.	TO STA.	FED.	ROAD	DIST. NO.	1	ILLINOIS	FED. AI	D PRO	JECT	

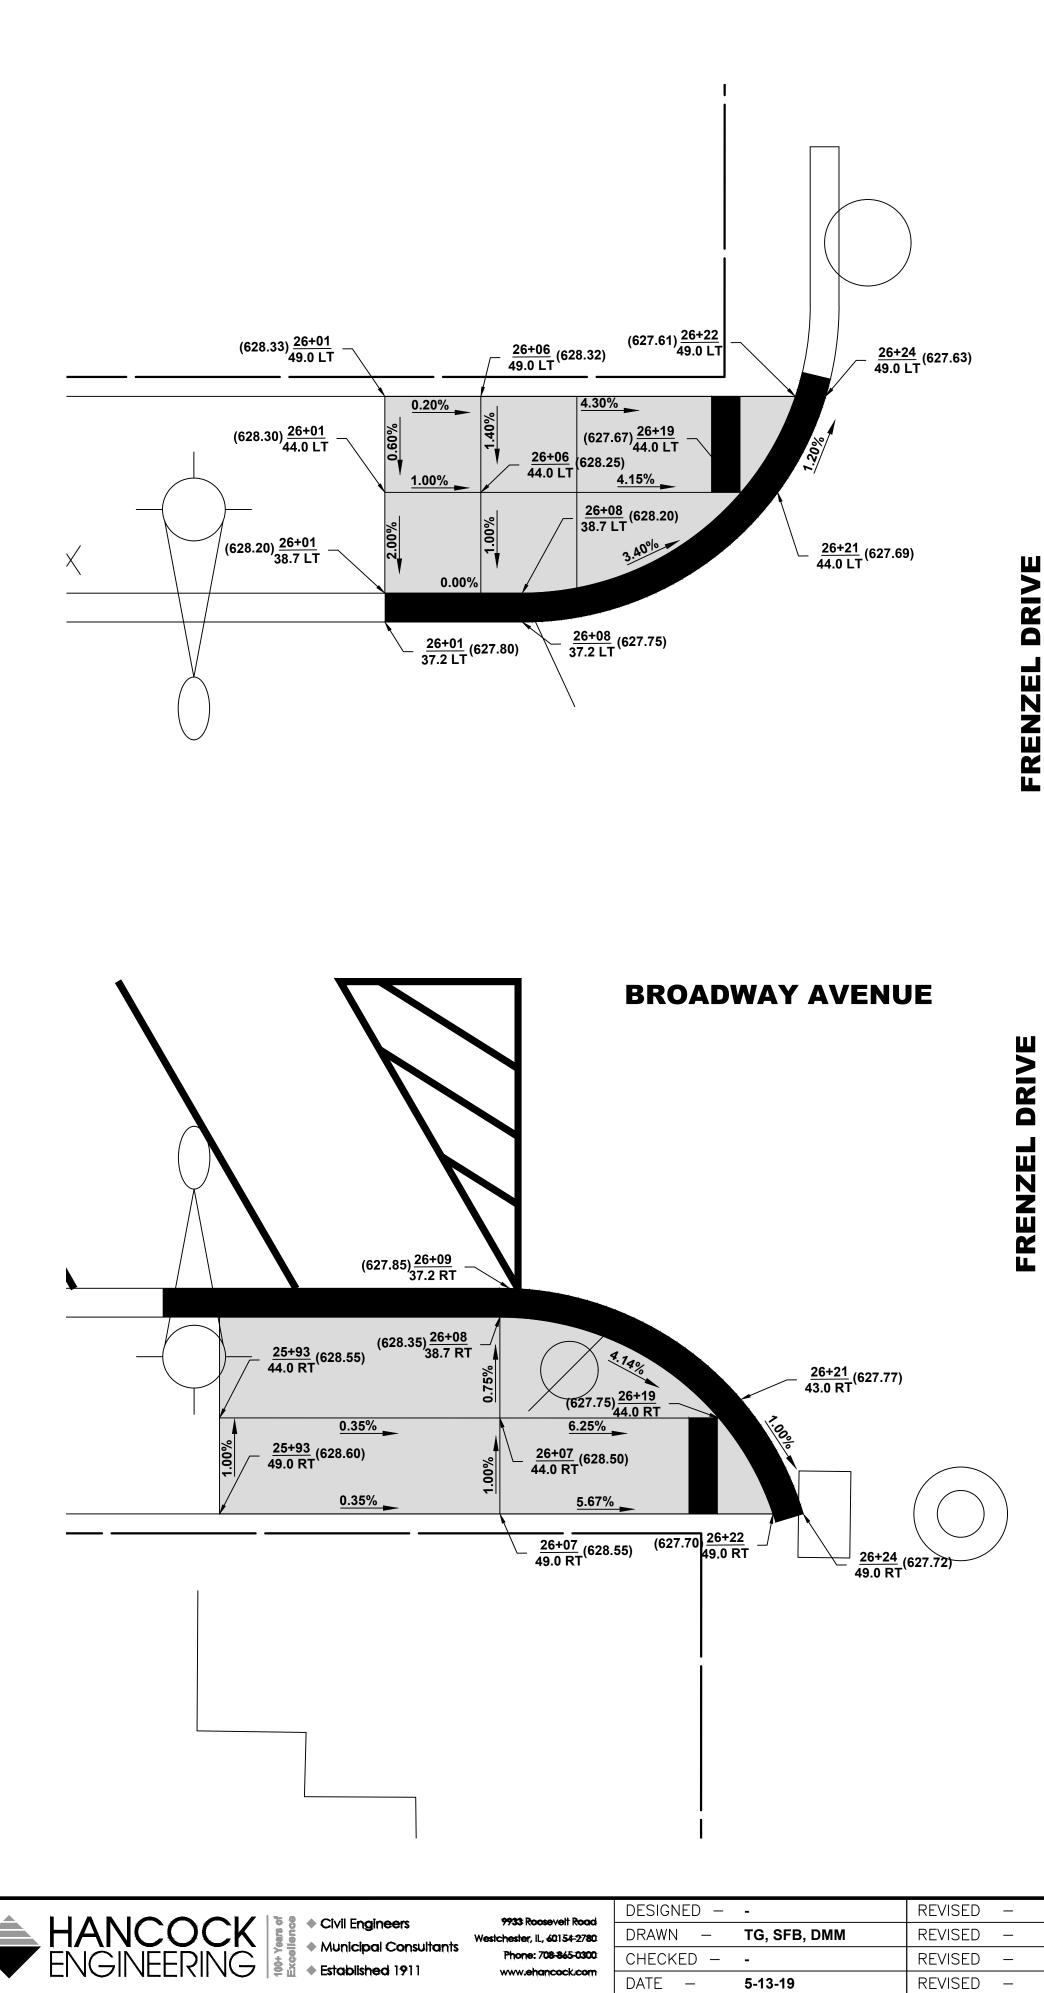


ENZ FR


DRIVI FRENZ


SHEET NO. 7 OF 7 SHEETS

SCALE: 1" = 5'

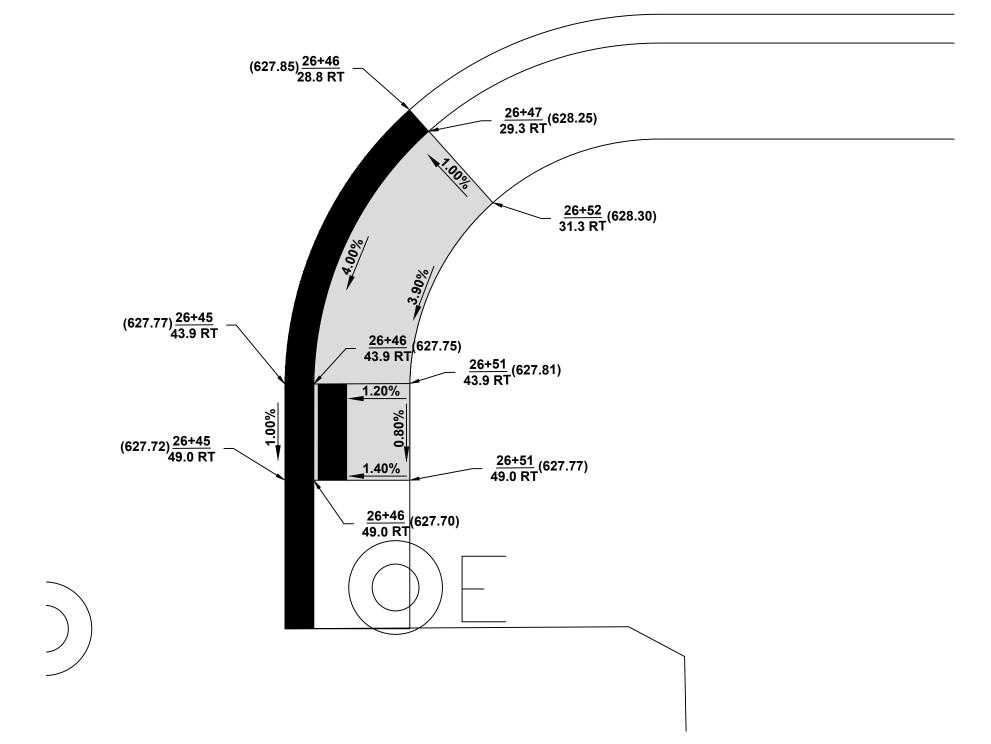


### **BROADWAY AVENUE**

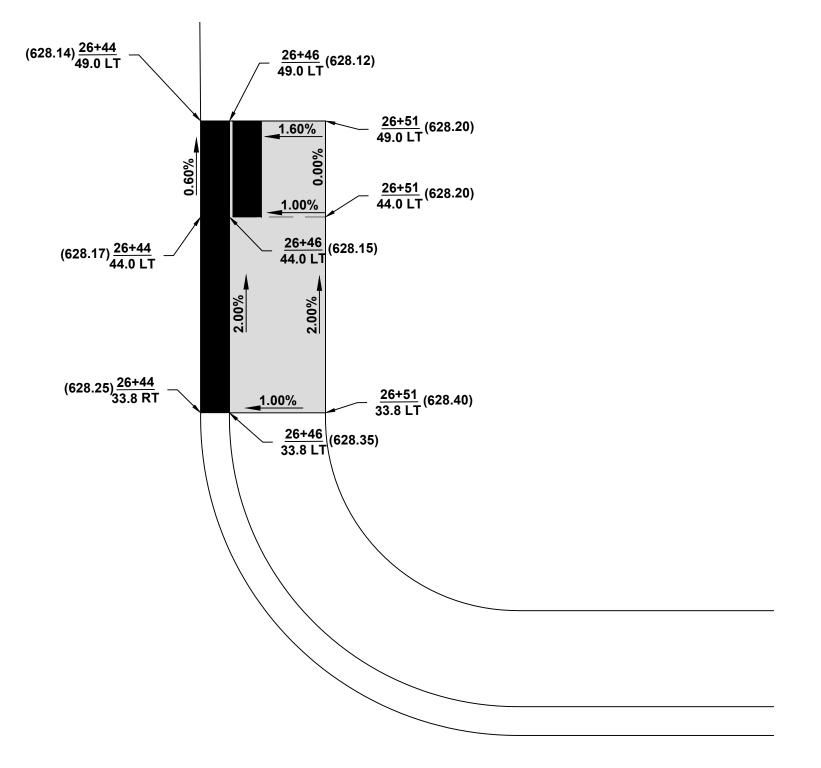

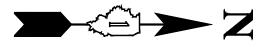

-	CTION WITH I.D.O.T. STANDARD 000001-07)
SYMBOL	DESCRIPTION
A	EXISTING HOT-MIX ASPHALT AREA
С	EXISTING CONCRETE AREA
G	EXISTING GRASS AREA
+ + + +	PROPOSED HOT-MIX ASPHALT BUTT JOINT
	REMOVE AND REINSTALL BRICK PAVER
	PROPOSED CONCRETE AREA, 5" SIDEWALK, 7" DRIVEWAY
	PROPOSED HOT-MIX ASPHALT RESURFACING AREA
А	STRUCTURE TO BE ADJUSTED
A*	STRUCTURE TO BE ADJUSTED (SPECIAL)
AH	HANDHOLE TO BE ADJUSTED
1C	NEW FRAME AND LID, TYPE 1, CLOSED LID
1P	NEW FRAME AND LID, TYPE 1, OPEN LID
1B	NEW FRAME AND LID, TYPE 1, WATERTIGHT BOLT DOWN LID
RC	STRUCTURE TO BE RECONSTRUCTED
Q	EXISTING FIRE HYDRANT
$\otimes$	EXISTING WATER VALVE BOX
	EXISTING WATER MAIN VALVE VAULT
	EXISTING STORM SEWER INLET
$\bigcirc$	EXISTING STORM SEWER CATCH BASIN
$\bullet$	PROPOSED STORM SEWER CATCH BASIN
$\bigcirc$	EXISTING SEWER MANHOLE
-\$	EXISTING STREET LIGHT POLE
Ø	EXISTING POWER POLE
	EXISTING HANDHOLE
	EXISTING CURB AND GUTTER
	PROPOSED CONCRETE CURB, TYPE B
	PROPOSED COMBINATION CONCRETE CURB AND GUTTER REMOVAL AND REPLACEMENT
>	EXISTING STORM SEWER
)>	EXISTING COMBINED SEWER
W	EXISTING WATER MAIN

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THE SUBJECT VILLAGE CONCLUDE THAT THE EXISTING SOIL CONSISTS OF CLAY WITH SOME MINOR SILT AND TRACES OF SAND.

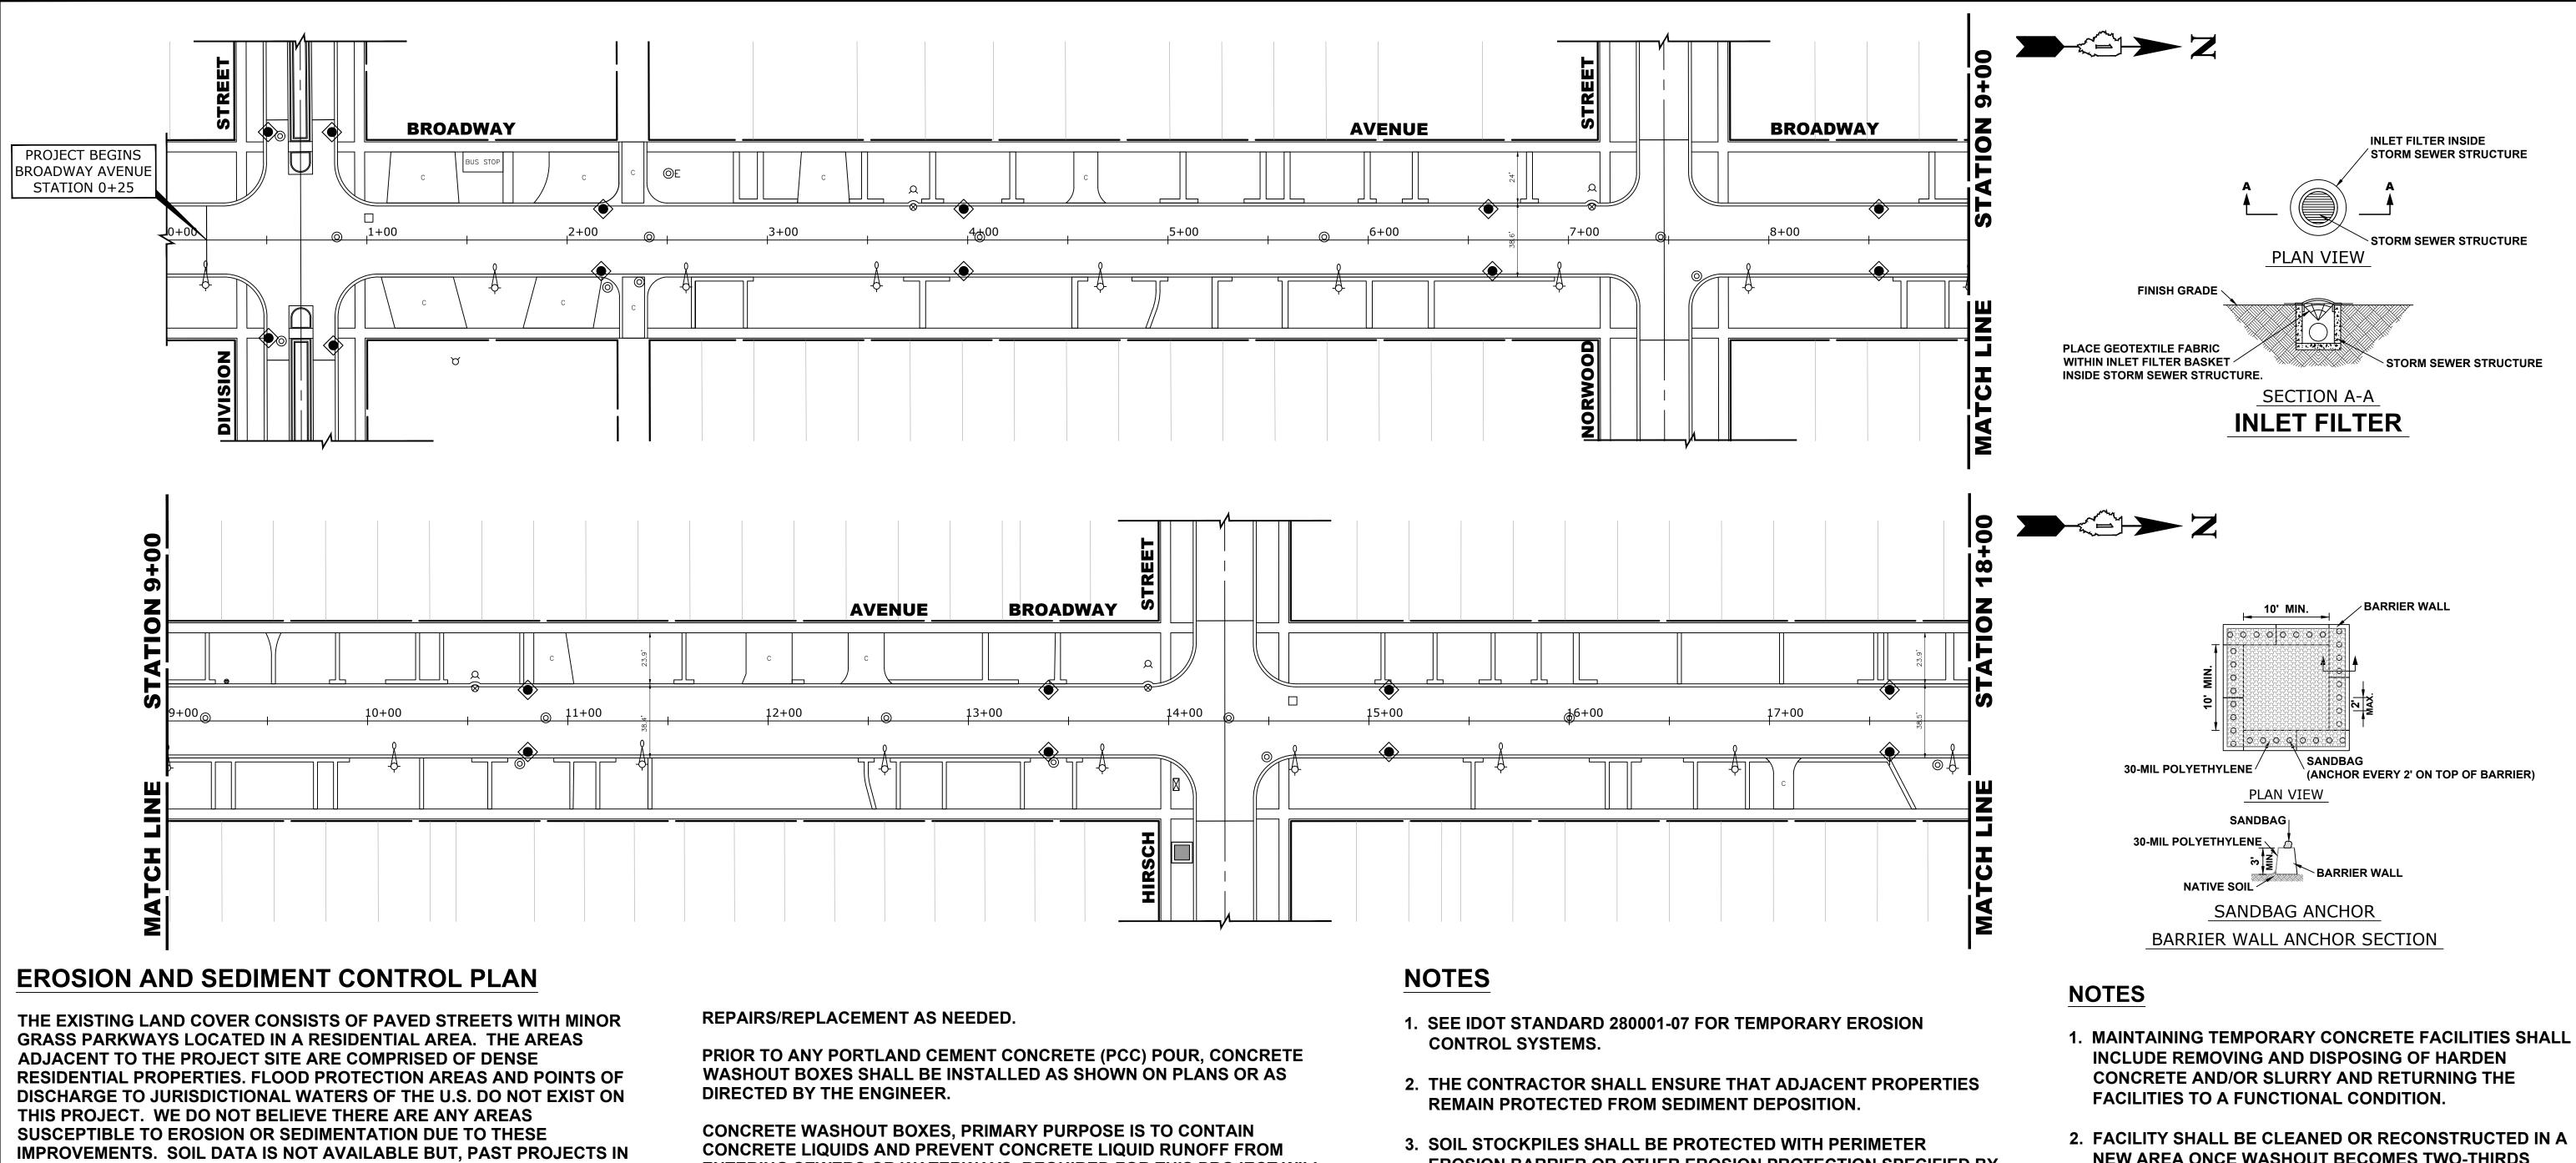PRIOR TO ANY SOIL/PAVEMENT DISTURBANCE, INLET FILTER ASSEMBLIES SHALL BE INSTALLED AS SHOWN ON PLANS.

THE INLET FILTER, PRIMARY PURPOSE IS TO TRAP SEDIMENT, REQUIRED FOR THIS PROJECT WILL BE A DROP IN INLET PROTECTION DEVICE SIMILAR TO FLEXSTORM INLET FILTERS. INLET FILTERS OF THIS TYPE HAVE BEEN USED ON PAST PROJECTS OF SIMILAR SIZE AND SCOPE AND HAVE HAD SATISFACTORY RESULTS.

THE INLET FILTER ASSEMBLY SHALL BE APPROVED BY THE ENGINEER OR VILLAGE PRIOR TO ORDERING AND INSTALLATION. THE INLET FILTER SHALL BE INSPECTED WEEKLY AND AFTER A 0.5 INCH RAIN EVENT BY THE ENGINEER. THE ENGINEER WILL REPORT ANY ISSUES, VIA VERBAL OR WRITTEN COMMUNICATION, THAT NEED TO BE ADDRESSED BY THE CONTRACTOR.

MAINTENANCE OF THE PROPOSED INLET FILTER WILL BE PER MANUFACTURE RECOMMENDATIONS AND WILL BE DONE BY THE CONTRACTOR. TYPICAL MAINTENANCE PRACTICES INCLUDE INSPECTION AFTER A RUNOFF EVENT, SEDIMENT REMOVAL AT 50% CAPACITY, AND

ENTERING SEWERS OR WATERWAYS, REQUIRED FOR THIS PROJECT WILL CONSIST OF A BARRIER WALL LINED WITH 30-MIL POLYETHYLENE OR AN ENGINEER APPROVED EQUAL WASHOUT. CONCRETE WASHOUT BOXES OF THIS TYPE HAVE BEEN USED ON PAST PROJECTS OF SIMILAR SIZE AND SCOPE AND HAVE HAD SATISFACTORY RESULTS.

THE PLAN FOR THE CONCRETE WASHOUT BOX SHALL BE SUBMITTED AND APPROVED BY THE ENGINEER OR VILLAGE PRIOR TO INSTALLATION AND WILL BE INSPECTED AFTER INSTALLATION. THE WASHOUT BOX SHALL BE INSPECTED PRIOR TO A CONCRETE POUR AND AFTER A CONCRETE POUR BY THE ENGINEER. THE ENGINEER WILL REPORT ANY ISSUES, VIA VERBAL OR WRITTEN COMMUNICATION, THAT NEED TO BE ADDRESSED BY THE CONTRACTOR.

MAINTENANCE OF THE PROPOSED CONCRETE WASHOUT BOXES WILL BE DONE BY THE CONTRACTOR. TYPICAL MAINTENANCE PRACTICES INCLUDE REPLACING DAMAGED LINER, DISPOSING OF SOLIDIFIED CONCRETE WASHOUT, AND REMOVAL OF ANY DISCHARGES WITHIN 24 HOURS.

ALL DISPOSAL OF CONSTRUCTION MATERIAL, AND SOLIDIFIED CONCRETE SHALL BE AT A CCDD (CLEAN CONSTRUCTION AND DEMOLITION DEBRIS) FACILITY

- **EROSION BARRIER OR OTHER EROSION PROTECTION SPECIFIED BY** THE RESIDENT ENGINEER. THE COST SHALL BE INCLUDED IN THE UNIT PRICE FOR THE INDIVIDUAL SOIL MATERIALS.
- 4. WHEREVER CONSTRUCTION VEHICLE ACCESS ROUTES INTERSECT PAVED PUBLIC ROADS. PROVISIONS SHALL BE MADE TO MINIMIZE THE TRANSPORT OF SEDIMENT BY RUNOFF OR VEHICLE TRACKING ONTO THE PAVED SURFACE. THE PROVISIONS MAY INCLUDE SPRAYING VEHICLE WHEELS TO CLEAR SEDIMENT BEFORE EXITING THE CONSTRUCTION SITE OR OTHER MEASURES APPROVED BY THE ENGINEER.
- 5. INLET FILTERS SHALL BE PAID FOR UNDER THE PAY ITEM FOR MAINTENANCE OF ROADWAYS. THE COST OF THE CONCRETE WASHOUTS SHALL BE INCLUDED IN THE COST OF THE CONTRACT.
- 6. INLET FILTER SHALL BE INSTALLED PRIOR TO CONSTRUCTION AND SHALL BE REMOVED AFTER CONSTRUCTION IS COMPLETED. FILTERS WILL BE INSPECTED WEEKLY AND THE CONTRACTOR WILL BE NOTIFIED OF ANY CORRECTIVE MEASURES THAT WILL BE **REQUIRED TO BE MADE BY THE CONTRACTOR.**

STATE OF ILLINOIS	EROSI	ON AND SEDIMENT
DEPARTMENT OF TRANSPORTATION		
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2. FACILITY SHALL BE CLEANED OR RECONSTRUCTED IN A **NEW AREA ONCE WASHOUT BECOMES TWO-THIRDS** FULL.

## **CONCRETE WASHOUT**

## LEGEND

SYMBOL  $\langle \bullet \rangle$ 

DESCRIPTION INLET FILTER/SEDIMENT CONTROL, DRAINAGE STRUCTURE, INLET FILTER CLEANING CONCRETE WASHOUT

INLET FILTER INSIDE

STORM SEWER STRUCTURE

STORM SEWER STRUCTURE

STORM SEWER STRUCTURE

**BARRIER WALL** 


## CONSTRUCTION SEQUENCE

**1. INSTALL EROSION CONTROL MEASURES** 

- 2. COMPLETE ALL UNDERGROUND WORK
- **3. PAVEMENT PATCHING**
- 4. RESURFACE PAVEMENTS
- **5. RESTORE DAMAGED AREAS ADJACENT TO IMPROVEMENTS** 6. REMOVE EROSION CONTROL MEASURES

IT CONTROL PLAN		F.A.U. RTE.	SECTION		COUNTY	TOTAL SHEETS	SHEET	
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E.H.E. PROJECT NO. 600-18-27901

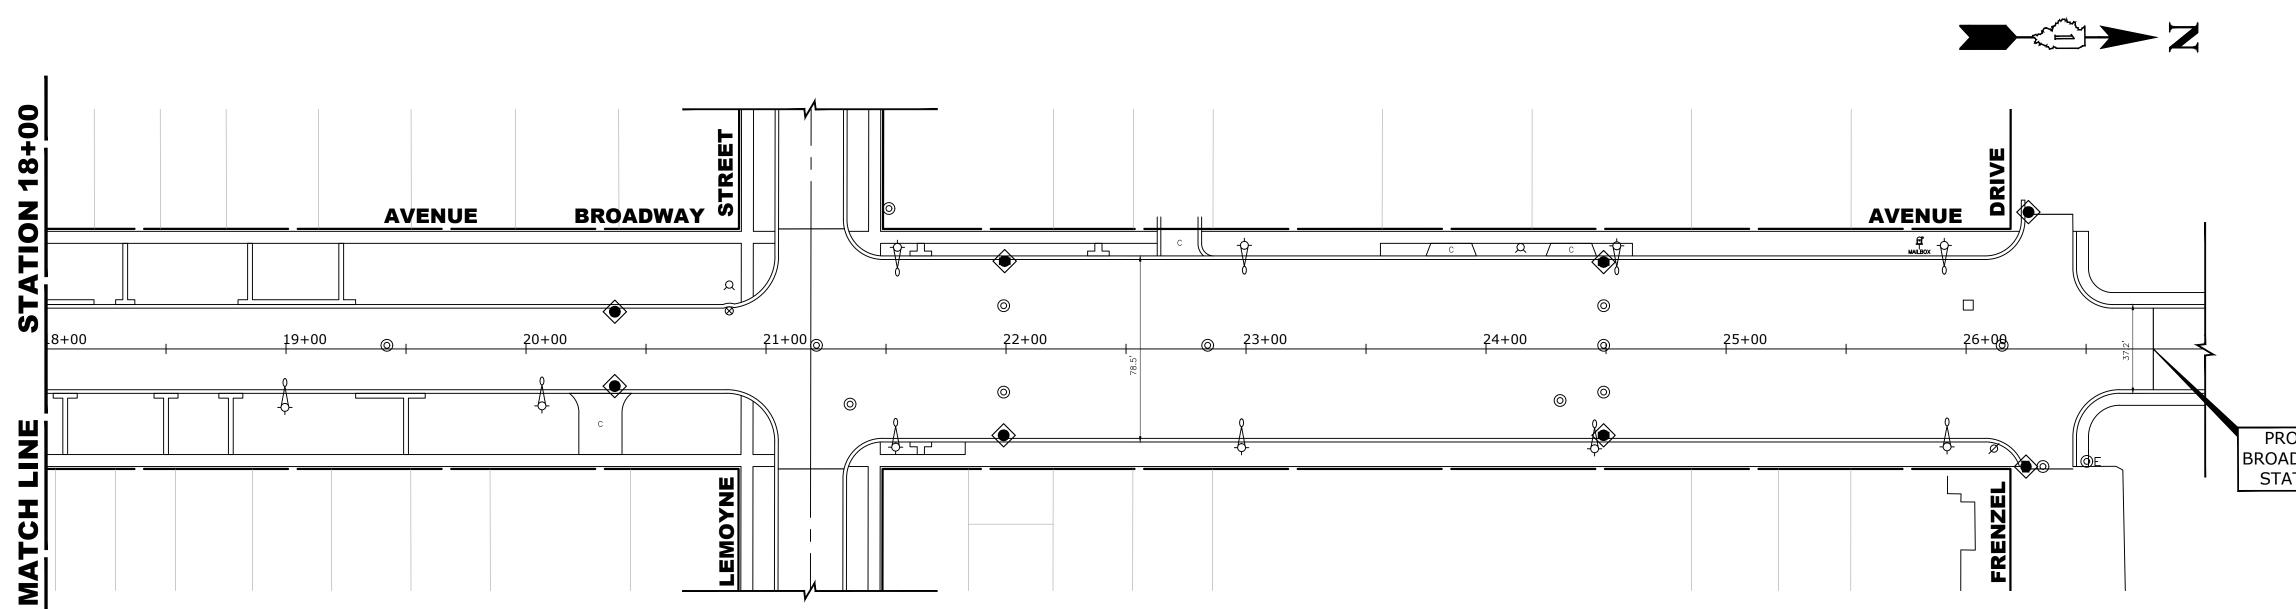

## **EROSION AND SEDIMENT CONTROL PLAN**

THE EXISTING LAND COVER CONSISTS OF PAVED STREETS WITH MINOR GRASS PARKWAYS LOCATED IN A RESIDENTIAL AREA. THE AREAS ADJACENT TO THE PROJECT SITE ARE COMPRISED OF DENSE RESIDENTIAL PROPERTIES. FLOOD PROTECTION AREAS AND POINTS OF DISCHARGE TO JURISDICTIONAL WATERS OF THE U.S. DO NOT EXIST ON THIS PROJECT. WE DO NOT BELIEVE THERE ARE ANY AREAS SUSCEPTIBLE TO EROSION OR SEDIMENTATION DUE TO THESE IMPROVEMENTS. SOIL DATA IS NOT AVAILABLE BUT, PAST PROJECTS IN THE SUBJECT VILLAGE CONCLUDE THAT THE EXISTING SOIL CONSISTS OF CLAY WITH SOME MINOR SILT AND TRACES OF SAND.

PRIOR TO ANY SOIL/PAVEMENT DISTURBANCE, INLET FILTER ASSEMBLIES SHALL BE INSTALLED AS SHOWN ON PLANS.

THE INLET FILTER, PRIMARY PURPOSE IS TO TRAP SEDIMENT, REQUIRED FOR THIS PROJECT WILL BE A DROP IN INLET PROTECTION DEVICE SIMILAR TO FLEXSTORM INLET FILTERS. INLET FILTERS OF THIS TYPE HAVE BEEN USED ON PAST PROJECTS OF SIMILAR SIZE AND SCOPE AND HAVE HAD SATISFACTORY RESULTS.

THE INLET FILTER ASSEMBLY SHALL BE APPROVED BY THE ENGINEER OR VILLAGE PRIOR TO ORDERING AND INSTALLATION. THE INLET FILTER SHALL BE INSPECTED WEEKLY AND AFTER A 0.5 INCH RAIN EVENT BY THE ENGINEER. THE ENGINEER WILL REPORT ANY ISSUES, VIA VERBAL OR WRITTEN COMMUNICATION, THAT NEED TO BE ADDRESSED BY THE CONTRACTOR.

MAINTENANCE OF THE PROPOSED INLET FILTER WILL BE PER MANUFACTURE RECOMMENDATIONS AND WILL BE DONE BY THE CONTRACTOR. TYPICAL MAINTENANCE PRACTICES INCLUDE INSPECTION AFTER A RUNOFF EVENT, SEDIMENT REMOVAL AT 50% CAPACITY, AND **REPAIRS/REPLACEMENT AS NEEDED.** 

PRIOR TO ANY PORTLAND CEMENT CONCRETE (PCC) POUR, CONCRETE WASHOUT BOXES SHALL BE INSTALLED AS SHOWN ON PLANS OR AS DIRECTED BY THE ENGINEER.

CONCRETE WASHOUT BOXES, PRIMARY PURPOSE IS TO CONTAIN CONCRETE LIQUIDS AND PREVENT CONCRETE LIQUID RUNOFF FROM ENTERING SEWERS OR WATERWAYS, REQUIRED FOR THIS PROJECT WILL CONSIST OF A BARRIER WALL LINED WITH 30-MIL POLYETHYLENE OR AN ENGINEER APPROVED EQUAL WASHOUT. CONCRETE WASHOUT BOXES OF THIS TYPE HAVE BEEN USED ON PAST PROJECTS OF SIMILAR SIZE AND SCOPE AND HAVE HAD SATISFACTORY RESULTS.

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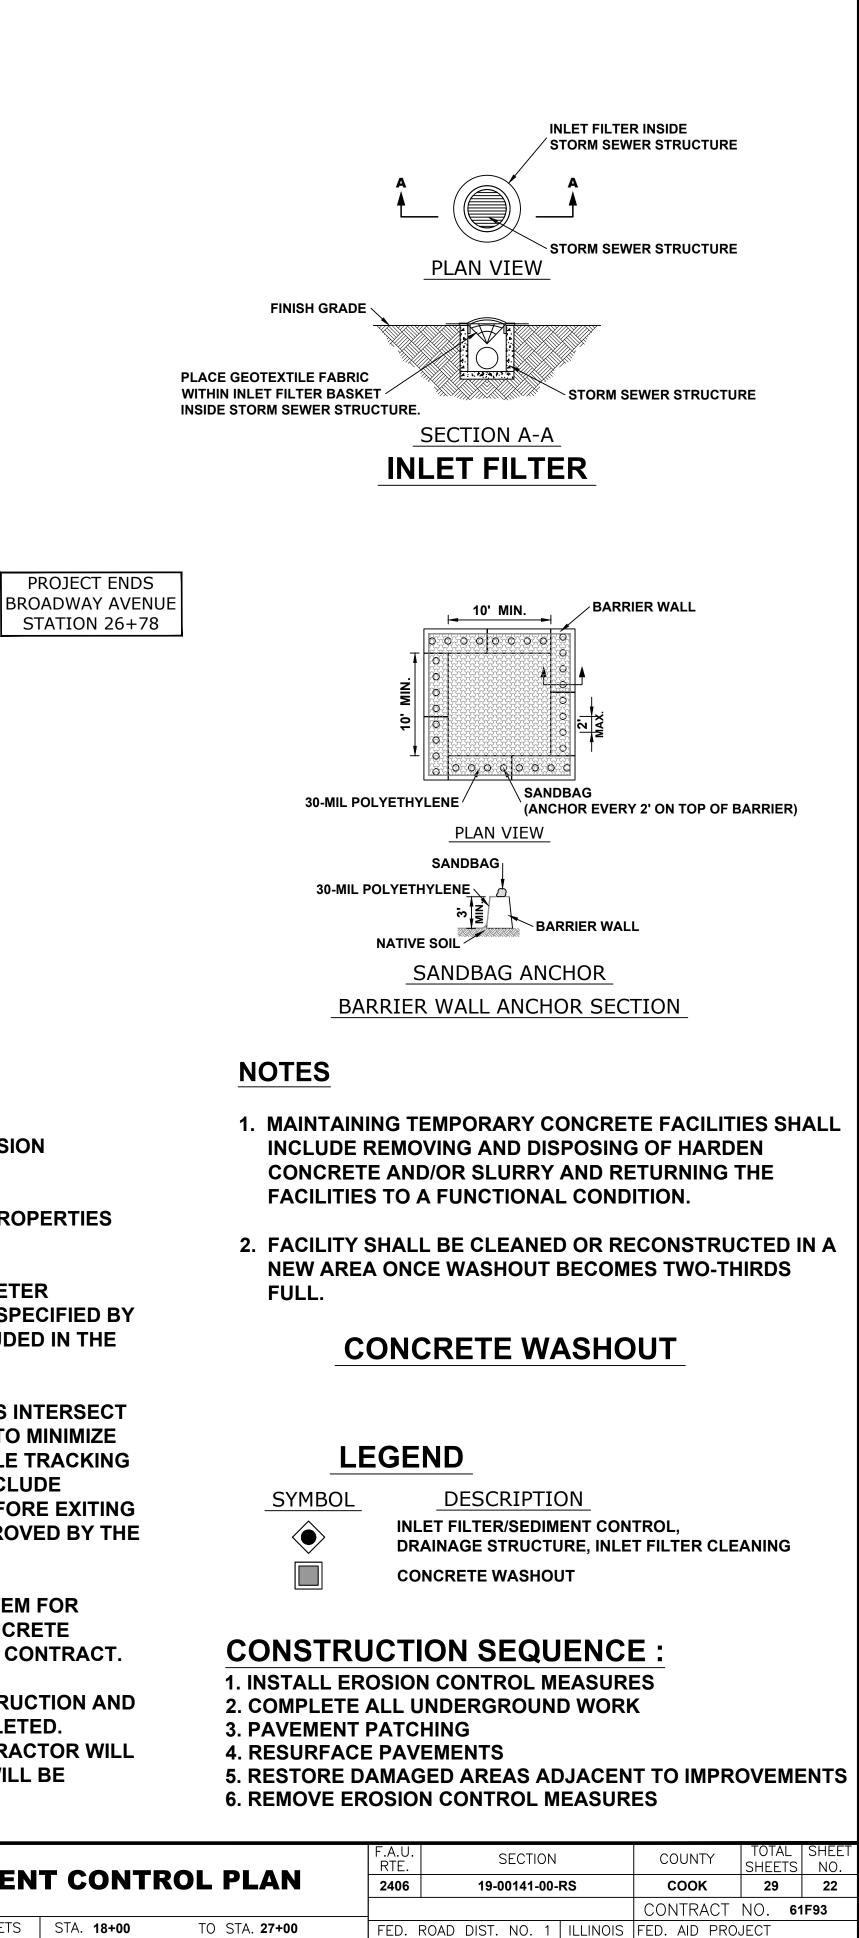
ALL DISPOSAL OF CONSTRUCTION MATERIAL, AND SOLIDIFIED CONCRETE SHALL BE AT A CCDD (CLEAN CONSTRUCTION AND DEMOLITION DEBRIS) FACILITY

	9933 Roosevelt Road	DESIGNED	REVISED –
HANCOCK Municipal Consultants	Westchester, IL, 60154-2780	DRAWN – <b>TG, SFB, DMM</b>	REVISED –
	Phone: /08-865-0300	CHECKED	REVISED –
	www.bilocccoli	DATE – <b>5-13-19</b>	REVISED –


#### **NOTES**

- 1. SEE IDOT STANDARD 280001-07 FOR TEMPORARY EROSION CONTROL SYSTEMS.
- 2. THE CONTRACTOR SHALL ENSURE THAT ADJACENT PROPERTIES REMAIN PROTECTED FROM SEDIMENT DEPOSITION.
- 3. SOIL STOCKPILES SHALL BE PROTECTED WITH PERIMETER EROSION BARRIER OR OTHER EROSION PROTECTION SPECIFIED BY THE RESIDENT ENGINEER. THE COST SHALL BE INCLUDED IN THE UNIT PRICE FOR THE INDIVIDUAL SOIL MATERIALS.
- 4. WHEREVER CONSTRUCTION VEHICLE ACCESS ROUTES INTERSECT PAVED PUBLIC ROADS. PROVISIONS SHALL BE MADE TO MINIMIZE THE TRANSPORT OF SEDIMENT BY RUNOFF OR VEHICLE TRACKING ONTO THE PAVED SURFACE. THE PROVISIONS MAY INCLUDE SPRAYING VEHICLE WHEELS TO CLEAR SEDIMENT BEFORE EXITING THE CONSTRUCTION SITE OR OTHER MEASURES APPROVED BY THE ENGINEER.
- 5. INLET FILTERS SHALL BE PAID FOR UNDER THE PAY ITEM FOR MAINTENANCE OF ROADWAYS. THE COST OF THE CONCRETE WASHOUTS SHALL BE INCLUDED IN THE COST OF THE CONTRACT.
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www.ehancock.com

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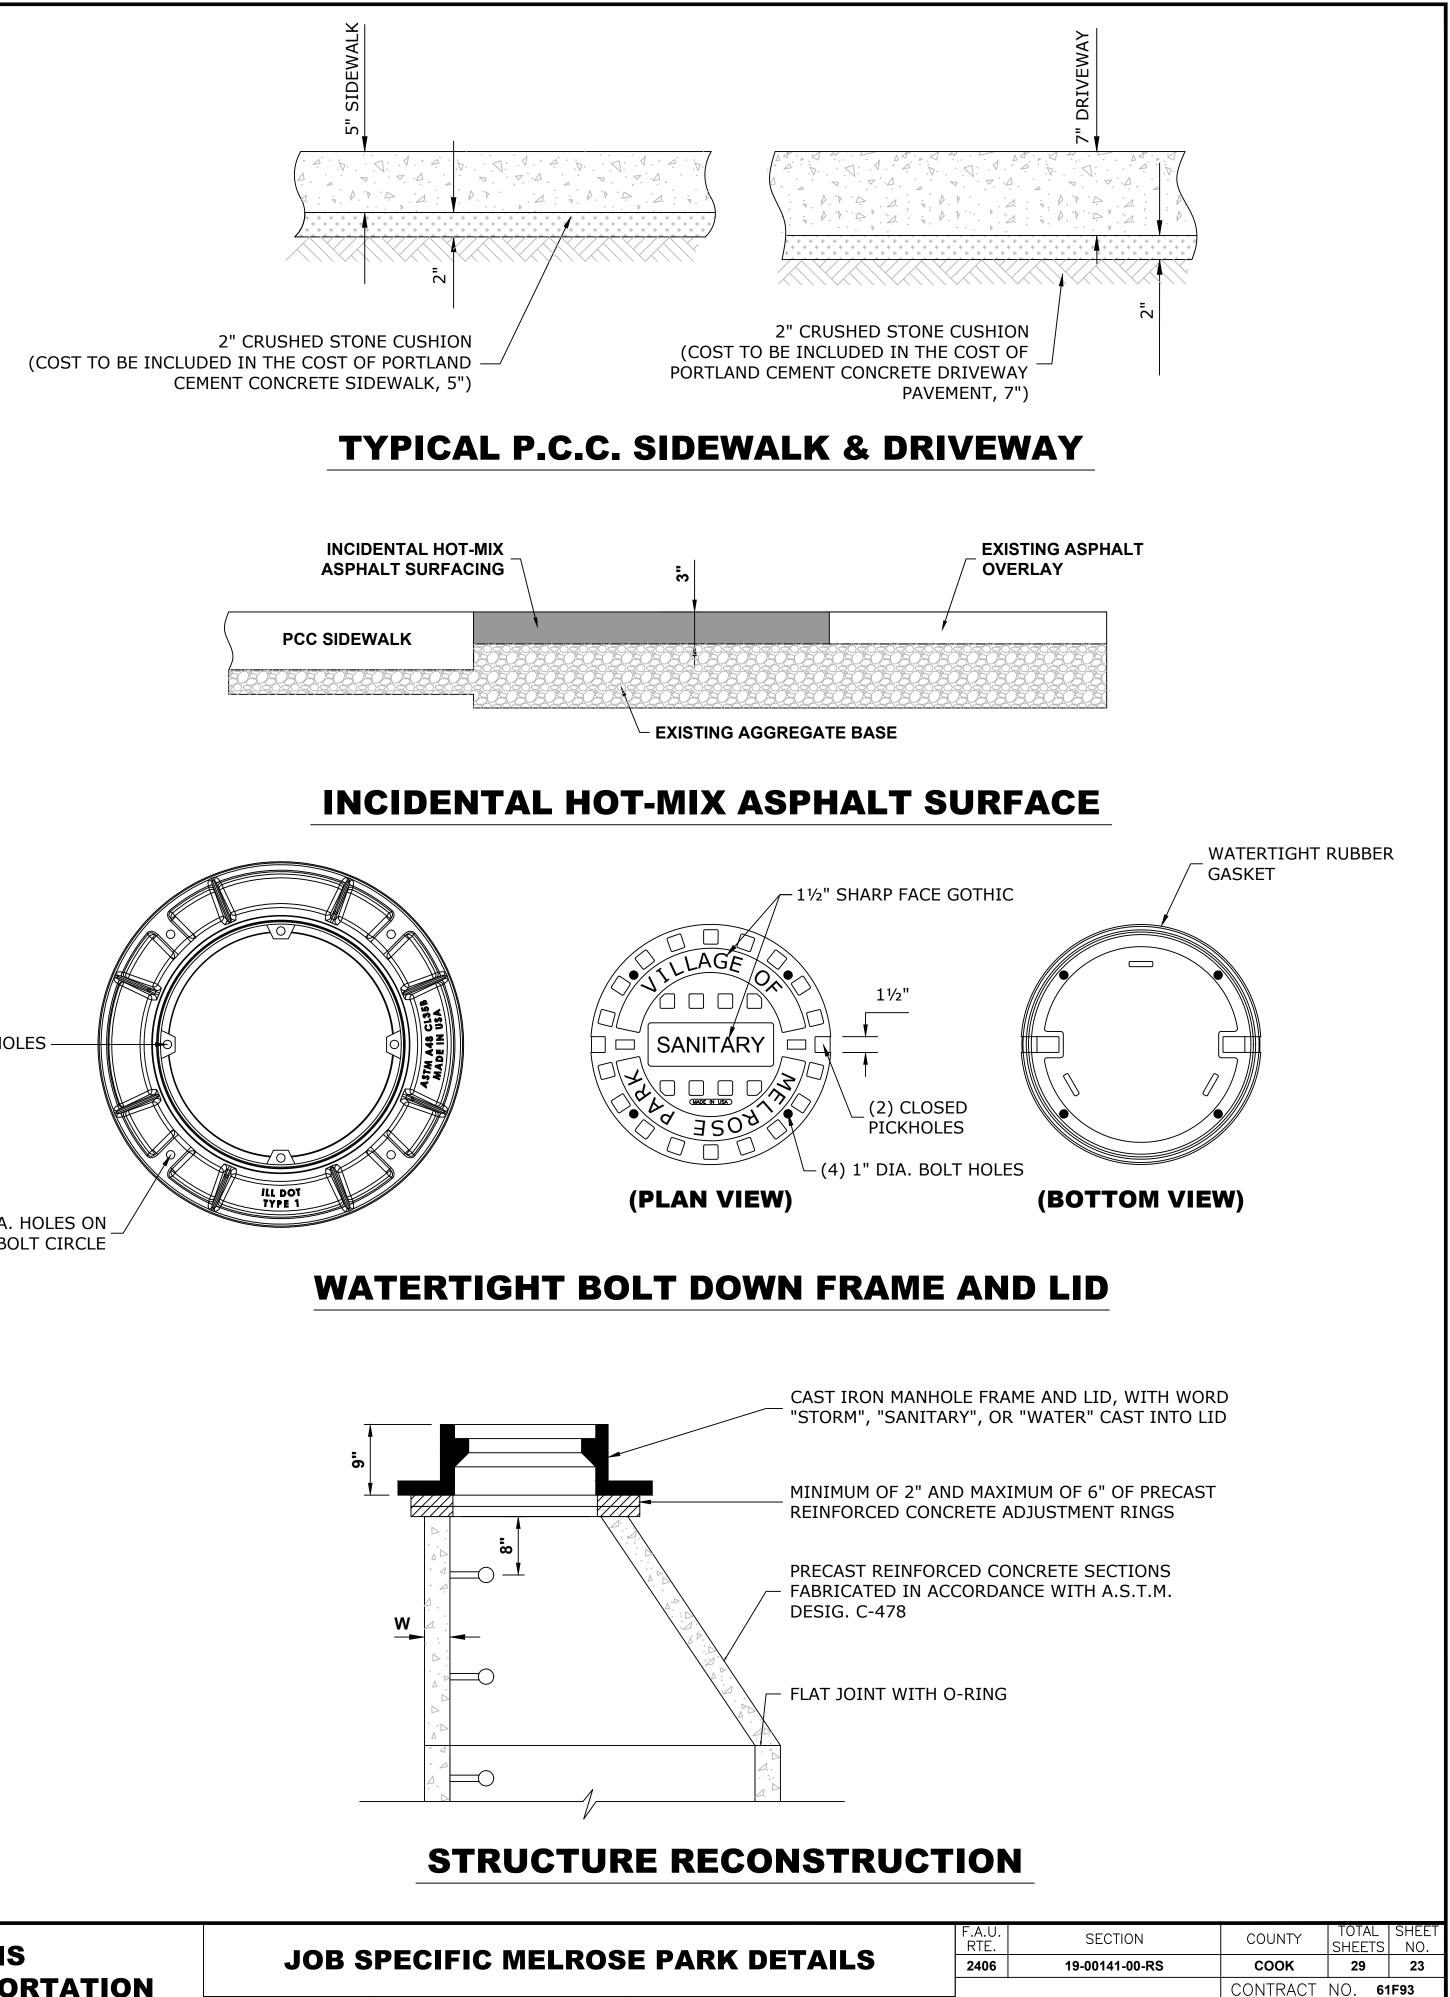
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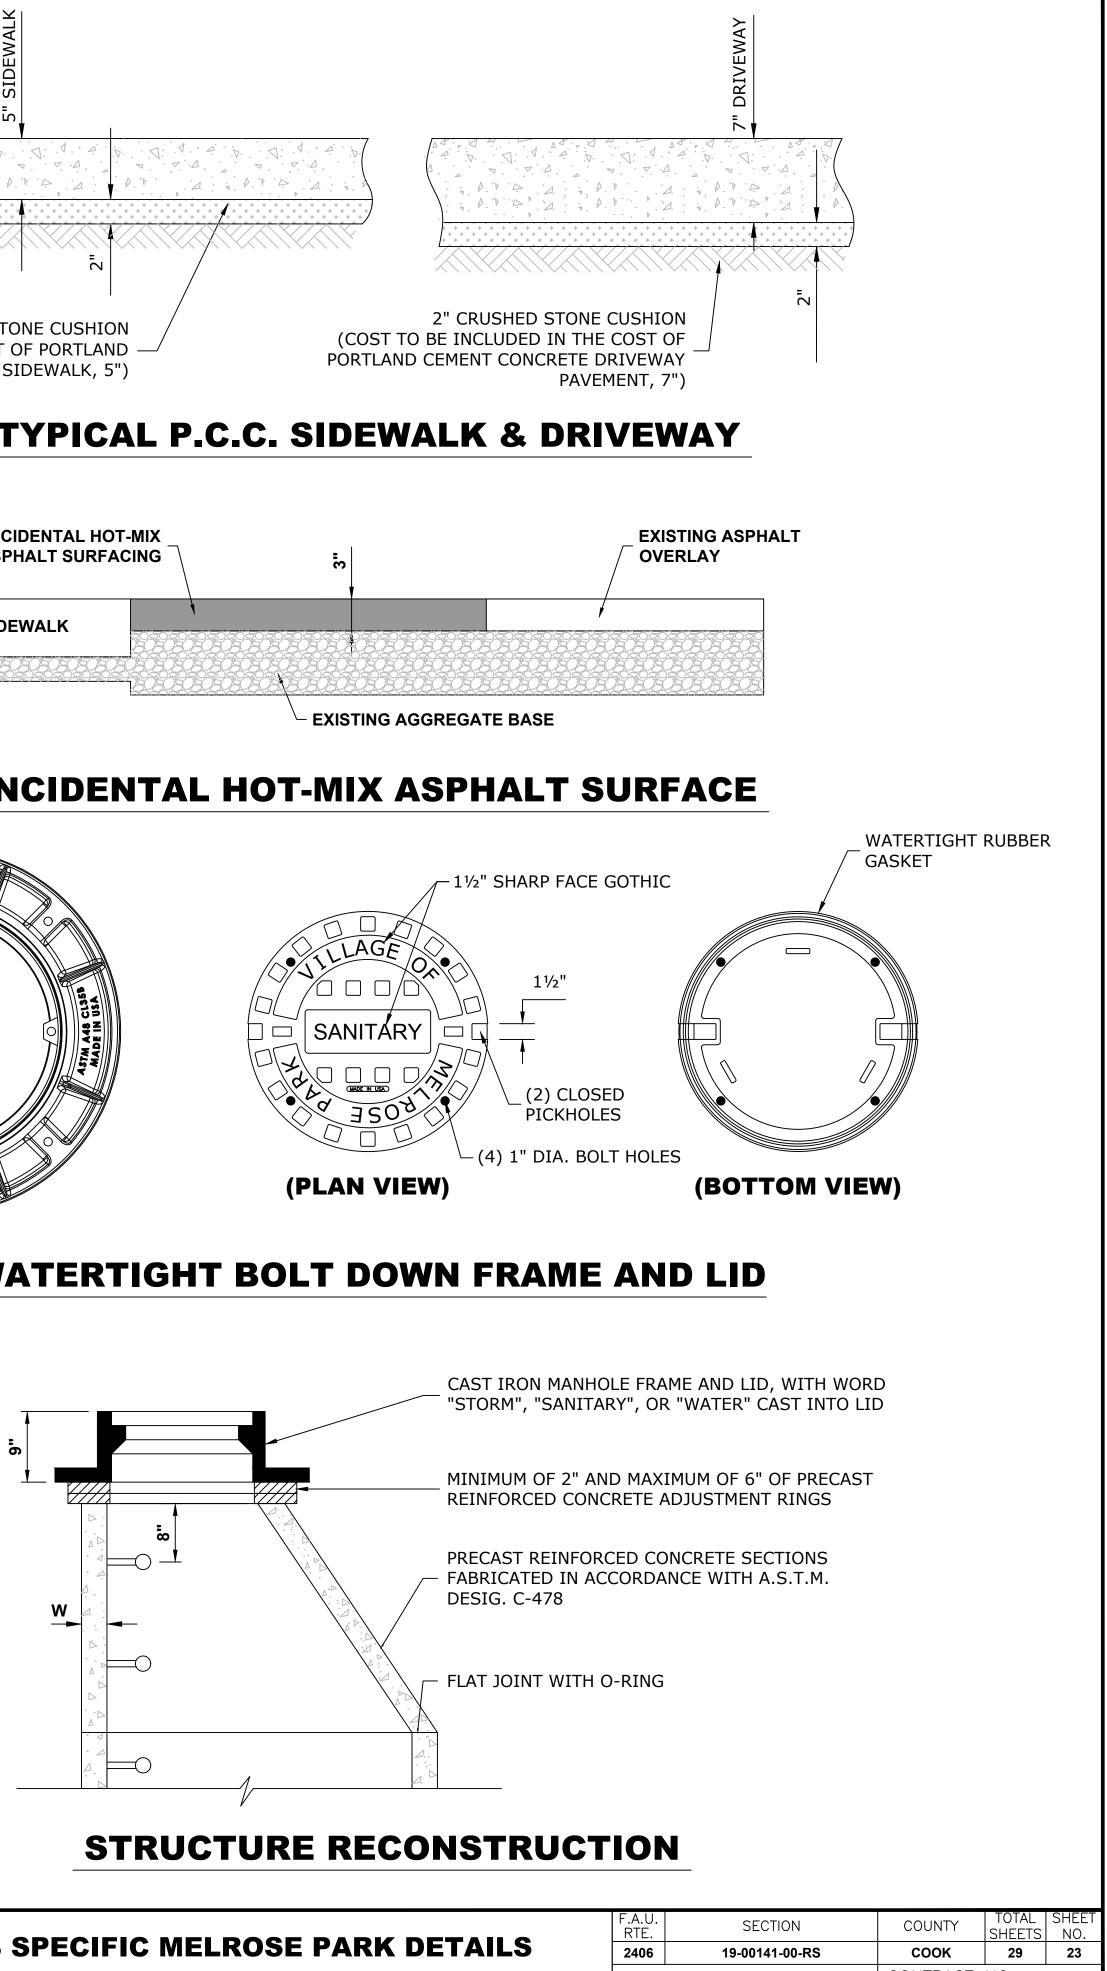
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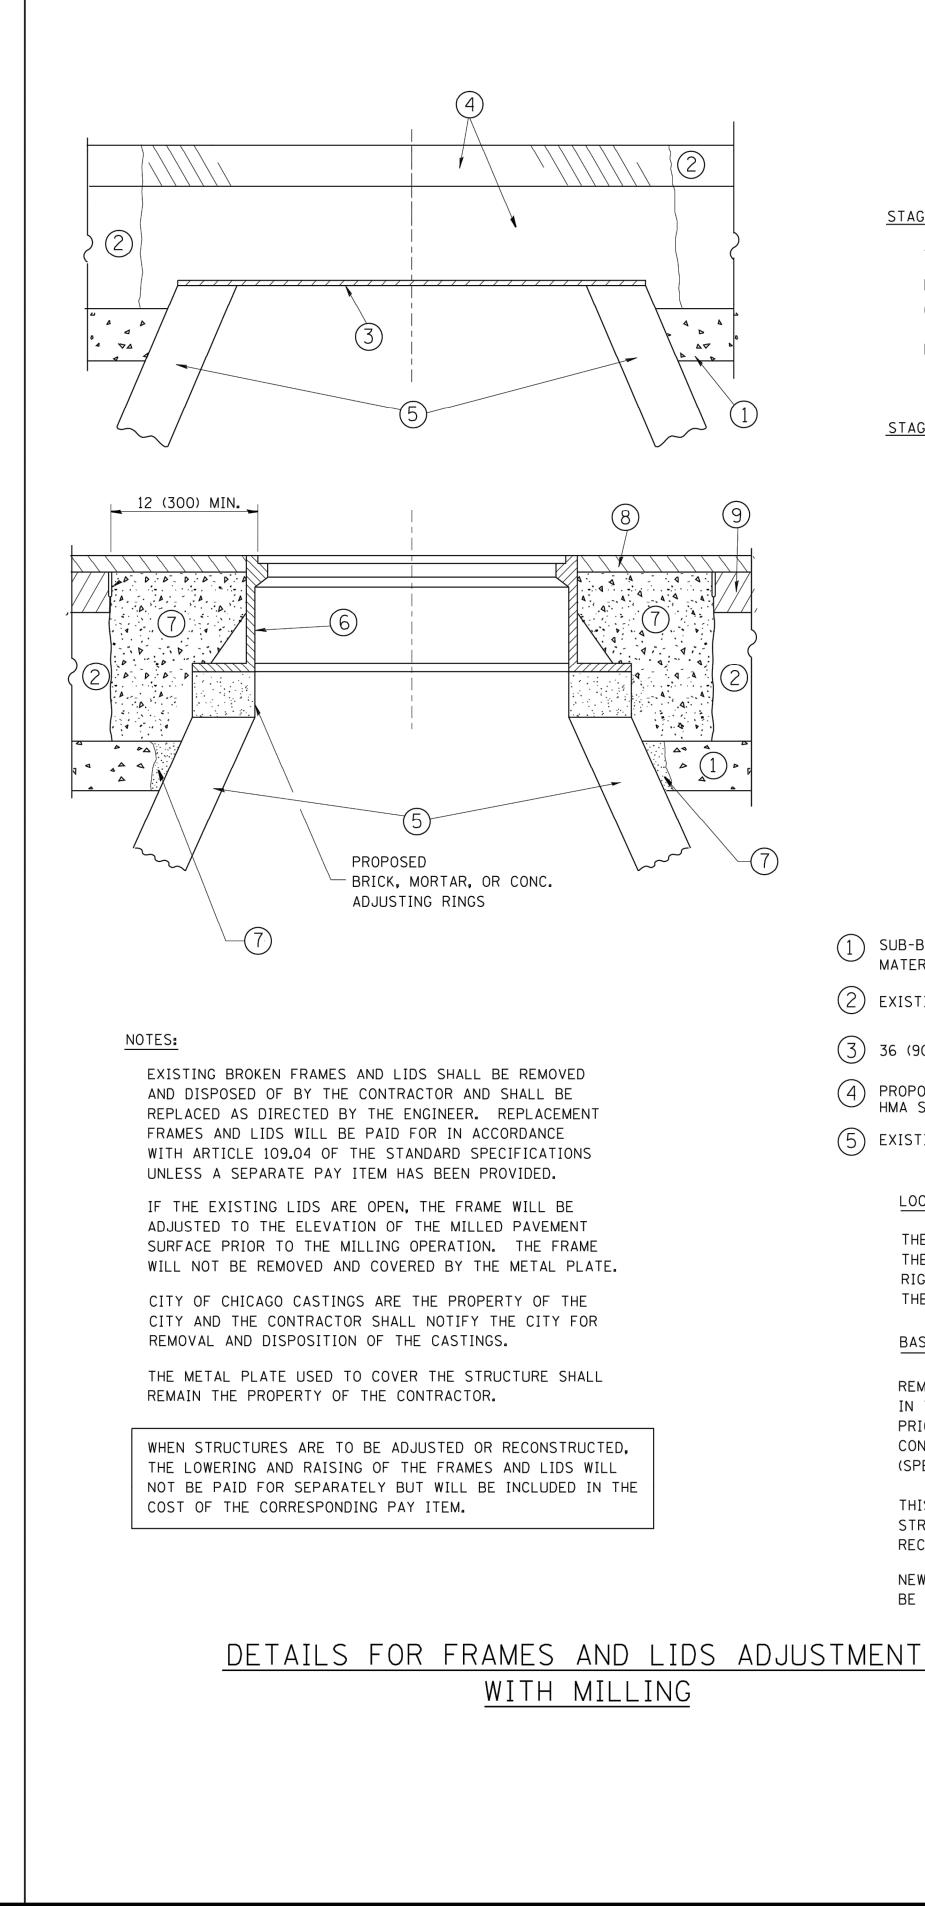
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### **STATE OF ILLINOIS DEPARTMENT OF TRANSPORTATION**

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#### CONSTRUCTION PROCEDURES

STAGE 1 (BEFORE PAVEMENT MILLING)

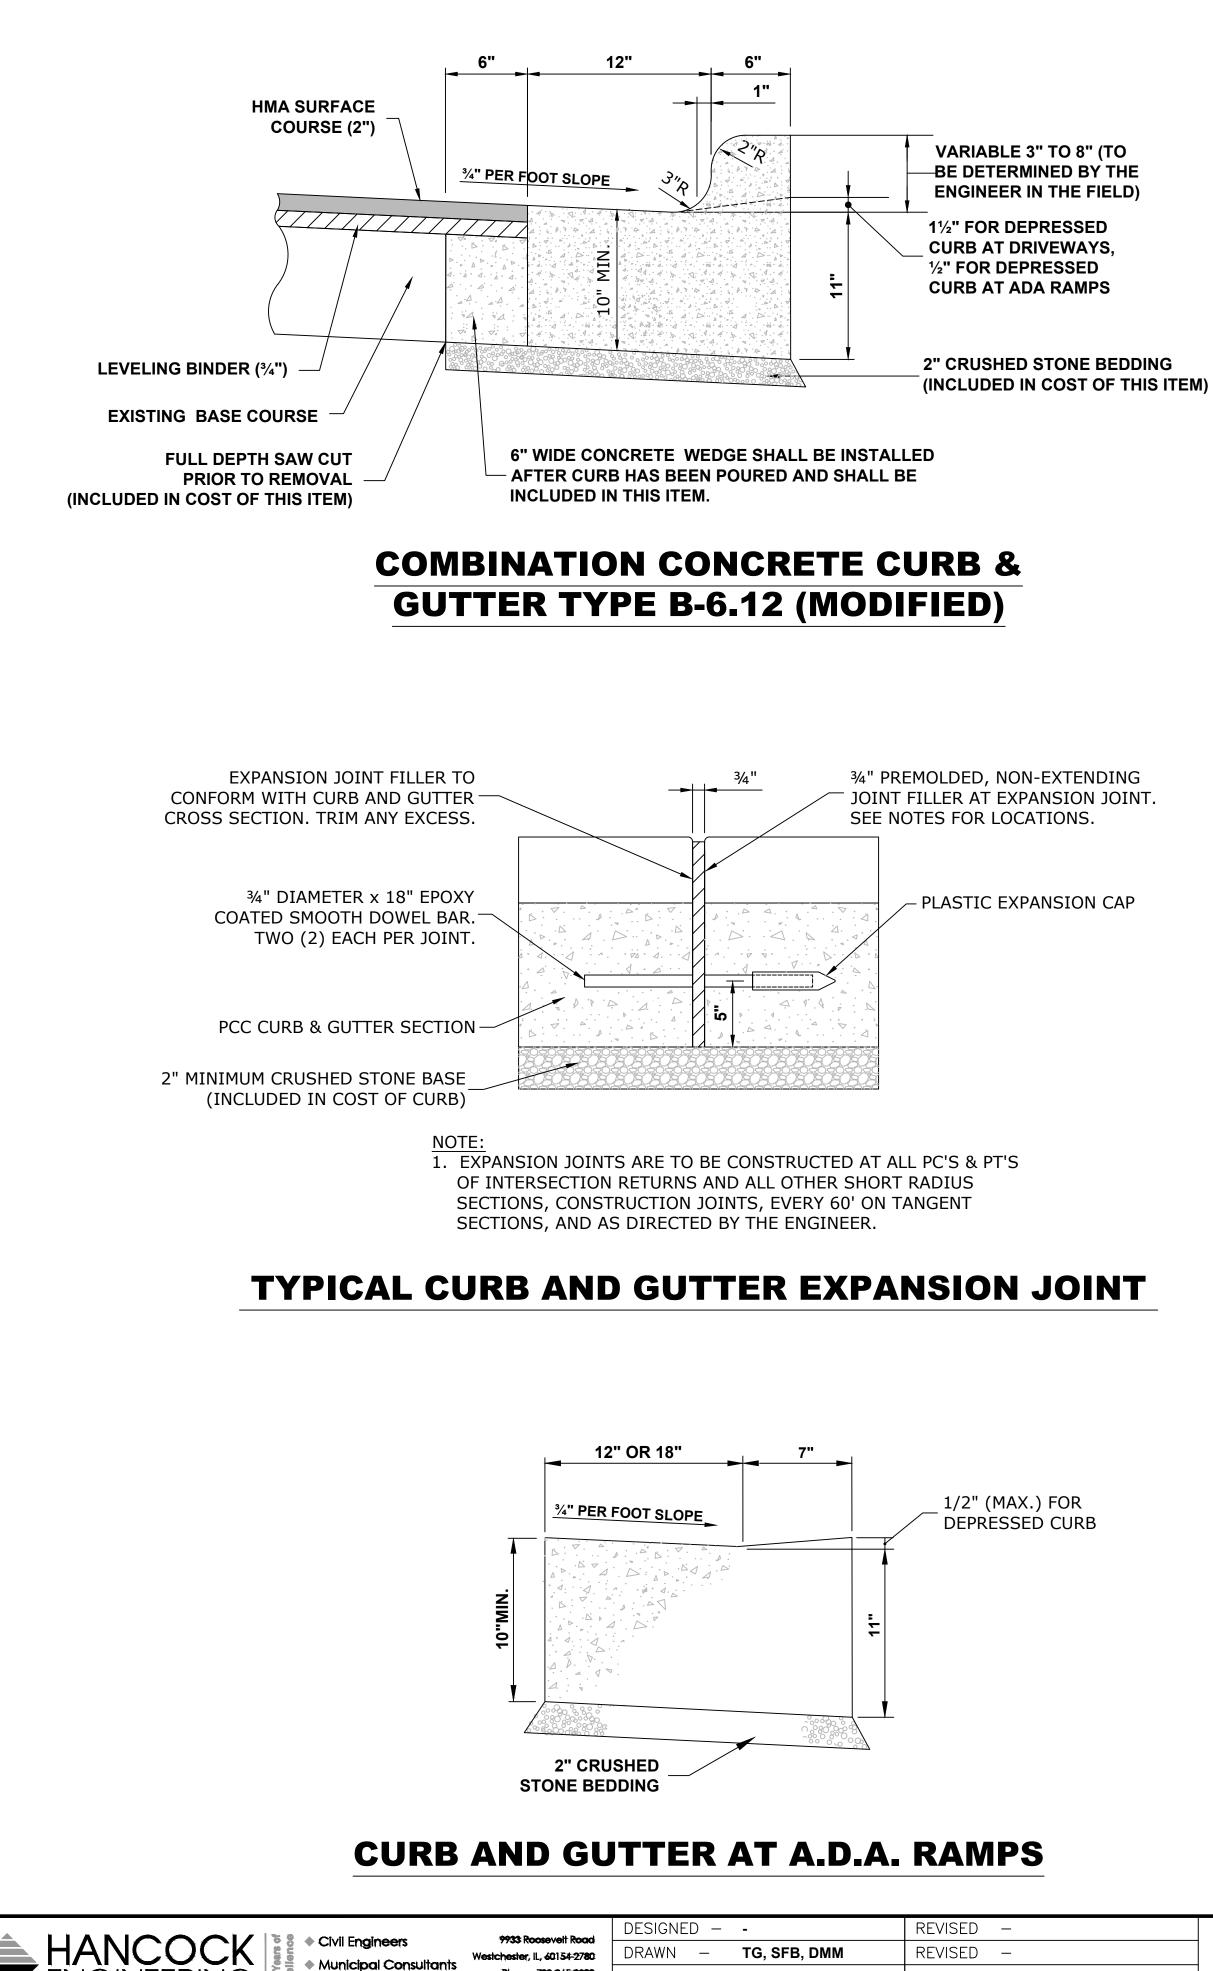- A) REMOVE A MINIMUM OF 12 (300) OF THE PAVEMENT FROM
- AROUND THE STRUCTURE. B) REMOVE THE EXISTING FRAME AND LID FROM THE STRUCTURE. C) COVER THE STRUCTURE OPENING WITH A 36 (900) DIAMETER
- METAL PLATE.
- D) BACKFILL WITH CRUSHED STONE AND A MINIMUM  $1\frac{1}{2}$  (40) THICK HMA SURFACE MIX APPROVED BY THE ENGINEER.

<u>STAGE 2</u> (AFTER PAVEMENT MILLING)

A) REMOVE THE HMA SURFACE MIX AND CRUSHED STONE.

- B) INSTALL THE FRAME AND LID; ADJUST THE FRAME TO ITS FINAL SURFACE ELEVATION.
- C) THE SURROUNDING SPACE SHALL BE FILLED WITH CLASS PP-1\* CONCRETE TO THE ELEVATION OF THE SURFACE OF THE EXISTING BASE COURSE OR THE BINDER COURSE.

\* UNLESS OTHERWISE SPECIFIED IN THE PLANS.

THE PROCEDURE EXPLAINED ABOVE SHALL CONFORM TO THE APPLICABLE PORTIONS OF SECTIONS 353, 406, 602, AND 603 OF THE STANDARD SPECIFICATIONS EXCEPT THAT "THE CONTRACTOR SHALL ADJUST THE STRUCTURES TO THE FINISHED PAVEMENT ELEVATION NO MORE THAN 5 CALENDAR DAYS PRIOR TO PLACEMENT OF THE FINAL LIFT OF SURFACE UNLESS APPROVED BY THE ENGINEER."

#### LEGEND

1	SUB-BASE GRANULAR MATERIAL	6 FRAME AND LID (SEE NOTES)
2	EXISTING PAVEMENT	(7) CLASS PP-1* CONCRETE
3	36 (900) DIAMETER METAL PLATE	(8) PROPOSED HMA SURFACE COURSE
4	PROPOSED CRUSHED STONE AND HMA SURFACE MIX	CONTROLOGED HIMR SOM ACE COUNSE
5	EXISTING STRUCTURE	9 PROPOSED HMA BINDER COURSE

#### LOCATION OF STRUCTURES:

THE CONTRACTOR WILL BE REQUIRED TO KEEP A RECORD OF THE LOCATIONS OF THE BURIED STRUCTURES ACCORDING TO THE STATION AND DISTANCE LEFT OR RIGHT OF THE CENTERLINE OF PAVEMENT. UPON COMPLETION OF THE WORK, THE CONTRACTOR WILL DELIVER THE RECORD TO THE ENGINEER.

BASIS OF PAYMENT:

REMOVING FRAMES AND LIDS ON DRAINAGE AND UTILITY STRUCTURES IN THE PAVEMENT PRIOR TO MILLING, AND ADJUSTING TO FINAL GRADE PRIOR TO PLACING THE SURFACE COURSE, WILL BE PAID FOR AT THE CONTRACT UNIT PRICE EACH FOR "FRAMES AND LIDS TO BE ADJUSTED (SPECIAL)."


THIS WORK WILL NOT BE PAID FOR WHEN DRAINAGE AND UTILITY STRUCTURES ARE SPECIFIED FOR PAYMENT AS STRUCTURE RECONSTRUCTION.


NEW FRAMES AND LIDS, WHEN SPECIFIED, WILL BE PAID FOR SEPARATELY.

ALL DIMENSIONS ARE IN INCHES (MILLIMETERS) UNLESS OTHERWISE SHOWN		ALL	DIMENSIONS	ARE ]	IN INCHES	(MILLIMETERS)	UNLESS	OTHERWISE	SHOWN
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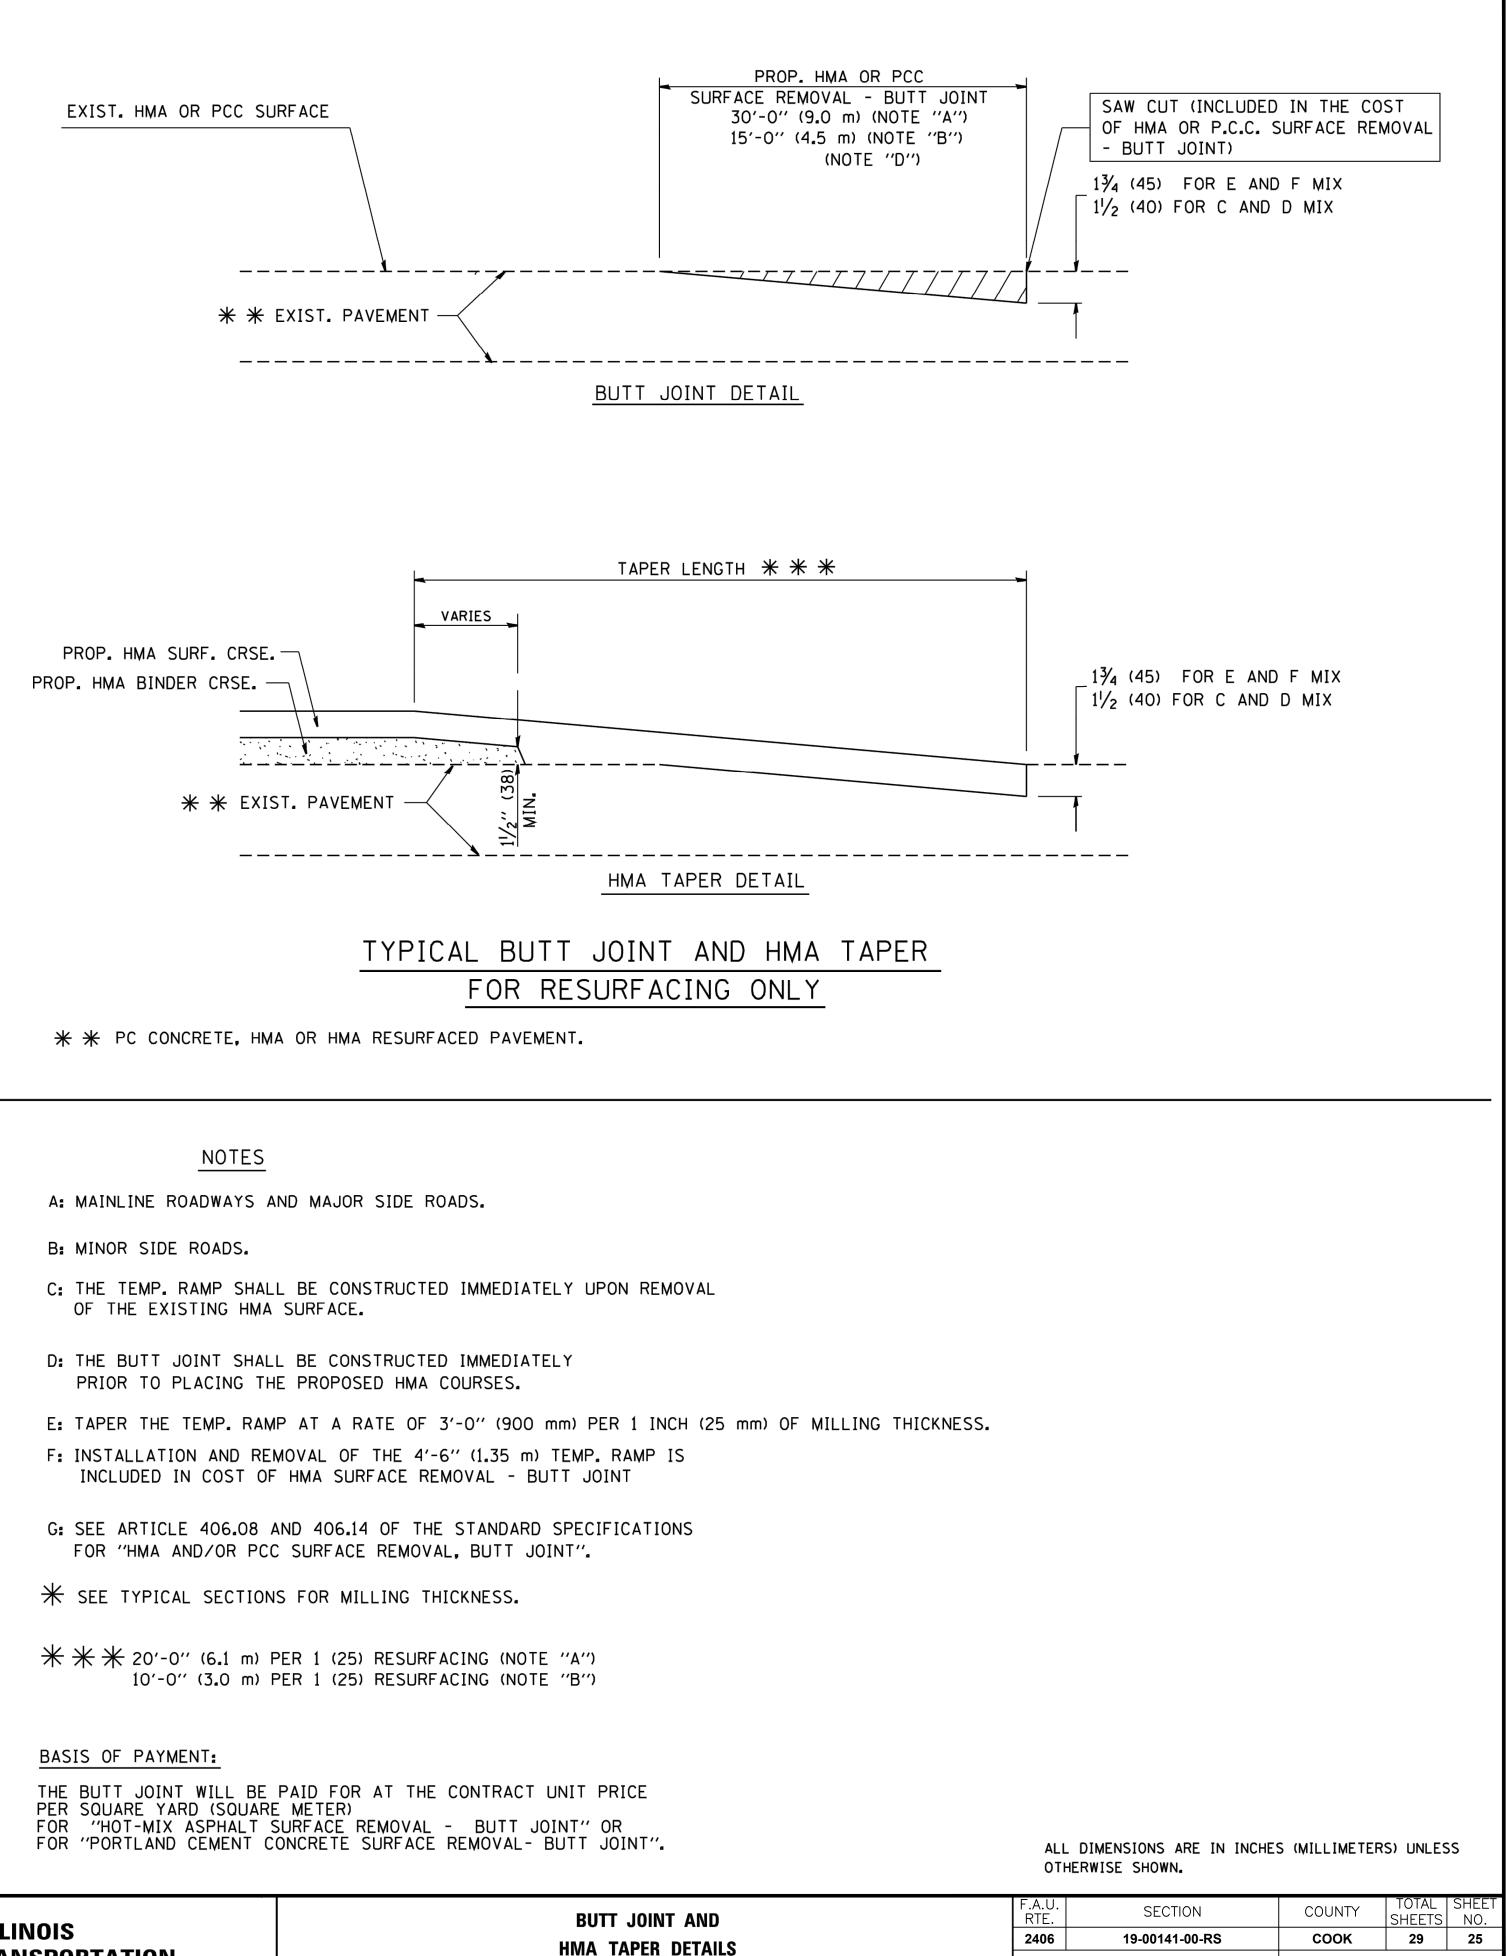
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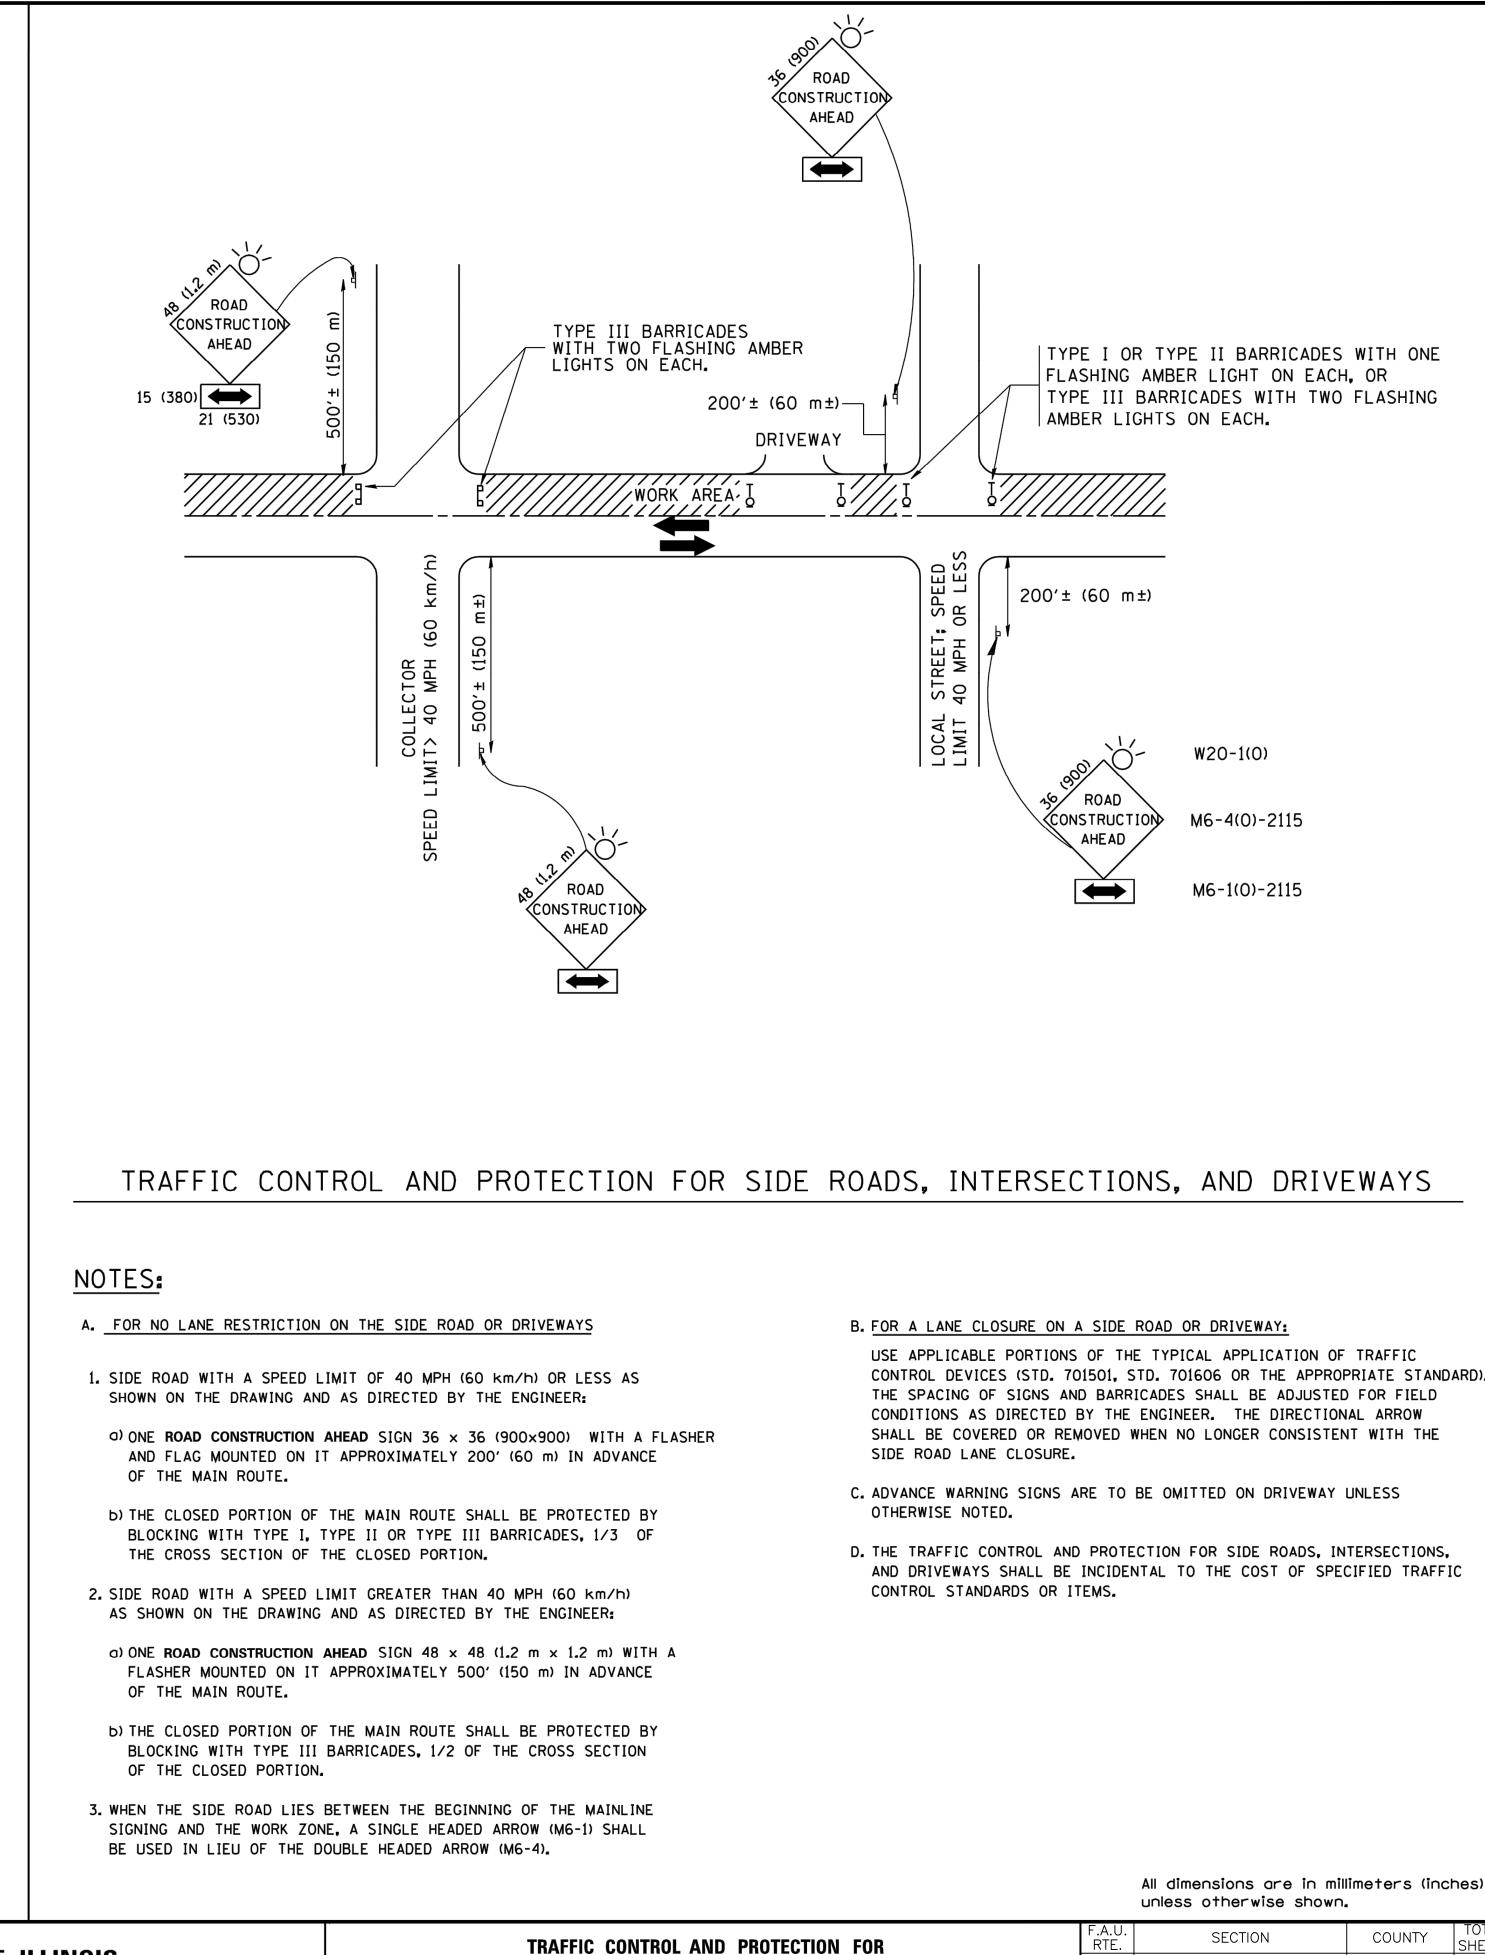


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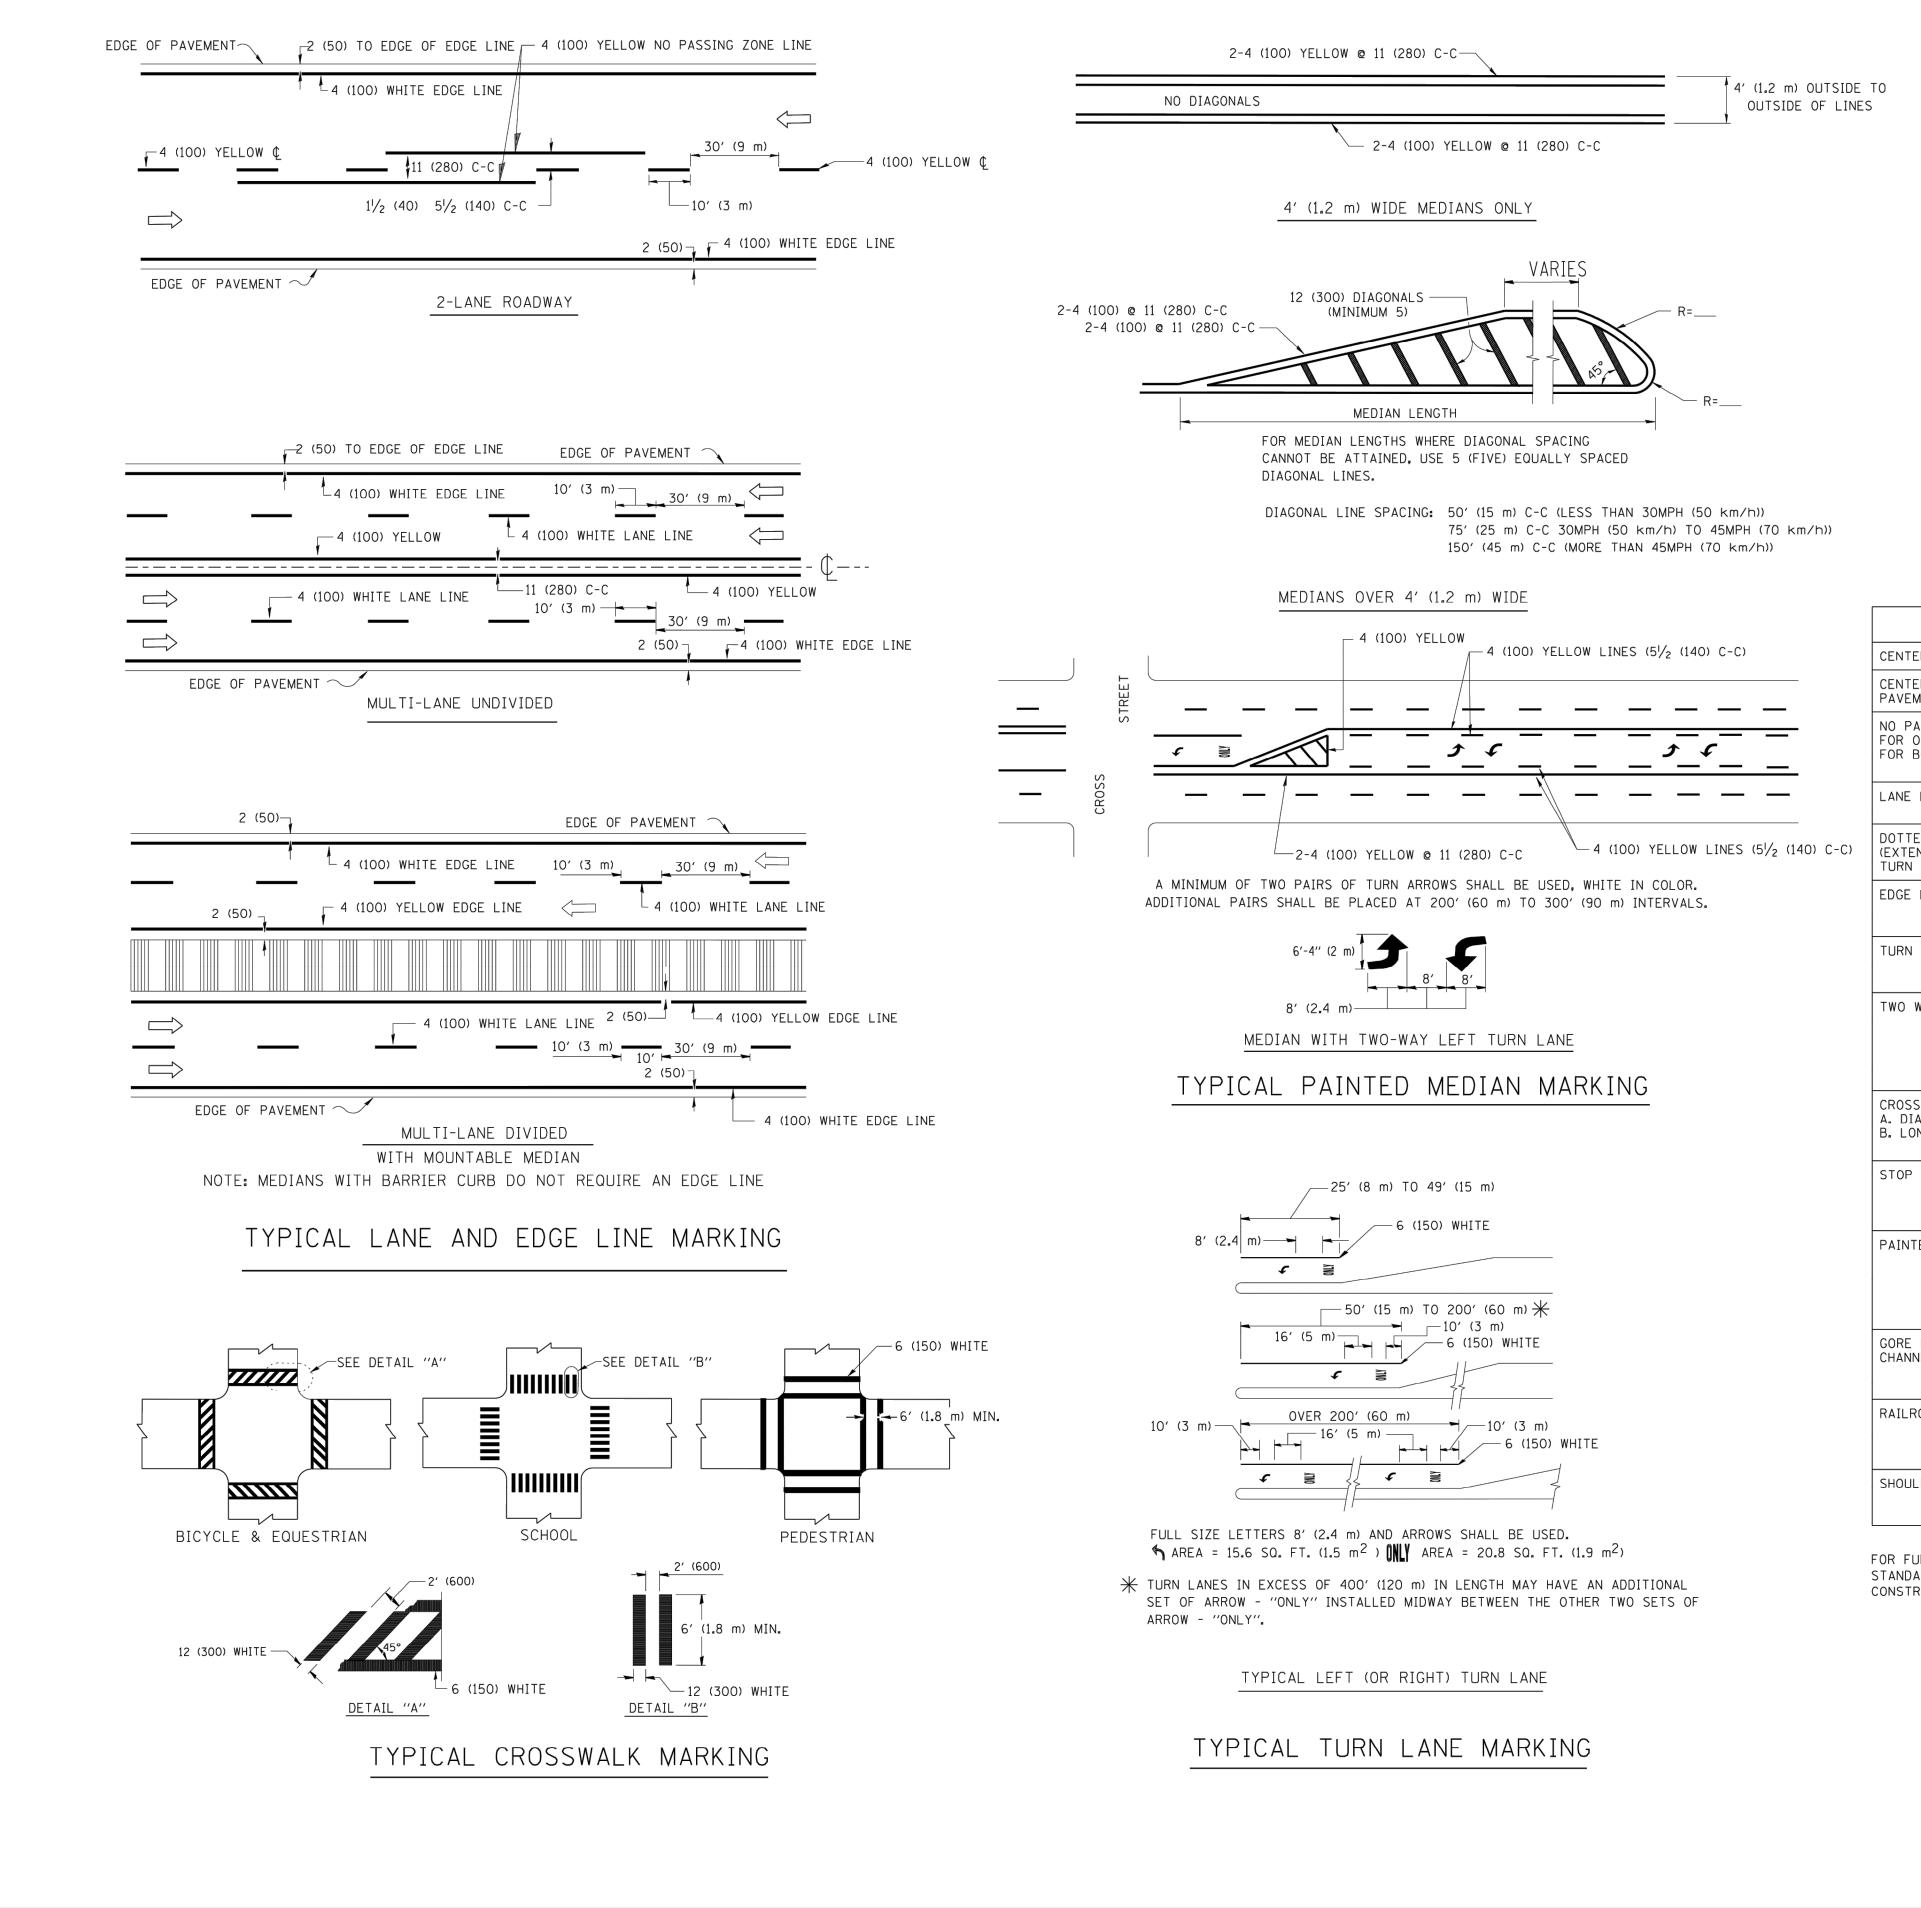
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B. FOR A LANE CLOSURE ON A SIDE ROAD OR DRIVEWAY:
USE APPLICABLE PORTIONS OF THE TYPICAL APPLICATION OF TRAFFIC
CONTROL DEVICES (STD. 701501, STD. 701606 OR THE APPROPRIATE STANDARD).
THE SPACING OF SIGNS AND BARRICADES SHALL BE ADJUSTED FOR FIELD
CONDITIONS AS DIRECTED BY THE ENGINEER. THE DIRECTIONAL ARROW
SHALL BE COVERED OR REMOVED WHEN NO LONGER CONSISTENT WITH THE
SIDE ROAD LANE CLOSURE.

## All dimensions are in millimeters (inches)
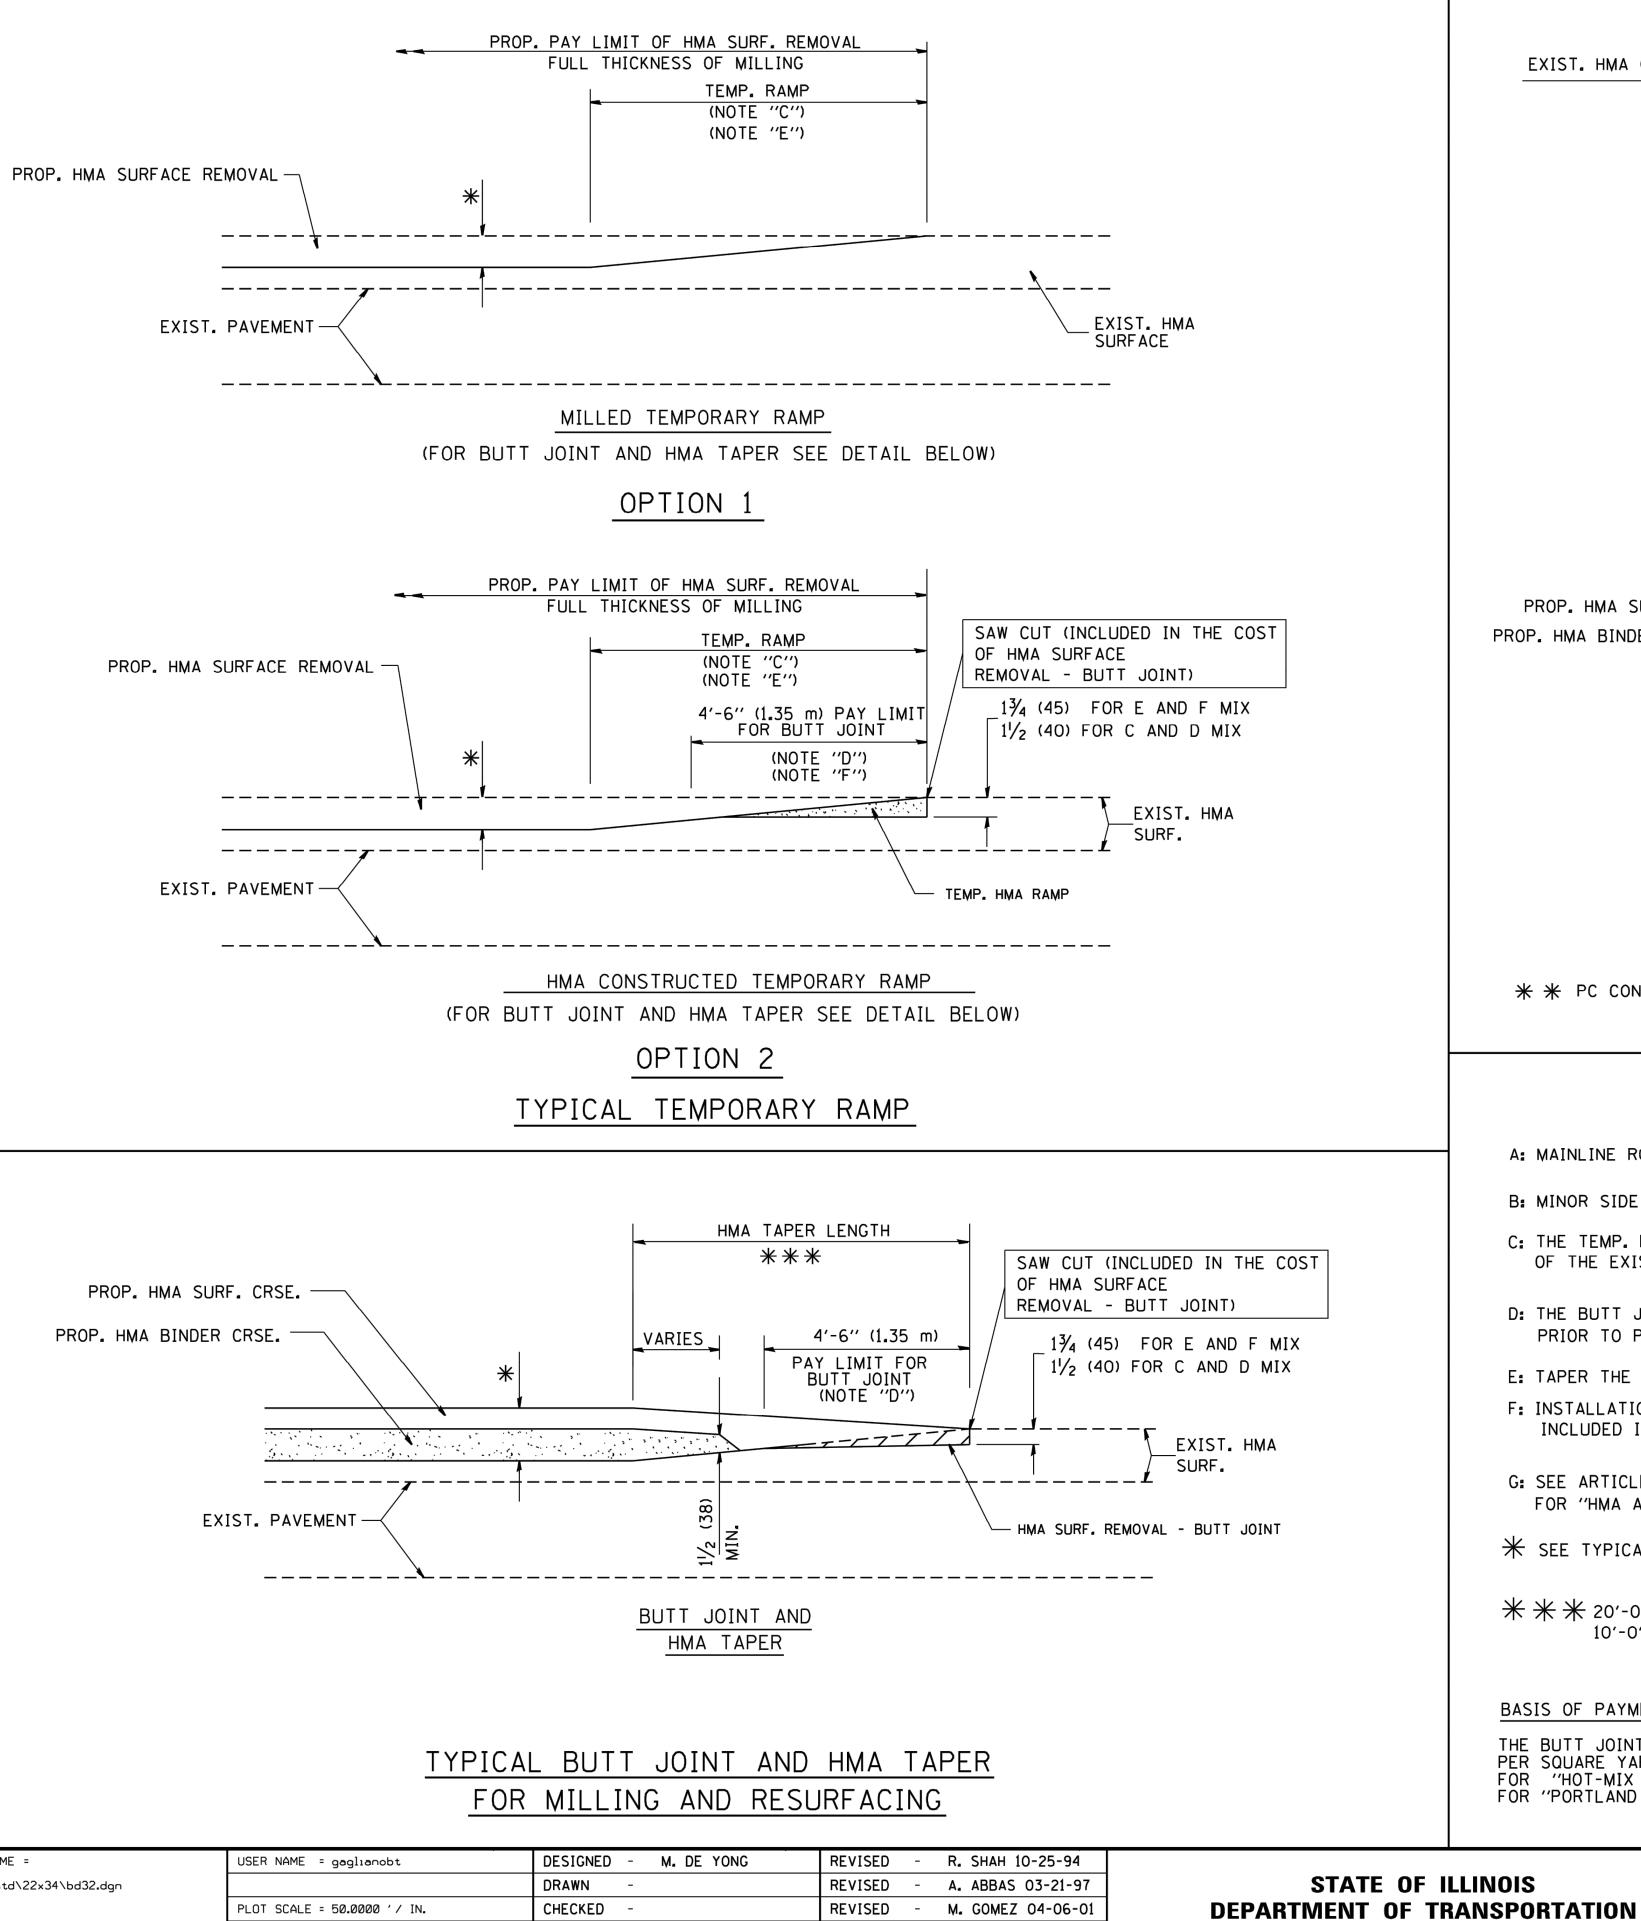
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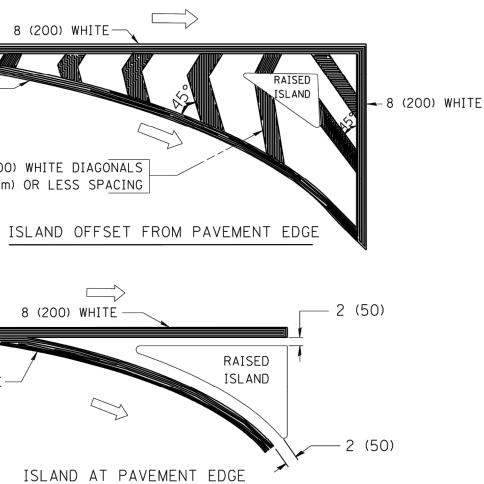
	300) WHITE DIAGONAL 3 m) OR LESS SPACIN
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	8 (200) WHITE —
8 (200) WHI	
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ARKING	WIDTH OF LIN

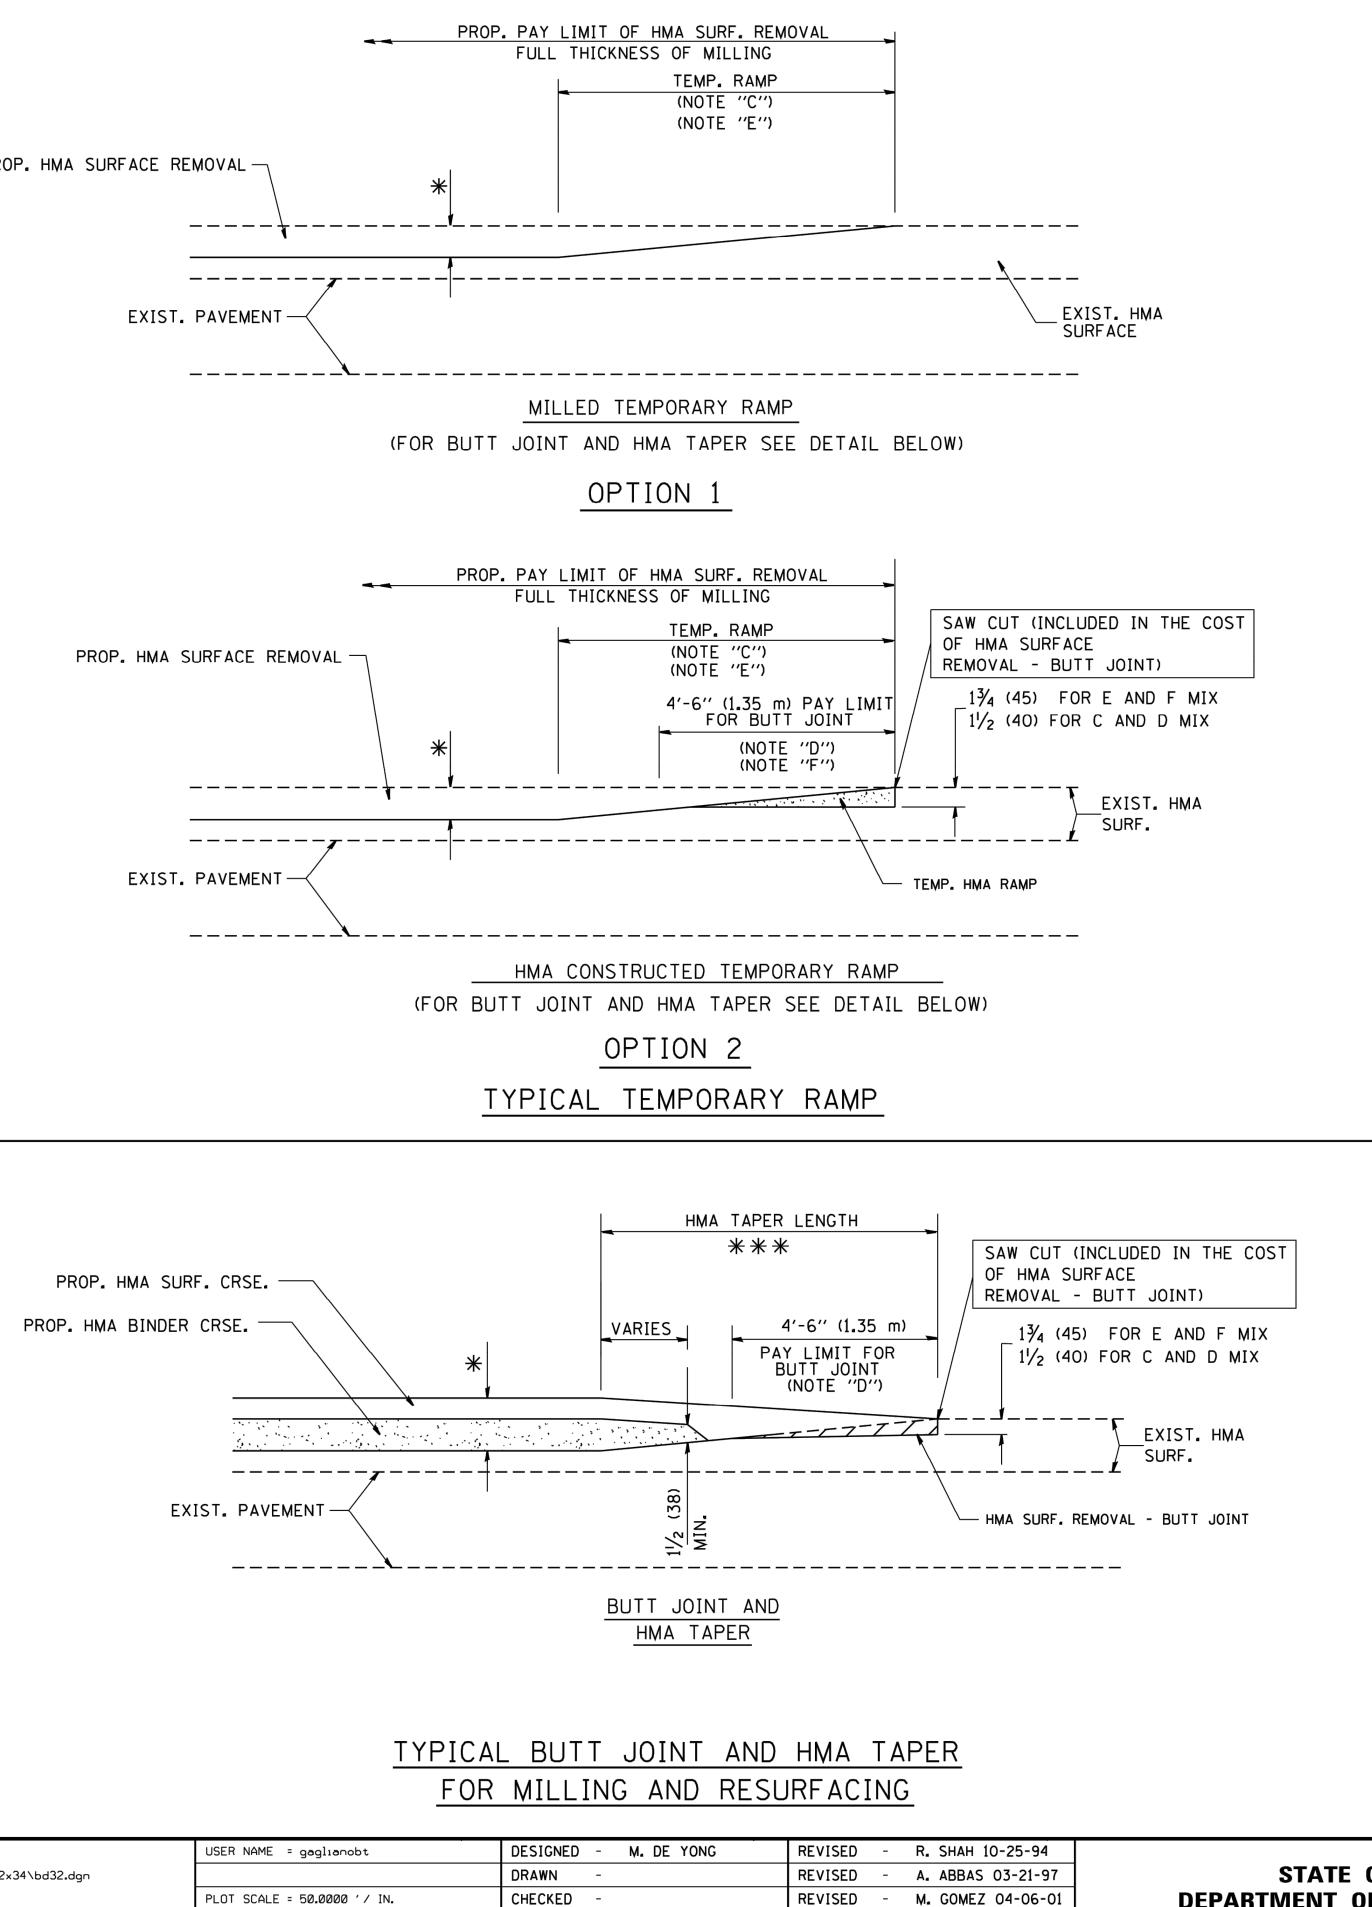8 (200) WHIT

TYPE OF MARKING	WIDTH OF LINE	PATTERN	COLOR	SPACING / REMARKS
CENTERLINE ON 2 LANE PAVEMENT	4 (100)	SKIP-DASH	YELLOW	10' (3 m) LINE WITH 30' (9 m) SPACE
CENTERLINE ON MULTI-LANE UNDIVIDED PAVEMENT	2 @ 4 (100)	SOLID	YELLOW	11 (280) C-C
NO PASSING ZONE LINES: FOR ONE DIRECTION FOR BOTH DIRECTIONS	4 (100) 2 @ 4 (100)	SOLID SOLID	YELLOW YELLOW	5 <sup>1</sup> /2 (140) C-C FROM SKIP-DASH CENTERLINE 11 (280) C-C OMIT SKIP-DASH CENTERLINE BETWEEN
LANE LINES	4 (100) 5 (125) ON FREEWAYS	SKIP-DASH SKIP-DASH	WHITE WHITE	10' (3 m) LINE WITH 30' (9 m) SPACE
DOTTED LINES (EXTENSIONS OF CENTER, LANE OR TURN LANE MARKINGS)	SAME AS LINE BEING EXTENDED	SKIP-DASH	SAME AS LINE BEING EXTENDED	2' (600) LINE WITH 6' (1.8 m) SPACE
EDGE LINES	4 (100)	SOLID	YELLOW-LEFT WHITE-RIGHT	OUTLINE MOUNTABLE MEDIANS IN YELLOW; EDGE LINES ARE NOT USED NEXT TO BARRIER CURB
TURN LANE MARKINGS	6 (150) LINE; FULL SIZE LETTERS & SYMBOLS (8' (2.4m))	SOLID	WHITE	SEE TYPICAL TURN LANE MARKING DETAIL
TWO WAY LEFT TURN MARKING	2 @ 4 (100) EACH DIRECTION	SKIP-DASH AND SOLID	YELLOW	10' (3 m) LINE WITH 30' (9 m) SPACE FOR SKIP-DASH; 51/2 (140) C-C BETWEEN SOLID LINE AND SKIP-DASH LINE
	8' (2.4m) LEFT ARROW	IN PAIRS	WHITE	SEE TYPICAL TWO-WAY LEFT TURN MARKING DETAIL
CROSSWALK LINES (PEDESTRIAN) A. DIAGONALS (BIKE & EQUESTRIAN) B. LONGITUDINAL BARS (SCHOOL)	2 @ 6 (150) 12 (300) @ 45° 12 (300) @ 90°	SOLID SOLID SOLID	WHITE WHITE WHITE	NOT LESS THAN 6' (1.8 m) APART 2' (600) APART 2' (600) APART SEE TYPICAL CROSSWALK MARKING DETAILS.
STOP LINES	24 (600)	SOLID	WHITE	PLACE 4' (1.2 m) IN ADVANCE OF AND PARALLEL TO CROSSWALK, IF PRESENT. OTHERWISE, PLACE AT DESIRED STOPPING POINT. PARALLEL TO CROSSROAD CENTERLINE, WHERE POSSIBLE
PAINTED MEDIANS	2 @ 4 (100) WITH 12 (300) DIAGONALS @ 45° NO DIAGONALS USED FOR 4' (1.2 m) WIDE MEDIANS	SOLID	YELLOW: TWO WAY TRAFFIC WHITE: ONE WAY TRAFFIC	11 (280) C-C FOR THE DOUBLE LINE SEE TYPICAL PAINTED MEDIAN MARKING.
GORE MARKING AND CHANNELIZING LINES	8 (200) WITH 12 (300) DIAGONALS @ 45°	SOLID	WHITE	DIAGONALS: 15' (4.5 m) C-C (LESS THAN 30MPH (50 km/h)) 20' (6 m) C-C 30MPH (50 km/h) TO 45MPH (70 km/h)) 30' (9 m) C-C (OVER 45MPH (70 km/h))
RAILROAD CROSSING	24 (600) TRANSVERSE LINES; "RR" IS 6' (1.8 m) LETTERS; 16 (400) LINE FOR "X"	SOLID	WHITE	SEE STATE STANDARD 780001 AREA OF: "R"=3.6 SQ. FT. (0.33 m <sup>2</sup> ) EACH "X"=54.0 SQ. FT. (5.0 m <sup>2</sup> )
SHOULDER DIAGONALS	12 (300) @ 45°	SOLID	WHITE - RIGHT YELLOW - LEFT	50' (15 m) C-C (LESS THAN 30MPH (50 km/h)) 75' (25 m) C-C (30 MPH (50 km/h) TO 45MPH (70 km/h)) 150' (45 m) C-C (OVER 45MPH (70 km/h))

FOR FURTHER DETAILS ON PAVEMENT MARKING REFER TO STANDARD SPECIFICATIONS FOR ROAD AND BRIDGE CONSTRUCTION AND STATE STANDARD 780001.


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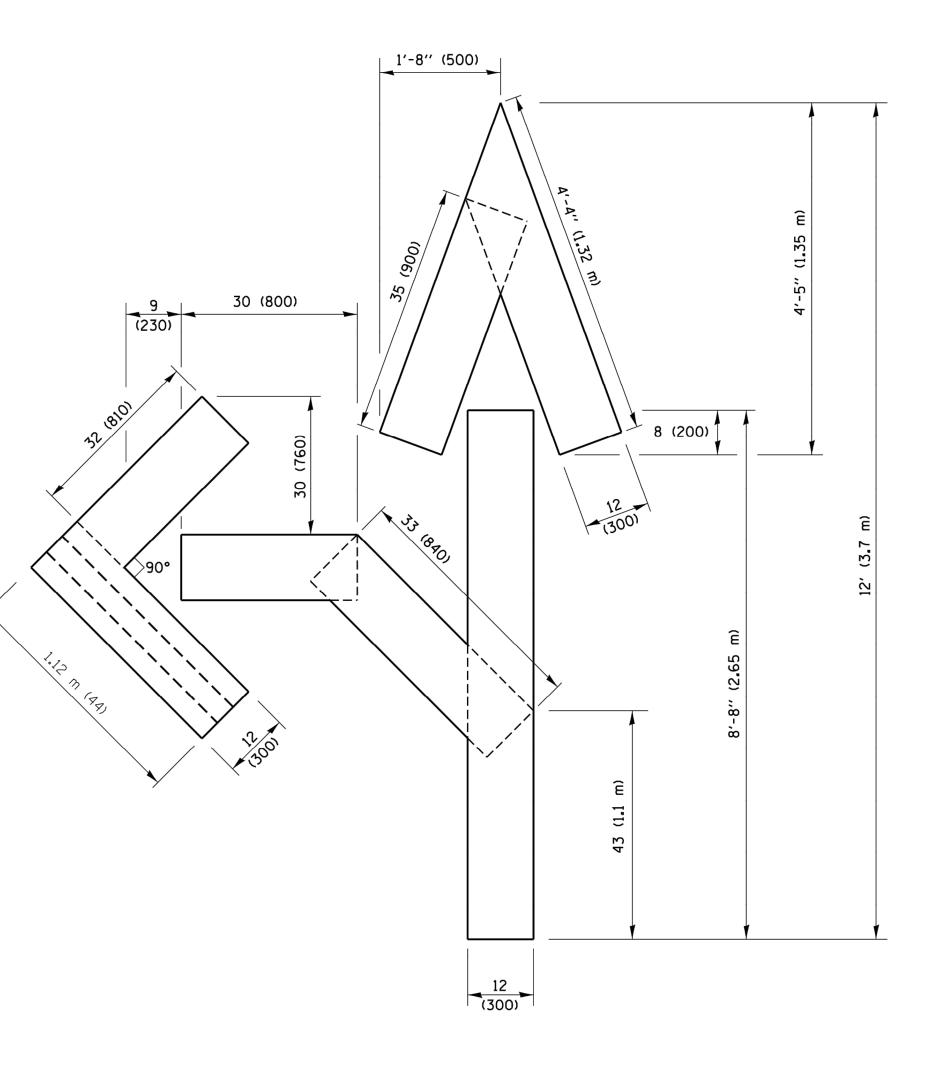
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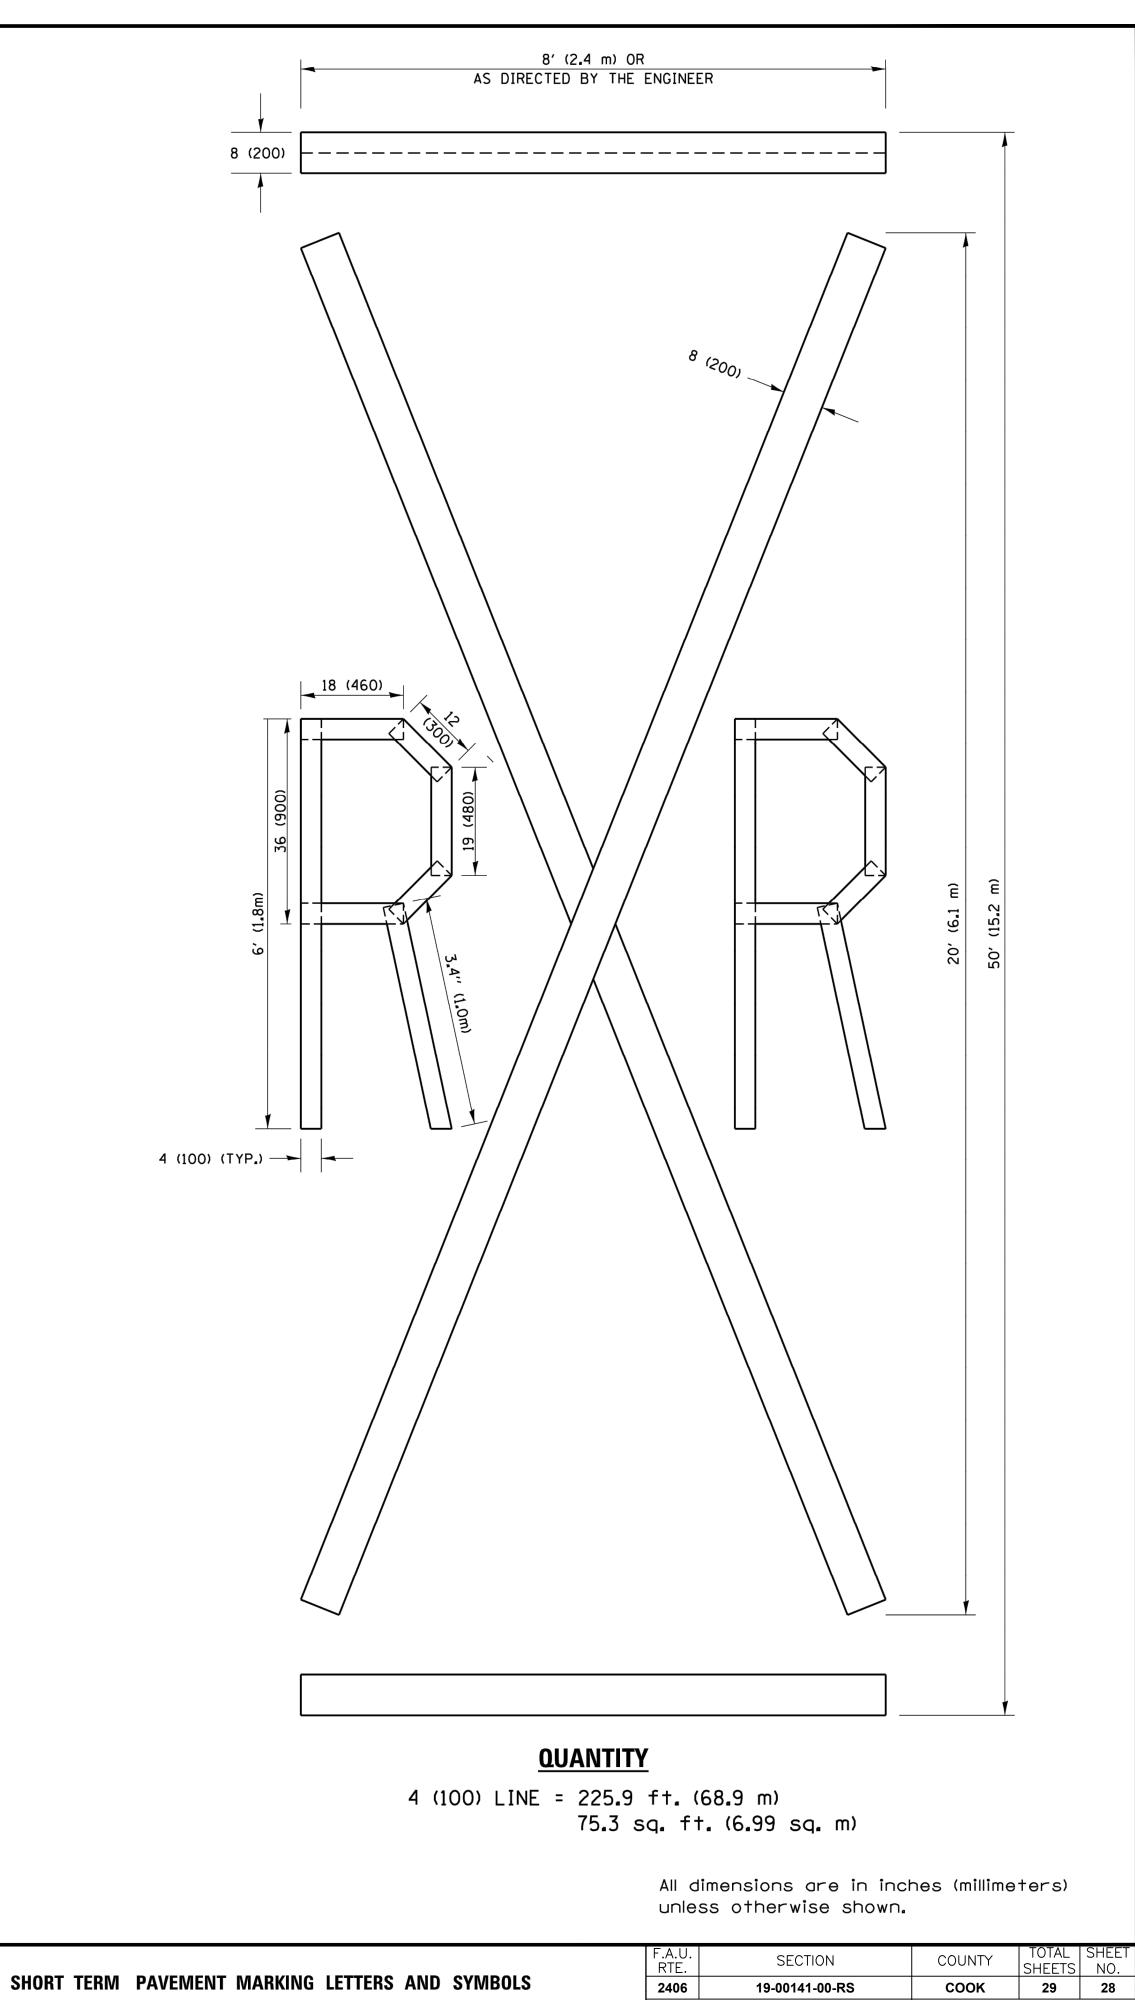
All dimensions are in inches (millimeters) unless otherwise shown.

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			TC-13		CONTRACT	NO. 6'	1F93
		FED. F	ROAD DIST. NO. 1	ILLINOIS	FED. AID PRO	)JECT	



REVISED -T. RAMMAG pw:\\IL084EBIDINTEG.1ll1no1s.gov:PWIDOT\Documents\IDOT Offices\District 1\Projects\Dist<mark>3t@RAWM</mark>\CADData\CADsheets\tc16.dgn REVISED - E. GOMEZ REVISED - E. GOMEZ CHECKED PLOT SCALE = 50.0000 '/ in. REVISED - A. SCHUE DATE - 09-18-94 PLOT DATE = 9/15/2016



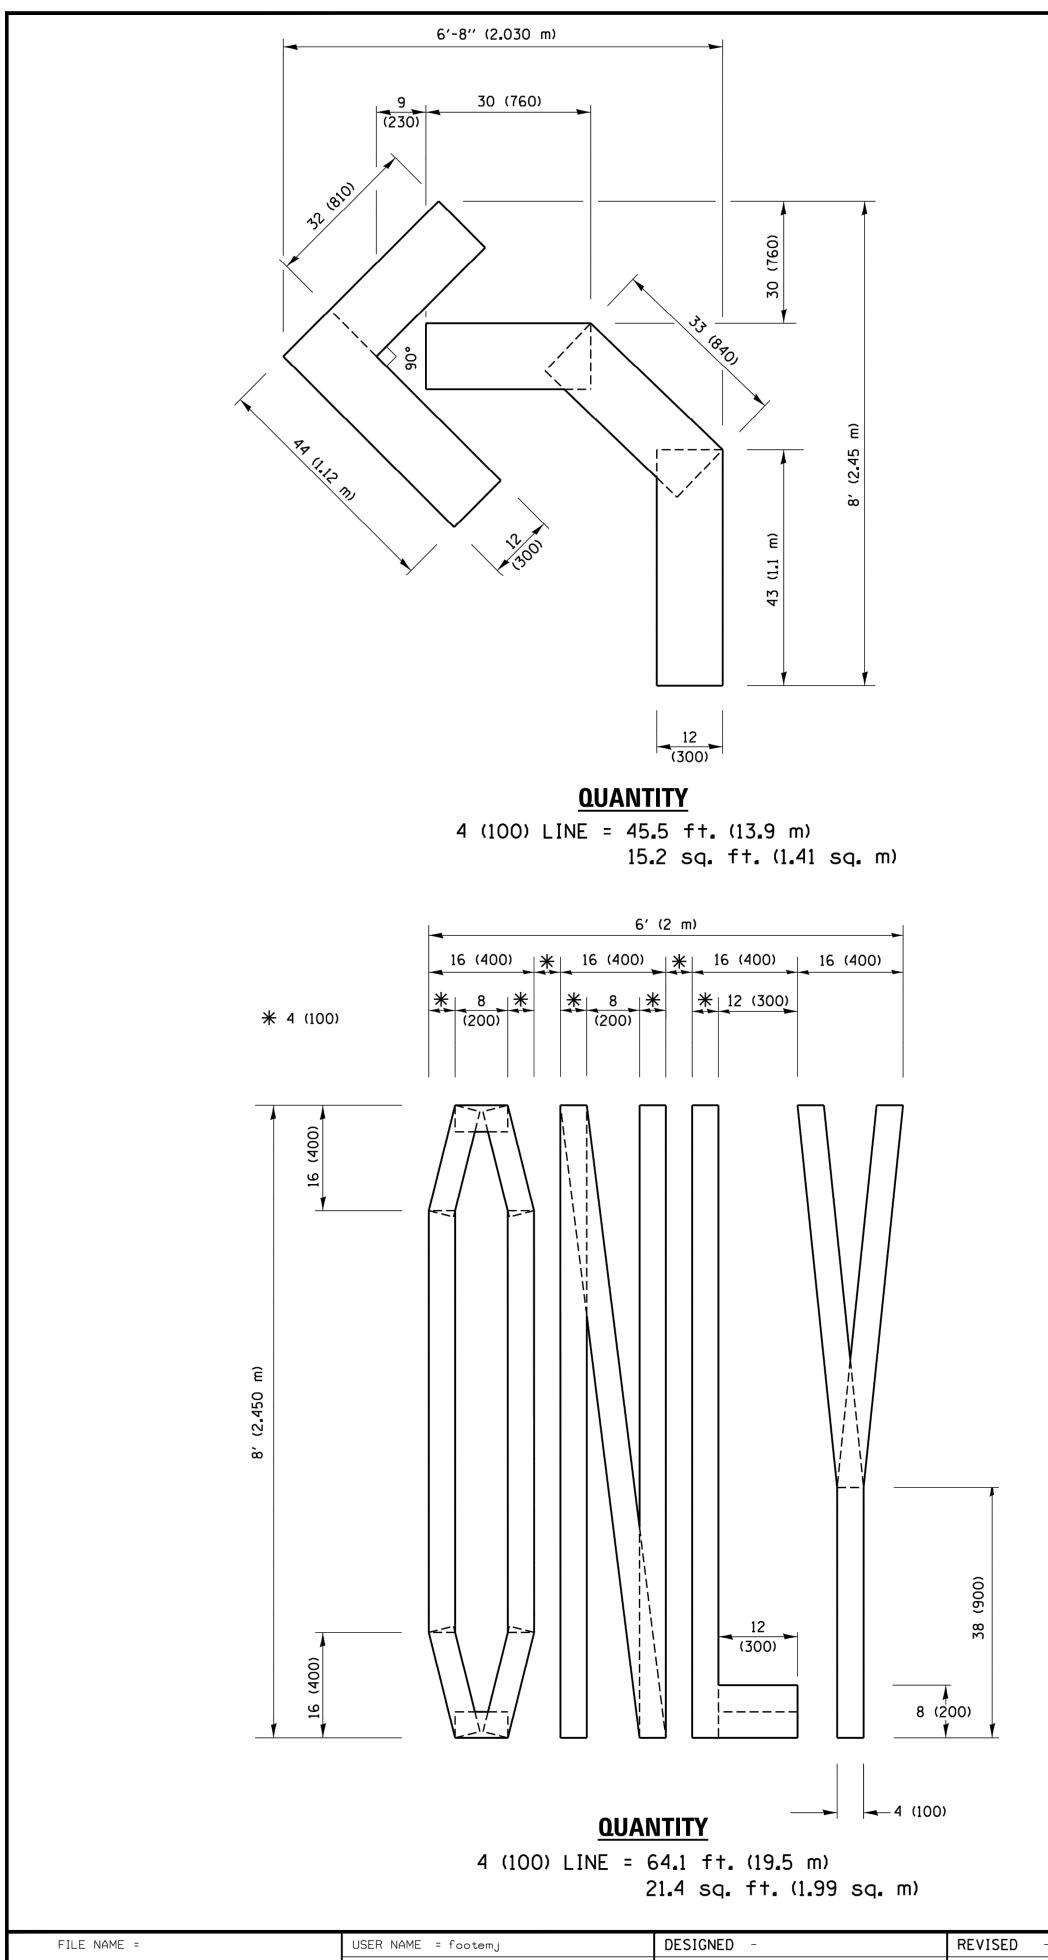

#### <u>QUANTITY</u>

4 (100) LINE = 82.5 ft. (25.1 m) 27.5 sq. ft. (2.53 sq. m)


#### NOTE:

ALL QUANTITIES OF PLACEMENT ARE REPRESENTED IN LINEAR FEET OF 4" LINES TO MATCH THE 4" TEMPORARY TAPE PAY ITEM AND REPRESENTS THE TOTAL QUANTITY OF 4" TAPE REQUIRED.

CHER 03-02-98	
08-28-00	
08-28-00	
TZE 09-15-16	

STATE OF ILLINOIS DEPARTMENT OF TRANSPORTATION

FILE NAME =	USER NAME = gaglianobt	DESIGNED -	REVISED - R. MIRS
W:\diststd\22x34\tc22.dgn		DRAWN -	REVISED - R. MIRS
	PLOT SCALE = 50.000 ′ / IN.	CHECKED -	REVISED - T. RAMMAC
	PLOT DATE = 1/4/2008	DATE -	REVISED - C. JUC

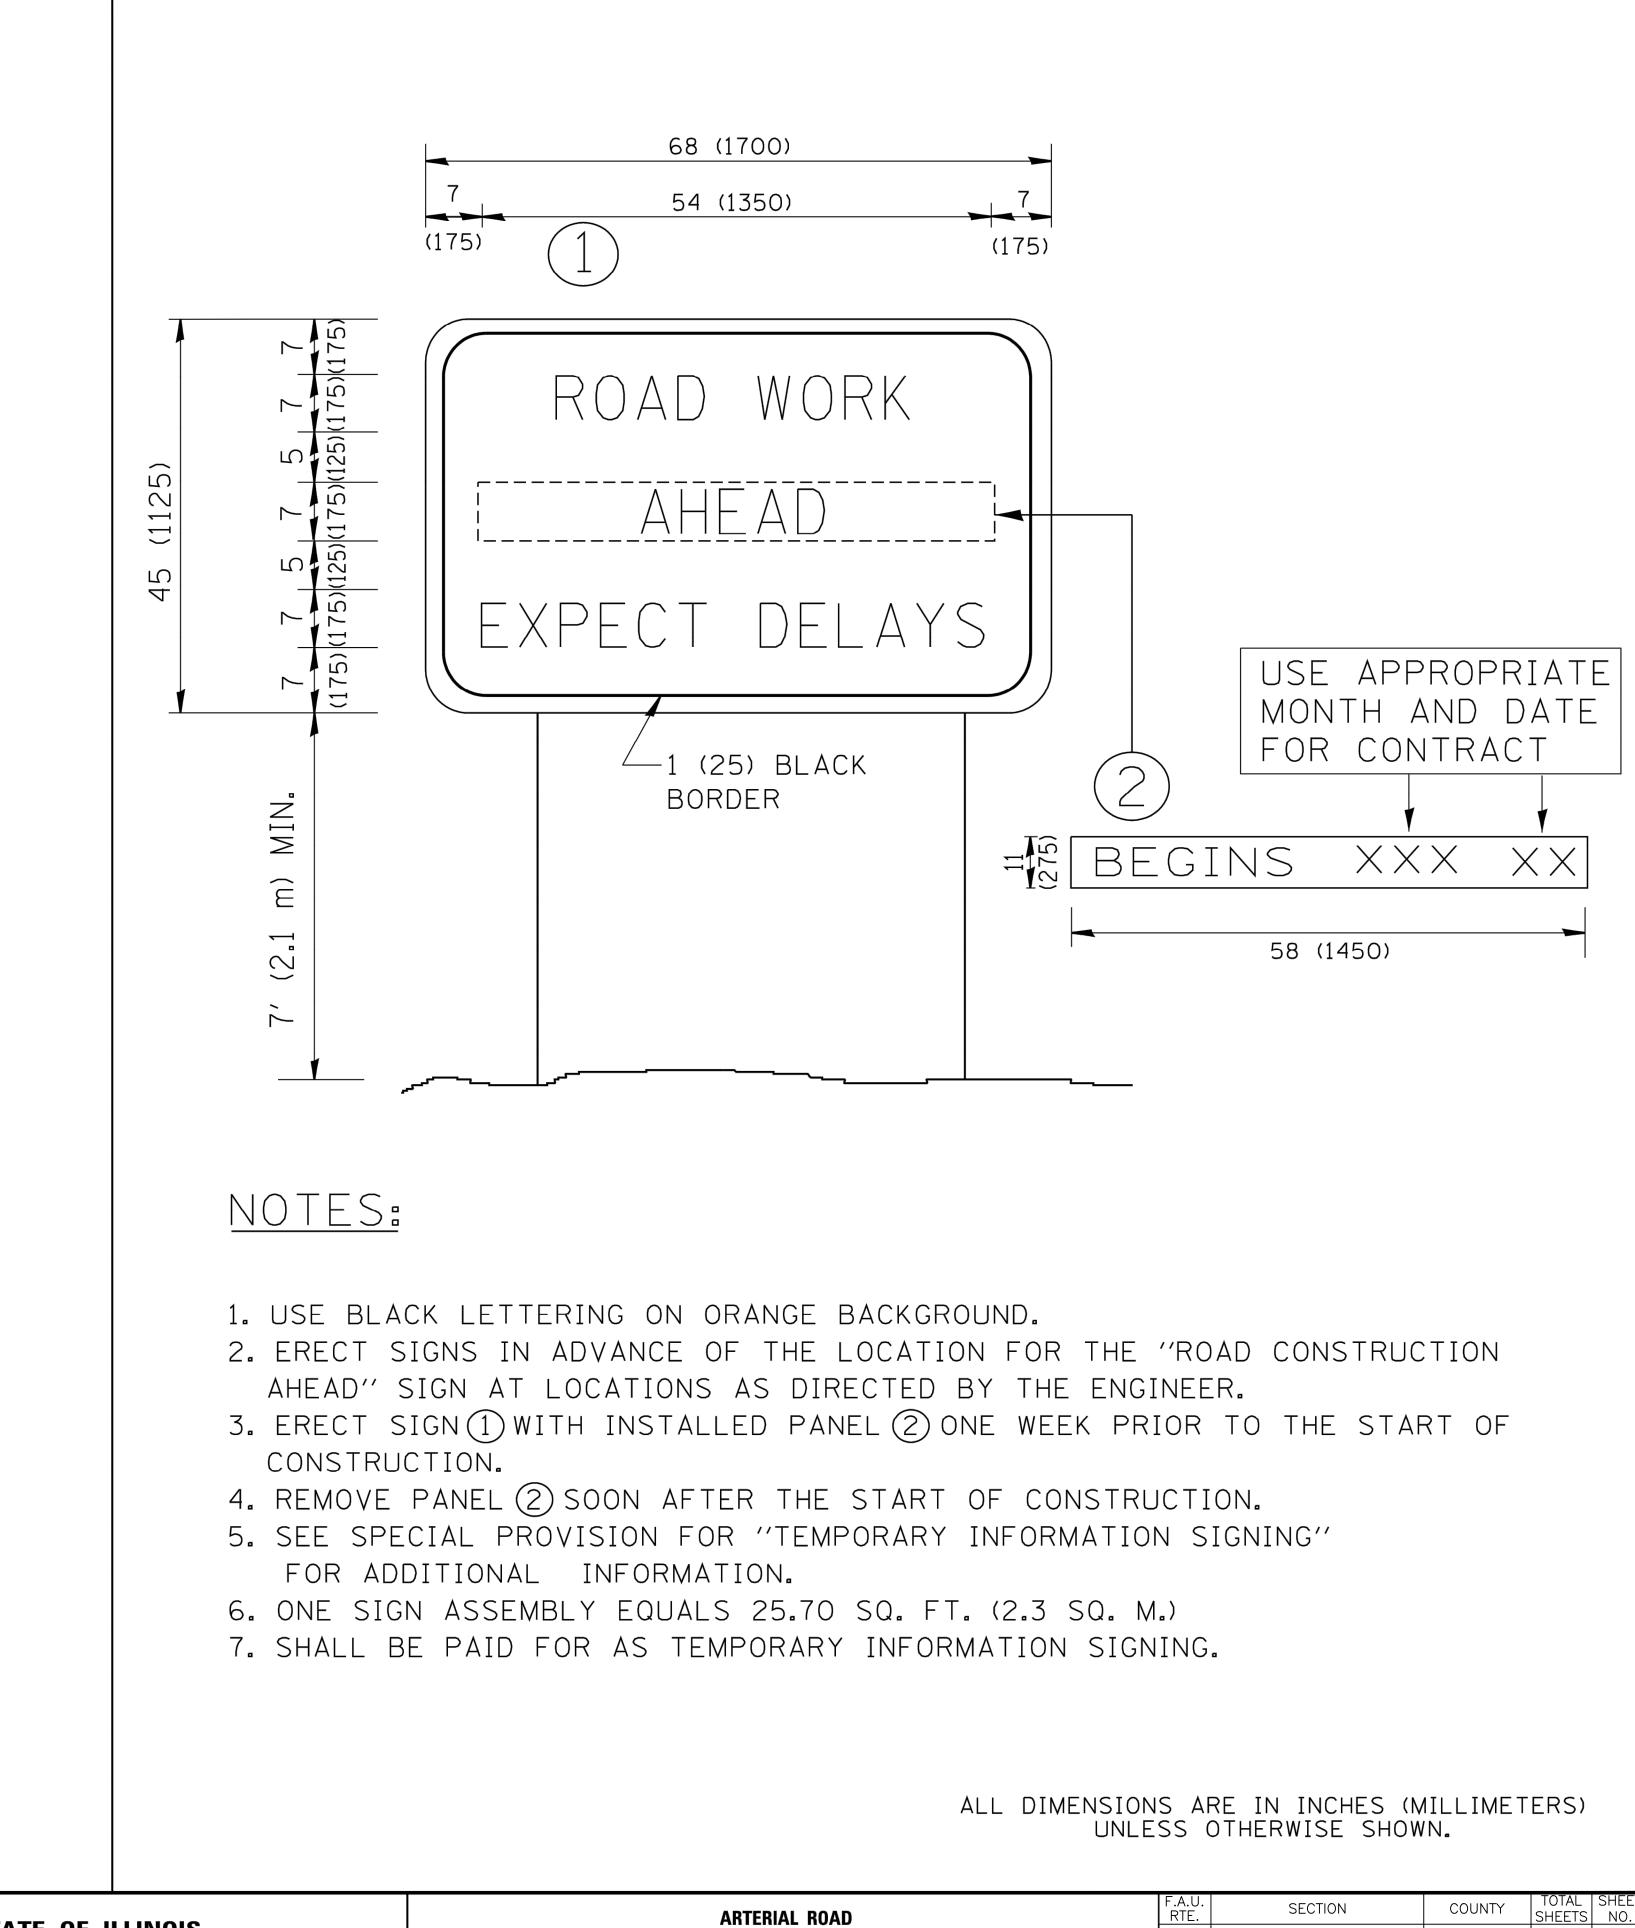

RS 09-15-97					
RS 12-11-97					
ACHER 02-02-99					
CIUS 01-31-07					

AD L		F.A.U. RTE.		SECTION		COL	JNTY	TOTAL SHEETS	SHEET
		2406		19-00141-00-RS		СО	ок	29	29
				TC-22		CONT	RACT	NO. 6	1F93
STA.	TO STA.	FED.	ROAD	DIST. NO. 1	ILLINOIS	FED. A	ID PRO	JECT	