STATE OF ILLINOIS

DEPARTMENT OF TRANSPORTATION

PROPOSED

HIGHWAY PLANS

FAI ROUTE 90/94: I-90/94 (KENNEDY EXPRESSWAY)

OHIO FEEDER AT MILWAUKEE AVENUE

D-91-162-19

STATE OF ILLINOIS

SUBMITTED JUNE 24 2019

LOCATION OF SECTION INDICATED THUS: - -

PRINTED BY THE AUTHORITY OF THE STATE OF ILLINOIS

IMPROVEMENT IS LOCATED IN THE

FOR INDEX OF SHEETS, SEE SHEET NO. 2

TRAFFIC DATA:

0

0

0

OHIO FEEDER 2018 ADT = 92.000

SECTION: 2019-040-BR PROJECT: **BRIDGE REPAIRS (SUBSTRUCTURE REPAIRS) COOK COUNTY**

C-91-373-19

IMPROVEMENT LOCATION: OHIO FEEDER AT N. MILWAUKEE AVE. SN: 016-1094 R 14 E Saint John Q Grand W Grand Ave FULTON RIVER

WEST CHICAGO TOWNSHIP

CITY OF CHICAGO

I-90/94 (KENNEDY EXPWY.) 2018 ADT = 292.200POSTED SPEED LIMIT = 55MPH

POSTED SPEED LIMIT = 55MPH

C.U.A.N. CHICAGO UTILITY ALERT NETWORK 1-312-744-7000

PROJECT ENGINEER: J. ALAIN MIDY (847) 221-3056 PROJECT MANAGER: FAWAD AQUEEL (847) 705-4247

CONTRACT NO. 62J18

INDEX OF SHEETS

- 1. TITLE SHEET
- 2. INDEX OF SHEETS, STATE STANDARDS AND GENERAL NOTES
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- 5. STAGING TYPICAL SECTIONS
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- 10-14. BRIDGE PLANS (SN 016-1094)
- 15-19. ELECTRICAL RELOCATION PLANS
- 20. ENTRANCE AND EXIT RAMP CLOSURE DETAILS (TC-08)
- 21. TRAFFIC CONTROL DETAILS FOR FREEWAY SINGLE AND MULTI-LANE WEAVE (TC-09)
- 22-23. MULTI-LANE FREEWAY PAVEMENT MARKING DETAIL (TC-12)
- 24. TRAFFIC CONTROL FOR FREEWAY SHOULDER CLOSURES AND PARTIAL RAMP CLOSURES (TC-17)
- 25. FREEWAY/EXPRESSWAY SIGNING FOR FLAGGING OPERATIONS AT WORK ZONE OPENINGS ON FREEWAYS/EXPRESSWAYS (TC-18)

STATE STANDARDS

STANDARD NO. DESCRIPTION

- 643001-02 SAND MODULE IMPACT ATTENUATORS
- 701106-02 OFF-ROAD OPERATIONS, MULTILANE, MORE THAN 15' (4.5 M) AWAY
- 701400-09 APPROACH TO LANE CLOSURE, FREEWAY/EXPRESSWAY
- 701401-12 LANE CLOSURE, FREEWAY/EXPRESSWAY
- 701411-09 LANE CLOSURE, MULTI-LANE, TRAFFIC CONTROL AT ENTRANCE OR EXIT RAMP, FOR SPEEDS >=45 MPH
- 701428-01 TRAFFIC CONTROL SETUP AND REMOVAL FREEWAY/EXPRESSWAY
- 701446-09 TWO LANE CLOSURE, FREEWAY/EXPRESSWAY
- 701901-08 TRAFFIC CONTROL DEVICES
- 704001-08 TEMPORARY CONCRETE BARRIER
- 782006 GUARDRAIL & BARRIER WALL REFLECTOR MOUNTING DETAILS

GENERAL NOTES

- BEFORE STARTING ANY EXCAVATION, THE CONTRACTOR SHALL CALL "C.U.A.N." AT (312) 744-7000 FOR FIELD LOCATIONS OF BURIED ELECTRIC, TELEPHONE AND GAS UTILITIES. 48 HOUR NOTIFICATION IS REQUIRED.
- THE CONTRACTOR SHALL COORDINATE CONSTRUCTION ACTIVITIES WITH UTILITY COMPANIES. AND THE CITY OF CHICAGO.
- 3. PLAN DIMENSIONS AND DETAILS RELATIVE TO EXISTING PLANS ARE SUBJECT TO NOMINAL CONSTRUCTION VARIATIONS. THE CONTRACTOR SHALL FIELD VERIFY EXISTING DIMENSIONS AND DETAILS AFFECTING NEW CONSTRUCTION AND MAKE NECESSARY APPROVED ADJUSTMENTS PRIOR TO CONSTRUCTION OR ORDERING OF MATERIALS, SUCH VARIATIONS SHALL NOT BE CAUSE FOR ADDITIONAL COMPENSATION FOR A CHANGE IN SCOPE OF THE WORK, HOWEVER, THE CONTRACTOR WILL BE PAID FOR THE QUANTITY ACTUALLY FURNISHED BASED AT THE UNIT PRICE BID FOR THE WORK.
- 4. THE CONTRACTOR WILL NOT BE ALLOWED TO SET UP A YARD OR FIELD OFFICE ON STATE PROPERTY WITHOUT WRITTEN PERMISSION FROM THE DEPARTMENT.
- THE CONTRACTOR SHALL CONTACT THE DISTRICT ONE TRAFFIC CONTROL SUPERVISOR AT (847) 705-4151 FOR EXPRESSWAYS A MINIMUM OF 72 HOURS IN ADVANCE OF BEGINNING WORK.
- 6. THE CONTRACTOR SHALL REQUEST AND GAIN APPROVAL FROM THE ILLINOIS
 DEPARTMENT OF TRANSPORATION'S EXPRESSWAY TRAFFIC OPERATIONS ENGINEER AT
 WWW.IDOTLCS.COM AT LEAST 24 HOURS IN ADVANCE OF ALL DAILY LANE, RAMP AND
 SHOULDER CLOSURES AND 7 DAYS IN ADVANCE OF ALL PERMANENT AND WEEKEND
 CLOSURES ON ALL FREEWAYS AND/OR EXPRESSWAYS. THIS ADVANCE NOTIFICATION
 IS CALCULATED BASED ON WORKWEEK OF MONDAY THOUGH FRIDAY AND SHALL NOT
 INCLUDE WEEKENDS AND HOLIDAYS.
- 7. THE CONTRACTOR SHALL BE REQUIRED TO PROVIDE ACCESS TO ABUTTING PROPERTY AT ALL TIMES DURING THE CONSTRUCTION OF THIS PROJECT.
- BEFORE BEGINNING ANY WORK, THE CONTRACTOR SHALL RETAIN AND RECORD FOR FUTURE REFERENCE, ALL EXISTING PAVEMENT MARKING LINES (AND RAISED REFLECTIVE PAVEMENT MARKERS) IN ORDER THAT THESE LOCATIONS CAN BE RE-ESTABLISHED FOR STRIPING. EXACT LOCATIONS OF ALL PAVEMENT MARKINGS SHALL BE AS DIRECTED BY THE ENGINEER.
- 9. WHEN ARTIFICIAL LIGHTING IS UTILIZED IN NIGHTTIME OPERATIONS, THE CONTRACTOR SHALL EXERCISE THE UTMOST PRECAUTIONS PREVENTING ADVERSE VISIBILITY TO THE MOTORING PUBLIC AND ADJACENT RESIDENTIAL AREAS.
- 10. THE CONTRACTOR SHALL TAKE NECESSARY PRECAUTIONS WHEN WORKING NEAR THE ABUTMENTS DUE TO ELECTRICAL JUNCTIONS BOXES AND ATTACHED CONDUITS.
- 11. THESE PLANS HAVE BEEN PREPARED FROM NOTES RECEIVED FROM THE BUREAU OF MAINTENANCE BRIDGE INSPECTORS.
- 12. DO NOT SCALE PLANS FOR CONSTRUCTION DIMENSIONS.
- 13. CONTRACTOR SHALL CONTACT IDOT TRAFFIC SYSTEM CENTER AT 708-588-2544 BEFORE PERFORMING ANY WORK.

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STATE OF ILLINOIS	
DEPARTMENT OF TRANSPORTA	NOITA

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	AND	GENERAL	NOTES		94	2019-040-BR	COOK	25	2
	AND	OLIVLIAL	NOILS				CONTRAC	T NO.	62J18
SHEET 1	OF 1	SHEETS	STA.	TO STA.		THE INDIS FED. A	ID PROJECT		

TITLE		SUMMARY OF QUANTITIES				CONSTRUC	TION TYPE C	CODE			SUMMAE	RY OF QUANTITIES				CO	NSTRUCTIO	N TYPE C	ODE	
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PRODUCT PROD											ITPE D - INL	AID - LINE 8"								
Description Description Print (1997) Description Desc	50800205	REINFORCEMENT BARS, EPOXY COATED	POUND	4010	4010															
									,	78004362	PREFORMED PL	ASTIC PAVEMENT MARKING.	FOOT	15	15					
200.00 AIGHTHE WORK 200K LIGHTNE	67000400	ENGINEER'S FIELD OFFICE, TYPE A	CAL MO	6	6						TYPE D - INL	AID - LINE 12"								
200.00 AIGHTHE WORK 200K LIGHTNE																				
200100 SHEET TERM PARKELET MARKING FEMERAL 2497 2497 2497 2497 2497 2497 2497 2497	67100100	MOBILIZATION	L SUM	1	1				k	78100300	REPLACEMENT	REFLECTOR	EACH	10	10					
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Procedure transfers Total 1 1 1 1 1 1 1 1 1																				
100990 PAYEMENT MARING TAME, TYPE IV 4" FOOT 4955 4955 1955	70300150	SHORT TERM PAVEMENT MARKING REMOVAL	SO FT	2457	2457				:	* 81100320	CONDUIT ATTA	CHED TO STRUCTURE, 1" DIA.,	FOOT	200	200					
											PVC COATED G	SALVANIZED STEEL								
200908 PAYEMENT MARRING TAPE, TYPE IV 8" FOOT 947 947 947 947	70300904	PAVEMENT MARKING TAPE, TYPE IV 4"	FOOT	4955	4955															
STATE OF ILLINGS STATE OF IL										* 81100805	CONDUIT ATTA	CHED TO STRUCTURE, 3" DIA.,	FOOT	630	630					
100100 TEMPORARY CONCRETE BARRIER FOOT 350 350	70300908	PAVEMENT MARKING TAPE, TYPE IV 8"	FOOT	947	947						PVC COATED G	GALVANIZED STEEL								
100100 TEMPORARY CONCRETE BARRIER FOOT 350 350																				
1	70300912	PAVEMENT MARKING TAPE, TYPE IV 12"	FOOT	174	174					* 81300530	JUNCTION BOX	, STAINLESS STEEL, ATTACHED	EACH	11	11					
# 81702110 ELECTRIC CABLE IN CONDUIT, 600V F00T 2000 2000											TO STRUCTURE	. 12" X 10" X 6"								
### ##################################	70400100	TEMPORARY CONCRETE BARRIER	FOOT	350	350															
# 89502350 REMOVE AND REINSTALL ELECTRIC CABLE FOOT 1500 1500										* 81702110	ELECTRIC CAB	BLE IN CONDUIT, 600V	FOOT	2000	2000					
REDIRECTIVE, NARROW). TEST LEVEL 3	70400200	RELOCATE TEMPORARY CONCRETE BARRIER	FOOT	150	150						(XLP-TYPE US	E) 1/C NO. 10								
REDIRECTIVE, NARROW). TEST LEVEL 3																			1	
STATE OF ILLINOIS SUMMARY OF QUANTITIES SUMMARY	70600260	IMPACT ATTENUATORS, TEMPORARY (FULLY	EACH	2	2					* 89502350	REMOVE AND R	REINSTALL ELECTRIC CABLE	FOOT	1500	1500					
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REDIRECTIVE), TEST LEVEL 3 BLASTING																				
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TYPE D - INLAID - LINE 5" ** SPECIALTY ITEMS]	REDIRECTIVE), TEST LEVEL 3									BLASTING									
TYPE D - INLAID - LINE 5" ** SPECIALTY ITEMS	78004355	DDEFORMED DIASTIC DAVEMENT MARVING	FOOT	50	50			1												
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	SUMMARY OF QUANTITIES				CC	NSTRUCTION	ON TYPE C	CODE			SUMMA	RY OF QUANTITIES			C	ONSTRUCTION	ON TYPE C	ODE	
CODE NO	ITEM	UNIT	URBAN TOTAL QUANTITIES	100% STATE 016-1094 0013						CODE NO	JUMMA	ITEM	UNIT	QUANTITIES 01	0% STATE 6-1094 0013				
X7011015	TRAFFIC CONTROL AND PROTECTION	L SUM	1	1											0013				
	(EXPRESSWAYS)																		
x7040125	PINNING TEMPORARY CONCRETE BARRIER	EACH	43	43															
W017012F	DEMONE EXICTING HUNGTION DOV	54611		10															
* X8130125	REMOVE EXISTING JUNCTION BOX	EACH	10	10				1											
* X8430100	REMOVE EXISTING CONDUIT ATTACHED TO	FOOT	300	300															
	STRUCTURE																		
Z0012754	STRUCTURAL REPAIR OF CONCRETE (DEPTH	SO FT	2139	2139															
	EQUAL TO OR LESS THAN 5 INCHES)																		
Z0012755	STRUCTURAL REPAIR OF CONCRETE (DEPTH	SO FT	72	72															
	GREATER THAN 5 INCHES)																		
								<u> </u>										1	
* Z0033028	MAINTENANCE OF LIGHTING SYSTEM	CAL MO	2	2															
Z0073200	TEMPORARY SHORING AND CRIBBING	EACH	11	11															
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											* SPECIALTY	ITEMS							<u> </u>
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MAINTENANCE OF TRAFFIC GENERAL NOTES


- 1. THE SUGGESTED STAGES OF CONSTRUCTION AND TRAFFIC CONTROL PLANS SHALL SERVE AS A GUIDE FOR SAFE DIVERSION OF TRAFFIC DURING EXECUTION OF THIS CONTRACT. HOWEVER, THE CONTRACTOR MAY IMPROVE OR MODIFY THE TRAFFIC CONTROL PLANS TO MEET CONSTRUCTION NEEDS BUT NOT AT THE EXPENSE OF PUBLIC SAFETY OR CONVENIENCE. ANY CHANGES TO THE TRAFFIC CONTROL PLAN SHALL BE SUBMITTED TO THE ENGINEER FOR APPROVAL.
- 2. THE CONTRACTOR SHALL BE REQUIRED TO MAINTAIN TRAFFIC IN ACCORDANCE WITH THE TRAFFIC CONTROL PLANS, SPECIAL PROVISIONS, APPLICABLE STATE STANDARDS, AND AS DIRECTED BY THE ENGINEER.
- 3. THE CONTRACTOR SHALL MAINTAIN A MINIMUM OF TWO THROUGH LANES IN EACH DIRECTION THROUGH OUT THE PROJECT AREA AT ALL TIMES.
- 4. THE CONTRACTOR SHALL FOLLOW THE SPECIAL PROVISION 'LIGHTS ON BARRICADES'.
- 5. ALL EXISTING SIGNS THAT CONFLICT WITH THE TRAFFIC CONTROL PLAN SHALL BE COVERED OR REMOVED IN ACCORDANCE WITH ARTICLE 107.25 OF THE STANDARD SPECIFICATIONS.
- 6. THE CONTRACTOR SHALL PROVIDE, INSTALL, MAINTAIN AND REMOVE ALL SIGNS AND SIGN SUPPORTS REQUIRED FOR TRAFFIC CONTROL AND PROTECTION.
- 7. ONE MONO-DIRECTIONAL FLASHING AMBER BEACON SHALL BE MOUNTED TO THE FIRST TWO WARNING SIGNS ON EACH APPROACH. THE FLASHING AMBER BEACON SHALL BE OPERATIONAL DURING HOURS OF
- 8. ALL TEMPORARY CONCRETE BARRIER WALL AND TEMPORARY IMPACT ATTENUATORS MUST BE SEATED ON BARE, CLEAN PAVEMENT OR PAVED SHOULDER.
- 9. THE TRAFFIC SIGNAL ENGINEER SHALL BE INFORMED 48 HOURS IN ADVANCE OF ANY CHANGE TO THE SUGGESTED STAGES OF CONSTRUCTION AND TRAFFIC CONTROL PLANS.
- 10. THE CONTRACTOR SHALL CONTACT THE IDOT D1 TRAFFIC CONTROL SUPERVISOR AT (847) 705-4157 A MINIMUM OF 72 HOURS IN ADVANCE OF BEGINNING WORK.

SUGGESTED STAGES OF CONSTRUCTION SEQUENCE

ESTABLISH TRAFFIC CONTROL AND PROTECTION IN ACCORDANCE WITH THE SUGGESTED MAINTENANCE OF TRAFFIC CONTROL PLANS. CONSTRUCT SUBSTRUCTURE REPAIRS ON SOUTH ABUTMENT AND NORTH PIER OF THE MILWAUKEE BRIDGE.


ESTABLISH TRAFFIC CONTROL AND PROTECTION IN ACCORDANCE WITH THE SUGGESTED MAINTENANCE OF TRAFFIC CONTROL PLANS. CONSTRUCT SUBSTRUCTURE REPAIRS ON SOUTH PIER OF MILWAUKEE BRIDGE.

INSTALL PERMANENT PAVEMENT MARKINGS AND REFLECTORS, PERFORM CLEAN UP AND PUNCH LIST ITEMS.

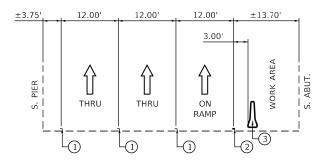

STAGE | E.B. – MILWAUKEE

(LOOKING EAST)

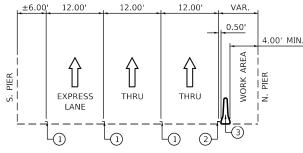

STAGE I W.B. - MILWAUKEE

(LOOKING WEST)

±18.00' 12.00' 12.00' ±8.30' 3.00 THRU

STAGE II W.B. – MILWAUKEE

(LOOKING WEST)

LEGEND

- 1) EX PAVEMENT MARKING
- 2 PR TEMP PAVEMENT MARKING
- 3 PR TEMP CONC BARRIER


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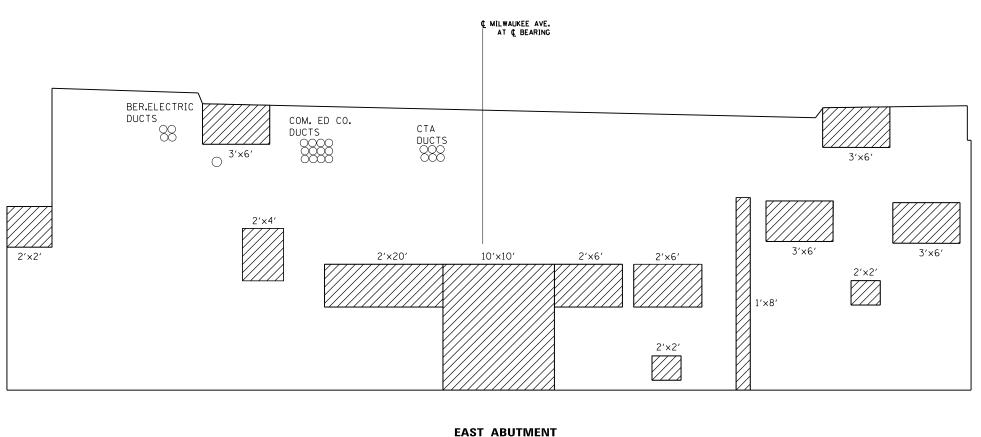
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STATE OF ILLINOIS **DEPARTMENT OF TRANSPORTATION**

TRAFFIC CONTROL STAGING NOTES AND STAGING TYPICAL SECTIONS SCALE: 1" = 10' SHEET 1 OF 1 SHEETS STA.

SECTION 94 2019-040-BR COOK 25 CONTRACT NO. 62J18



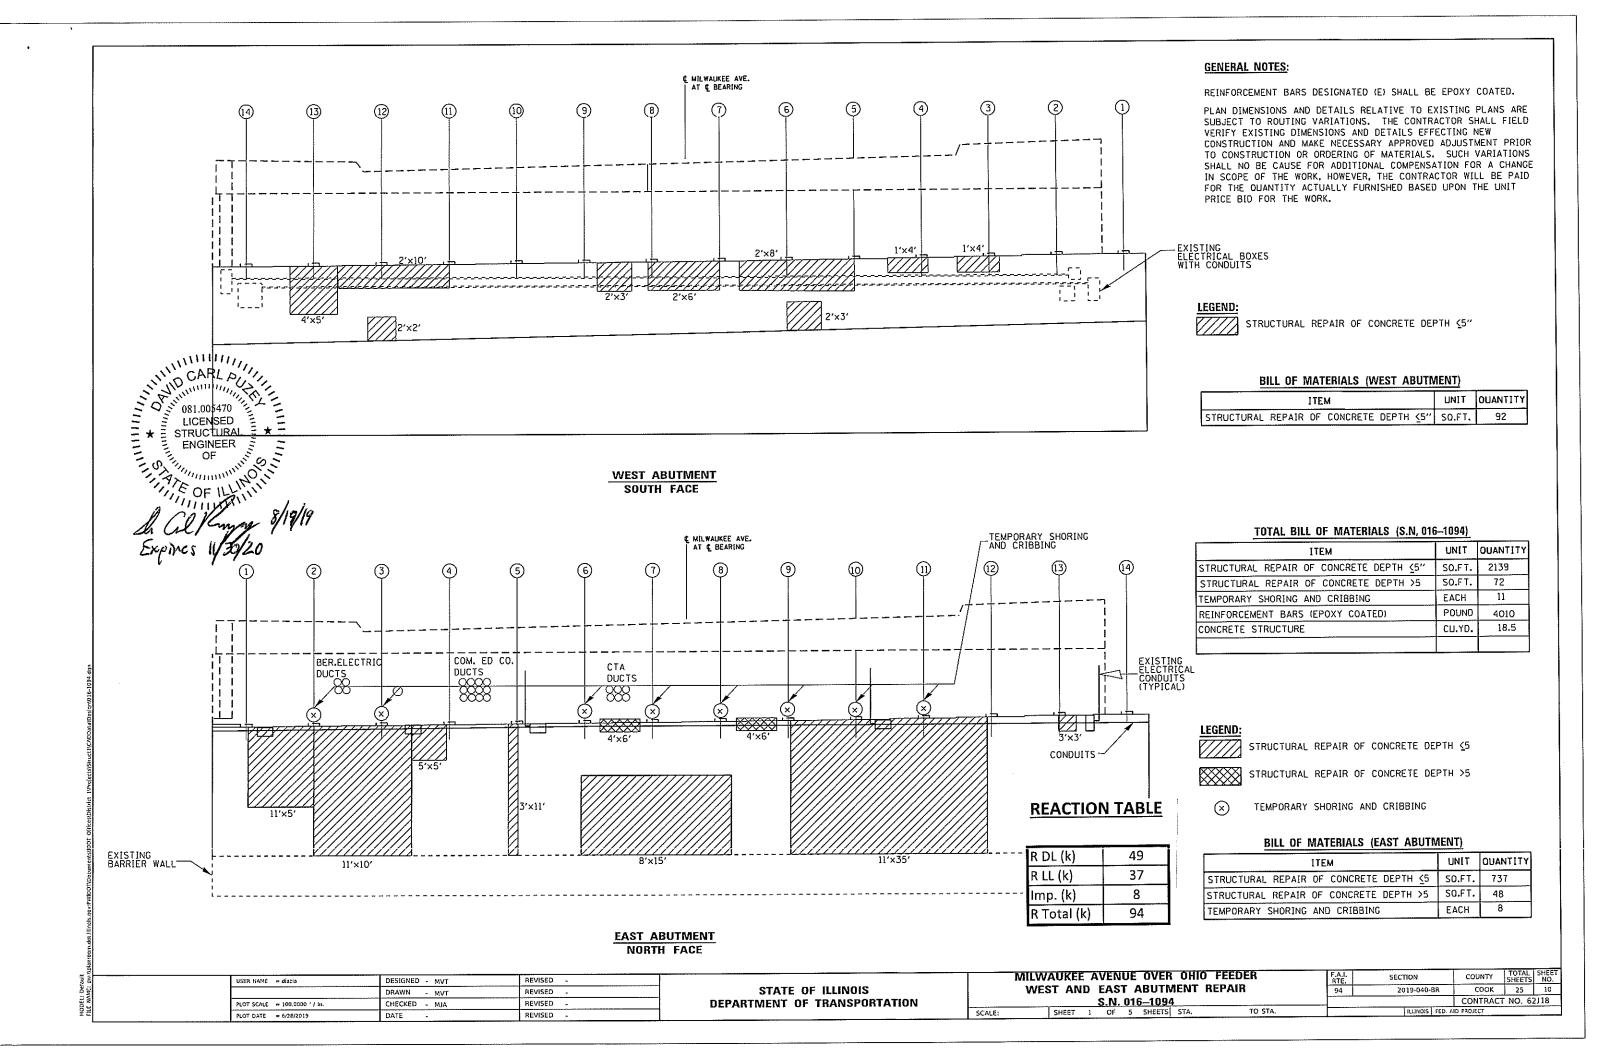


<u>LEGEN</u>

STRUCTURAL REPAIR OF CONCRETE DEPTH <5"

BILL OF MATERIALS

ITEM	UNIT	QUANTITY
STRUCTURAL REPAIR OF CONCRETE DEPTH <5"	SQ.FT.	264



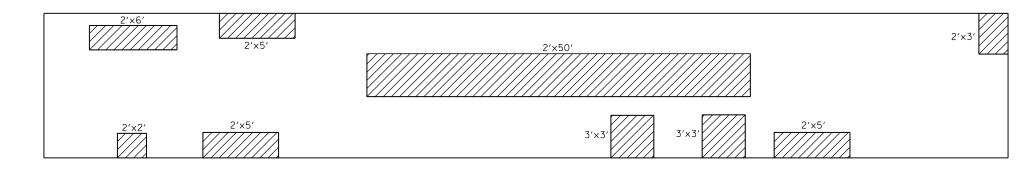

LEGEND

STRUCTURAL REPAIR OF CONCRETE DEPTH <5"

APPROACH BENT

BILL OF MATERIALS (APPROACH BENT)

	ITEM								
STRUCTURAL	REPAIR	OF	CONCRETE	DEPTH	<u>√</u> 5′′	SQ.FT.	170		

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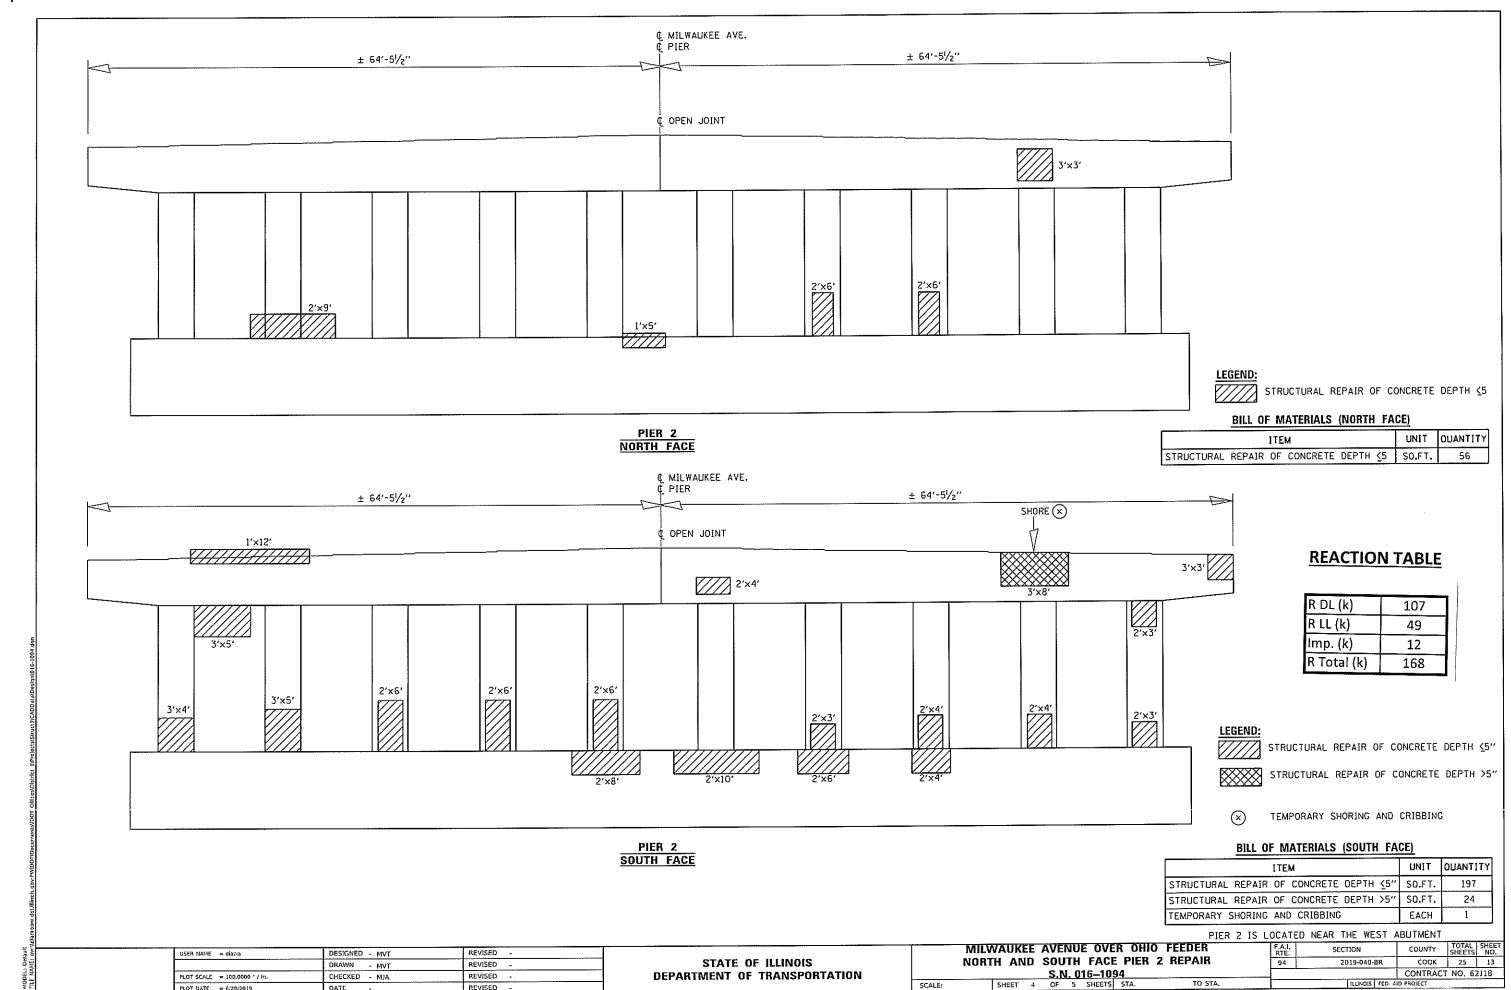
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STATE OF ILLINOIS
DEPARTMENT OF TRANSPORTATION

F.A.I. RTE. SECTION COUNTY TOTAL SHEETS NO.

94 2019-040-BR COOK 25 11

CONTRACT NO. 62 J 18





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LIGHTIN	LIGHTING AND ELECTRICAL LEGEND							
SYMBOL	DESCRIPTION							
ŌE Ţ	EXISTING UNDERPASS LIGHTING TO REMAIN							
0	EXISTING JUNCTION BOX TO REMAIN							
© ^R	EXISTING JUNCTION BOX TO BE REMOVED							
•	JUNCTION BOX, STAINLESS STEEL, ATTACHED TO STRUCTURE, 6"X6"X4"							
EE_	EXISTING UNDERGROUND UNIT DUCT TO REMAIN							
-R	EXISTING CONDUIT ATTACHED TO STRUCTURE TO BE REMOVED							
	PVC COATED, RGC, ATTACHED TO STRUCTURE							

ABBREVIATION	DESCRIPTION
AC	ALTERNATING CURRENT
A/C	AERIAL CABLE
B.O.C.	BACK OF CURB
СВ	CIRCUIT BREAKER
CKT	CIRCUIT
СМ	CENTIMETER
CP	CONTROL PANEL
CT	CURRENT TRANSFORMER
DA	DAVIT ARM
DC	DIRECT CURRENT
DIA	DIAMETER
DP	DISTRIBUTION PANEL
E	EXISTING UNIT TO REMAIN
ECA	ELECTRIC CABLE ASSEMBLY
E.O.P.	EDGE OF PAVEMENT
FT	FEET OR FOOT
FU	FUSE
GND	GROUND
HID	HIGH INTENSITY DISCHARGE
JB	JUNCTION BOX
KVA	KILOVOLT-AMPERE
KW	KILOWATTS
М	METER
MA	MAST ARM
MC	MULTI-CONDUCTOR
MM	MILLIMETER
M.H.	MOUNTING HEIGHT
MW	MESSENGER WIRE
NO. #	NUMBER
N.T.S.	NOT TO SCALE
Р	PROPOSED
PB	PUSH BUTTON
PNL	PANEL
PVC	POLYVINYL CHLORIDE
PVCC RGC	PVC COATED RIGID GALVANIZED CONDUIT
PT	POTENTIAL TRANSFORMER
R	EXISTING UNIT TO BE REMOVED
	(OWNER SALVAGED U.N.O.)
RR	EXISTING UNIT TO BE REMOVED AND
	REINSTALLED
RECP	RECEPTACLE
RGC	RIGID GALVANIZED CONDUIT
SEL SW	SELECTOR SWITCH
SPARE	SPARE
SPACE	SPACE
SS	STAINLESS STEEL
STA	STATION
T/F	TOP OF FOUNDATION
UD	UNIT DUCT
U.N.O.	UNLESS NOTED OTHERWISE
UGC, GS	UNDERGROUND CONDUCT, GALVANIZED STEE
WP	WOOD POLE
XFMR	TRANSFORMER
HPS	HIGH PRESSURE SODIUM
LPS	LOW PRESSURE SODIUM
LTFM	LIQUID TIGHT FLEXIBLE METALLIC

GENERAL NOTES

THE ELECTRICAL WORK SHALL BE PERFORMED IN ACCORDANCE WITH THE LATEST CODES, STANDARDS AND THE IDOT STANDARD SPECIFICATIONS FOR ROAD AND BRIDGE CONSTRUCTION ADOPTED APRIL 1, 2016, AND SUPPLEMENTAL SPECIFICATIONS AND RECURRING SPECIAL PROVISIONS.

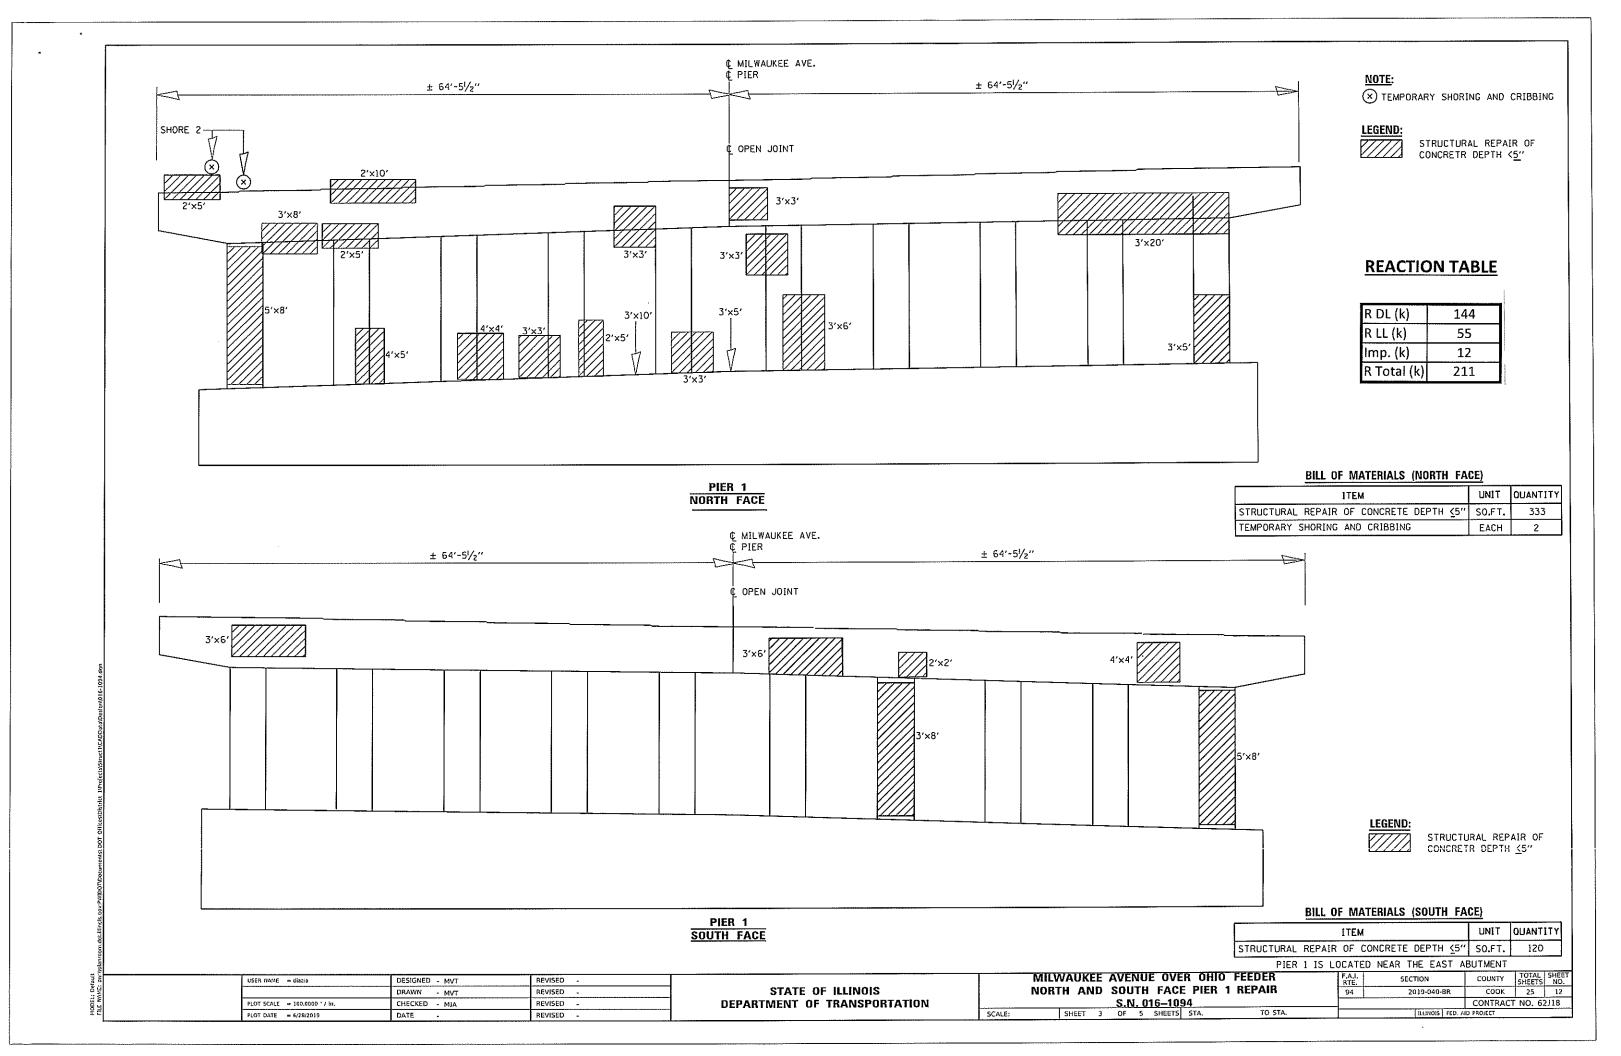INDEX OF DRAWINGS:

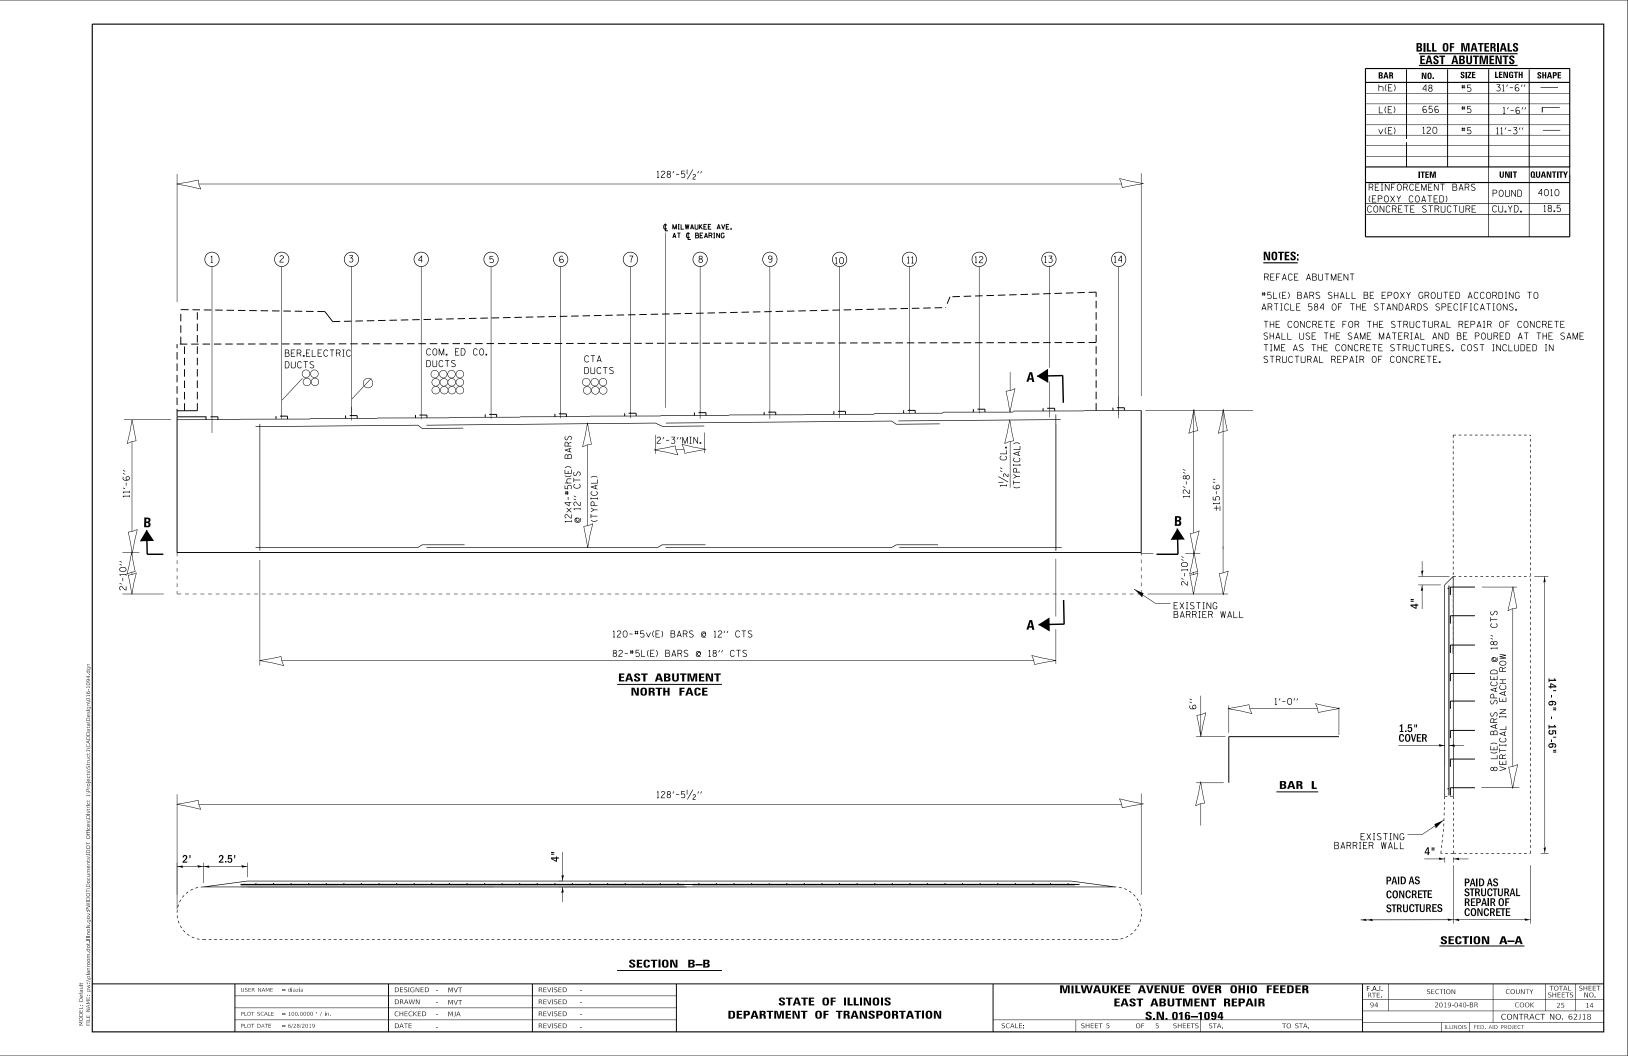DRAWING NO.	<u>TITLE</u>
LT-01	LEGEND, ABBREVIATIONS, GENERAL NOTES, SCHEDULE OF QUANTITIES AND INDEX OF DRAWINGS
LT-02	ELECTRIC CONDUIT RELOCATION PLAN WB ONTARIO ST MILWAUKEE AVE
LT-03	LIGHTING DETAILS
LT-04	IDOT-D1 STANDARDS (MISC. ELECTRICAL DETAILS SHEET A)
LT-05	IDOT-D1 STANDARDS (SUSPENDED MOUNT UNDERPASS LUMINAIRE INSTALLATION DETAILS)

IDOT-D1 STANDARDS:

STANDARD	NO.	TITLE
017111071110		

BE-702 MISC. ELECTRICAL DETAILS SHEET A

BE-900 SUSPENDED MOUNT UNDERPASS LUMINAIRE INSTALLATION DETAILS

SCHEDULE OF QUANTITIES

DESCRIPTION	UNIT	QUANTITY
CONDUIT ATTACHED TO STRUCTURE, 1" DIA., PVC COATED GALVANIZED STEEL	FOOT	200
CONDUIT ATTACHED TO STRUCTURE, 3" DIA., PVC COATED GALVANIZED STEEL	FOOT	630
JUNCTION BOX, STAINLESS STEEL, ATTACHED TO STRUCTURE, 12" X 10" X 6"	EACH	11
REMOVE AND REINSTALL ELECTRIC CABLE FROM CONDUIT	FOOT	1500
ELECTRIC CABLE IN CONDUIT, 600V (XLP-TYPE USE) 1/C NO. 10	FOOT	2000
REMOVE EXISTING JUNCTION BOX	EACH	10
REMOVE EXISTING CONDUIT ATTACHED TO STRUCTURE	FOOT	300
MAINTENANCE OF LIGHTING SYSTEM	CAL MO	2

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USER NAME = \$USER\$	DESIGNED - MG	REVISED -
	DRAWN - MG	REVISED -
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PLOT DATE = \$DATE\$	DATE - 6/24/2019	REVISED -

LT-01

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	DRAWN - MG	REVISED -
PLOT SCALE = \$SCALE\$	CHECKED - RP	REVISED -
PLOT DATE = \$DATE\$	DATE - 6/24/2019	REVISED -

STATE OF ILLINOIS DEPARTMENT OF TRANSPORTATION (LOOKING NORTH)

SCALE: 1"=30"

SHEET

	RIC COND ONTARIO				
CCT	OF	CTLLC	CTA	TO STA	

V.I. E.	SECTION		COUNTY	TOTAL SHEETS	SHEET NO.	
4	2019-0	40-BR	COOK	16		
1				CONTRACT	NO. 62	2J18
		ILLINOIS	FED. A	D PROJECT		

LT-02

LEGEND

NOTES

PLOT DATE = \$DATE\$

DATE

- 6/24/2019


REVISED

SCALE: 1"=30"

SHEET

OF SHEETS STA.

TO STA

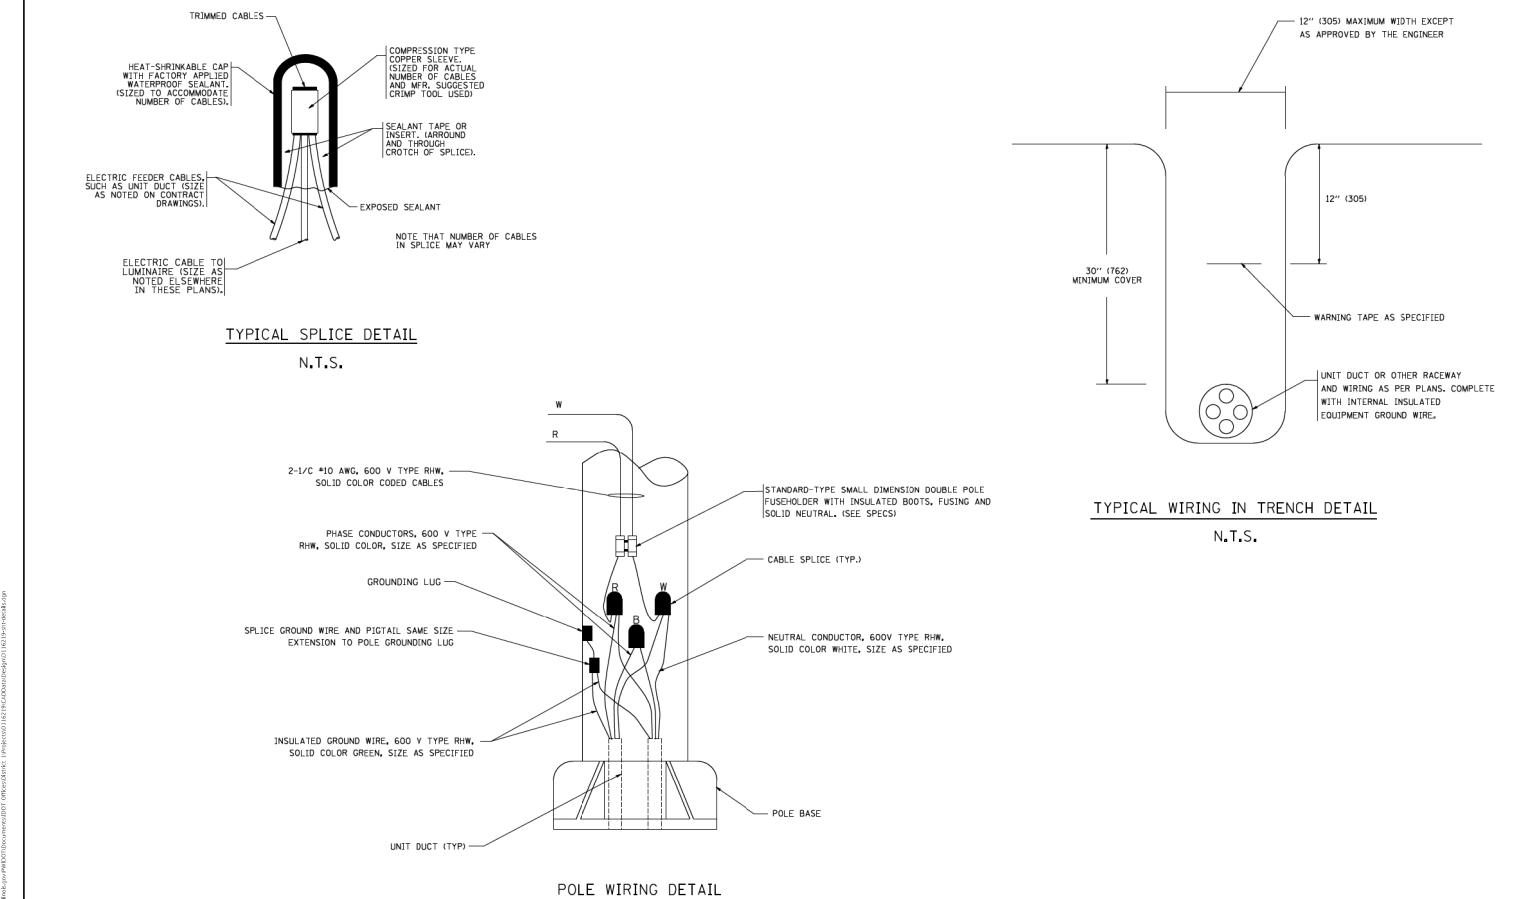

FILE NAME =

\diststd\22x34\be702.dgn

REVISED - 08-08-03 JSER NAME = gaglianobt DESIGNED -DRAWN REVISED CHECKED -REVISED PLOT SCALE = 50.000 '/ IN. PLOT DATE = 1/4/2008 DATE REVISED

STATE OF ILLINOIS **DEPARTMENT OF TRANSPORTATION**

N.T.S.


SECTION MISC. ELECTRICAL DETAILS 94 2019-040-BR SHEET A BE-702 CONTRACT NO. 62J18 SHEET NO. 1 OF 1 SHEETS STA. TO STA. SCALE: NONE

LT-04

25 18

COUNTY

соок

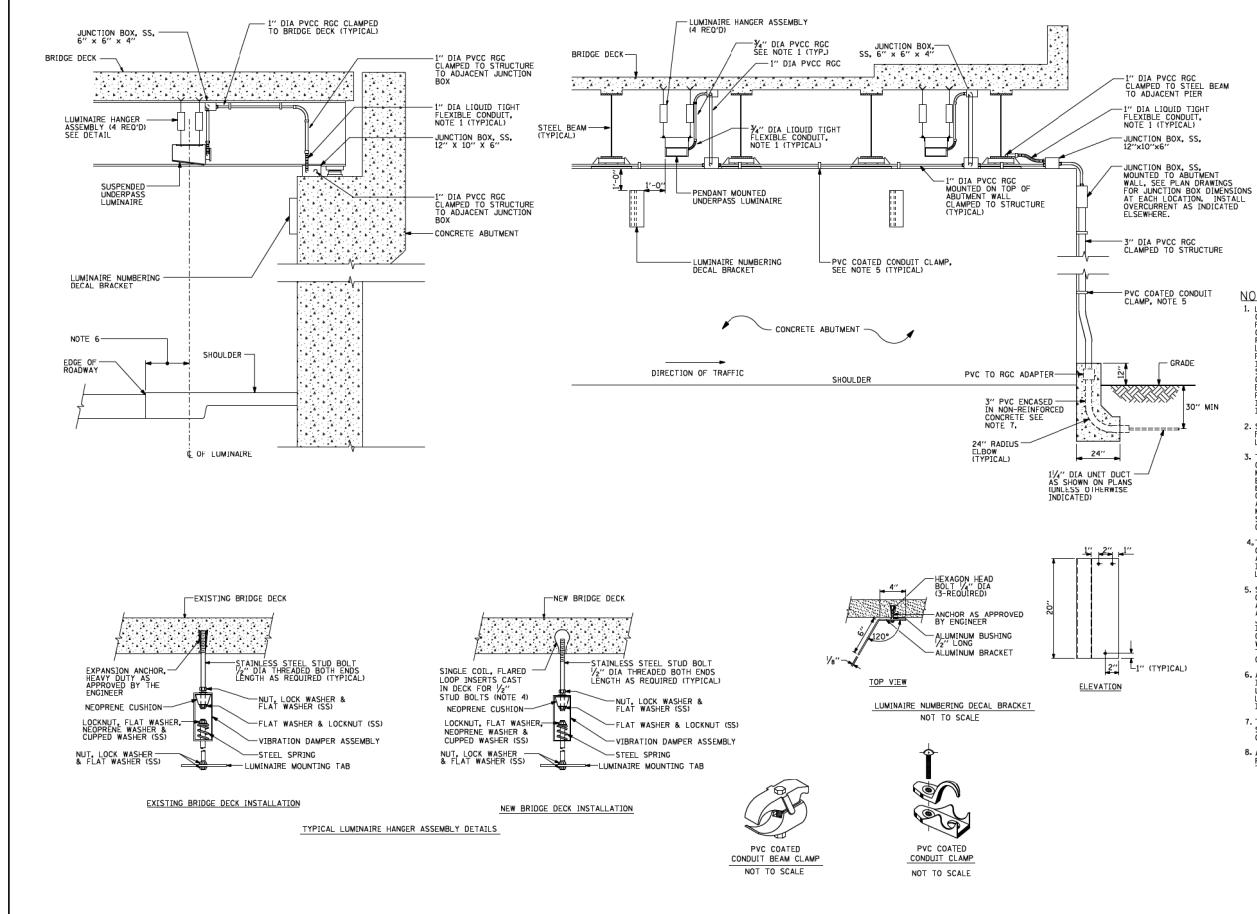

NOTES:

- NOTES:

 1. LIQUID TIGHT FLEXIBLE METAL
 CONDUTT, MAXIMUM LENGTH 6'-0", TYPICAL
 FOR EACH INSTANCE AS SHOWN, PROVIDE PVC
 COATED RIGID GALVANIZED STEEL CONDUIT AS
 REQUIRED NOT TO EXCEED 6'-0" OF FLEXIBLE
 LIQUID TIGHT METAL CONDUIT, LIQUID TIGHT
 FLEXIBLE METAL CONDUIT WILL BE INCLUDED
 IN THE COST OF THE CONDUIT ATTACHED TO
 STRUCTURE, OF THE CORRESPONDING DIA.,
 GALVANIZED STEEL, PVC COATED PAY ITEM
 EXCEPT THAT ½" DIA. CONDUIT AND ½" DIA.
 FLEXIBLE CONDUIT SHALL BE INCLUDED
 IN THE COST OF UNDERPASS LUMINAIRE
 INSTALLATION.
- 2. SEE UNDERPASS LIGHTING PLANS FOR INSTALLATION LOCATION OF UNDERPASS LIGHTING LUMINAIRES.
- 3. THE CONTRACTOR SHALL USE APPROVED SINGLE COIL FLARED LOOP INSERTS WHEN SUSPENDED MOUNTING AN UNDERPASS LUMINAIRE TO A NEW BRIDGE DECK. THE FLARED LOOP INSERTS MUST BE CAST INTO THE CONCRETE DECK. THE CONTRACTOR IS RESPONSIBLE FOR LOCATING AND COORDINATING THE INSERT LOCATING SYSTEM AS SHOWN ON THE PLANS WITH THE BRIDGE DECK CONTRACTOR. SEE DETAIL.
- 4.THE UNDERPASS LUMINAIRE HANGER ASSEMBLY COMPLETE WITH HEAVY DUTY ANCHORS/INSERTS AND ALL APPLICABLE HARDWARE SHALL BE INCLUDED IN THE COST OF THE UNDERPASS LUMINAIRE PAY ITEM.
- 5. SECURE THE CONDUIT WITH PVC COATED CONDUIT CLAMPS OR CONDUIT BEAM CLAMPS AS SHOWN AT 5'-O" INTERVALS FOR LATERALS AND WITHIN 2'-O" MAXIMUM FROM ANY JUNCTION BOX, FLEXIBLE CONDUIT, OR CHANGE IN DIRECTION. ALL PVC COATED CONDUIT CLAMPS OR BEAM CLAMPS SHALL BE INCLUDED WITH THE COST OF THE "CONDUIT ATTACHED TO STRUCTURE, OF THE CORRESPONDING DIA,, GALVANIZED STEEL, PVC COATED" PAY ITEM.
- 6. ALL UNDERPASS LUMINAIRES MUST BE CENTERED IN THE BEAM SPACE AS INDICATED ON THE PLANS UNLESS OTHERWISE DIRECTED BY THE RIOR, LUMINAIRE SETBACK SHALL BE AS INDICATED IN PLANS FOR EACH SPECIFIC UNDERPASS
- 7. THE CONCRETE ENCASED CONDUIT TRANSITION SHALL BE INCLUDED IN THE COST OF THE GALVANIZED RIGID STEEL CONDUIT PAY ITEMS.
- 8. ALL CONDUIT ATTACHED TO STRUCTURE SHALL BE PVC COATED RIGID STEEL CONDUIT (PVCC RGC) TYPICAL.

LT-05

- 12-12-05 FILE NAME = JSER NAME = gaglianobt DESIGNED REVISED \diststd\22x34\be900.dgn DRAWN REVISED CHECKED REVISED PLOT SCALE = 50.000 '/ IN. PLOT DATE = 1/4/2008 DATE REVISED


STATE OF ILLINOIS **DEPARTMENT OF TRANSPORTATION**


SUSPENDED MOUNT UNDERPASS LUMINAIRE INSTALLATION DETAILS SHEET NO. 1 OF 1 SHEETS STA.

SCALE: NONE

TO STA

SECTION COUNTY 94 2019-040-BR COOK 25 BE-900 CONTRACT NO. 62J18

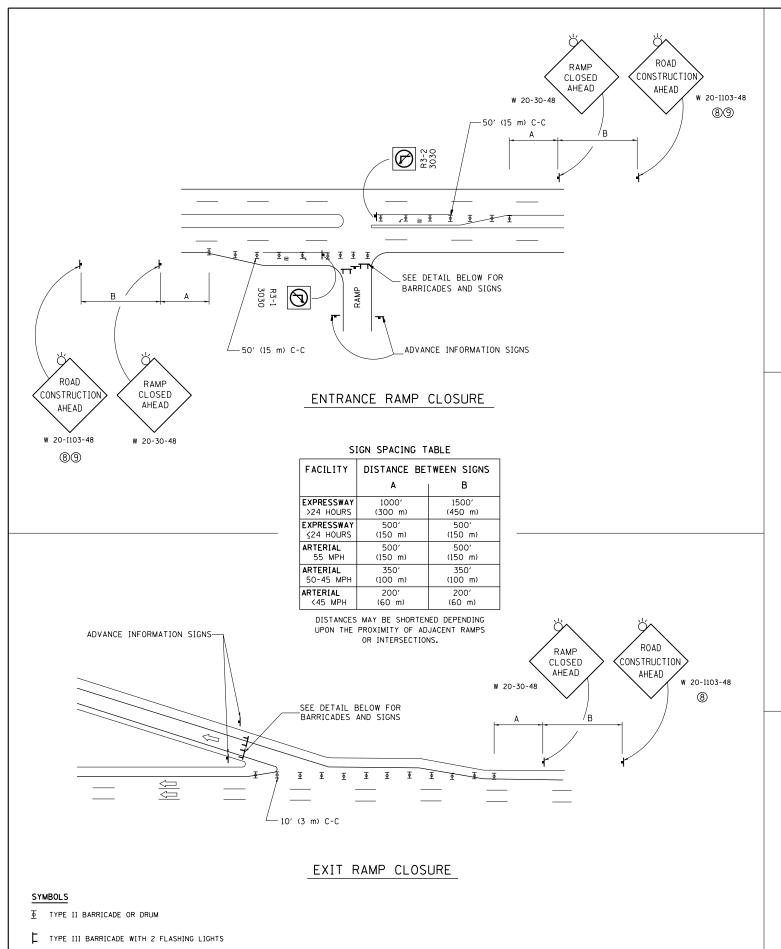

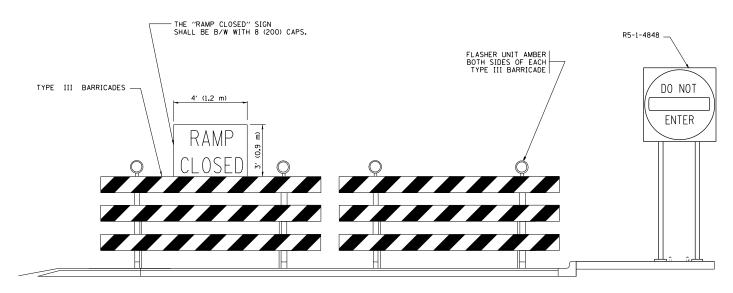


DETAIL FOR REQUIRED BARRICADES & SIGNS



BLACK LEGEND ON ORANGE
BACKGROUND MOUNTED
DIAGONALLY
E MOD FONT
1 (25) BORDER
SIGNS ARE REQUIRED ON ALL THE EXIT

1 (25) BORDER
THESE SIGNS ARE REQUIRED ON ALL THE EXIT
GUIDE SIGNS FOR EXIT RAMPS THAT WILL BE
CLOSED FOR MORE THAN FOUR (4) CONSECUTIVE DAYS.

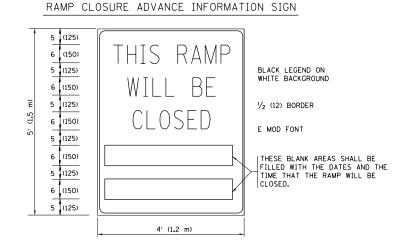

THESE SIGNS ARE REQUIRED ON BOTH SIDES OF THE RAMP, MINIMUM OF 1 WEEK IN ADVANCE OF THE CLOSURE.

THESE SIGNS SHALL BE FABRICATED AND PAID FOR ACCORDING TO THE TEMPORARY INFORMATION SIGNING SPECIAL PROVISION


GENERAL NOTES:


- ① CONES MAY BE SUBSTITUTED FOR DRUMS OR TYPE II
 BARRICADES DURING DAY OPERATIONS. CONES SHALL BE
 A MINIMUM OF 28 (700) HIGH.
- (2) VERTICAL BARRICADES SHALL NOT BE USED FOR RAMP CLOSURES.
- (3) A FLAGGER SHALL BE POSITIONED AT EACH CLOSED RAMP THAT IS OPEN TO CONSTRUCTION VEHICLES, PRECEEDED BY A W20-7 FLAGGER WARNING SIGN.
- 4 ALL ROUTE MARKERS AND TRAILBLAZER ASSEMBLIES WHICH DIRECT MOTORISTS TO A CLOSED ENTRANCE RAMP SHALL BE COVERED WHEN THE RAMP IS CLOSED FOR MORE THAN FOUR (4) DAYS.
- (5) THE SIGNING AND BARRICADING WHICH IS REQUIRED BY THIS DETAIL SHALL BE INCLUDED IN THE COST OF TRAFFIC CONTROL AND PROTECTION (EXPRESSWAYS).


- 6 AUTHORIZATION FROM THE DISTRICT'S BUREAU OF TRAFFIC IS REQUIRED FOR ALL RAMP CLOSURES.
- (7) THE RAMP CLOSURE ADVANCE INFORMATION SIGNS SHALL BE ERECTED IF THE CLOSURE TIME EXCEEDS TWENTY-FOUR (24) HOURS, ADDITIONAL ADVANCE WARNING SIGNS ON EXIT GUIDE SIGNING WILL BE REQUIRED FOR EXIT RAMP CLOSURES THAT EXCEED FOUR (4) DAYS IN LENGTH
- (8) ROAD CONSTRUCTION AHEAD SIGNS MAY BE OMITTED WHEN THIS DETAIL IS USED IN CONJUNCTION WITH OTHER TRAFFIC CONTROL THAT ALREADY INCLUDES A ROAD CONSTRUCTION AHEAD SIGN.
- ARTERIAL ROAD CONSTRUCTION AHEAD SIGNS SHALL BE INSTALLED ON THE LEFT SIDE OF TRAFFIC IF THE MEDIAN IS MORE THAN 10 FT WIDE.


ALL DIMENSIONS ARE IN INCHES (MILLIMETERS)
UNLESS OTHERWISE SHOWN.

FILE NAME =	USER NAME = diazia	DESIGNED - D.W.S.	REVISED - S.P.B. 01-07		ENTRANCE AND EXIT RAMP	F.A.I. RTE.	SECTION	COUNTY	TOTAL '	HEET NO.
par i promiso di il misori doc	•	NACAWAN Design DistStd.dgn	REVISED - S.P.B. 12-09	STATE OF ILLINOIS	CLOSURE DETAILS	94	2019-040-BR	соок	25	20
	PLOT SCALE = 100.0000 '/ in.	CHECKED -	REVISED - M.D. 06-13	DEPARTMENT OF TRANSPORTATION			TC-08	CONTRACT	NO. 6	2J18
Default	PLOT DATE = 6/28/2019	DATE - 02-83	REVISED - M.D. 01-18		SCALE: NONE SHEET 1 OF 1 SHEETS STA. TO STA.		ILLINOIS FED. A	ID PROJECT		

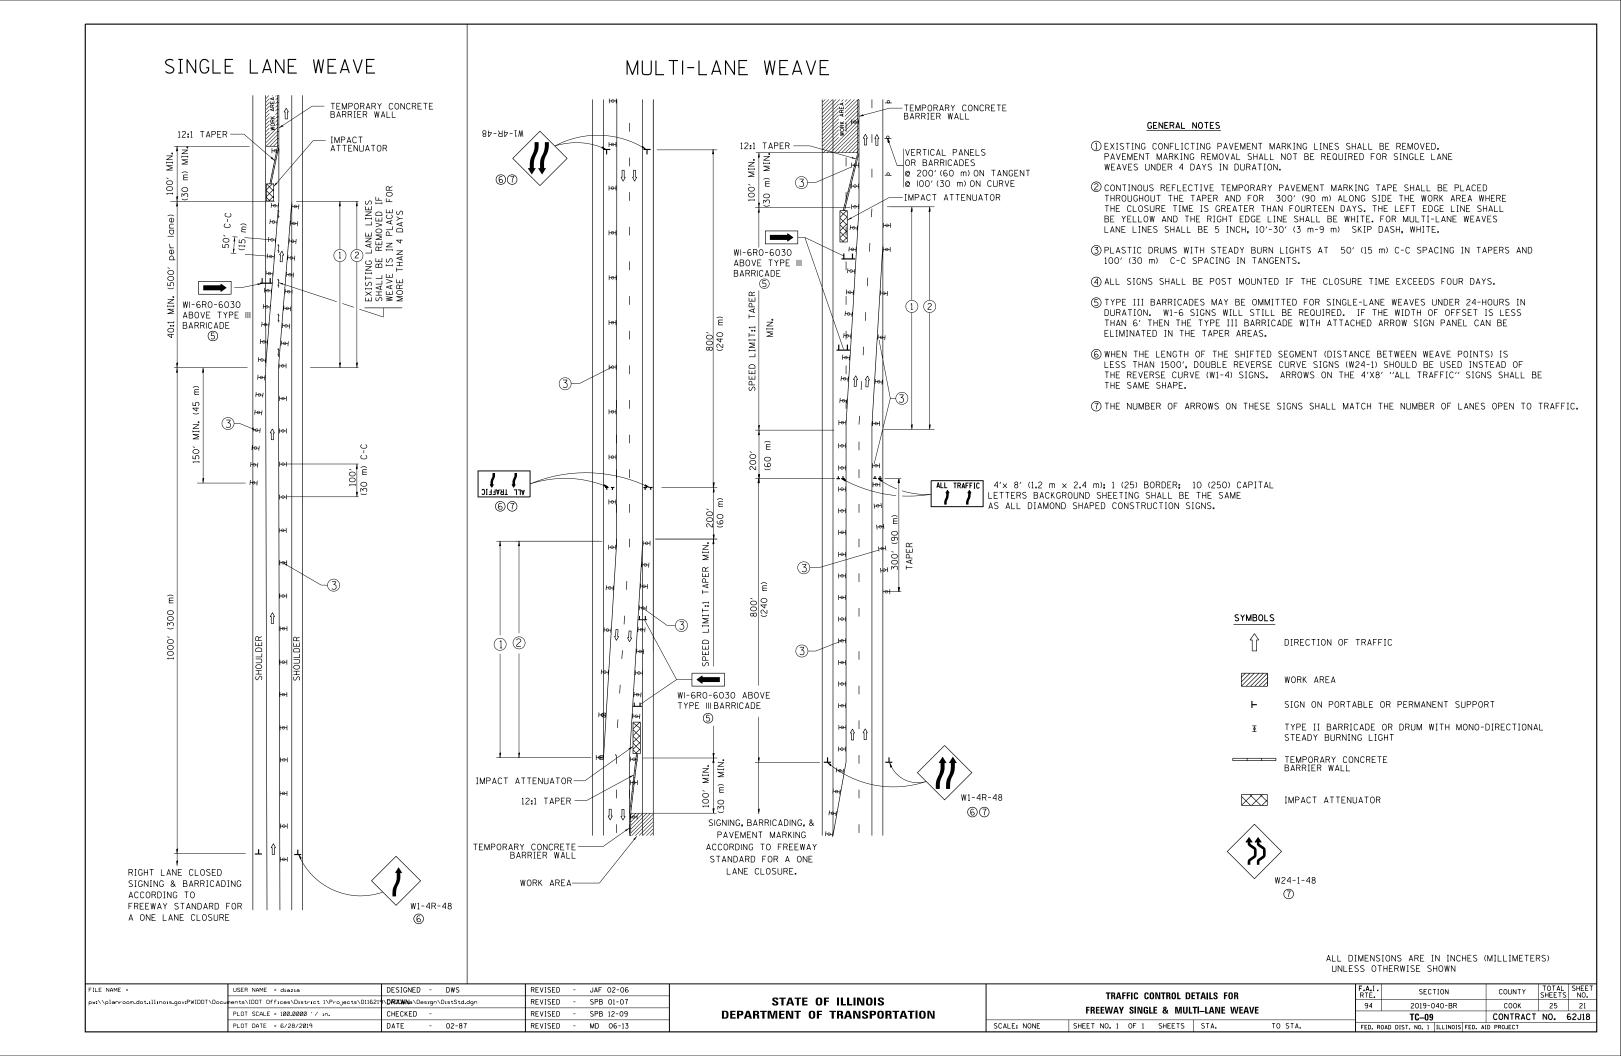

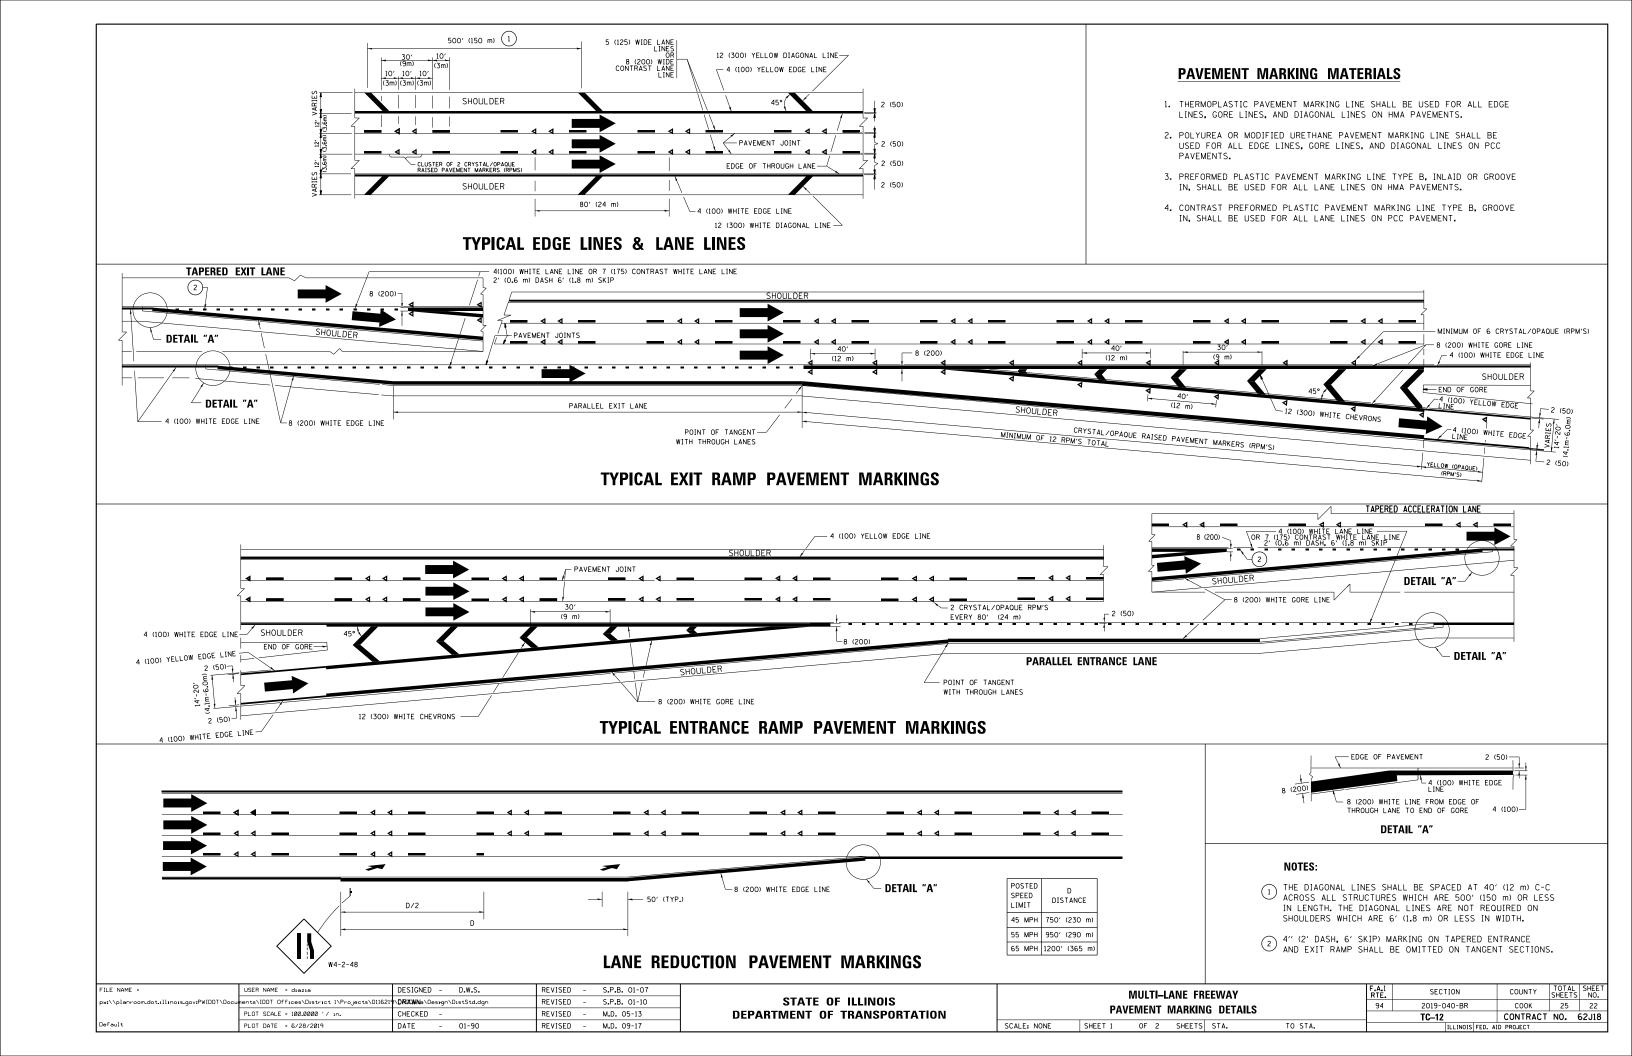


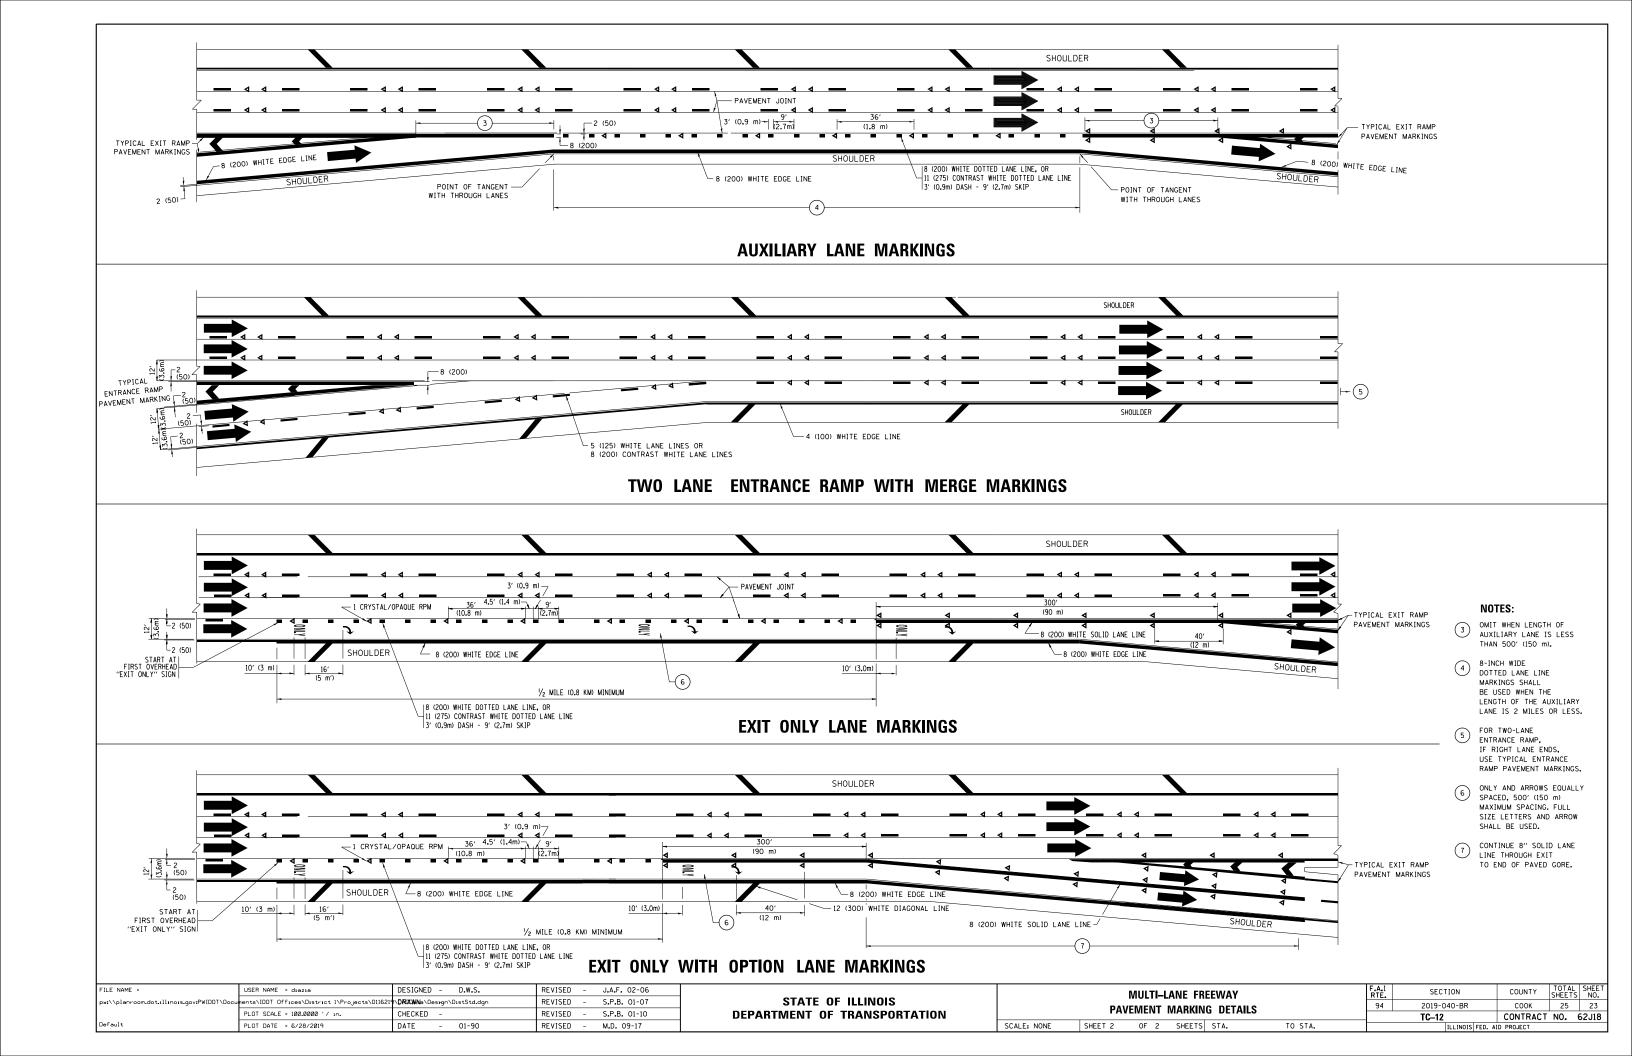

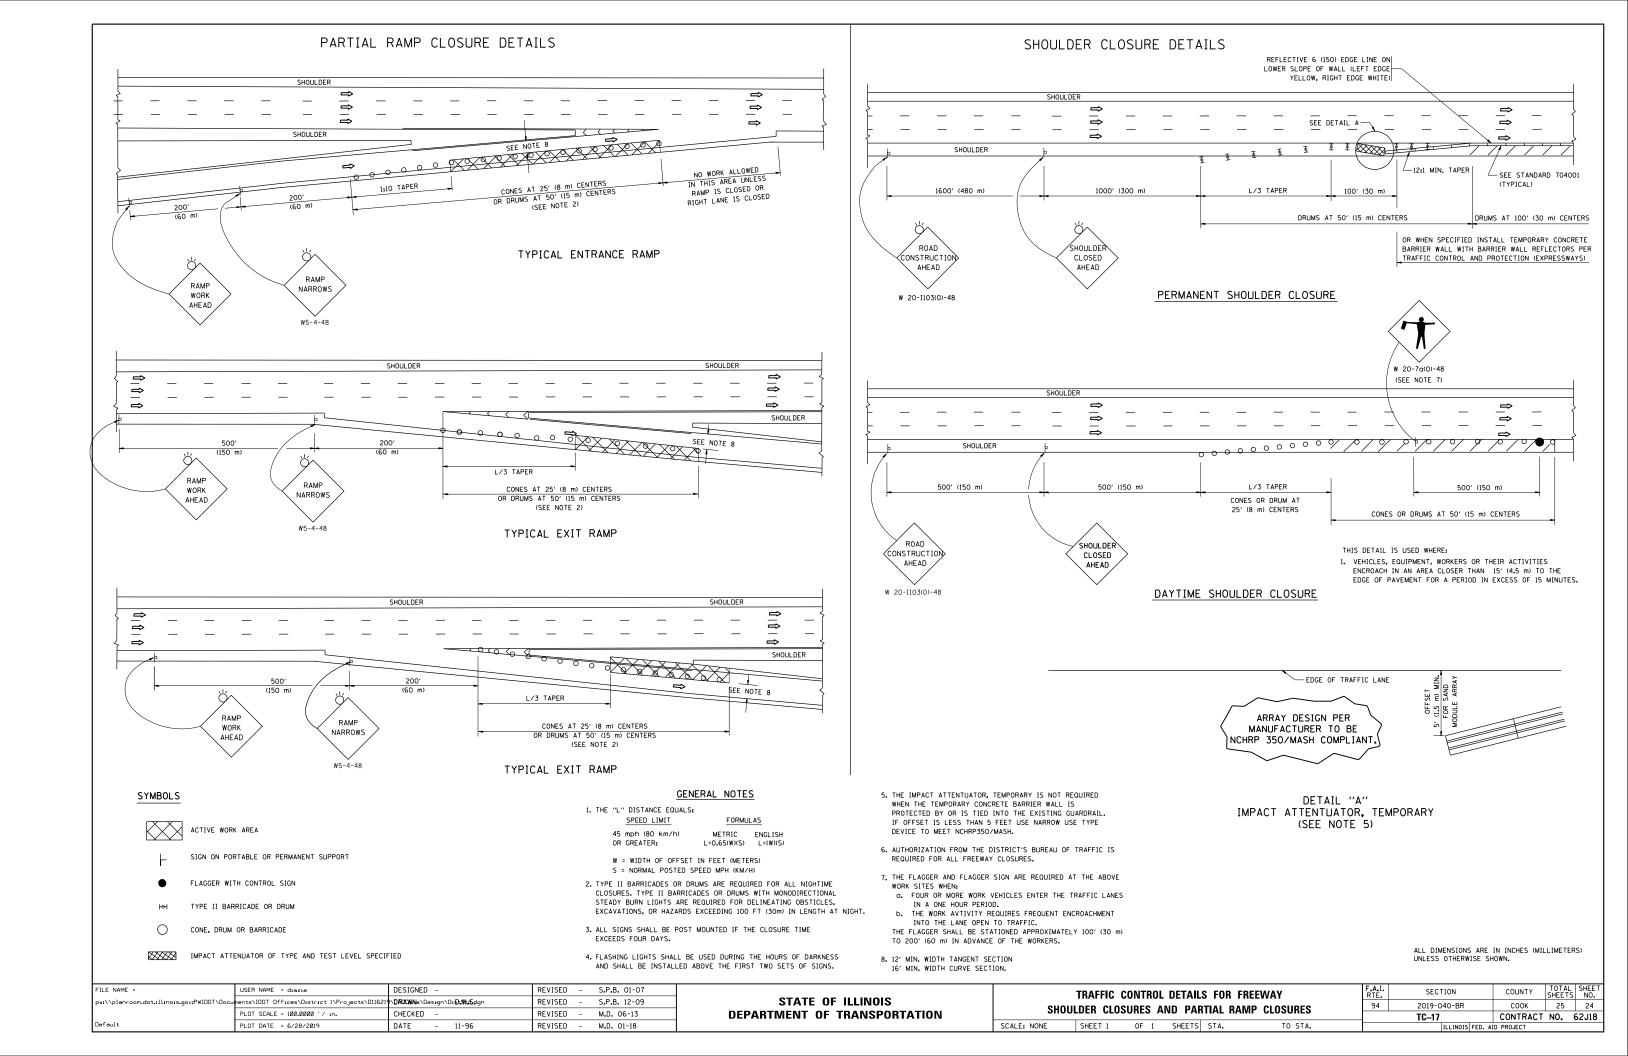


SIGNING FOR FLAGGING OPERATIONS AT WORK ZONE OPENINGS

WORK ZONE EXIT OPENING

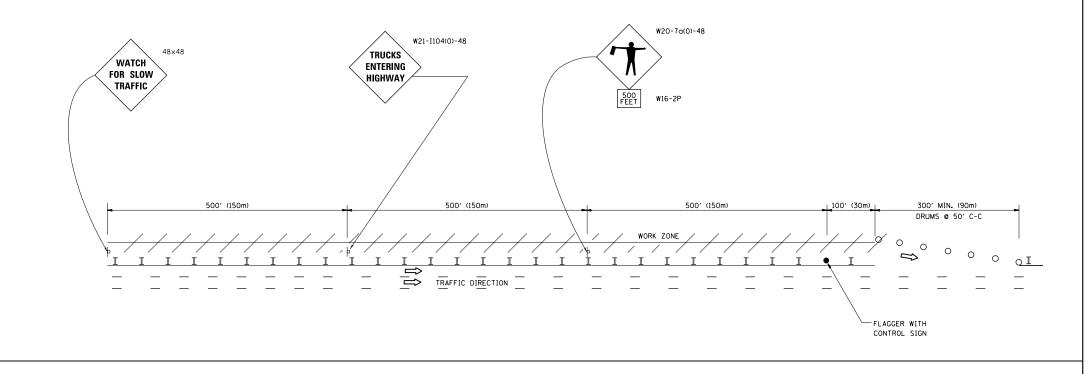

WORK ZONE ENTRY OPENING

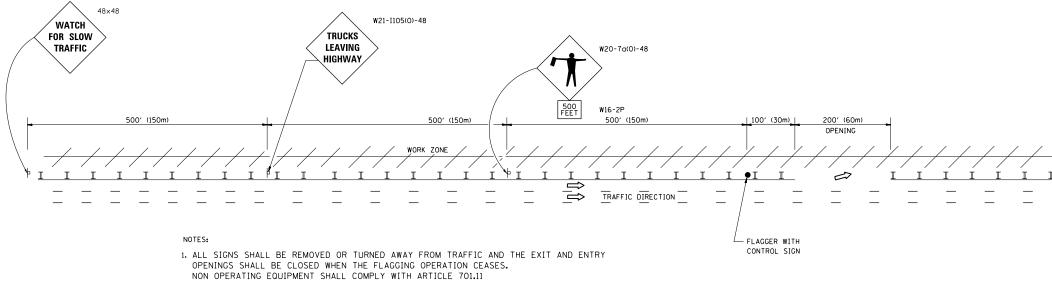

- 2. WORK ZONE OPENINGS SHALL BE A MINIMUM OF ONE HALF MILE APART AND A MINIMUM OF ONE QUARTER MILE FROM ALL ENTRANCE AND EXIT RAMPS.
- 3. EXITING THE WORK ZONE AT ANY PLACE OTHER THAN AT A WORK ZONE EXIT OPENING WILL BE PROHIBITED.
- 4. ALL VEHICLES SHALL ENTER THE WORK ZONE AT ENTRY OPENINGS, USING THEIR TURN SIGNALS TO WARN MOTORISTS
- 5. FLAGGERS SHALL NOT STOP TRAFFIC OR DIRECT TRAFFIC INTO AN ADJACENT LANE.

ALL DIMENSIONS ARE IN INCHES (MILLIMETERS)
UNLESS OTHERWISE SHOWN

FILE NAME =	USER NAME = diazia	DESIGNED -	REVISED - J.A.F. 02-06		FRFF\	WAY/EXPRESSWAY SIGNING FO	OR FLAGGING OPERATIONS	RTE.	SECTION	COUNTY	SHEETS	NO.
pw:\\planroom.dot.illinois.gov:PWIDOT\Docu	ents\IDOT Offices\District 1\Projects\D11621	\DAXWNa\Design\DistStd.dgn	REVISED - S.P.B. 01-07	STATE OF ILLINOIS				94	2019-040-BR	соок	25	25
	PLOT SCALE = 100.0000 ' / in.	CHECKED -	REVISED - S.P.B. 12-09	DEPARTMENT OF TRANSPORTATION	AI	WORK ZONE OPENINGS ON F	REEWAYS/EXPRESSWAYS		TC-18	CONTRACT	NO. 62	2J18
	PLOT DATE = 6/28/2019	DATE -	REVISED - M.D. 06-13		SCALE: NONE SHEET NO. 1 OF 1 SHEETS STA. TO STA.		FED. ROAD D		AID PROJECT			