09-20-2024 LETTING ITEM 012

FOR INDEX OF SHEETS, SEE SHEET NO. THIS PROJECT IS LOCATED IN

THE VILLAGE OF SCHAUMBURG

STATE OF ILLINOIS DEPARTMENT OF TRANSPORTATION

2023 ROD YARD PARKING СООК


D-91-076-24

PROPOSED HIGHWAY PLANS

MS ROUTE 666 (RODENBURG RD.) SECTION 2023 ROD YARD PARKING **COOK COUNTY**

CURB & GUTTER, PARKING IMPROVEMENT C-91-085-24

RODENBURG MAINTENANCE YARD 1480 RODENBURG RD, SCHAUMBURG, IL 60193

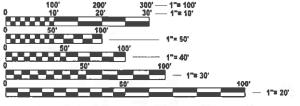


ENGINEERING SCALES. REDUCED SIZED PLANS WILL NOT CONFORM TO STANDARD SCALES. IN MAKING MEASUREMENTS ON REDUCED PLANS, THE ABOVE SCALES MAY BE USED.


JOINT UTILITY LOCATION INFORMATION FOR EXCAVATION 1-800-892-0123 OR 811

PROJECT ENGINEER: RODRIGO LEDEZMA (847) 705-4580 PROJECT MANAGER: J. ALAIN MIDY (847) 221-3056

CONTRACT NO. 62V99

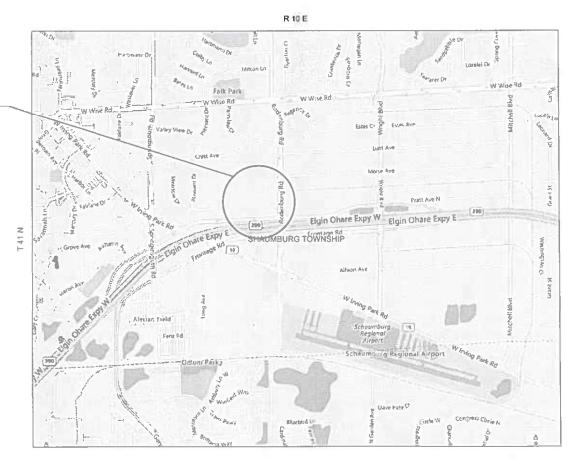



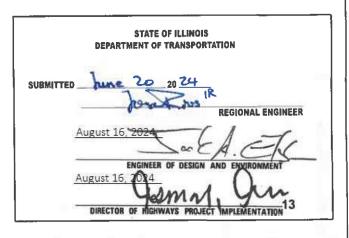

PRINTED BY THE AUTHORITY OF THE STATE OF ILLINOIS

INDEX OF SHEETS

SHEET NO.	DESCRIPTION
1	COVER SHEET
2	INDEX OF SHEETS, STATE STANDARDS & GENERAL NOTES
3	SUMMARY OF QUANTITIES
4	TYPICAL SECTIONS
5	ROADWAY PLANS
6	PROPOSED GRADING PLAN
7	DRIVEWAY DETAILS - DISTANCE BETWEEN R.O.W. AND FACE OF CURB & EDGE OF SHOULDER $>=$ 15' (4.5 M) (BD-01)
8	FRAMES AND LIDS ADJUSTMENT WITH MILLING (BD-08)
9	CURB OR CURB AND GUTTER REMOVAL AND REPLACEMENT (BD-24)
10	DISTRICT ONE TYPICAL PAVEMENT MARKINGS (TC-13)
11	ADA DETAIL FOR SINGLE PERPENDICULAR CURB RAMPS W/ EXIST. 5% OR LESS RUN. SLOPE (PD-01)

STATE STANDARDS

STANDARD NO.	DESCRIPTION
000001-08	STANDARD SYMBOLS, ABBREVIATIONS, AND PATTERNS
604001-05	FRAME AND LIDS TYPE 1
701101-05	OFF-RD OPERATIONS, MULTILANE, 15' (4.5 m) TO 24" (600 mm) FROM PAVEMENT EDGE

GENERAL NOTES


- 1. BEFORE STARTING ANY EXCAVATION, THE CONTRACTOR SHALL CALL "JULIE" AT (800) 892-0123 OR 811 FOR FIELD LOCATIONS OF BURIED ELECTRIC, TELEPHONE, AND GAS FACILITIES. (48 HOUR NOTIFICATION REQUIRED)
- 2. THE CONTRACTOR SHALL COORDINATE CONSTRUCTION ACTIVITIES WITH THE RODENBURG TEAM SECTION ACTING OPERATIONS SUPERVISOR MARIE PORTIS AT 630-351-3260, AND THE FLEET OPERATIONS TEAM SECTION OPERATIONS SUPERVISOR MICKAEL MULLER AT 630-351-
- 3. THE CONTRACTOR WILL NOT BE ALLOWED TO SET UP A YARD OR FIELD OFFICE ON STATE PROPERTY WITHOUT WRITTEN PERMISSION FROM THE DEPARTMENT.
- 4. ALL MILLED SURFACES SHALL BE A UNIFORM CROSS SLOPE AND FREE OF RIDGES BETWEEN PASSES. ANY DEVIATIONS SHALL BE CORRECTED AT NO COST TO THE DEPARTMENT.
- 5. BUTT JOINTS SHALL BE INSTALLED AT THE ENDS OF ALL RESURFACING (WHERE RESURFACING MEETS EXISTING PAVEMENT) ACCORDING TO THE "BUTT JOINT AND HOT-MIX ASPHALT TAPER DETAILS" SHEET INCLUDED IN THE PLANS, UNLESS OTHERWISE SPECIFIED.
- 6. ALL PAVEMENT PATCHING LOCATIONS WILL BE DETERMINED IN THE FIELD BY THE ENGINEER.
- 7. DRAINAGE ADJUSTMENT OR RECONSTRUCTION LOCATIONS WILL BE DETERMINED IN THE FIELD BY THE ENGINEER.
- 8. IT SHALL BE THE CONTRACTOR'S RESPONSIBILITY TO VERIFY ALL DIMENSIONS AND CONDITIONS EXISTING IN THE FIELD PRIOR TO CONSTRUCTION AND ORDERING OF MATERIALS.
- 9. THE CONTRACTOR SHALL BE REQUIRED TO KEEP A RECORD OF THE LOCATIONS OF THE BURIED STRUCTURES TO THE SATISFACTION OF THE ENGINEER.
- 10. THE CONTRACTOR SHALL BE REQUIRED TO KEEP A RECORD OF THE LOCATIONS OF THE BURIED STRUCTURES ACCORDING TO THE STATION AND DISTANCE LEFT OR RIGHT OF THE CENTERLINE OF PAVEMENT. UPON COMPLETION OF THE WORK, THE CONTRACTOR SHALL DELIVER THE RECORD TO THE ENGINEER.
- 11. DO NOT SCALE PLANS FOR CONSTRUCTION DIMENSIONS.
- 12. EXISTING BROKEN FRAMES AND LIDS SHALL BE REMOVED AND DISPOSED OF BY THE CONTRACTOR AND SHALL BE REPLACED AS DIRECTED BY THE ENGINEER, REPLACEMENT FRAMES AND LIDS WILL BE PAID FOR ACCORDING TO ARTICLE 109,04 OF THE STANDARD SPECIFICATIONS UNLESS A SEPARATE PAY ITEM HAS BEEN PROVIDED.
- 13. TEN (10) FOOT TRANSITIONS SHALL BE USED TO MATCH PROPOSED CURB AND GUTTER AND MEDIAN ITEMS OF WORK TO EXISTING CURBS AND GUTTER AND MEDIANS IN THE FIELD, UNLESS OTHERWISE SHOWN.
- 14. BEFORE COMMENCING ANY WORK, THE CONTRACTOR MUST CONTACT IDOT DISTRICT 1 ELECTRICAL MAINTENANCE CONTRACTOR (EMC) MEADE ELECTRIC: TED TROYNER, 1-708-588-2544 FOR IDOT OWNED UNDERGROUND LIGHTING FACILITIES (CABLES, CONDUITS ETC.) IDENTIFICATION.

USER NAME = Jacob.Roth	DESIGNED -	REVISED -
	DRAWN -	REVISED -
PLOT SCALE = 0.16666633 ' / in.	CHECKED -	REVISED -
PLOT DATE = 7/10/2024	DATE -	REVISED -

SCALE: OF 1 SHEETS STA. TO STA.

						CONS	STRUCTIO	N TYPE CODE					CONS	TRUCTION	TYPE COI	DE
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		IANITITIES									SHIMMADY OF OHANTITIES					
	SUMMARY OF QU	OANTITIES			ROADWAY						SUMMARY OF QUANTITIES	ROAL	VVAT			
					100% STATE							100 STA)% TE			
Code No.	ltem		Unit	Total Quantity	0004					Code No.	ltem	Unit Total 00)4			
20200100 EARTH EXCAVATION			CU YD		4305					★ 66900530	SOIL DISPOSAL ANALYSIS	EACH 4 4				
Education Education (Control of Control of C			00.15	1000	1000				——	T 00000000		2,1011				
31101400 SUBBASE GRANULAR	MATERIAL, TYPE B 6"		SQ YD	20663	20663					66901001	REGULATED SUBSTANCES PRE-CONSTRUCTION PLAN	L SUM 1				
40600275 BITUMINOUS MATERIA	S (PRIME COAT)		POUND	46492	46492					★ 66901003	REGULATED SUBSTANCES FINAL CONSTRUCTION REPORT	LSUM 1				
	,															
40600290 BITUMINOUS MATERIA	LS (TACK COAT)		POUND	8789	8789					* 66901006	REGULATED SUBSTANCES MONITORING	CAL DA 4				
40603085 HOT-MIX ASPHALT BIN	IDER COURSE, IL-19.0, N70		TON	3472	3472					67100100	MOBILIZATION	L SUM 1				
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40604062 HOT-MIX ASPHALT SUF	RFACE COURSE, IL-9.5, MIX "D", N70		TON	2510	2510					78000100	THERMOPLASTIC PAVEMENT MARKING - LETTERS AND SYMBOLS	SQ FT 19 1	9			
42001300 PROTECTIVE COAT			SQ YD	569	569					* 78000200	THERMOPLASTIC PAVEMENT MARKING - LINE 4"	FOOT 1253 12	53			
			1	1					-+							
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42300400 PORTLAND CEMENT C	CONCRETE DRIVEWAY PAVEMENT, 8 INCH		SQ YD	261	261					78000600	THERMOPLASTIC PAVEMENT MARKING - LINE 12"	FOOT 202 20	2			
42400200 PORTLAND CEMENT C	ONCRETE SIDEWALK 5 INCH		SQ FT	300	300					X4400503	COMBINATION CURB AND GUTTER REMOVAL AND REPLACEMENT GREATER THAN 10 FEET	FOOT 1279 12	79			
42400800 DETECTABLE WARNING	GS		SQ FT	20	20					X5537800	STORM SEWERS TO BE CLEANED 12"	FOOT 400 40	0			
44000100 PAVEMENT REMOVAL			SQ YD	20663	20663					X6700407	ENGINEER'S FIELD OFFICE, TYPE A (D1)	CAL MO 12 1	2			
44000155 HOT-MIX ASPHALT SUF	RFACE REMOVAL, 1 1/2"		SQ YD	9216	9216					Z0013798	CONSTRUCTION LAYOUT	L SUM 1				
44000200 DRIVEWAY PAVEMENT	REMOVAL		SQ YD	261	261					Z0018400	DRAINAGE STRUCTURES TO BE ADJUSTED	EACH 2 2				
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44000500 COMBINATION CURB A	AND GUITER REMOVAL		FOOT	212	212					20018500	DRAINAGE STRUCTURES TO BE CLEANED	EACH 10 1	,			
44000600 SIDEWALK REMOVAL			SQ FT	300	300					Z0018600	DRAINAGE STRUCTURES TO BE RECONSTRUCTED	EACH 4				
44200070 01 400 5 54701151 71	TOE II. 40 INCH		00.72						+							_
44200970 CLASS B PATCHES, TY	FEII, IVINOH		SQ YD	56	56											
44200974 CLASS B PATCHES, TY	PE III, 10 INCH		SQ YD	50	50											
			1													
44201742 CLASS D DATOUES TO	ZET SINCH		20.1/2	24	24				-+							
44201713 CLASS D PATCHES, TY	ı∟ı, ∪ INO⊓		SQ YD	24	24											
44201717 CLASS D PATCHES, TY	PE II, 6 INCH		SQ YD	306	306											
44201721 CLASS D PATCHES, TY	PE III. 6 INCH		SQ YD	139	139				-+							
HZUITZI OLAGO D PATORES, TY	i E iii, O INOTI		30,10	139	108											
				1												
44201723 CLASS D PATCHES, TY	PEIV, 6 INCH		SQ YD	116	116											
♦ 66900200 NON-SPECIAL WASTE	DISPOSAL		CU YD	2650	2650				+							
			CO YD	2000	2650											_
SPECIALTY ITEM																
USER NAME = Jacob.Roth DESIGNED - REVISED - DRAWN - REVISED - CHECKED - REVISED -						CTAT	E OF ILLI	NOIS	SUMMARY OF QUANTITIES	M.S. RTE.	SECTIO	N	COUNTY	TOTAL SHEETS		
						DEPARTMENT			DODENDUDO MAINTENANOE VARR	666	2023 ROD YARD	PARKING	COOK	11		
	PLOT DATE = 7/12/2024	DATE -	REVISED					ANTINENT	J. INAI	onini	SCALE: NTS SHEET 1 OF 1 SHEETS STA. TO ST	Α.	ILL	INOIS FED. AID P	CONTRACT ROJECT	1 NO. 62V

RODENBURG MAINTENANCE YARD

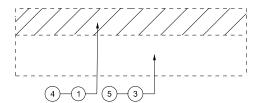



6-2-3-

EXISTING TYPICAL SECTION (PAVEMENT RECONSTRUCTION)

EXISTING TYPICAL SECTION (RESURFACING)

RODENBURG MAINTENANCE YARD

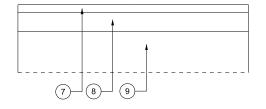

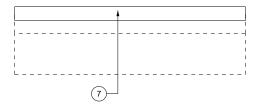

PROP. TYPICAL SECTION
(PAVEMENT RECONSTRUCTION)

PROP. TYPICAL SECTION (RESURFACING)

THE CONTRACTOR SHALL PATCH FIRST THEN MILL

LEGEND

- 1) EXISTING HMA PAVEMENT 3"
- (2) EXISTING HMA PAVEMENT 3 7"
- 3 EXISTING SUBGRADE 7½
- 4 PROPOSED PAVEMENT REMOVAL
- 5) PROPOSED SUBGRADE REMOVAL (EARTH EXCAVATION) 7 ½"
- $\begin{tabular}{ll} \hline \end{tabular}$ PROPOSED HMA SURFACE REMOVAL, 1 ½"
- PROPOSED HOT-MIX ASPHALT SURFACE COURSE IL-9.5, MIX "D", N70 , 1 ½"
- (8) PROPOSED HOT-MIX ASPHALT BINDER COURSE, IL-19.0, N70, 3"
- 9 PROPOSED SUBBASE GRANULAR MATERIAL


HOT-MIX ASPHALT MIXTURE REQUIREMENTS								
MIXTURE TYPE	AIR VOIDS(%) @ N _{DES.}	PROGRAM (QMP)						
PAVEMENT RECONSTRUCTION								
HOT-MIX ASPHALT SURFACE COURSE IL-9.5, MIX "D", N70 , 1½"	4% @ 70 GYR	QC/QA						
HOT-MIX ASPHALT BINDER COURSE, IL-19.0, N70, 3"	4% @ 70 GYR	QC/QA						
PAVEMENT RESURFACING								
HOT-MIX ASPHALT SURFACE COURSE IL-9.5, MIX "D", N70, 1½"	4% @ 70 GYR	QC/QA						
PATCHING								
CLASS D PATCHES (HMA BINDER IL-19.0)	4% @ 70 GYR	QC/QA						
QMP DESIGNATION: QUALITY CONTROL/QUALITY ASSURANCE(QA/QC); QUALITY CONTROL FOR PERFORMANCE(QCP); PAY FOR PERFORMANCE(PFP)								

THE UNIT WEIGHT USED TO CALCULATE ALL HMA SURFACE MIXTURE QUANTITIES IS 112 LBS/SQ YD/IN.

SCALE:

THE "AC TYPE" FOR POLYMERIZED HMA MIXES SHALL BE "SBS/SBR PG 76-22" AND FOR NON-POLYMERIZED HMA THE "AC TYPE" SHALL BE "PG 64-22" UNLESS MODIFIED BY RECLAIMED MATERIALS SPECIFICATIONS.

USER NAME = Baraa.Alsmadi	DESIGNED -	REVISED -
	DRAWN -	REVISED -
	CHECKED -	REVISED -
PLOT DATE = 4/19/2024	DATE -	REVISED -

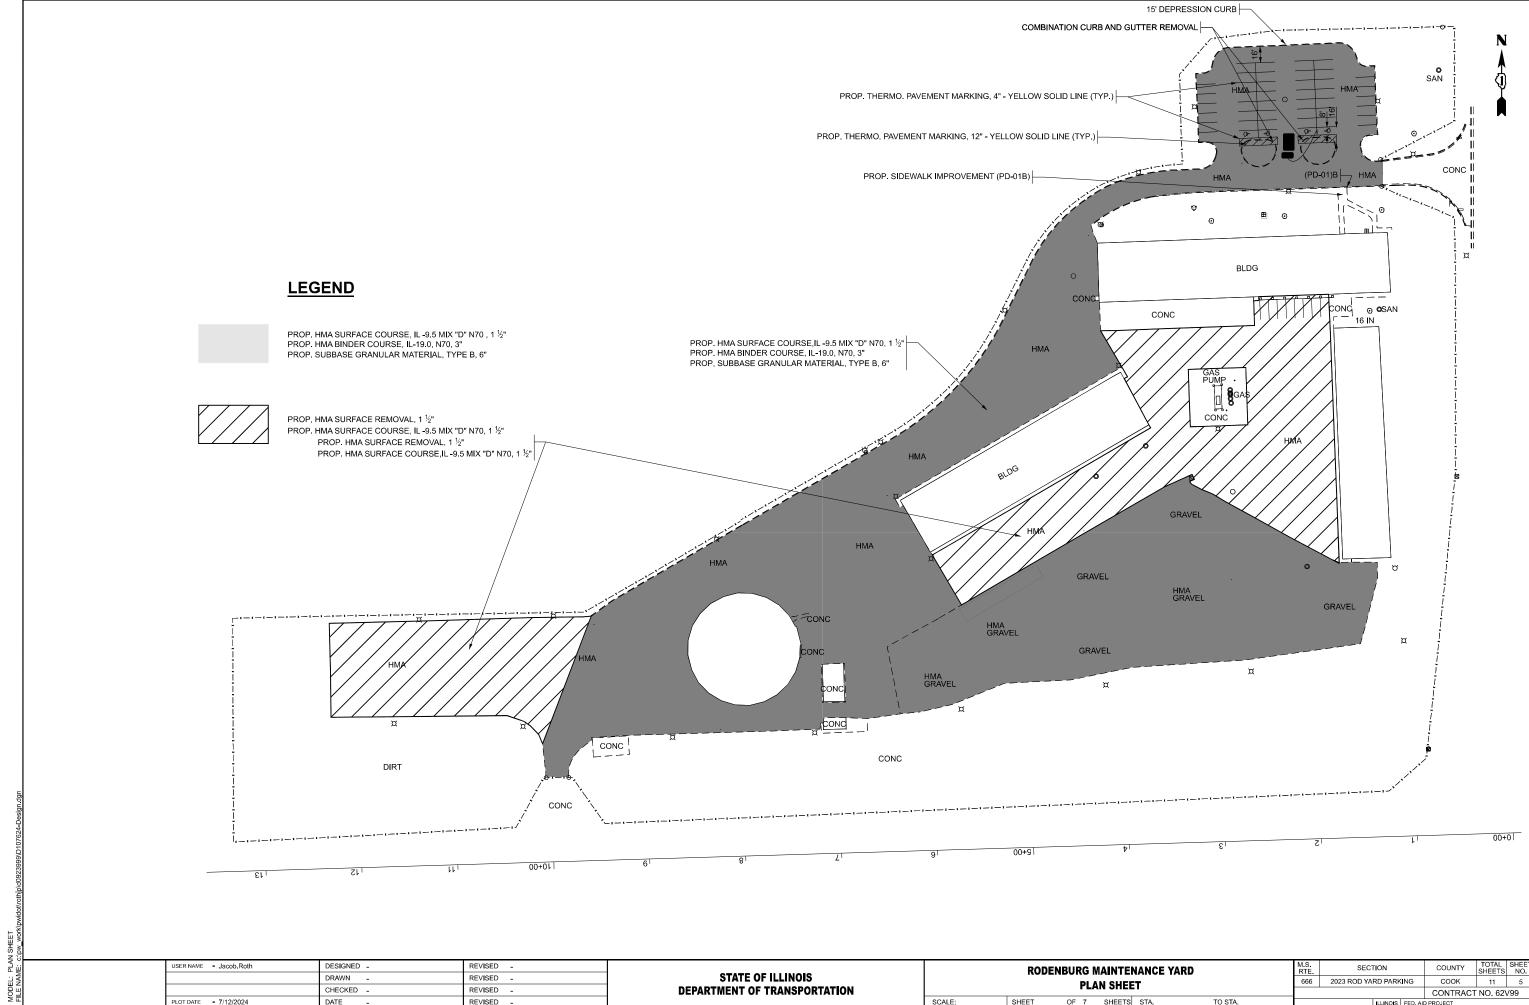

DATE

REVISED -

DEPARTMENT OF TRANSPORTATION

SHEET OF 7 SHEETS STA. TO STA. CONTRACT NO. 62V99

BLDG **LEGEND** PROP. HMA SURFACE COURSE, IL -9.5 MIX "D" N70 , 1 $\frac{1}{2}$ " PROP. HMA BINDER COURSE, IL-19.0, N70, 3" PROP. SUBBASE GRANULAR MATERIAL, TYPE B, 6" PROP. HMA SURFACE REMOVAL, 1 ½" PROP. HMA SURFACE COURSE, IL -9.5 MIX "D" N70, 1 ½" HMA GRAVEL GRAVEL CONC 10+00 COUNTY TOTAL SHEET NO.

COOK 11 6 USER NAME = Jacob.Roth DESIGNED -REVISED -RODENBURG MAINTENANCE YARD GRADING PLAN SHEET SECTION STATE OF ILLINOIS DEPARTMENT OF TRANSPORTATION DRAWN REVISED -666 2023 ROD YARD PARKING CHECKED -REVISED -CONTRACT NO. 62V99

SCALE:


OF 7 SHEETS STA.

TO STA.


PLOT DATE = 7/12/2024

DATE


REVISED -

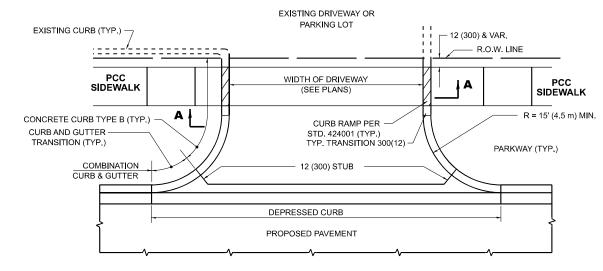



WITH CONCRETE CURB, TYPE B

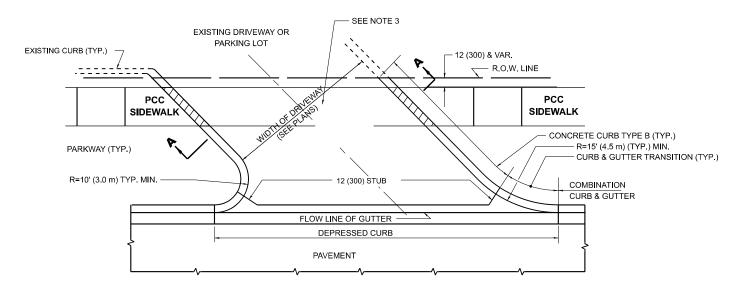

WITH CONCRETE CURB, TYPE B

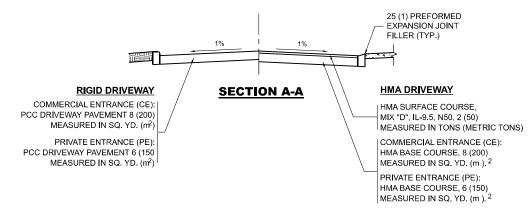

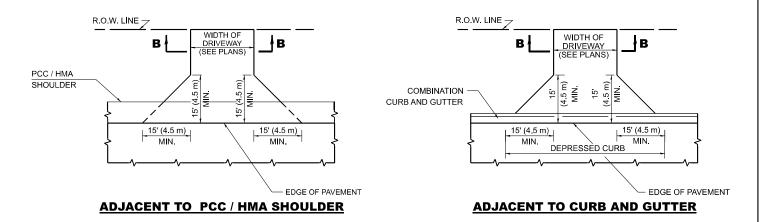

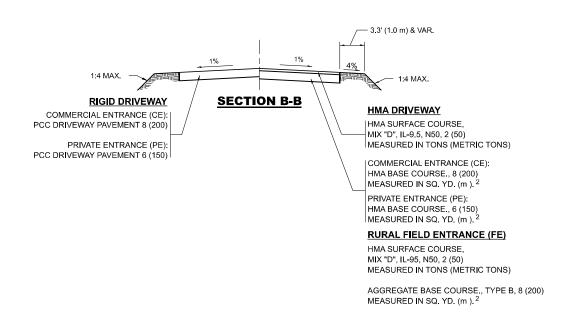


GENERAL NOTES


- DRIVEWAY SLOPES, LOCATIONS, & GEOMETRIC LAYOUT SHALL BE IN ACCORDANCE WITH THE LATEST EDITION OF THE "HANDBOOK FOR POLICY ON PERMITS FOR ACCESS DRIVEWAYS TO STATE HIGHWAYS".

 FOR FURTHER LAYOUT REQUIREMENTS, REFER TO ILLUSTRATIONS IN THE PERMIT HANDBOOK. DRIVEWAYS SHALL BE REPLACED IN KIND, UNLESS OTHERWISE NOTED ON THE PLANS.
- 2. COMMERCIAL DRIVEWAYS SHALL BE CONSTRUCTED WITH CONCRETE CURB, TYPE B RETURNS EXCEPT WHEN THE SIDEWALK EDGE IS 4 FEET (1.2 METERS) OR LESS FROM THE BACK OF CURB, CONSTRUCT A FLARE DRIVEWAY WITHOUT CURB.

ALL DIMENSIONS ARE IN INCHES (MILLIMETERS) UNLESS OTHERWISE NOTED.

USER NAME = Jacob.Roth	DESIGNED -	REVISED - R. BORO 06-11-08		DRI	IVEWAY DETAILS - DISTANCE BETWEEN R.	O.W.	F.A.M.S RTE	SECTION	COUNTY	TOTAL SHEET SHEETS NO.
	DRAWN -	REVISED - R. BORO 09-06-11	STATE OF ILLINOIS	AND	FACE OF CUIDD & EDGE OF CHOULDED >46	1/4 E\	666	2023 ROD YARD PARKING	соок	11 7
PLOT SCALE = 0.16666633 * / in.	CHECKED -	REVISED - K. SMITH 08-28-19	DEPARTMENT OF TRANSPORTATION	AND	FACE OF CURB & EDGE OF SHOULDER >15	(4.5m)	В	D400-01 (BD-01)	CONTRACT	Γ NO. 62V99
PLOT DATE = 7/10/2024	DATE -	REVISED - K. SMITH 11-18-22		SCALE: NONE	SHEET 1 OF 1 SHEETS STA.	TO STA.		ILLINOIS FED. AI	D PROJECT	

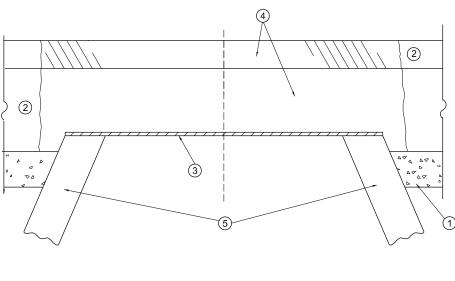

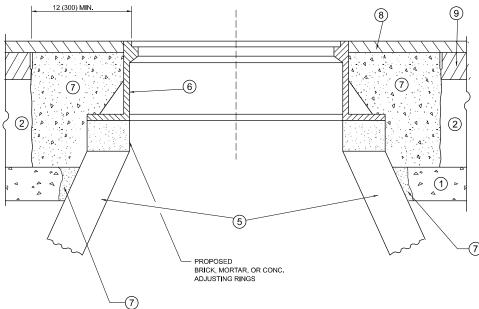

DETAILS FOR FRAMES AND LIDS ADJUSTMENT

<u>NOTES</u>

- 1. EXISTING BROKEN FRAMES AND LIDS SHALL BE REMOVED AND DISPOSED OF BY THE CONTRACTOR AND SHALL BE REPLACED AS DIRECTED BY THE ENGINEER. REPLACEMENT FRAMES AND LIDS WILL BE PAID FOR IN ACCORDANCE WITH ARTICLE 109.04 OF THE STANDARD SPECIFICATIONS UNLESS A SEPARATE PAY ITEM HAS BEEN PROVIDED.
- 2. IF THE EXISTING LIDS ARE OPEN, THE FRAME WILL BE ADJUSTED TO THE ELEVATION OF THE MILLED PAVEMENT SURFACE PRIOR TO THE MILLING OPERATION. THE FRAME WILL NOT BE REMOVED AND COVERED BY THE METAL PLATE.
- 3. CITY OF CHICAGO CASTINGS ARE THE PROPERTY OF THE CITY AND THE CONTRACTOR SHALL NOTIFY THE CITY FOR REMOVAL AND DISPOSITION OF THE CASTINGS.
- 4. THE METAL PLATE USED TO COVER THE STRUCTURE SHALL REMAIN THE PROPERTY OF THE CONTRACTOR.
- 5. THE CONTRACTOR SHALL REMOVE ALL TRAFFIC CONTROL DEVICES BY THE END OF EACH WORK SHIFT.

WITH MILLING

CONSTRUCTION PROCEDURES

STAGE 1 (BEFORE PAVEMENT MILLING)

A) REMOVE A MINIMUM OF 12 (300) OF THE PAVEMENT FROM AROUND THE STRUCTURE.

- B) REMOVE THE EXISTING FRAME AND LID FROM THE STRUCTURE. C) COVER THE STRUCTURE OPENING WITH A 36 (900) DIAMETER METAL PLATE.
- D) BACKFILL WITH CRUSHED STONE AND HMA SURFACE MIX APPROVED BY THE ENGINEER. (MIN. 3 (80) HMA TO REMAIN AFTER MILLING).

STAGE 2 (AFTER PAVEMENT MILLING)

A) REMOVE THE HMA SURFACE MIX AND CRUSHED STONE. B) INSTALL THE FRAME AND LID; ADJUST THE FRAME TO ITS FINAL SURFACE ELEVATION.

- C) THE SURROUNDING SPACE SHALL BE FILLED WITH CLASS PP-2 * CONCRETE TO THE ELEVATION OF THE SURFACE OF THE EXISTING BASE COURSE OR THE BINDER COURSE.
- * UNLESS OTHERWISE SPECIFIED IN THE PLANS.

THE PROCEDURE EXPLAINED ABOVE SHALL CONFORM TO THE APPLICABLE PORTIONS OF SECTIONS 353, 406, 602, AND 603 OF THE STANDARD SPECIFICATIONS EXCEPT THAT "THE CONTRACTOR SHALL ADJUST THE STRUCTURES TO THE FINISHED PAVEMENT ELEVATION NO MORE THAN 5 CALENDAR DAYS PRIOR TO PLACEMENT OF THE FINAL LIFT OF SURFACE UNLESS APPROVED BY THE ENGINEER."

LEGEND

1 SUB-BASE GRANULAR MATERIAL

(6) FRAME AND LID (SEE NOTES)

2 EXISTING PAVEMENT

(7) CLASS PP-2* CONCRETE

3 36 (900) DIAMETER METAL PLATE

8 PROPOSED HMA SURFACE COURSE

4 PROPOSED CRUSHED STONE AND HMA SURFACE MIX

(5) EXISTING STRUCTURE

(9) PROPOSED HMA BINDER COURSE

LOCATION OF STRUCTURES


THE CONTRACTOR WILL BE REQUIRED TO KEEP A RECORD OF THE LOCATIONS OF THE BURIED STRUCTURES ACCORDING TO THE STATION AND DISTANCE LEFT OR RIGHT OF THE CENTERLINE OF PAVEMENT. UPON COMPLETION OF THE WORK, THE CONTRACTOR WILL DELIVER THE RECORD TO THE ENGINEER.

BASIS OF PAYMENT

- 1. REMOVING FRAMES AND LIDS ON DRAINAGE AND UTILITY STRUCTURES IN THE PAVEMENT PRIOR TO MILLING, AND ADJUSTING TO FINAL GRADE PRIOR TO PLACING THE SURFACE COURSE, WILL BE PAID FOR AT THE CONTRACT UNIT PRICE EACH FOR "FRAMES AND LIDS TO BE ADJUSTED (SPECIAL)."
- 2. THIS WORK WILL NOT BE PAID FOR WHEN DRAINAGE AND UTILITY STRUCTURES ARE SPECIFIED FOR PAYMENT AS STRUCTURE RECONSTRUCTION.
- 3. NEW FRAMES AND LIDS, WHEN SPECIFIED, WILL BE PAID FOR SEPARATELY.
- 4. WHEN STRUCTURES ARE TO BE ADJUSTED OR RECONSTRUCTED. THE LOWERING AND RAISING OF THE FRAMES AND LIDS WILL NOT BE PAID FOR SEPARATELY BUT WILL BE INCLUDED IN THE COST OF THE CORRESPONDING PAY ITEM.

ALL DIMENSIONS ARE IN INCHES (MILLIMETERS) UNLESS OTHERWISE SHOWN

SER NAME = Jacob.Roth DESIGNED - R. SHAH REVISED - R. BORO 03-09-11 COUNTY **DETAILS FOR STATE OF ILLINOIS** DRAWN REVISED - R. BORO 12-06-11 666 2023 ROD YARD PARKING COOK 11 FRAMES AND LIDS ADJUSTMENT WITH MILLING HECKED -REVISED - K. SMITH 11-18-22 **DEPARTMENT OF TRANSPORTATION** BD600-03 (BD-08) CONTRACT NO. 62V99 SCALE: NONE SHEET 1 OF 1 SHEETS STA. PLOT DATE = 7/10/2024 REVISED - K. SMITH 09-15-23 DATE 10-25-94

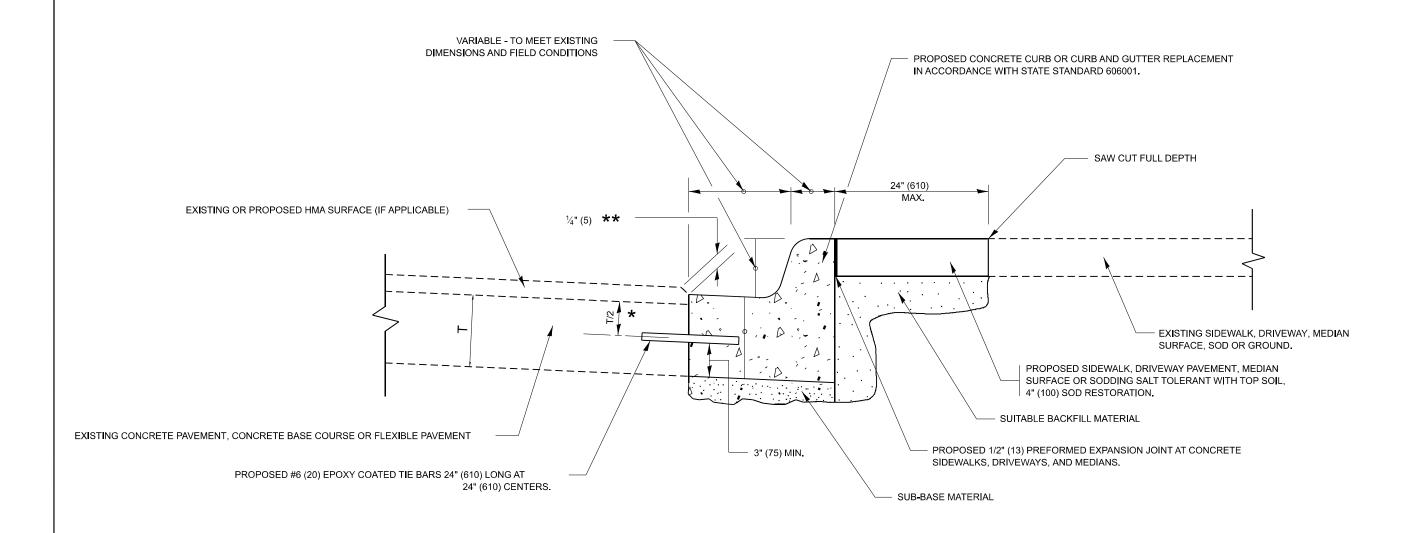



- ★ 3" (75) MINIMUM FROM TOP AND BOTTOM OF THE CONCRETE PAVEMENT OR BASE COURSE.
- ** IF THE FINAL SURFACE OF THE PAVEMENT IS CONCRETE, THE GUTTER IS TO BE FLUSH WITH THE PAVEMENT.

CURB OR CURB AND GUTTER REMOVAL AND REPLACEMENT


ALL DIMENSIONS ARE IN INCHES (MILLIMETERS) UNLESS OTHERWISE SHOWN.

USER NAME = Jacob.Roth	DESIGNED - A. HOUSEH	REVISED - A. ABBAS 03-21-97			CURI	B OR CI	URB AN	ID GUTTER		F.A.M. RTE.	\$ s	ECTION	COUNTY	TOTAL SHEETS	SHEET NO.
	DRAWN -	REVISED - M. GOMEZ 01-22-01	STATE OF ILLINOIS		DEM	SVAL AL	ND DED	LACEMENT		666	2023 ROD	YARD PARKING	COOK	11	9
PLOT SCALE = 0.16666633 1 / in.	CHECKED -	REVISED - R. BORO 12-15-09	DEPARTMENT OF TRANSPORTATION		KEIVIC	JVAL A	NU KEP	LACEMENI			BD600-06	(BD-24)	CONTRAC	T NO. 62	√99
PLOT DATE = 7/10/2024	DATE - 03-11-94	REVISED - K. SMITH 07-11-19		SCALE: NONE	SHEET 1	OF 1	SHEETS	STA.	TO STA.			ILLINOIS FED. AID	PROJECT		

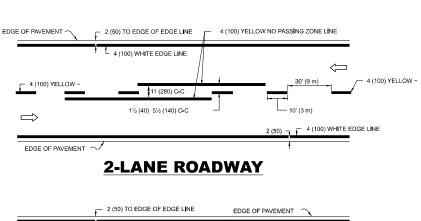


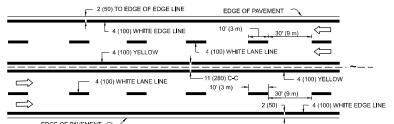

MULTI-LANE UNDIVIDED

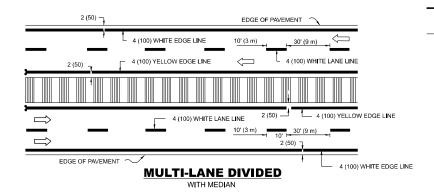

TYPICAL LANE AND EDGE LINE MARKING

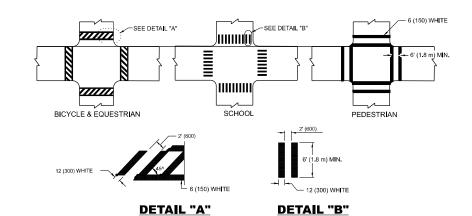


TYPICAL CROSSWALK MARKING

* MARKINGS SHALL BE INSTALLED PARALLEL TO THE CENTERLINE OF THE ROAD WHICH IT CROSSES

TWO-4 (100) YELLOW @ 11 (280) C-C 4' (1.2 m) OUTS DE TO NO DIAGONALS TWO-4 (100) YELLOW @ 11 (280) C-C


4' (1.2 m) WIDE MEDIANS ONLY

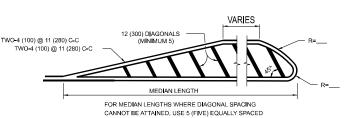


DIAGONAL LINES. 50' (15 m) C-C (LESS THAN 30MPH (50 km/h)) 75' (25 m) C-C 30MPH (50 km/h) TO 45MPH (70 km/h))

MEDIANS OVER 4' (1.2 m) WIDE


150' (45 m) C-C (MORE THAN 45MPH (70 km/h))

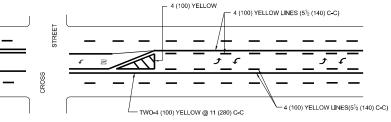

A MINIMUM OF TWO PAIRS OF TURN ARROWS SHALL BE USED, WHITE IN COLOR. ADDITIONAL PAIRS SHALL BE PLACED AT 200' (60 m) TO 300' (90 m) INTERVALS.

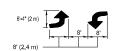


MEDIAN WITH TWO-WAY LEFT TURN LANE TYPICAL PAINTED MEDIAN MARKING

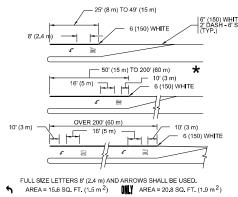


TURN LANES IN EXCESS OF 400' (120 m) IN LENGTH MAY HAVE AN ADDITIONAL SET OF ARROW - "ONLY" INSTALLED MIDWAY BETWEEN THE OTHER TWO SETS OF

TYPICAL LEFT (OR RIGHT) TURN LANE

TYPICAL TURN LANE MARKING

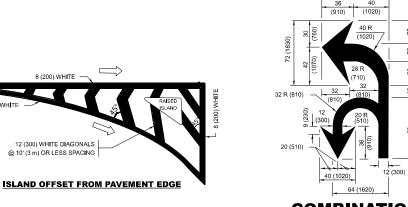

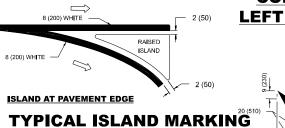

@ 10' (3 m) OR LESS SPACING

COMBINATION **LEFT AND U-TURN** 32 R (810)

ILTIIDN

LANE REDUCTION **TRANSITION**

D(FT)

SPEED LIMIT

		<u>U-</u>	<u>rurn</u>	★ LANE REDUCTION ARROWS REQUIRED AT SPEEDS OF 45 MPH C GREATER OR WHEN SPECIFIED IN PLANS.
TYPE OF MARKING	WIDTH OF LINE	PATTERN	COLOR	SPACING / REMARKS
CENTERLINE ON 2 LANE PAVEMENT	4 (100)	SKIP-DASH	YELLOW	10' (3 m) LINE WITH 30' (9 m) SPACE
CENTERLINE ON MULTI-LANE UNDIVIDED PAVEMENT	2 @ 4 (100)	SOLID	YELLOW	11 (280) C-C
NO PASSING ZONE LINES: FOR ONE DIRECTION FOR BOTH DIRECTIONS	4 (100) 2 @ 4 (100)	SOLID SOLID	YELLOW YELLOW	5½ (140) C-C FROM SKIP-DASH CENTERLINE 11 (280) G-C OMIT SKIP-DASH CENTERLINE BETWEEN
LANE LINES	4 (100) 5 (125) ON FREEWAYS	SKIP-DASH SKIP-DASH	WHITE WHITE	10' (3 m) LINE WITH 30' (9 m) SPACE
DOTTED LINES (EXTENSIONS OF CENTER, LANE OR TURN LANE MARKINGS)	SAME AS LINE BEING EXTENDED	SKIP-DASH	SAME AS LINE BEING EXTENDED	2' (600) LINE WITH 6' (1.8 m) SPACE
EDGE LINES	4 (100)	SOLID	YELLOW-LEFT WHITE-RIGHT	OUTLINE MEDIANS IN YELLOW
TURN LANE MARKINGS	6 (150) LINE; FULL SIZE LETTERS & SYMBOLS (8' (2.4m))	SOLID	WHITE	SEE TYPICAL TURN LANE MARKING DETAIL
TWO WAY LEFT TURN MARKING	2 @ 4 (100) EACH DIRECTION 8' (2.4m) LEFT ARROW	SKIP-DASH AND SOLID IN PAIRS	YELLOW	10' (3 m) LINE WITH 30' (9 m) SPACE FOR SKIP-DASH: 5½ (140) C-C BETWEEN SOLID LINE AND SKIP-DASH LINE SEE TYPICAL TWO-WAY LEFT TURN MARKING DETAIL
CROSSWALK LINES (PEDESTRIAN) A. DIAGONALS (BIKE & EQUESTRIAN) B. LONGITUDINAL BARS (SCHOOL)	2 @ 6 (150) 12 (300) @ 45° 12 (300) @ 90°	SOLID SOLID SOLID	WHITE WHITE WHITE	NOT LESS THAN 6' (1.8 m) APART 2' (600) APART 2' (600) APART SEE TYPICAL CROSSWALK MARKING DETAILS.
STOP LINES	24 (600)	SOLID	WHITE	PLACE 4" (1.2 m) IN ADVANCE OF AND PARALLEL TO CROSSWALK, IF PRESENT. OTHERWISE, PLACE AT DESIRED STOPPING POINT, PARALLEL TO CROSSROAD CENTERLINE, WHERE POSSIBLE
PAINTED MEDIANS	2 @ 4 (100) WITH 12 (300) DIAGONALS @ 45° NO DIAGONALS USED FOR 4' (1.2 m) WIDE MEDIANS	SOLID	YELLOW: TWO WAY TRAFFIC WHITE: ONE WAY TRAFFIC	11 (280) C-C FOR THE DOUBLE LINE SEE TYPICAL PAINTED MEDIAN MARKING.
GORE MARKING AND CHANNELIZING LINES	8 (200) WITH 12 (300) DIAGONALS @ 45°	SOLID	WHITE	DIAGONALS: 15' (4.5 m) C-C (LESS THAN 30MPH (50 km/h)) 20' (6 m) C-C 30MPH (50 km/h) TO 45MPH (70 km/h)) 30' (9 m) C-C (OVER 45MPH (70 km/h))
RAILROAD CROSSING 24 (600) TRANSVERSE LINES; "RR" IS 6" (1.8 m) LETTERS; 16 (400) LINE FOR "x" WHITE		WHITE	SEE STATE STANDARD 780001 AREA OF: 'R'=3,6 SQ, FT, (0.33 m ²) EACH 'X'=54,0 SQ, FT, (5,0 m ²)	
SHOULDER DIAGONALS (REQUIRED FOR SHOULDERS $\geq 8^{\circ}$)	12 (300) @ 45°	SOLID	WHITE - RIGHT YELLOW - LEFT	50' (15 m) C-C (LESS THAN 30MPH (50 km/h)) 75' (25 m) C-C (30 MPH (50 km/h) TO 45MPH (70 km/h)) 150' (45 m) C-C (OVER 45MPH (70 km/h))
U TURN ARROW	SEE DETAIL	SOLID	WHITE	16,3 SF
2 ARROW COMBINATION LEFT AND U TURN	SEE DETAIL	SOLID	WHITE	30.4 SF

FOR FURTHER DETAILS ON PAVEMENT MARKING REFER TO STANDARD SPECIFICATIONS FOR ROAD AND BRIDGE CONSTRUCTION AND STATE STANDARD 780001.

All dimensions are in inches (millimeters) unless otherwise shown.

JSER NAME = Jacob.Roth DESIGNED - EVERS REVISED - C. JUCIUS 09-09-09 REVISED -DRAWN C. JUCIUS 07-01-13 CHECKED -PLOT DATE = 7/10/2024 DATE

STATE OF ILLINOIS DEPARTMENT OF TRANSPORTATION

DISTRICT ONE 2023 ROD YARD PARKING COOK TYPICAL PAVEMENT MARKINGS CONTRACT NO. 62V99 OF 1 SHEETS STA. SHEET 1

