STATE OF ILLINOIS 09-20-2024 LETTING ITEM 081

DEPARTMENT OF TRANSPORTATION DIVISION OF HIGHWAYS

PROPOSED HIGHWAY PLANS


C-92-024-24

FAP ROUTE 316 (IL 26) SECTION (101(V-BR & R-2)BDR **PROJECT NHPP-MFAM(291)** TYPE of IMPROVEMENT: BRIDGE REPAIR SN 052-0062 OVER UP RR AT SCL OF DIXON LEE COUNTY

DIXON TOWNSHIP T21N R9E, SECTIONS 4 & 5

FOR INDEX OF SHEETS, SEE SHEET NO. 2 FOR STATE STANDARDS, SEE SHEET NO. 2

> SOUTH DIXON TOWNSHIP **T21N, R94 SECTIONS 8 & 9**

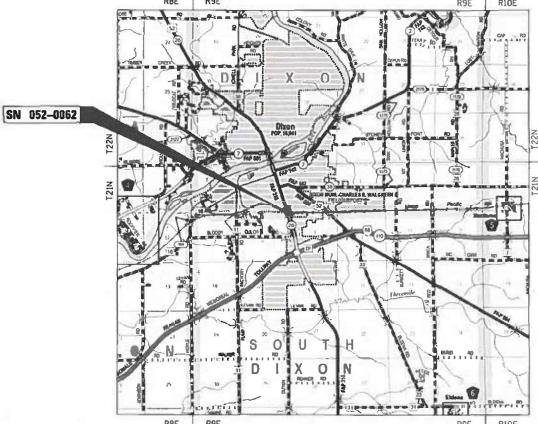

GROSS LENGTH = 360.83 FT. = 0.068 MILE

NET LENGTH = 360.83 FT. = 0.068 MILE

PROJECT ENGINEER: JAMES R. PUSH, PE (630) 930-6420 PROJECT MANAGER: MAHMOUD ETEMADI (815) 284-5393

ENGINEERING SCALES. REDUCED SIZED PLANS WILL NOT CONFORM TO STANDARD SCALES. IN MAKING MEASUREMENTS ON REDUCED PLANS, THE ABOVE SCALES MAY BE USED

JOINT UTILITY LOCATION INFORMATION FOR EXCAVATION

CONTRACT NO. 64S29

1-800-892-0123

OR 811

Ö

0



DATE: 01/21/2024 JAMES R. PUSH, P.E. LICENSE NO.: 062-048736 EXPIRES: NOVEMBER 30, 2025

ILLINOIS CONTRACT NO. 64529 D-92-061-23 LOCATION OF SECTION INDICATED THUS: -SUITE 2975 CHICAGO, IL 60601 312-634-6201 CONSULTANTS OESIGN FIRM - PROFISTRUCT ENGINEER IL LUC.- 184005283-0006 STATE OF ILLINOIS DEPARTMENT OF TRANSPORTATION

March 22, 2024

PRINTED BY THE AUTHORITY OF THE STATE OF ILLINOIS

INDEX OF SHEETS

COVER SHEET

- 2 INDEX OF SHEETS, STATE STANDARDS & GENERAL NOTES
- 3 6 SUMMARY OF QUANTITIES
- 7 SCHEDULES
- 8 12 STAGE CONSTRUCTION TRAFFIC CONTROL PLANS
- 13 PAVEMENT MARKING PLANS
- 14 ROADWAY PLAN
- 15 28 N 052**-**0062)
- 29 FRAME AND GRATE FOR INLETS, SPECIAL (DISTRICT STD 13.2c)
- 30 33 WORK ZONE SIGN DETAILS (DISTRICT STD 34.1)
- 34 36 TYPICAL PAVEMENT MARKINGS (DISTRICT STD 41.1)
- 37 GUARDRAIL REFLECTORS, TYPE C (SPECIAL) (DISTRICT STD 55.1)
- 38 TRAFFIC CONTROL AND PROTECTION AT TURN BAYS (TO REMAIN OPEN TO TRAFFIC) (DISTRICT STD 94.2)
- 39 UPRR MINIMUM COMSTRUCTION CLEARANCE ENVELOPE

STATE STANDARDS

000001-08	STANDARD SYMBOLS, ABBREVIATIONS AND PATTERNS
001006	DECIMAL OF AN INCH AND OF A FOOT
630001-13	STEEL PLATE BEAM GUARDRAIL
631031-18	TRAFFIC BARRIER TERMINAL, TYPE 6
701427-05	LANE CLOSURE, MULTILANE, INTERMITTENT OR MOVING OPERATION, FOR SPEEDS \leq 40 MPH
701601-09	URBAN LANE CLOSURE, MULTILANE, 1W OR 2W WITH NONTRAVERSABLE MEDIAN
701801-06	SIDEWALKr OR CROSSWALK CLOSURE
701901-09	TRAFFIC CONTROL DEVICES
780001-05	TYPICAL PAVEMENT MARKINGS
781001-04	TYPICAL APPLICATIONS RAISED REFLECTIVE PAVEMENT MARKERS
782006-01	GUARDRAIL AND BARRIER WALL REFLECTOR MOUNTING DETAILS



STATE OF ILLINOIS DEPARTMENT OF TRANSPORTATION

INDEX OF SHEETS, STATE STANDARDS & GENERAL NOTES SCALE: N.T.S. | SHEET 1 OF 1 SHEETS | STA. TO STA.

GENERAL NOTES

THE CONTRACTOR SHALL SUBMIT A SEQUENCE OF CONSTRUCTION OPERATIONS TO THE RESIDENT ENGINEER FOR APPROVAL BEFORE THIS PROJECT IS STARTED.

ALL BORROW/WASTE/USE SITES MUST BE APPROVED BY THE DEPARTMENT PRIOR TO REMOVING ANY MATERIAL FROM THE PROJECT OR INITIATING ANY EARTHMOVING ACTIVITIES, INCLUDING TEMPORARY STOCKPILING OUTSIDE THE LIMITS OF

THE CONTRACTOR SHALL BE RESPONSIBLE FOR PROTECTING UTILITY PROPERTY DURING CONSTRUCTION OPERATIONS AS OUTLINED IN ARTICLE 107.31 OF THE STANDARD SPECIFICATIONS. A MINIMUM OF 48 HOURS ADVANCE NOTICE IS REQUIRED FOR NON-EMERGENCY WORK. THE JULIE NUMBER IS 800-892-0123.

IDOT IS NOT A MEMBER OF JULIE. THERE ARE NO IDOT UTILITIES WITHIN THE PROJECT AREA.

ALL ELEVATIONS SHOWN IN PLANS ARE BASED ON NORTH AMERICAN VERTICAL DATUM OF 1988 (NAVD 88).

WHEN RELOCATE TEMPORARY CONCRETE BARRIER IS SPECIFIED, THE WALL SHALL BE REMOVED, STORAGE AND TRANSPORTATION TO AND FROM STORAGE, WHEN THE WALL IS NOT NEEDED FOR A TIME AS SHOWN ON THE STAGING PLANS, RELOCATED AND REINSTATED AT THE NEW LOCATION. THE REINSTALLATION REQUIREMENTS SHALL BE THE SAME AS THOSE FOR A NEW INSTALLATION. THIS SHALL BE PAID FOR AT THE CONTRACT UNIT PRICE PER FOOT FOR RELOCATE TEMPORARY CONCRETE BARRIER.

THERE ARE NO COMMITMENTS ASSOCIATED WITH THIS PROJECT.

CONSTRUCTION.

THE QUANTITIES INCLUDED IN THE PLANS FOR HOT-MIX ASPHALT RESURFACING ARE INTENDED TO GIVE THE COVERAGE SHOWN ON THE TYPICAL CROSS SECTIONS. IT IS NOT INTENDED TO INCREASE THE THICKNESS OF THE HOT-MIX ASPHALT MIXTURE IN ORDER TO USE ALL OF THE QUANTITIES INCLUDED IN THE CONTRACT.

ALL SAW CUTS NECESSARY TO COMPLETE THE WORK DETAILED IN THESE PLANS SHALL BE INCLUDED IN THE COST FOR THE VARIOUS PAY ITEMS INVOLVED.

THE FOLLOWING MIXTURE REQUIREMENTS ARE APPLICABLE FOR THIS PROJECT:

MIXTURE USE(S): PG: PG: PG: PG: PG: 4.0% @ N DESIGN - 50 MIXTURE COMPOSITION: IL 9.5 FRICTION AGGREGATE: QUALITY MANAGEMENT PROGRAM: QC / QA		
DESIGN AIR VOIDS: 4.0% @ N DESIGN - 50 MIXTURE COMPOSITION: IL 9.5 FRICTION AGGREGATE: MIX "C" QUALITY MANAGEMENT PROGRAM: QC / QA	MIXTURE USE(S):	HMA CONC SURF CSE
MIXTURE COMPOSITION: IL 9.5 FRICTION AGGREGATE: MIX "C" QUALITY MANAGEMENT PROGRAM: QC / QA	PG:	PG 64 -22
FRICTION AGGREGATE: MIX "C" QUALITY MANAGEMENT PROGRAM: QC / QA	DESIGN AIR VOIDS:	4.0% @ N DESIGN - 50
QUALITY MANAGEMENT PROGRAM: QC / QA	MIXTURE COMPOSITION:	IL 9.5
	FRICTION AGGREGATE:	MIX "C"
	QUALITY MANAGEMENT PROGRAM:	QC / QA
SUBLOT SIZE: N / A	SUBLOT SIZE:	N / A

THE FOLLOWING RATES OF APPLICATION HAVE BEEN USED TO CALCULATE PLAN QUANTITIES:

BITUMINOUS MATERIALS (TACK COAT)
BITUMINOUS MATERIALS (TACK COAT)
HOT-MIX ASPHALT MATERIAL
AGGREGATE MATERIAL

0.05 LBS / SQ FT (ON PAVEMENT)
0.025 LBS / SQ FT (FOG)
0.056 TON / SQ YD PER 1"
1.60 TONS / CU YD

PAVEMENT MARKING SHALL BE DONE ACCORDING TO STANDARD 780001, EXCEPT AS FOLLOWS:

- ALL WORDS, SUCH AS ONLY, SHALL BE 8 FEET HIGH.
- ALL NON-FREEWAY ARROWS SHALL BE THE LARGE SIZE.
- THE DISTANCE BETWEEN YELLOW NO-PASSING LINES SHALL BE 8 INCHES, NOT 7 INCHES, AS SHOWN IN THE DETAIL OF TYPICAL LANE AND EDGE LINES.
- CENTERLINE SKIP DASH PAVEMENT MARKING ON MULTI-LANE DIVIDED, MULTI-LANE UNDIVIDED, AND ONE-WAY ROADWAY SHALL BE ACCORDING TO DISTRICT STANDARD 41.1.

UNLESS DIRECTED BY THE ENGINEER, PAVEMENT MARKING LINES SHALL NOT BE LAID DIRECTLY OVER A LONGITUDINAL CRACK OR JOINT NOR OVER A TAR OR ASPHALT PAINTED LINE.

- THE EDGE OF A CENTERLINE OR LANE LINE SHALL BE OFFSET A MINIMUM DISTANCE OF 2" FROM A LONGITUDINAL CRACK OR JOINT
- EDGE LINES SHALL BE APPROXIMATELY 2" FROM THE EDGE LINE OF PAVEMENT. SEE SECTION 780 OF THE STANDARD SPECIFICATIONS FOR TRAFFIC CONTROL ITEMS.

AREAS OF DECK REPAIRS SHOWN ARE ESTIMATED. THE ENGINEER SHALL SHOW ACTUAL LOCATIONS OF DECK REPAIRS ON AS-BUILT PLANS.

MICROSILICA CONCRETE SHALL INCLUDE MACRO-SIZE, TYPE III, SYNTHETIC FIBERS MEETING THE 'BRIDGE DECK MICROSILICA CONCRETE OVERLAY' SPECIAL PROVISION.

80%	FED
20% S	TAT

	ITEM			LEE COUNTY		
CODE NO.		UNIT	TOTAL QUANTITY	CONSTRUCTI	ON CODE	
				Roadway 0006	BRIDGE 0059	
				ROADWAY	SN 052-0062	
20200100	EARTH EXCAVATION	CU YD	100	100		
21101635	TOPSOIL FURNISH AND PLACE, 9"	SQ YD	393	393		
25000110	SEEDING, CLASS 1A	ACRE	0.25	0.25		
25000400	NITROGEN FERTILIZER NUTRIENT	POUND	23	23		
25000500	PHOSPHORUS FERTILIZER NUTRIENT	POUND	23	23		
25000600	POTASSIUM FERTILIZER NUTRIENT	POUND	23	23		
25100620	EDOC ION CONTROL DI ANIZET	50 VD	202	202		
25100630	EROSION CONTROL BLANKET	SQ YD	393	393		
40600985	PORTLAND CEMENT CONCRETE SURFACE REMOVAL - BUTT JOINT	SQ YD	428		428	
42001300	PROTECTIVE COAT	SQ YD	1,074		1,074	
42400200	PORTLAND CEMENT CONCRETE SIDEWALK 5 INCH	SQ FT	275		275	
44000100	PAVEMENT REMOVAL	SQ YD	393	393		
				,,,,,,,,,,,,,,,,,,,,,,,,,,,,,,,,,,,,,,,		
44000500	COMBINATION CURB AND GUTTER REMOVAL	FOOT	301		301	
44000600	SIDEWALK REMOVAL	SQ FT	275		275	
48203033	HOT-MIX ASPHALT SHOULDERS, 9"	SQ YD	393	393		
50102400	CONCRETE REMOVAL	CU YD	20.1		20.	

^{*} DENOTES SPECIALTY ITEM



USER NAME = Jpush	DESIGNED	-	JRP	REVISED	-
	DRAWN	-	JRP	REVISED	=
PLOT SCALE = 40.0000 '/ in.	CHECKED	-		REVISED	=
PLOT DATE = 1/21/2024	DATE	-	05/05/2022	REVISED	=

STATE OF ILLINOIS DEPARTMENT OF TRANSPORTATION

	;	SUMMARY	OF QU	ANTITIES	
CALE: N.T.S.	SHEET 1	OF 4	SHEETS	STA.	TO STA.

				LEE COUNTY		
CODE NO.	ITEM	UNIT	TOTAL QUANTITY	CONSTRUCTION CODE		
			,	Roadway 0006	BRIDGE 0059	
				ROADWAY	SN 052-0062	
50157300	PROTECTIVE SHIELD	SQ YD	506		506	
50300255	CONCRETE SUPERSTRUCTURE	CU YD	20.1		20.	
50800205	REINFORCEMENT BARS, EPOXY COATED	POUND	3,155		3,155	
50901739	BRIDGE FENCE RAILING, CURVED	FOOT	169		169	
52000110	PREFORMED JOINT STRIP SEAL	ГООТ	183		183	
58700300	CONCRETE SEALER	SQ FT	20		20	
59000200	EPOXY CRACK INJECTION	FOOT	379.5		379.	
60605000	COMBINATION CONCRETE CURB AND GUTTER, TYPE B-6.24	FOOT	301		301	
67000400	ENGINEER'S FIELD OFFICE, TYPE A	CAL MO	3	3		
67100100	MOBILIZATION	L SUM	1	0.5	0.5	
70102630	TRAFFIC CONTROL AND PROTECTION, STANDARD 701601	L SUM	1	1		
70102640	TRAFFIC CONTROL AND PROTECTION, STANDARD 701801	L SUM	1	1		
70103815	TRAFFIC CONTROL SURVEILLANCE	CAL DA	15	15		
70107025	CHANGEABLE MESSAGE SIGN	CAL DA	56	56		
70300150	SHORT TERM PAVEMENT MARKING REMOVAL	SQ FT	4,647	4,647		
70307100	TEMPORARY PAVEMENT MARKING LETTERS AND SYMBOLS - TYPE IV TAPE	SQ FT	52	52		
	TEM ONANT TAVEMENT MAINTING EETTERS AND STMBOLS - THE TV TATE	30 11	32	32		

^{*} DENOTES SPECIALTY ITEM



USER NAME = Jpush	DESIGNED	-	JRP	REVISED	-
	DRAWN	-	JRP	REVISED	-
PLOT SCALE = 40.0000 '/ 10.	CHECKED	-		REVISED	-
PLOT DATE = 1/21/2024	DATE	-	05/05/2022	REVISED	=

	S	UMMARY	OF QU	ANTITIES	
SCALE: N.T.S.	SHEET 2	OF 4	SHEETS	STA.	TO STA.

809	%	FE	
20%	S	TAT	Ī

					LEE COUNTY		
CODE NO.	CODE NO.	ITEM	UNIT	TOTAL QUANTITY	CONSTRUCTION CODE		
					Roadway 0006	BRIDGE 0059	
				ROADWAY	SN 052-0062		
	70307120	TEMPORARY PAVEMENT MARKING - LINE 4" - TYPE IV TAPE	FOOT	13,786	13,786		
	78009000	MODIFIED URETHANE PAVEMENT MARKING - LETTERS AND SYMBOLS	SQ FT	188	188		
	78009004	MODIFIED URETHANE PAVEMENT MARKING - LINE 4"	FOOT	8,343	8,343		
	78009008	MODIFIED URETHANE PAVEMENT MARKING - LINE 8"	FOOT	692	692		
	78009012	MODIFIED URETHANE PAVEMENT MARKING - LINE 12"	ГООТ	239	239		
	78011000	GROOVING FOR RECESSED PAVEMENT MARKING, LETTERS AND SYMBOLS	SQ FT	188	188		
	78011025	GROOVING FOR RECESSED PAVEMENT MARKING 5"	FOOT	8,343	8,343		
	78011045	GROOVING FOR RECESSED PAVEMENT MARKING 9"	FOOT	692	692		
	78011065	GROOVING FOR RECESSED PAVEMENT MARKING 13"	FOOT	239	239		
	78100100	RAISED REFLECTIVE PAVEMENT MARKER	EACH	106	106		
	78200005	GUARDRAIL REFLECTORS, TYPE A	EACH	5	5		
	78300200	RAISED REFLECTIVE PAVEMENT MARKER REMOVAL	EACH	106	106		
	78300201	PAVEMENT MARKING REMOVAL - GRINDING	SQ FT	3,642	3,642		
	X0322102	TEMPORARY SIDEWALK RAMP	EACH	4	4		
	X0322215	CLEANING BRIDGE SCUPPERS AND DOWNSPOUTS	EACH	8			



USER NAME = Jpush	DESIGNED	-	JRP	REVISED	-
	DRAWN	-	JRP	REVISED	=
PLOT SCALE = 40.0000 '/ in.	CHECKED	-		REVISED	=
PLOT DATE = 1/21/2024	DATE	-	05/05/2022	REVISED	=

STATE OF ILLINOIS DEPARTMENT OF TRANSPORTATION

SUMMARY OF QUANTITIES											
SCALE: N.T.S.	SHEET 3	OF 4	SHEETS	STA.	TO STA.						

80% FED 20% STATE

				LEE COUNTY			
CODE NO.	ITEM	UNIT	TOTAL QUANTITY	CONSTRUCT	ION CODE		
				Roadway 0006	BRIDGE 0059		
				ROADWAY	SN 052-0062		
X5030250	BRIDGE DECK GROOVING (LONGITUDINAL)	SQ YD	916		916		
X5091600	STEEL RAILING REMOVAL	FOOT	172		172		
X6020710	CATCH BASINS TO BE ADJUSTED WITH SPECIAL FRAME AND GRATE	EACH	2		2		
Z0001800	APPROACH SLAB REPAIR (PARTIAL DEPTH)	SQ YD	2		2		
Z0006014	BRIDGE DECK LATEX CONCRETE OVERLAY, 2 1/2 INCHES	SQ YD	1,037		1,037		
Z0007430	TEMPORARY SIDEWALK	SQ FT	725	725			
Z0012130	BRIDGE DECK SCARIFICATION 3/4"	SQ YD	1,037		1,037		
	BRIDGE DECK SCARIFICATION 3/4	30 10	1,037		1,037		
Z0012754	STRUCTURAL REPAIR OF CONCRETE (DEPTH EQUAL TO OR LESS THAN 5 INCHES)	SQ FT	20		20		
Z0016001	DECK SLAB REPAIR (FULL DEPTH, TYPE I)	SQ YD	24		24		
Z0016002	DECK SLAB REPAIR (FULL DEPTH, TYPE II)	SQ YD	24		24		
Z0018051	DRAINAGE SCUPPERS TO BE ADJUSTED	EACH	4		4		
				_			
Z0029090	DIAMOND GRINDING (BRIDGE SECTION)	SQ YD	914		914		
Z0048665	RAILROAD PROTECTIVE LIABILITY INSURANCE	L SUM	1		1		

^{*} DENOTES SPECIALTY ITEM



USER NAME = Jpush	DESIGNED	-	JRP	REVISED	-
	DRAWN	-	JRP	REVISED	-
PLOT SCALE = 40.0000 ' / in.	CHECKED	-		REVISED	-
PLOT DATE = 1/21/2024	DATE	-	05/05/2022	REVISED	=

STATE OF ILLINOIS DEPARTMENT OF TRANSPORTATION

SCALE: N.T.S.	SHEET 4	OF 4	SHEETS	STA.	TO STA.	•

					PAVEME	NT MARKING	REMOVAL -	GRINDING				
	LOCA	ATION						78300201				
				LETTERS AND SYMBOLS			LINE 4"		LIN	E 8"	LINE	12"
				LETTERS AN	DSYMBOLS	SOLID	SKIP DASH	SOLID	SOLID	DOTTED	SOLID	
STATION	ТО	STATION	SIDE	ARROWS	"ONLY"	LANE LINE	LANE LINE	MEDIAN EDGE	TURN LANE	TURN LANE	MEDIAN DIAGNAL LINE	MEDIAN CHEVRON
							,	SQ FT			•	
NORTH SECTION	ON											
28+50.0	ТО	34+79.0	LT & RT				104.8					
28+50.0	TO	30+30.0	LT & RT			120.0						
30+30.0	TO	34+79.0	LT & RT					598.7	-		191.0	
32+43.5	ТО	33+60.0	RT					,		25.9		
33+60.0	TO	34+74.5	LT & RT	31.2					159.3			48.0
35+53.0	TO	39+00.0	LT & RT			231.3	57.8	231.3				
35+53.0	TO	37+05.0	RT	31.2	20.8				101.3			
SOUTH SECTION	ON									-	9.00	
39+00.0	TO	43+96.0	LT & RT			330.7	82.7	330.7				
42+78.0	TO	43+96.0	RT [®]	31.2	20.8							
44+87.0	TO	49+49.0	LT & RT			308.0	77.0	308.0				
44+87.0	TO	46+03.0	LT	31.2	20.8				77.3			
46+03.0	TO	46+87.0	LT							18.7		
			TOTAL	156.0	83.2	990.0	322.3	1468.7	338.0	44.6	191.0	48.0
			USE					3642				

	LOCA	ATION		TEMPORARY PAVEMENT MAR 70307100		7	0307120			
	LOOF	T	_	70307100			- TYPE IV TAPE			
				LETTERS AND SYMBOLS - TYPE IV TAPE	SC	DLID I	10 100 April 10 10 10 10 10 10 10 10 10 10 10 10 10	DOTTED		
STATION	TO	STATION	SIDE	LEFT ARROWS		ELINE	INTERSECTION			
OTATION	10	OTATION	OIDL	WHITE	YELLOW	WHITE	YELLOW	WHITE		
				SQFT	ILLLOVV	VVIIIL	FOOT	VVIIIL		
				3011			1001			
TAGE I			_							
30+00.0	ТО	34+46.0	RT		446.0					
30+00.0	TO	34+83.0	LT & RT		483.0					
30+00.0	TO	34+84.0	LT & RT		1800.000000	484.0				
30+00.0	TO	34+86.0	LT			486.0				
34+83.0	TO	35+50.0	RT			FF	134.0	67.0		
35+50.0	TO	40+49.0	RT		998.0	499.0				
40+49.0	TO	43+99.5	LT & RT			350.5				
40+49.0	TO	43+70.0	RT		321.0					
40+49.0	TO	43+99.5	RT		350.5					
43+99.5	TO	44+95.0	LT					95.5		
44+00.0	TO	44+96.0	LT & RT				96.0			
44+96.0	TO	51+92.0	LT		696.0					
44+96.0	TO	49+45.0	LT			464.5				
48+52.5	TO	49+45.0	LT					92.5		
49+45.0	TO	51+92.0	LT			247.0				
TAGE II										
26+00 0	TO	34+85 0	IT&RT			885 0				
26+00.0	TO	34+85.0	RT		1366.5					
34+85.0	TO	35+54.0	LT				69.0	69.0		
35+54.0	TO	43+98.0	LT & RT		1688.0	1688.0				
43+98.0	TO	44+87.0	LT & RT				89.0	89.0		
44+87.0	TO	48+76.0	RT			389.0				
44+87.0	TO	46+30.0	RT		143.0					
44+87.0	TO	47+40.0	LT		253.0	253.0				
45+27.0	TO	45+82.0	LT	46.8						
47+40.0	TO	48+32.0	LT					92.0		
48+11.0	TO	49+36.0	LT					125.0		
48+32.0	TO	51+92.0	LT		360.0					
49+36.0	TO	51+92.0	LT			256.0				
			TOTAL	100,000	7105.0	5755	388	537.5		
			USE	46.8			13786			

				1	MODIFIED	IRETHANE P.	AVEMENT MAR	KING					
	LOCA	TION		78009000		78009004	0.	7800	9008	78009	9012		
				LETTERS AND	LINE 4"		LIN	E 8"	LINE 12"				
				SYMBOLS	SOLID SKIP DASH		SOLID	DOTTED	SOLID	SOLID	SOLID		
STATION	ТО	STATION	SIDE	ARROWS	LANE LINE	LANE LINE	MEDIAN EDGE	LEFT TURN LANE	LEFT TURN LANE	MEDIAN DIAGNAL LINE	MEDIAN CHEVRON		
				WHITE	W	WHITE		W-	ITE	YELLOW	WHITE		
				SQFT									
NORTH SECT	ION												
28+50.0	TO	34+79.0	LT & RT			314.5							
28+50.0	TO	30+30.0	LT & RT		360.0								
30+30.0	TO	34+79.0	LT & RT				1796.0			191.0			
32+43.5	TO	33+60.0	RT					38.8					
33+60.0	TO	34+74.5	LT & RT	46.8					239.0		48.0		
35+53.0	TO	39+00.0	LT & RT		694.0	173.5	694.0						
35+53.0	TO	37+05.0	LT	46.8					152.0				
SOUTH SECTI	ION								5				
39+00.0	TO	43+96.0	LT & RT		992.0	248.0	992.0						
42+78.0	TO	43+96.0	RT	46.8					118.0				
44+87.0	TO	49+49.0	LT & RT		924.0	231.0	924.0						
44+87.0	TO	46+03.0	LT	46.8					116.0				
46+03.0	TO	46+87.0	LT					28.0					
			TOTAL	187.2	2970.0	967.0	4406.0	66.8	625.0	191.0	48.0		
			USE	188		8343		6	92	23	9		


QU	JANDEL CONSULTANTS
1/21/2024	10:31:13 AM
	1/21/2024


USER NAME =	jpush	DESIGNED -	REVISED -
		DRAWN -	REVISED -
PLOT SCALE =	100.000 ' / in.	CHECKED -	REVISED -
PLOT DATE =	1/21/2024	DATE -	REVISED -


STATE OF ILLINOIS
DEPARTMENT OF TRANSPORTATION


_	1						1				I ====::			
	STAGE	CONSTRI	JCTIO	N TRAFFIC	F.A.P. RTE	SECTION		COUNTY	TOTAL SHEETS					
			9	CHEDULE	s		316	101(V-BR & R-2)BDR		LEE	38	7		
		OUILDOLLO								CONTRACT NO. 64S29				
	SCALE: N.T.S.	.E: N.T.S. SHEET 1 OF 1 SHEETS STA. TO STA.						ILLINOIS FED. AID PROJECT						


STATE OF ILLINOIS
DEPARTMENT OF TRANSPORTATION
STAGE CONSTRUCTION TRAFFI
MOT TYPICAL S

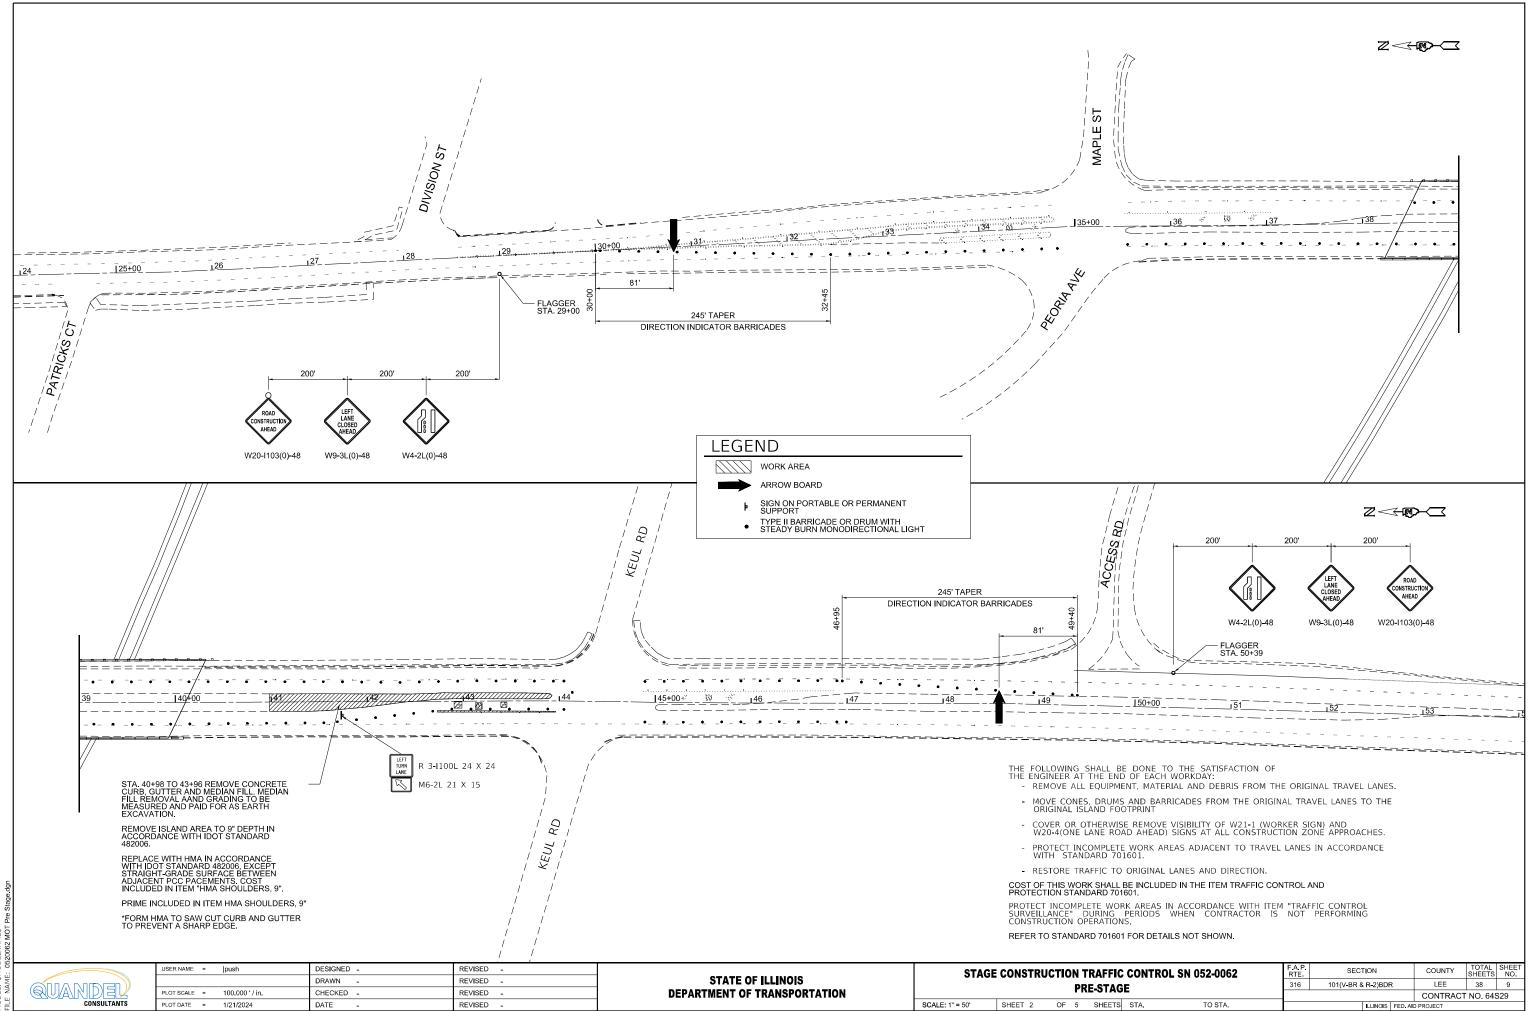


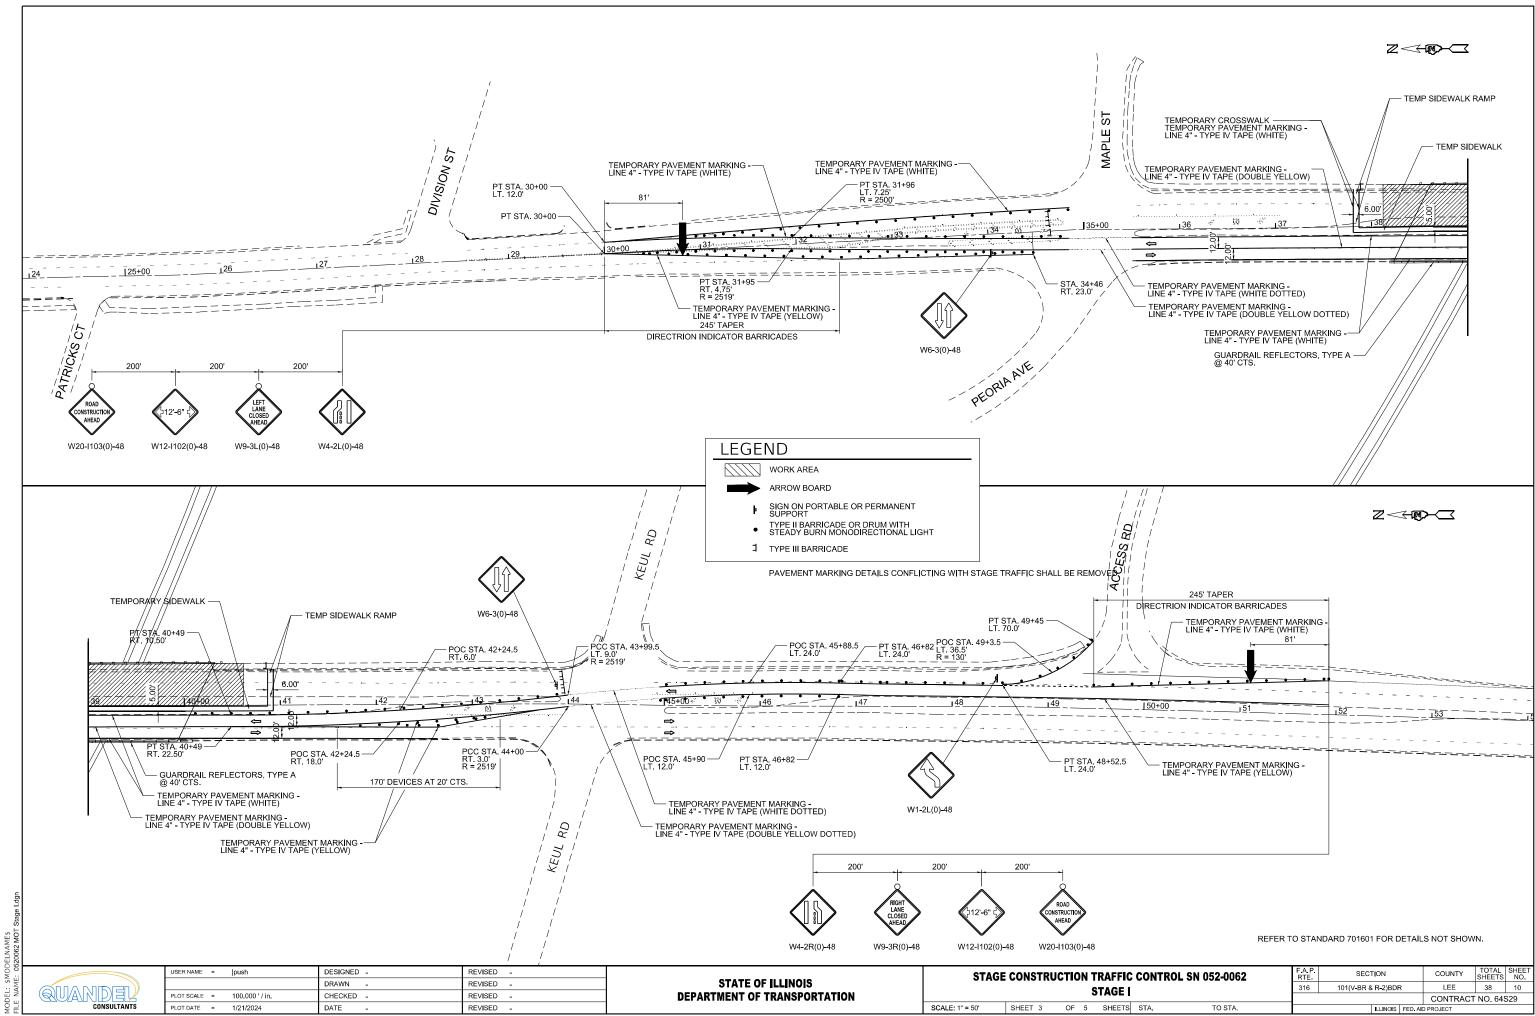

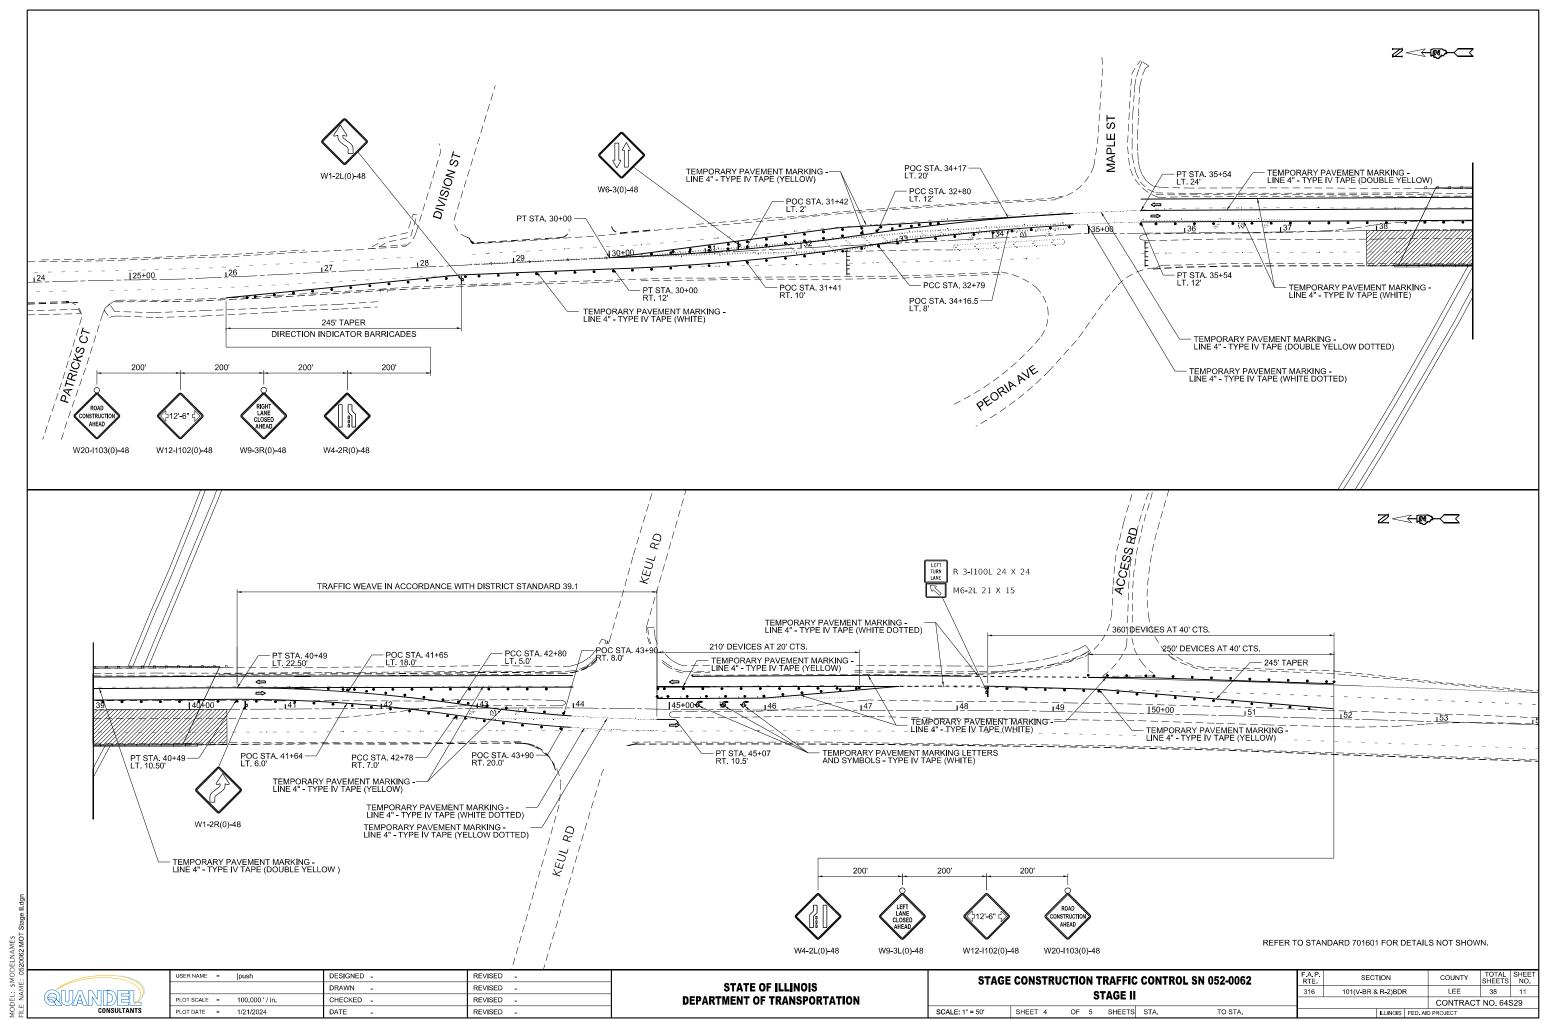

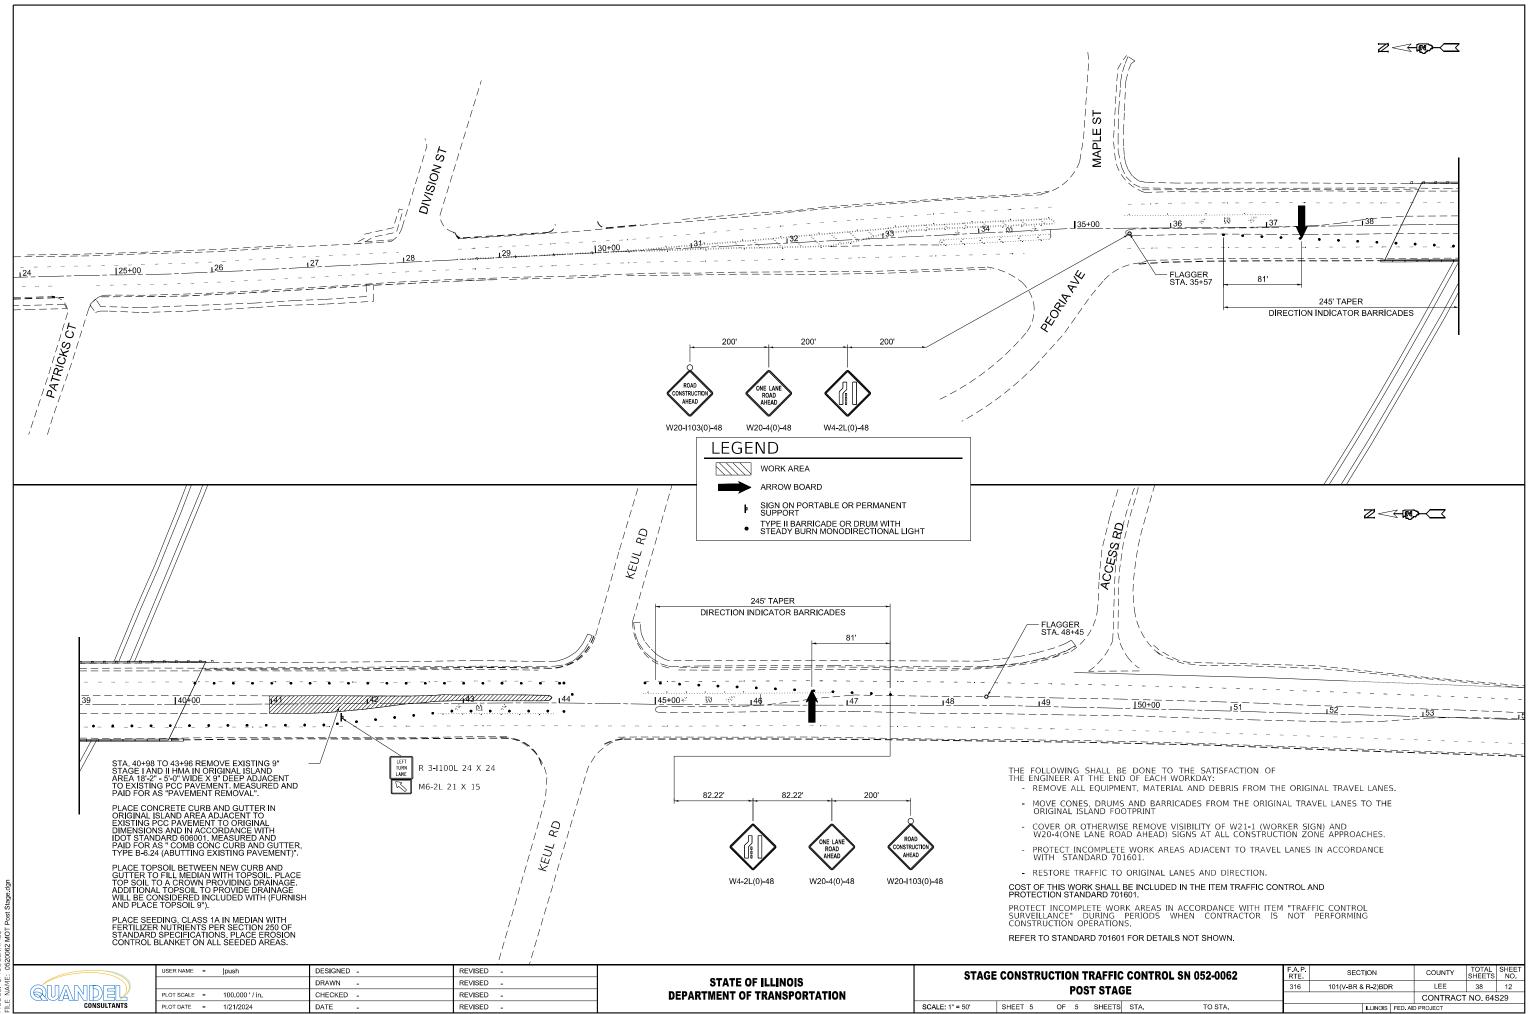

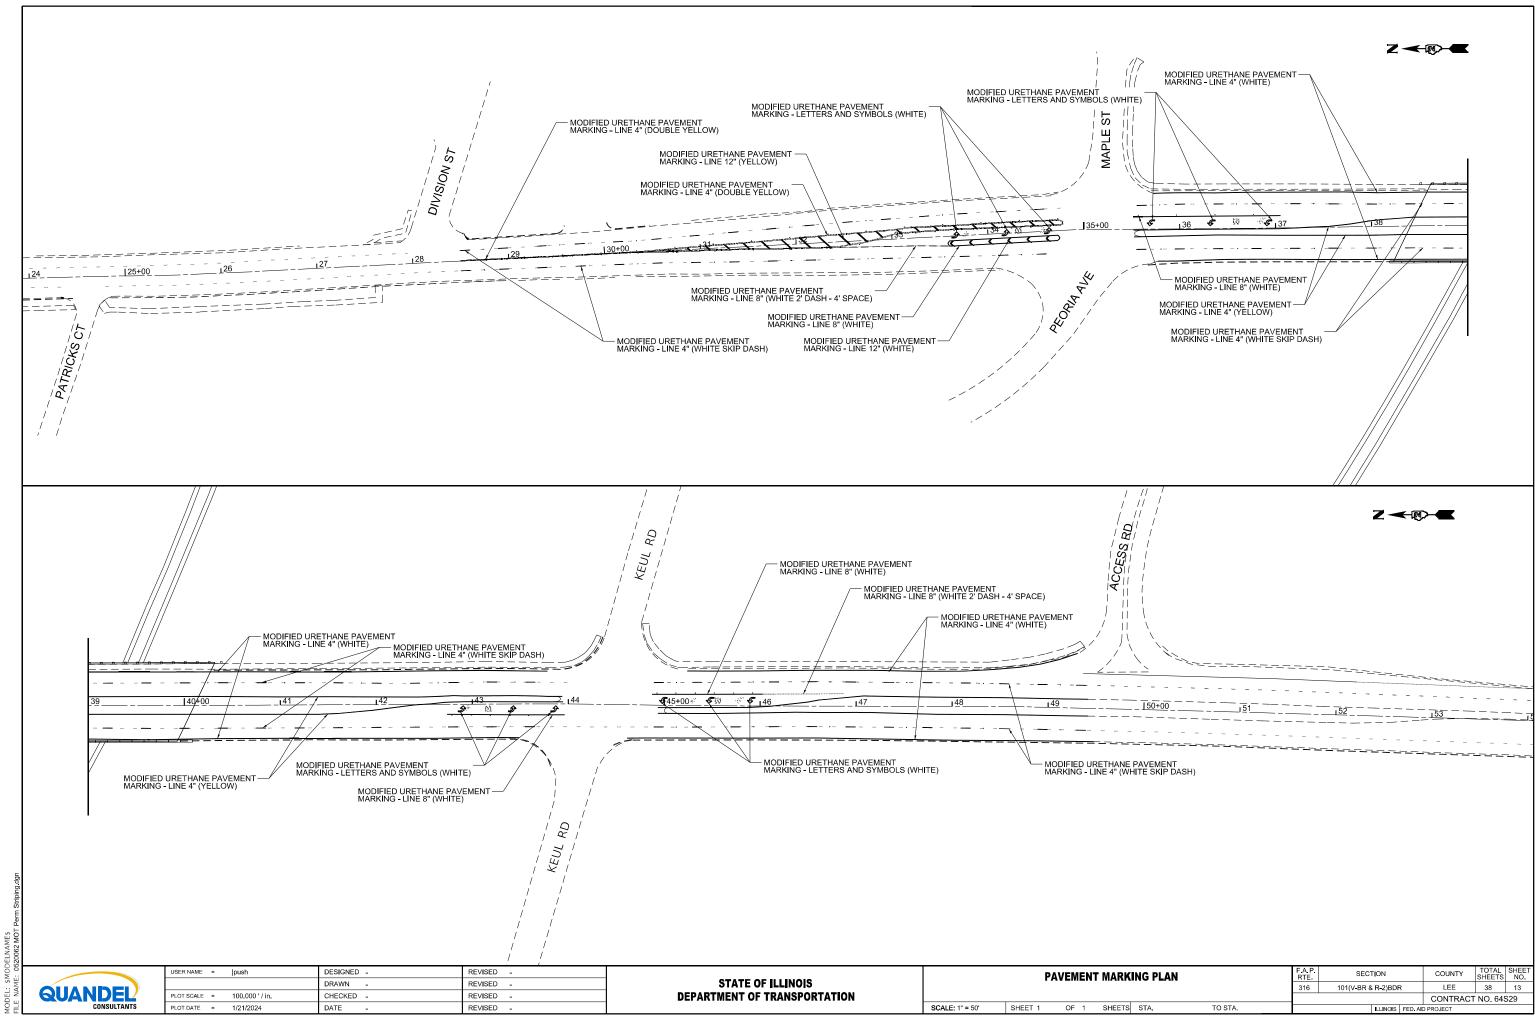

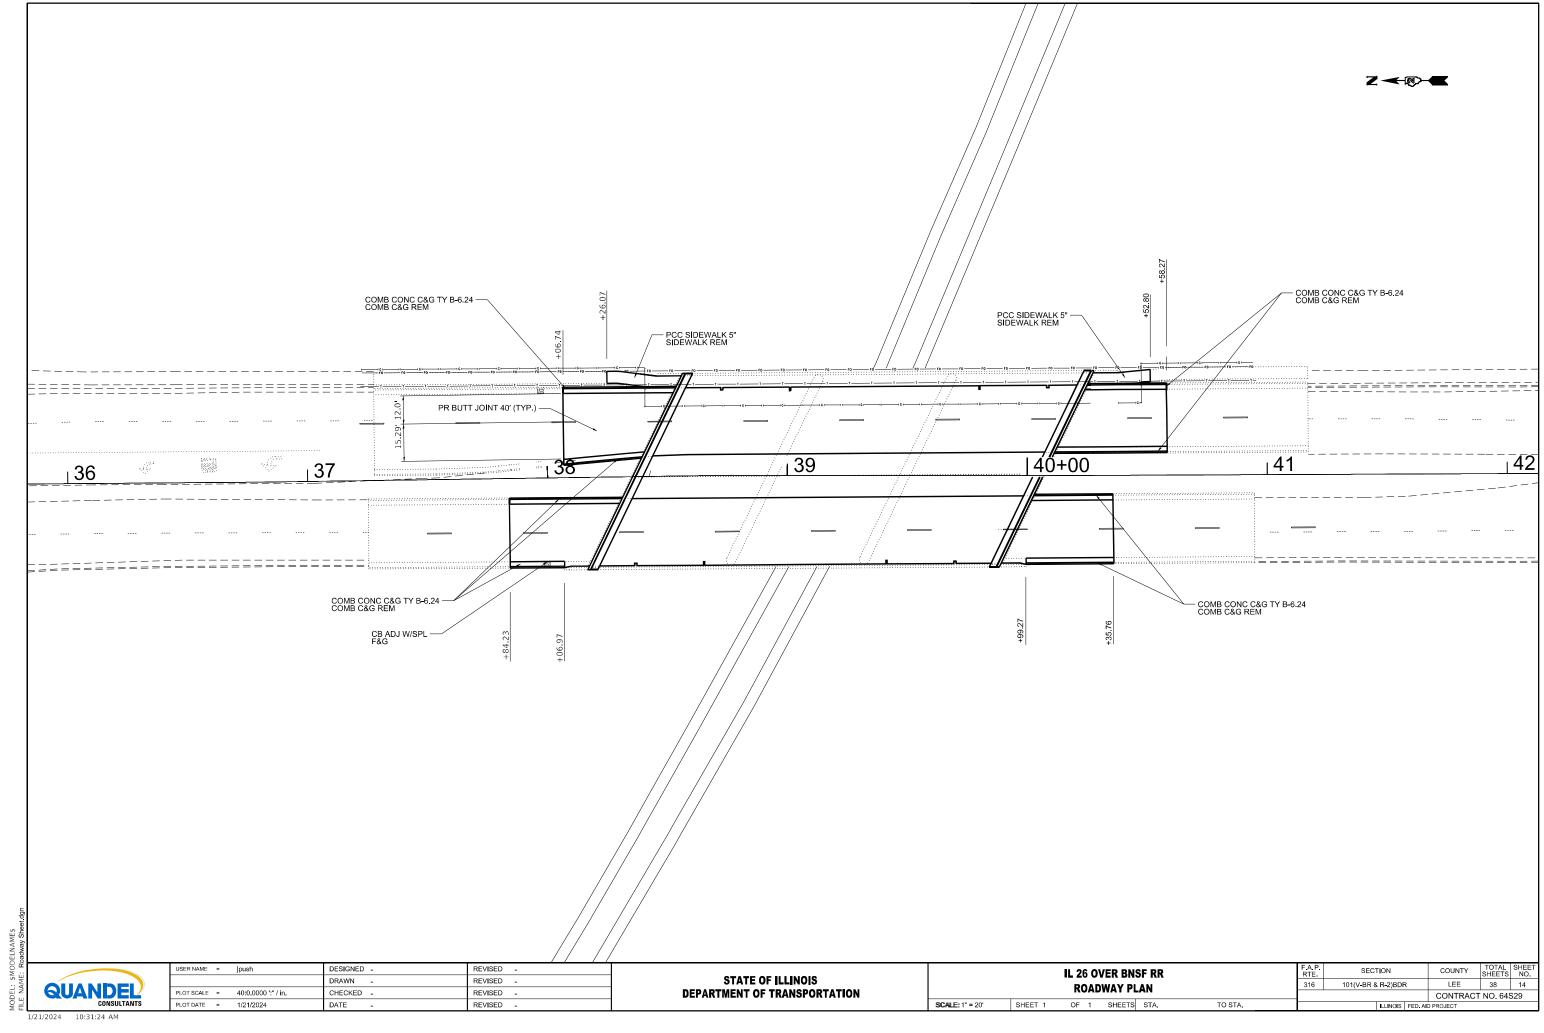

reinforced concrete deck. The back-to-back-of abutment bridge length is 172'-7¾" and the out-to-out bridge deck width is 81'-9". The proposed work consists of deck scarification, joint reconstruction, deck and approach slab repair and placement of a new latex concrete overlay, along with curved bridge fence installation on the east side and various substructure repairs. A single lane of traffic in each direction shall be maintained during the work using median cross-overs. 172'-7¾" Back-to-Back of Abutments 168'-51/2" End-to-End Bridge Fence Railing in the plans. NORTH ABUT. SOUTH ABUT. **Q** Union Pacific Railroad DESIGN SPECIFICATIONS 2002 AASHTO Standard Specifications for Highway Bridges, (Proposed) LOADING HS 20-44 PIER 1 PIER 2 ELEVATION Existing and proposed loading 172'-7¾" Back to Back Abutments 166'-6" (-to-(Abutment Bearing Lines ≠ © U.P. RR Mainline ∠ 50'-0"± × Limits of Protective Shield Q NB IL 26 P.G.L. NB Lanes 26°00′00″ - Back South Abut - @ IL 26 Bk. North Abut. P.G.L. SB Lanes € SB IL 26 -© North Abut. — © Pier 1 - Ç Pier 2 € South Abut. JEFFREY P. 55'-6" (Span 1) 55'-6" (Span 2) 55'-6" (Span 3) BUCHOLC 081-005605 PLANDate: 01/23/2024 Expires 11/30/2024 **GENERAL PLAN AND ELEVATION STATE OF ILLINOIS**

SCOPE OF WORK

- $\langle A \rangle$ Perform required pre-stage work. See Roadway Plans.
- $\langle B \rangle$ Reconstruct expansion joints at North and South Abutments.
- $\langle C \rangle$ Scarify $\frac{3}{4}$ " from bridge deck slab, as shown in the plans.
- $\langle D \rangle$ Perform full depth deck slab repair where required after scarification and corresponding deck survey.
- $\langle E \rangle$ Perform partial depth approach slab repair, where shown.
- $\langle F \rangle$ Adjust bridge deck scuppers. Clean scuppers and deck drains.
- $\langle G \rangle$ Place 2½" Latex Concrete Overlay over bridge deck slab, as shown
- $\langle H \rangle$ Perform $\frac{1}{4}$ " Diamond Grinding (Bridge Section) and Bridge Deck Grooving (Longitudinal) to bridge deck.
- $\langle I \rangle$ Perform concrete patching and crack sealing to piers and abuts.
- $\langle J \rangle$ Apply concrete sealant to repaired areas of substructure concrete.
- $\langle K \rangle$ Remove existing bridge railing on sidewalk (east) side of bridge, and place curved bridge fence railing.
- $\langle L \rangle$ Replace approach sidewalk and approach curb & gutter sections as shown in the plans. Adjust catch basin and install new frame & grate along west side of north approach in SB lanes.
- $\langle M \rangle$ Apply Protective Coat to the new deck overlay, reconstructed joints, and new sidewalk & curb sections.
- $\langle N \rangle$ Construct butt joint and resurface bridge approaches.

DESIGN STRESSES

FIELD UNITS (NEW)


 $f'c = 4,000 \ psi$

fy = 60,000 psi (Reinforcement)

FIELD UNITS (EXISTING)

 $f'c = 3,500 \ psi$

fy = 60,000 psi (Reinforcement)

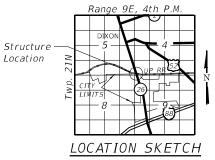

GENERAL PLAN & ELEVATION F.A.P. 316 (IL 26) OVER UP RR SEC (101(V-BR & R-2)BDR LEE COUNTY STATION 39+26.00 STRUCTURE NO. 052-0062



USER NAME =	DESIGNED	-	BMW	REVISED -
	CHECKED	-	JRT	REVISED -
PLOT SCALE =	DRAWN	-	BMW	REVISED -
PLOT DATE =	CHECKED	-	JRT	REVISED -

Existing Structure 052-0062, built in 1988, is a three-span precast, prestressed conrete beam superstructure supporting a

DEPARTMENT OF TRANSPORTATION

IL 26 OVER UP RR - S.N. 052-0062 SHEET 1 OF 14 SHEETS

SECTION 316 101(V-BR & R-2)BDR LEE 38 15 CONTRACT NO. 64S29

INDEX OF SHEETS

- 1. General Plan and Elevation
- 2. General Data
- 3. Stage Construction Details
- 4. Wearing Surface Details
- 5. Reflected Deck and Approach Slab Patching Details
- 6. Expansion Joint Concrete Removal Details
- 7. Expansion Joint Concrete Replacement Details I
- 8. Expansion Joint Concrete Replacement Details II
- 9A-9B. Preformed Joint Strip Seal
 - 10. Bridge Fence Railing Detail I
- 11. Bridge Fence Railing Detail II
- 12. Pier 1 Repairs
- 13. Pier 2 Repairs
- 14. Abutment Repairs

GENERAL NOTES

- 1. Plan dimensions and details relative to the existing plans are subject to nomintal construction variations. The Contractor shall field verify existing dimensions and details affecting new construction and make necessary approved adjustments prior to construction or ordering of materials. Such variations shall not be cause for additional compensation for a change of scope of work, however, the Contractor will be paid for the quantity actually furnished at the unit price for the work.
- 2. Existing reinforcement bars extending into the removal area shall be cleaned, straightened and incorporated into the new construction. Any reinforcement bars that are damaged during concrete removal operations shall be repaired or replaced with approved bar splicers or anchorage system. Cost inlouded with Concrete Removal.
- 3. Joint openings shall be adjusted according to article 520.04 of the Std. Specs. when the deck is poured at an ambient temperature other than 50°F.
- 4. Reinforcement bars designated (E) shall be epoxy coated.
- 5. Prior to pouring the new concrete deck, all heavy or loose rust, loose mill scale and other loose or potentially detrimental foreign material shall be removed from the surfaces in contact with the concrete. Tightly adhered paint may remain unless otherwise noted. Removal shall be accomplished by methods that will not damage the steel and the cost will be included in the pay item covering removal of the existing concrete.
- 6. Traffic will be maintained using stage construction.
- 7. The Contractor shall use extreme care during concrete removal so as not to damage the PPC I-Beams.

QUANDEL

USER NAME =	DESIGNED	-	BMW	REVISED	-
	CHECKED	-	JRT	REVISED	-
PLOT SCALE =	DRAWN	-	BMW	REVISED	-
PLOT DATE =	CHECKED	-	JRT	REVISED	-


STATE OF ILLINOIS
DEPARTMENT OF TRANSPORTATION

TOTAL BILL OF MATERIAL

ITEM	UNIT	SUPER	SUB	TOTAL
Portland Cement Concrete Surface Removal - Butt Joint	SQ YD	428	0	428
Protective Coat	SQ YD	1,074	0	1,074
Concrete Removal	CU YD	20.1	0	20.1
Protective Shield	SQ YD	506	0	506
Concrete Superstructure	CU YD	20.1	0	20.1
Reinforcement Bars, Epoxy Coated	POUND	3,155	0	3,155
Bridge Fence Railing, Curved	F00T	169	0	169
Preformed Joint Strip Seal	FOOT	183	0	183
Concrete Sealer	SQ FT	0	20	20
Epoxy Crack Injection	FOOT	0	379.5	379.5
Cleaning Bridge Scuppers and Downspouts	EACH	8	0	8
Bridge Deck Grooving (Longitudinal)	SQ YD	916	0	916
Steel Railing Removal	FOOT	172	0	172
Approach Slab Repair (Partial Depth)	SQ YD	2	0	2
Bridge Deck Latex Concrete Overlay, 2 1/2 Inches	SQ YD	1,037	0	1,037
Bridge Deck Scarification 3/4"	SQ YD	1,037	0	1,037
Structural Repair Of Concrete (Depth Equal To Or Less than 5 Inches)	SQ FT	0	20	20
Deck Slab Repair (Full Depth, Type I)	SQ YD	24	0	24
Deck Slab Repair (Full Depth, Type II)	SQ YD	24	0	24
Drainage Scuppers To Be Adjusted	EACH	4	0	4
Diamond Grinding (Bridge Section)	SQ YD	914	0	914
Railroad Protective Liability Insurance	L SUM	1	0	1


^{*} Protective Coat shall be applied to all new concrete superstructure and all new concrete overlays as specified in Article 503.19 of the Standard Specifications.

^{**} Up to $\frac{1}{4}$ inch to be ground off the bridge deck.

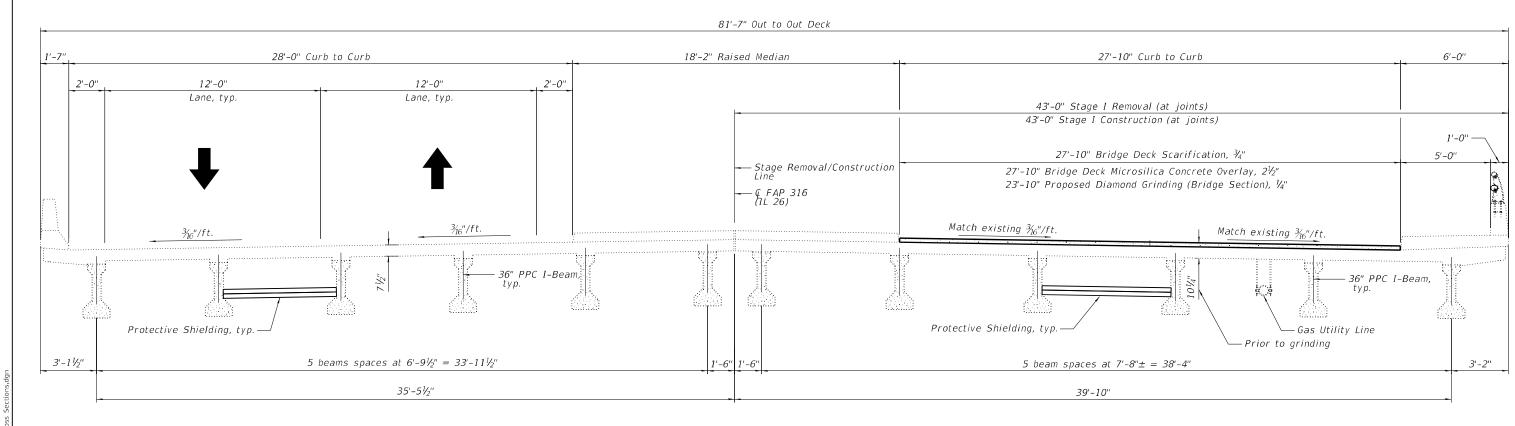

STAGE I REMOVAL AND CONSTRUCTION

(Half superstructure cross-sections, looking north)

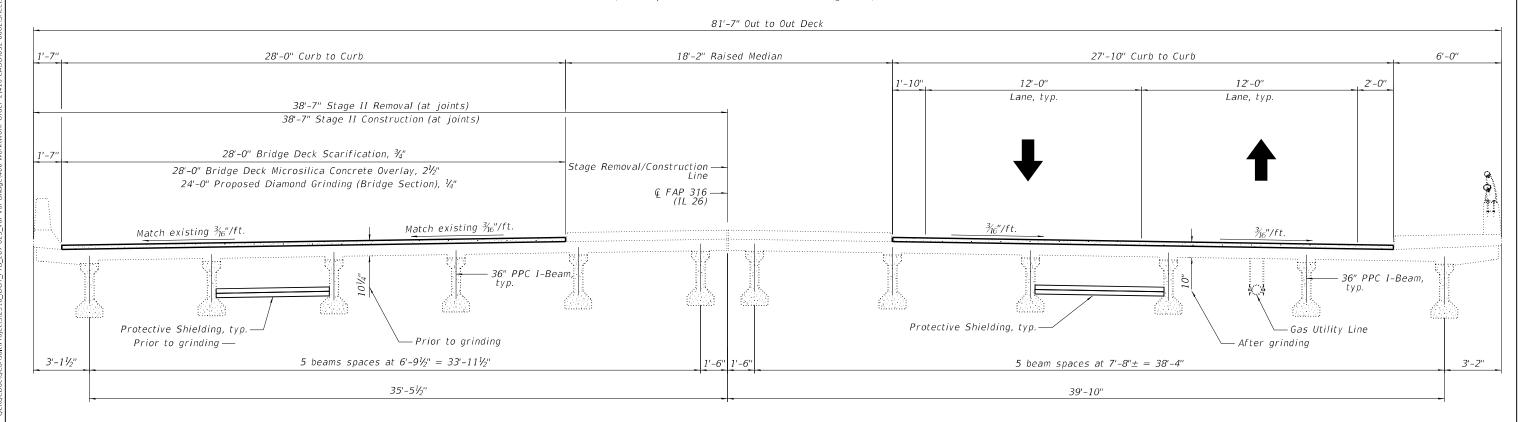

STAGE II REMOVAL AND CONSTRUCTION


(Half superstructure cross-sections, looking north)

QUANDEL
CONSULTANTS


USER NAME =	DESIGNED	-	ВМЖ	REVISED -	Π
	CHECKED	-	JRT	REVISED -	l
PLOT SCALE =	DRAWN	-	ВМЖ	REVISED -	l
PLOT DATE =	CHECKED	-	JRT	REVISED -	l

STATE OF ILLINOIS	
DEPARTMENT OF TRANSPORTATION	


STAGE CONSTRUCTION DETAILS		SECTION	COUNTY	TOTAL SHEETS	SHEET NO.
IL 26 OVER UP RR - SN 052-0062	316	101(V-BR & R-2)BDR	LEE	38	17
L 20 07EH 01 HH = 3N 032=0002			CONTRACT	NO. 6	4529
SHEET 3 OF 14 SHEETS		ILLINOIS FED. AI	D PROJECT		

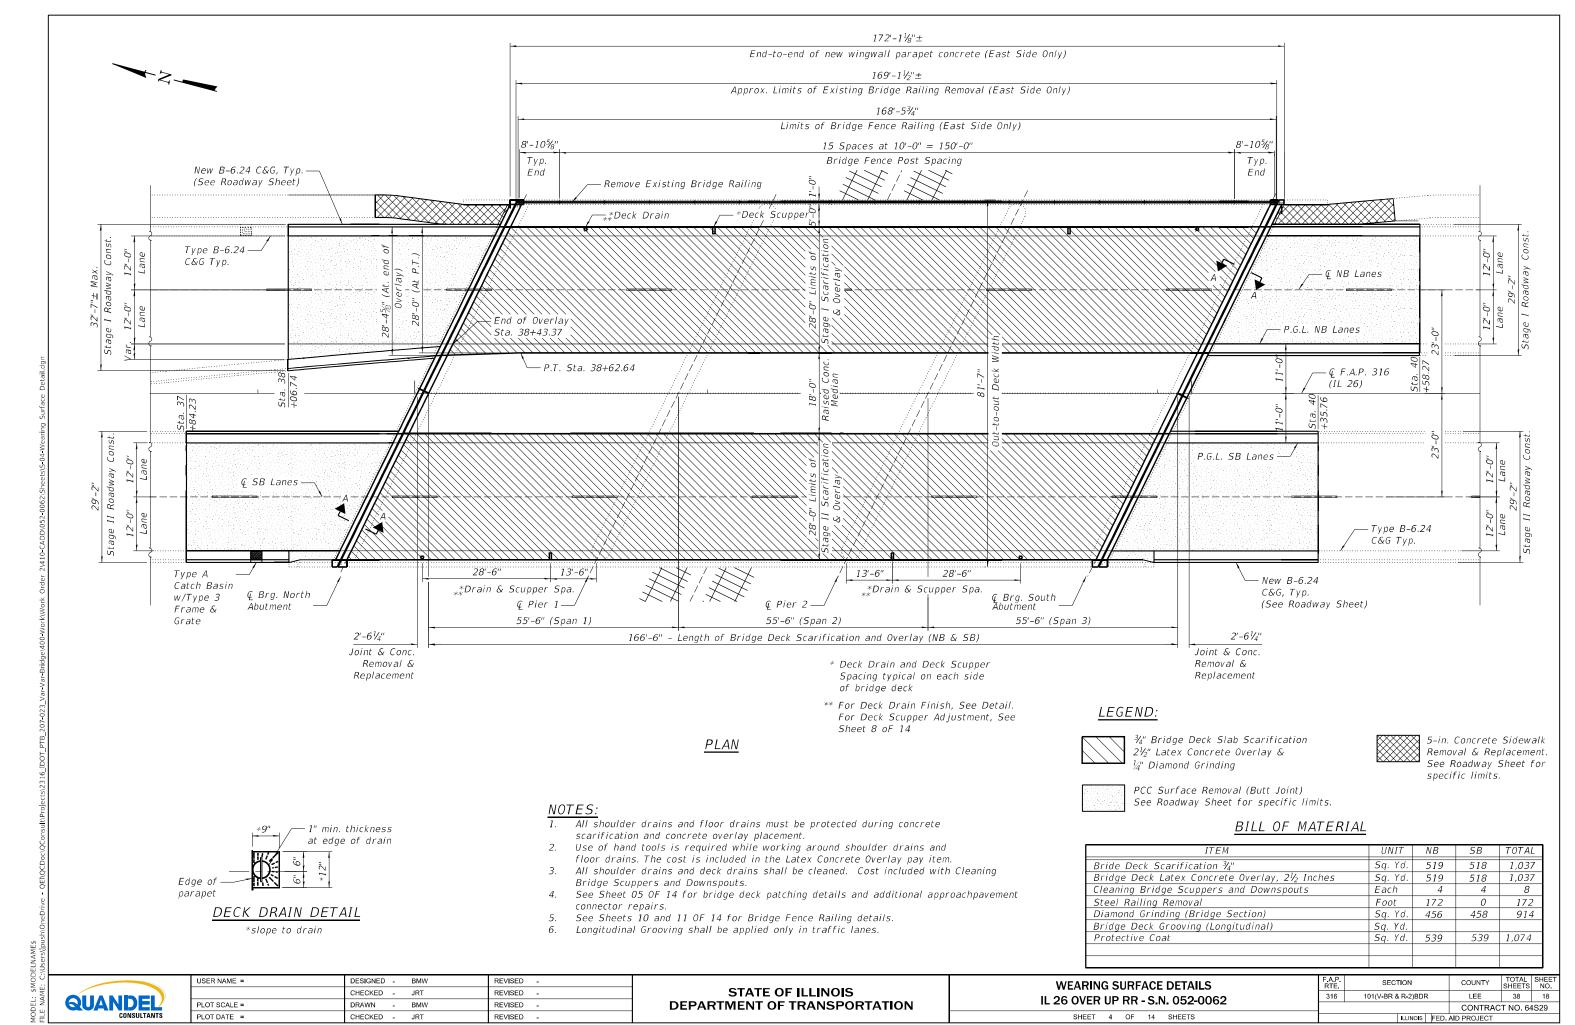

2/12/2024 4:32:29 PM

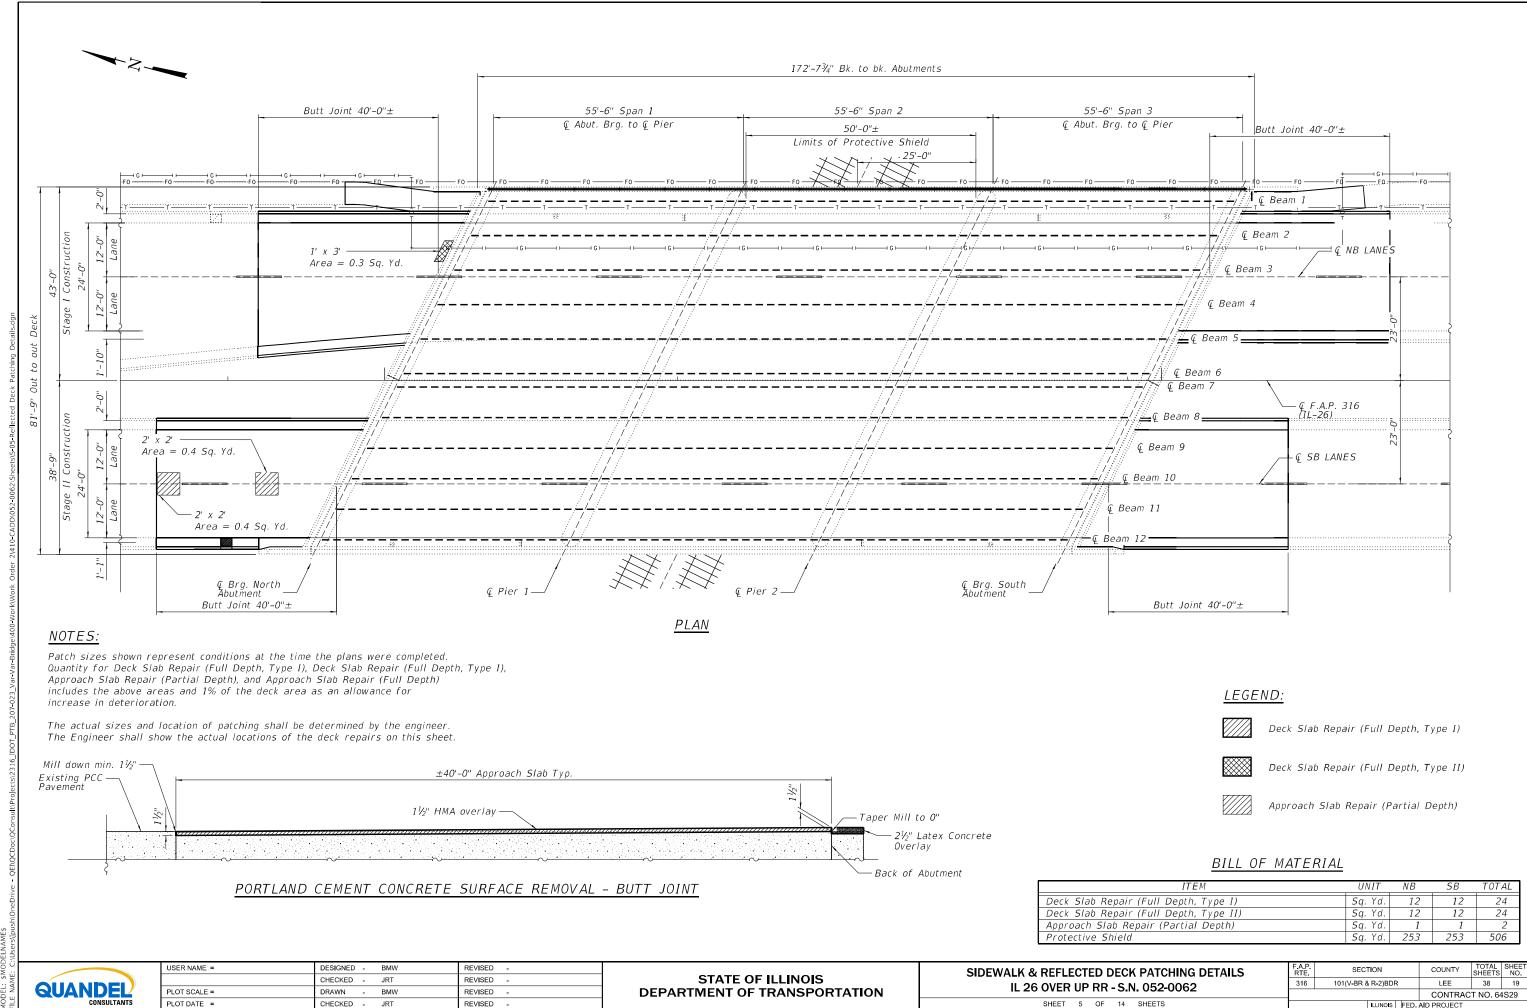



2/12/2024 4:32:30 PM

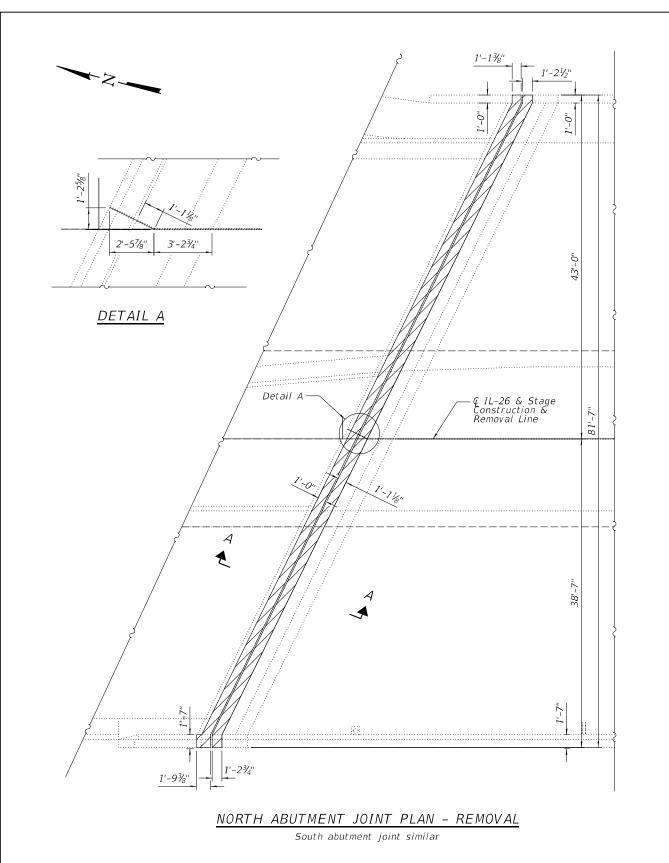


1'-0" 1'-0" 50F Existing PPC 36" I Beam

SECTION A-A

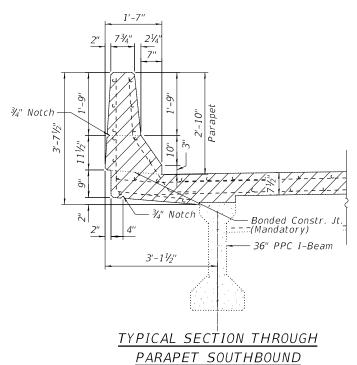

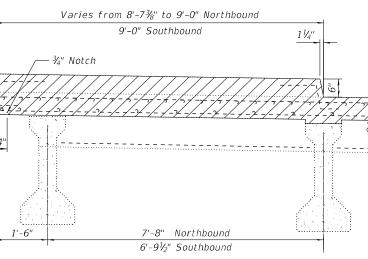

TYPICAL SECTION THROUGH **MEDIAN**

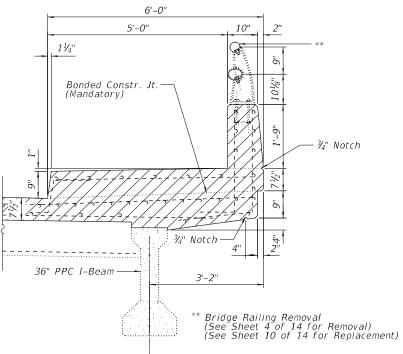

TYPICAL SECTION THROUGH PARAPET NORTHBOUND

<u>NOTES</u>

Removal and Disposal of Exist. Expansion Joint is included in the cost of CONCRETE REMOVAL.

LEGEND Concrete Removal

BILL OF MATERIAL


38 20

	Pay Item	Unit	Qua	ntity	Total
			Stage I	Stage II	
*	Concrete Removal	Cu. Yd.	10.4	9.7	20.1

** Concrete Removal Quantity is for end of the Deck removal, including parapet and joint hatchblock.



USER NAME =	DESIGNED - BMW	REVISED -
	CHECKED - JRT	REVISED -
PLOT SCALE =	DRAWN - BMW	REVISED -
PLOT DATE =	CHECKED - JRT	REVISED -

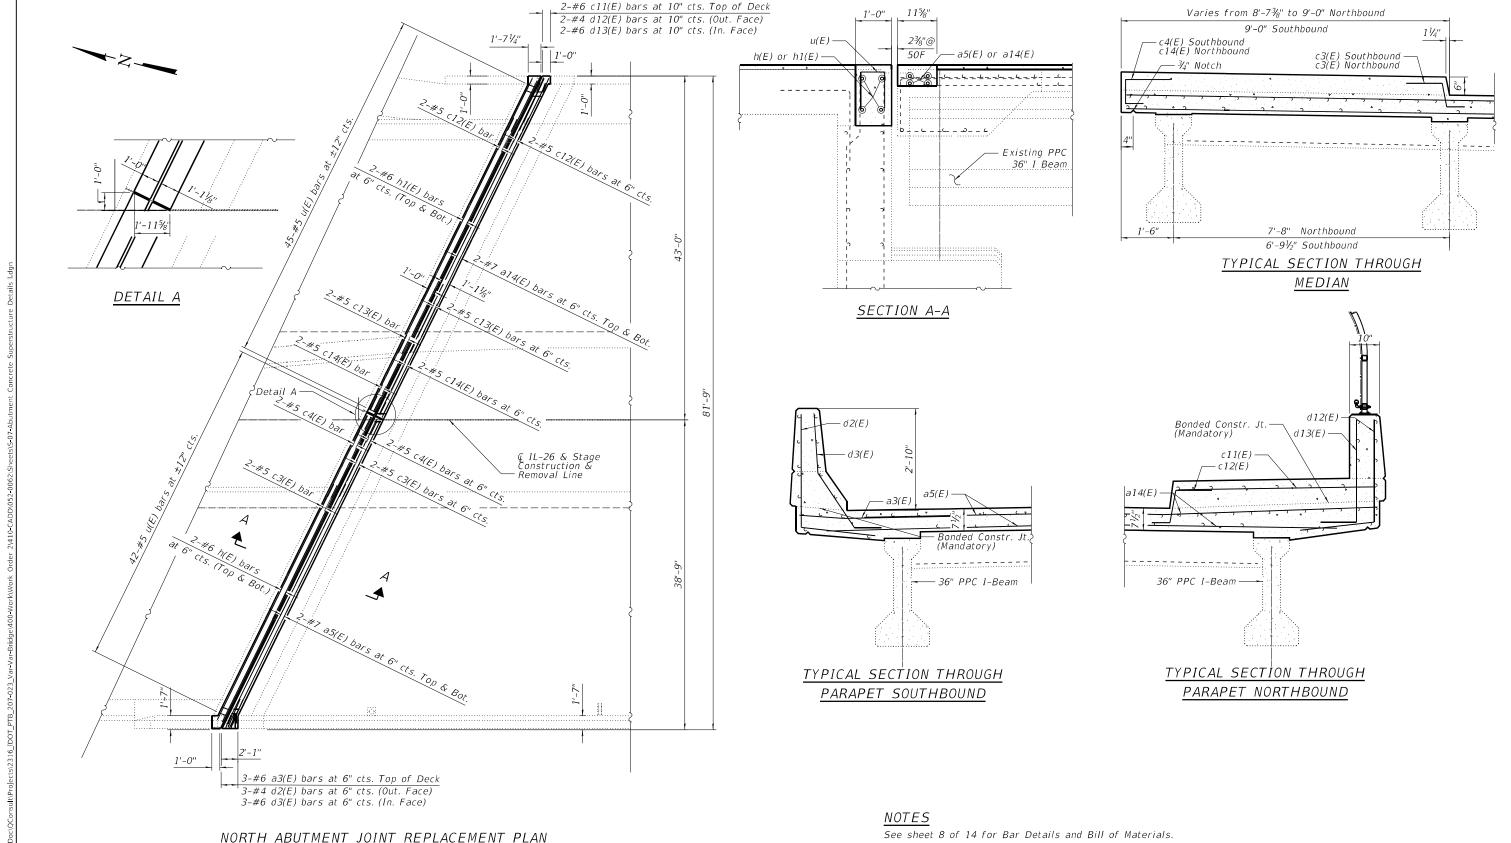


NORTH ABUTMENT JOINT REPLACEMENT PLAN

South abutment joint similar


USER NAME =	DESIGNED -	BMW	REVISED -	
	CHECKED -	JRT	REVISED -	
PLOT SCALE =	DRAWN -	BMW	REVISED -	
PLOT DATE =	CHECKED -	JRT	REVISED -	
				_

ABUTMENT CONCRETE REMOVAL DETAILS	F.A.P. RTE	SECTION
IL 26 OVER UP RR - S.N. 052-0062	316	101(V-BR & R-2)BDR
16 20 0 VEIX 01 1XIX - 3.14. 032-0002		
OUEET 7 OF 44 OUEETO		

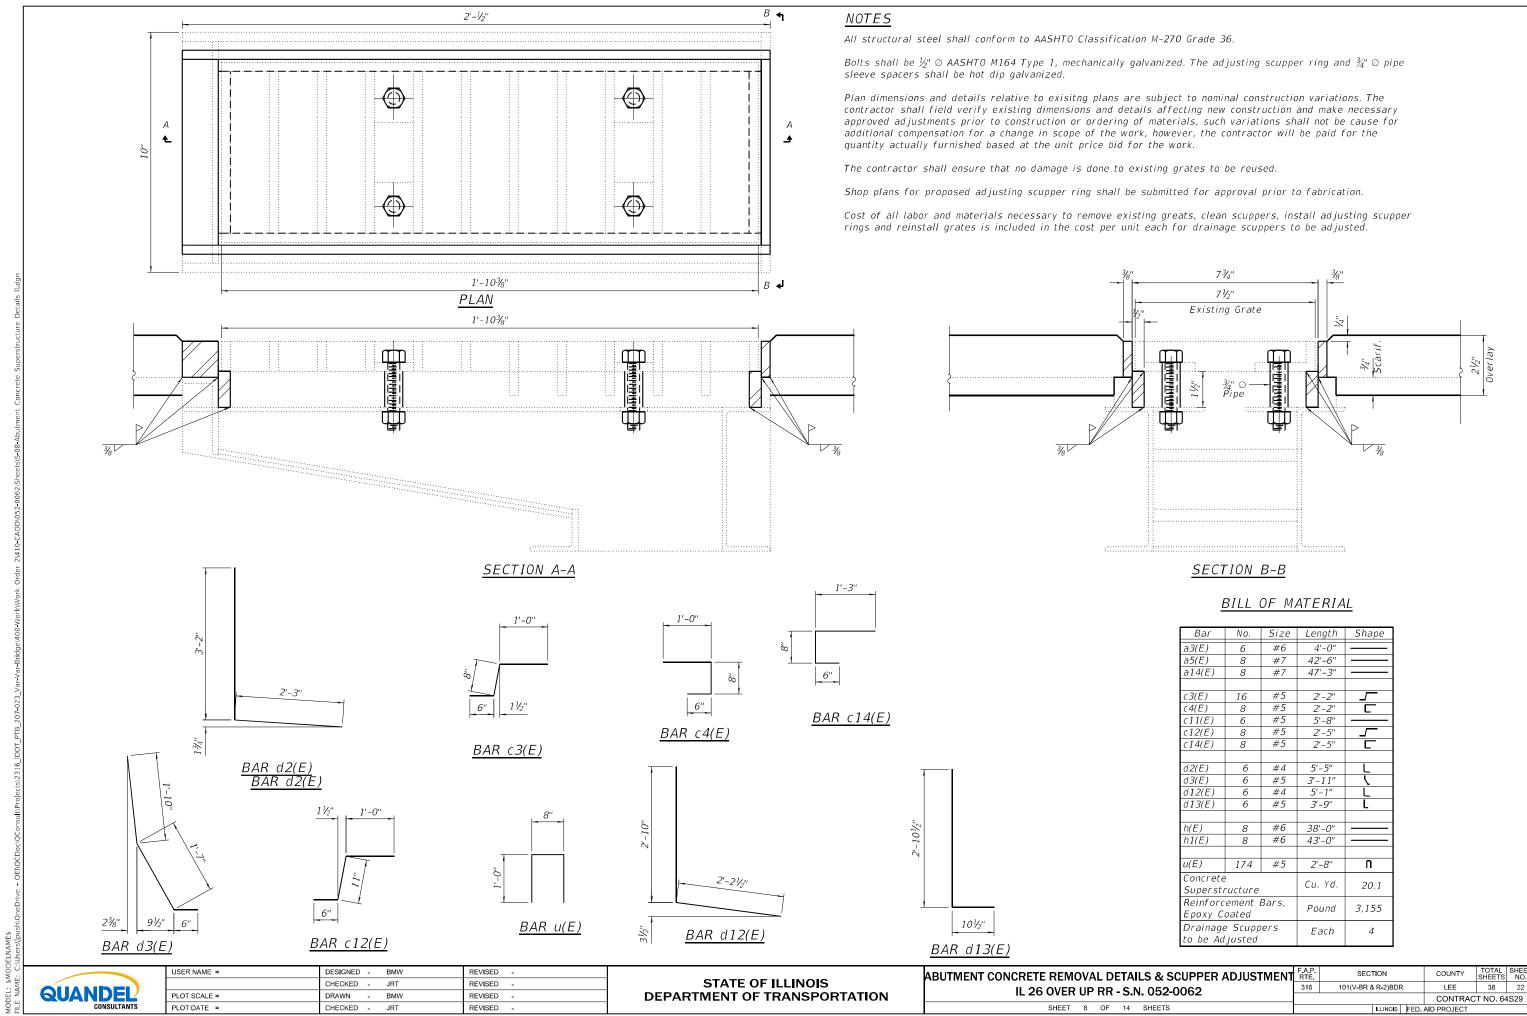


$FOR SKEWS \le 30^{\circ}$

PLAN AT PARAPET

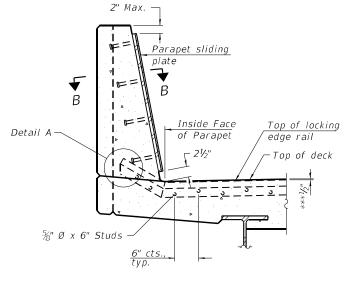


SECTION AT PARAPET


(Skews > 30° shown. Skews ≤ 30° similar except as shown in plan view.)

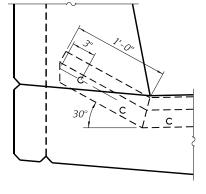

DETAIL A

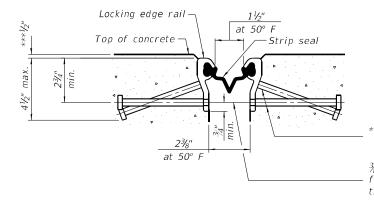

SHOWING ROLLED RAIL JOINT

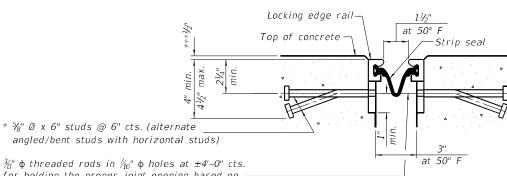


for holding the proper joint opening based on the temperature during the deck pour. Place to miss studs. All rods shall be burned, or sawed off flush with the plates after concrete is set.

SHOWING WELDED RAIL JOINT

SECTION A-A

* Granular or solid flux filled headed studs conforming to Article 1006.32 of the Std. Specs., automatically end welded.

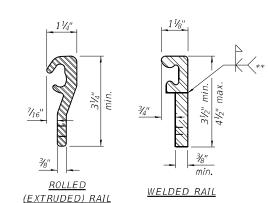

Notes:

rated movement of 4 inches.

shall be followed.

rail splice detail.

The strip seal shall be made continuous and shall have a minimum thickness of $\frac{1}{4}$ ". The configuration of the strip seal shall match the configuration of the locking edge rails. Open or "webbed" strip seal gland configurations are not permitted. The gland shall be sized for a maximum

The locking edge rails depicted are configured for typical applications and are conceptual only. The actual configuration of the locking edge rails and matching strip seal may vary from

manufacturer to manufacturer provided they fit the application

and meet the minimum anchorage shown. Flanged edge rails, however, will not be allowed. Locking edge rails may exceed the 4½" maximum depth provided the anchorage system is revised

All steel components shall be galvanized after fabrication according to Article 520.03 of the Standard Specifications.

rail joint within 10' measured perpendicular to the face of the curb or parapet shall be welded as shown in the locking edge

39" constant slope barrier shown, 44" constant slope barrier

The concrete opening below the strip seal will vary based

to the concrete opening, not the joint opening, and are based on the rolled locking edge rail. If the Contractor elects to use a different locking edge rail, dimensional adjustments may be required. One exception to this would be the strip seal joint at the end of the precast bridge approach slab. For these cases the pavement connector length shall be adjusted, not the

on the locking edge rail chosen by the Contractor. Deck and parapet lengths shown elsewhere in the plans are dimensioned

The Maximum space between locking edge rail segments shall be $\frac{3}{16}$ " and sealed with a suitable sealant; however, any

The top surface of sidewalk sliding plates shall have a

Cost of parapet sliding plates, sidewalk sliding plates, embedded plates, anchorage studs, and expansion anchors

according to the manufacturer's recommendation. The manufacturer's recommended installation methods


raised pattern according to ASTM A786.

included with Preformed Joint Strip Seal.

length of the bridge approach slab.

LOCKING EDGE RAILS

** Back gouge not required if complete joint penetration is verified by mock-up.

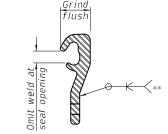

LOCKING EDGE RAIL SPLICE

The inside of the locking edge rail groove shall be free of weld residue. Rolled rail shown, welded rail similar.

BILL OF MATERIAL

Item	Unit	Total
Preformed Joint Strip Seal	Foot	183

***Prior to grinding


USER NAME =	DESIGNED	-	BMW	REVISED	-
	CHECKED	-	JRT	REVISED	-
PLOT SCALE =	DRAWN	-	BMW	REVISED	-
PLOT DATE =	CHECKED	-	JRT	REVISED	-

STATE OF ILLINOIS DEPARTMENT OF TRANSPORTATION


PREFORMED JOINT STRIP SEAL IL 26 OVER UP RR - S.N. 052-0062


A.P. RTE	SEC.	TION		COUNTY	TOTAL SHEETS	SHE
316	101(V-BR 8	k R-2)BDF	₹	LEE	38	23
				CONTRAC	T NO. 64	1829
		II I INIOIO	EED	AID DDO IECT		

SHEET 9A OF 14 SHEETS

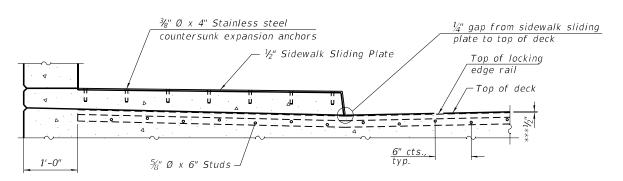


SECTION AT RAISED SIDEWALK

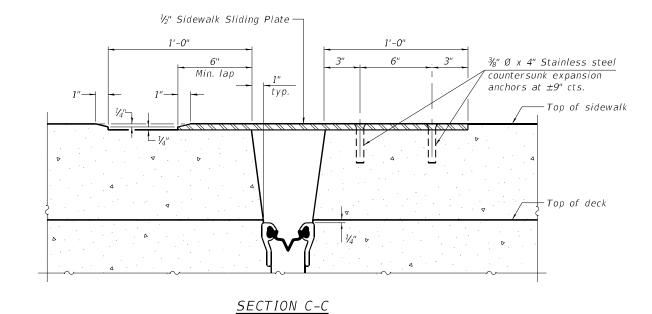

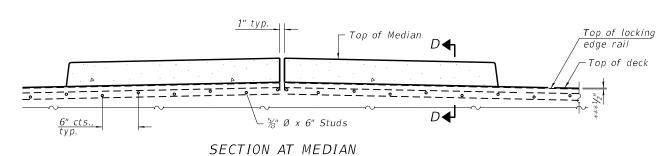


For skews > 30°, chamfer acute corners 2" similar to sidewalk.

***Prior to grinding

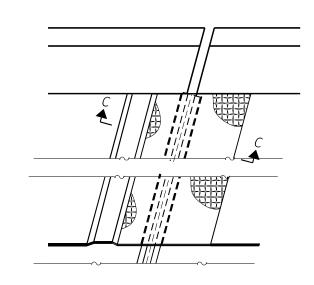

 $(FOR SKEWS \le 30^{\circ})$

PLAN AT RAISED SIDEWALK

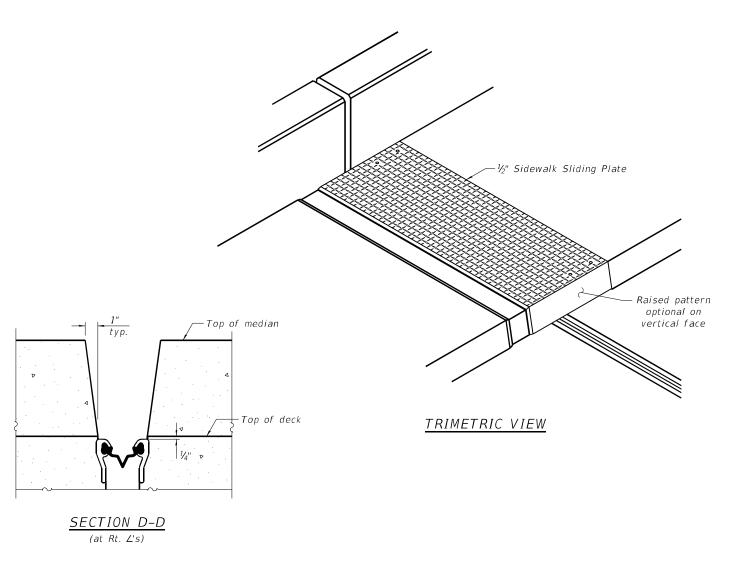



 USER NAME =
 DESIGNED - BMW
 REVISED

 CHECKED - JRT
 REVISED

 PLOT SCALE =
 DRAWN - BMW
 REVISED


 PLOT DATE =
 CHECKED - JRT
 REVISED

STATE OF ILLINOIS
DEPARTMENT OF TRANSPORTATION


 PREFORMED JOINT STRIP SEAL
 F.A.P. RTE.
 SECTION
 COUNTY
 TOTAL SHEETS
 NO.

 1L 26 OVER UP RR - S.N. 052-0062
 316 101(V-BR & R-2)BDR
 LEE
 38 23B

 SHEET
 98 0F
 14 SHEETS
 CONTRACT NO. 64S29

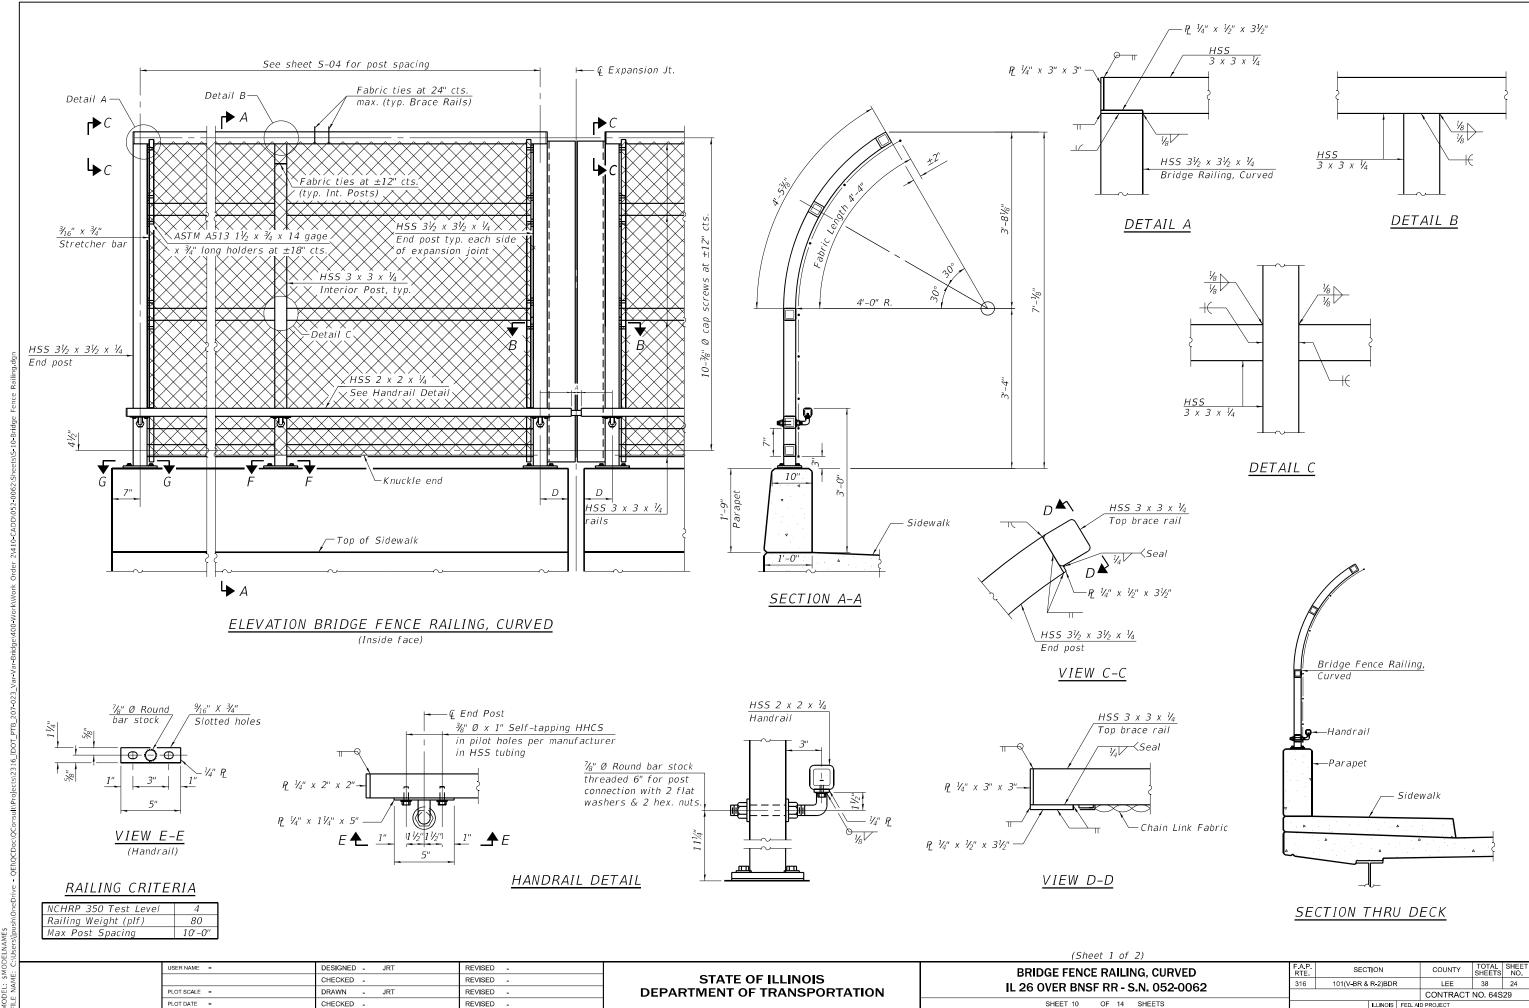

1/21/2024 10:31:33 AM

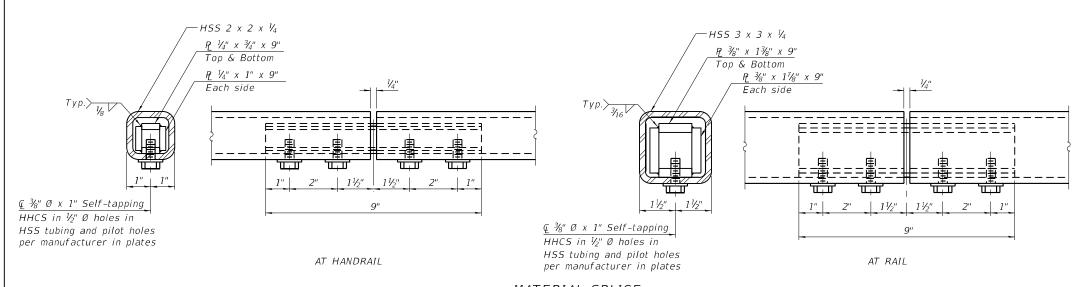

Note.

Place reinforcement bars to miss anchor rod locations. CVN testing is not required for the HSS tubing used in the Bridge Fence Railing, Curved.

All HSS tubing used for the Handrail shall be CVN tested according to Article 1006.34(b) of the Standard Specifications.

All heavy hex nuts shall be according to ASTM A 563 grade DH.

All fully threaded anchor rods shall be ASTM F1554 grade 105.

The post base plate shall be fastened to the curb snug tight and given an additional 1/8" turn.

Rail splice inserts may be built out of bent plates of the same thicknesses and outside geometry limits as the 4 plate rail splice inserts shown.

When the contract specifies a galvanized railing, all steel rail elements shall be galvanized according to Article 509.05 of the Standard Specifications. When the contract specifies a painted railing, all posts, rail, splices, anchor devices and plates of the railing shall be painted according to the paint system for railings as specified in the General Notes.

See sheet 10 of 13 for dimensions of concrete openings at expansion joints.

5/8" Ø x 2" hex. hd.

H.S. bolts with

1" Round bar stock
AASHTO M270 G50 - tap


for ¾" Ø H.S. bolts

½" x 1½" x 7½" Bar

R washer

1½" x 1¼" x 5/16"

∽ Base № ½" x 6" x 9"

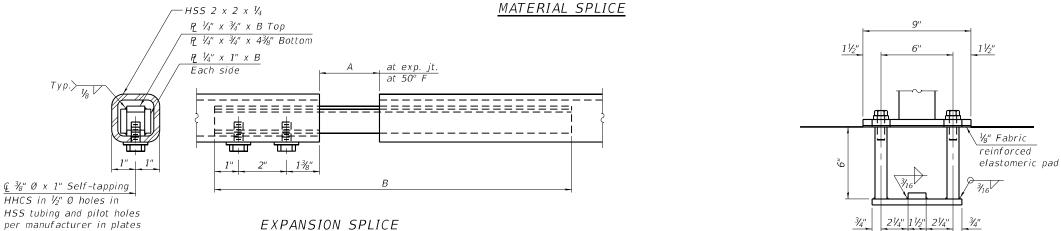

ANCHORAGE ASSEMBLY

Back face


of parapet

The Bridge Fence Railing, Curved fasteners for end posts near expansion joints may need to be installed prior to installing the bent plates.


½" x 1½" x 5¼" Bar

min.

In lieu of the cast-in-place anchor device shown, the Contractor has the option of drilling and setting $\frac{6}{10}$ $\frac{6}{10}$ fully threaded anchor rods with the same plate washers as specified above and heavy hex lock nuts according to Article 509.06 of the Standard Specifications. Embedment shall be according to the manufacturer's specifications.

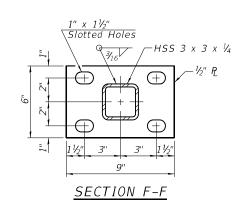

(Weld bottom plate on bolt side)

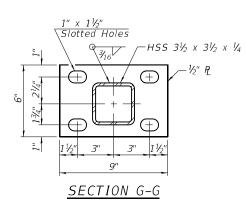

$\frac{3}{8}$ " Ø x 1" Self-tapping HHCS in $\frac{1}{2}$ " Ø holes in plates & pilot holes per manufacturer in HSS tubing, typ. $\frac{1}{4}$ " x 2" x 2½", typ. $\frac{1}{4}$ " $\frac{1}{2}$ " $\frac{1}{4}$ " $\frac{1}{4}$ " $\frac{1}{4}$ " $\frac{1}{4}$ " Stretcher bar, typ. ASTM A513 $\frac{1}{2}$ x $\frac{3}{4}$ x 14 gage x $\frac{3}{4}$ " long holders, typ.

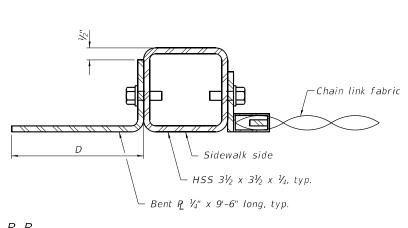


TABLE OF DIMENSIONS

Location	T	Α	В	С	D
Over Strip Seal Jt.	≤4"	21/2"	1'-57/8"	71/4"	7"
Over Finger or Modular Jt.	≤9½"	5½"	1'-115/8"		
Over Finger or Modular Jt.	≤15"	81/4"	2'-51/8"		·

= ; total movement based on total temperature range from -20°F to 120°F along centerline of roadway at expansion joint.


SECTION B-B

BILL OF MATERIAL Item Unit Qu

Item	Unit	Quantity
Bridge Fence Railing, Curved	Foot	169


(Sheet 2 of 2)

JSER NAME =	DESIGNED - JRT	REVISED -		BRII
	CHECKED -	REVISED -	STATE OF ILLINOIS	
PLOT SCALE =	DRAWN - JRT	REVISED -	DEPARTMENT OF TRANSPORTATION	IL 26
PLOT DATE =	CHECKED -	REVISED -		

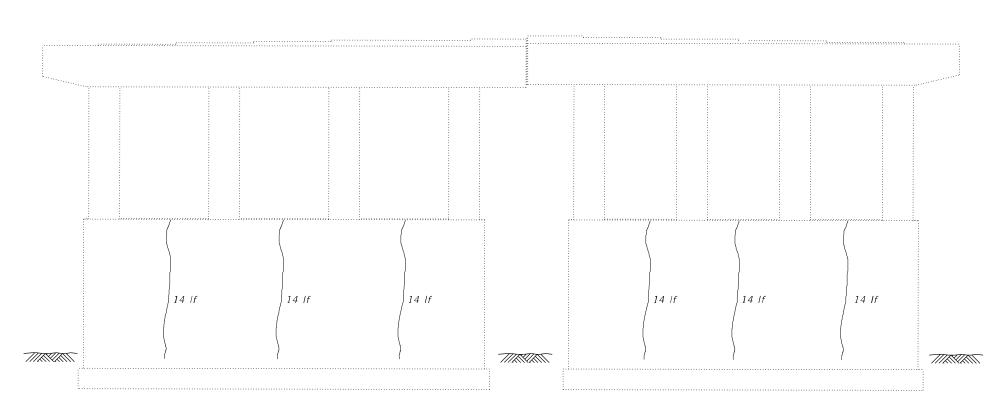

PIER 1 - NORTH ELEVATION

(Lookng South)

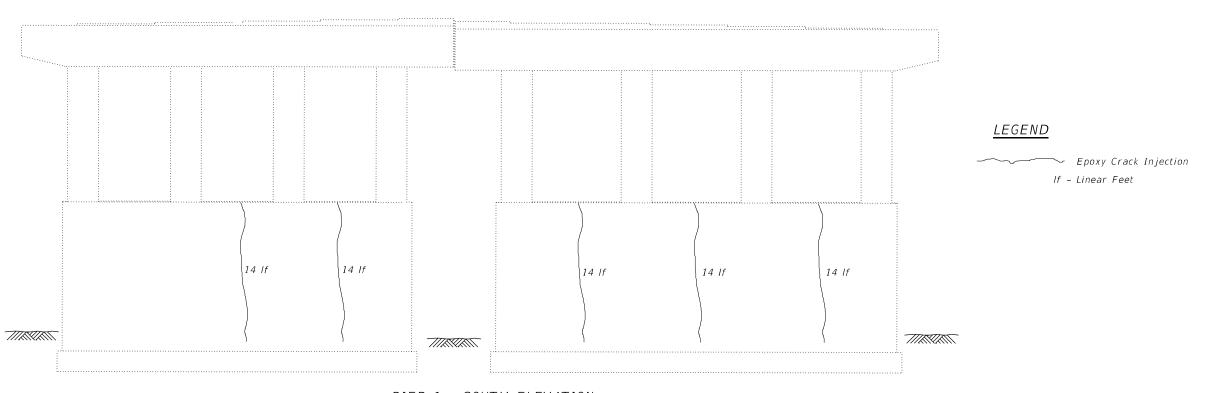


PIER 1 - SOUTH ELEVATION


(Looking North)



USER NAME =	DESIGNED - BMW	REVISED -
	CHECKED - JRT	REVISED -
PLOT SCALE =	DRAWN - BMW	REVISED -
PLOT DATE =	CHECKED - JRT	REVISED -

PIER 1 REPAIRS	F.A.P. RTE	SECTION
L 26 OVER UP RR - S.N. 052-0062	316	101(V-BR & R-2)BD
L 20 0 VLIV 01 1/1V - 3.1V. 032-0002		
OUEET 40 OF 44 OUEETO		

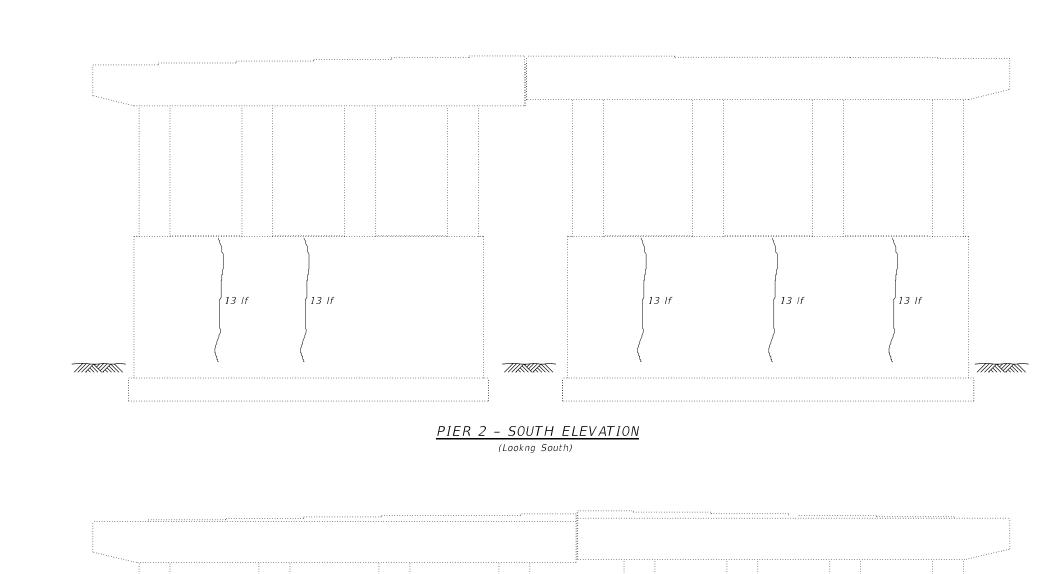

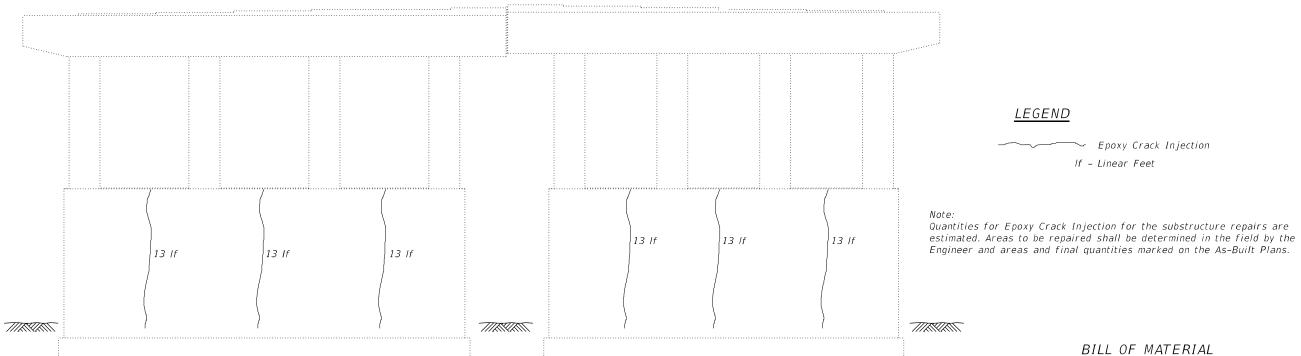

QUANDEL

 USER NAME =
 DESIGNED - BMW
 REVISED

 CHECKED - JRT
 REVISED

 PLOT SCALE =
 DRAWN - BMW
 REVISED

 PLOT DATE =
 CHECKED - JRT
 REVISED

STATE OF ILLINOIS DEPARTMENT OF TRANSPORTATION

PIER 2 - NORTH ELEVATION

(Looking North)

PIER 2 REPAIRS
IL 26 OVER UP RR - S.N. 052-0062

SHEET 13 OF 14 SHEETS

ITEM

Epoxy Crack Injection

 FA.P. RTE.
 SECTION
 COUNTY
 TOTAL SHEETS
 SHEETS NO.


 316
 101(V-BR & R-2)BDR
 LEE
 38
 27

 CONTRACT NO. 64S29

UNIT | PIER 1 | PIER 2 | TOTAL

Foot 154 130 284

NORTH ABUTMENT ELEVATION

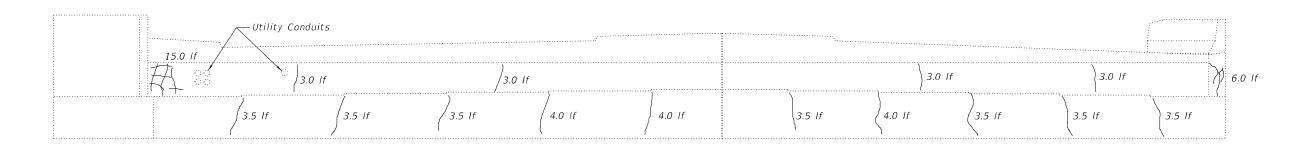

SOUTH ABUTMENT ELEVATION

<u>LEGEND</u>

Structural Repair of Concrete (Depth Equal to or Less Than 5 inches)

Epoxy Crack Injection

Note:

Quantities for Structural Repair of Concrete and Epoxy Crack Injection for the substructure repairs are estimated. Areas to be repaired shall be determined in the field by the Engineer and areas and final quantities marked on the As-Built Plans


BILL OF MATERIAL

ITEM	UNIT	NORTH ABUT.	SOUTH ABUT.	TOTAL
Structural Repair of Concrete (Depth Equal to or Less Than 5 inches)	Sq. Ft.	20	0	20
Epoxy Crack Injection	Foot	26	69.5	89.5
Concrete Sealer	Sq. Ft.	20	0	20



USER NAME =	DESIGNED - BMW	REVISED -
	CHECKED - JRT	REVISED -
PLOT SCALE =	DRAWN - BMW	REVISED -
PLOT DATE =	CHECKED - JRT	REVISED -

FRAME AND GRATE FOR INLETS, SPECIAL

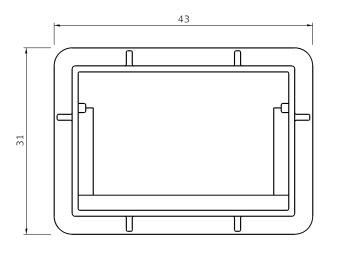


TRANSVERSE SECTION

 $17\frac{3}{4}$

ABBBBBB



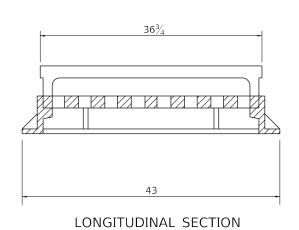

SECTION A-A 35½

PLAN OF GRATE


ALL DIMENSIONS ARE IN INCHES UNLESS OTHERWISE NOTED.

R 3067 OR EQUIVALENT APPROXIMATE WEIGHT - 510 LBS.

REVISED - 6-27-14							F.A.P.	SECTION	COUNTY	TOTAL	SHEET NO.
REVISED - 10-13-11		REGIO	N 2/Γ	DISTRICT :	316	101(V-BR & R-2)BDR	LEE	38	29		
REVISED -									CONTRAC	T NO. 64	1529
REVISED -	SCALE: N.T.S.	SHEET	OF	SHEETS	STA.	TO STA.		TILLINOIS FED A	ID PROJECT		

WORK ZONE SIGN DETAILS

ILLINOIS STANDARD G20–I100

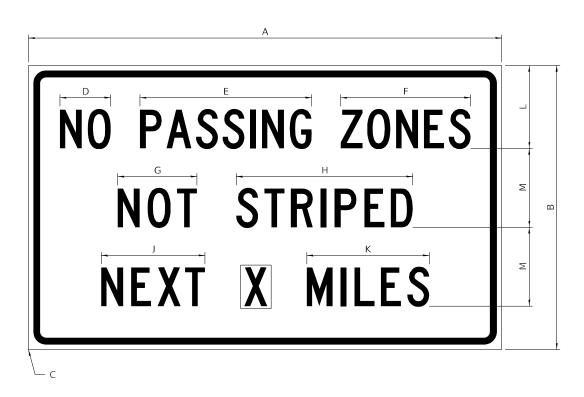

LEGEND AND BORDER BACKGROUND

BLACK ORANGE

NON-REFLECTORIZED REFLECTORIZED

CICN CIZE					[DIMEN	ISIONS	5				
SIGN SIZE	А	В	С	D	Е	F	G	Н	J	K	Г	М
60 x 36	60.00	36,00	2,25	6.4	21.80	16.40	10.00	22,40	13,20	15,50	10.50	10.00

SIGN SIZE	SER	IES BY	LINE	MARGIN	PODDED	
SIGN SIZE	1	2	3	MARGIN	BORDER	
60 x 36	5C	5C	5C	0.625	0.875	

Sign not to scale

GENERAL NOTES


All work to furnish and install these signs shall be included in the cost of the specified traffic control standards and shall not be paid separately.

All Illinois Standard signs shall conform to the latest edition of the "Illinois Standard Highway Signs Book" in effect on the date of invitation for bids.

Signs shall meet the applicable portions of Sections 701 and 720 of the Standard Specifications.

All dimensions are in inches unless otherwise noted.

ILLINOIS STANDARD W8–I107

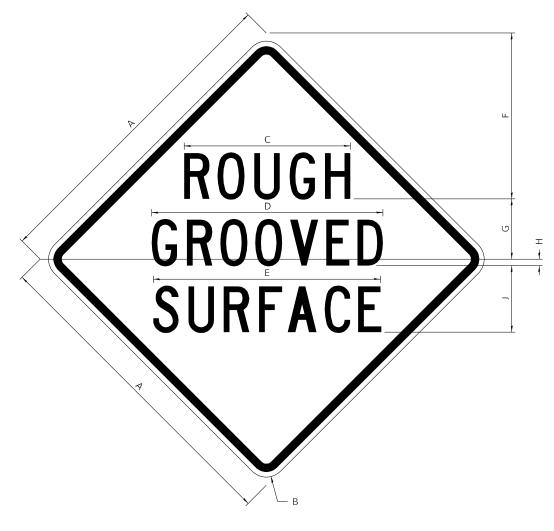

LEGEND AND BORDER BACKGROUND

BLACK

NON-REFLECTORIZED REFLECTORIZED

SIGN SIZE	DIMENSIONS									
SIGN SIZE	А	В	С	D	Е	F	G	Н	J	
48 x 48	48.00	3.00	25.00	34.80	34.20	24.94	9.00	1.00	10.00	


SIGN SIZE	SER	IES BY	LINE	MARGIN	BORDER		
SIGN SIZE	1	2	3	MARGIN BORDE			
48 x 48	7C	7C	7C	1.250	0.750		

Sign not to scale

	USER NAME = jpush	DESIGNED -	REVISED - 3-02-16				F.A.P. BTF	SECTION	COUNTY	TOTAL	SHEET
FILE NAME: 64S29-SHT-D2Details.dgn		DRAWN -	REVISED -	STATE OF ILLINOIS	REGION 2 / DISTRICT 2 STANDARD			101(V-BR & R-2)BDR	LEE	38	30
	PLOT SCALE = 100 0000 / in	CHECKED -	REVISED -	DEPARTMENT OF TRANSPORTATION					CONTRACT	F NO. 64	529
	PLOT DATE = 1/21/2024	DATE -	REVISED -		SCALE: N.T.S.	SHEET 1 OF 4 SHEETS STA. TO STA.		ILLINOIS FED. A	ID PROJECT		

WORK ZONE SIGN DETAILS

ILLINOIS STANDARD W12–I102

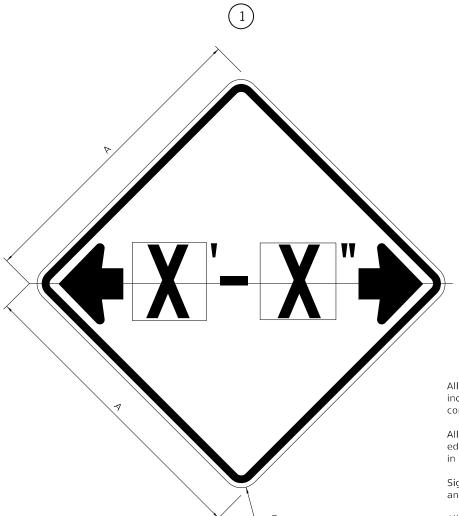

GENERAL NOTES

All work to furnish and install these signs shall be included in the cost of the specified traffic control standards and shall not be paid separately.

All Illinois Standard signs shall conform to the latest edition of the "Illinois Standard Highway Signs Book" in effect on the date of invitation for bids.

Signs shall meet the applicable portions of Sections 701 and 720 of the Standard Specifications.

All dimensions are in inches unless otherwise noted.

LEGEND AND BORDER COLOR BACKGROUND

BLACK FL ORANGE

NON-REFLECTORIZED REFLECTORIZED


SIGN SIZE	DIMEN	ISIONS
SIGN SIZE	А	В
48 × 48	48.00	3.00

Illinois Standard signs W12-I102 and W12-I103 shall be used as described in the special provisions.

SIGN SIZE	SERIES BY LINE	MARGIN	BORDER
SIGN SIZE	1	MARGIN	DORDER
48 x 48	12C	0.750	1,250

Sign not to scale

ILLINOIS STANDARD W12–I103

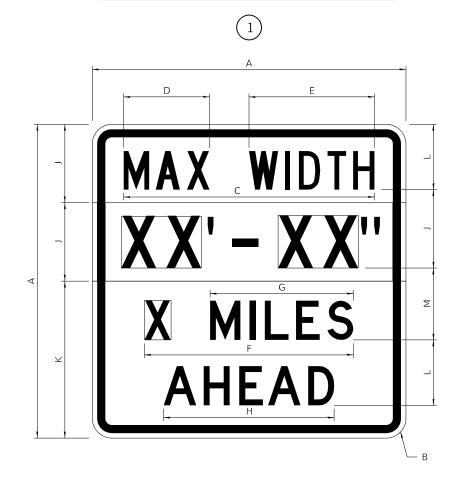

LEGEND AND BORDER BACKGROUND BACKGROUND (WIDTH) BLACK WHITE FL ORANGE

NON-REFLECTORIZED REFLECTORIZED REFLECTORIZED

SIGN SIZE					[DIMEN	ISIONS	5				
SIGN SIZE	А	В	С	D	Е	F	G	Н	J	K	L	M
48 x 48	48.00	3.00	38.40	13.20	19.20	32.00	22.00	26.20	12.00	24.00	10.00	11.00

SIGN SIZE		SERIES	BY LINE		MARGIN	BORDER
SIGN SIZE	1	2	3	4	MARGIN	BURDER
48 x 48	6C	8D	6D	6D	0.750	1.250

Sign not to scale


XX'-XX" WIDTH AND X MILES ARE VARIABLE TOP AND BOTTOM OF BACKGROUND WHITE

34.1

		USER NAME = jpush	DESIGNED -	REVISED - 3-02-16				RTF.	SECTION	COUNTY	SHEETS	NO.
FILE NAME: 64S29-SHT-	T-D2Details.dgn		DRAWN -	REVISED -	STATE OF ILLINOIS		REGION 2 / DISTRICT 2 STANDARD	316	101(V-BR & R-2)BDR	LEE	38	31
		PLOT SCALE = 100.0000 / in	CHECKED -	REVISED -	DEPARTMENT OF TRANSPORTATION				, , , , , ,	CONTRAC	T NO. 64	1529
		PLOT DATE = 1/21/2024	DATE -	REVISED -		SCALE: N.T.S.	SHEET 2 OF 4 SHEETS STA. TO STA.		ILLINOIS FED. A	ID PROJECT		

WORK ZONE SIGN DETAILS

ROAD CLOSED TO OVERSIZED LOADS

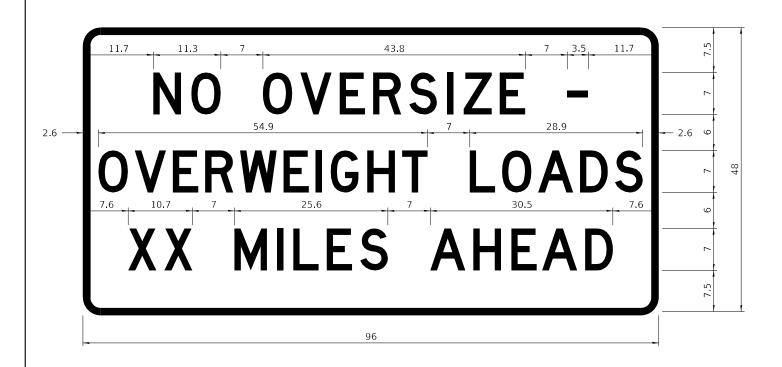

COLOR

LEGEND AND BORDER BACKGROUND

BLACK ORANGE


NON-REFLECTORIZED REFLECTORIZED

Permit Loads - Loads Over 13 Feet, 3.0" Radius, 1.3" Border, [NO OVERSIZE -] D; [OVERWEIGHT LOADS] D 85% spacing; [XX MILES AHEAD] D; Table of letter and object lefts.

	N 11.7	O 18.1	O 30.0	V 36.2	E 42.8	R 48.4	S 54.4	I 60.7	Z 63.5	E 69.5	- 80.8				
ſ	O 2.6	V 8.6	E 15.0	R 20.4	W 26.2	E 33,4	I 38.8	G 41.3	H 47.4	T 53.2	L 64.5	O 69.9	A 75.9	D 82.9	S 88.7
[X 7.6	X 13.6	M 25.3	I 32.3	L 35.1	E 40.6	S 46.2	A 57.9	H 65.1	E 71.4	A 76.6	D 83.7			

Sign not to scale

STOP LINE SIGN FOR TEMPORARY SIGNALS

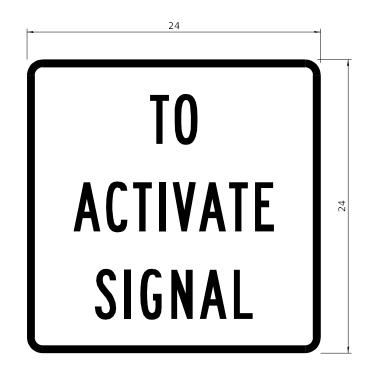

LEGEND AND BORDER BACKGROUND

BLACK WHITE

NON-REFLECTORIZED REFLECTORIZED

LEE

38 32 CONTRACT NO. 64S29

34.1

SIGN SIZE	SER	IES BY	LINE
SIGN SIZE	1	2	3
24 x 24	4C	4C	4C

Sign not to scale

GENERAL NOTES

All work to furnish and install these signs shall be included in the cost of the specified traffic control standards and shall not be paid separately.

All Illinois Standard signs shall conform to the latest edition of the "Illinois Standard Highway Signs Book" in effect on the date of invitation for bids.

Signs shall meet the applicable portions of Sections 701 and 720 of the Standard Specifications.

All dimensions are in inches unless otherwise noted.

	USER NAME = jpush	DESIGNED -	REVISED - 3-02-16		REGION 2 / DISTRICT 2 STANDARD					F.A.P.	SECTION
FILE NAME: 64S29-SHT-D2Details.dgn		DRAWN -	REVISED -	STATE OF ILLINOIS	REGION 2 / DISTRICT 2 STANDARD			D	316	101(V-BR & R-2)BDR	
	PLOT SCALE = 100.0000 / in.	CHECKED -	REVISED -	DEPARTMENT OF TRANSPORTATION							
	PLOT DATE = 1/21/2024	DATE -	REVISED -		SCALE: N.T.S.	SHEET 3	OF 4 SHEE	TS STA.	TO STA.		ILLINOIS FED. /

ENTRANCE SIGN FOR USE WITH TEMPORARY SIGNALS

WORK ZONE SIGN DETAILS



2.25" Radius, 0.88" Border, 0.50" IndenT; [CAUTION] D; [ONE LANE ROAD] D; [FOLLOW TRAFFIC] D; [FLOW] D

This sign shall be installed at entrances located between the temporary signals as shown in the staging plans.

Table Of Widths And Spaces

C A U T I O N 22.31 3.36 0.62 4.18 0.94 3.36 0.94 0.94 0.94 0.78 1.17 3.52 1.17 3.36		I 0.78	0.94		0.94	U 3.36	0.94	A 4.18	0.62	C		
--	--	-----------	------	--	------	-----------	------	-----------	------	---	--	--

	0		Ν		Е
8.23	3.51	1.17	3.36	1.18	3.04

5.00 3.05 0.31 4.18 0.94 3.36 1.17 3.0
--






	Т		R		Α		F		F		I		С	
5.00	3.05	0.94	3.36	0.94	4.18	0.93	3.05	0.94	3.04	0.94	0.78	1.18	3.35	7.43

	F		L		0		W	
27.60	3.05	0.94	3.04	0.94	3.52	0.93	4.38	27.60

Sign not to scale

STAY IN YOUR LANE

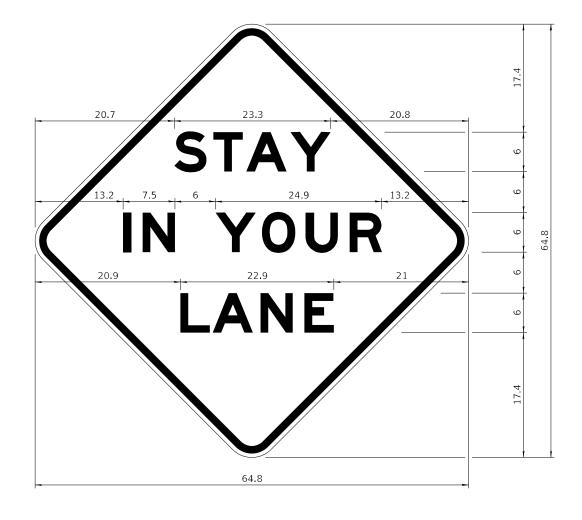

COLOR

LEGEND AND BORDER BACKGROUND

BLACK ORANGE NON-REFLECTORIZED REFLECTORIZED

48.0" across sides 3.8" Radius, 1.0" Border, 0.6" Indent; "STAY" E Mod; "IN YOUR" E Mod; "LANE" E Mod;

Table of Letter and Object Lefts

S	Т	Α	Υ
20.7	26.8	31.6	38.0

_						
	I	Z	Υ	0	\cup	R
	13.2	15.9	26.7	33.9	40.5	46.8

L	Α	N	Е		
20.9	25.8	33.1	39.4		

Sign not to scale

	USER NAME = jpush	DESIGNED -	REVISED - 3-02-16		REGION 2 / DISTRICT 2 STANDARD		F.A.P. BTF	SECTION	COUNTY	TOTAL SHEET NO.				
FILE NAME: 64S29-SHT-D2Details.dgn		DRAWN -	REVISED -	STATE OF ILLINOIS			316	101(V-BR & R-2)BDR	LEE	38 33				
	PLOT SCALE = 100.0000 / in.	CHECKED -	REVISED -	DEPARTMENT OF TRANSPORTATION								CONTRACT	T NO. 64529	
	PLOT DATE = 1/21/2024	DATE -	REVISED -		SCALE: N.T.S.	SHEET 4 OF 4	SHEETS	STA.	TO STA.	ILLINOIS FED. AID PRO		AID PROJECT	JECT	

GENERAL NOTES

All work to furnish and install these signs shall be included in the cost of the specified traffic control standards and shall not be paid separately.

All Illinois Standard signs shall conform to the latest edition of the "Illinois Standard Highway Signs Book"

Signs shall meet the applicable portions of Sections 701

All dimensions are in inches unless otherwise noted.

in effect on the date of invitation for bids.


and 720 of the Standard Specifications.

34.1

TYPICAL PAVEMENT MARKINGS


MEDIAN PAVEMENT MARKING

TYPICAL PAVEMENT MARKING FOR FLUSH MEDIAN AT LEFT TURN LANE

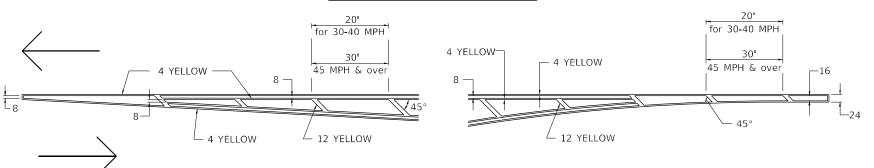

-8 WHITE

- 24 WHITE

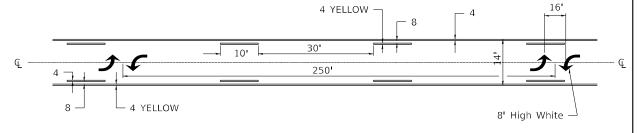

** ALL DIMENSIONS ARE IN INCHES UNLESS OTHERWISE NOTED.

TYPICAL ISLAND OFFSET SHOULDER WIDTH

24 WHITE-


8 WHITE

TYPICAL MARKING FOR PAINTED ISLANDS

NOTE: * 45° TO LOCAL TAN. 24 WHITE STOP BAR 45° ANGLE 8 WHITE HDDOWN 45° ANGLE 12 WHITE THROUGH TRAFFIC

STANDARD CROSSWALK MARKING

See Schedules for Locations

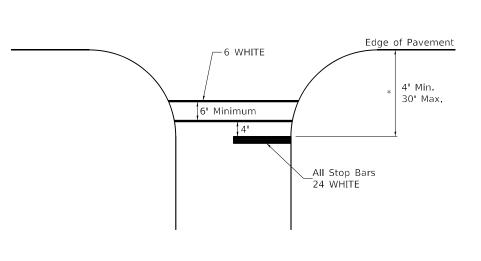

 Distance to the nearest edge of the intersecting roadway in the absence of a marked crosswalk.

		USER NAME = jpush	DESIGNED -	REVISED - 6-27-14
	FILE NAME: 64S29-SHT-D2Details.dgn		DRAWN -	REVISED - 3-05-12
	PLOT SCALE = 100.0000 / in.	CHECKED -	REVISED -	
		PLOT DATE = 1/21/2024	DATE -	REVISED -

5 Diagonals


Minimum

- 12 WHITE

STATE OF ILLINOIS
DEPARTMENT OF TRANSPORTATION


					 _	_
REGION	2 /	DISTRICT	2	STANDARD		

F.A.P. RTE	SECTION	SECTION			
316	101(V-BR & R-2)BDR	LEE	38	34	
			CONTRACT	NO. 64	1529
	TILLIMOIS FED	_ ^	ID DROJECT		

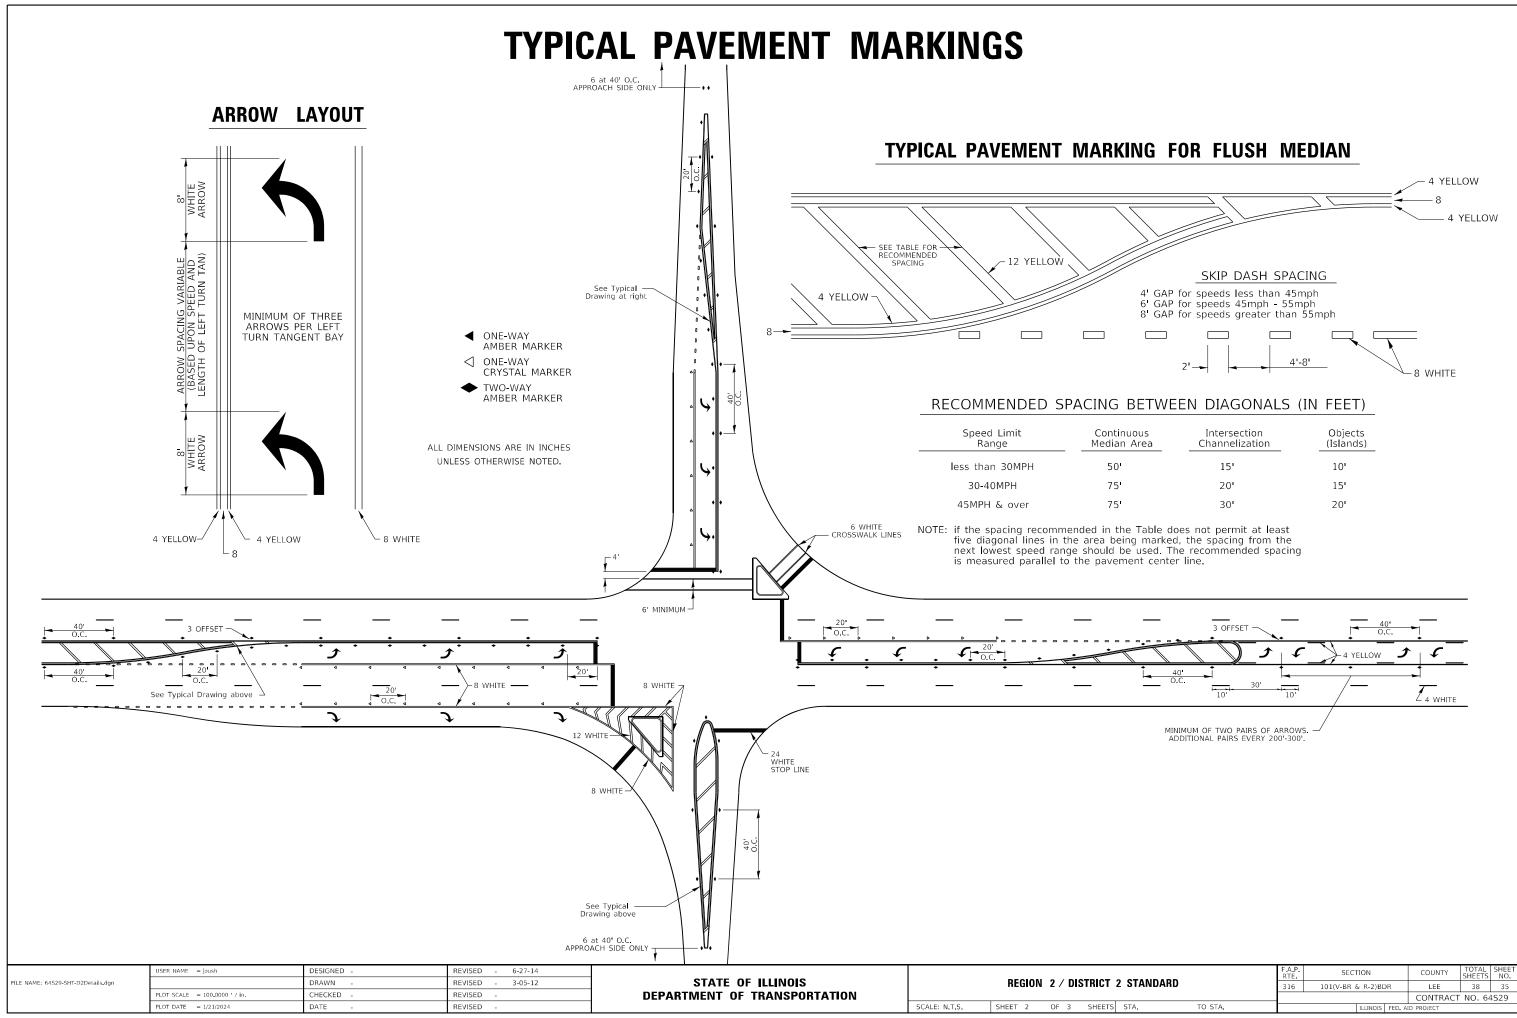


TYPICAL PAVEMENT MARKINGS

TYPICAL PARKING SPACING

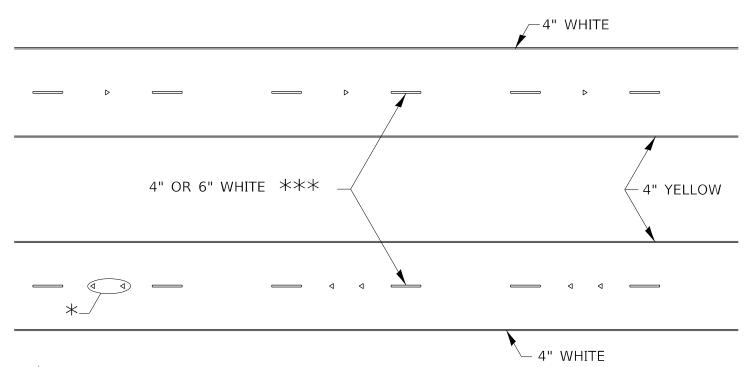

* SEE HIGHWAY STANDARD 781001 FOR SPACING DETAILS. USE DOUBLE MARKERS WHEN ADT ≥ 20,000.

MULTI-LANE / DIVIDED

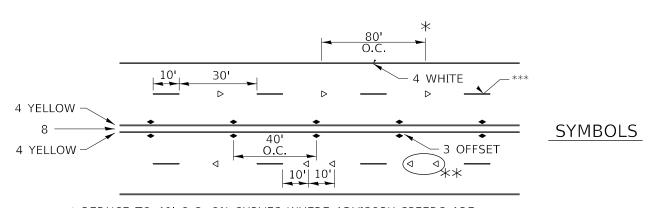

- * REDUCE TO 40' O.C. ON CURVES WHERE ADVISORY SPEEDS ARE 10 MPH LOWER THAN POSTED SPEEDS.
- ** USE DOUBLE MARKERS WHEN ADT ≥ 20,000

*** CENTERLINE SKIP DASH PAVEMENT MARKING SPEED LIMIT LESS THAN 40 MPH USE 4" LINE. SPEED LIMIT 40 MPH AND OVER USE 6" LINE.

MULTI-LANE / UNDIVIDED & ONE WAY

(FOR MULTI-LANE UNDIVIDED HIGHWAYS USE THIS DETAIL NOT HIGHWAY STANDARD 781001)


	USER NAME = jpush	DESIGNED -	REVISED - 6-27-14	Г
FILE NAME: 64S29-SHT-D2Details.dgn		DRAWN -	REVISED - 8-27-13	l
	PLOT SCALE = 100.0000 / in.	CHECKED -	REVISED - 11-28-12	l
	PLOT DATE = 1/21/2024	DATE -	REVISED -	ı

STATE OF ILLINOIS **DEPARTMENT OF TRANSPORTATION**

SECTION REGION 2 / DISTRICT 2 STANDARD 101(V-BR & R-2)BDR LEE CONTRACT NO. 64S29 OF 3 SHEETS STA. TO STA.

__22'-25**'** - 4 WHITE Face of Curb 20' Min. — No Parking Zone 22'-25**'** -4 WHITE Face of Curb 30' Min. — Approach to Signal No Parking Zone 20' Min. Face of Curb 20' Min. — No Parking Zone

TYPICAL PAVEMENT MARKING FOR TWO LANE SECTION - NO PASSING ZONES

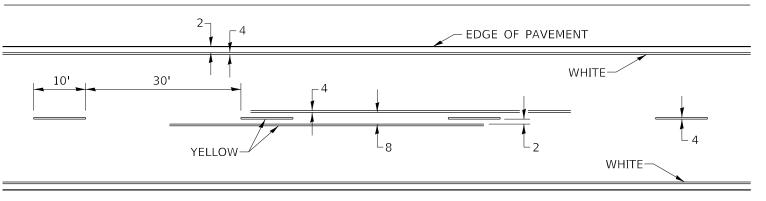


38 36

GUARDRAIL AND BARRIER WALL REFLECTORS, TYPE C (SPECIAL)

REFLECTORS MOUNTED ON METAL BLOCK OUT

SHALL BE MOUNTED USING AN APPROVED

BONDING AGENT PER THE MANUFACTURE'S SPECIFICATIONS OR TWO SELF TAPPING GALVANIZED SCREWS WITH WASHERS.

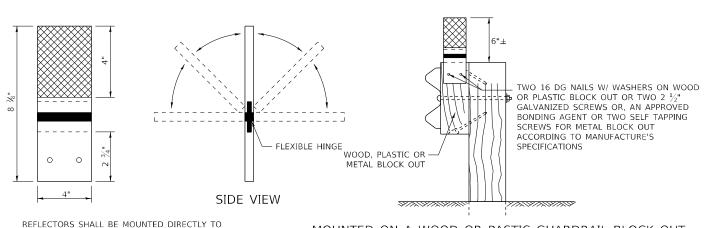


REFLECTORS MOUNTED ON WOODEN OR PLASTIC BLOCK OUT SHALL BE MOUNTED USING TWO 16 DG NAILS AND TWO $\frac{3}{16}$ " WASHERS OR TWO 2 $\frac{1}{2}$ " GALVANIZED SCREWS WITH WASHERS

WOOD OR PLASTIC BLOCK OUTS.


MOUNTED ON A WOOD OR PASTIC GUARDRAIL BLOCK OUT

REFLECTORS MOUNTED ON WOOD OR PLASTIC GUARDRAIL BLOCK OUT

STRAIGHT GUARDRAIL / DELINEATOR ADDITIONAL SHEETING MAY BE ADDED AS NEEDED REFLECTOR SIDE VIEW TOP OF REFLECTOR PLACED FLUSH WITH TOP OF POST UNLESS DOUBLE SIDED REFLECTOR IS CALLED FOR THEN REFLECTOR SHALL BE PLACED SUCH THAT THE REFLECTOR IS ABOVE THE TOP OF THE POST AND VISIBLE. $10/24 \times 1^{1/2}$ " BOLTS WITH WASHERS AND NUT (ADDITIONAL HOLES MAY BE DRILLED AS NEEDED) 1414 → | → 0.090" REFLECTORS MAY BE MOUNTED TO DELINEATOR POST USING TWO 10/24 X 1 $\frac{1}{2}$ " BOLTS WITH NUTS AND WASHERS. ADDITIONAL HOLES SHALL BE DRILLED IN THE REFLECTORS AS SHOWN ABOVE DIRECTION OF MOUNTED ON A DELINEATOR POST DELINEATORS SHALL BE INSTALLED ACCORDING TO STANDARD 635001 EXCEPT THAT THE POST SHALL BE ROTATED 180°. THE POST WILL HAVE THE WIDE SIDE FACING TRAFFIC AND THE REFLECTOR ATTACHECD AS SHOWN ABOVE.

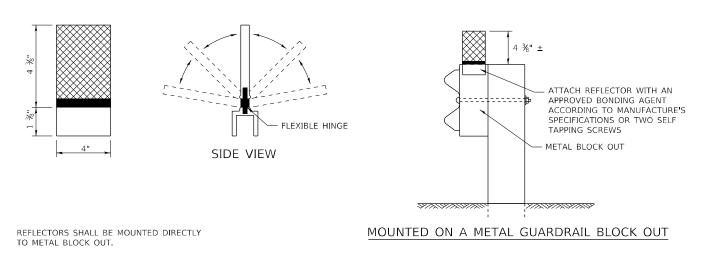


REFLECTORS MOUNTED ON METAL GUARDRAIL BLOCK OUT

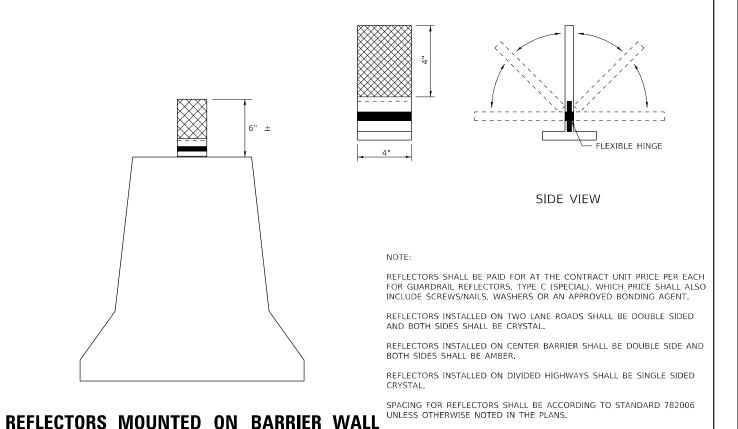

DESIGNED 4-27-23 STATE OF ILLINOIS REGION 2 / DISTRICT 2 STANDARD FILE NAME: 64S29-SHT-D2Details.dgn DRAWN REVISED 6-21-21 101(V-BR & R-2)BDR LEE 38 37 HECKED REVISED **DEPARTMENT OF TRANSPORTATION** CONTRACT NO. 64529 OF SHEETS STA. TO STA.


FRAME AND GRATE FOR INLETS, SPECIAL

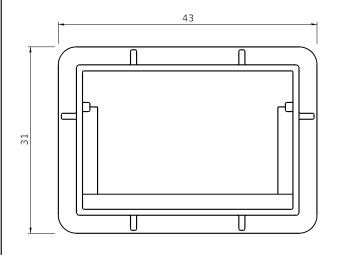


17¾ 5¾

TRANSVERSE SECTION

PLAN OF FRAME
WITHOUT GRATE AND CURB BOX

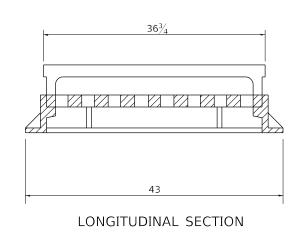

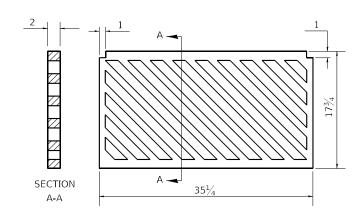

PLAN OF GRATE


ALL DIMENSIONS ARE IN INCHES UNLESS OTHERWISE NOTED.

R 3067 OR EQUIVALENT APPROXIMATE WEIGHT - 510 LBS.

FRAME AND GRATE FOR INLETS, SPECIAL

13.2c

TRAFFIC CONTROL AND PROTECTION AT TURN BAYS (TO REMAIN OPEN TO TRAFFIC)

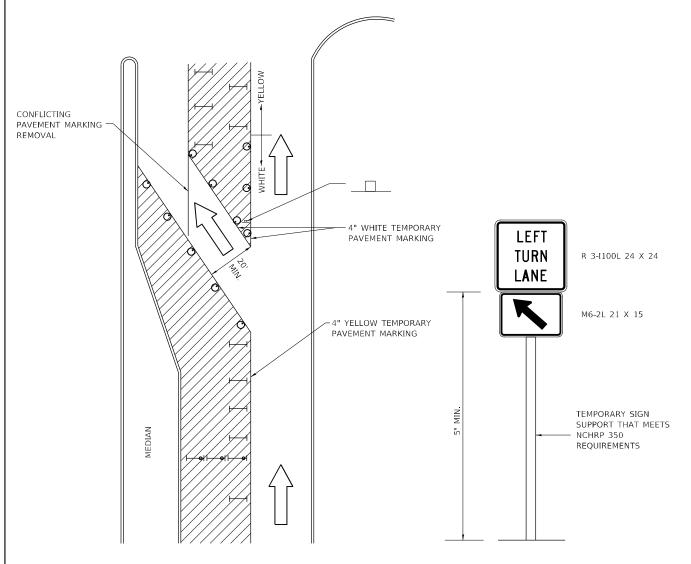

GENERAL NOTES

WORK AREA

LANE OPEN TO TRAFFIC

TYPE I OR II BARRICADE OR DRUM

LEGEND

DRUM OR BARRICADE WITH STEADY BURN LIGHT

WITH FLASHING BURNING LIGHT

TYPE I OR II CHECK BARRICADE WITH STEADY

SIGN (SEE DETAIL)

CONES MAY BE SUBSTITUTED FOR BARRICADES OR DRUMS AT HALF THE SPACING DURING DAY OPERATIONS. CONES SHALL BE A MINIMUM OF 28 IN HEIGHT.

STEADY BURNING LIGHTS WILL NOT BE REQUIRED ON BARRICADES OR DRUMS FOR DAY OPERATIONS. ALL LIGHTS WILL BE MONODIRECTIONAL.

TEMPORARY PAVEMENT MARKING SHALL BE PLACED THROUGHOUT THE BARRICADED AREA OF EACH BAY WHERE THE CLOSURE TIME IS GREATER THAN FOURTEEN DAYS.

THIS APPLICATION ALSO APPLIES WHEN WORK IS BEING PERFORMED IN THE RIGHT.

LANE(S) AND THE RIGHT TURN BAY IS TO REMAIN OPEN. UNDER THIS CONDITION,

LONGITUDINAL DIMENSIONS MAY BE ADJUSTED TO FIT FIELD CONDITIONS.

THESE CONTROLS SHALL SUPPLEMENT MAINLINE TRAFFIC CONTROL FOR LANE CLOSURES.

TRAFFIC CONTROL AND PROTECTION AT TURN BAYS (TO REMAIN OPEN TO TRAFFIC) SHALL BE INCLUDED IN THE COST SPECIFIED TRAFFIC CONTROL STANDARDS OR ITEMS.

ALL DIMENSIONS ARE IN INCHES UNLESS OTHERWISE NOTED.

REVISED - 10-14-11								SECTION	COUNTY	TOTAL SHEETS	SHEET NO.
REVISED -		REGION 2 / DISTRICT 2 STANDARD					RTE. 316	101(V-BR & R-2)BDR	LEE	38	38
REVISED -									CONTRACT NO. 64S29		
REVISED -	SCALE: N.T.S.	SHEET 1	OF 1	SHEETS	STA	TO STA	THINOIC FED AID BROJECT				

