



SECTION 18, TOWNSHIP 37, RANGE 13

F. A. U. #	SECTION	COUNTY	TOTAL SHEETS	SHEET NO.
2855	05-00052-00-LT	COOK	009	004
STA.	TO STA.			
FED. ROAD DIST. NO.	ILLINOIS	FED. AID PROJECT		

CONTRACT # 83963

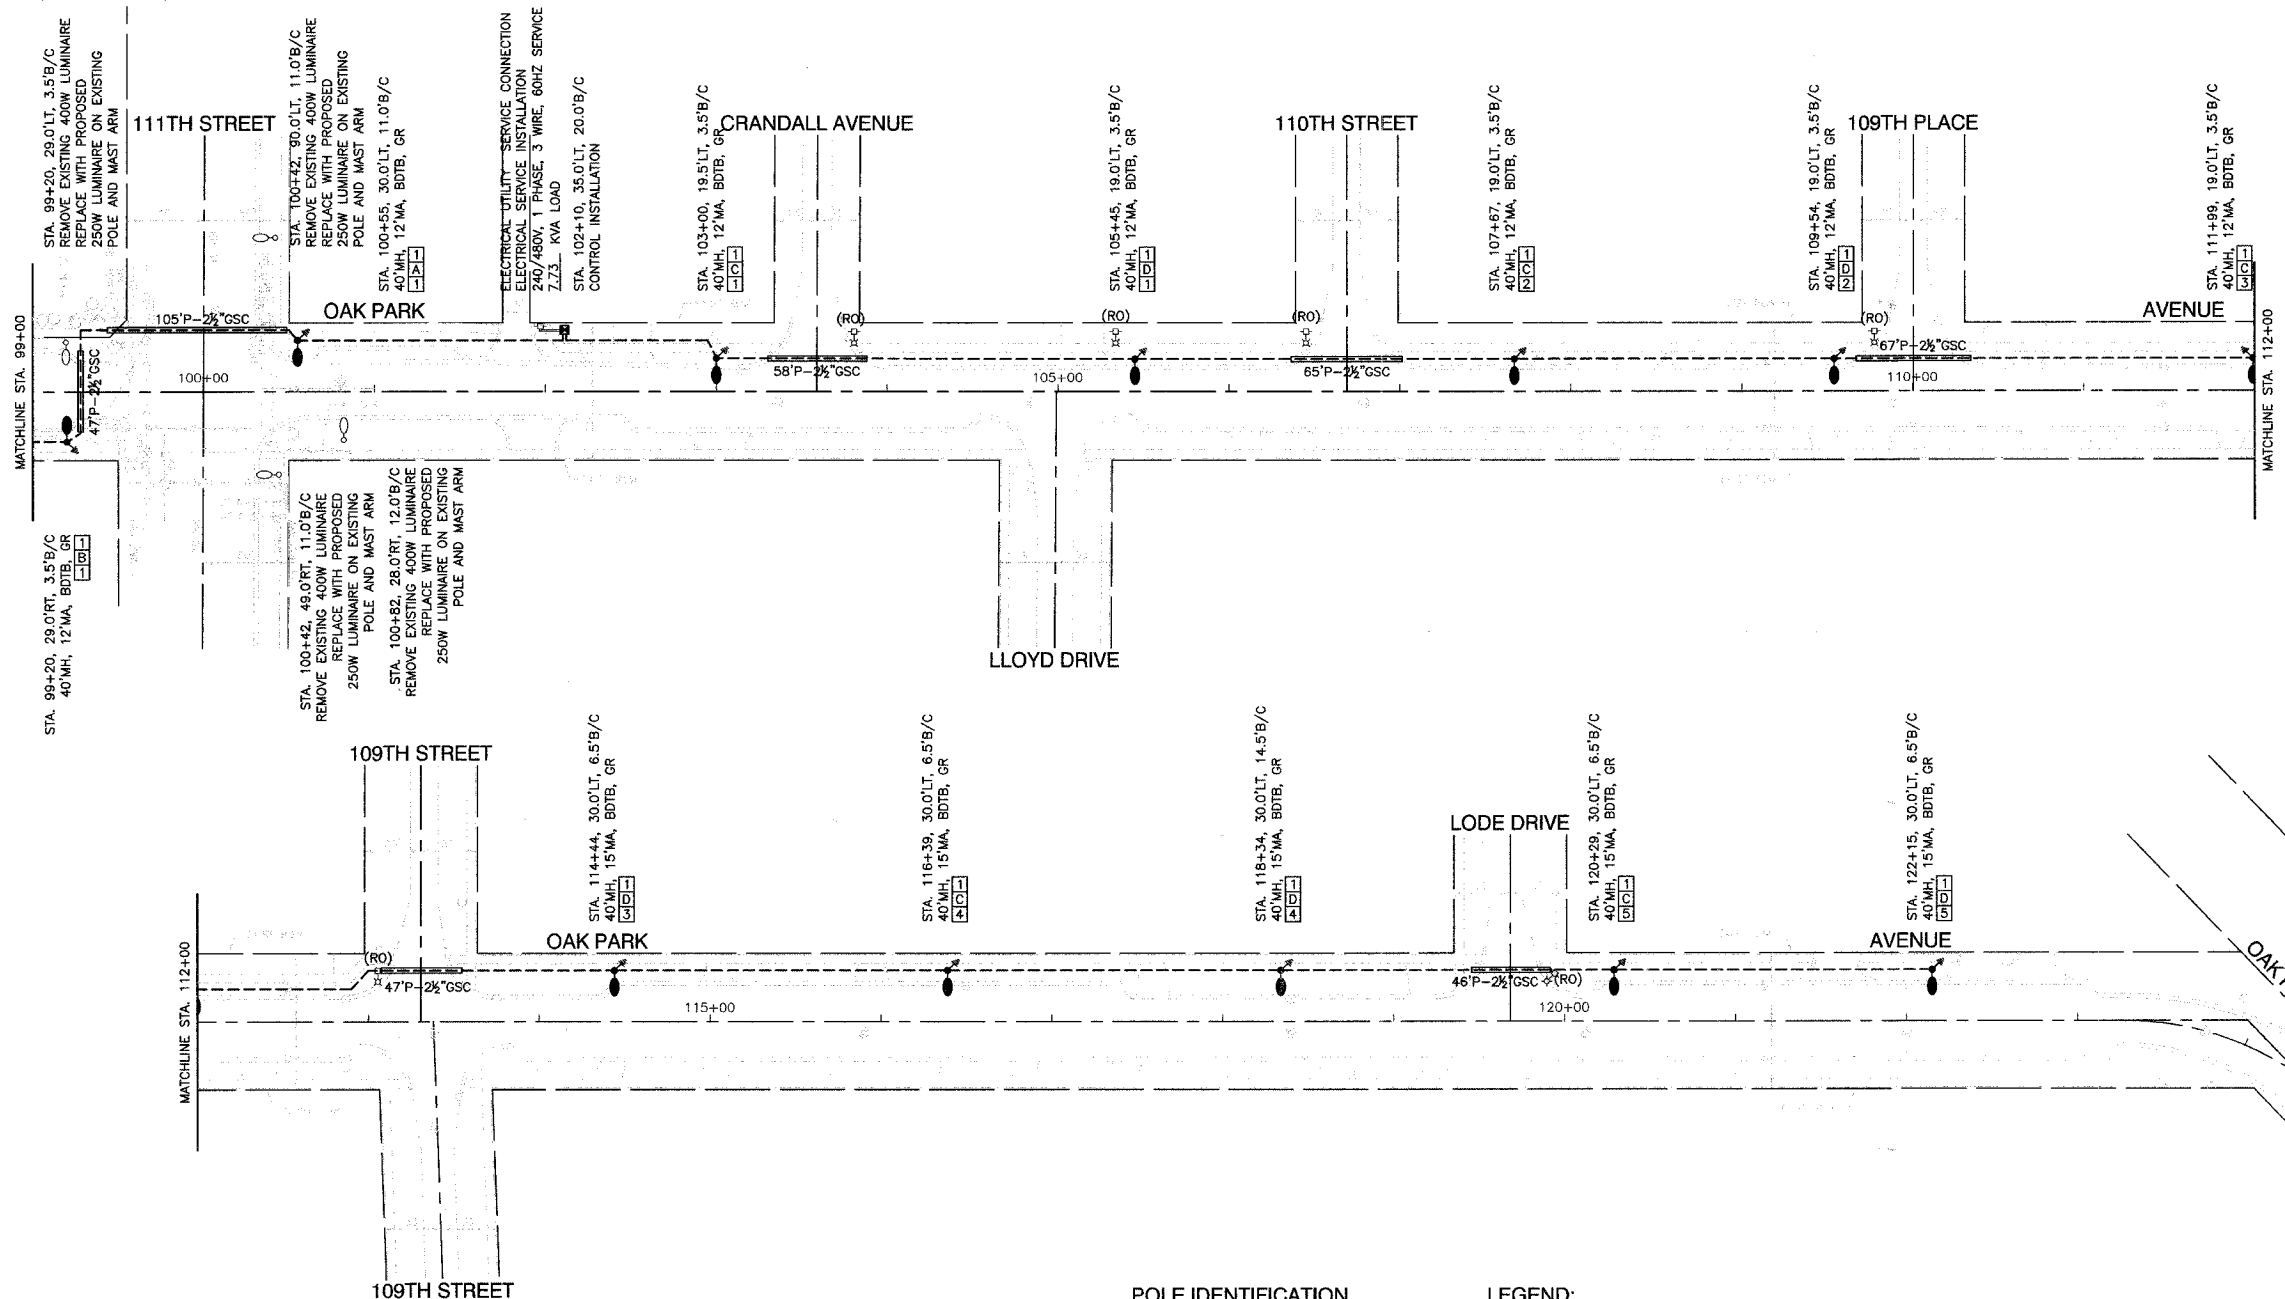

POLE IDENTIFICATION

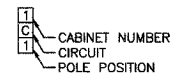

LEGEND:

- EXISTING STREET LIGHT
- PROPOSED STREET LIGHT-250W HPS
- PROPOSED CONTROLLER
- P — CONDUIT, PUSHED, GALVANIZED STEEL
- T — CONDUIT, TRENCHED, GALVANIZED STEEL
- - - UNIT DUCT, 3-1/C, NO.6 AWG AND NO.8 GROUND, 600V IN 1-1/4" DUCT
- S — SERVICE WIRE, 3-1/C, NO. 1/0 AWG. (SEE LIGHTING CONTROLLER PLAN)
- ⊗ GR GROUND ROD, 5/8" DIA. x 10'
- (RO) REMOVAL OF EXISTING STREET LIGHT BY OTHERS
- LT LEFT
- RT RIGHT
- MH MOUNTING HEIGHT
- MA MAST ARM
- B/C BACK OF CURB
- BDTB BREAKAWAY DEVICE, TRANSFORMER BASE, 15" BOLT CIRCLE
- R&R REMOVE AND REPLACE EXISTING STREET LIGHT

REVISIONS	
NAME	DATE

ILLINOIS DEPARTMENT OF TRANSPORTATION

OAK PARK AVENUE STREET LIGHTING PLAN SHEETS

SCALE: VERT. NA
 HORIZ. 1"=50'
 DATE 4-6-07

DRAWN BY PS
 CHECKED BY TRL/DWS

ROBINSON ENGINEERING, LTD.
 1700 SOUTH PARK AVENUE, SOUTH HOLLAND, ILLINOIS 60473
 (708) 925-4200 FAX (708) 311-5628
 ILLINOIS DESIGN FIRM REGISTRATION NO. 1-94207-123 05562-PLAN-01 - P02