




P10.EROS_SHT11_HRGREEN.dgn

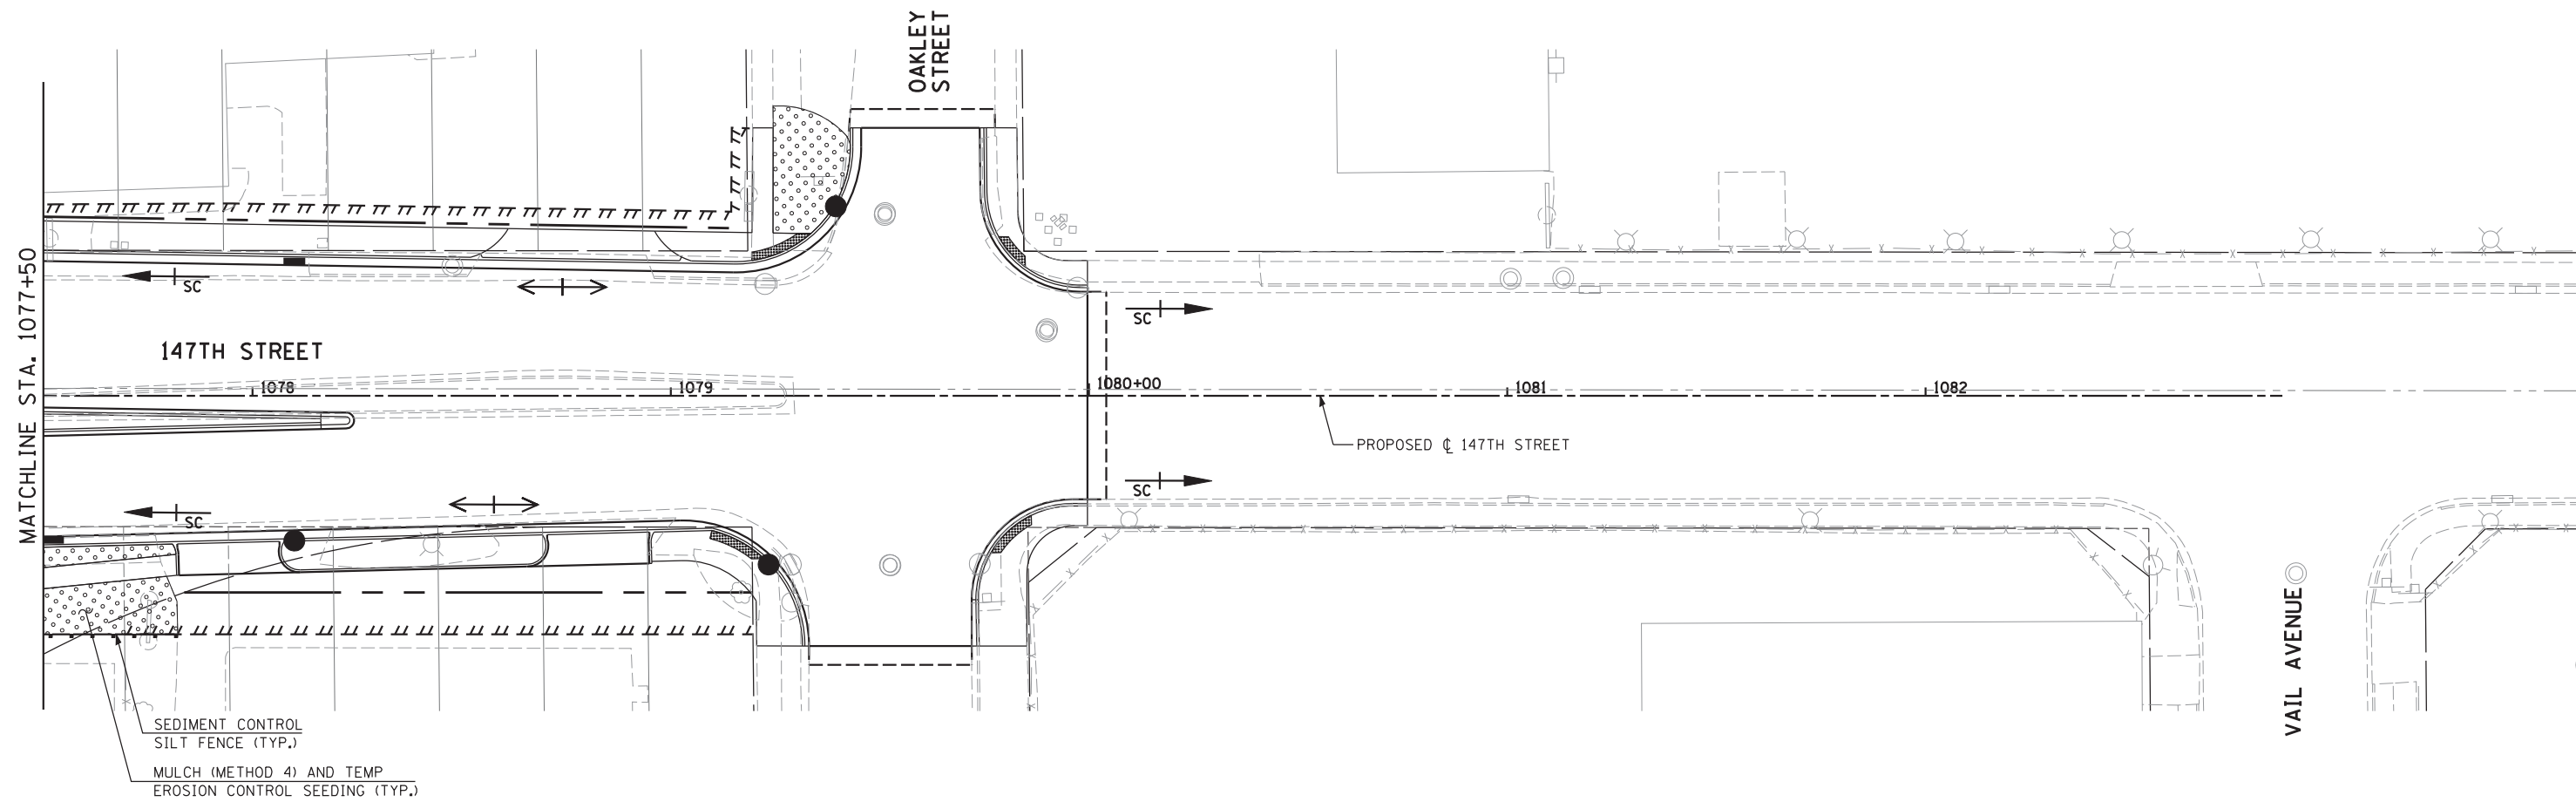


SEDIMENT CONTROL
SILT FENCE (TYP.)
MULCH (METHOD 4) AND TEMP
EROSION CONTROL SEEDING (TYP.)

INLET FILTERS

- STA 1077+52.3, 33.6' RT
- STA 1078+10, 31.2' LT
- STA 1078+10, 32.1' RT
- STA 1079+25.9, 40.3' RT
- STA 1079+40.5, 43' LT
- STA 1079+73.9, 40.2' RT
- STA 1079+97.2, 25.8' LT

LEGEND	
	EXISTING RIGHT-OF-WAY
	PROPOSED RIGHT-OF-WAY
	PROPOSED TEMPORARY EASEMENT

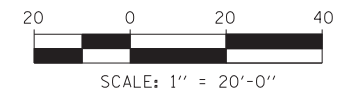

<p>HRGreen.com Illinois Professional Design Firm #184-001322</p>	USER NAME =	DESIGNED - JRS	REVISED - JRS 12/01/2011
		DRAWN - MJF	REVISED - JRS 02/15/2012
	PLOT SCALE =	CHECKED - APS	REVISED - JRS 05/04/2012
	PLOT DATE =	DATE - 7/22/2011	REVISED -

**STATE OF ILLINOIS
DEPARTMENT OF TRANSPORTATION**

**147TH STREET PROJECT
EROSION CONTROL PLAN - 147TH STREET**

SCALE: 1"=20' SHEET NO. 11 OF 22 SHEETS STA. 1077+50 TO STA. 1083+00

F.A.I. RTE.	SECTION	COUNTY	TOTAL SHEETS	SHEET NO.
57	(0405-1 & 0506-2) R-1	COOK	577	183
FED. ROAD DIST. NO. ILLINOIS FED. AID PROJECT			CONTRACT NO. 60M57	