
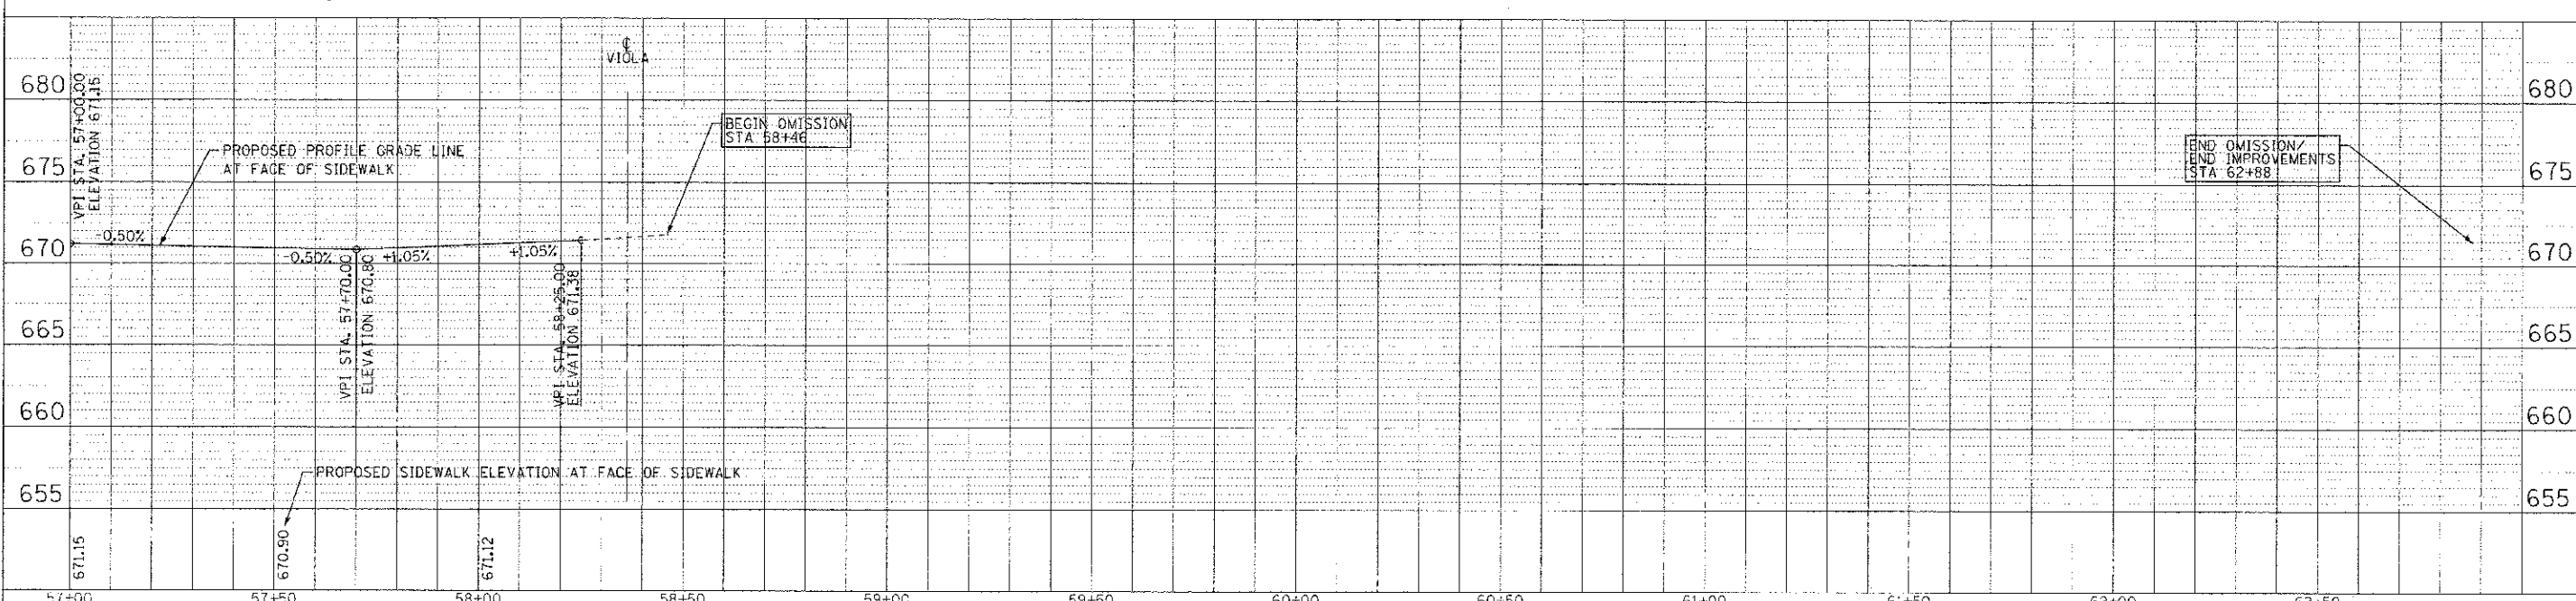


STORM STRUCTURES						
STRUCTURE NUMBER	STATION	OFFSET	STRUCTURE	FRAME AND LID	RIM	INVERTS
S-21	57+98	22.3' RT	PRECAST REINFORCED CONCRETE FLARED END SECTIONS 12"			670.00 (NE)
S-22	58+15	27.3' RT	CATCH BASINS, TYPE A	TYPE 1, CLOSED LID		669.80 (N) 669.80 (SW) 669.80 (N)
S-23	58+18	44.9' RT	PRECAST REINFORCED CONCRETE FLARED END SECTIONS 12"			670.20 (W)

STORM PIPES					
PIPE NO.	CLASS/TYP	DIAMETER	LENGTH (FT)	SLOPE (%)	TBF (CYD)
P-15	STORM SEWERS, PVC, SDR 26, 12"	12	12	2.22%	0
P-16	STORM SEWERS, PVC, SDR 26, 12"	12	12	3.33%	2

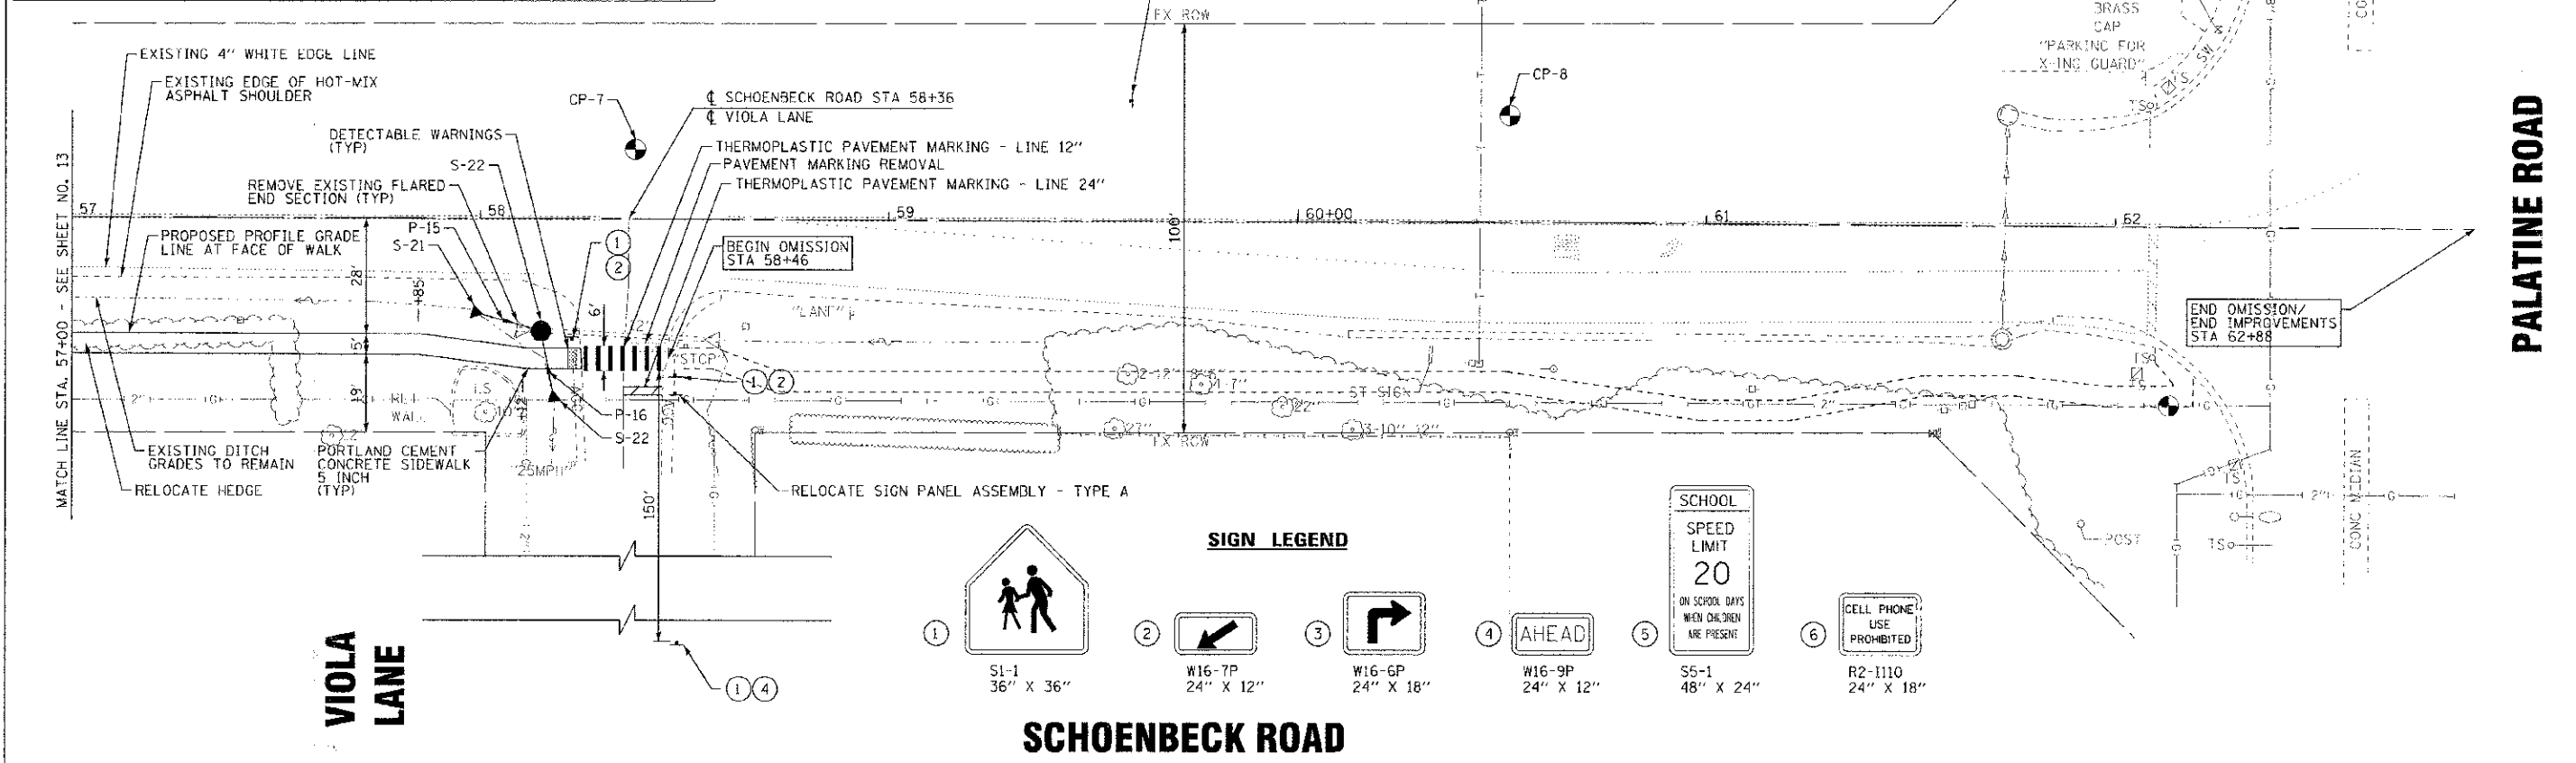

	DESIGNED - MWP	REVISED - IDOT/CHD REVIEW 06-25-12	CITY OF PROSPECT HEIGHTS, ILLINOIS SCHOENBECK ROAD SAFE ROUTES TO SCHOOLS	PLAN AND PROFILE	F.A.J. RTE. 2673	SECTION 12-00049-00-SW	COUNTY COOK	TOTAL SHEETS 27	SHEET NO. 14
	DRAWN - HKM	REVISED - IDOT/CHD REVIEW 07-12-12			C-91-905-2	CONTRACT NO. 63731			
	CHECKED - JUF	REVISED -			FED. ROAD DIST. NO.	ILLINOIS FED. AID PROJECT M-SRTS-4009(E)			
	DATE 06-25-12	FILE 11088; TCM PP9.sht			SCALE: H: 1"=20' V: 1"=5'	STA. 57+00 TO STA. 63+59			

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