09/23/2022 LETTING, ITEM 051


FOR INDEX OF SHEETS, SEE SHEET NO. 2 FOR LIST OF HIGHWAY STANDARDS, SEE SHEET NO. 2 FOR SUMMARY OF QUANTITIES, SEE SHEETS NO. 4 - 7

STATE OF ILLINOIS DEPARTMENT OF TRANSPORTATION

PLANS FOR PROPOSED FEDERAL AID HIGHWAY

VARIOUS ROUTES, VARIOUS LOCATIONS SECTION NO. 19-DCCSS-04-TL PROJECT NO. 9CTW(805) CENTRAL SIGNAL SYSTEM EXPANSION 4 DuPAGE COUNTY

C-91-096-22

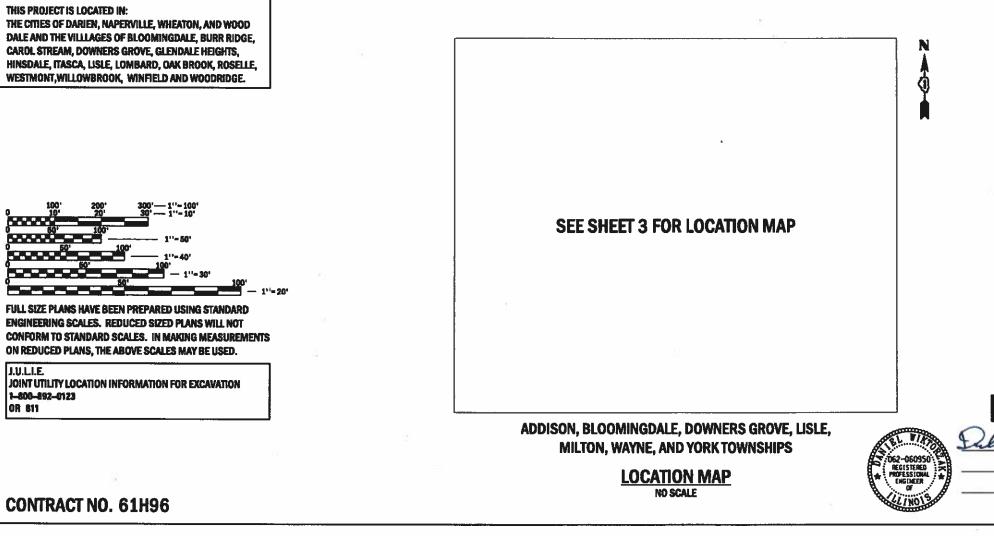


JERAL AID PROGRAM ENGINEER: CARMEN E. RAMOS, P.E., SCHAUMBURG, IL

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HIGHWAY STANDARDS

000001-08	STANDARD SYMBOLS, ABBREVIATIONS, & PATTERNS
001006	DECIMAL OF AN INCH AND OF A FOOT
701006-05	OFF-RD OPERATIONS, 2L, 2W, 15'(4.5M) TO 24"(600MM) FROM PAVEMENT EDGE
701011-04	OFF-RD MOVING OPERATIONS 2L, 2W, DAY ONLY
701101-05	OFF-RD OPERATIONS, MULTILANE 15 (4.5M) TO 24 (600MM) FROM PAVEMENT EDGE
701106-02	OFF-RD OPERATIONS, MULTILANE MORE THAN 15 (4.5M) AWAY
701301-04	LANE CLOSURE. 2L, 2W, SHORT TIME OPERATIONS
701311-03	LANE CLOSURE. 2L, 2W, MOVING OPERATIONS - DAY ONLY
701426-09	LANE CLOSURE. MULTILANE, INTERMITTENT OR MOVING OPERATION, FOR SPEEDS \geq 45 MPH
701427-05	LANE CLOSURES, MULTILANE, INTERMITTENT OR MOVING OPERATION, FOR SPEEDS \leq 40 MPH
701501-06	URBAN LANE CLOSURE, 2L, 2W, UNDIVIDED
701502-09	URBAN LANE CLOSURE, 2L, 2W, WITH BIDIRECTIONAL LEFT TURN LANE
701601-09	URBAN LANE CLOSURE, MULTILANE, 1W OR 2W, WITH NONTRAVERSABLE MEDIAN
701602-10	URBAN LANE CLOSURE, MULTILANE, 2W, WITH BIDIRECTIONAL LEFT TURN LANE
701606-10	URBAN SINGLE LANE CLOSURE, MULTILANE 2W WITH MOUNTABLE MEDIAN
701701-10	URBAN LANE CLOSURE, MULTILANE INTERSECTION
701801-06	SIDEWALK, CORNER OF CROSSWALK CLOSURE
701901-07	TRAFFIC CONTROL DEVICES
805001-01	ELECTRICAL SERVICE INSTALLATION DETAILS
814001-03	HANDHOLES
857001-01	STANDARD PHASE DESIGNATION DIAGRAMS AND PHASE SEQUENCES
862001-01	UNINTERRUPTABLE POWER SUPPLY (UPS)
072001 02	TRAFFIC SIGNAL CROUNDING AND RONDING

873001-02 TRAFFIC SIGNAL GROUNDING AND BONDING

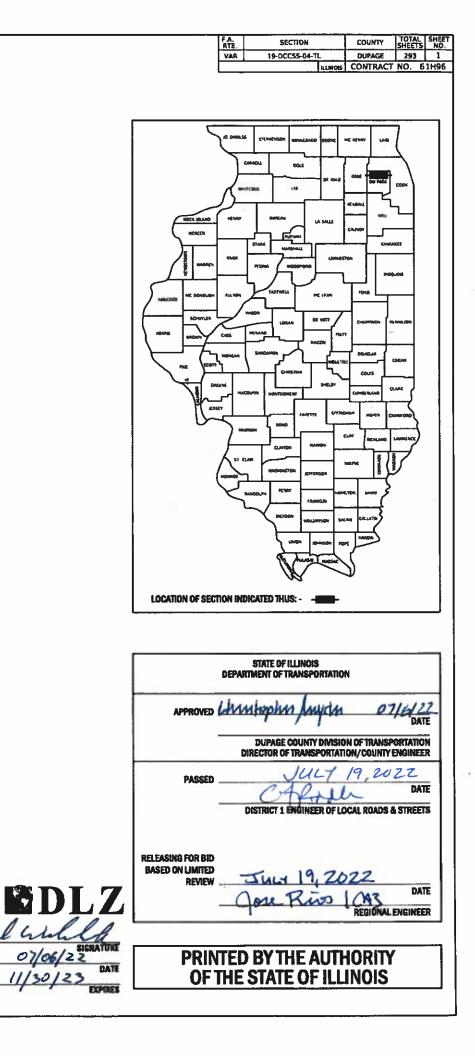GENERAL NOTES

- 1. THE ILLINOIS DEPARTMENT OF TRANSPORTATION "STANDARD SPECIFICATIONS FOR ROAD AND BRIDGE CONSTRUCTION". JANUARY 1, 2022; MANUAL OF UNIFORM TRAFFIC CONTROL DEVICES FOR STREETS AND HIGHWAYS, LATEST EDITION; PROJECT SPECIFICATIONS; ALL APPLICABLE REQUIREMENTS OF THE ILLINOIS DEPARTMENT OF TRANSPORTATION; THE CITY OF DARIEN, NAPERVILLE, WHEATON, AND WOOD DALE; THE VILLLAGES OF BLOOMINGDALE, BURR RIDGE, CAROL STREAM, DOWNERS GROVE, GLENDALE HEIGHTS, HINSDALE, ITASCA, LISLE, LOMBARD, OAK BROOK, ROSELLE, WESTMONT, WILLOWBROOK, WINFIELD AND WOODRIDGE; THE DUPAGE COUNTY DIVISION OF TRANSPORTATION; ALL APPLICABLE REQUIREMENTS OF THE ORDINANCES OF AUTHORITIES HAVING JURISDICTION; AND ALL ADDENDA THERETO SHALL GOVERN THIS WORK. 2. THE STANDARDS SPECIFICATIONS, PROJECT SPECIFICATIONS
- CONSTRUCTION PLANS, AND SUBSEQUENT DETAILS ARE ALL TO BE CONSIDERED AS PART OF THE CONTRACT.
- 3. THE CONTRACTOR SHALL SOLELY BE RESPONSIBLE FOR THE INSTALLATION AND MAINTENANCE OF ADEQUATE SIGNS, TRAFFIC CONTROL DEVICES, AND WARNING DEVICES TO INFORM AND PROTECT THE PUBLIC DURING ALL PHASES OF CONSTRUCTION.
- 4. THE CONTRACTOR IS RESPONSIBLE FOR RETURNING ALL AREAS AFFECTED BY EQUIPMENT OR LABORERS TO EXISTING CONDITIONS. THE CONTRACTOR IS ALSO RESPONSIBLE FOR PROTECTING ALL NEW WORK UNTIL COMPLETION OF THIS CONTRACT.
- 5. EXISTING UTILITIES: WHEN THE PLANS OR SPECIAL PROVISIONS INCLUDE INFORMATION PERTAINING TO THE LOCATION OF UNDERGROUND UTILITY FACILITIES, SUCH INFORMATION IS BASED ON RECORD INFORMATION PROVIDED BY THE INDIVIDUAL UTILITY OWNERS. IT SHALL BE THE CONTRACTOR'S RESPONSIBILITY TO DETERMINE THE ACTUAL LOCATION OF ALL SUCH FACILITIES. THE CONTRACT SHALL ALSO CONTACT J.U.L.I.E. TO OBTAIN LOCATES OF THE RESPECTIVE UTILITY COMPANIES UNDERGROUND **FACILITIES**
- 6. IT SHALL BE THE CONTRACTOR'S RESPONSIBILITY TO VERIFY ALL DIMENSIONS AND THE CONDITIONS EXISTING IN THE FIELD PRIOR TO ORDERING MATERIALS AND BEGINNING CONSTRUCTION
- 7. THE EXACT LOCATION OF ALL UTILITIES SHALL BE FIELD VERIFIED BY THE CONTRACTOR BEFORE ORDERING ANY MATERIALS AND STARTING ANY WORK, FOR LOCATIONS OF UTILITIES, LOCALLY OWNED EOUIPMENT, LEASED ENFORCEMENT CAMERA SYSTEM FACILITIES, AND IDOT UNDERGROUND FACILITIES, CONTACT THE LOCAL COUNTIES MUNICIPALITIES, AND IDOT FOR LOCATES, THE CONTRACTOR SHALL CALL 'JULIE' AT (800) 892-0123 OR 811 FOR FIELD LOCATIONS OF BURIED UTILITIES (48 HOURS NOTIFICATION REOUIRED)
- 8. THE CONTRACTOR SHALL CHECK THE PROPOSED TRAFFIC SIGNAL EQUIPMENT LOCATIONS FOR OVERHEAD UTILITY CONFLICTS. THE CONTRACTOR SHALL COORDINATE ANY CONFLICTS WITH THE UTILITY COMPANIES AND THE RESIDENT ENGINEER BEFORE ORDERING MATERIALS.
- 9. THE CONTRACTOR SHALL COORDINATE CONSTRUCTION ACTIVITIES WITH UTILITY COMPANIES, LOCAL GOVERNMENT AGENCIES, AND IDOT
- 10. THIS PROJECT INVOLVES THE INSTALLATION OF CONDUIT; HANDHOLES; UPGRADED OR REPLACEMENT CONTROLLERS AND CABINETS; FIBER-OPTIC CABLE: PTZ CAMERAS AND THEIR PERIPHERALS AND CABLES: AND MOUNTING POLES AT LOCATIONS SHOWN ON THE PLANS.
- 11. THESE PLANS USE EXISTING PLANS AS BACKGROUND WHERE POSSIBLE. THE CONTRACTOR SHALL USE CARE TO CORRECTLY DISTINGUISH PROPOSED WORK FROM THE EXISTING WORK. CALLOUTS AND OTHER INFORMATION IN THE BACKGROUND OF THE VIDEO CAMERA INSTALLATION COMMUNICATION NODES, AND COMMUNICATION INTERCONNECT PLAN SHEETS ARE NOT APPLICABLE TO THIS CONTRACT. APPLICABLE ITEMS ON THESE SHEETS ARE IDENTIFIED BY BOLD CALLOUTS. BACKGROUNDS HAVE BEEN LIGHTENED TO HIGHLIGHT THE DISTINCTION BETWEEN BOLD CALLOUTS AND BACKGROUNDS.
- 12. RIGHT-OF-WAY LINES SHOWN ON THE PLANS ARE APPROXIMATE. THE CONTRACTOR SHALL ENSURE THAT ALL WORK IS PERFORMED WITHIN EXISTING COUNTY, CITY OR STATE RIGHT-OF-WAY. THIS PROJECT INVOLVES NO RIGHT-OF-WAY ACOUISITION.
- 13. THE SYSTEM COMMUNICATIONS ARE INTENDED TO OPERATE USING BOTH EXISTING AND PROPOSED FIBER OPTIC CABLES. INTERCONNECT SCHEMATICS ARE INCLUDED FOR AREAS THAT INVOLVE PROPOSED FIBER OPTIC CABLE. SHEETS SHOWING EXISTING CABLES ARE ALSO INCLUDED FOR INFORMATION ONLY

JSER NAME = dwiktorzak DESIGNED -REVISED INDEX OF SHEETS, HIGH STATE OF ILLINOIS DRAWN REVISED GENERAL NOTES AND OT SCALE = 40.0000 ' / in HECKED REVISED **DEPARTMENT OF TRANSPORTATION** SCALE: NTS SHEET 1 OF 1 SHEET DATE REVISED PLOT DATE = 7/7/2022

14. THE CONTRACTOR SHALL COORDINATE WITH DUDOT AND THE VILLAGE OF LOMBARD FOR THE LOCATION AND ORIENTATION OF EACH PROPOSED PTZ CAMERA PRIOR TO CAMERA INSTALLATION

15. THE CONTRACTOR SHALL MARK THE RECORD DRAWINGS TO REFLECT ANY CHANGES TO THE PLANS, THE RECORD DRAWING REQUIREMENTS ARE IDENTIFIED IN SECTION 801.16 OF THE STANDARD SPECIFICATIONS AND THE SPECIAL PROVISIONS.

16. THE CONTRACTOR SHALL CONTACT KALPANA KANNAN-HOSADURGA, THE DISTRICT ONE TRAFFIC CONTROL SUPERVISOR. AT KALAPANA HOSADURGA@ILLINOIS.GOV A MINIMUM OF 72 HOURS IN ADVANCE OF BEGINNING WORK.

18. ABBREVIATIONS HAVE BEEN USED THROUGHOUT THE PLANS. SEE ARTICLE 101.01 OF THE STANDARD SPECIFICATIONS, STANDARD SYMBOLS, ABBREVIATIONS AND PATTERNS (STANDARD 000001), AND DISTRICT ONE DETAIL STANDARD TRAFFIC SIGNAL DESIGN DETAILS (TS-05) FOR MOST ABBREVIATIONS. IN ADDITION, THE FOLLOWING ABBREVIATIONS HAVE BEEN USED IN THE PLANS AND ARE TO BE CONSTRUED THE SAME AS THE RESPECTIVE EXPRESSIONS REPRESENTED:

ATMS ссти HAR IDOT ISTHA ITS DUDOT TMC ONC

17. REMOVAL NOTES INDICATE THE EQUIPMENT IN USE AT THE TIME THE PLANS WERE PREPARED AND SERVE AS GUIDANCE TO THE CONTRACTOR. IN CASES WHERE THE CONTROLLER TYPE AND MODEL DIFFER FROM THE NOTES IN THE PLANS, THE CONTRACTOR SHALL CONFIRM DISPOSAL WITH DUPAGE COUNTY PRIOR TO SALVAGING. IN NO CASE SHALL THE CONTRACTOR DISPOSE OF AN ASC/3, COBALT AS2/M MASTER, M-50 SERIES, OR M-60 SERIES CONTROLLER. THESE CONTROLLERS REMAIN THE PROPERTY OF DUPAGE COUNTY AND SHALL BE RETURNED UNLESS WRITTEN AUTHORIZATION IS PROVIDED BY THE DUPAGE COUNTY DOT TRAFFIC ENGINEER.

> ADVANCED TRAFFIC MANAGEMENT SYSTEM CLOSED-CIRCUIT TELEVISION HIGHWAY ADVISORY RADIO ILLINOIS DEPARTMENT OF TRANSPORTATION ILLIONOIS STATE TOLL HIGHWAY AUTHORITY INTELLIGENT TRANSPORTATION SYSTEM DUPAGE COUNTY DIVISION OF TRANSPORTATION TRAFFIC MANAGEMENT CENTER OUTDOOR NETWORK CABLE

19. THE QUANTITY FOR ROD AND CLEAN EXISTING CONDUIT IS FOR USE WITH EXISTING CONDUITS WHICH HAVE ALL EXISTING CABLES AND FIBER REMOVED. PRIOR TO INSTALLING PROPOSED CABLE AND/OR FIBER IN THE EXISTING CONDUIT.


20 CONTRACTOR SHALL TAKE PRECAUTION BY PRESERVING EXISTING TREES WITHIN THE RIGHT OF WAY IE ANY DAMAGE OCCURS TREES SHALL BE REPLACED IN KIND PER ARTICLE 201 07 REPAIR OR REPLACEMENT OF EXISTING PLANT MATERIAL REQUIREMENTS STATED HEREIN.

21. PROPOSED DETECTION ZONES FOR VEHICLE DETECTION SYSTEM, SPECIAL HAVE BEEN SHOWN ON PLAN SHEETS AT NEW LOCATIONS. AT LOCATIONS WHERE EXISTING VEHICLE DETECTION SYSTEMS ARE IN USE, EXISTING DETECTION ZONES MAY BE SHOWN IF RECORDS EXISTING INDICATING THE DETECTION ZONES. THE PROPOSED DETECTION ZONES AT LOCATION WITH EXISTING VEHICLE DETECTION SYSTEMS ARE TO BE THE SAME AS THE EXISTING DETECTION ZONES, UNLESS DIRECTED BY THE ENGINEER OTHERWISE.

COMMITMENTS

NO COMMITMENTS WERE MADE FOR THIS PROJECT.

łW	AY STAND	DARDS,	F.A. RTE	SEC	FION		COUNTY	TOTAL SHEETS	SHEET NO.
۰ c	OMMITM	ENTS	VAR.	19-DCCS	5S-04-TL		DUPAGE	293	2
		LINIS	_				CONTRACT	NO. 6	1H96
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LEGEND

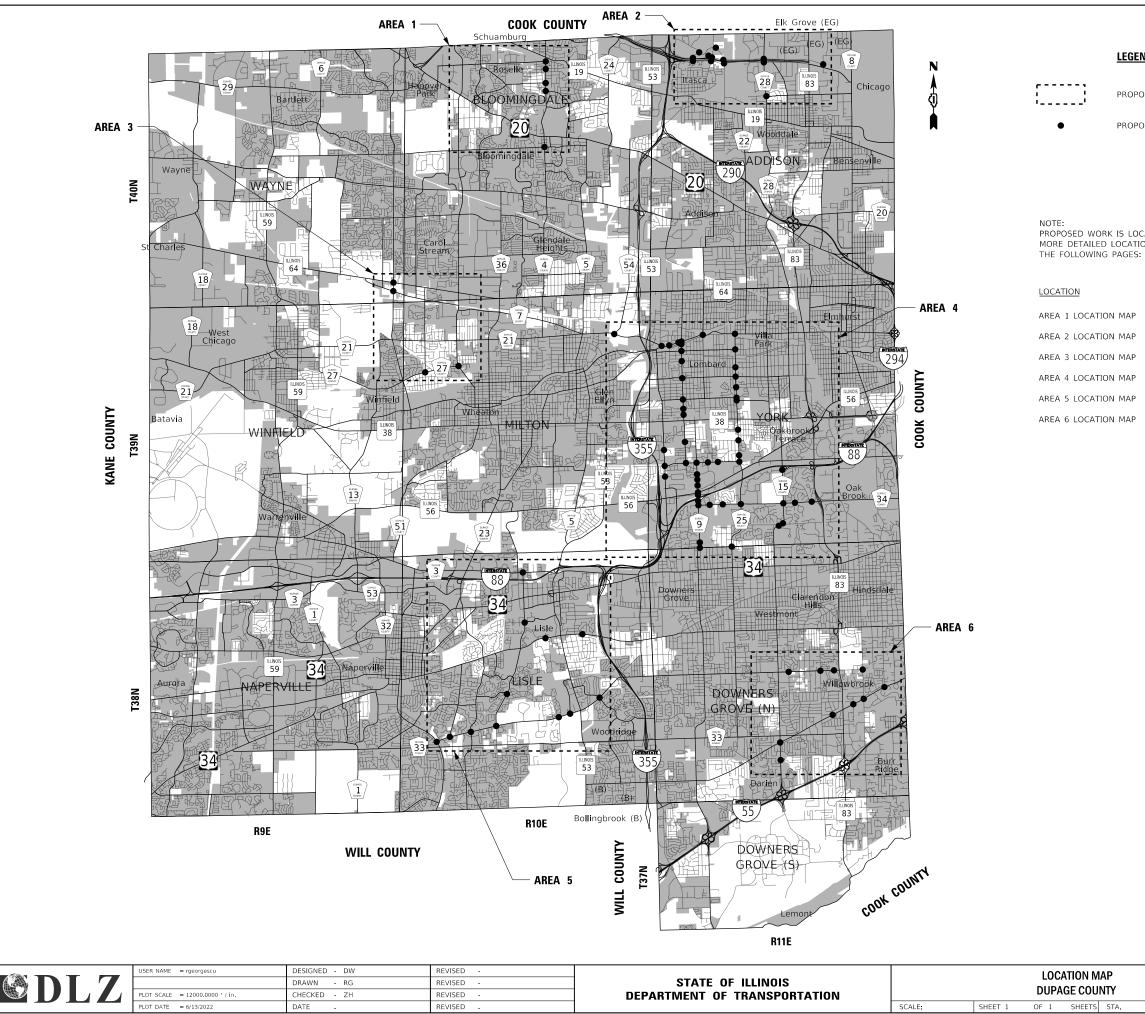PROPOSED IMPROVEMENT AREA

PROPOSED SIGNAL IMPROVEMENT LOCATION

PROPOSED WORK IS LOCATED AT 6 AREAS WITHIN DUPAGE COUNTY. MORE DETAILED LOCATION MAPS ARE INCLUDED FOR EACH AREA ON

		<u>SHEETS</u>
TION	MAP	8
TION	MAP	23
TION	MAP	52
TION	MAP	62 - 63
TION	MAP	223
TION	MAP	254

М	AP		F.A. RTE	SECTION		COUNTY	TOTAL SHEETS	SHEET NO.
м	NTY		VAR.	19-DCCSS-03-TL		DUPAGE	293	3
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TS	STA.	TO STA.		ILLINOIS	FED. A	D PROJECT		

SPEC.				TOTAL		00% FE	DERAL / 20 TRAFFIC		COOMIT	
PROV.	CODE NO.	PAY ITEM DESCRIPTION	UNIT	QUANTITY				21		
				4-				BAN		
					AREA 1	AREA 2	AREA 3	AREA 4	AREA 5	ARËA
	66900200	NON-SPECIAL WASTE DISPOSAL		155	5	10	5	110	15	10
	66900400	SPECIAL WASTE GROUNDWATER DISPOSAL	GALLON	3805	135	260	100	2710	370	230
	00500400		GALLON		155	200	100	2710	1,0	
	66900530	SOIL DISPOSAL ANALYSIS	EACH	18	1	1	1	12	2	1
				-						
	66901001	REGULATED SUBSTANCES PRE-CONSTRUCTION PLAN	L SUM	1	0,17	0,17	0.17	0.17	0.16	0.16
	66901003	REGULATED SUBSTANCES FINAL CONSTRUCTION REPORT	L SUM	1	0.17	0.17	0.17	0.17	0.16	0,16
	66901006	REGULATED SUBSTANCES MONITORING	CAL DA	11	0,5	1	0.5	7,5	1	0.5
	67100100	MOBILIZATION	L SUM	1	0.17	0.17	0.17	0.17	0.16	0,16
	0/100100	MODILIZATION		±	0.17	0.17	0.17	0.17	0.10	0,10
	70102620	TRAFFIC CONTROL AND PROTECTION, STANDARD 701501	L SUM	1	0.17	0,17	0,17	0,17	0.16	0.16
	70102622	TRAFFIC CONTROL AND PROTECTION, STANDARD 701502	LSUM	1	0,17	0.17	0.17	0.17	0.16	0.16
	70102625	TRAFFIC CONTROL AND PROTECTION, STANDARD 701606	L SUM	1	0.17	0.17	0.17	0.17	0,16	0.16
	70102630	TRAFFIC CONTROL AND PROTECTION, STANDARD 701601	L SUM	1	0.17	0.17	0.17	0.17	0.16	0.16
	70100000			7	0.17	0.17	0.17	0.17	0.16	0.16
	70102632	TRAFFIC CONTROL AND PROTECTION, STANDARD 701602	L SUM	1	0.17	0.17	0.17	0.17	0.16	0.10
	70102635	TRAFFIC CONTROL AND PROTECTION, STANDARD 701701	LSUM	1	0.17	0.17	0.17	0.17	0.16	0.16
	70102640	TRAFFIC CONTROL AND PROTECTION, STANDARD 701801	L SUM	1	0,17	0.17	0.17	0.17	0.16	0.16
	81028200	UNDERGROUND CONDUIT, GALVANIZED STEEL, 2" DIA.	FOOT	931				702	153	76
	81028220	UNDERGROUND CONDUIT, GALVANIZED STEEL, 3" DIA.	FOOT	962				962		
	81028240	UNDERGROUND CONDUIT, GALVANIZED STEEL, 4" DIA.	FOOT	661	64	100		357	140	
	81028240	UNDERGROUND CONDOLL, GALVANIZED STEEL, 4 DIA.	1001	001		100			140	
D1	81028750	UNDERGROUND CONDUIT, COILABLE NONMETALLIC CONDUIT, 2" DIA.	FOOT	124952	7217	4766	4871	71485	22852	13761
	81104580	CONDUIT ATTACHED TO STRUCTURE, 2" DIA., STAINLESS STEEL	FOOT	1001				297	704	
	81300550	JUNCTION BOX, STAINLESS STEEL, ATTACHED TO STRUCTURE, 12" X 12" X 6"	EACH	15				5	10	
·····										
01, D, SP	81400100	HANDHOLE	EACH	198	9	8	9	111	41	20
01, D, SP	81400200	HEAVY-DUTY HANDHOLE	EACH	3				3		
אר יח ידר ''			EACH	ى 	1					
01, D, SP	81400300	DOUBLE HANDHOLE	EACH	3				3		
							<u> </u>			
D1, D	85000200	MAINTENANCE OF EXISTING TRAFFIC SIGNAL INSTALLATION	EACH	129	6	15	4	62	29	13
D1	85700200	FULL-ACTUATED CONTROLLER AND TYPE IV CABINET	EACH	1			1	1		
	33730200			*				<u> </u>	-	

* SPECIALITY ITEM ** CONSTRUCTION CODE 0042

D1 DISTRICT 1 SPECIAL PROVISION BDE BUREAU OF DESIGN SPECIAL PROVISION D DUDOT SPECIAL PROVISION SP SPECIAL PROVISION

	USER NAME = zhoerbert	DESIGNED -	REVISED -				F	F.A. SECTION	COUNTY TOTAL SHEET SHEETS NO.
		DRAWN -	REVISED +] STATE OF ILLINOIS		SUMMARY OF QUANTITIES		VAR. 19-DCCSS-04-TL	DUPAGE 293 4
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	PLOT DATE # 6/15/2022	DATE -	REVISED -		SCALE:	SHEET 1 OF 4 SHEETS STA.	TO STA.	ILLINOIS FED. 4	AID PROJECT
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SPEC.				TOTAL		00/01		% DUPAGE SIGNAL	00001	
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				-			UR	BAN		
					AREA 1	AREA 2	AREA 3	AREA 4	AREA 5	AREA
	06100700									<u> </u>
	86400100	TRANSCEIVER - FIBER OPTIC	EACH	5	1			2	2	
Dl	87300010	GROUNDING EXISTING HANDHOLE FRAME AND COVER	EACH	164	4	10		146	4	
Dl	87300925	ELECTRIC CABLE IN CONDUIT, TRACER, NO. 14 1C	FOOT	171056	8970	6750	5550	106476	26745	1656
D1	87301805	ELECTRIC CABLE IN CONDUIT, SERVICE, NO. 6 2 C	FOOT	1792	165	160	34	1071	93	269
D1	87301900	ELECTRIC CABLE IN CONDUIT, EQUIPMENT GROUNDING CONDUCTOR, NO. 6 1C	FOOT	25704	798	1561	34	22292	750	269
	87900200	DRILL EXISTING HANDHOLE	EACH	166	14	8	4	102	22	16
	88500100	INDUCTIVE LOOP DETECTOR	EACH	117	7	13		94	3	
			EACH	LL?				34		
	88700300	LIGHT DETECTOR AMPLIFIER	EACH	1	1					
D1	89501410	RELOCATE EXISTING EMERGENCY VEHICLE PRIORITY SYSTEM, PHASING UNIT	EACH	29		2		25	1	1
	89502300	REMOVE ELECTRIC CABLE FROM CONDUIT	FOOT	53422	5285	1250	14	39416	1264	619
D1, D	89502375	REMOVE EXISTING TRAFFIC SIGNAL EQUIPMENT	EACH	63	2	3	1	50	3	4
	89502380	REMOVE EXISTING HANDHOLE	EACH	20				11	1	8
SP	X0322765	RELOCATE VIDEO VEHICLE DETECTION SYSTEM	EACH	5				5		
D1	X0324599	ROD AND CLEAN EXISTING CONDUIT	FOOT	20148	1970	925	14	16981	73	18
SP	X0326104	RELOCATE RADAR DETECTOR SYSTEM	EACH	2				1	1	
				-						
D	X1400102	OUTDOOR RATED NETWORK CABLE	FOOT	8914	235	1314		6495	279	59
D	X1400150	SERVICE INSTALLATION, GROUND MOUNTED, METERED	EACH	2			· · · · · · · · · · · · · · · · · · ·	1		I
D	X1400158	FIBER OPTIC SPLICE ENCLOSURE	EACH	8		1		7		
SP	X1400170	FIBER OPTIC SPLICE CLOSURE, WATERTIGHT	EACH	36				36		
D	X1400215	REMOTE CONTROLLED VIDEO SYSTEM	EACH	47	1	5		36	1	4
	X1400216	LAYER II (DATALINK) SWITCH	EACH	73	4	13		45	3	8
D	X1400221	UPGRADE EXISTING CONTROLLER TO NTCIP SPECIAL	EACH	21	1	10		10		
D	X1400303	FIBER OPTIC PATCH PANEL, 24 PORT, CABINET MOUNT	EACH	78	4	13	1	44	9	7
SP	X1400335	WIRELESS TRANSMISSION SYSTEM POINT TO POINT	EACH	2		2				
D	X1400460	LAYER III (NETWORK) SWITCH	EACH	8		1		7		

* SPECIALITY ITEM ** CONSTRUCTION CODE 0042

D1 DISTRICT 1 SPECIAL PROVISION BDE BUREAU OF DESIGN SPECIAL PROVISION D DUDOT SPECIAL PROVISION SP SPECIAL PROVISION

	USER NAME 🛥 zhoerbert	DESIGNED -	REVISED -					F.A. BTE.	SECTION COUNTY TOTA
		DRAWN -	REVISED -] STATE OF ILLINOIS		SUMMARY OF QUANTITIES		VAB.	19-DCCSS-04-TL DUPAGE 293
	PLOT SCALE = 100.0000 ' / in.	CHECKED -	REVISED -	DEPARTMENT OF TRANSPORTATION		-			CONTRACT NO.
	PLOT DATE = 6/15/2022	DATE -	REVISED -		SCALE:	SHEET 2 OF 4 SHEETS STA.	TO STA.		ILLINOIS FED. AID PROJECT
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CDCC					TO741		80% FEC	DERAL / 20%		COUNTY	
	0005.00										
PROV.	CODE NO.	PAY TIEM DESCRIPTION		UNIT	QUANTITY						
						AREA 1	AREA 2			AREA 5	AREA
							11112112	71112710	7.1.1.1.1	71112710	r ii viiir
SP	X8050095	SERVICE INSTALLATION (SPECIAL)		EACH	20	2	3	1	10	1	3
D	X8570215	FULL-ACTUATED CONTROLLER IN EXIS	TING CABINET	EACH	25	1	1		15	2	6

D	X8570226	FULL-ACTUATED CONTROLLER AND TY	PE IV CABINET, SPECIAL	EACH	30	1	2		25	1	1
D	X8620200	UNINTERRUPTABLE POWER SUPPLY, S	PECIAL	EACH	25	2	3	1	12	3	4
D	X8710024	FIBER OPTIC CABLE IN CONDUIT, NO. 62	2.5/125, MM12F SM24F	FOOT	13035	3240		1175		1745	687
D	X8710030	FIBER OPTIC CABLE 48 FIBERS, SINGLE	MODE	FOOT	187257	7610	6820	4535	133967	24515	981
SP	X8950212	MODIFY EXISTING CONTROLLER CABIN	ET, SPECIAL	EACH	58	3	12	1	25	9	8
SP	X8950510	REMOVE FIBER OPTIC CABLE FROM CO	NDUIT	FOOT	28018	3160	1095		21981		178
SP	XX005800	RELOCATE EXISTING UPS BATTERY BA	CK-UP SYSTEM	EACH	22				22		
D	XX007017	TERMINATE FIBER IN CABINET		EACH	410	8	198		92	76	36
	××007020			EACH	4						
<u> </u>	22007029	RELOCATE EXISTING TRANSCEIVER		EACH	۱ ۱				I		
SP	XX007536	PAINT TRAFFIC SIGNAL EQUIPMENT	***************************************	EACH	3				3		
D	XX007622	ELECTRIC METER		EACH	9	2			5	2	
D	XX007952	TERMINAL SERVER		EACH	2				2		
D	XX008251	SPLICE FIBER IN CABINET		EACH	182		50		40	86	6
	XX008254	LAYER III FIBER OPTIC TRANSCEIVER M	ODULE, SFP TYPE, LONG DISTANCE	EACH	47	1	4		35	6	1
D	XX008396	CAMERA MOUNTING ASSEMBLY, SPECIA	AL	EACH	5				5		
D	XX009046	VEHICLE DETECTION SYSTEM, SPECIAL		EACH	22	1			18	1	2
D1	70033046	RE-OPTIMIZE TRAFFIC SIGNAL SYSTEM	! FVFL 2	FACH	1						·····
D1	Z0050400	REMOVE AND REPLACE ANCHOR BOLTS	3	EACH	2				1		1
BDE	Z0076600	TRAINEES		HOUR	1000						
BDE	Z0076604	TRAINEES TRAINING PROGRAM GRADU	ATE	HOUR	1000						
SP	XX009537	WIRELESS TRANSMISSION SYSTEM SU		EACH	1		4				
SP [XX009538	HIBER CONNECTION, BUILDING NO. 1			1				1		
SP	XX009539	FIBER CONNECTION, BUILDING NO. 2		LSUM	1				1		
	I										
	D D D D D D D D D SP SP SP SP SP SP D SP D D D SP D	PROV.CODE NO.SPX8050095SPX8050095DX8570215DX8570266DX8570266DX8570266DX8620200DX8710024DX8710024DX8710024SPX8950510SPX8950510SPXX0076017SPXX007017SPXX007017SPXX007029SPXX007536SPXX007536SPXX007536DXX007522DXX007536DXX007526DXX007622DXX008254DXX008254DXX008254DXX008254DXX008254DXX008254DXX008254SPZ0076600SPZ0076604SPXX009537SPXX009538	PROV. CODE NO. PAY ITEM DESCRIPTION SP X8050055 SERVICE INSTALLATION (SPECIAL) D X8570215 FULL-ACTUATED CONTROLLER IN EXIST D X8570226 FULL-ACTUATED CONTROLLER AND TY D X8620200 UNINTERRUPTABLE POWER SUPPLY, SI D X8710024 FIBER OPTIC CABLE IN CONDUIT, NO. 62 D X8710030 FIBER OPTIC CABLE 48 FIBERS, SINGLE SP X8950510 REMOVE FIBER OPTIC CABLE FROM CO SP X8950510 REMOVE FIBER OPTIC CABLE FROM CO SP XX007029 RELOCATE EXISTING UPS BATTERY BAG SP XX007029 RELOCATE EXISTING TRANSCEIVER SP XX007029 RELOCATE EXISTING TRANSCEIVER SP XX007029 RELOCATE EXISTING TRANSCEIVER SP XX007536 PAINT TRAFFIC SIGNAL EQUIPMENT SP XX00752 TERMINAL SERVER D XX00752 TERMINAL SERVER D XX008251 SPLICE FIBER IN CABINET SP XX008251 SPLICE FIBER IN CABINET D XX008254 CAMERA MOUNTING ASSEMBLY, SPECIAL D XX	PROV. CODE NO. PAY ITEM DESCRIPTION SP X8850056 SERVICE INSTALLATION (SPECIAL) D X8570216 FULL-ACTUATED CONTROLLER IN EXISTING CABINET D X8570226 FULL-ACTUATED CONTROLLER IN EXISTING CABINET D X8670220 FULL-ACTUATED CONTROLLER AND TYPE IV CABINET, SPECIAL D X8670200 UNINTERRUPTABLE POWER SUPPLY, SPECIAL D X810030 FIBER OPTIC CABLE IN CONDUIT, NO, 62.5/125, MM12F SM24F T MODIFY EXISTING CONTROLLER CABINET, SPECIAL D X8950510 REMOVE FIBER OPTIC CABLE FROM CONDUIT SP X8950510 REMOVE FIBER OPTIC CABLE FROM CONDUIT SP X8050500 RELOCATE EXISTING UPS BATTERY BACK-UP SYSTEM SP XX007017 TERMINATE FIBER IN CABINET SP XX007029 RELOCATE EXISTING TRANSCEIVER SP XX007529 RELOCATE EXISTING TRANSCEIVER SP XX007520 RELOCATE EXISTING TRANSCEIVER SP XX007522 ELECTRIC METER SP	PROV. CODE NO. PAY ITEM DESCRIPTION UNIT NO. X8950005 SERVICE INSTALLATION (SPECIAL) EACH D X8570215 FULL-ACTUATED CONTROLLER IN EXISTING CABINET EACH D X8570236 FULL-ACTUATED CONTROLLER ND TYPE IV CABINET, SPECIAL EACH D X8570236 FULL-ACTUATED CONTROLLER AND TYPE IV CABINET, SPECIAL EACH D X8570236 FULL-ACTUATED CONTROLLER AND TYPE IV CABINET, SPECIAL EACH D X8570236 FULL-ACTUATED CONTROLLER AND TYPE IV CABINET, SPECIAL EACH D X8570236 FULL-ACTUATED CONTROLLER AND TYPE IV CABINET, SPECIAL FOOT D X8710030 FIBER OPTIC CABLE 48 FIBERS, SINGLE MODE FOOT SP X8950510 REMOVE FIBER OPTIC CABLE FROM CONDUIT FOOT SP X8950510 REMOVE FIBER OPTIC CABLE FROM CONDUIT FOOT SP X8007017 TERMINATE FIBER IN CABINET EACH SP X8007017 TERMINATE FIBER IN CABINET EACH SP X8007028 RELOCATE EXISTING TRANSCEIVER EACH SP X8007029 RELOCATE EXISTING TRANSCEIVER EACH SP X8007262 ELECTRIC METER EACH SP X80079282 RELOCATE EXISTING TRANSCEIVER	PROV. CODE NO. PAY ITEM DESCRIPTION UNIT QUANTITY SP X805005 SERVICE INSTALLATION (SPECIAL) EACH 20 SP X807026 FULL-ACTUATED CONTROLLER IN EXISTING CABINET EACH 20 TO X807026 FULL-ACTUATED CONTROLLER IN EXISTING CABINET EACH 20 TO X807026 FULL-ACTUATED CONTROLLER AND TYPE IN CABINET, SPECIAL EACH 20 TO X807026 FIBER OPTIC CABLE IN CONDUIT, NO, 52,5/125, MM12F BM24F FOOT 113035 TO X89710024 FIBER OPTIC CABLE AS FIBERS, SINGLE MODE FOOT 113035 SP X89710030 FIBER OPTIC CABLE FROM CONDUIT FOOT 200180 SP X895001 RELOCATE EXISTING LYPS BATTERY BACK-LYP SYSTEM FOOT 200180 SP X0007017 TERMINATE FIBER IN CABINET EACH 1 SP X0007020 RELOCATE EXISTING UPS BATTERY BACK-LYP SYSTEM EACH 1 SP X0007020 RELOCATE EXISTING CABINET EACH 1 SP X0007020 RELOCATE EXISTING UPS BATTERY BACK-LYP SYSTEM EACH 1 SP X0007020 RELOCATE EXISTING UPS BATTERY BACK-LYP SYSTEM EACH 1 SP X0007020 RELOCATE EXIS	PROV. CODE NO. PAY ITEM DESCRIPTION Unit PLACE 8P X805005 SERVICE INSTALLATION (SPECIAL) EACH 20 2 0 X857021 PLUL-ACTUATED CONTROLLER IN EXISTING CABINET EACH 28CH 2 1 0 X857022 FULL-ACTUATED CONTROLLER IN EXISTING CABINET EACH 20 2 1 0 X857023 FULL-ACTUATED CONTROLLER AND TYPE IV CABINET, SPECIAL EACH 20 2	HOW APY ITEM DESCRIPTION UNITY AUMINITY 9P 20000000 SERVICE INSTALLATION (SPECIAL) EACH 200 2 3 9P 20000000 SERVICE INSTALLATION (SPECIAL) EACH 200 2 3 10 25872215 FULL-ACTUATED CONTROLLER IN EXISTING CABINET. SPECIAL EACH 300 1 2 10 25872215 FULL-ACTUATED CONTROLLER AND TYPE IN CABINET. SPECIAL EACH 300 1 2 10 25872215 ININTERRUPTABLE POWER SUPPLY, SPECIAL EACH 300 1 2 10 25870205 ININTERRUPTABLE POWER SUPPLY, SPECIAL EACH 1021 2 3 10 25970215 ININTERRUPTABLE POWER SUPPLY, SPECIAL EACH 1021 3	ROV. ROV. PAVITEM DESCRIPTION UNIT QUANTRY Image: Control of the control of th	PROV. PAY TEM DESCRIPTION UNIT PULNATTY PULNATTY PULNATTY PULNATTY PI ARBA 1 AREA 2 AREA 2 <t< td=""><td>MRV. COUR NO. PAY TEM DESORPTION UNIT CUIL CUIL OUT OUT OUT See ABRO370 SERVICE INSTALLATION (REPECIAL) ARCA AREA3 AREA3</td></t<>	MRV. COUR NO. PAY TEM DESORPTION UNIT CUIL CUIL OUT OUT OUT See ABRO370 SERVICE INSTALLATION (REPECIAL) ARCA AREA3 AREA3

* SPECIALITY ITEM ** CONSTRUCTION CODE 0042

D1 DISTRICT 1 SPECIAL PROVISION BDE BUREAU OF DESIGN SPECIAL PROVISI D DUDOT SPECIAL PROVISION SP SPECIAL PROVISION

	USER NAME = dwiktorzak	DESIGNED -	REVISED -			•		F.A. RTF	SECTION	COUNTY TOTAL	
		DRAWN -	REVISED -	STATE OF ILLINOIS		SUMMARY OF QUAI	NTITIES	VAR.	19-DCC55-04-TL	DUPAGE 293	6
	PLOT SCALE = 100.0000 * / in.	CHECKED -	REVISED -	DEPARTMENT OF TRANSPORTATION							61H96
	PLOT DATE # 7/7/2022	DATE -	REVISED -		SCALE:	SHEET 3 OF 4 SHEETS	STA. TO STA.		ILLINOIS FED	AID PROJECT	
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			PROV.	CODE NO.	PAY ITEN	DESCRIPTION			UNIT	QUANTITY			
											AREA 1	AREA 2	AREA 3
							•						
			SP	XX009540	FIBER CO	NNECTION, BUILDING NO. 3			L SUM	1	1		
			SP	XX009541	FIBER CC	NNECTION, BUILDING NO. 4	~~~~~~~~~~~~~~~~~~~~~~~~~~~~~~~~~~~~~~~		LSUM	1			
			SP	XX009542	FIBER CC	NNECTION, BUILDING NO. 5			LSUM	1	- <u> </u>		
										· · · · · · · · · · · · · · · · · · ·			
			SP	XX009543	RACK MC	UNTED SPLICE ENCLOSURE			EACH	5			
			SP	XX009479	POE EXT				EACH	11		2	
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D D	DUDOT SPECIAL PROVIS	ION		-									-
		SER NAME 🛥 dwiktorzak	DESIGNE	D -	F	REVISED -							
S T)T 7 🗆		DRAWN	-	F	REVISED -		STATE OF ILLINOIS			:	SUMMARY	OF QUAN
		OT SCALE = 100.0000 ' / in. OT DATE = 7/7/2022	CHECKEI DATE	-		REVISED -	DEPARTN	IENT OF TRANSPORTATI	UN	SCALE:	SHEET 4	OF 4	SHEETS S

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	STA.	TO STA.			ILLINOIS	FED. A	ID PROJECT		



INTERSECTION PLANS

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<u>#</u>	LOCATION	<u>SHEETS</u>
24	BLOOMINGDALE RD AND SCHICK RD	10
61	ROSELLE RD AND WALNUT CT	11
58	ROSELLE RD AND BRYN MAWR AVE	12
60	ROSELLE RD AND MAPLE AVE	13
59	ROSELLE RD AND CENTRAL AVE	14 - 16

INTERCONNECT PLANS

LOCATION

A BLOOMINGDALE RD/ROS

	USER NAME = zhoerbert	DESIGNED - DW	REVISED -			TRAFFIC SIGNAL MODERNIZATION PLAN - AREA 1	F.A BT	SECTION	COUNTY TOTAL SHEET
		DRAWN - RG	REVISED -	STATE OF ILLINOIS				AR. 19-DCCSS-04-TL	DUPAGE 293 8
	PLOT SCALE = 2000.0000 / in.	CHECKED - ZH	REVISED -	DEPARTMENT OF TRANSPORTATION	AREA 1 LOCATION MAP				CONTRACT NO. 61H96
	PLOT DATE = 6/13/2022	DATE -	REVISED -		SCALE:	SHEET 1 OF 1 SHEETS STA. TO STA	۸.	ILLINOIS Fr	ED. AID PROJECT
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PROPOSED INTERCONNECT AREA - SEE INTERCONNECT PLANS PROPOSED SIGNAL IMPROVEMENT CORRIDOR PROPOSED SIGNAL IMPROVEMENT LOCATION


	5	HEET	<u>'S</u>
DSELLE RD	1	7 -	21

AREA 1 SIGNAL IMPROVEMENTS


					R	OSELLE	RD A	ND
PAY ITEM NO.	PAY ITEM DESCRIPTION	UNIT	TOTAL	BLOOMINGDALE RD AND SCHICK RD	WALNUT ST/WALNUT CT	BRYN MAWR AVE	MAPLE AVE	CENTRAL AVE/MAIN ST
85000200	MAINTENANCE OF EXISTING TRAFFIC SIGNAL INSTALLATION	EACH	5	1	1	1	1	1
86400100	TRANSCEIVER - FIBER OPTIC	EACH	1			1		
87300010	GROUNDING EXISTING HANDHOLE FRAME AND COVER	EACH	4			4		
87301805	ELECTRIC CABLE IN CONDUIT, SERVICE, NO. 6 2 C	FOOT	165			117	48	
87301900	ELECTRIC CABLE IN CONDUIT, EQUIPMENT GROUNDING CONDUCTOR, NO. 6 1C	FOOT	798			750	48	
88500100	INDUCTIVE LOOP DETECTOR	EACH	7			7		
88700300	LIGHT DETECTOR AMPLIFIER	EACH	1			1		
89502300	REMOVE ELECTRIC CABLE FROM CONDUIT	FOOT	2125			97	56	1972
89502375	REMOVE EXISTING TRAFFIC SIGNAL EQUIPMENT	EACH	2			1	1	
X0324599	ROD AND CLEAN EXISTING CONDUIT	FOOT	125			97	28	
X1400102	OUTDOOR RATED NETWORK CABLE	FOOT	235					235
X1400215	REMOTE CONTROLLED VIDEO SYSTEM	EACH	1					1
X1400216	LAYER II (DATALINK) SWITCH	EACH	4		1	1	1	1
X1400221	UPGRADE EXISTING CONTROLLER TO NTCIP SPECIAL	EACH	1		1			
X1400303	FIBER OPTIC PATCH PANEL, 24 PORT, CABINET MOUNT	EACH	4		1	1	1	1
X8050095	SERVICE INSTALLATION (SPECIAL)	EACH	2			1	1	
X8570215	FULL-ACTUATED CONTROLLER IN EXISTING CABINET	EACH	1				1	
X8570226	FULL-ACTUATED CONTROLLER AND TYPE IV CABINET, SPECIAL	EACH	1			1		
X8620200	UNINTERRUPTABLE POWER SUPPLY, SPECIAL	EACH	2			1	1	
X8950212	MODIFY EXISTING CONTROLLER CABINET, SPECIAL	EACH	3		1		1	1
XX007622	ELECTRIC METER	EACH	2		1			1
XX009046	VEHICLE DETECTION SYSTEM, SPECIAL	EACH	1					1

	USER NAME = zhoerbert	DESIGNED - DRAWN - CHECKED -	REVISED - REVISED - REVISED -	STATE OF ILLINOIS DEPARTMENT OF TRANSPORTATION		SCHEDULE OF QUANTITIES			SECTION 19-DCCSS-04-TL	COUNTY TOTAL SHEETS SHEET NO. DUPAGE 293 9
	PLOT DATE = 6/13/2022	DATE -	REVISED -		SCALE:	SHEET 1 OF 1 SHEETS STA.	TO STA.	_	ILLINOIS FED.	CONTRACT NO. 61H96 AID PROJECT
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PLOT DATE = 6/12/2022


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ROSELLE RD AND WALNU OF 7 SHEET 2 SHEE

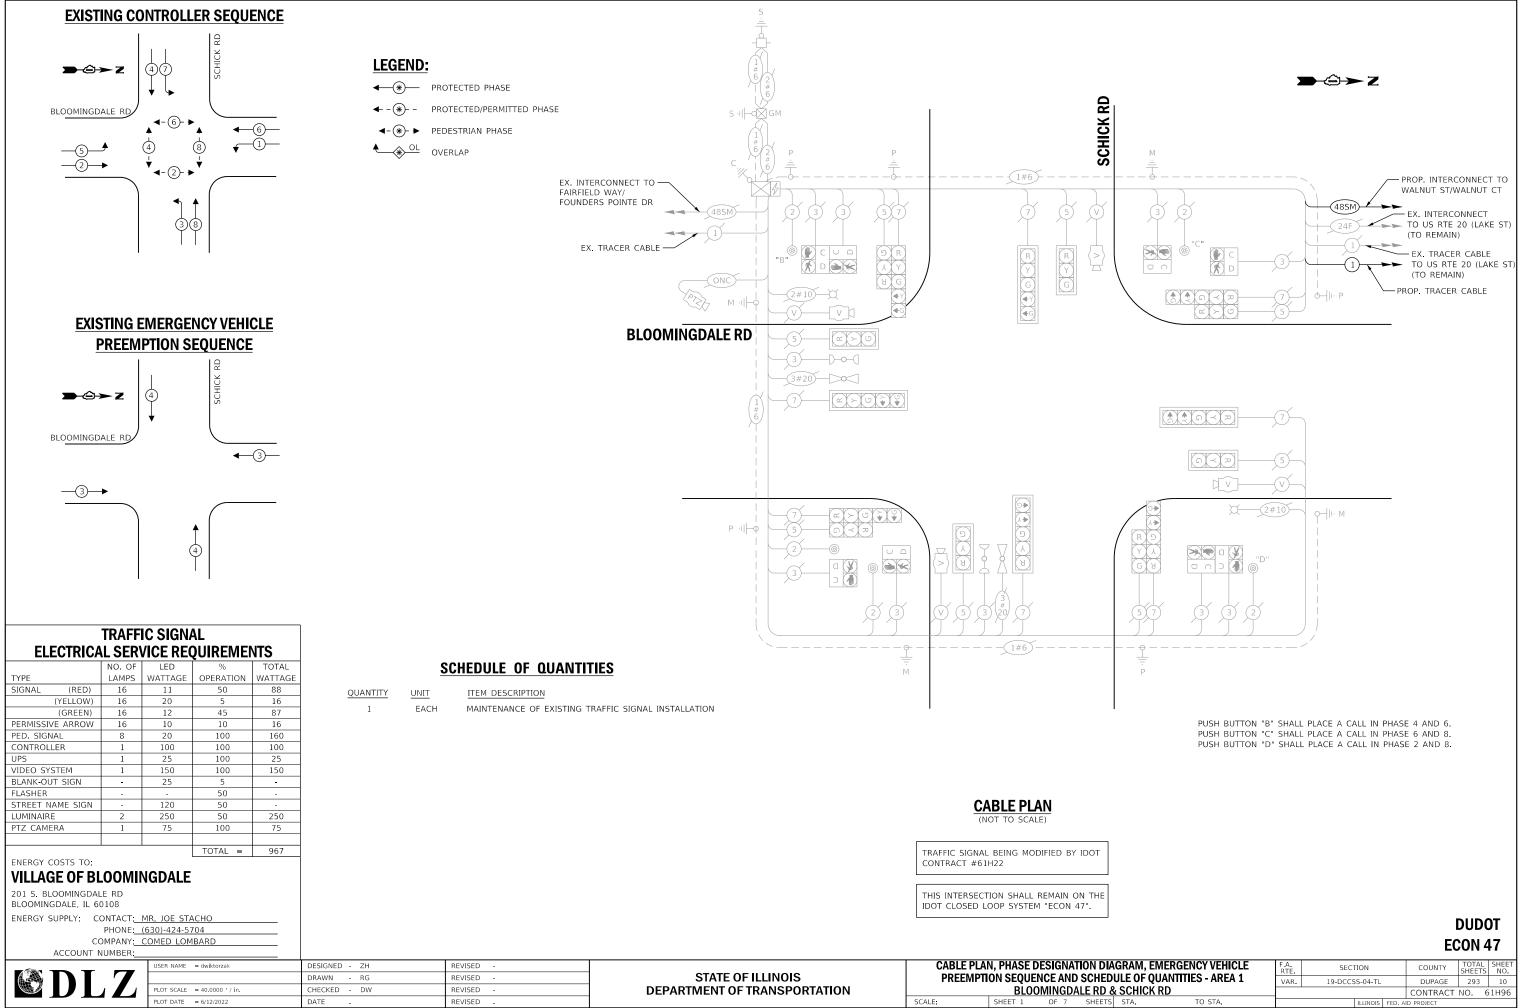
SCALE:

IAGRAM, EMERGENCY VEHICLE		F.A. RTE	SECTION		COUNTY TOTA		SHEET NO.		
DULE OF QUANTITIES - AREA 1			VAR.	19-DCCSS-04-TL		DUPAGE	293	11	
UŢ	<u>st/v</u>	VALNUT CT					CONTRACT	NO. 6	51H96
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			RTE.	JEC	101		COOMIT	SHEETS	5 NO.
DULE OF QUANTITIES - AREA 1			VAR.	19-DCCSS-04-TL			DUPAGE	293	12
(N MAWR AVE						CONTRACT	NO.	61H96
5	STA.	TO STA.			ILLINOIS	FED. A	ID PROJECT		

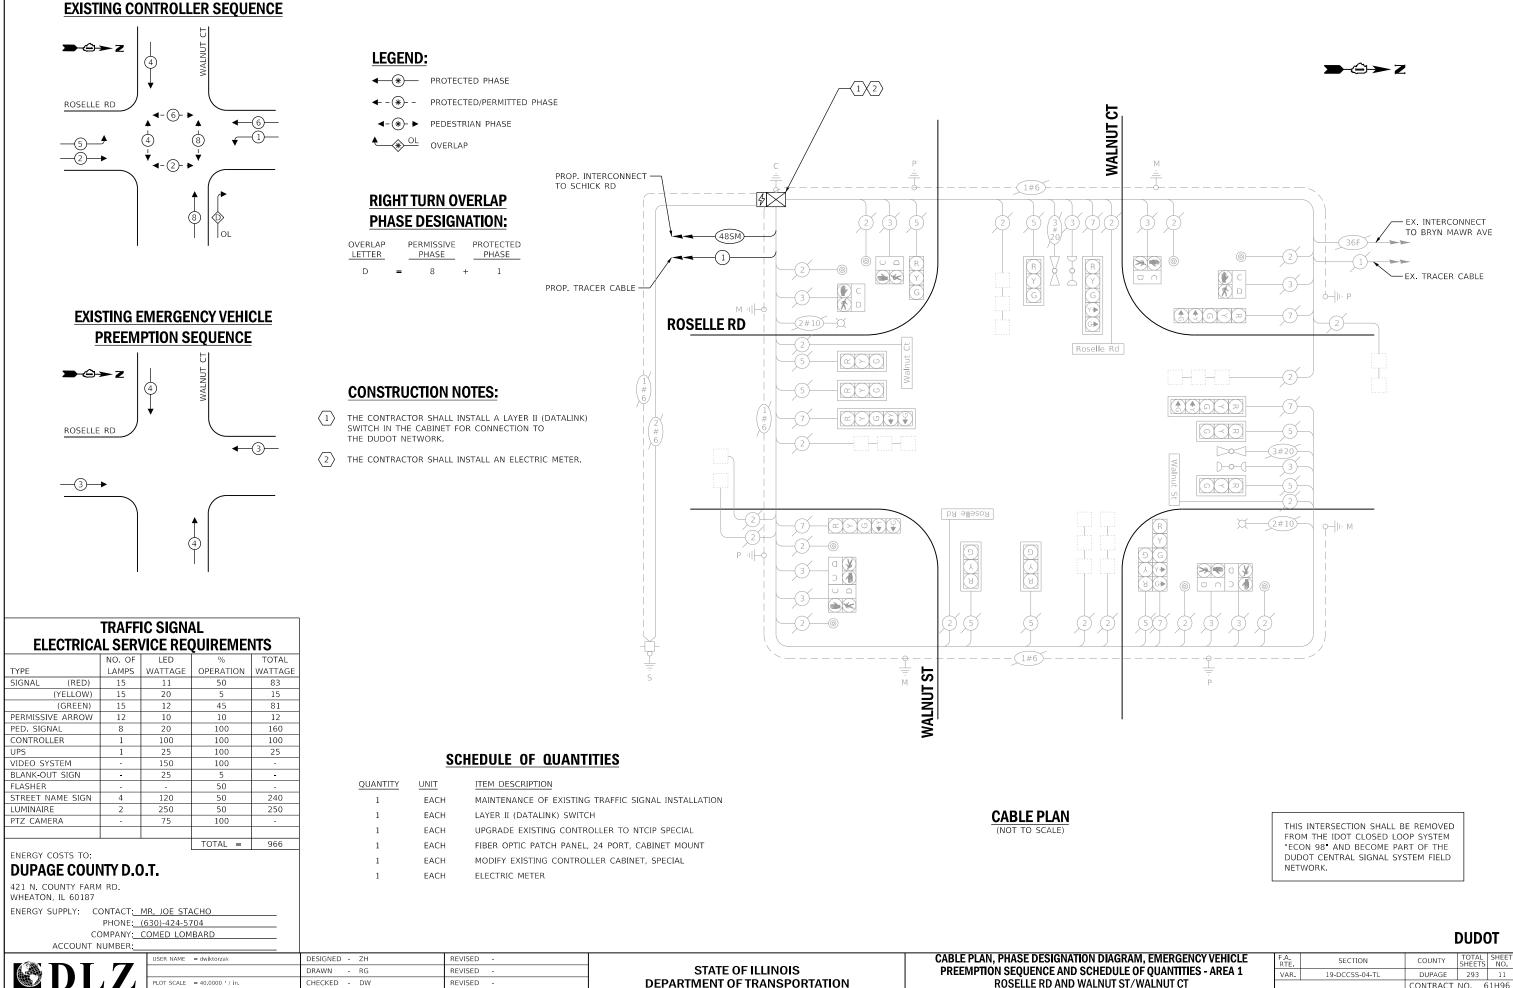

REVISED

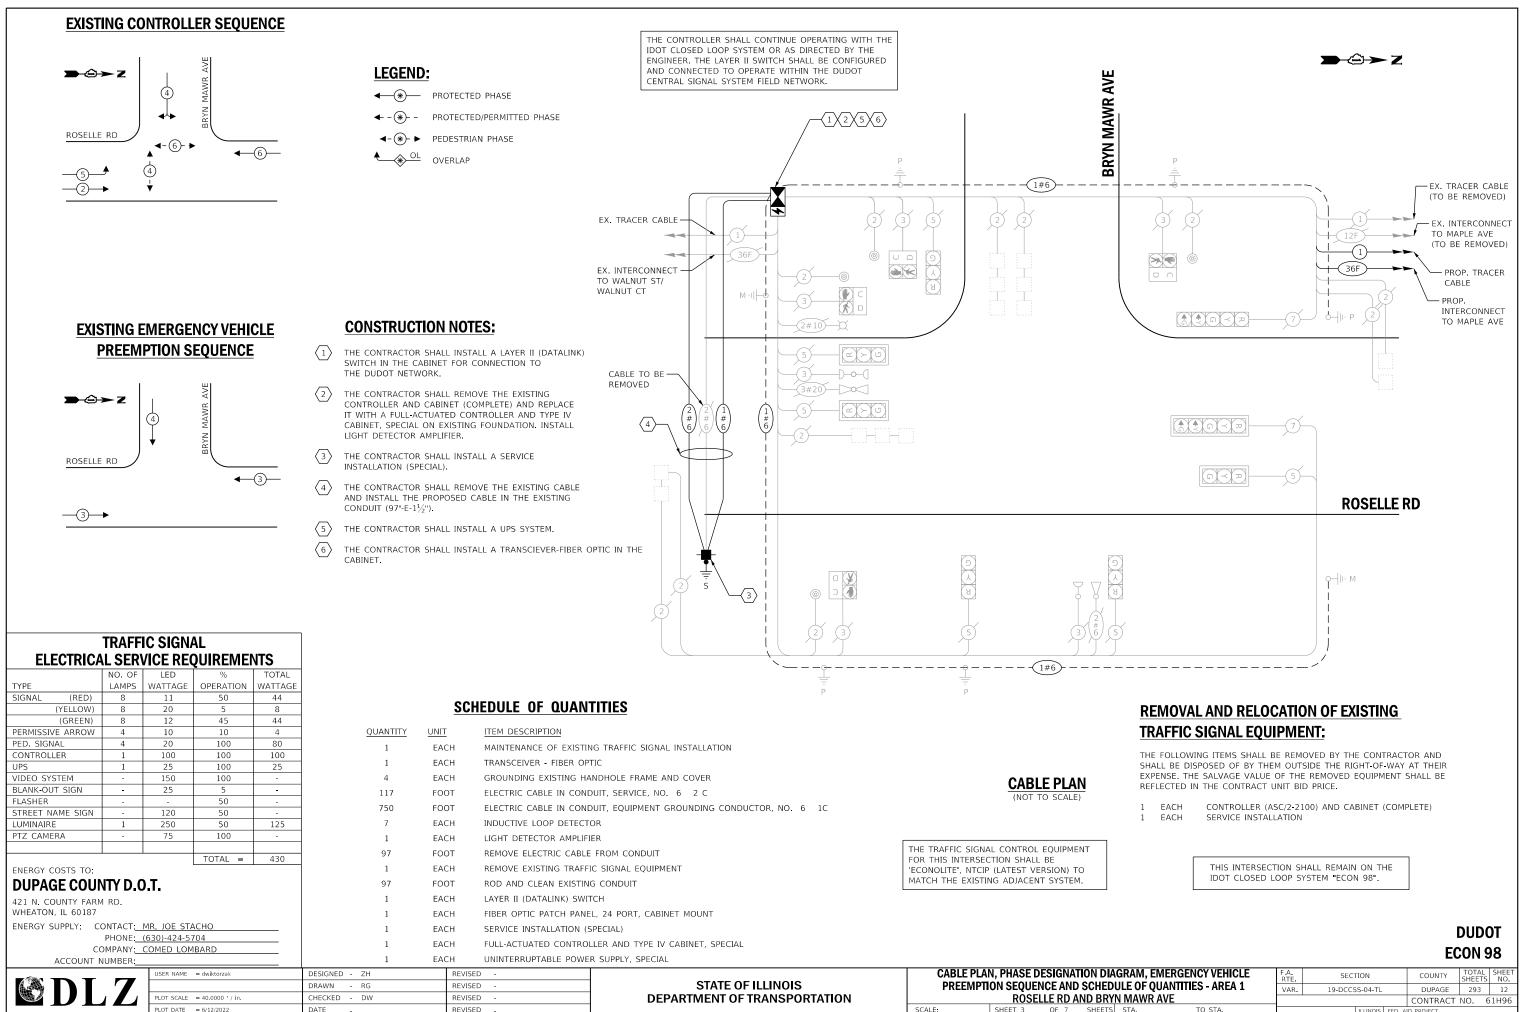
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PLOT DATE = 6/12/2022

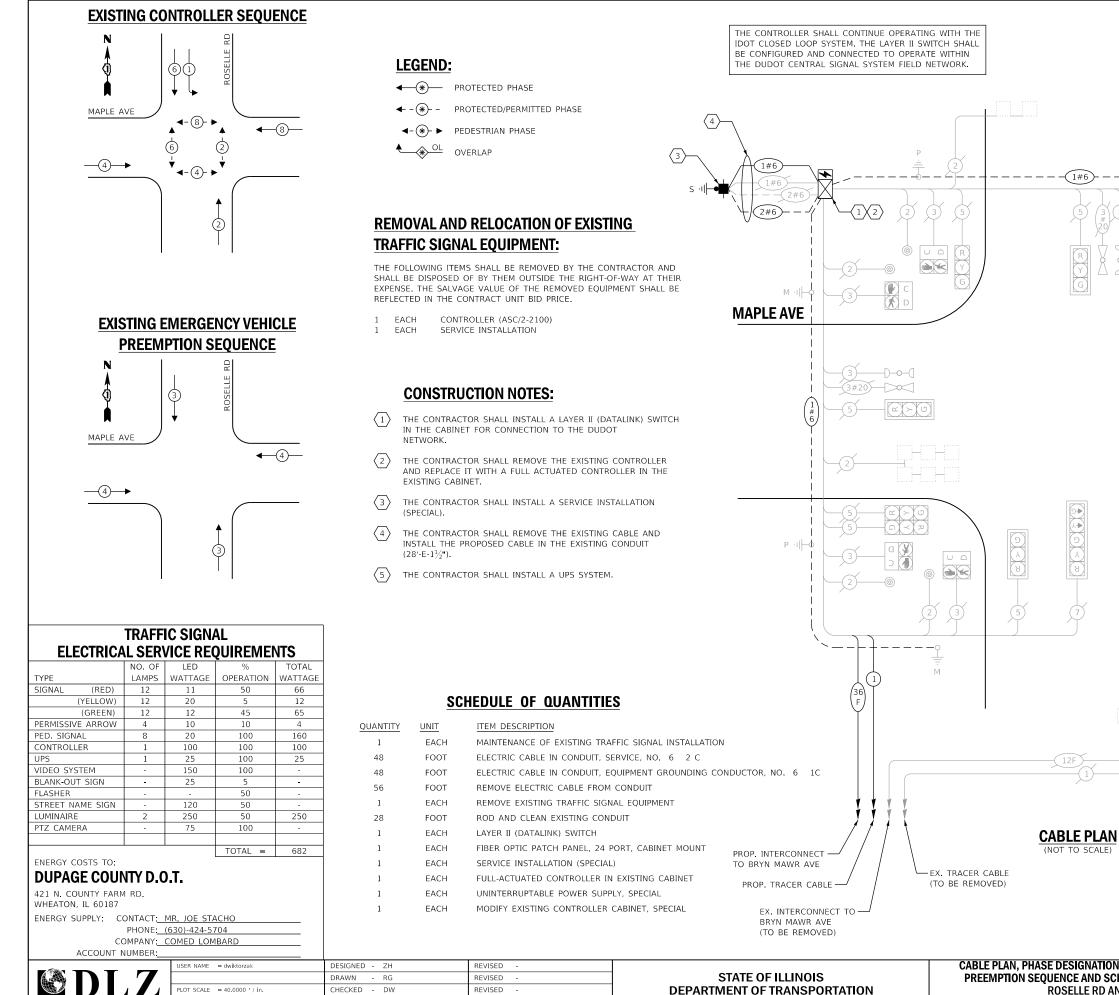
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ROSELLE RD AND MAPLE AVE SHEET 4 OF 7 SHEETS STA.

SCALE:



DEPARTMENT OF TRANSPORTATION

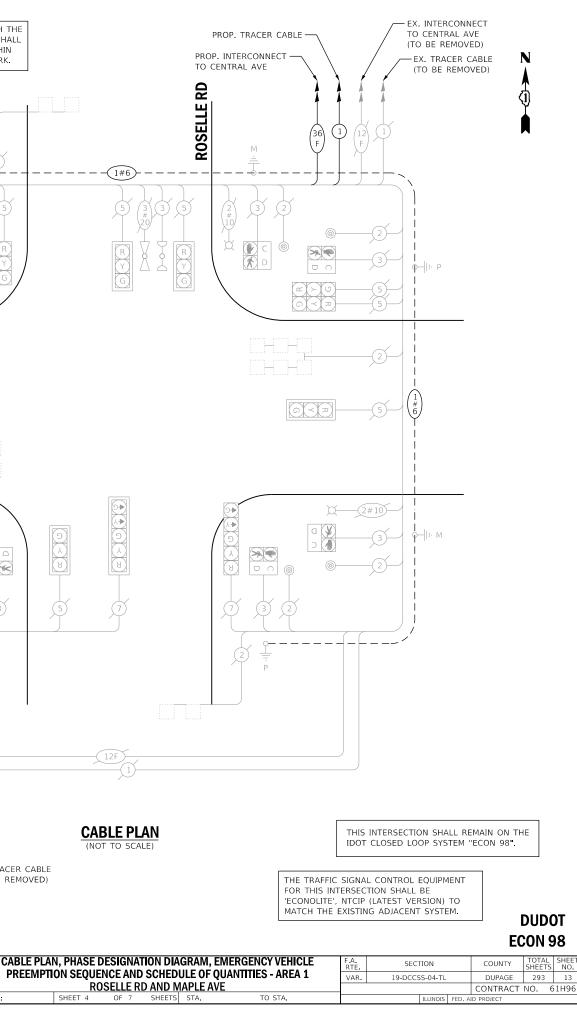

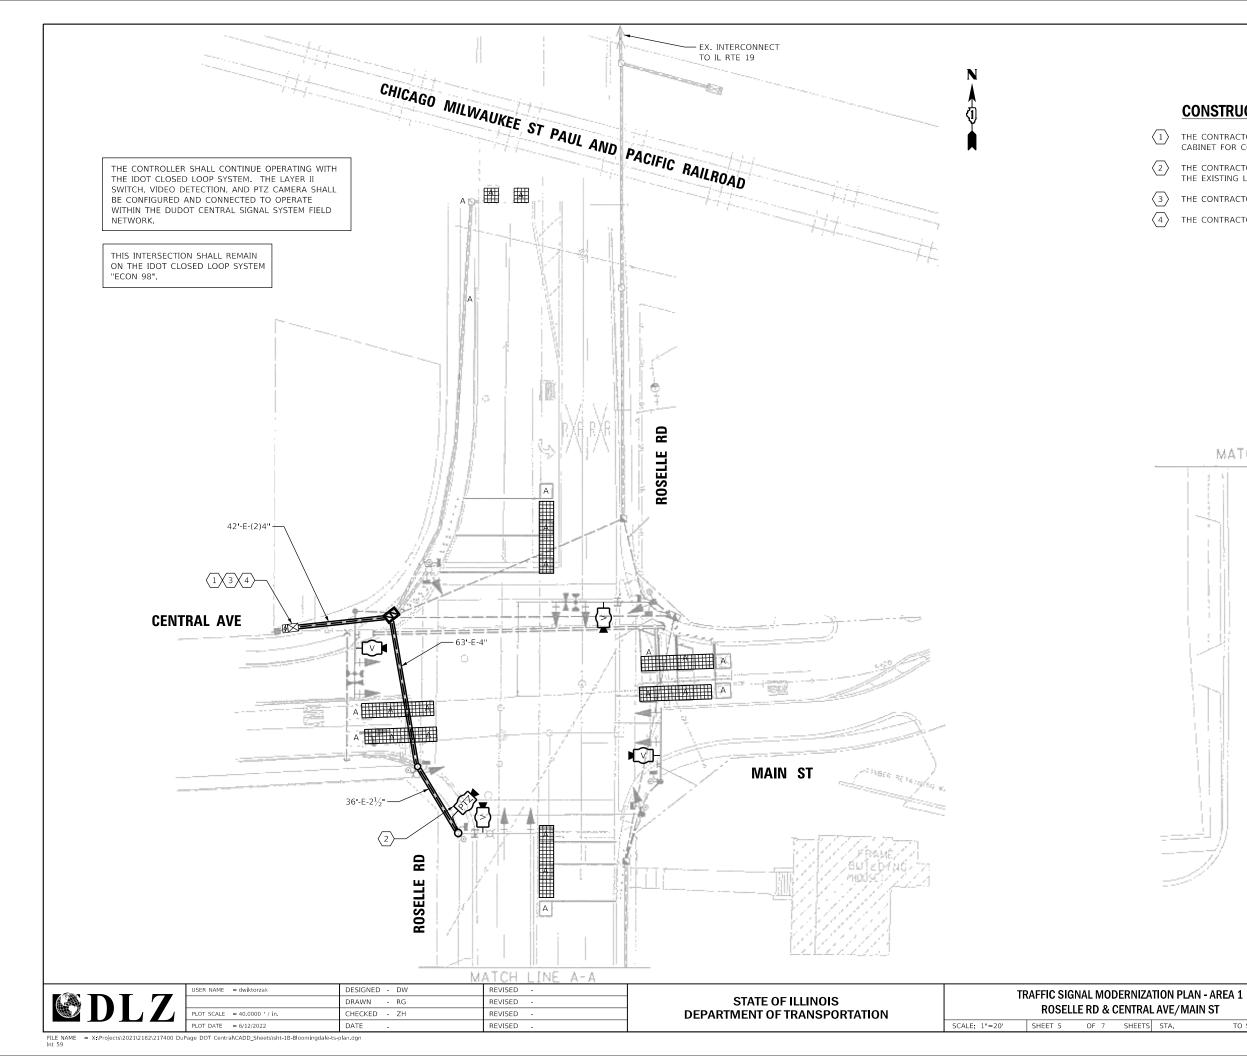
CONSTRUCTION NOTES:

THE CONTRACTOR SHALL INSTALL A LAYER II (DATALINK) SWITCH IN THE CABINET FOR CONNECTION TO THE DUDOT NETWORK.

THE CONTRACTOR SHALL INSTALL A REMOTE CONTROLLED VIDEO SYSTEM ON THE EXISTING LUMINAIRE ARM.

THE CONTRACTOR SHALL INSTALL AN ELECTRIC METER.

THE CONTRACTOR SHALL INSTALL A VEHICLE DETECTION SYSTEM, SPECIAL.

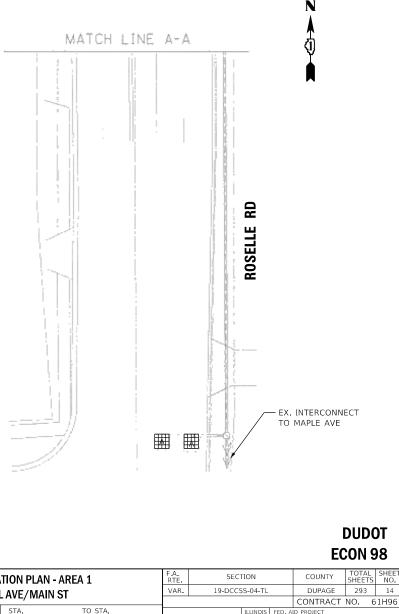

THE CONTROLLER SHALL CONTINUE OPERATING WITH THE IDOT CLOSED LOOP SYSTEM. THE LAYER II SWITCH, VIDEO DETECTION, AND PTZ CAMERA SHALL BE CONFIGURED AND CONNECTED TO OPERATE WITHIN THE DUDOT CENTRAL SIGNAL SYSTEM FIELD NETWORK.

> THIS INTERSECTION SHALL REMAIN ON THE IDOT CLOSED LOOP SYSTEM "ECON 98".

NO CHANGES SHALL BE MADE TO THE CONTROLLER SEQUENCE WITHOUT ADVANCED APPROVAL FROM THE ILLINOIS COMMERCE COMMISSION (ICC). ANY CHANGE TO THE CRC VALUES RESULTING FROM THE PROPOSED WORK SHALL BE DOCUMENTED BY THE VENDOR AND REPORTED TO DUDOT AND THE ICC.

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CENTRAL AVE		A
P ·I −Φ		
RAFFIC SIGNAL INSTALLATION	м	

CHICAGO MILWAUKEE ST PAUL AND PACIFIC RAILROAD

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QUANTITY	UNIT	ITEM DESCRIPTION
1	EACH	MAINTENANCE OF EXISTING TRAFFIC SIGNAL INSTALLATIO
1972	FOOT	REMOVE ELECTRIC CABLE FROM CONDUIT
235	FOOT	OUTDOOR RATED NETWORK CABLE
1	EACH	REMOTE CONTROLLED VIDEO SYSTEM
1	EACH	LAYER II (DATALINK) SWITCH
1	EACH	FIBER OPTIC PATCH PANEL, 24 PORT, CABINET MOUNT
1	EACH	MODIFY EXISTING CONTROLLER CABINET, SPECIAL
1	EACH	ELECTRIC METER
1	EACH	VEHICLE DETECTION SYSTEM, SPECIAL

SCHEDULE OF QUANTITIES

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	4			

CABLE PLAN (NOT TO SCALE)

COMPANY: ACCOUNT NUMBER:	OMED LOMBARD									ECON 98
	USER NAME = dwiktorzak	DESIGNED - ZH	REVISED -			AN, PHASE DESIGNATION DIAGRAM, EMI		F.A. BTE	SECTION	COUNTY TOTAL SHEET SHEETS NO.
		DRAWN - RG	REVISED -	STATE OF ILLINOIS	PREEMP	TION SEQUENCE AND SCHEDULE OF QUA	-	VAR.	19-DCCSS-04-TL	DUPAGE 293 15
	PLOT SCALE = 40.0000 ' / in.	CHECKED - DW	REVISED -	DEPARTMENT OF TRANSPORTATION		ROSELLE RD AND CENTRAL AVE/MA	N ST			CONTRACT NO. 61H96
	PLOT DATE = 6/12/2022	DATE -	REVISED -		SCALE:	SHEET 6 OF 7 SHEETS STA.	TO STA.		ILLINOIS FED.	ND PROJECT
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ELECTRICAL SERVICE REQUIREMENTS LED TOTAL NO. OF % TYPE LAMPS WATTAGE OPERATION WATTAGE SIGNAL (RED) 12 11 50 (YELLOW) 12 20 12 5 (GREEN) 12 12 65 45

TRAFFIC SIGNAL

PERMISSIVE ARROW	8	10	10	8
PED. SIGNAL	8	20	100	160
CONTROLLER	1	100	100	100
UPS	1	25	100	25
VIDEO SYSTEM	1	150	100	150
BLANK-OUT SIGN	-	25	5	-
FLASHER	-	-	50	-
STREET NAME SIGN	-	120	50	-
LUMINAIRE	-	250	50	-
PTZ CAMERA	1	75	100	75
			TOTAL =	661


ENERGY COSTS TO:

DUPAGE COUNTY D.O.T.

421 N. COUNTY FARM RD. WHEATON, IL 60187

ENERGY SUPPL	: CONTACT: MR. JOE STA	CHO
	PHONE: (630)-424-57	'04

FILE NA Int 59

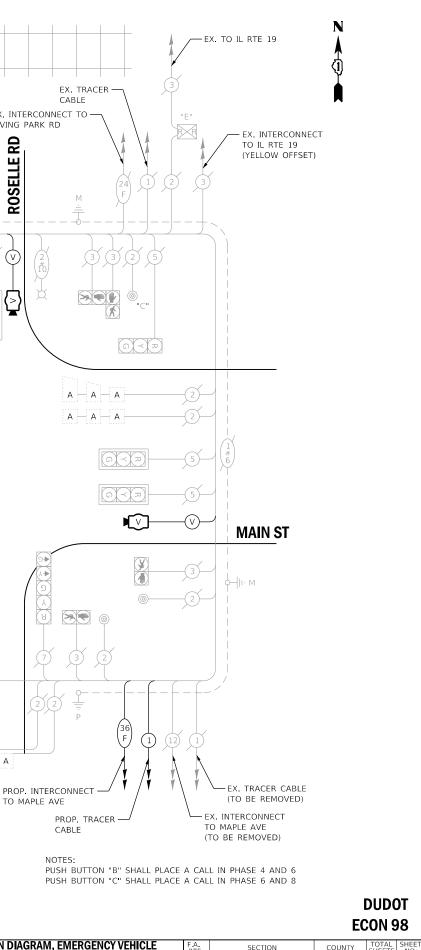

PROPOSED SEQUENCE OF OPERATION

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ROSELLE ROAD N/B NEAR RIGHT AND FAR RIGHT WAST ARM SECHALS	R	R	R	R	R	R	R	c	G	G	С	G	Ÿ	R	R	R	R	R	R
ROSELLE ROAD N/B FAR LEFT AND FHD WAST ADW SIGNALS	R 	Ĥ 🛶 Y	R 	R 	Ř	R	R	6 	6 -≠ c	б 	G	G	Ŷ	R	R	Ĥ	R	R	R
ROSELLF ROAD S/B MEAN HICHT AND FAR RICHT WAST ARM SIGNALS	Ĥ	Я	R	R	G	G	G	R	R	R	Ģ	6	γ	R	R	п	R	R	R
ROSELLE ROAD 5/8 FAR LEFT AND END WAST ANM SEGNALS	R ⊸≢C	R - III G	R - Y	R - Y	С — С	G 	÷ −∎∙ Y	R	R	R	C	Ġ	ř	R	R	R	R	तर	R.
CENTRAL AVENUE E/B ALL SIGNALS	R	R	R	R	R	R	R	R	R	ħ	R	R	R	R	G	c	Y	R	-Я
WAIN STREET W/B ALL SIGNALS	R	R	R	R	я	A	R	Ŕ	R	R	R	я	R	R	G	G	٣	R	R
PEDESTRIAN SIGNALS CROSSING CENTRAL AVE. ON WEST SIDE OF ROSELLE ROAD	н	н	н	н	 + P		н	н	н	н	*P	* * FH	н	н	н	м	н	H	¢.
PEDESTRIAN STOWALS CROSSING MAIN ST. ON EAST SIDE OF ROSELLE ROAD	н	н	н	н	H	н	Н	жP	* # 5H	н	жP	북 米 FH	н	н	н	н	н	H	A
PEDESTRIAN SIGNALS CROSSING ROSELLE ROAD DN SOUTH SIDE OF CENTRAL AVE./MAIN ST.	н	н	H	Н	н	н	н	н	н	н	н	н	Н	Η	*P	₩ ₩ FH	н	н	R
PEDESTRIAN SIGNALS CROSSING ROSELLE RDAD ON NORTH SIDE OF CENTRAL AVE./MAIN ST.	н	н	н	н	н	н	н	н	н	н	н	н	н	н	≉P	# # FH	н	Н	к

* TO APPEAR ONLY UPON PUSHBUTION ACTUATION

- ** FLASHING 💮 IS TO TERMINATE AT THE COMPLETION OF THE PÉDESSRÍAN INTÉRVAL CLEARANCE.
- ⊕ THIS "∰" OR FLASHING 10 INTERVAL MAY FINISH TIMEME IN THE BIDIRECTIONAL STRAIGHT THROUGH MOVEMENT IF THE LEFT ARROW TIME IS NOT SUFFICIENT TO COMPLETE 🕼 OR FLASHING 🗑 INTERVALS. 🗿 AND FLASHING 📆 TININGS TO BE SET ONLY ON PHASES WHERE 🚯 AND FLASHING 🏠 ARE INDICATED IN THE SEQUENCE DF OPFRATION.
- P = [LLUM(NATED PERSON = WALK
- FW ULUMINATED FLASHING HAND = FLASHING DON'T WALK
- H = [LLUMENATED SOLID HAND = DON'T WALK

PHASE 2+6 SHALL BE PLACED ON RECALL.

FOR INFORMATION ONLY

PROPOSED RAILROAD PREEMPTION SEQUENCE OF OPERATION

PROPOSED RAILROAD PREEMPTION SE		TOL .								IPTOR ER J	PREEN		PREEMPTOR NUMBER 2				
CHANGE FROM NORMAL SEQUENCE OF	Ŀ	5		B.		11		4			2		- 				
CHANGE FROM EMERGENCY VEHICLE PREEMPTION SEQUENCE OF OPERATION INTERVAL NUMBER										2		3					
RAILROAD PRÉÉMPTION SEQUENCE OF PERATION INTERVAL NUMBER	A	19	۱C	σι	LE	LF	ĩC	LH	IJ	IК	IL.	tM.	2	3	4	5	ÇLEAR TO
CHANGE TO RAILAGAD PREEMPTION SEQUENCE OF OPERATION INTERVAL MUMBER	2	1C	LD	2	١F	2	ы	z	ιĸ	ż	1M	2	3	4	5		NORMAL
ROSELLE ROAD N/8 NEAR RICHT AND FAR RIGHT WAST ARM STOKALS	R	R	Y	R	Ŷ	я	R	R	ĩ	R	Ħ	R	Ŕ	R	я	я	Δ
ROSELLE ROAD N/B FAR LEFT AND END WAST ARM SIGNALS	R 🔫 Y	Ħ	Υ	Ħ	Y	R	ħ	R	Y	R	я	R	ส	R	R	R	Δ
ROSELLE ROAD 578 FAR RIGHT AND FAR REGHT MAST ARM SIGNALS	R	G	Я	Ĥ	G	G	я	R	6	Ģ	R	R	c	Ϋ́	R	R	
ROSELLE ROAD S/B FAR LEFT AND END MAST ARK SIGNALS	я 4 с	с - Ф. Ģ	R	8	G	G	R	я	ç	с	R	R	с С	Å	R	R	
CENTRAL AVENUE E/B ALL SIGNALS	я	R	R	R	R	я	Ŷ	R	R	R	Ŷ	R	R	R	R	C	Δ
WAIN SIRGET W/B	R	R	R	R	Ŗ	R	γ	R	R	R	۲	R	R	R	R	¢	
PEDESTABLAN SIGNALS CADSSING CENTRAL AVE. My west side of roselle road	н	FH	н	н	FH	н	н	н	н	н	н	н	н	н	н	н	
REDESTREAN SEGNALS CROSSING WAIN ST. IN EAST SIDE OF ROSELLE ROAD	H	н	FМ	н	Fн	н	н	н	н	н	н	н,	н	н	н	н	Δ
EDESTRIAN SIGNALS CROSSING ROSELLE ROAD IN SOUTH SIDE OF CENTRAL AVE./MAIN SI,	н	н	н	н	н	н	Fн	н	H	н	н	н	н	н	н	н	4
EDESEMIAN SIGNALS CROSSING ROSELLE ROAD N NORTH SIDE OF COVIRAL AVE/MAIN SI.	н	к	H.	к	н	н	FH	н	н	н	н	н	н	н	н	н	Δ

△ RAILROAD PREENPTION SECUENCE SMALL PROVIDE THE PROPER CLEARANCE INTERVAL TO RESUME THE NORMAL SEQUENCE OF OPERATION OF PROPER CLEARANCE INTERVAL TO DISPLAY AN EMERGENCY VEHICLE INTERVAL (IF APPLICABLE) AFTER RAILROAD PREEMPTION INTERVAL 5 IS TERMINATED.


DODDACED FREDERINGY VEHICLE DOCEMPTION CONTRACT OF ODEDATION

PROPOSED EMERGENCY VEHICLE PRE	EMP	TION	SEQ	UENC	E OF	OPE	RATI	ON												PREEMPTOR NUMBER 3	PREEMPIOR NUMBER 4	
CHANGE FROM NORMAL SEQUENCE OF OPERATION INTERVAL NUMBER	L	:	5		5		E	3		8		11		11			14		14			CLEAR TO
EMERCENCY VEHICLE PREEMPTION SEQUENCE OF OPERATION INTERVAL NUMBER	ţΔ	IB	1¢	LD	lΕ	IF	ιc	ы	11	ĮK.	IL	м	IN	IP	10	18	15	LT	10	ż	3	NORMAL SEQUENCE
CHANGE TO EMERGENCY VEHICLE PREEMPTION SEQUENCE OF OPERATION INTERVAL MUNBER	ÖR)	ιc	2	sE.	1F	3	эн	2	18.	9L	3	2	ĮP	:0	3	15	jT	2	2			0
RCSELLE ROAD N/B NÉAR RIGHT AND FAR RIGHT WAST ARN SIGNALS	R	R	R	R	R	R	G	С	С	Ŷ	R	с.	C	Y	R	Ŗ	R	R	R	G	R	0
ROSELLE ROAD N/8 FAR LEFT AND END MASE ARM SIGNALS	R – ar Y	R	R	R	R	Ŕ	G 	G A	G 	Ŷ	8	G	G	Υ	R	R	R	R	R	G	R	0
AGSELLE ROAD 578 MEAR RIGHT AND FAR RIGHT WAST ARM STGNALS	R	G	G	G	¥	Ŕ	R	R	R	R	R	G	c	Y	R	Ŕ	R	R	R	G	я	Ó
ROSELLE ROAD 5/8 FAR LEF1 AND EMD MAST ARM STONALS	R ⊸∎ĭ	С - ч С	Ç ⊸∎ Y	с - 4 6	Y	Ŕ	R	Ŕ	R	R	R	G	G	У	R	Ŗ.	R	R	R	G	R	0
CENTRAL AVENUE E/B ALL SIGNALS	R	R	R	Ŕ	R	R	R	R	R	R	R	R	R	ĥ	R	G	۲	R	G	8	Ģ	0
MAIN STREET #/B ALL SIGNALS	R	R	R	R	R	R	R	R	ħ	Ŕ	R	R	R	R	R	G	٢	R	Ġ	H	G	0
PEDESIRIAN SIGNALS CROSSING GENTRAL AVE. ON WEST SIDE OF ROSELLE ROAD	н	Fн	ы	Fн	н	Н	н	н	н	н	н	FH	FH	П	н	н	н	н	н	н	н	0
PEDESTRIAN SIGNALS CROSSING WAIN ST. ON EAST SIDE OF ROSELLE ROAD	н	н	н	н	н	н	FH	н	FH	н	н	₽н	Fн	HE	н	H	н	н	н	н	н	0
PEDESTRIAN SIGNALS CROSSING ROSELLE ROAD ON SOUTH SIDE OF CENTRAL AVE./MAIN ST.	Н	н	Н	н	Н	Н	н	Н	н	н	П	ы	Н	H	H	FH	H	н	£H	н	н	0
PEDESIRIAN SIGNALS CROSSING ROSELLE ROAD ON NORTH SIDE OF CENTRAL AVE./MAIN ST.	н	н	н	н	н	Н	н	н	н	н	н	н	н	H	н	FH	н	H	Fн	н	н	0


EMERGENCY VEHICLE SEQUENCE SHALL PROVIDE THE PROPER CLEARANCE INTERVAL TO RESUME THE NORMAL SEQUENCE OF OPERATION OR PROPER CLEARANCE INTERVAL TO DISPLAY & DIFFERENT EMERGENCY INTERVAL AFTER EMERGENCY VEHICLE INTERVAL 2 OR 3 IS TERMINATED.

USER NAME = dwiktorzak	DESIGNED - ZH	REVISED -			AN, PHASE DESIGNATION DIAGRAM, EMERGENCY VEHICLI		SECTION	COUNTY	TOTAL SHEET
	DRAWN - RG	REVISED -	STATE OF ILLINOIS	PREEMP	TION SEQUENCE AND SCHEDULE OF QUANTITIES - AREA 1	VAR.	19-DCCSS-04-TL	DUPAGE	293 16
PLOT SCALE = 40.0000 ' / in.	CHECKED - DW	REVISED -	DEPARTMENT OF TRANSPORTATION		ROSELLE RD AND CENTRAL AVE/MAIN ST			CONTRACT	NO. 61H96
PLOT DATE = 6/12/2022	DATE -	REVISED -		SCALE:	SHEET 7 OF 7 SHEETS STA. TO STA.		ILLINOIS FED	AID PROJECT	

DUDOT **ECON 98**

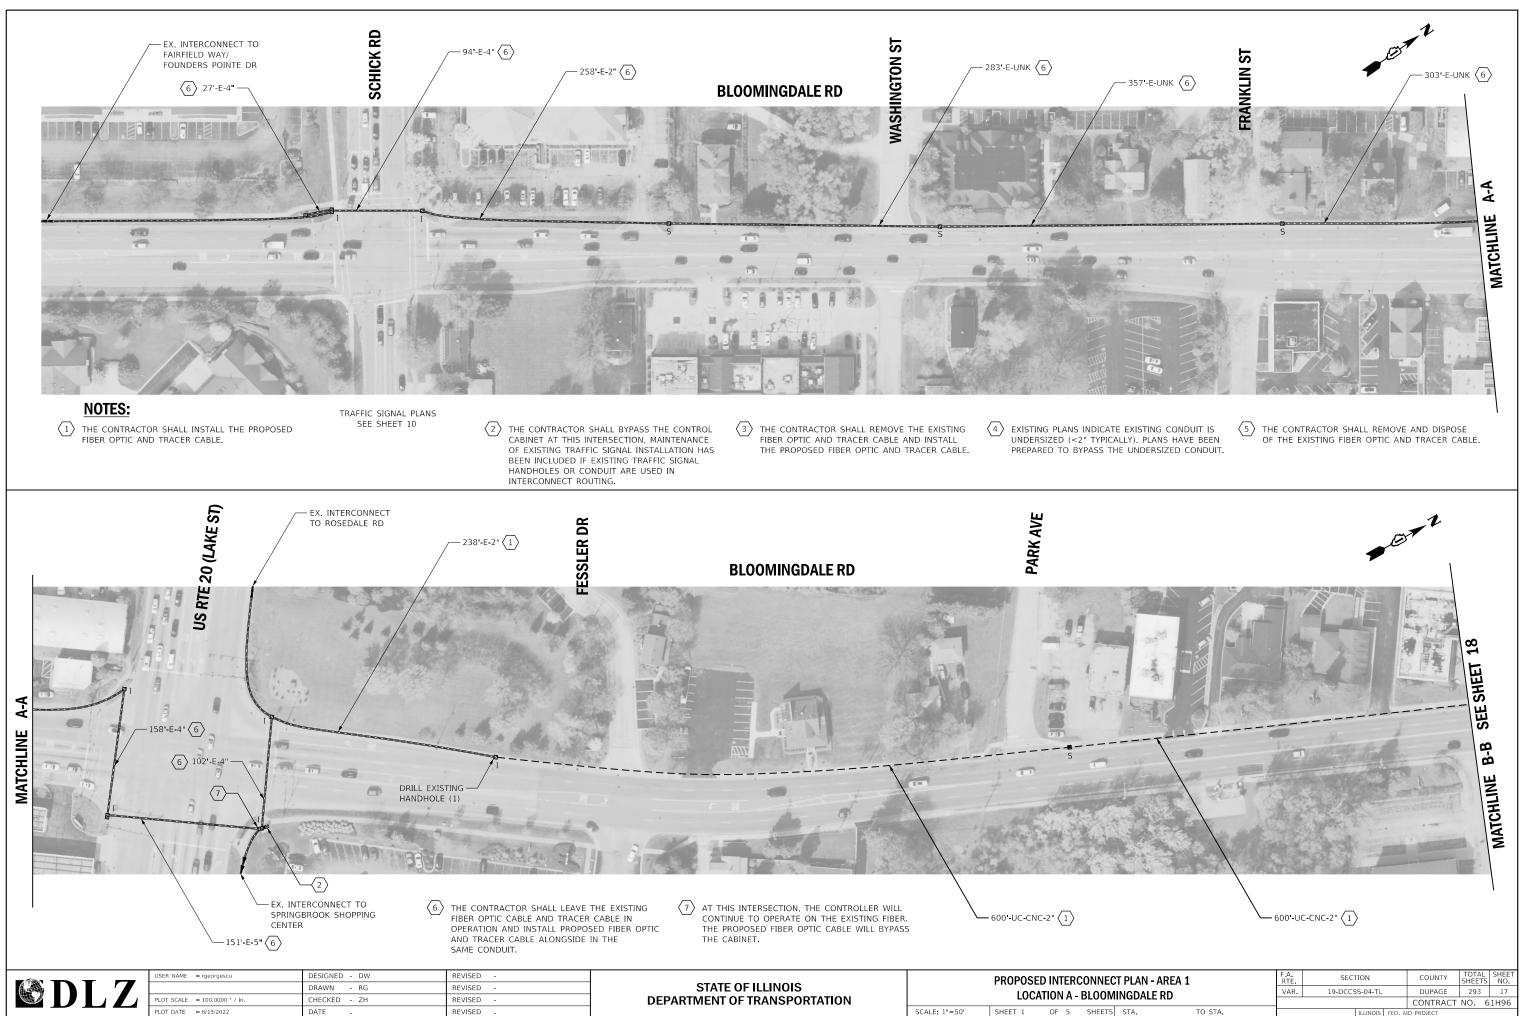


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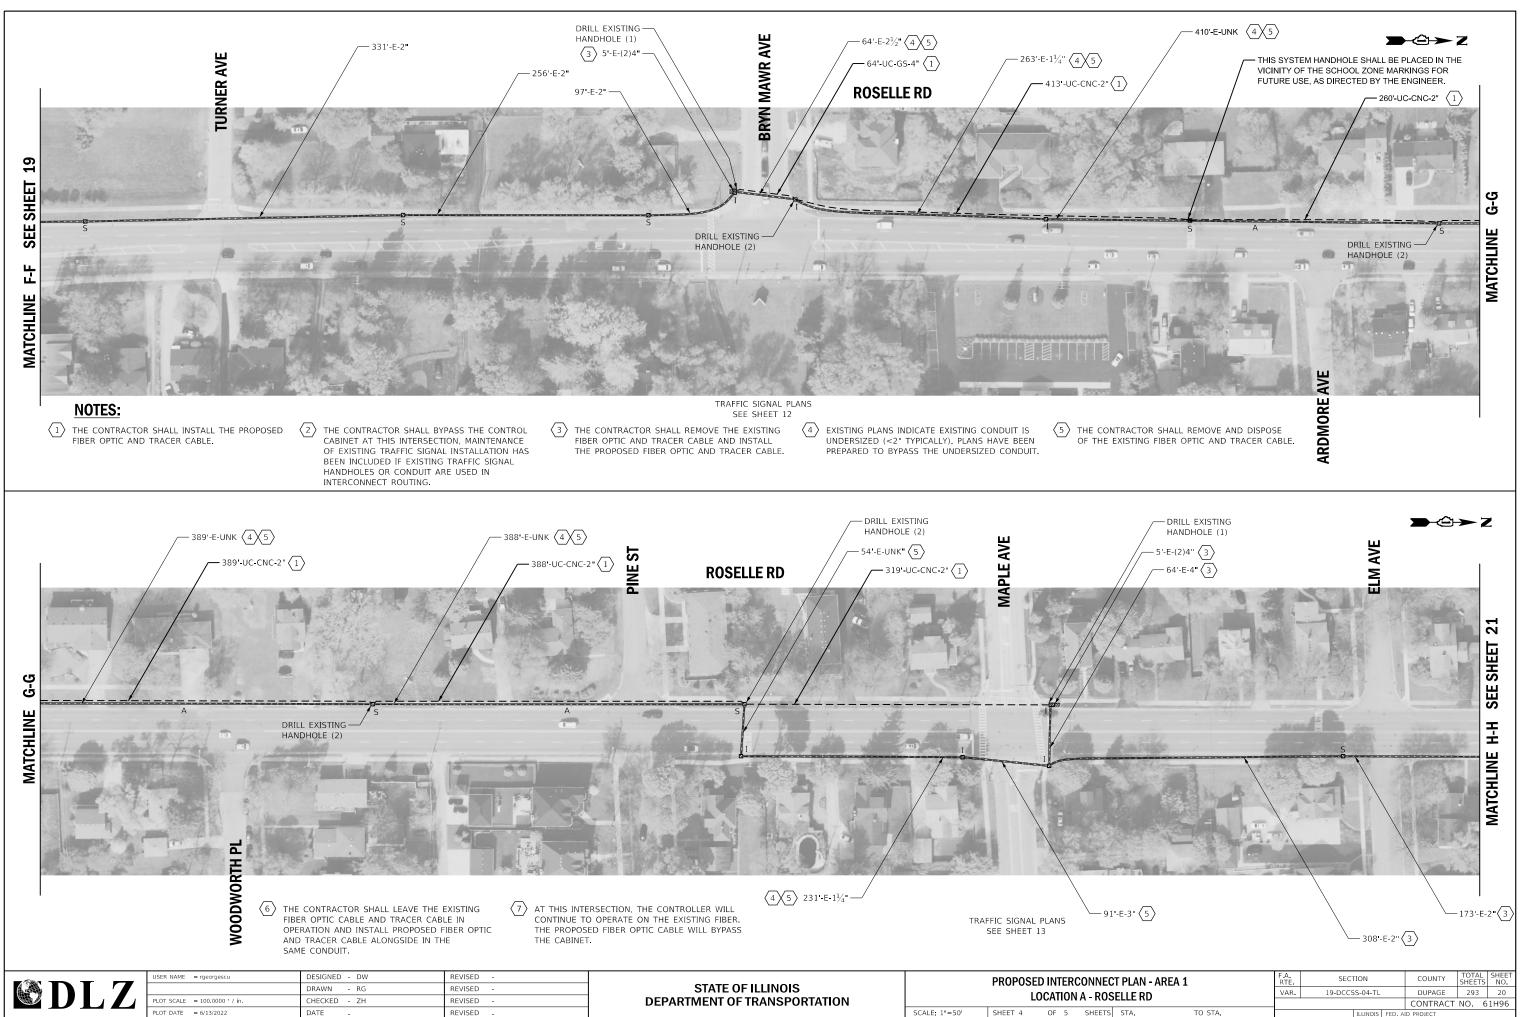

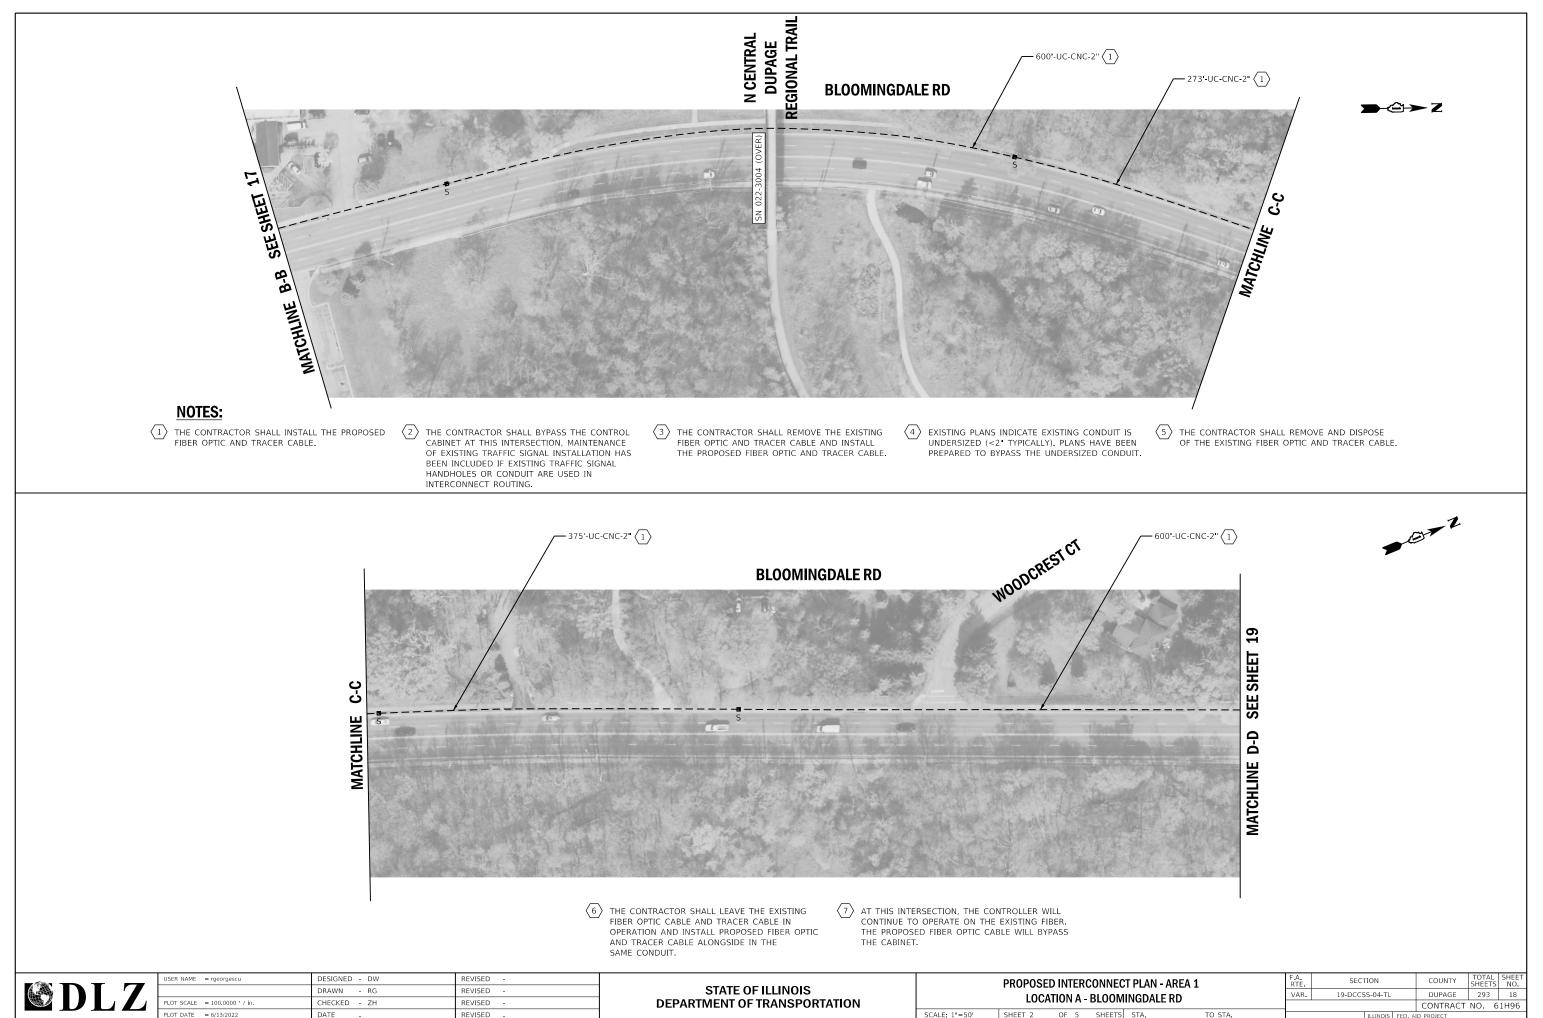
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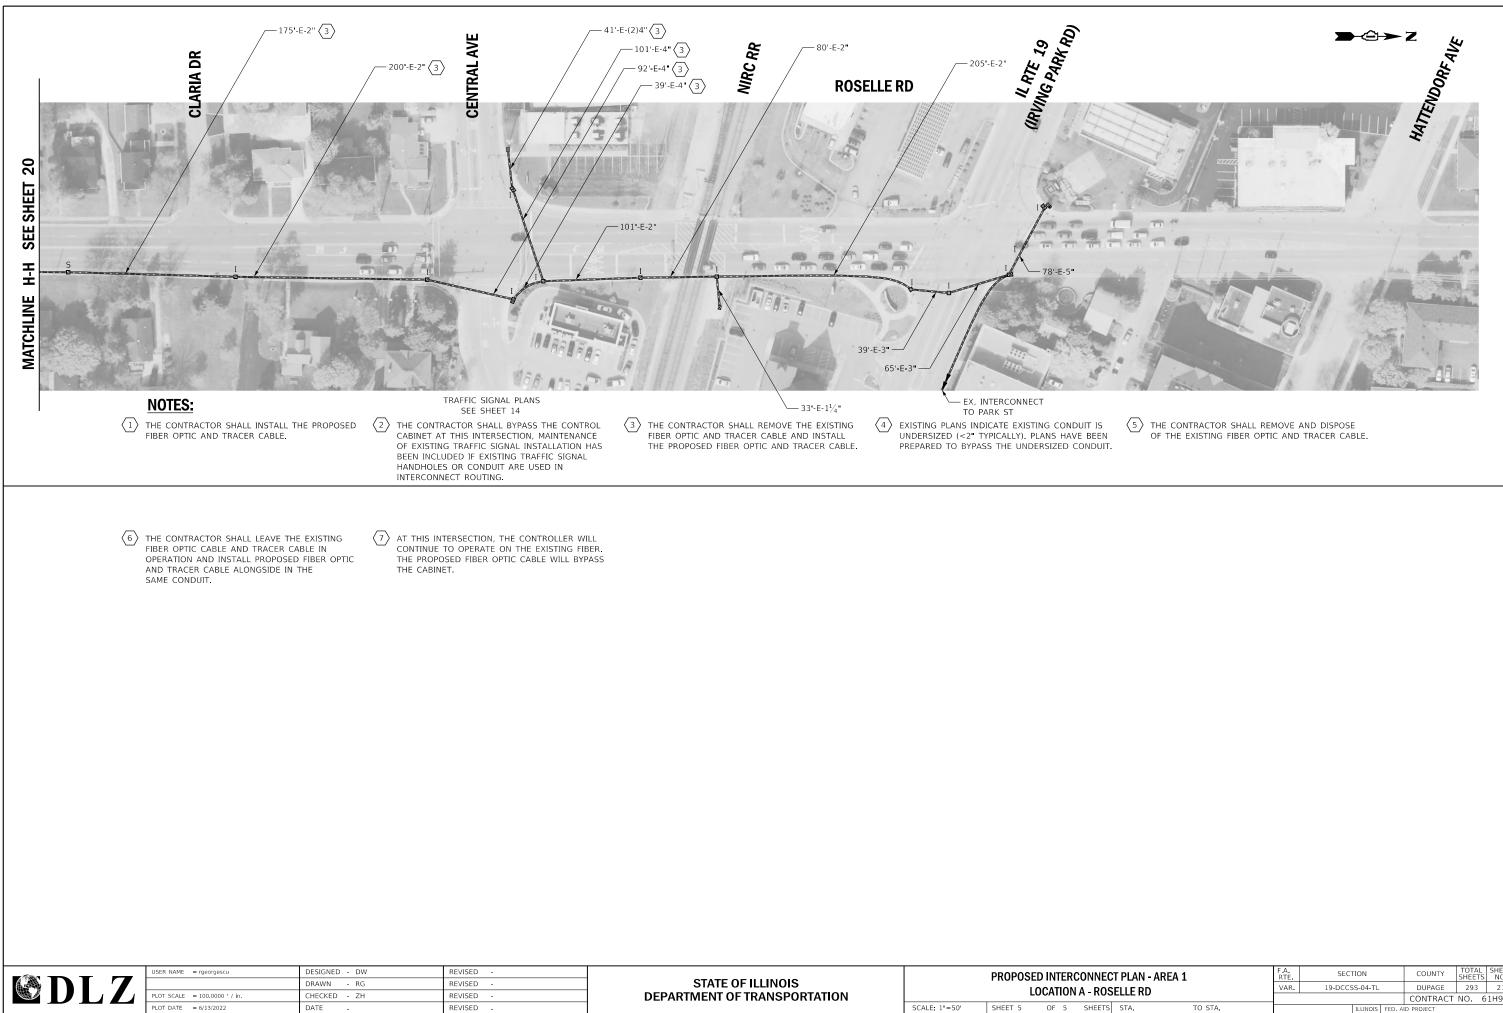
SHEET 2 OF 5 SHEETS STA.




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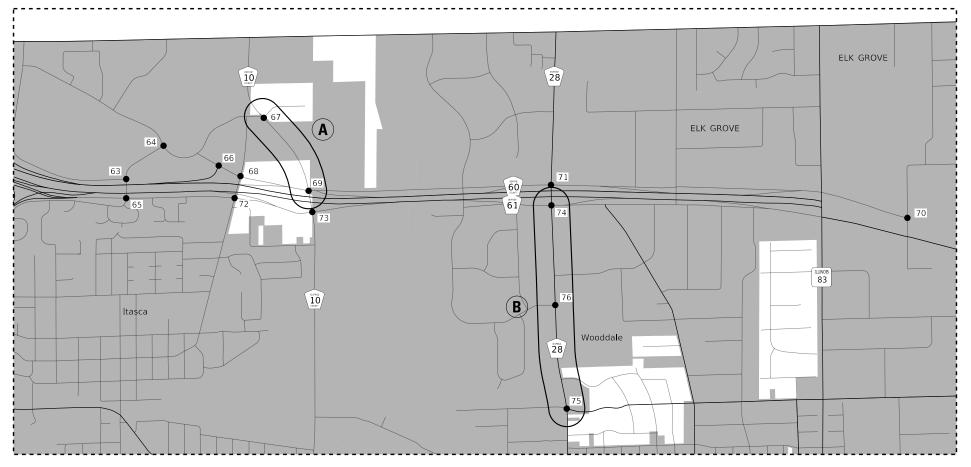
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			F.A.	05.03	ION	COUNTRY	TOTAL	SHEET
EC	T PLAN - ARE	A 1	RTE	SECT	TION	COUNTY	SHEETS	NO.
ns	ELLE RD		VAR.	19-DCCS	S-04-TL	DUPAGE	293	21
00						CONTRACT	NO. 6	1H96
TS	STA.	TO STA.			ILLINOIS FED. /	AID PROJECT		

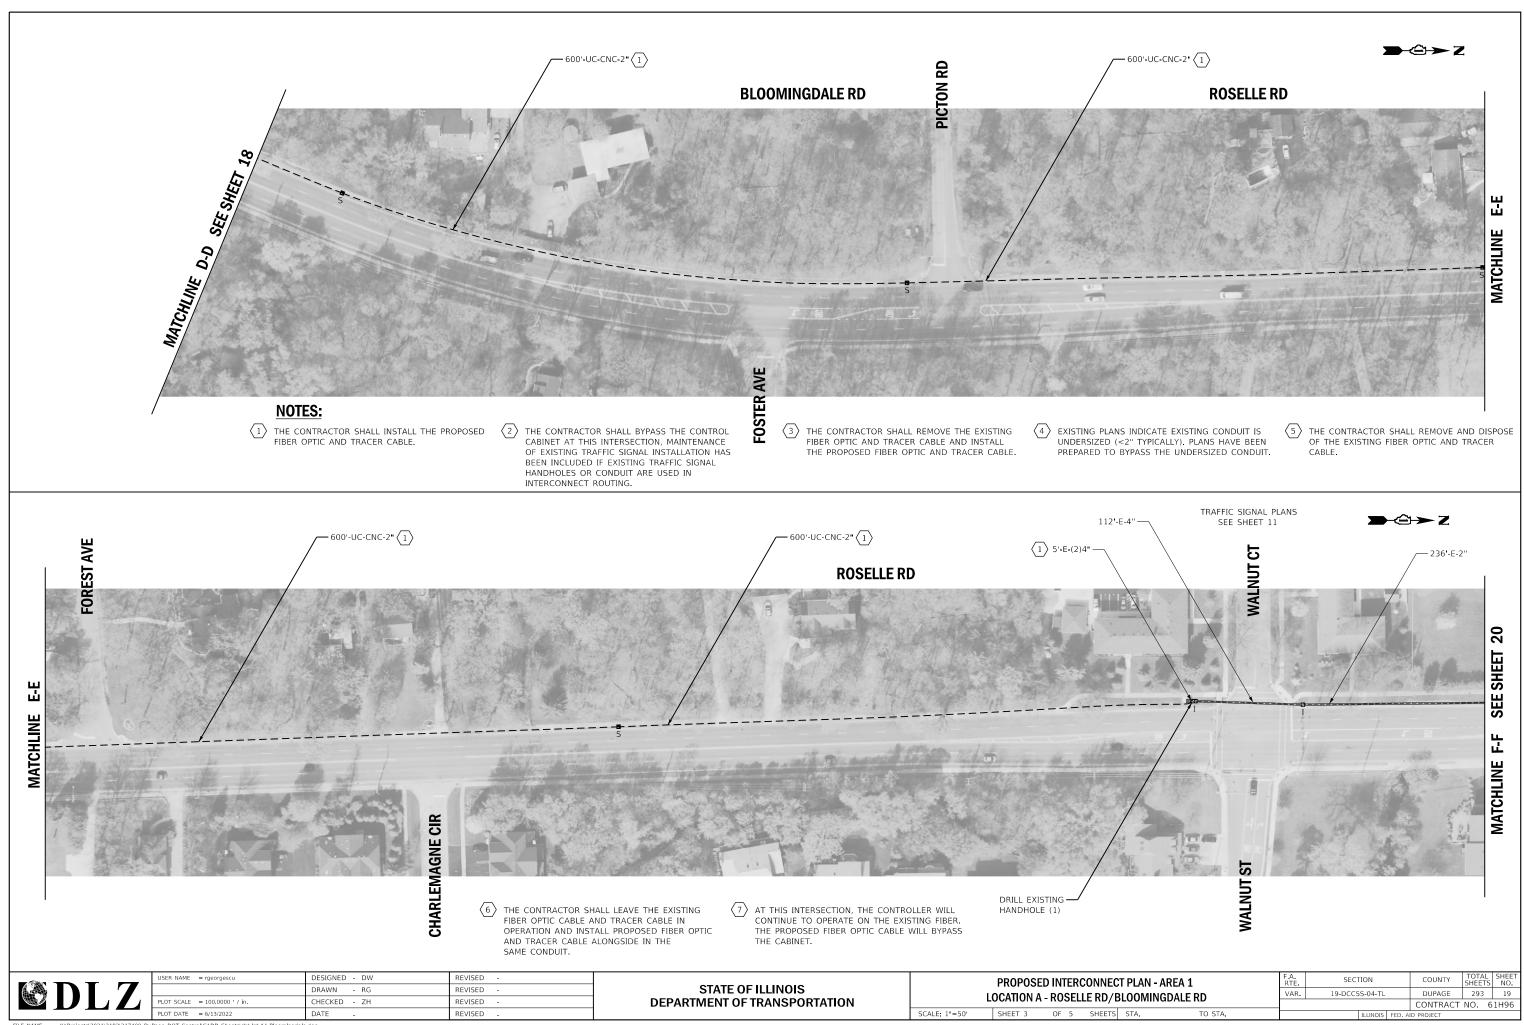

Γ		USER NAME = dwiktorzak	DESIGNED - DW	REVISED -		PROPOSED			EMATIC	
			DRAWN - RG	REVISED -	STATE OF ILLINOIS	FRUFUSEDI	MERCONN		AREA 1	AN
		PLOT SCALE = 1000.0000 ' / in.	CHECKED - ZH	REVISED -	DEPARTMENT OF TRANSPORTATION				AKEA I	
		PLOT DATE = 6/12/2022	DATE -	REVISED -		SCALE:	SHEET 1	OF 1	SHEETS	S
	LE NAME = X \Projects\2021\2182\217400 DuP	age DOT Central\CADD_Sheets\sht-int-schematic-Area	1.dgn							




LEGEND
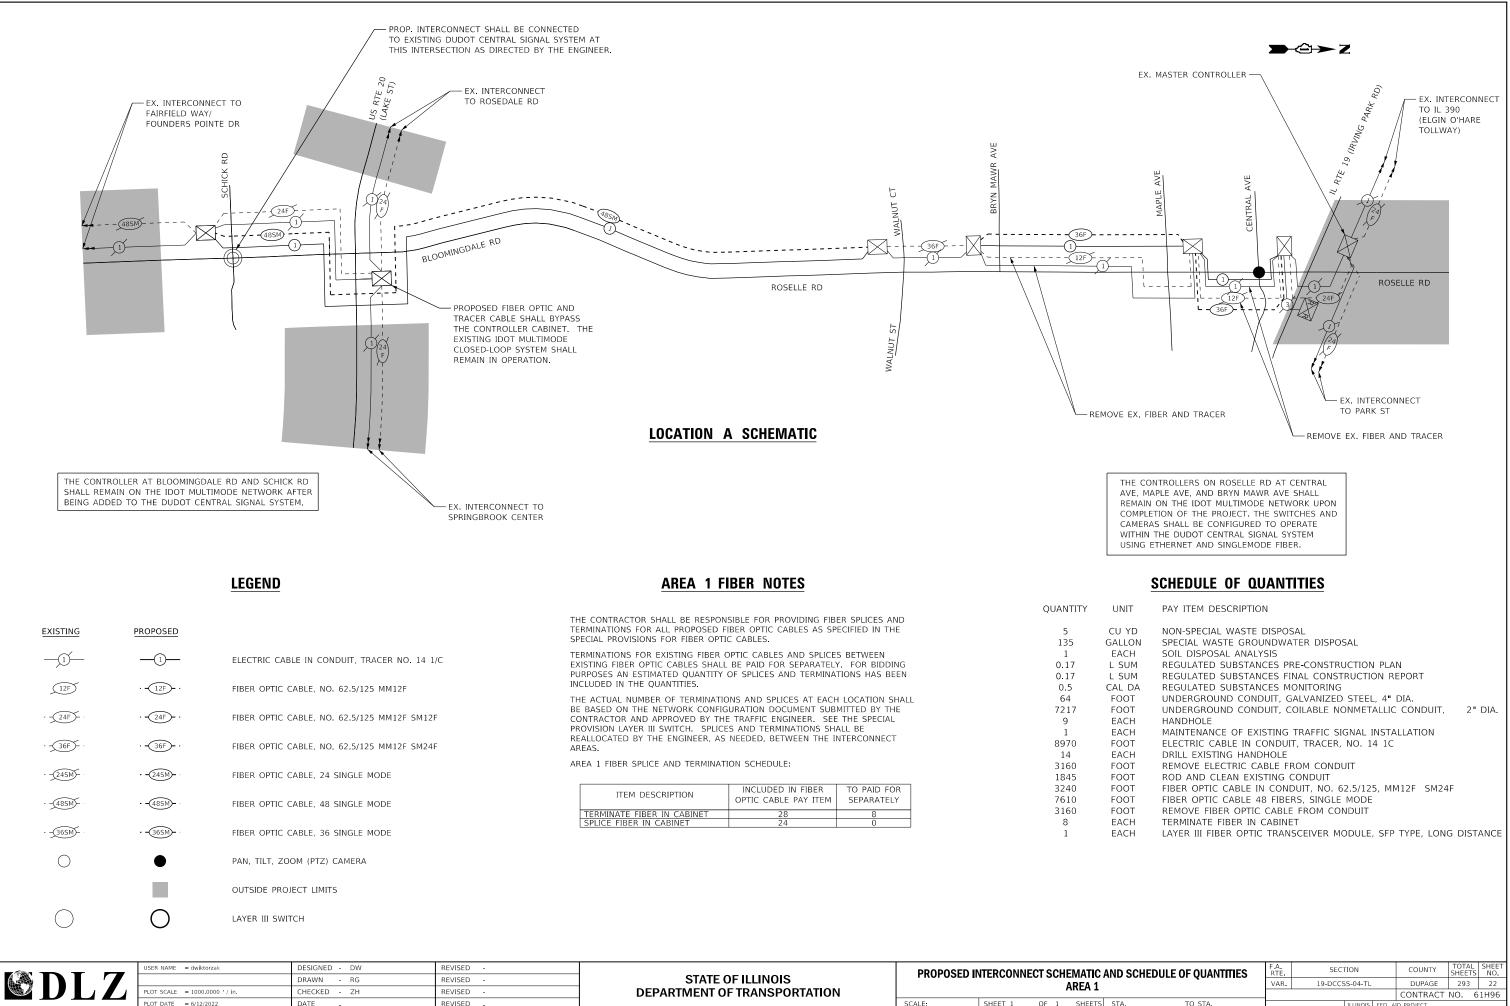
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PROPOSED INTERCONNECT AREA - SEE INTERCONNECT PLANS



PROPOSED SIGNAL IMPROVEMENT LOCATION

INTERCONNECT PLANS

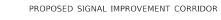	LOCATION	<u>SHEETS</u>
A	PROSPECT AVE	46
B	WOOD DALE RD	47 -48

<u>AREA 2</u>

INTERSECTION PLANS

<u>#</u>	LOCATION	SHEETS
65	CLOVER RIDGE LN/HAMILTON LAKES DR AND SOUTH THORNDALE AVE	25
63	HAMILTON LAKES DR AND PARK BLVD	26
64	HAMILTON LAKES DR AND PIERCE RD	27
72	ARLINGTON HEIGHTS RD AND S THORNDALE AVE	28
68	ARLINGTON HEIGHTS RD AND KETTER DR / N THORNDALE AVE	29 - 31
73	PROSPECT AVE AND S THORNDALE AVE	32 - 33
69	PROSPECT AVE AND N THORNDALE AVE	34 - 35
67	PROSPRCT AVE AND PIERCE RD / MARINO CT	36 - 37
75	WOOD DALE RD AND SCHOOL ST / FOSTER AVE	38 - 39
76	WOOD DALE RD AND MITTEL DR	40
74	WOOD DALE RD AND S THORNDALE AVE	41 - 42
71	WOOD DALE RD AND N THORNDALE AVE	43
66	KETTER DR AND RAMP L1	44
70	N THORNDALE AVE AND SUPREME DR	45


USER NAME = rgeorgescu	DESIGNED - DW	REVISED -			TRAFFIC SIGNAL MODERNIZATION PLAN - AREA 2 AREA 2 LOCATION MAP		SECTION	COUNTY TOTAL SHEET
	DRAWN - RG	REVISED -	STATE OF ILLINOIS				19-DCCSS-04-TL	DUPAGE 293 23
PLOT SCALE = 2000.0000 ' / in.	CHECKED - ZH	REVISED -	DEPARTMENT OF TRANSPORTATION	DEPARTMENT OF TRANSPORTATION AREA 2 LOCATION MAP				CONTRACT NO. 61H96
PLOT DATE = 6/13/2022	DATE -	REVISED -		SCALE:	SHEET 1 OF 1 SHEETS STA. TO STA.		ILLINOIS FED.	AID PROJECT

FILE NAME = X1Projects/2021/2182/217400 DuPage DOT Central(CADD_Sheets/sht-location map.dgn Area 2


AREA 2 SIGNAL IMPROVEMENTS

				HAMI	LTON L	4KES	ARLIN	IGTON	PRO	SPECT	AVE	woo	DDAL	ERD /	4ND		
				(I	DR AND		HTS R	d and		AND					l		
PAY ITEM NO.	PAY ITEM DESCRIPTION	UNIT	TOTAL	SOUTH THORNDALE AVE	PARK BLVD	PIERCE RD	SOUTH THORNDALE AVE	Ketter Dr/North Thorndale ave	SOUTH THORNDALE AVE	NORTH THORNDALE AVE	PIERCE RD/MARINO CT	FOSTER AVE/SCHOOL ST	MITTEL DR	SOUTH THORNDALE AVE	NORTH THORNDALE AVE	Ketter dr and ramp L1	N THORNDALE AVE AND SUPREME DR
85000200	MAINTENANCE OF EXISTING TRAFFIC SIGNAL INSTALLATION	EACH	14	1	1	1	1	1	1	1	1	1	1	1	1	1	1
87300010	GROUNDING EXISTING HANDHOLE FRAME AND COVER	EACH	10									5	5				<u> </u>
87301805	ELECTRIC CABLE IN CONDUIT, SERVICE, NO. 6 2 C	FOOT	160								61	34	65				
87301900	ELECTRIC CABLE IN CONDUIT, EQUIPMENT GROUNDING CONDUCTOR, NO. 6 1C		1561								61	750	750				
88500100	INDUCTIVE LOOP DETECTOR	EACH	13									8	5				
89501410	RELOCATE EXISTING EMERGENCY VEHICLE PRIORITY SYSTEM, PHASING UNIT	EACH	2									1	1				
89502300	REMOVE ELECTRIC CABLE FROM CONDUIT	FOOT	155								82	28	45				
89502375	REMOVE EXISTING TRAFFIC SIGNAL EQUIPMENT	EACH	з								1	1	1				
X0324599	ROD AND CLEAN EXISTING CONDUIT	FOOT	100								41	14	45				
X1400102	OUTDOOR RATED NETWORK CABLE	FOOT	1314					209	232	91	80	314		297	91		
X1400158	FIBER OPTIC SPLICE ENCLOSURE	EACH	1					1									
X1400215	REMOTE CONTROLLED VIDEO SYSTEM	EACH	5					1	1		1	1		1			
X1400216	LAYER II (DATALINK) SWITCH	EACH	13	1	1	1	1		1	1	1	1	1	1	1	1	1
X1400221	UPGRADE EXISTING CONTROLLER TO NTCIP SPECIAL	EACH	10	1	1	1	1	1	1	1				1	1	1	
X1400303	FIBER OPTIC PATCH PANEL, 24 PORT, CABINET MOUNT	EACH	13	1	1	1	1		1	1	1	1	1	1	1	1	1
X1400335	WIRELESS TRANSMISSION SYSTEM POINT TO POINT	EACH	2							1					1		
X1400460	LAYER III (NETWORK) SWITCH	EACH	1					1				_					
X8050095	SERVICE INSTALLATION (SPECIAL)	EACH	З								1	1	1				
X8570215	FULL-ACTUATED CONTROLLER IN EXISTING CABINET	EACH	1								1						
X8570226	FULL-ACTUATED CONTROLLER AND TYPE IV CABINET, SPECIAL	EACH	2									1	1				
X8620200	UNINTERRUPTABLE POWER SUPPLY, SPECIAL	TERRUPTABLE POWER SUPPLY, SPECIAL EACH 3									1	1	1				
X8950212	MODIFY EXISTING CONTROLLER CABINET, SPECIAL	EACH	12	1	1	1	1	1	1	1	1			1	1	1	1
	WIRELESS TRANSMISSION SYSTEM SUBSCRIBER UNIT	EACH	1					1									
	POE EXTENDER	EACH	2									1		1			

	USER NAME = zhoerbert	DESIGNED -	REVISED -							F.A. BTE	SECTION	COUNTY TOTAL SHEET
		DRAWN -	REVISED -	STATE OF ILLINOIS	SCHEDULE OF QUANTITIES			VAR.	19-DCCSS-04-TL	DUPAGE 293 24		
	PLOT SCALE = 100.0000 / in.	CHECKED -	REVISED -	DEPARTMENT OF TRANSPORTATION						CONTRACT NO. 61H96		
	PLOT DATE = 6/13/2022	DATE -	REVISED -		SCALE:	SHEET 1	OF 1 SHE	TS STA.	TO STA.		ILLINOIS FED.	AID PROJECT
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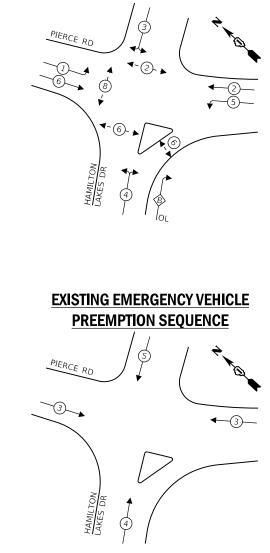
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	· ,	EMERGENCY VEHICLE	F.A. RTE	SECTIO	ЛС		COUNTY	TOTAL SHEETS	SHEET NO.
		UANTITIES - AREA 2	VAR.	19-DCCSS-	-04-TL		DUPAGE	293	26
<u> </u>	<u>ND PARK</u>	BLVD					CONTRACT	NO. 6	51H96
TS	STA.	TO STA.		IL	LINOIS	FED. AI	ID PROJECT		

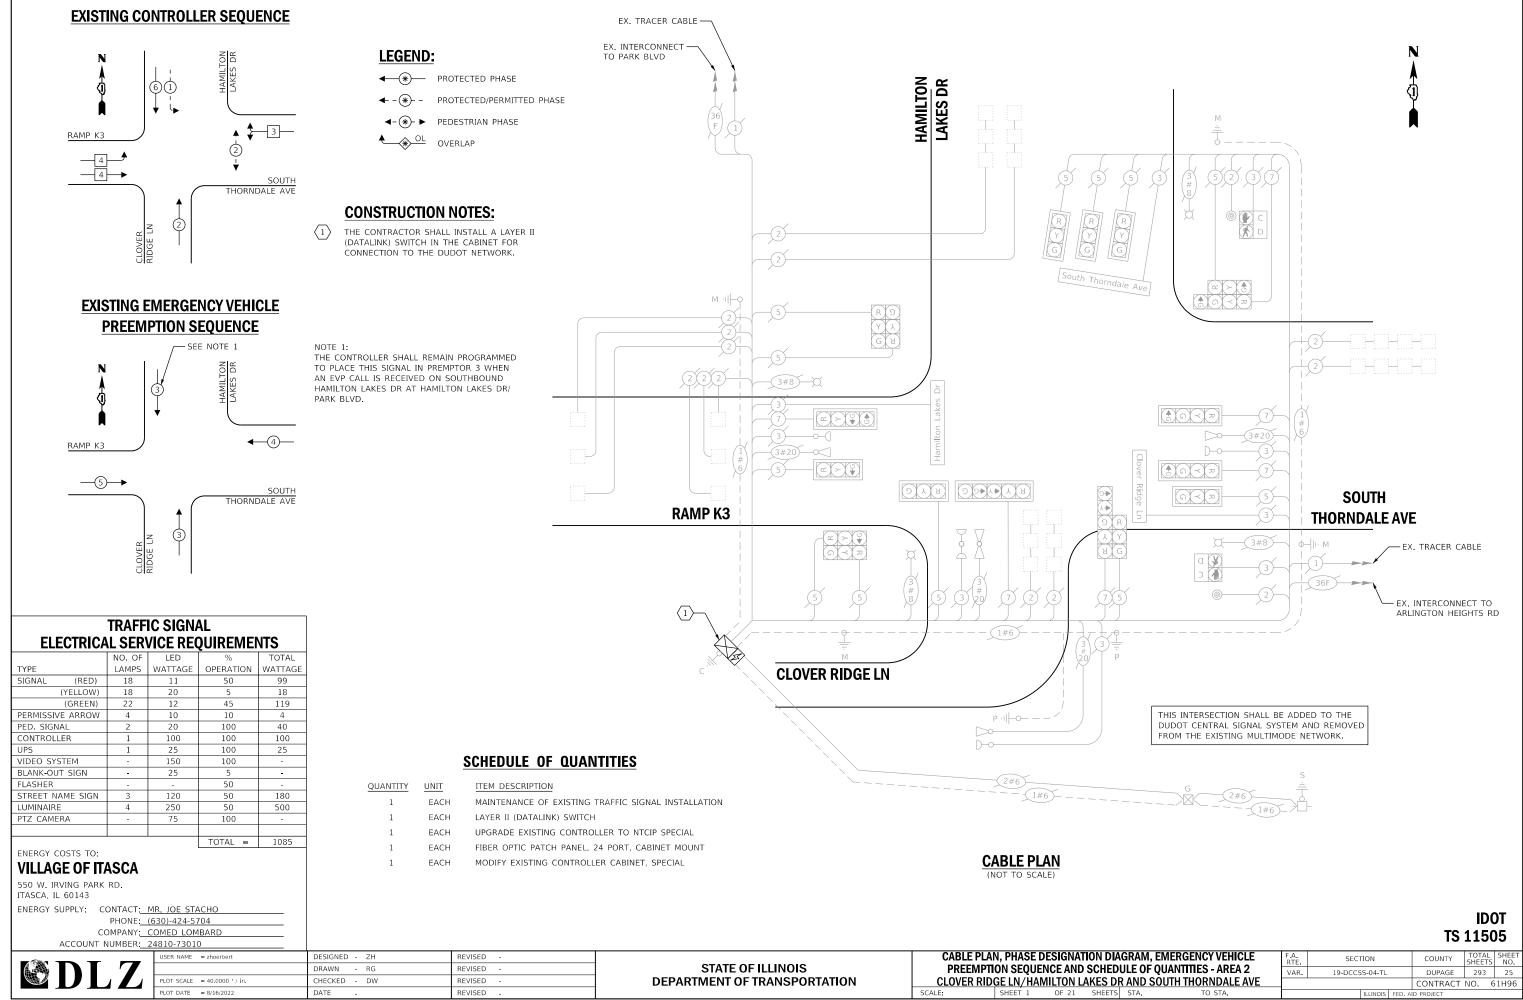EXISTING CONTROLLER SEQUENCE

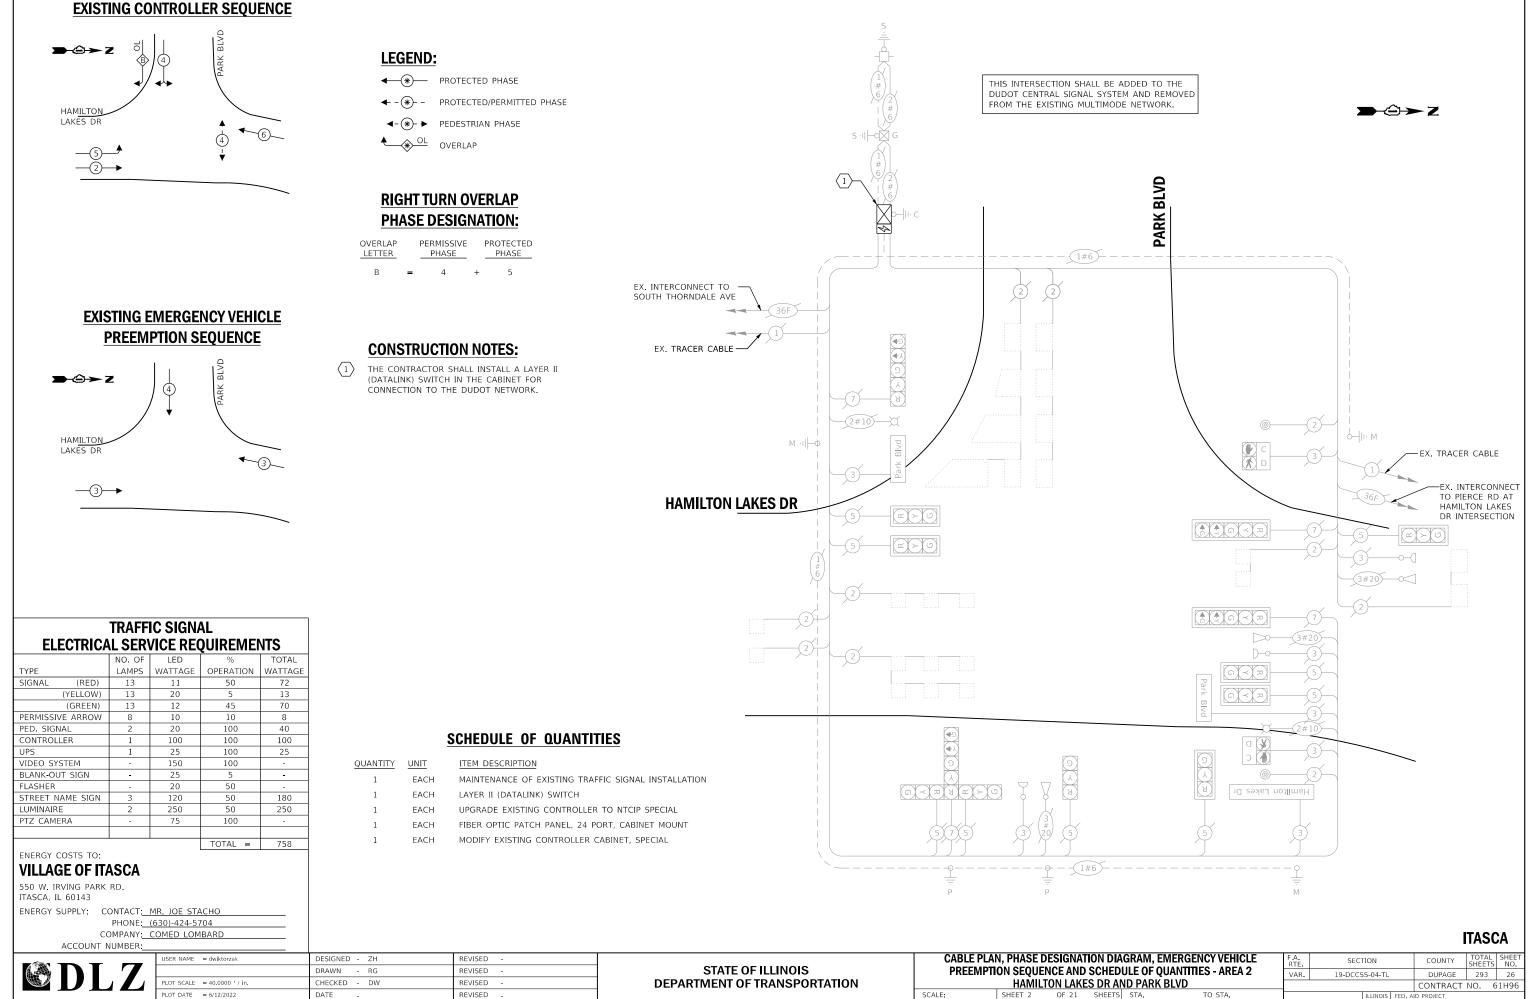

TRAFFIC SIGNAL									
ELECTRICAL SERVICE REQUIREMENTS									
NO. OF LED % TOTAL									
TYPE	LAMPS	WATTAGE	OPERATION	WATTAGE					
SIGNAL (RED)	21	11	50	116					
(YELLOW)	21	20	5	21					
(GREEN)	26	12	45	141					
PERMISSIVE ARROW	16	10	10	16					
PED. SIGNAL	8	20	100	160					
CONTROLLER	1	100	100	100					
UPS	1	25	100	25					
VIDEO SYSTEM	-	150	100	-					
BLANK-OUT SIGN	-	25	5	-					
FLASHER	-	20	50	-					
STREET NAME SIGN	4	120	50	240					
LUMINAIRE	2	250	50	250					
PTZ CAMERA	-	75	100	-					
			TOTAL =	1069					

ENERGY COSTS TO:

VILLAGE OF ITASCA 550 W. IRVING PARK RD.

220	٧٧.	1L/ /	UNG	PARK	
ITAS	CA.	IL	6014	43	

ENERGY SUPPLY:	CONTACT MR JOE STACHO
	PHONE: (630)-424-5704
	COMPANY: COMED LOMBARD

LEGEND:

- ← (¥) PROTECTED PHASE
- ← (*)- PROTECTED/PERMITTED PHASE
- ◄- (*)- ► PEDESTRIAN PHASE
- ◆ OL OVERLAP

RIGHT TURN OVERLAP PHASE DESIGNATION:

OVERLAP <u>LETTER</u>		PERMISSIVE PHASE		PROTECTED PHASE
В	=	4	+	5

CONSTRUCTION NOTES:

THE CONTRACTOR SHALL INSTALL A LAYER II (DATALINK) SWITCH IN THE EXISTING CABINET FOR CONNECTION TO THE DUDOT NETWORK. $\langle 1 \rangle$

QUANTITY	UNIT	ITEM DESCRIPTION
1	EACH	MAINTENANCE OF EXISTING TRAFFIC SIG
1	EACH	LAYER II (DATALINK) SWITCH
1	EACH	UPGRADE EXISTING CONTROLLER TO NT
1	FACH	FIRER OPTIC PATCH PANEL 24 PORT CA

- 1 1 EA 1 EA

PIERCE RD $2 + 10$ $3 + 10$ $4 + 10$ $5 + 10$	P 1 2 3 1 5 2 1 3 3 1 5 2 1 3 3 1 4 1 1 1 1 1 1 1 1 1 1 1 1 1
INSTALLATION	ex. Interconnect
	TO PARK BLVD

SCHEDULE OF QUANTITIES


EACH	MAINTENANCE OF EXISTING TRAFFIC SIGNAL INSTALLATION
EACH	LAYER II (DATALINK) SWITCH
EACH	UPGRADE EXISTING CONTROLLER TO NTCIP SPECIAL
EACH	FIBER OPTIC PATCH PANEL, 24 PORT, CABINET MOUNT
EACH	MODIFY EXISTING CONTROLLER CABINET, SPECIAL

EX. TRACER CABLE -


THIS INTERSECTION SHALL BE ADDED TO THE
DUDOT CENTRAL SIGNAL SYSTEM AND REMOVED
FROM THE EXISTING MULTIMODE NETWORK.

- 54	USER NAME = dwiktorzak	DESIGNED - ZH	REVISED -		CABLE	,		,		F.A. BTE	SECTION	COUNTY TOTAL	L SHEET
634		DRAWN - RG	REVISED -	STATE OF ILLINOIS	PREE	EMPTION SEQUENCE AND S				VAR.	19-DCCSS-04-TL	DUPAGE 293	27
	PLOT SCALE = 40,0000 / in	CHECKED - DW	REVISED -	DEPARTMENT OF TRANSPORTATION		HAMILTON LAKES	<u>5 DR AN</u>	<u>D PIERCE</u>	RD			CONTRACT NO.	61H96
	PLOT DATE = 6/12/2022	DATE -	REVISED -		SCALE:	SHEET 3 OF 21 S	SHEETS	STA.	TO STA.		ILLINOIS FED	. AID PROJECT	

FILE NAME Int 64

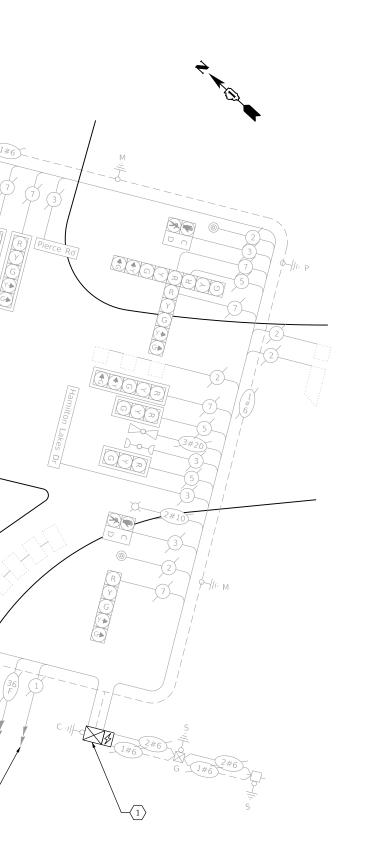


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THIS INTERSECTION SHALL BE ADDED TO THE DUDOT CENTRAL SIGNAL SYSTEM AND REMOVED FROM THE EXISTING MULTIMODE NETWORK.

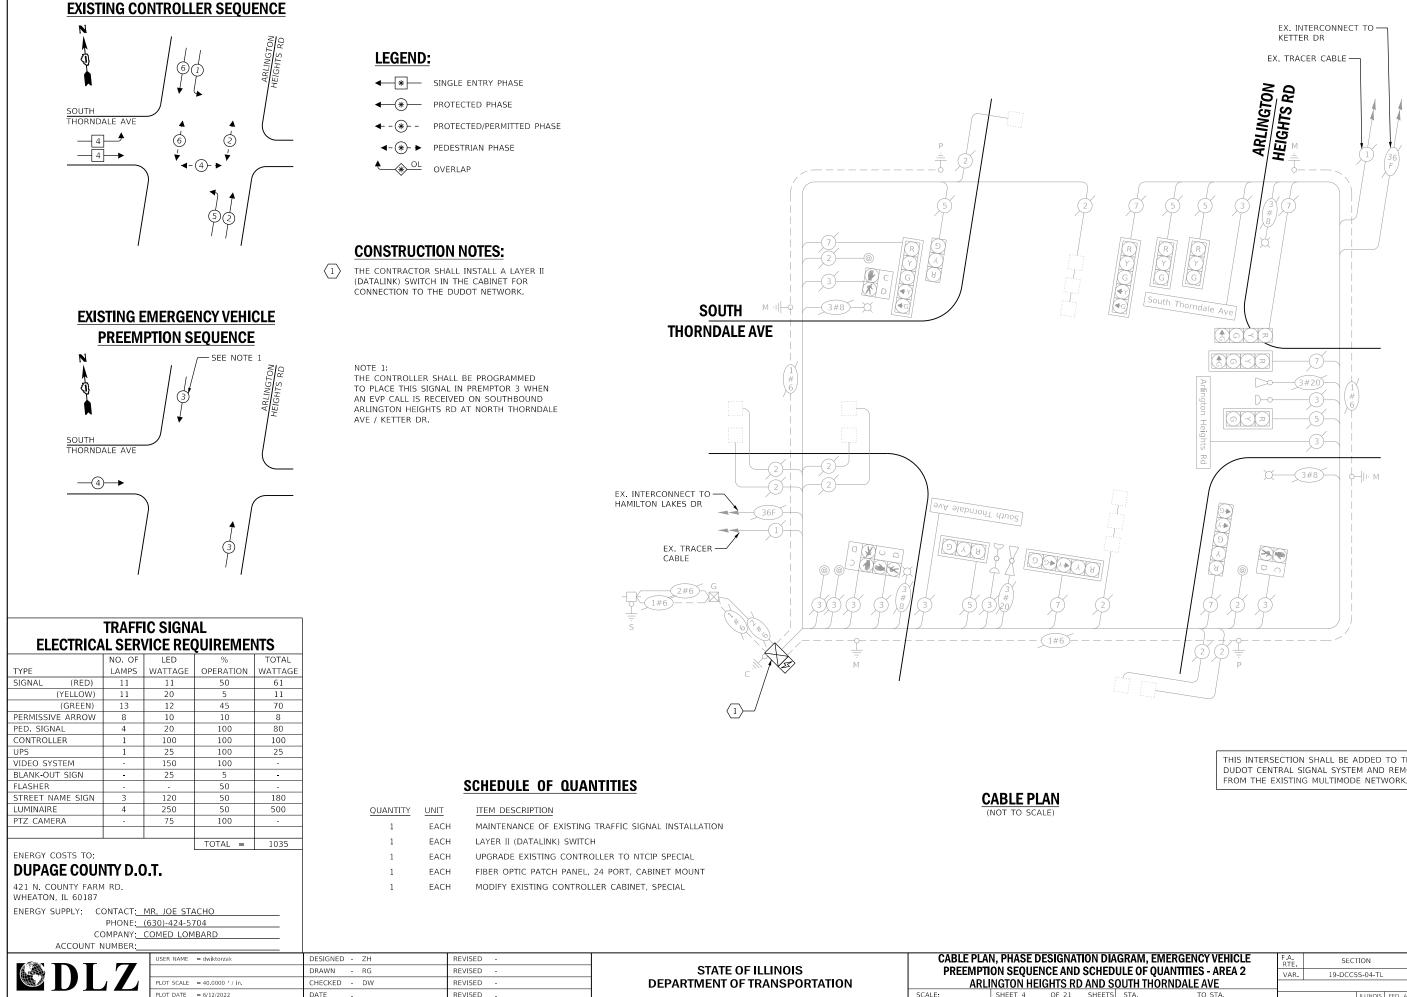IAGRAM, EMERGENCY VEHICLE	F.A. RTE	SECTION	COUNTY	TOTAL	
DULE OF QUANTITIES - AREA 2	VAR	19-DCCSS-04-TL	DUPAGE	293	28
SOUTH THORNDALE AVE		•	CONTRACT	NO. 6	51H96
TS STA. TO STA.		ILLINOIS FED A	ID PROJECT		




FILE NAME Int 68 = X\Projects\2021\2182\217400 DuPage DOT Central\CADD_Sheets\sht-2B-Arlingto


SCALE: 1"=20' SHEET 5 OF 21 SHEET

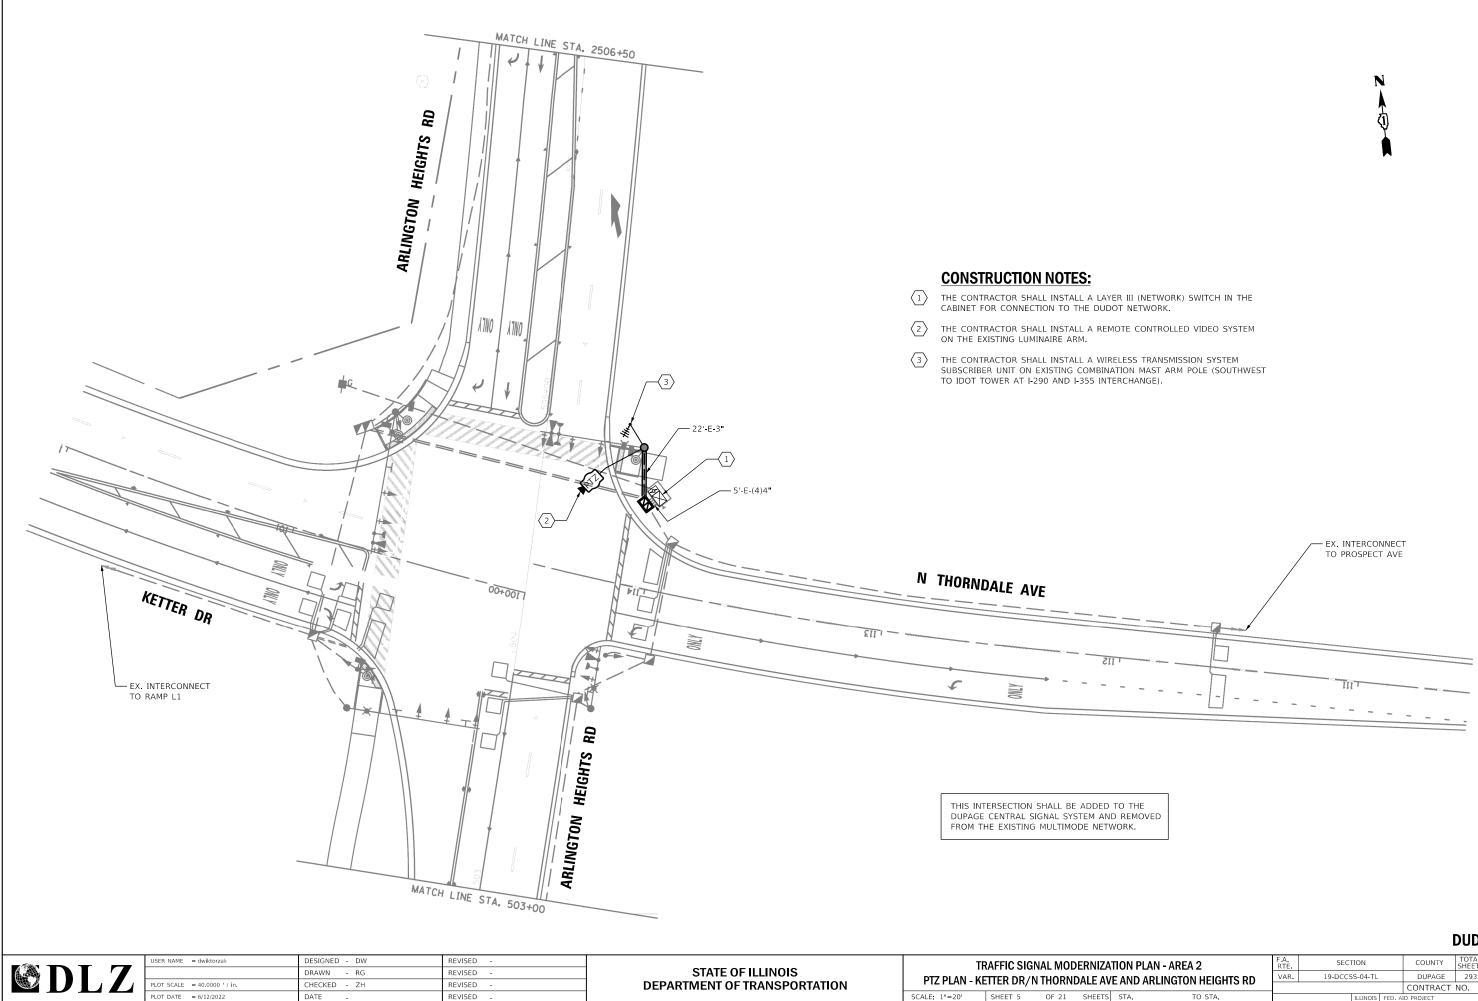


ZA	10N PLAN - AREA 2	F.A. RTE	SEC	FION		COUNTY	TOTAL SHEETS	SHEET NO.
Δ٧	E AND ARLINGTON HEIGHTS RD	VAR.	19-DCCS	5S-04-TL		DUPAGE	293	29
~ *						CONTRACT	NO. 6	51H96
TS	STA. TO STA.			ILLINOIS	FED, A	D PROJECT		

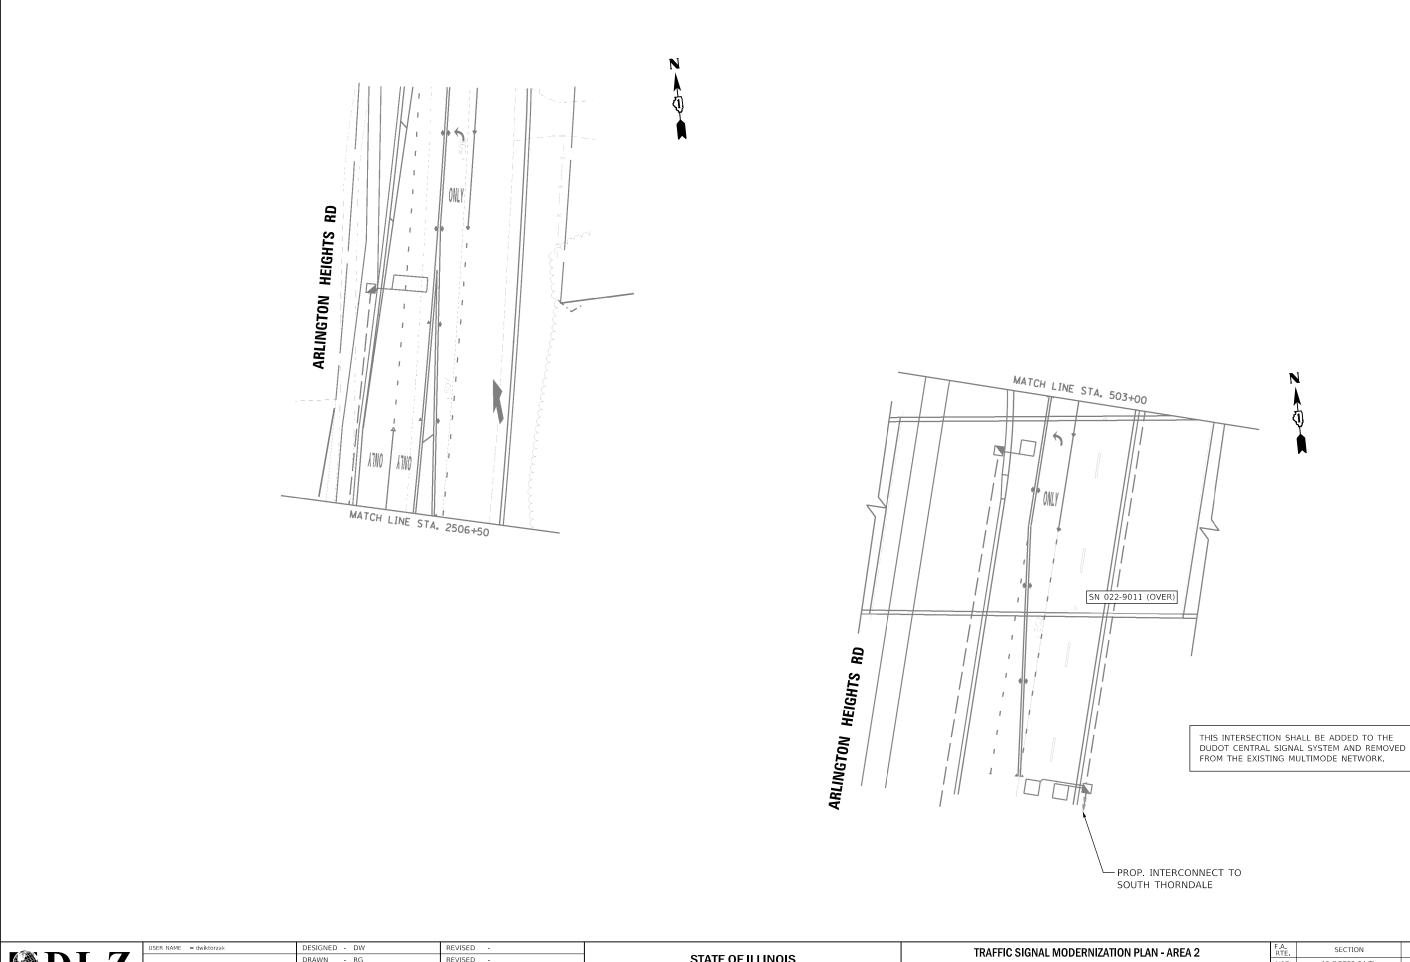


	USER NAME = dwiktorzak	DESIGNED - DW	REVISED -		TRAFFIC SIGNAL MODERNIZATION PLAN - AREA 2	F.A RT	SECTION	COUNTY TOTAL SHEET SHEETS NO.
		DRAWN - RG	REVISED -	STATE OF ILLINOIS			R. 19-DCCSS-04-TL	DUPAGE 293 30
	PLOT SCALE = 40.0000 / in.	CHECKED - ZH	REVISED -	DEPARTMENT OF TRANSPORTATION	PTZ PLAN - KETTER DR/N THORNDALE AVE AND ARLINGTON HE			CONTRACT NO. 61H96
	PLOT DATE = 6/12/2022	DATE -	REVISED -		SCALE: 1"=20' SHEET 6 OF 21 SHEETS STA. TO ST	۹.	ILLINOIS	FED. AID PROJECT
FILE NAME = X:\Projects\2021\2182\217400 Du Int 68	age DOT Central\CADD_Sheets\sht-2B-Arlington-ts	s-plan.dgn						

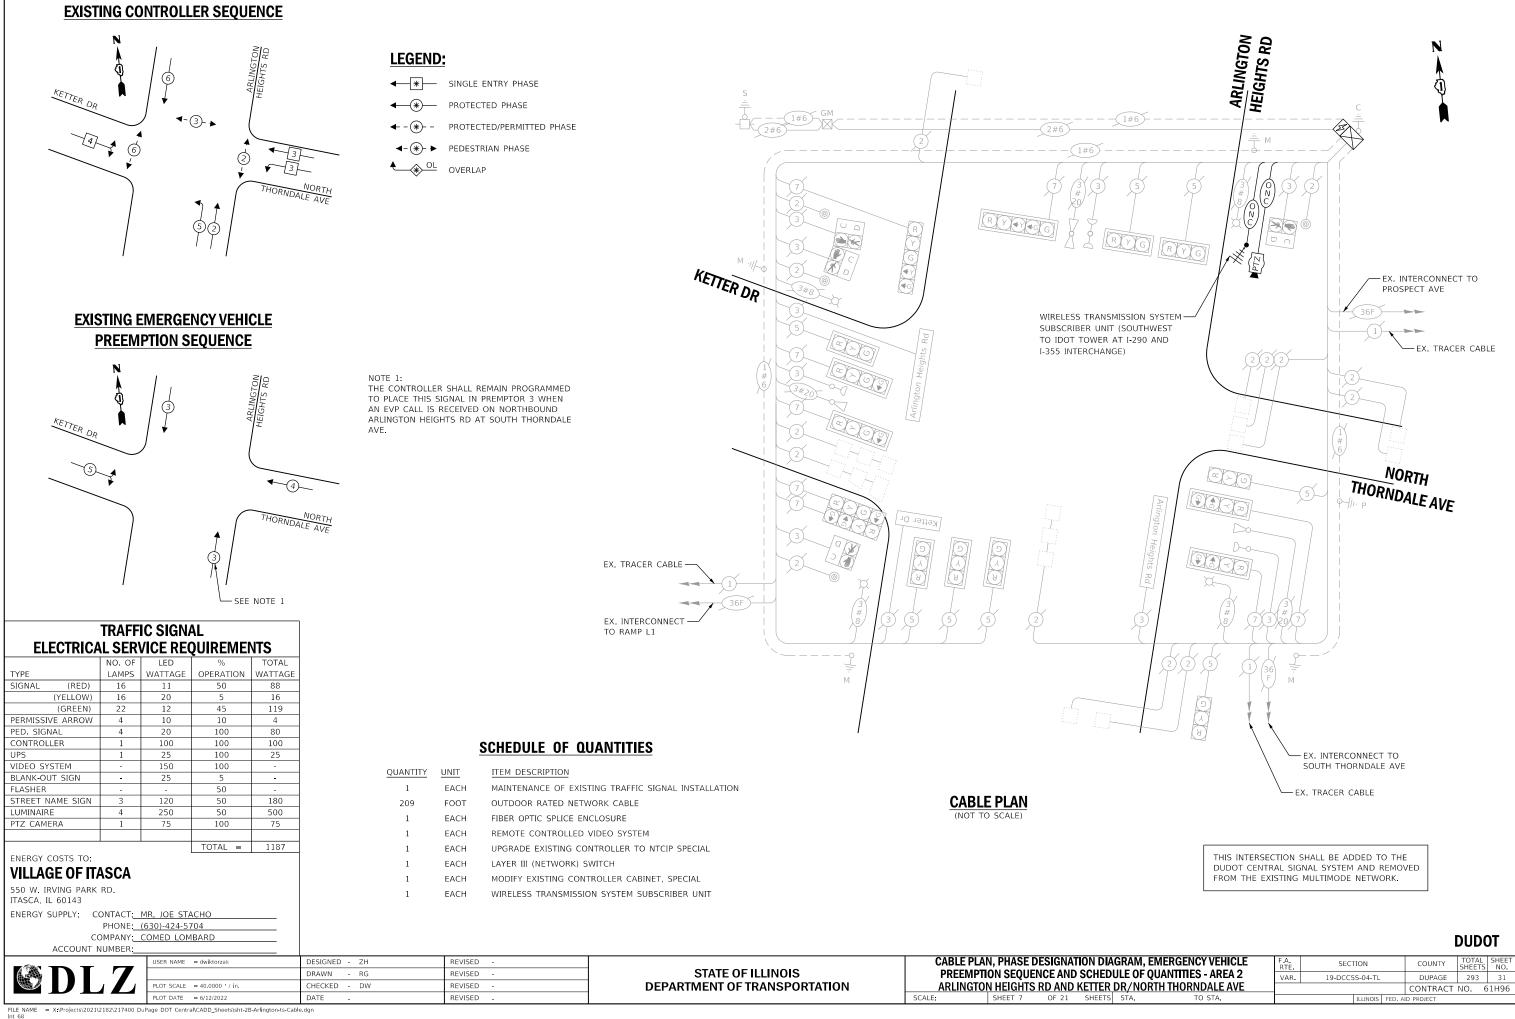

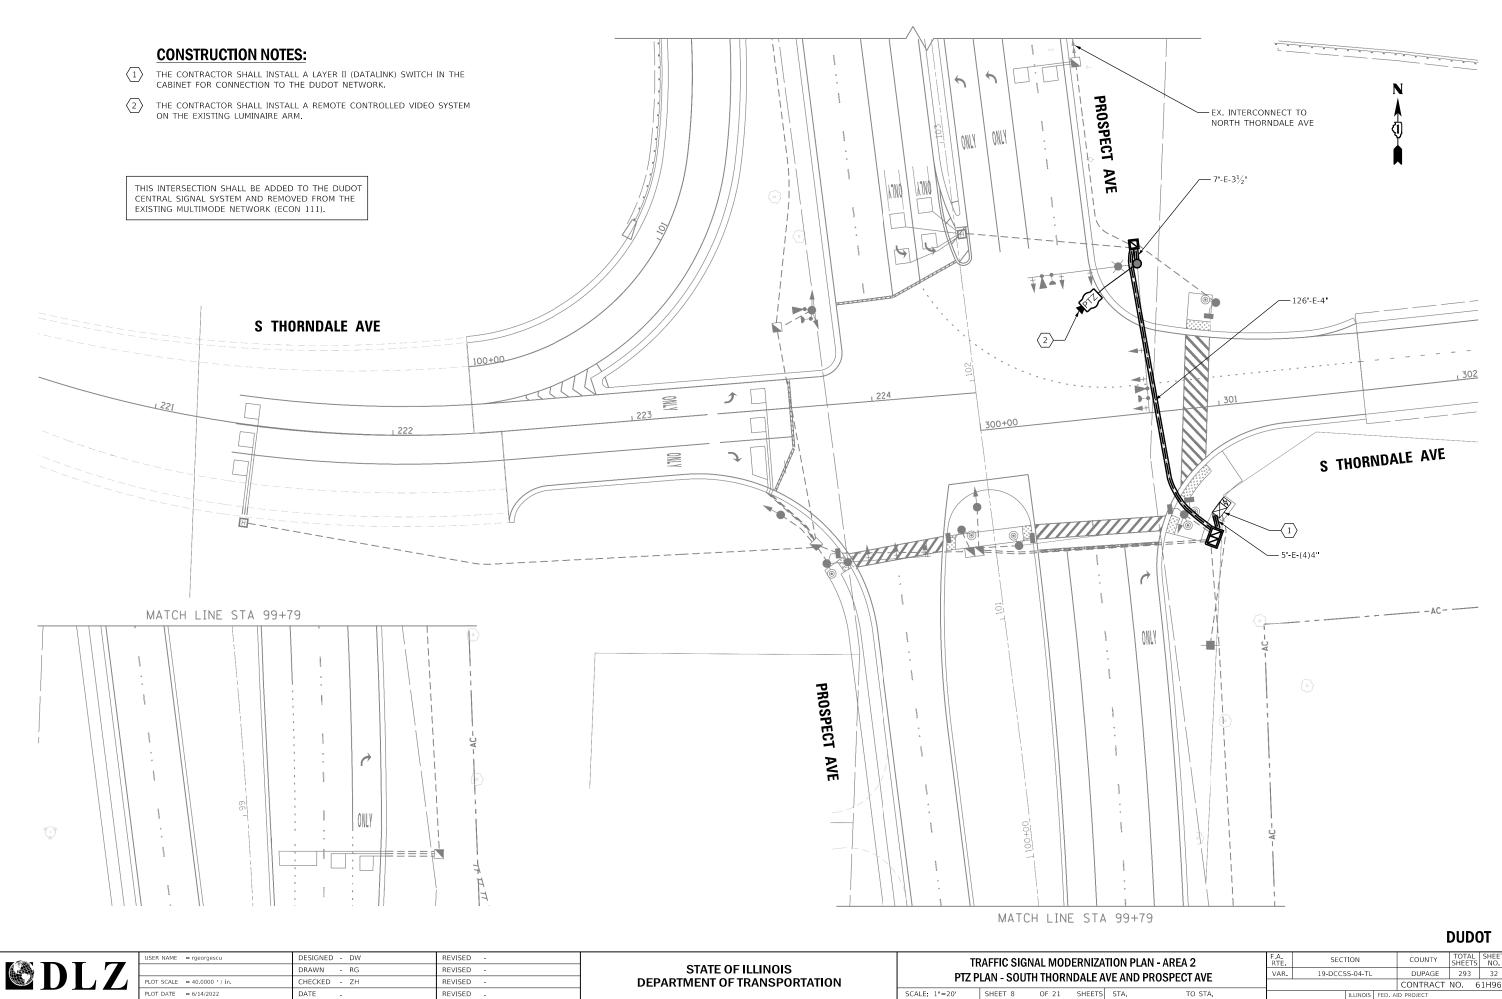

FILE NAME = X\Projects\2021\2182\217400 DuPage DOT Central\CADD_Sheets\sht-2C-Prospect-ts-plan.dgn Int 73

FΔ		SPECT AVE	VAR.	19-DCCS	6S-04-TL		DUPAGE	293	32
- 7	AVE AND PROSPECT AVE					CONTRACT	NO.	61H96	
ETS	STA.	TO STA.			ILLINOIS	FED. A	ID PROJECT		

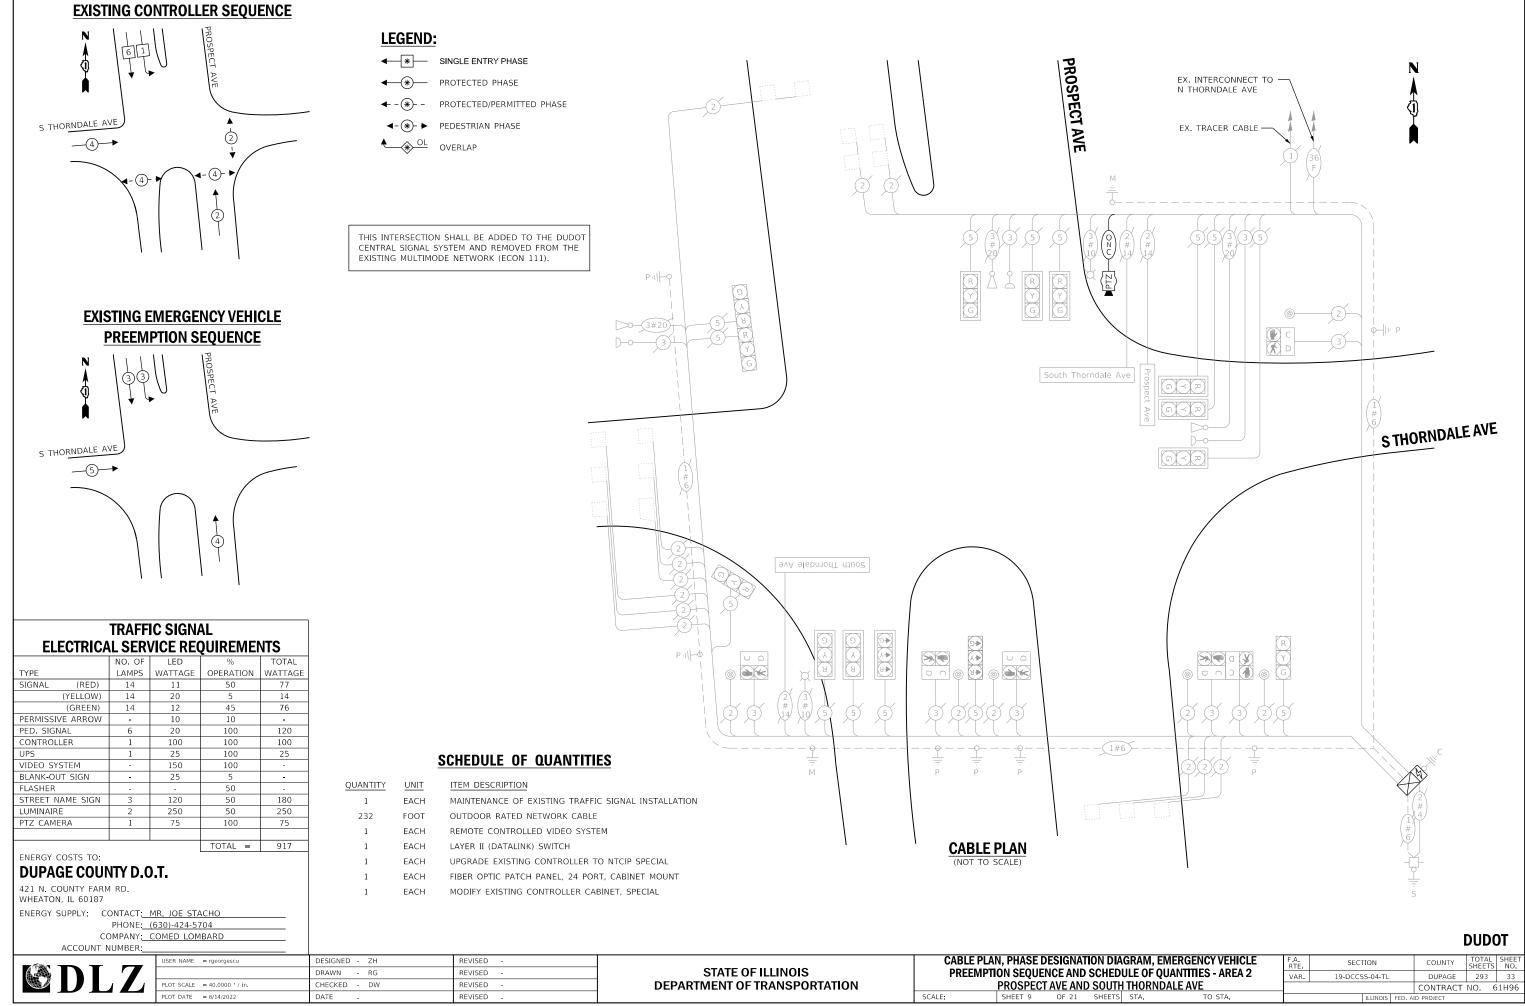

FILE NAME = X Projects\2021\2182\217400 DuPage DOT Central\CADD_Sheets\sht-2C-Prospect-ts-Cable.dgn Int 73

REMOVAL AND RELOCATION OF EXISTING TRAFFIC SIGNAL EQUIPMENT:


THE FOLLOWING ITEMS SHALL BE REMOVED BY THE CONTRACTOR AND SHALL REMAIN THE PROPERTY OF THE AGENCY LISTED BELOW. THE CONTRACTOR SHALL SAFELY STORE AND ARRANGE FOR PICKUP (DELIVERY) OF ALL EQUIPMENT TO BE RETURNED TO THE LISTED AGENCY AS PER THE TRAFFIC SIGNAL SPECIFICATIONS.

AGENCY: DUPAGE COUNTY DIVISION OF TRANSPORTATION

EACH MASTER CONTROLLER (ASC/2M-1000) 1 1 EACH MODEM

CONSTRUCTION NOTES:

- $\langle 1 \rangle$ THE CONTRACTOR SHALL INSTALL A LAYER II (DATALINK) SWITCH IN THE CABINET FOR CONNECTION TO THE DUDOT NETWORK.
- $\langle 2 \rangle$ THE CONTRACTOR SHALL INSTALL A PROPOSED WIRELESS INTERCONNECT.

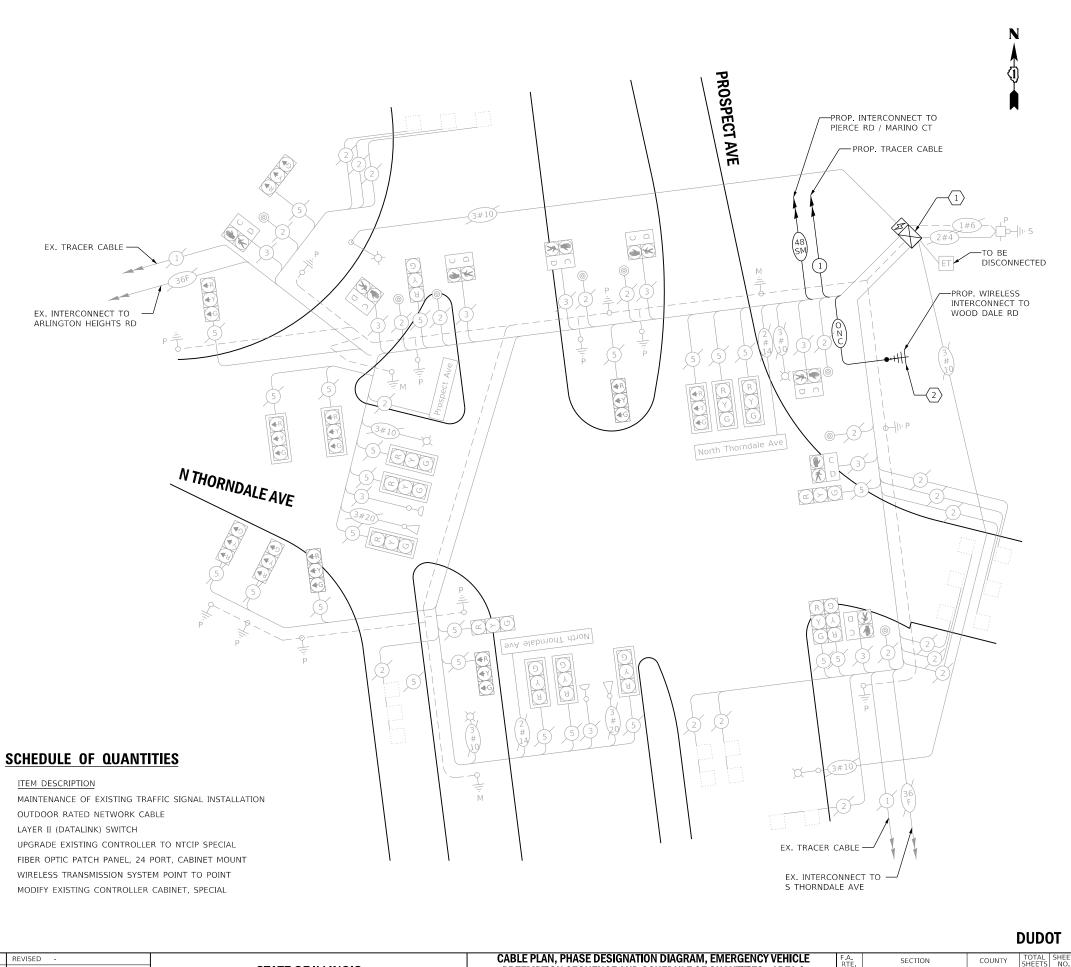

THIS INTERSECTION SHALL BE ADDED TO THE DUDOT CENTRAL SIGNAL SYSTEM AND REMOVED FROM THE EXISTING MULTIMODE NETWORK (ECON 111).

ELECTRICA		IC SIGN/		NTS
	NO. OF	LED	%	TOTAL
TYPE	LAMPS	WATTAGE	OPERATION	WATTAGE
SIGNAL (RED)	23	11	50	127
(YELLOW)	23	20	5	23
(GREEN)	23	12	45	125
PERMISSIVE ARROW	-	10	10	-
PED. SIGNAL	8	20	100	160
CONTROLLER	1	100	100	100
UPS	1	25	100	25
VIDEO SYSTEM	-	150	100	-
BLANK-OUT SIGN	-	25	5	-
FLASHER	-	-	50	-
STREET NAME SIGN	3	120	50	180
LUMINAIRE	5	250	50	625
PTZ CAMERA	-	75	100	-
			TOTAL =	1365
ENERGY COSTS TO:		. -		
DUPAGE COUI). .		
421 N. COUNTY FARM WHEATON, IL 60187	4 RD.			
ENERGY SUPPLY: C	ONTACT:	MR. JOE STA	АСНО	
		(630)-424-57		
C	OMPANY:	COMED LOM	IBARD	
ACCOUNT I	UMBER:			
		USER NAME	= rgeorgescu	

QUANTITY	UNIT	ITEM DESCRIPTION
1	EACH	MAINTENANCE OF EXISTING TRAFFIC SIGNAL INSTALLATION
91	FOOT	OUTDOOR RATED NETWORK CABLE
1	EACH	LAYER II (DATALINK) SWITCH
1	EACH	UPGRADE EXISTING CONTROLLER TO NTCIP SPECIAL
1	EACH	FIBER OPTIC PATCH PANEL, 24 PORT, CABINET MOUNT
1	EACH	WIRELESS TRANSMISSION SYSTEM POINT TO POINT
1	EACH	MODIFY EXISTING CONTROLLER CABINET. SPECIAL

©DLZ	PLOT SCALE = 40.0000 ' / in.	DESIGNED - ZH DRAWN - RG CHECKED - DW	REVISED - REVISED - REVISED -	STATE OF ILLINOIS DEPARTMENT OF TRANSPORTATION		E PLAN, PHASE DESIGNATION DIAGRAM, EM EMPTION SEQUENCE AND SCHEDULE OF QU PROSPECT AVE AND NORTH THORNDA	ANTITIES - AREA 2	F.A. RTE. VAR.	SECTION 19-DCCSS-04-TL	COUNTY TOTAL SHEETS SHEET NO. DUPAGE 293 34 CONTRACT NO. 61H96
FILE NAME = X:\Projects\2021\2182\217400	PLOT DATE = 6/14/2022 DuPage DOT Central\CADD_Sheets\sht-2C-Prospect-ts-Cak	DATE _	REVISED -		SCALE:	SHEET 10 OF 21 SHEETS STA.	TO STA.		ILLINOIS FED	AID PROJECT

SEQUENCE OF OPERATION

MOVEMENT			TEXAS U-TURN	FRONTAGE	ROAD	Ŧ						-	TEXAS U-TURN	AVENUE AVENUE	ROAD 1 T1 1								TEXAS U-TURN	37N3/W B FROWTAG	1. 0	-					-use IJ-TURN / =	ANNAL ANNAL	GE ROAD					
PHASE					8	3									2 ·	+ 5								2 +	- 6								9					F
INTERVAL	1	2A	2B	2C	3A	3B	3C	4A	4B	4C	5	6A	6B	6C	7A	7B	7C	8A	8B	8C	9	10A	10B	11A	11B	11C	12A	12B	13	14A	14B	14C	15A	15B	16A	16B	16C	A
CHANGE TO			2 +	5		2 + 1	6		9			,	2 + 6	ò		9			8			g)	I	8		2 +	- 5			8		2 +	- 5	2	2 + 6		H
PROSPECT AVENUE N/B END MAST ARM AND MEDIAN SIGNALS	R	R	R	R	R	R	R	R	R	R	_ G	G	Υ.	R	G	Y	R	G	→ Y	R	R	R	R	R	R	R	R	_R	R	_R .	R	R	R	R	R	R	R	R
PROSPECT AVENUE N/B MID & FAR RIGHT MAST ARM, NEAR RIGHT SIGNALS	R	R	R	R	R	R	R	R	R	R	G	G	G	G	G	G	G	G	Y	R	G	G	G	G	Y	R	G	G	G	G	Y	R	G	G	G	G	G	R
PROSPECT AVENUE S/B MAST ARM, FAR LEFT, AND NEAR RIGHT SIGNALS	R	R	R	R	R	R	R	R	R	R	R	R	R	R	R	R	R	R	R	R	G	G	G	G	Y	R	Y	R	G	G	Y	R	Y	R	G	G	G	R
PROSPECT AVENUE S/B ALL RIGHT TURN ONLY SIGNALS	R	R	R	R	R	R	R.	R	R	R	R	R	R	R	R	R	R	R	R	R	G	¥►	R,	G 🛌	Y-	R	Y.	R	R	R	R	R_	R	R	R	R	R	R
WB FRONTAGE ROAD W/B ALL SIGNALS	G	G	Y	R	G	Y	R	G	Y	R	R	R	R	R	R	R	R	R	R	R	R	R	R	R	R	R	R	R	R	R	R	R	R	R	R	R	R	R
TEXAS U-TURN RAMP N/B ALL SIGNALS	R	R	R	R	R	R	_ R	R	R	R	R	R	R	R	R	R	R	R	R	R	R	R	R	R	R	_R -	R	R	G	G -	Y	R	<u> </u>	R	G.	<u> </u>	R	R
PEDESTRIAN SIGNALS CROSSING SB RIGHT TURN LANE OF PROSPECT AVENUE ON NORTH SIDE OF WB FRONTAGE ROAD	*P	*P	*P	*P	**FH	н	Н	*P	*P	*P	۰P	•∗FH	н	н	*P	*P	*P	۰P	*P	*P	н	н	н	Н	Н	н	Н	Н	*P	۰P	*P	*P	*P	*P 9	**FH	н	н	
PEDESTRIAN SIGNALS CROSSING SB THROUGH LANES OF PROSPECT AVENUE ON NORTH SIDE OF WB FRONTAGE ROAD	*P	*P	*P	۰P	**FH	н	н	**FH	н	н	*P	**FH	н	Н	**FH	н	Н	*P	*P	*P	н	Н	Н	н	Н	н	н	Н	н	Н	н	Н	н	н	н	н	н	D
PEDESTRIAN SIGNALS CROSSING NB PROSPECT AVENUE ON NORTH SIDE OF WB FRONTAGE ROAD	*P	**FH	н	н	**FH	н	Н	**FH	н	н	н	Н	н	н	н	н	Н	Н	Н	н	н	Н	Н	Н	Н	н	Н	Н	н	н	н	н	н	н	н	н	н	ĸ
PEDESTRIAN SIGNALS CROSSING WB FRONTAGE ROAD ON EAST SIDE OF PROSPECT AVENUE	н	н	Н	Н	Н	н	Н	н	Н	н	*P	*P	*P	*P	*P	*P	*P	**FH	Н	Н	*P	*P	*P	**FH	Н	Н	*P	*P	*P	**FH	н	н	*P	*P	*P	*P	*P	

PHASE 2 + 6 SHALL BE PLACED ON RECALL

TO APPEAR ONLY UPON PUSHBUTTON ACTUATION
 FLASHING "DON'T WALK" IS TO TERMINATE AT THE COMPLETION OF THE PEDESTRIAN INTERVAL CLEARANCE.

- P = ILLUMINATED PERSON = WALK FH = ILLUMINATED FLASHING HAND = FLASHING DON'T WALK H = ILLUMINATED SOLID HAND = DON'T WALK

FOR INFORMATION ONLY


EMERGENCY VEHICLE PREEMPTION SEQUENCE OF OPERATION

													F N	EEN	/ []			.ųu			F U										R PREEMPTOR NUMBER 4			
CHANGE FROM NORMAL SEQUENCE OF OPERATION INTERVAL NUMBER		1		1	5	5			5			9		9		9			9			13			13		13	13	3					
EMERGENCY VEHICLE PREEMPTION SEQUENCE OF OPERATION INTERVAL NUMBER	1A	1B	1C	1D	1E 1	.F 1G	1H	1J	1K	1L	1M	1N	1P	1 Q	1R	1S	1T	1U	1V	1W	1X 1	LY 1	1Z	1AA 1	1BB	1CC 11	DD 1E	E 1FI	F 1G	G 2	3	4	5	CLEAR TO
CHANGE TO EMERGENCY VEHICLE PREEMPTION SEQUENCE OF OPERATION INTERVAL NUMBER	IB	1C	2.3 OR 4	5	2	1G 1H	3 OF 4	^R 1К	1L	5	1N	1P	2	3	15	1⊤	4	1V	1 W	5	1Y	1Z	2	1BB 1	1CC	3	4 1F	F 1G	G 5					NORMAL SEQUENCE
PROSPECT AVENUE N/B END MAST ARM AND MEDIAN SIGNALS	R	R	R	_R _	G	G Y	R	G	→ Y	R	R	_ R	R	R.	R	R	R	<u>_</u> R	R		R 🚽	R	R	R	<u>R</u> -	R 🗸	R 🚽	R	R	G	R	R	R	\diamond
PROSPECT AVENUE N/B MID & FAR RIGHT MAST ARM, NEAR RIGHT SIGNALS	R	R	R	R	G	C C	G	G	Y	R	G	G	G	G	G	G	G	G	Y	R	G	G	G	G	G	G	G (; Y	R	G	G	G	R	\diamond
PROSPECT AVENUE S/B MAST ARM, FAR LEFT, AND NEAR RIGHT SIGNALS	R	R	R	R	R	R R	R	R	R	R	G	Y	R	G	G	G	G	G	Y	R	G	Y	R	G	G	G (3 0	; Y	R	R	G	G	R	\diamond
PROSPECT AVENUE S/B ALL RIGHT TURN ONLY SIGNALS	R	R	R	R I	₹ <u></u>	R R	R	R	R	R	G	Y►	R.	G 🛌	G	<u> </u>	R_	G 🛌	¥►	R	R I	R F	R	R.	R	R F		• <u>R</u>	- <u>R</u>	R	G	R	R	\diamond
WB FRONTAGE ROAD W/B ALL SIGNALS	G	Y	R	G	R	R R	R	R	R	R	R	R	R	R	R	R	R	R	R	R	R	R	R	R	R	R f	R F	R R	R	R	R	R	G	♦
TEXAS U-TURN RAMP N/B ALL SIGNALS	R	R	R	R	R	RR	R	R	R	R	R	R	R	R	R	R	R	R.	R	R	G	<u>Y</u> _	R	G	¥.	R	G 🚽	<u> </u>	- _ R	R R	R	G	R	♦
PEDESTRIAN SIGNALS CROSSING SB RIGHT TURN LANE OF PROSPECT AVENUE ON NORTH SIDE OF WB FRONTAGE ROAD	FH	н	н	FH	FH	FH H	н	FH	н	н	н	н	н	н	н	н	н	н	н	нF	н	н	н	FH	н	H F	H FI	н н	н	н	н	н	н	♦
PEDESTRIAN SIGNALS CROSSING SB THROUGH LANES OF PROSPECT AVENUE ON NORTH SIDE OF WB FRONTAGE ROAD	FH	н	Н	FH	FH	FH H	н	FH	н	н	н	н	н	н	н	н	н	н	н	Н	н	н	н	н	н	H I	+ +	н	н	н	н	н	н	\diamond
PEDESTRIAN SIGNALS CROSSING NB PROSPECT AVENUE ON NORTH SIDE OF WB FRONTAGE ROAD	FH	н	Н	FH	н	н н	н	н	н	н	н	н	н	н	н	Н	н	н	н	н	н	н	н	н	Н	нŀ	+ +	н	н	н	н	н	н	\diamond
PEDESTRIAN SIGNALS CROSSING WB FRONTAGE ROAD ON EAST SIDE OF PROSPECT AVENUE	н	Н	Н	Н	FH	FH H	Н	FH	н	н	FH	Н	Н	FH	FH	Н	н	FH	н	ΗΙ	FH	н	н	FH	н	H F	H F	нн	н	Н	н	н	Н	\diamond

EMERGENCY VEHICLE SEQUENCE SHALL PROVIDE THE PROPER CLEARANCE INTERVAL TO RESUME THE NORMAL SEQUENCE OF OPERATION OR PROPER CLEARANCE INTERVAL TO DISPLAY A DIFFERENT EMERGENCY VEHICLE INTERVAL AFTER EMERGENCY VEHICLE INTERVAL 2, 3, 4 OR 5 IS TERMINATED.

USER NAME = rgeorgescu	DESIGNED - ZH	REVISED -			N, PHASE DESIGNATION DIAG	,	F.A. BTE	SECTION	COUNTY TOTAL SHEET
	DRAWN - RG	REVISED -	STATE OF ILLINOIS	PREEMPT	10N SEQUENCE AND SCHEDUL	LE OF QUANTITIES - AREA 2	VAR.	19-DCCSS-04-TL	DUPAGE 293 35
PLOT SCALE = 40.0000 / in.	CHECKED - DW	REVISED -	DEPARTMENT OF TRANSPORTATION	PROSPECT AV	/E AND NORTH THORNDALE AV	/E - SEQUENCE OF OPERATION			CONTRACT NO. 61H96
PLOT DATE = 6/14/2022	DATE -	REVISED -		SCALE:	SHEET 11 OF 21 SHEETS S	STA. TO STA.		ILLINOIS FED.	AID PROJECT

THIS INTERSECTION SHALL BE ADDED TO THE DUDOT CENTRAL SIGNAL SYSTEM AND REMOVED FROM THE EXISTING MULTIMODE NETWORK (ECON 111).

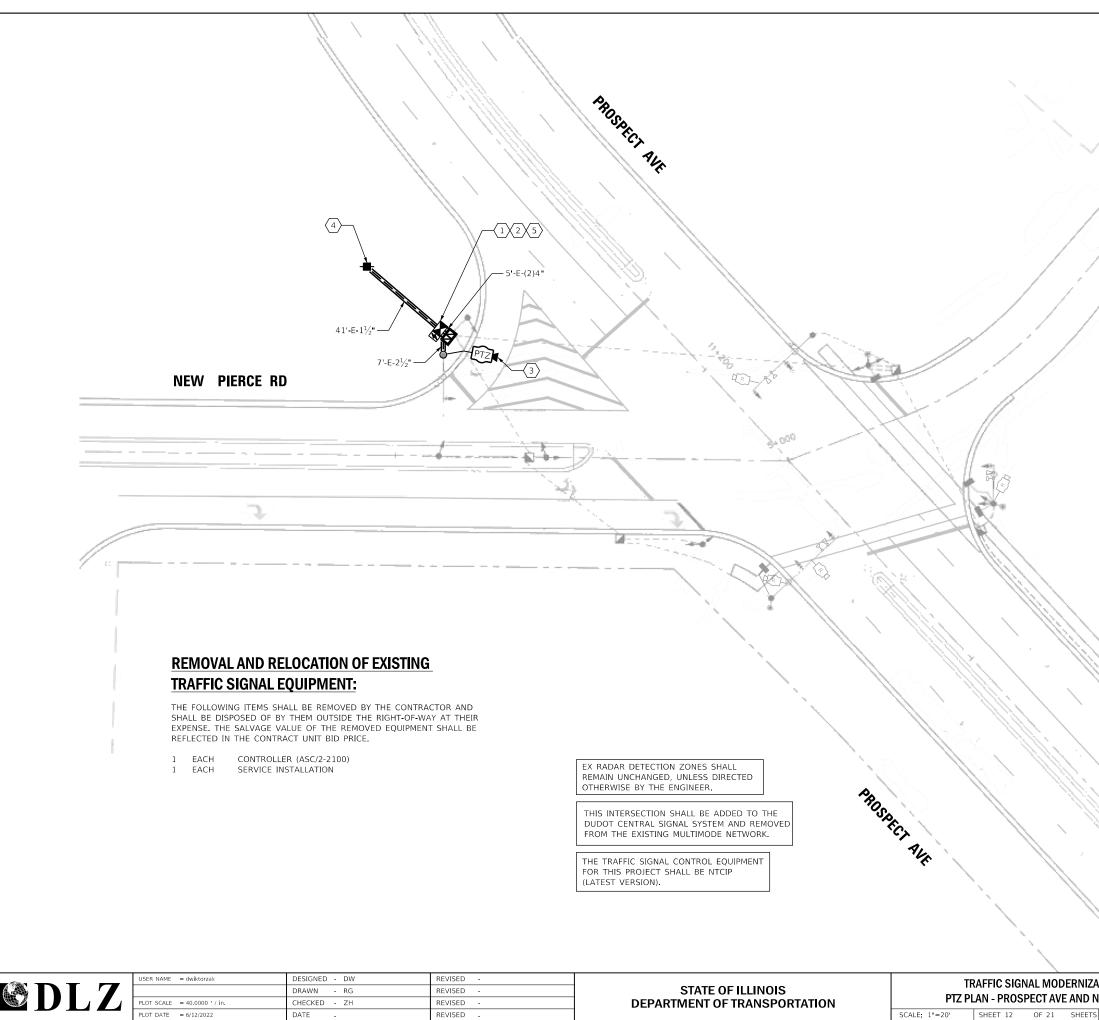

FILE NAME = X Projects/2021/2182/217400 DuPage DOT Central/CADD Sheets/sht-2C-Prospect-ts-plan.dgn Int 67

DATE

SCALE: 1"=20' SHEET 12 OF 21 SHEET




CONSTRUCTION NOTES:

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MARINO

- THE CONTRACTOR SHALL INSTALL A LAYER II (DATALINK) SWITCH IN $\langle 1 \rangle$ THE CABINET FOR CONNECTION TO THE DUDOT NETWORK.
- $\langle 2 \rangle$ THE CONTRACTOR SHALL REMOVE THE EXISTING CONTROLLER AND REPLACE IT WITH A FULL ACTUATED CONTROLLER IN THE EXISTING CABINET.
- $\langle 3 \rangle$ THE CONTRACTOR SHALL INSTALL A REMOTE CONTROLLED VIDEO SYSTEM ON THE EXISTING TRAFFIC SIGNAL MAST ARM ASSEMBLY AND POLE.
- $\langle 4 \rangle$ THE CONTRACTOR SHALL INSTALL A SERVICE INSTALLATION (SPECIAL).
- $\langle 5 \rangle$ THE CONTRACTOR SHALL INSTALL A UPS SYSTEM.

ATION PLAN - AREA 2
NEW PIERCE/MARINO CT VAR. 19-DCCSS-04-TL DUPAGE 293 36
CONTRACT NO. 61H96
S STA. TO STA. ILLINOIS FED. AID PROJECT

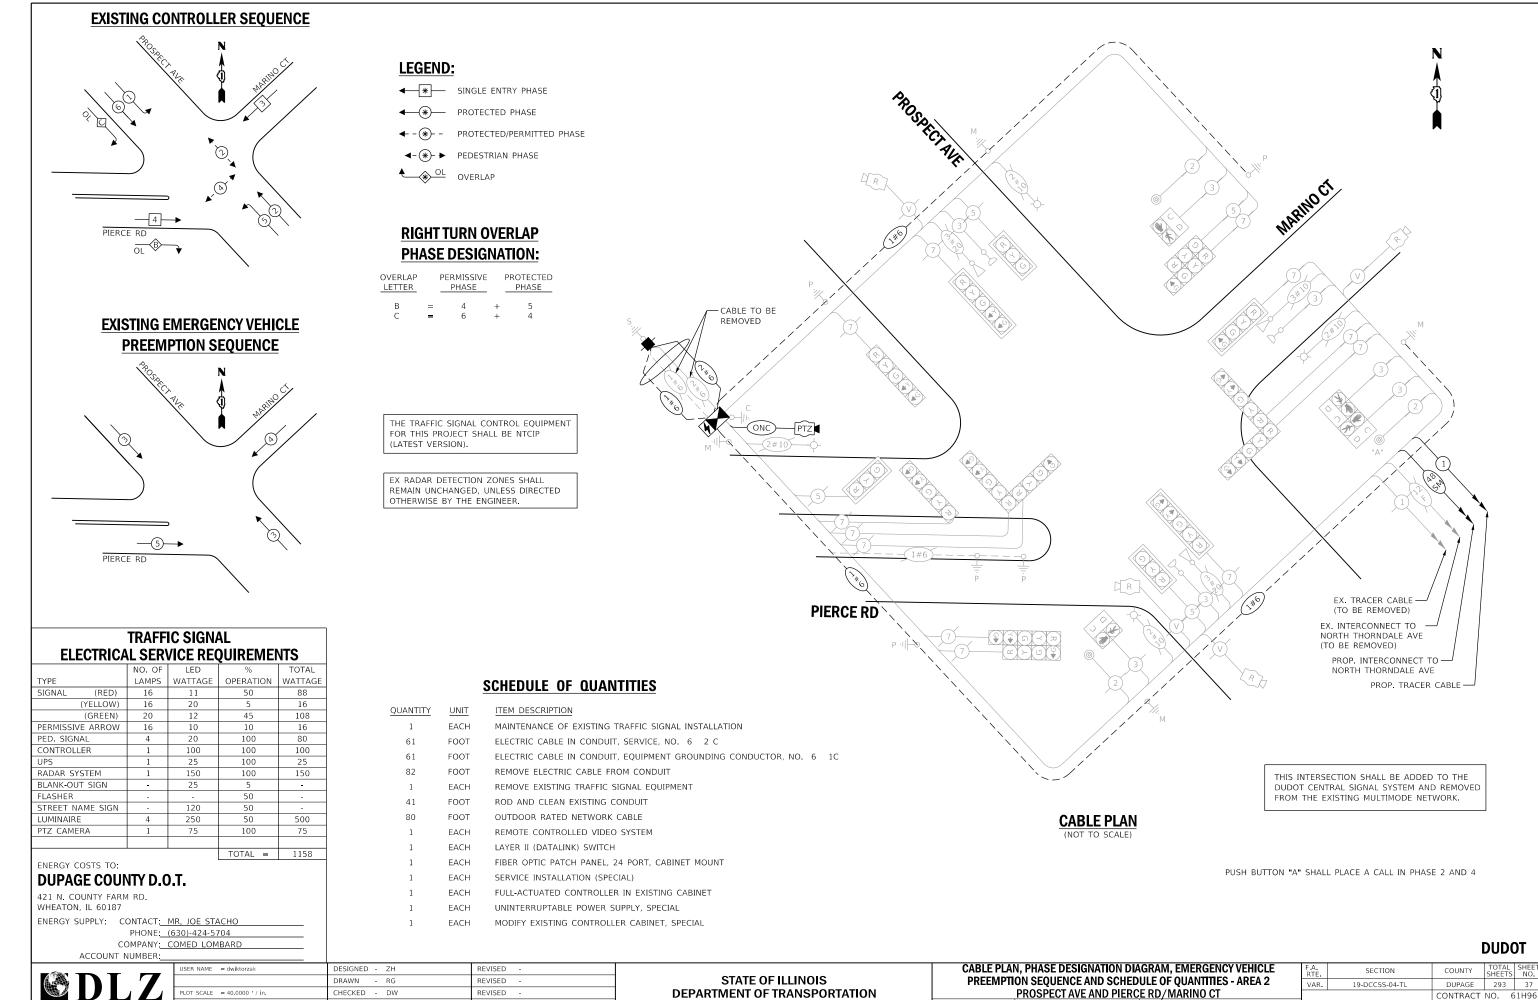


PLOT DATE = 6/12/2022 DATE FILE NAME Int 67 \Projects\2021\2182\217400 DuPage DOT Central\CADD_Sheets\sht-2C-Prospect-ts-Cable.dgr

REVISED


DEPARTMENT OF TRANSPORTATION

PROSPECT AVE AND PIERCE RD/MARINO CT SCALE: OF 21 SHEETS STA. SHEET 13

TO STA

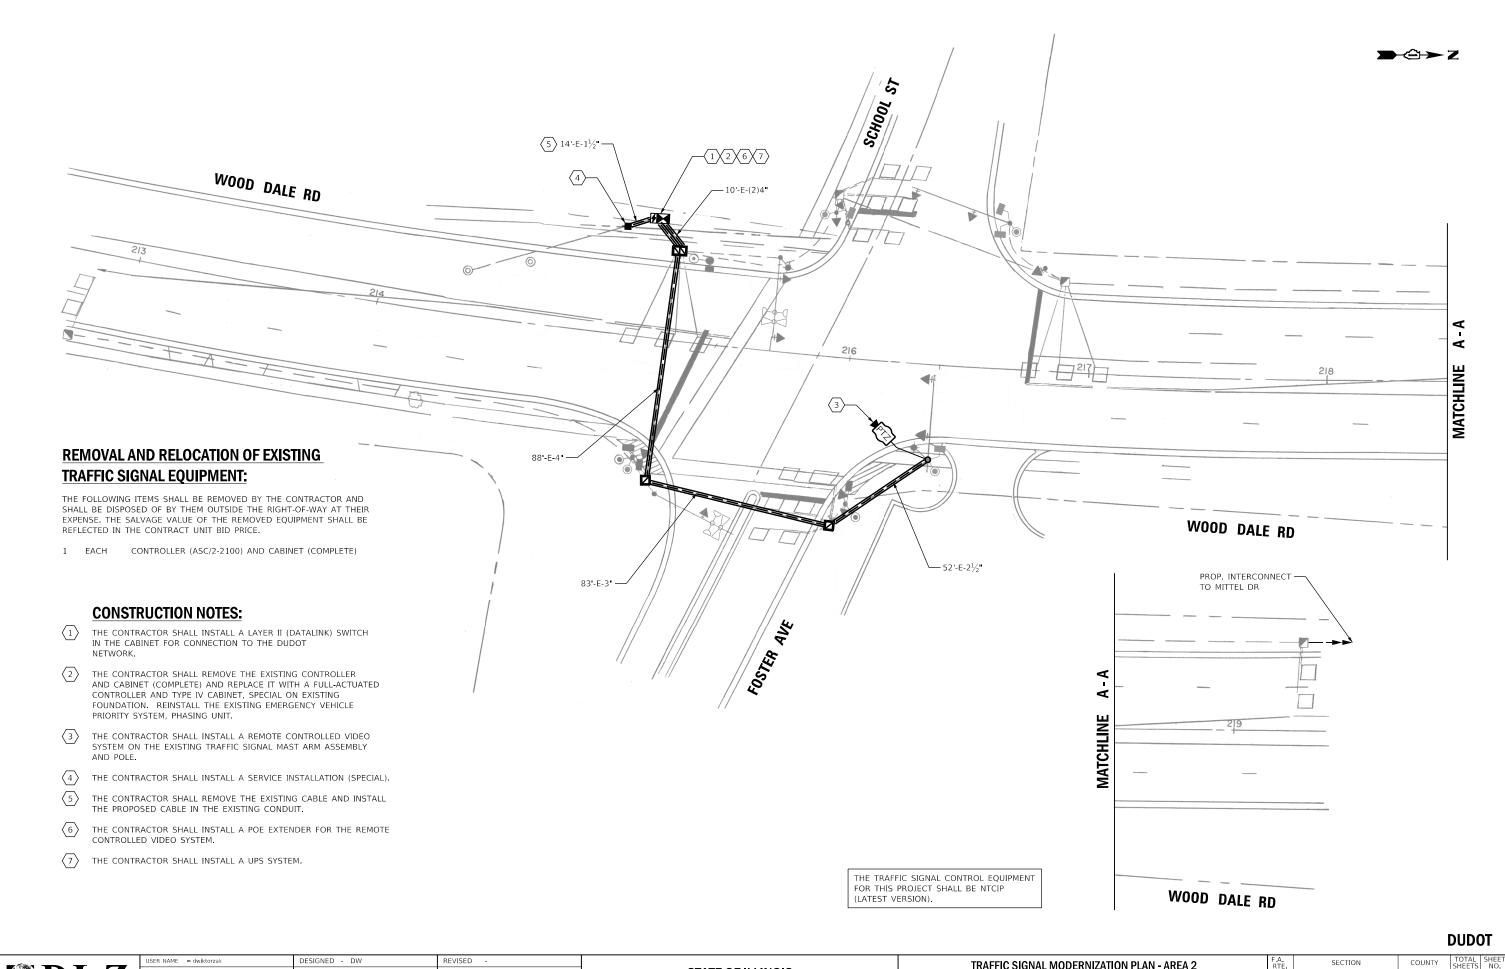

USER NAME = dwiktorza	C DESIGNED - DW	REVISED -		TRAFFIC SIGNAL MODERNIZATION PLAN - AREA 2	F.A. RTE	SECTION	COUNTY TOTAL SHEET SHEETS NO.
	DRAWN - RG	REVISED -	STATE OF ILLINOIS		VAR.	19-DCCSS-04-TL	DUPAGE 293 38
PLOT SCALE = 40.0000	/ in. CHECKED - ZH	REVISED -	DEPARTMENT OF TRANSPORTATION	PTZ PLAN - WOOD DALE RD AND FOSTER AVE/SCHOOL ST			CONTRACT NO. 61H96
PLOT DATE = 6/12/2023	DATE -	REVISED -		SCALE: 1"=20' SHEET 14 OF 21 SHEETS STA. TO STA.		ILLINOIS FEI	D. AID PROJECT

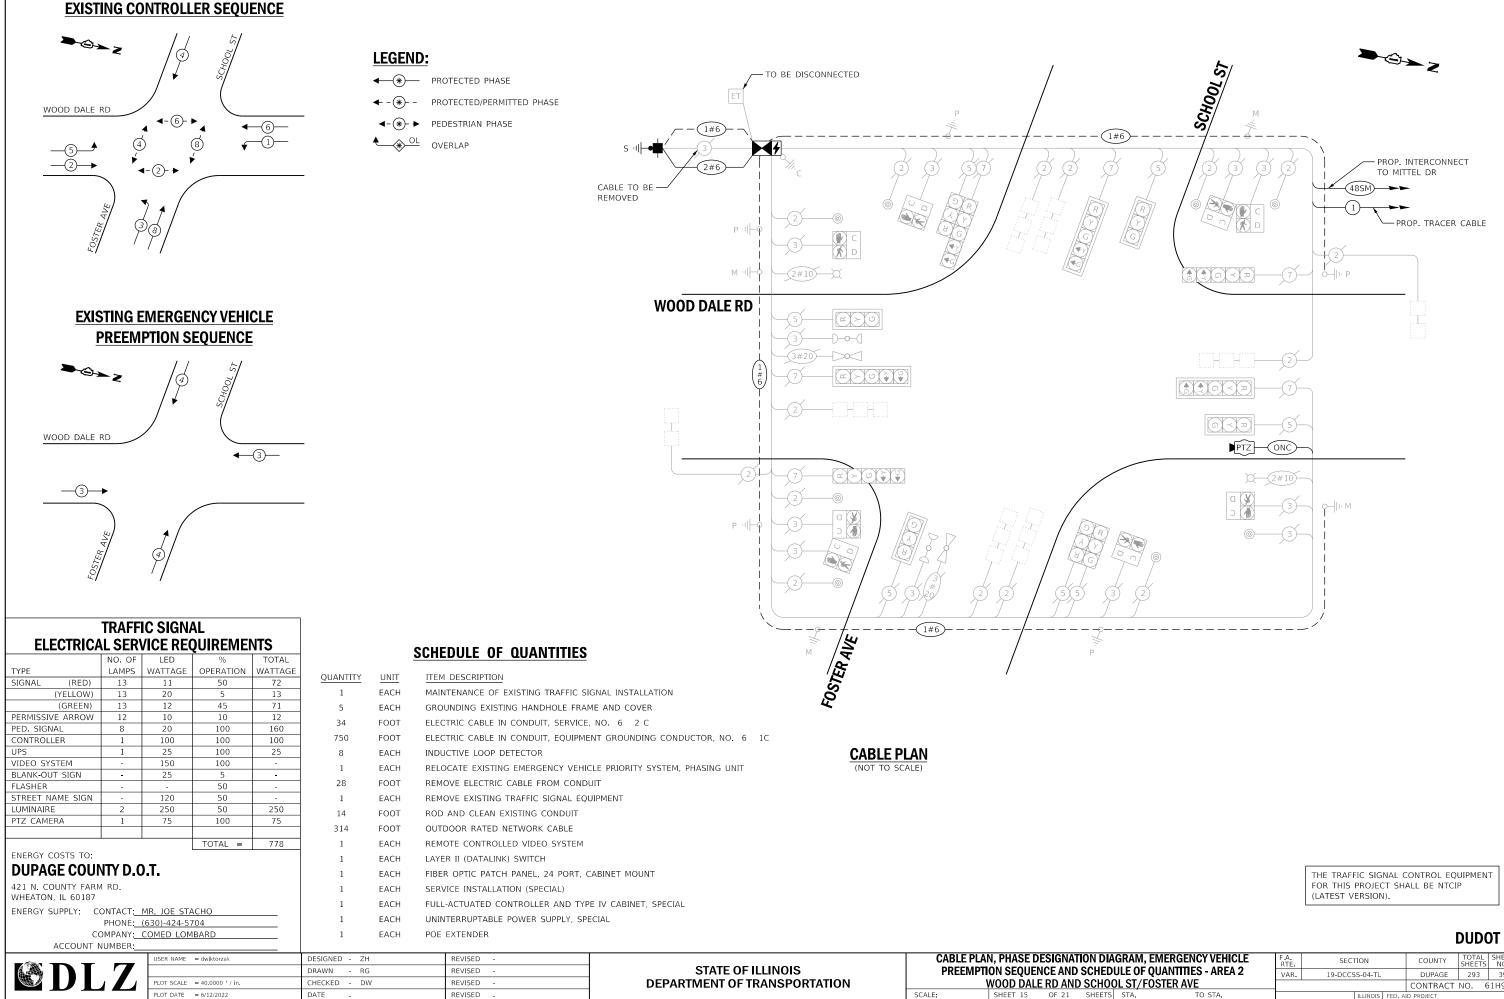

FILE NAME = X:Projects/2021/2182/217400 DuPage DOT Central/CADD_Sheets/sht-2D-Wooddale-ts-Cable.dgn Int 75


PLOT DATE = 6/12/2022

DATE

REVISED

HAGRAM, EMERGENCY VEHICLE		F.A. SECTION		COUNTY	TOTAL SHEETS	SHEET NO.	
EDULE OF QUANTITIES - AREA 2		19-DCCSS-04-TL		DUPAGE	293	39	
OOL ST/FOSTER AVE					CONTRACT	NO. 6	1H96
TS STA. TO STA.			ILLINOIS	FED. A	ID PROJECT		

SCALE:

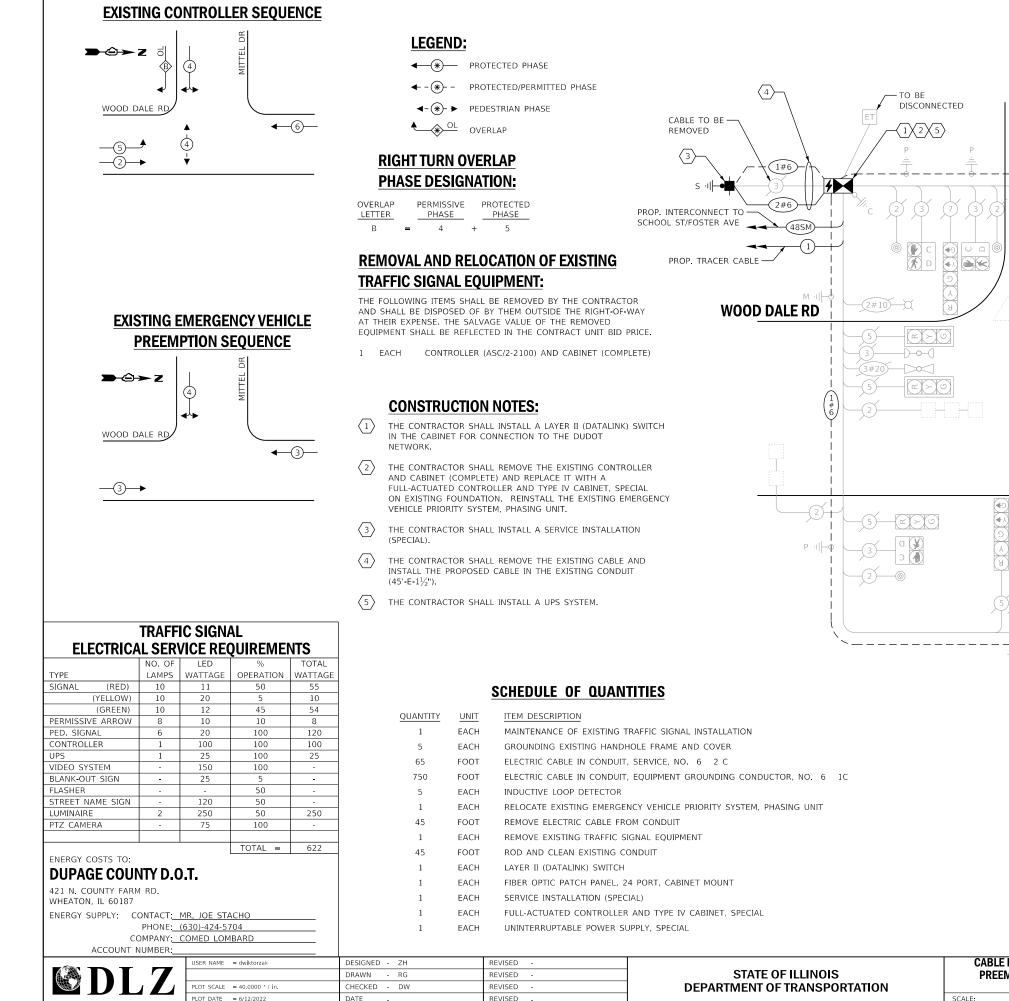

FILE NAME = X:Projects/2021/2182/217400 DuPage DOT Central/CADD_Sheets/sht-2D-Wooddale-ts-Cable.dgn Int 76


(1#6)

(1#6)


CABLE PLAN

(NOT TO SCALE

≫€

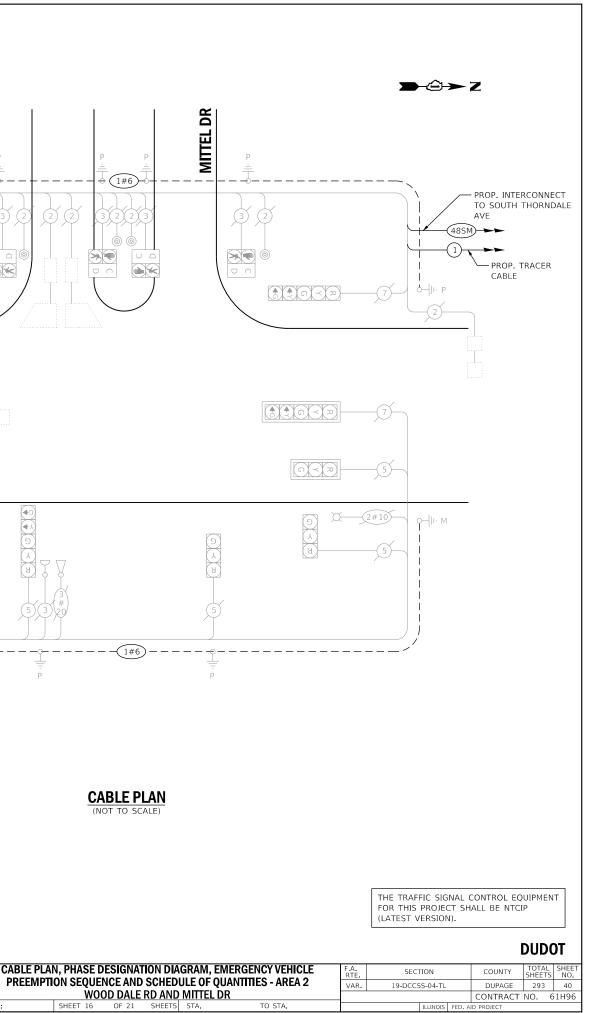


PREEMPTION SEQUENCE AND SCHEDULE OF QUANTITIES - AREA 2 WOOD DALE RD AND MITTEL DR SHEET 16 OF 21 SHEETS STA

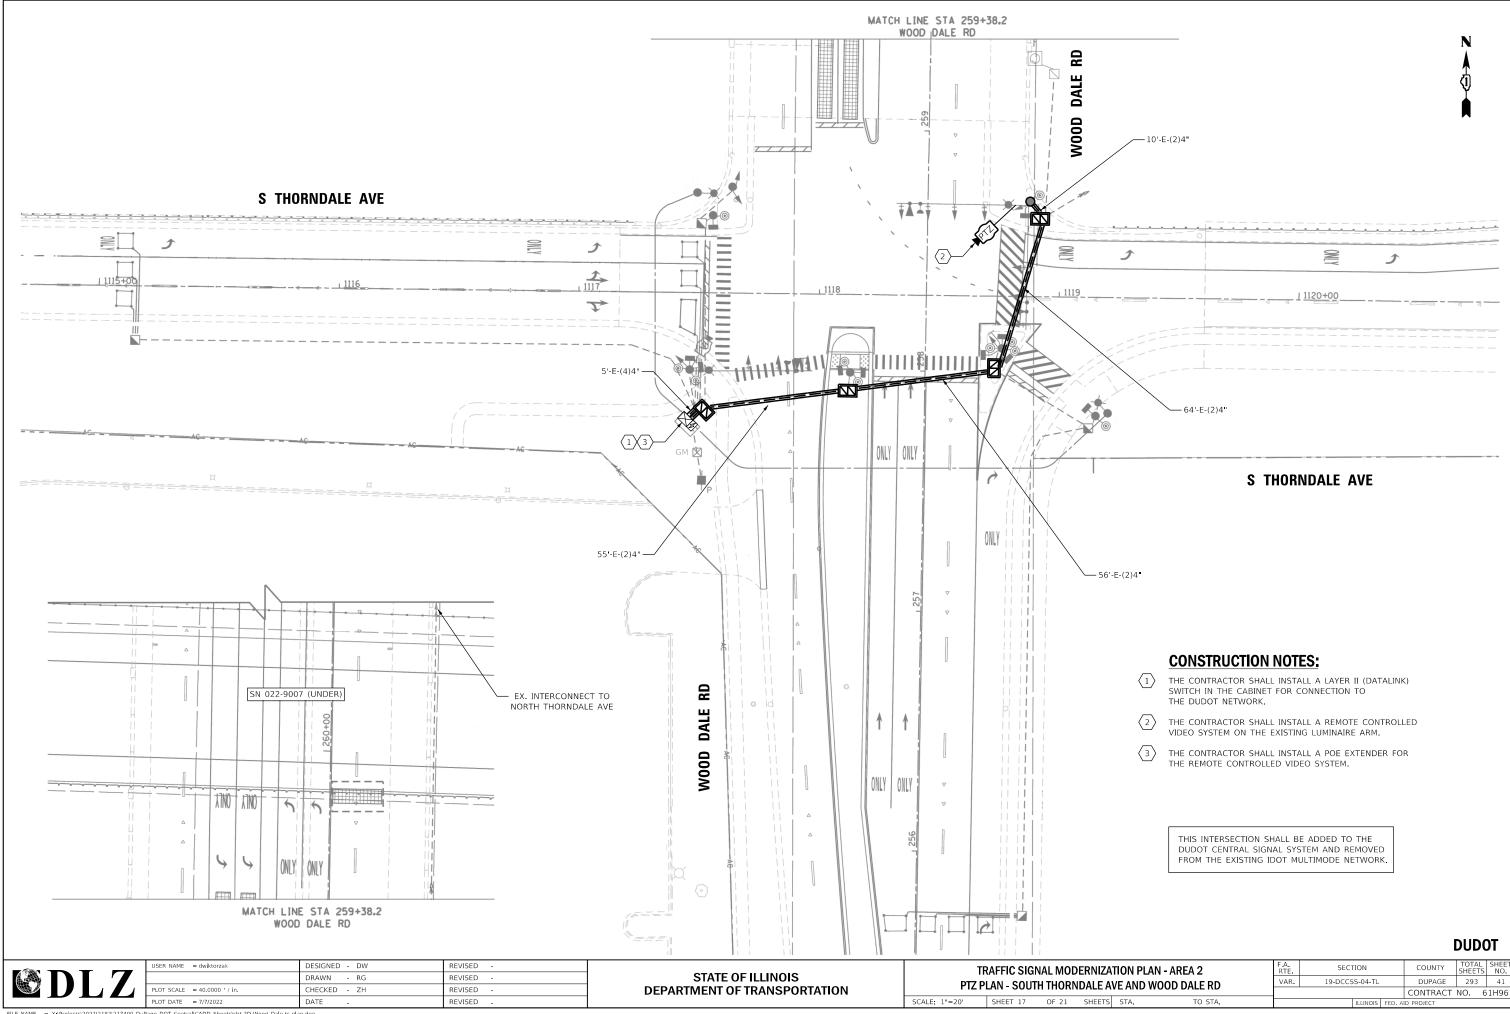

FILE NAME Int 74 X:\Projects\2021\2182\217400 DuPage DOT Central\CADD_Sheets\sht-2D-Wood Dale-ts-plan.dgn

ZATION PLAN - AREA 2 E AVE AND WOOD DALE RD		F.A. RTE			COUNTY	TOTAL SHEETS	SHEET NO.		
		VAR.	VAR. 19-DCCSS-04-TL			DUPAGE	293	41	
	AVE AND WOOD DALE RD		_				CONTRACT	NO. 6	51H96
TS	STA.	TO STA.			ILLINOIS	FED. A	ID PROJECT		

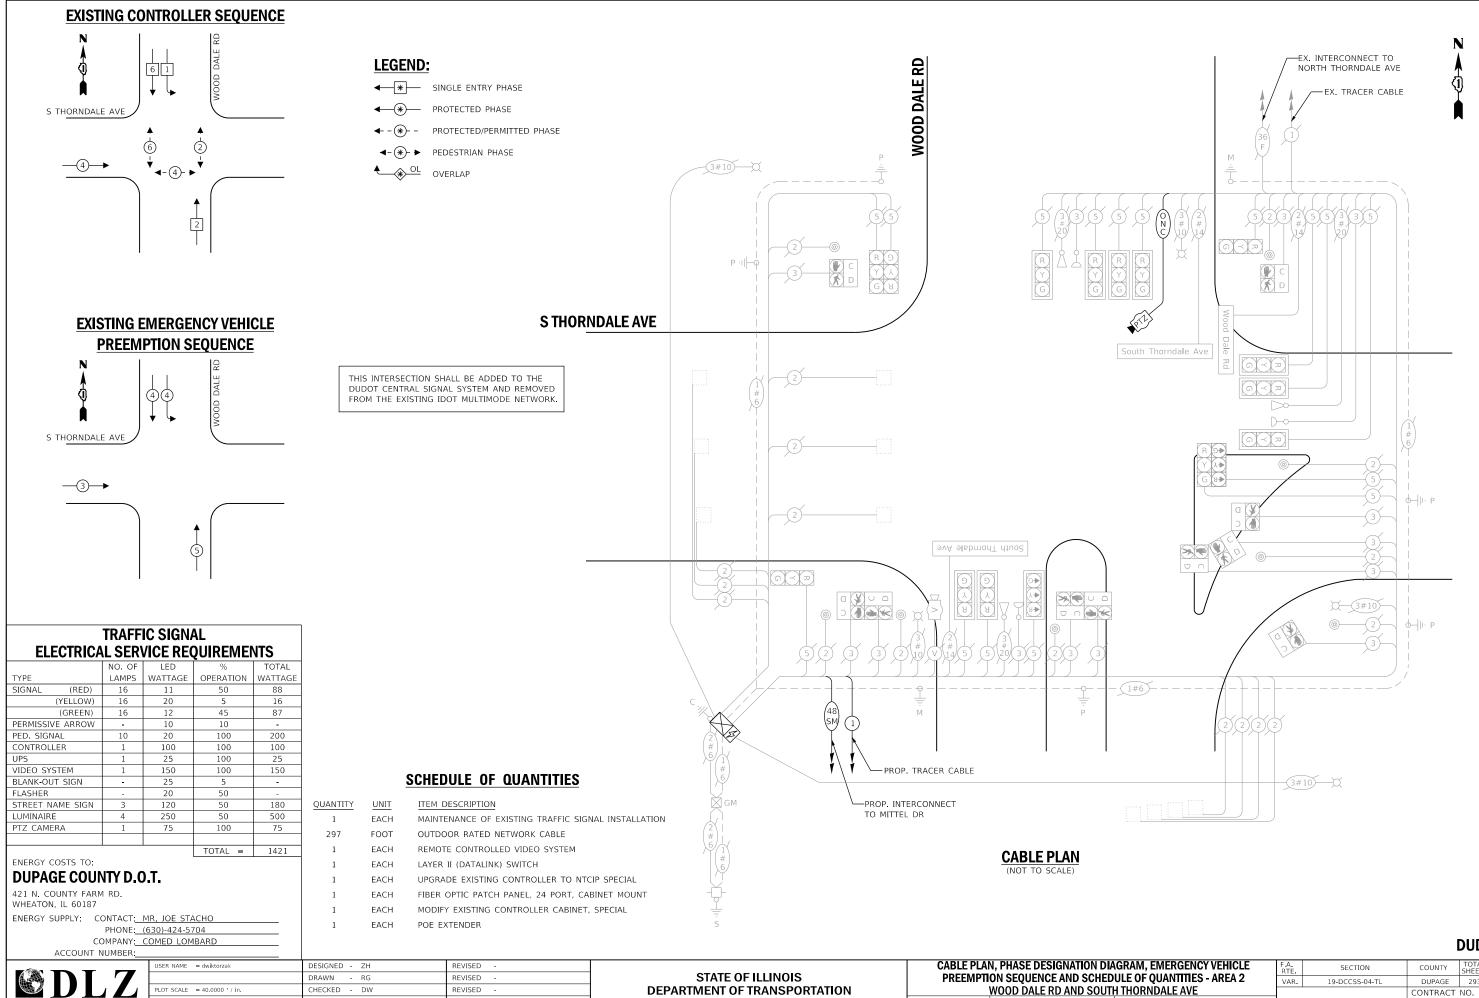

FILE NAME = X:Projects/2021/2182/217400 DuPage DOT Central/CADD_Sheets/sht-2D-Wooddale-ts-Cable.dgn Int 74

PLOT DATE = 6/12/2022

DATE


REVISED


SHEE

									,
	- ,	AERGENCY VEHICLE	F.A. RTE	SEC	FION		COUNTY	TOTAL SHEETS	SHEET NO.
DULE OF QUANTITIES - AREA 2		VAR.	19-DCCS	5S-04-TL		DUPAGE	293	42	
Tŀ	<u>i Thornd</u>	ALE AVE					CONTRACT	NO. 6	51H96
٢S	STA.	TO STA.			ILLINOIS	FED. A	ID PROJECT		


DUDOT

SCALE: SHEET 18 OF 21

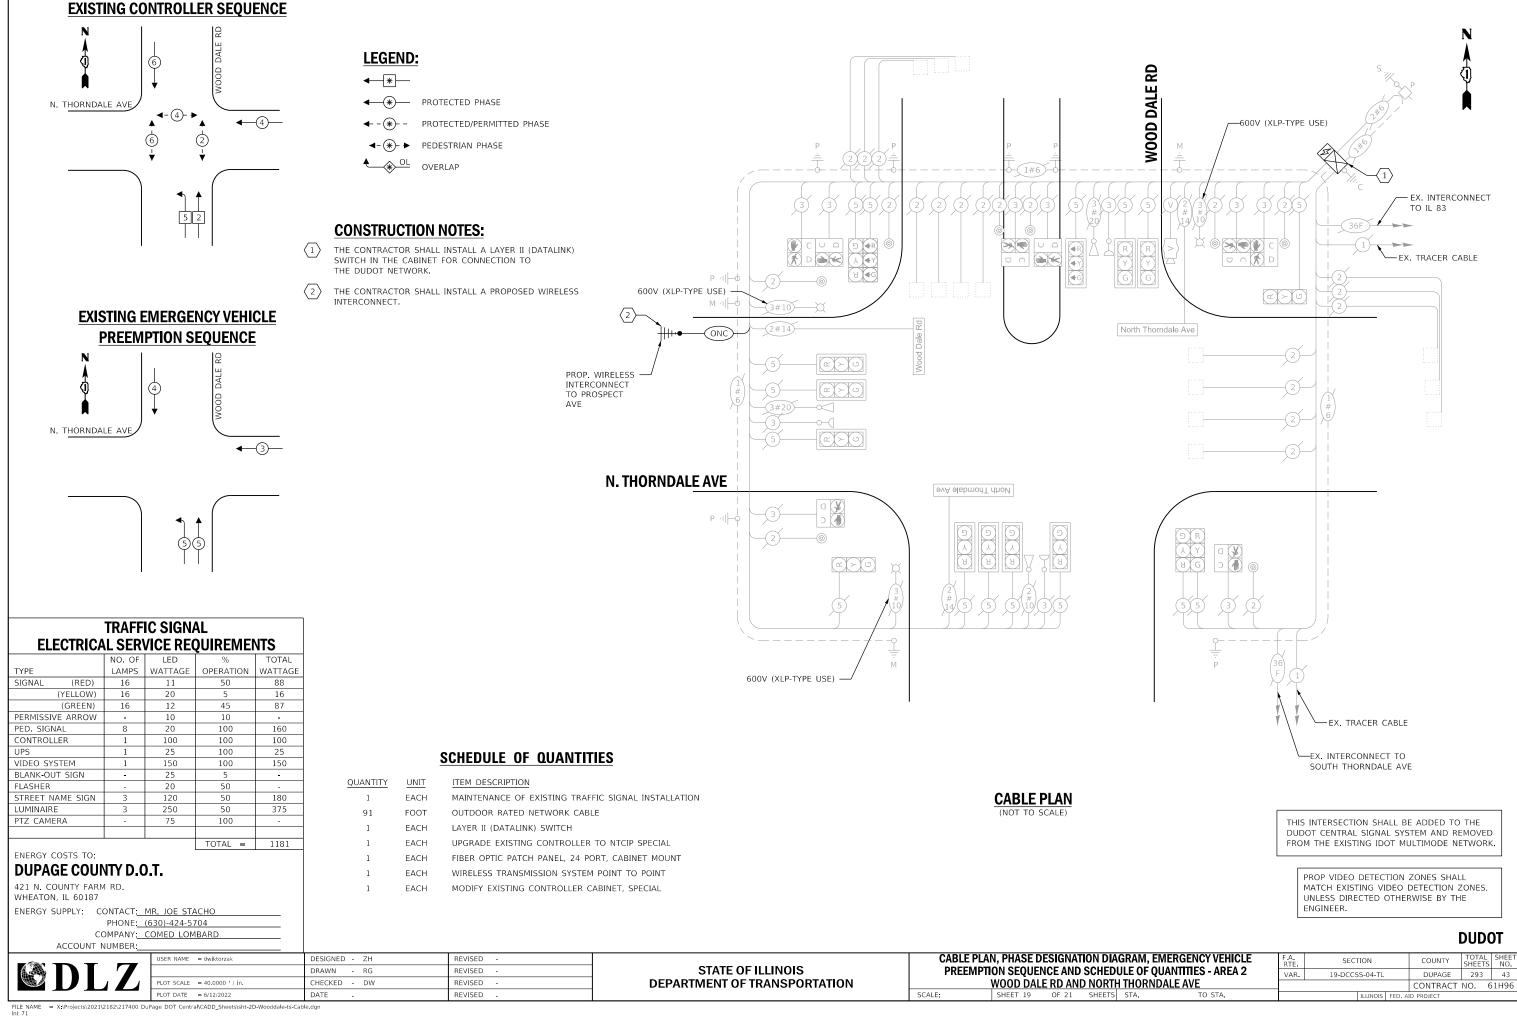


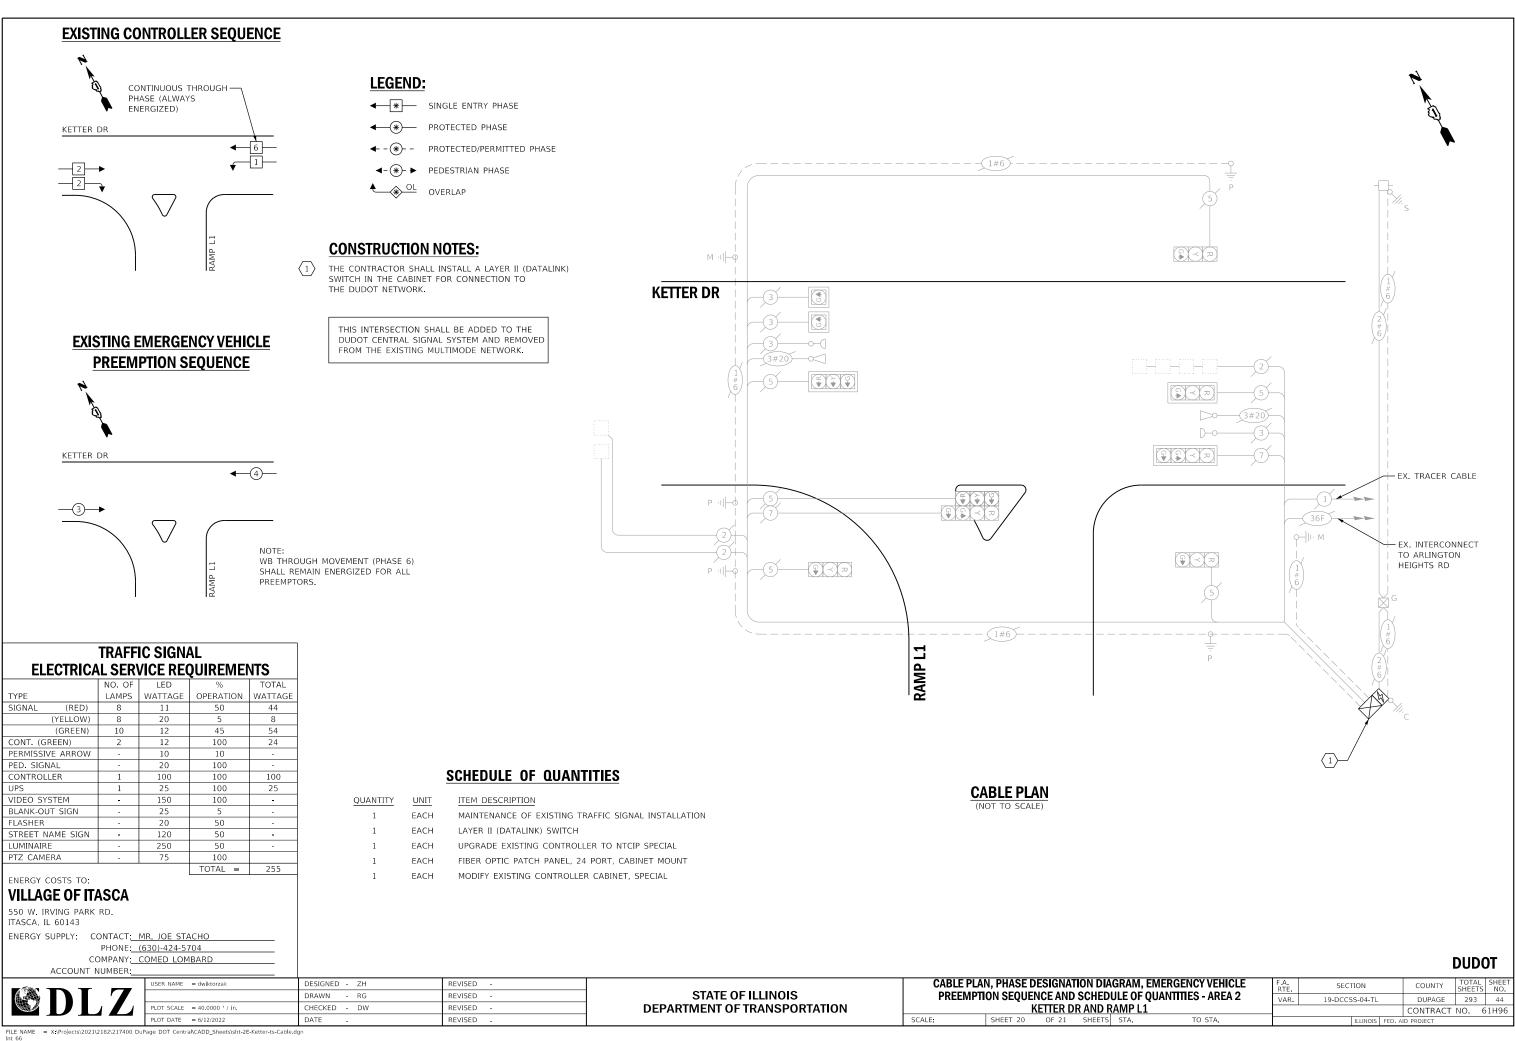


LE NAME = X \Projects\2021\21	82\217400 DuPage DOT Central\C	\DD_Sheets\sht-2E-Ketter-ts-Cable d	an

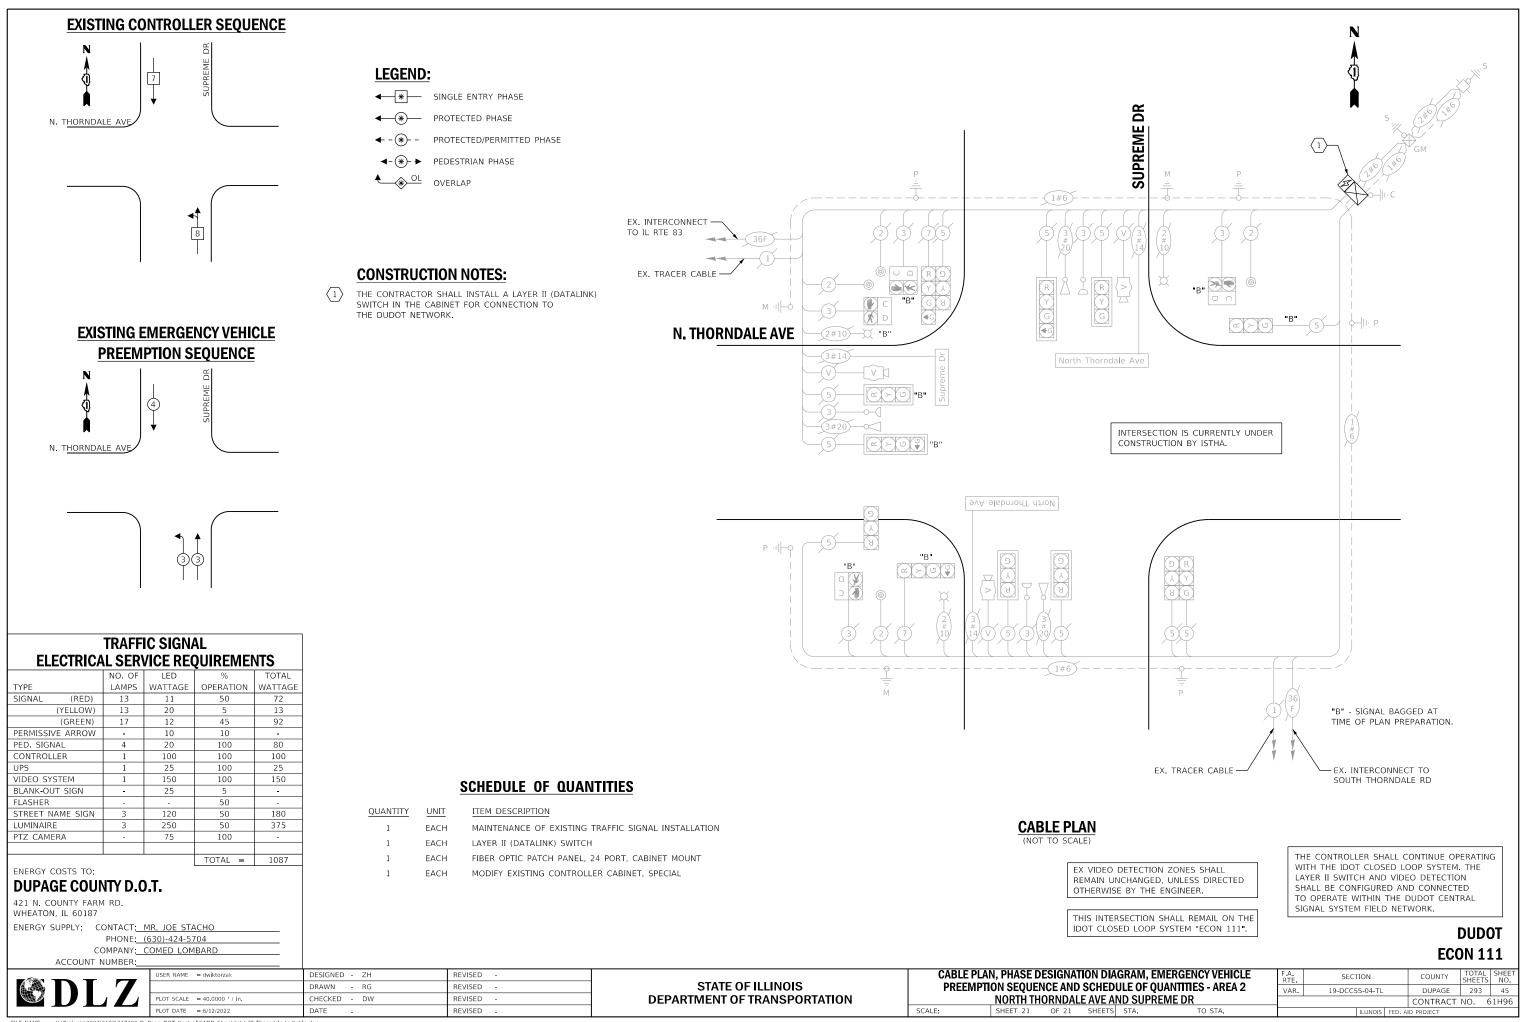


FILE NAME = X Projects 2021/2182 217400 DuPage DOT Central CADD Sheets sht-2F-Thorndale-ts-Cable.dgn Int 70

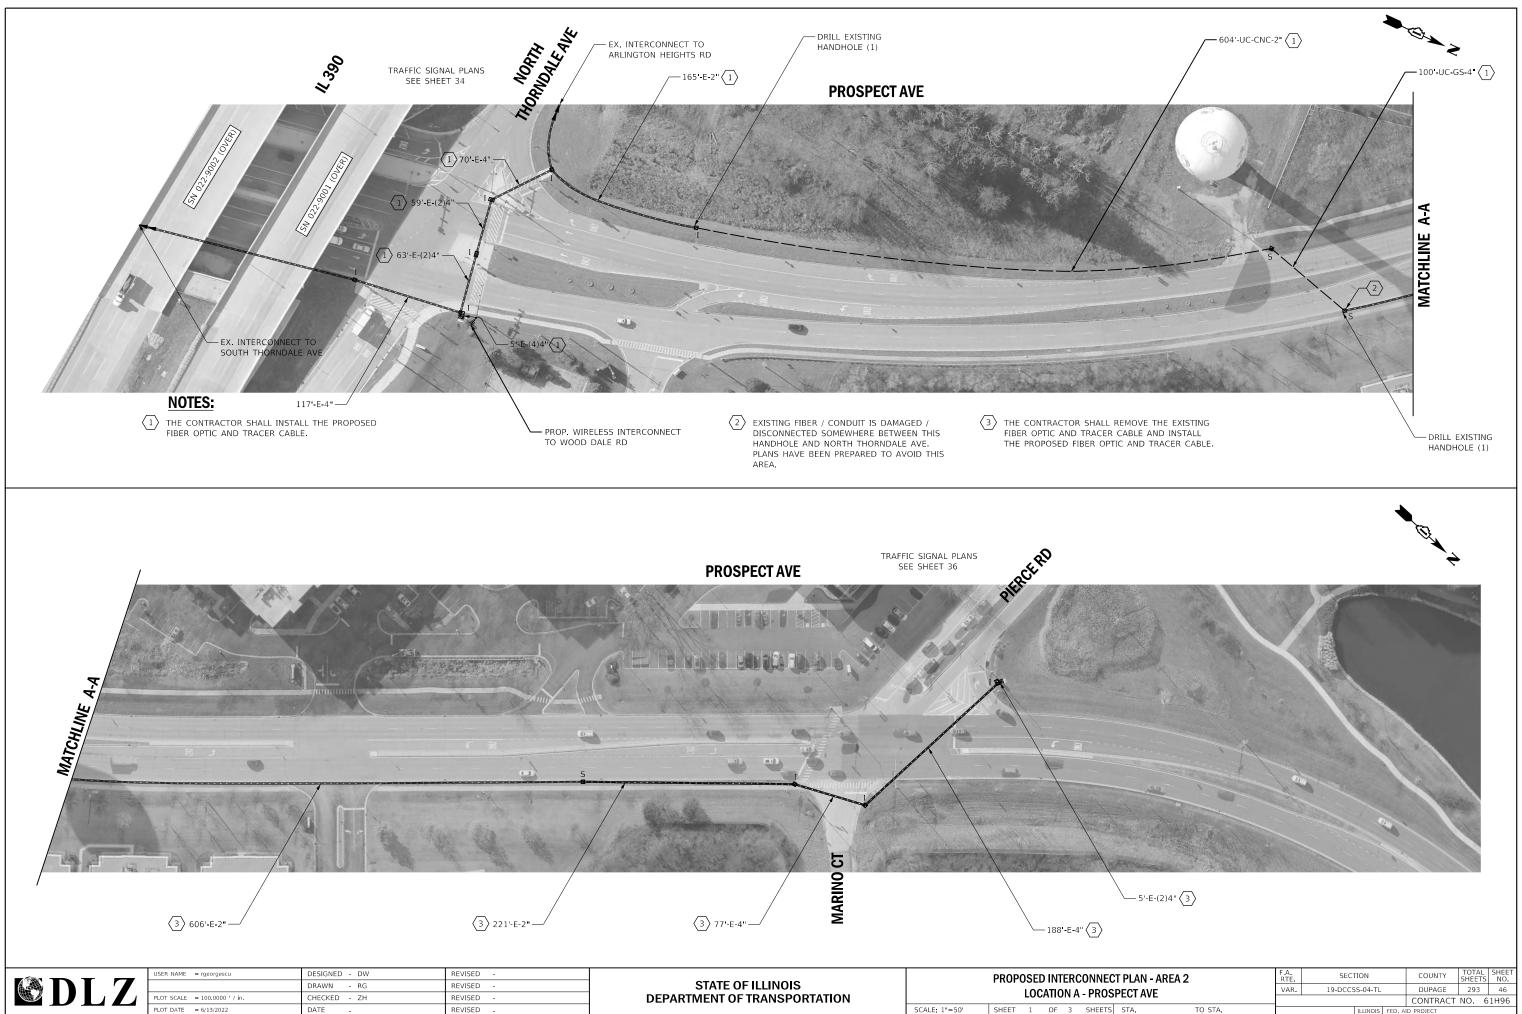


X:\Projects\2021\2182\217400 DuPage DOT Central\CADD_Sheets\sht-Int-A2-Prosp

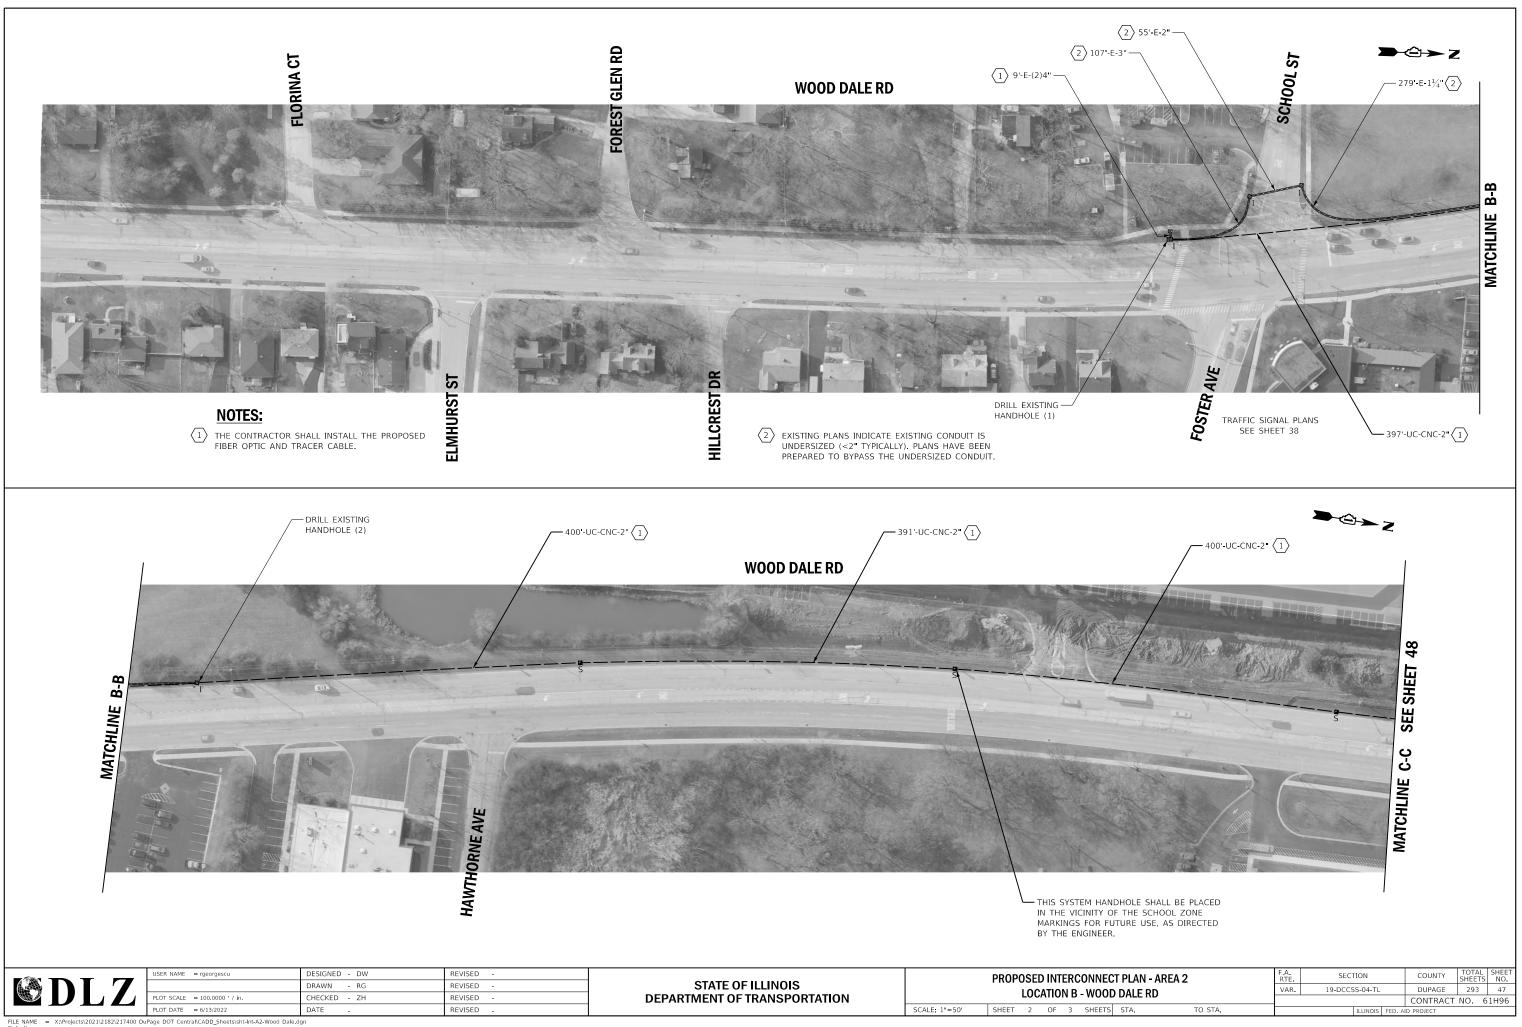

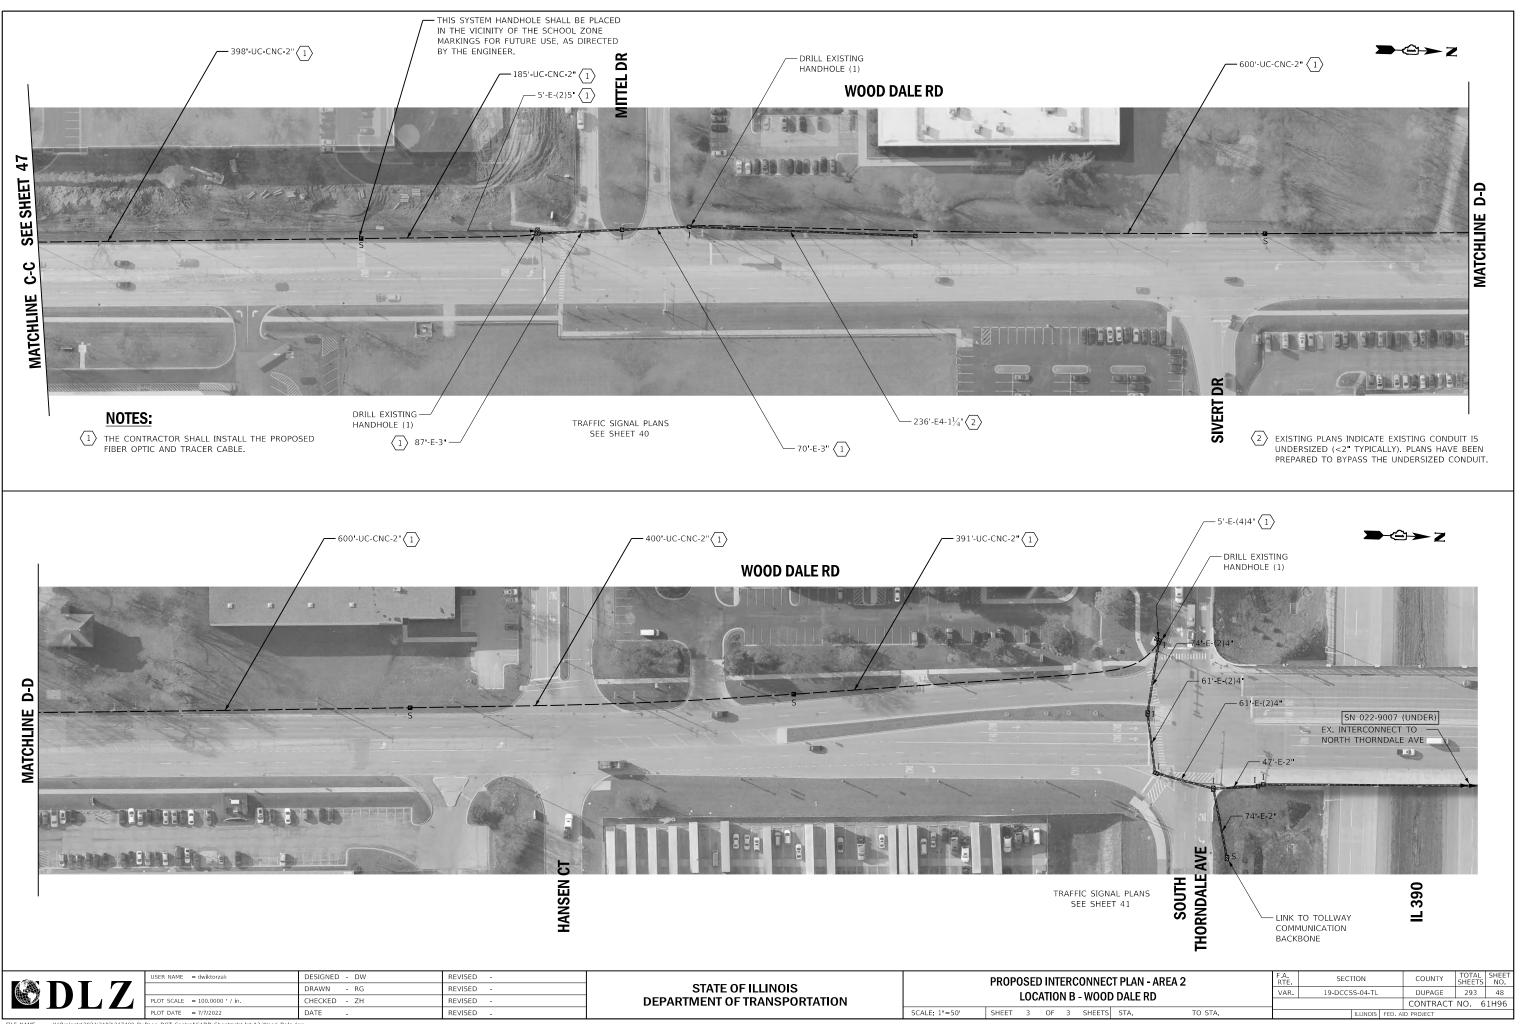

FILE NAME Default = X:\Projects\2021\2182\217400 DuPage DOT Central\CADD_Sheets\sht-Int-A2-Wood Dale.dgn

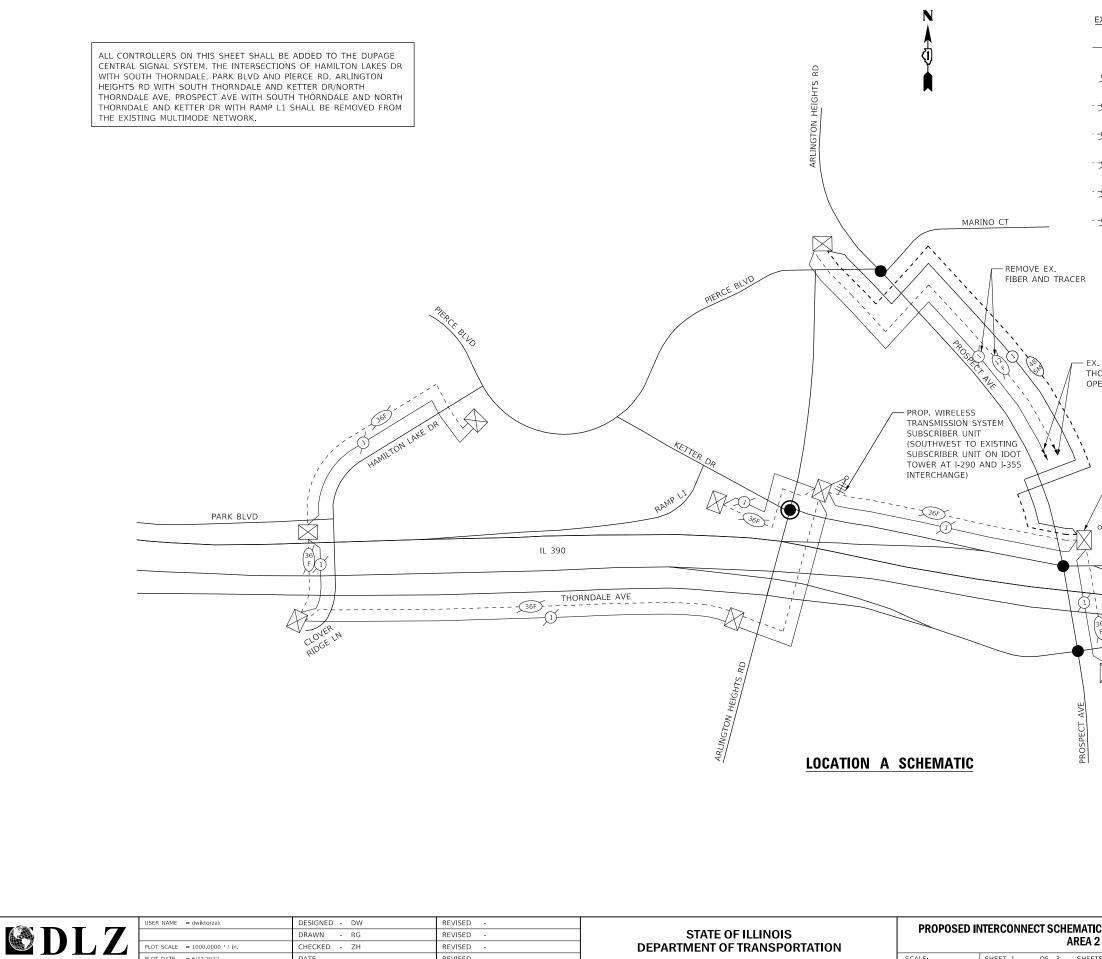

FILE NAME	= X \Projects\2021\2182\217400 DuPage DOT Central\CADD Sheets\sht-int-schematic-Area 2 dgn
Dofault	

LOT SCALE = 1000.0000 ' / in.

PLOT DATE = 6/12/2022

CHECKED - ZH

DATE

REVISED

REVISED

LEGEND

HORNDALE (NOT CURRENTLY PERATIONAL) EX. MASTER CONTROLLER (TO BE REMOVED) PROP. WIRELESS INTERCONNECT TO WOOD DALE RD IL 390			LLGLIND	
128 - 128 - 128 - 128 - 188 FIBER OPTIC CABLE, NO. 62.5/125 MM12F SM12F - 149 - 1249 - 188 OPTIC CABLE, NO. 62.5/125 MM12F SM12F - 149 - 149 - 198 OPTIC CABLE, NO. 62.5/125 MM12F SM12F - 149 - 149 - 198 OPTIC CABLE, NO. 62.5/125 MM12F SM12F - 149 - 149 - 198 OPTIC CABLE, NO. 62.5/125 MM12F SM12F - 149 - 149 - 149 - 198 OPTIC CABLE, NO. 62.5/125 MM12F SM24F - 1490 - 1490 - 198 OPTIC CABLE, 24 SINGLE MODE - 1490 - 1480 - 198 OPTIC CABLE, 36 SINGLE MODE - 1980 - 198 OPTIC CABLE, 36 SINGLE MODE - 1980 - 198 OPTIC CABLE, 36 SINGLE MODE - 1980 - 198 OPTIC CABLE, 36 SINGLE MODE - 1980 - 198 OPTIC CABLE, 36 SINGLE MODE - 1980 - 198 OPTIC CABLE, 36 SINGLE MODE - 1980 - 198 OPTIC CABLE, 36 SINGLE MODE - 1980 - 198 OPTIC CABLE, 36 SINGLE MODE - 1980 - 198 OPTIC CABLE, 36 SINGLE MODE - 1990 - 198 INTERCONNECT - 1990 - 199 INTERCONNECT - 1990 - 199 INTERCONNECT <td< td=""><td>EXISTING</td><td>PROPOSED</td><td></td><td></td></td<>	EXISTING	PROPOSED		
141 - (241) FIBER OPTIC CABLE, NO. 62.5/125 MM12F SM12F 150 - (351) - (351) FIBER OPTIC CABLE, NO. 62.5/125 MM12F SM24F 150 - (351) - (351) FIBER OPTIC CABLE, 24 SINGLE MODE 1505 - (4350) - (1650) FIBER OPTIC CABLE, 36 SINGLE MODE 1505 - (3550) - (3550) FIBER OPTIC CABLE, 36 SINGLE MODE 1505 - (3550) - (3550) FIBER OPTIC CABLE, 36 SINGLE MODE 1505 - (3550) - (3550) FIBER OPTIC CABLE, 36 SINGLE MODE 1505 - (3550) - (3550) FIBER OPTIC CABLE, 36 SINGLE MODE 1505 - (3550) - (3550) FIBER OPTIC CABLE, 36 SINGLE MODE 1505 - (3550) - (3550) FIBER OPTIC CABLE, 36 SINGLE MODE 1505 - (3550) - (3550) FIBER OPTIC CABLE, 36 SINGLE MODE 1607 - (1000) - (1000) - (1000) - (1000) 1700000 - (1000) - (1000) - (1000) - (1000) 1800 - (1000) - (1000) - (1000) - (1000) 1800 - (1000) - (1000) - (1000) - (1000) <tr< td=""><td></td><td></td><td>ELECTRIC CABLE IN CONDUIT, TRACER NO.</td><td>14 1/C</td></tr<>			ELECTRIC CABLE IN CONDUIT, TRACER NO.	14 1/C
GEF - GEF FIBER OPTIC CABLE, NO. 62.5/125 MM12F SM24F - GESF - GESF - GESF FIBER OPTIC CABLE, 24 SINGLE MODE - GESF - GESF - GESF FIBER OPTIC CABLE, 36 SINGLE MODE - GESF - GESF - GESF FIBER OPTIC CABLE, 36 SINGLE MODE - GESF - GESF - GESF FIBER OPTIC CABLE, 36 SINGLE MODE - GESF - GESF - GESF FIBER OPTIC CABLE, 36 SINGLE MODE - GESF - GESF - GESF FIBER OPTIC CABLE, 36 SINGLE MODE - GESF - GESF - GESF FIBER OPTIC CABLE, 36 SINGLE MODE - GESF - GESF - GESF FIBER OPTIC CABLE, 36 SINGLE MODE - GESF - GESF - GUTSIDE PROJECT LIMITS - OUTSIDE PROJECT TO NORTH - GESF - GUTSIDE PROJECT LIMITS - FEX. MASTER CONTROLLER - FROP. WIRELESS INTERCONNECT - TO WOOD DALE RD - GUTSIDE PROP. WIRELESS INTERCONNECT - GUTSIDE REMOVED - GUTSIDE RD - GUTSIDE RD - GUTSIDE RD - GUTSIDE RD - GUTSIDE RD	12F	· - 12F- ·	FIBER OPTIC CABLE, NO. 62.5/125 MM12F	
- (150) - (150) FIBER OPTIC CABLE, 24 SINGLE MODE - (150) - (150) FIBER OPTIC CABLE, 36 SINGLE MODE - (150) - (150) FIBER OPTIC CABLE, 36 SINGLE MODE - (150) - (150) FIBER OPTIC CABLE, 36 SINGLE MODE - (150) - (150) · - 24F - ·	FIBER OPTIC CABLE, NO. 62.5/125 MM12F	SM12F
Image: State of the state	- <u>36</u> F)-	· - 36F- ·	FIBER OPTIC CABLE, NO. 62.5/125 MM12F	SM24F
FIBER OPTIC CABLE, 36 SINGLE MODE PAN, TILT, ZOOM (PTZ) CAMERA OUTSIDE PROJECT LIMITS LAYER III SWITCH AN INTERCONNECT TO NORTH HORNDALE (NOT CURRENTLY PERATIONAL) EX. MASTER CONTROLLER (TO BE REMOVED) PROP. WIRELESS INTERCONNECT TO WOOD DALE RD IL 390	- <u>245M</u> -	245M	FIBER OPTIC CABLE, 24 SINGLE MODE	
PAN, TILT, ZOOM (PTZ) CAMERA OUTSIDE PROJECT LIMITS LAYER III SWITCH	-48SM- 4	(485M)- 1	FIBER OPTIC CABLE, 48 SINGLE MODE	
UTSIDE PROJECT LIMITS	- <u>365M</u> - 1	<u>365M</u>	FIBER OPTIC CABLE, 36 SINGLE MODE	
LAYER III SWITCH	\bigcirc	•	PAN, TILT, ZOOM (PTZ) CAMERA	
X. INTERCONNECT TO NORTH HORNDALE (NOT CURRENTLY PERATIONAL) EX. MASTER CONTROLLER (TO BE REMOVED) PROP. WIRELESS INTERCONNECT TO WOOD DALE RD IL 390			OUTSIDE PROJECT LIMITS	
HORNDALE (NOT CURRENTLY PERATIONAL) EX. MASTER CONTROLLER (TO BE REMOVED) PROP. WIRELESS INTERCONNECT TO WOOD DALE RD IL 390	\bigcirc	0	LAYER III SWITCH	
(F)	HORNDALE (NOT PERATIONAL)	CURRENTLY MASTER CONTROLLE BE REMOVED) - PROP. WIRELESS IN	TERCONNECT	CHLINE A - A
(F)	1			
				7W

C /	AND SC	HEDULE OF QUANTITIES	F.A. RTE	SECT	ΠΟΝ		COUNTY	TOTAL SHEETS	SHEET NO.
2		····· · · · · · · · · · · · · · · · ·	VAR.	19-DCCS	S-04-TL		DUPAGE	293	49
							CONTRACT	NO. 6	1H96
TS	STA.	TO STA.			ILLINOIS	FED. A	D PROJECT		

AREA 2 FIBER NOTES

THE CONTRACTOR SHALL BE RESPONSIBLE FOR PROVIDING FIBER SPLICES AND TERMINATIONS FOR ALL PROPOSED FIBER OPTIC CABLES AS SPECIFIED IN THE SPECIAL PROVISIONS FOR FIBER OPTIC CABLES.

TERMINATIONS FOR EXISTING FIBER OPTIC CABLES AND SPLICES BETWEEN EXISTING FIBER OFFIC CABLES SHALL BE PAID FOR SEPARATELY. FOR BIDDING PURPOSES AN ESTIMATED QUANTITY OF SPLICES AND TERMINATIONS HAS BEEN INCLUDED IN THE QUANTITIES.


THE ACTUAL NUMBER OF TERMINATIONS AND SPLICES AT EACH LOCATION SHALL BE BASED ON THE NETWORK CONFIGURATION DOCUMENT SUBMITTED BY THE CONTRACTOR AND APPROVED BY THE TRAFFIC ENGINEER. SEE THE SPECIAL PROVISION LAYER III SWITCH. SPLICES AND TERMINATIONS SHALL BE REALLOCATED BY THE ENGINEER, AS NEEDED, BETWEEN THE INTERCONNECT AREAS.

AREA 2 FIBER SPLICE AND TERMINATION SCHEDULE:

ITEM DESCRIPTION	INCLUDED IN FIBER OPTIC CABLE PAY ITEM	TO PAID FOR SEPARATELY
TERMINATE FIBER IN CABINET	42	198
SPLICE FIBER IN CABINET	24	54

SCHEDULE OF QUANTITIES

10	CU YD	NON-SPECIAL WASTE DISPOSAL
260	GALLON	SPECIAL WASTE GROUNDWATER DISPOSAL
1	EACH	SOIL DISPOSAL ANALYSIS
0.17	L SUM	REGULATED SUBSTANCES PRE-CONSTRUCTION PLAN
0.17	L SUM	REGULATED SUBSTANCES FINAL CONSTRUCTION REPORT
1	CAL DA	REGULATED SUBSTANCES MONITORING
100	FOOT	UNDERGROUND CONDUIT, GALVANIZED STEEL, 4" DIA.
4766	FOOT	UNDERGROUND CONDUIT, COILABLE NONMETALLIC CONDUIT, 2" DIA.
8	EACH	HANDHOLE
1	EACH	MAINTENANCE OF EXISTING TRAFFIC SIGNAL INSTALLATION
6750	FOOT	ELECTRIC CABLE IN CONDUIT, TRACER, NO. 14 1C
8	EACH	DRILL EXISTING HANDHOLE
1095	FOOT	REMOVE ELECTRIC CABLE FROM CONDUIT
825	FOOT	ROD AND CLEAN EXISTING CONDUIT
6820	FOOT	FIBER OPTIC CABLE 48 FIBERS, SINGLE MODE
1095	FOOT	REMOVE FIBER OPTIC CABLE FROM CONDUIT
198	EACH	TERMINATE FIBER IN CABINET
50	EACH	SPLICE FIBER IN CABINET
4	EACH	LAYER III FIBER OPTIC TRANSCEIVER MODULE, SFP TYPE, LONG DISTANCE

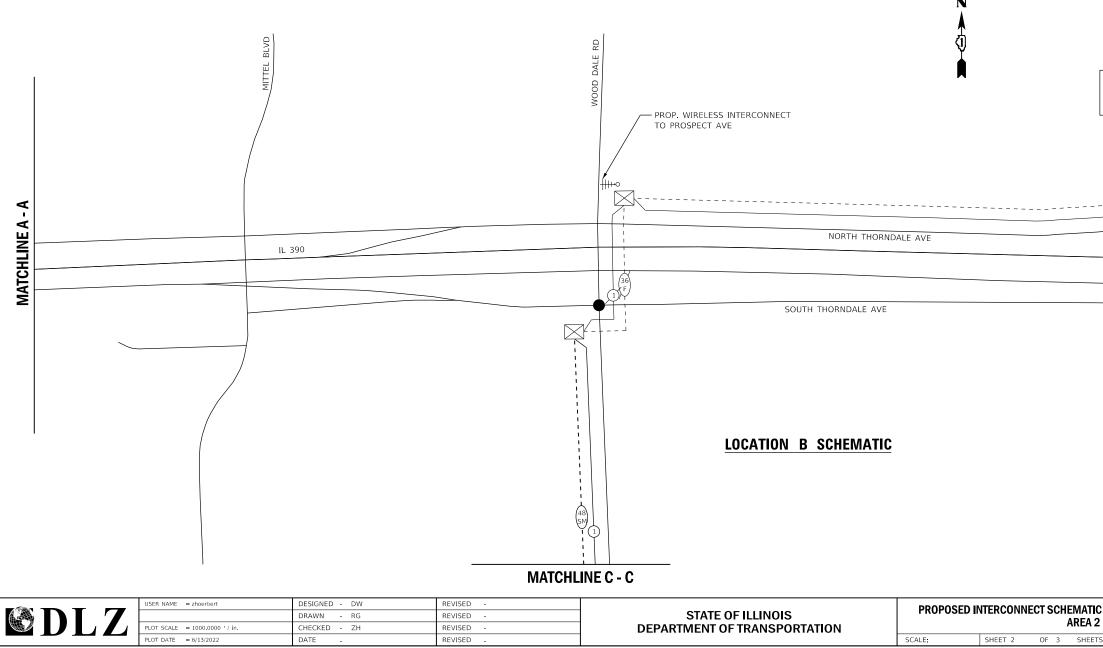

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LEGEND

EXISTING	PROPOSED	
1		ELECTRIC CABLE IN CONDUIT, TRACER NO. 14 1/C
12F	· - 12F- ·	FIBER OPTIC CABLE, NO. 62.5/125 MM12F
24F	· - 24F - ·	FIBER OPTIC CABLE, NO. 62.5/125 MM12F SM12F
- <u>- 36</u> F	· - 36F - ·	FIBER OPTIC CABLE, NO. 62.5/125 MM12F SM24F
(245M)- 1	(245M)- +	FIBER OPTIC CABLE, 24 SINGLE MODE
<u>(485M)</u>	(485M)	FIBER OPTIC CABLE, 48 SINGLE MODE
<u>365M</u> - 1	<u>365M</u>	FIBER OPTIC CABLE, 36 SINGLE MODE
\bigcirc	●	PAN, TILT, ZOOM (PTZ) CAMERA
		OUTSIDE PROJECT LIMITS
\bigcirc	0	LAYER III SWITCH

THE CONTROLLERS ON WOOD DALE RD AT SOUTH THORNDALE AVE AND NORTH THORNDALE AVE SHALL BE ADDED TO THE DUDOT CENTRAL SIGNAL SYSTEM AND REMOVED FROM THE IDOT MULTIMODE NETWORK.


B

MATCHLINE B -

IL 390

(36F)

C /	AND SCHEDULE OF OUANTITIES	F.A. RTE	SECT	FION		COUNTY	TOTAL SHEETS	SHEET NO.
2	···· · · · · · · · · · · · · · · · · ·	VAR.	19-DCCS	5S-04-TL		DUPAGE	293	50
_						CONTRACT	NO. 6	1H96
TS	STA. TO STA.			ILLINOIS	FED. A	D PROJECT		

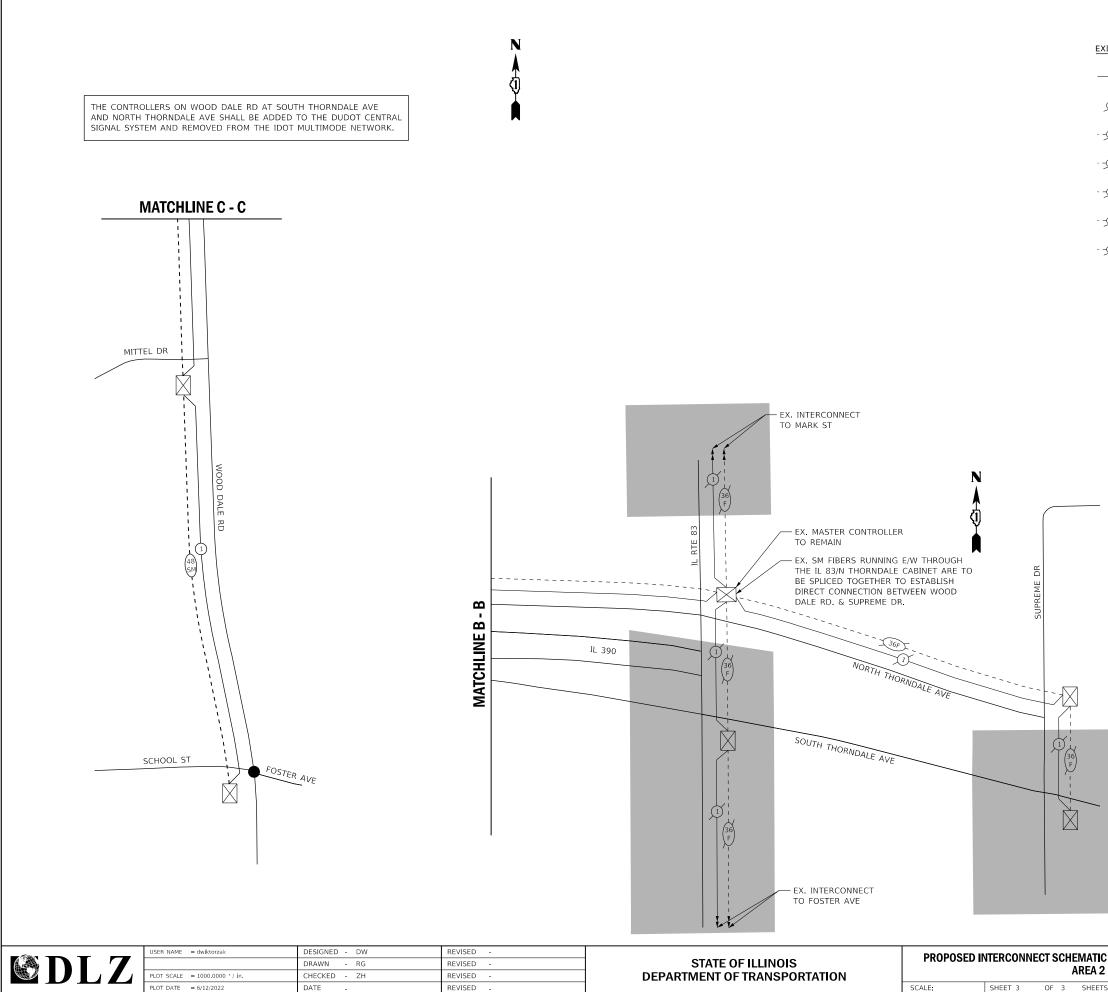

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LEGEND

XISTING	PROPOSED	
<u>(1</u>)		ELECTRIC CABLE IN CONDUIT, TRACER NO. 14 1/C
12F	· - 12F- ·	FIBER OPTIC CABLE, NO. 62.5/125 MM12F
	· - 24F - ·	FIBER OPTIC CABLE, NO. 62.5/125 MM12F SM12F
- <u>36</u> F)- ·	. <u>- 36F</u>	FIBER OPTIC CABLE, NO. 62.5/125 MM12F SM24F
-245M- 4	245M	FIBER OPTIC CABLE, 24 SINGLE MODE
-48SM	(485M)	FIBER OPTIC CABLE, 48 SINGLE MODE
- <u>365M</u> - 1	- <u>365M</u>	FIBER OPTIC CABLE, 36 SINGLE MODE
\bigcirc	ullet	PAN, TILT, ZOOM (PTZ) CAMERA
		OUTSIDE PROJECT LIMITS
\bigcirc	0	LAYER III SWITCH

THE CONTROLLER ON NORTH THORNDALE AVE AND AND SUPREME DR SHALL REMAIN ON THE IDOT MULTIMODE NETWORK UPON COMPLETION OF THE PROJECT. THE SWITCH AND VIDEO DETECTION SHALL BE CONFIGURED TO OPERATE WITHIN THE DUDOT CENTRAL SIGNAL SYSTEM USING ETHERNET AND SINGLEMODE FIBER.

C AND SCHEDULE OF QUANTITIES			F.A. RTE	SECTION			COUNTY	TOTAL SHEETS	SHEET NO.
			VAR.	VAR. 19-DCCSS-04-TL			DUPAGE	293	51
_							CONTRACT	NO. 6	1H96
TS	STA.	TO STA.			ILLINOIS	FED. AI	ID PROJECT		



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<u>#</u>	LOCATION	SHEETS
117	COUNTY FARM RD AND ST CHARLES RD	54
120	COUNTY FARM RD AND IL RTE 64	55
43	JEWELL RD AND PLEASANT HILL RD	56
42	JEWELL RD AND GARY AVE	57

LOCATIO (A)COUNTY В JEWELL

MADI 7	USER NAME = rgeorgescu	DESIGNED - DW	REVISED -			TRAFFIC SIGNAL MODERNIZATION PLAN - AREA 3	F.A. BTE	SECTION	COUNTY TOTAL SHEET
		DRAWN - RG	REVISED -	STATE OF ILLINOIS		AREA 3 LOCATION MAP	VAR.	19-DCCSS-04-TL	DUPAGE 293 52
	PLOT SCALE = 2000.0000 / in.	CHECKED - ZH	REVISED -	DEPARTMENT OF TRANSPORTATION		AREA 3 LUCATION MAP			CONTRACT NO. 61H96
	PLOT DATE = 6/13/2022	DATE -	REVISED -		SCALE:	SHEET 1 OF 1 SHEETS STA. TO STA.		ILLINOIS FEE	D. AID PROJECT
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PROPOSED INTERCONNECT AREA - SEE INTERCONNECT PLANS PROPOSED SIGNAL IMPROVEMENT CORRIDOR PROPOSED SIGNAL IMPROVEMENT LOCATION

FION PLANS

INTERCONNECT PLANS


ION	<u>SHEETS</u>
TY FARM RD	58
L RD	59 - 60


AREA 3 SIGNAL IMPROVEMENTS

				COUNT	Y FAR№	IJEWE	LL RC
		RD AND A		ND .			
PAY ITEM NO.	PAY ITEM DESCRIPTION	UNIT	TOTAL	ST CHARLES RD	IL RTE 64	PLEASANT HILL RD	gary ave
85000200	MAINTENANCE OF EXISTING TRAFFIC SIGNAL INSTALLATION	EACH	4	1	1	1	1
87301805	ELECTRIC CABLE IN CONDUIT, SERVICE, NO. 6 2 C	FOOT	34	34			
87301900	ELECTRIC CABLE IN CONDUIT, EQUIPMENT GROUNDING CONDUCTOR, NO. 6 1C	FOOT	34	34			
89502300	REMOVE ELECTRIC CABLE FROM CONDUIT	FOOT	14	14			
89502375	REMOVE EXISTING TRAFFIC SIGNAL EQUIPMENT	EACH	1	1			
X0324599	ROD AND CLEAN EXISTING CONDUIT	FOOT	14	14			
X1400303	FIBER OPTIC PATCH PANEL, 24 PORT, CABINET MOUNT	EACH	1	1			
X8050095	SERVICE INSTALLATION (SPECIAL)	EACH	1	1			
X8620200	UNINTERRUPTABLE POWER SUPPLY, SPECIAL	EACH	1	1			
X8950212	MODIFY EXISTING CONTROLLER CABINET, SPECIAL	EACH	1	1			
Z0033046	RE-OPTIMIZE TRAFFIC SIGNAL SYSTEM LEVEL 2	EACH	1	1			

	USER NAME = zhoerbert	DESIGNED -	REVISED -			SCHEDIII E OF QUANTITIES				SECTION	COUNTY TOTAL SHEET SHEETS NO.
		DRAWN -	REVISED -	STATE OF ILLINOIS	SCHEDULE OF QUANTITIES				VAR.	19-DCCSS-04-TL	DUPAGE 293 53
	PLOT SCALE = 100.0000 / in.	CHECKED -	REVISED -	DEPARTMENT OF TRANSPORTATION							CONTRACT NO. 61H96
	PLOT DATE = 6/13/2022	DATE -	REVISED -		SCALE:	SHEET 1 OF 1 SHEETS	STA.	TO STA.		ILLINOIS FED	AID PROJECT
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<u>QUANTITY</u>	UNIT	ITEM DESCRIPTION	
1	EACH	MAINTENANCE OF EXISTING TRAFFIC SIGNAL INSTALLATION	
34	FOOT	ELECTRIC CABLE IN CONDUIT, SERVICE, NO. 6 2 C	
34	FOOT	electric cable in conduit, equipment grounding conductor, no. 6 1c CABLE PLAN	
14	FOOT	REMOVE ELECTRIC CABLE FROM CONDUIT (NOT TO SCALE)	
1	EACH	REMOVE EXISTING TRAFFIC SIGNAL EQUIPMENT	
14	FOOT	ROD AND CLEAN EXISTING CONDUIT	
1	EACH	FIBER OPTIC PATCH PANEL, 24 PORT, CABINET MOUNT	
1	EACH	SERVICE INSTALLATION (SPECIAL)	
1	EACH	UNINTERRUPTABLE POWER SUPPLY, SPECIAL	
1	EACH	MODIFY EXISTING CONTROLLER CABINET, SPECIAL	
1	EACH	RE-OPTIMIZE TRAFFIC SIGNAL SYSTEM LEVEL 2	


	ACCOUNT NUMBER:							
		USER NAME = dwiktorzak	DESIGNED - ZH	REVISED -		CABLE PLAN, PHASE DESIGNATION DIAGRAM, EMERGENCY VEHICLE	F.A. SECTION	COUNTY TOTAL SHEET
		DRAWN - RG	REVISED -	STATE OF ILLINOIS	PREEMPTION SEQUENCE AND SCHEDULE OF QUANTITIES - AREA 3	VAR. 19-DCCSS-04-TL	DUPAGE 293 54	
		PLOT SCALE = 40.0000 ' / in.	CHECKED - DW	REVISED -	DEPARTMENT OF TRANSPORTATION	COUNTY FARM RD AND ST CHARLES RD		CONTRACT NO. 61H96
L		PLOT DATE = 6/12/2022	DATE -	REVISED -		SCALE. SHEET 1 OF 4 SHEETS STA. TO STA.	ILLINOIS F	ED. AID PROJECT
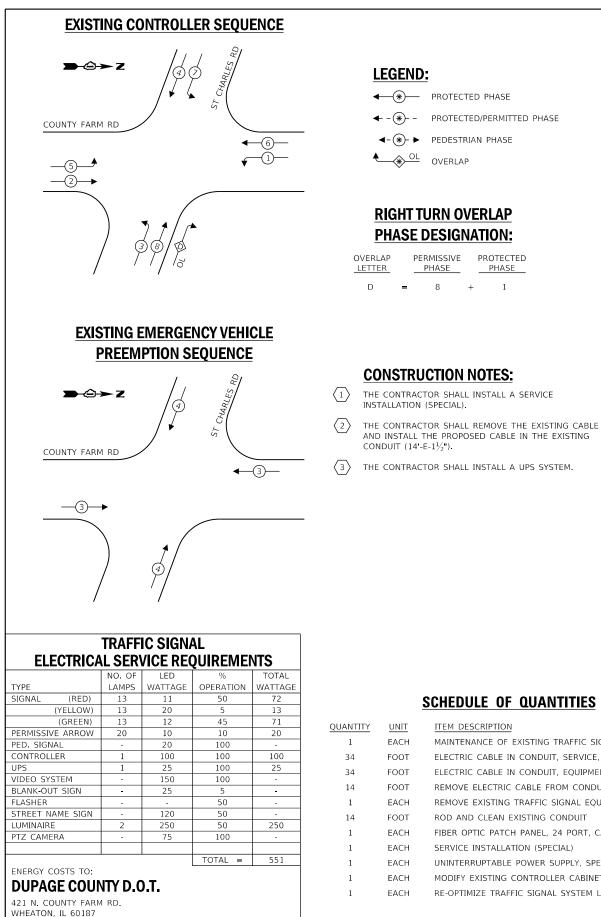
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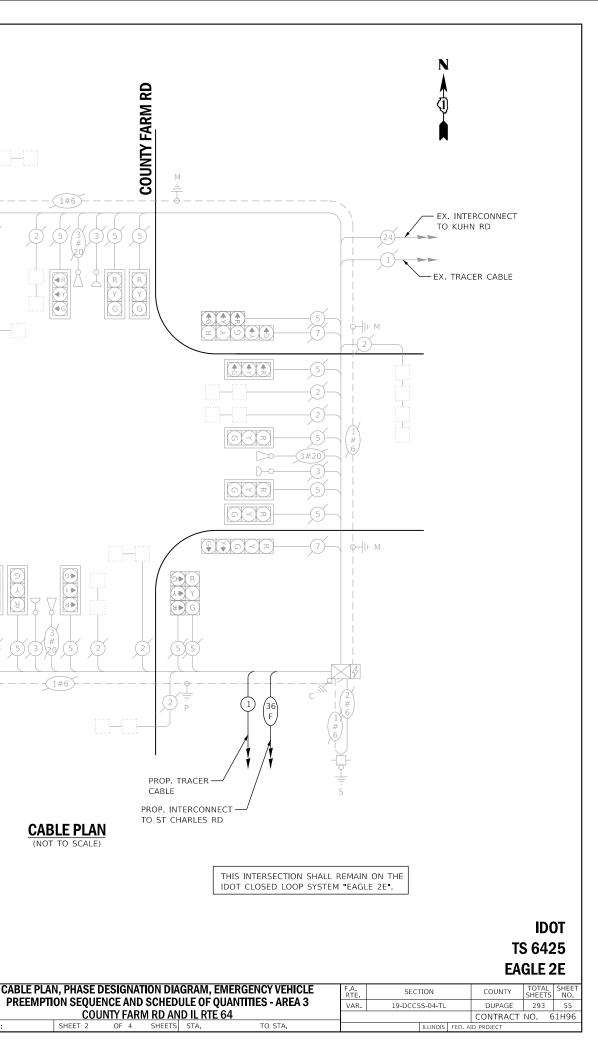
PHONE: (630)-424-5704 COMPANY: COMED LOMBARD

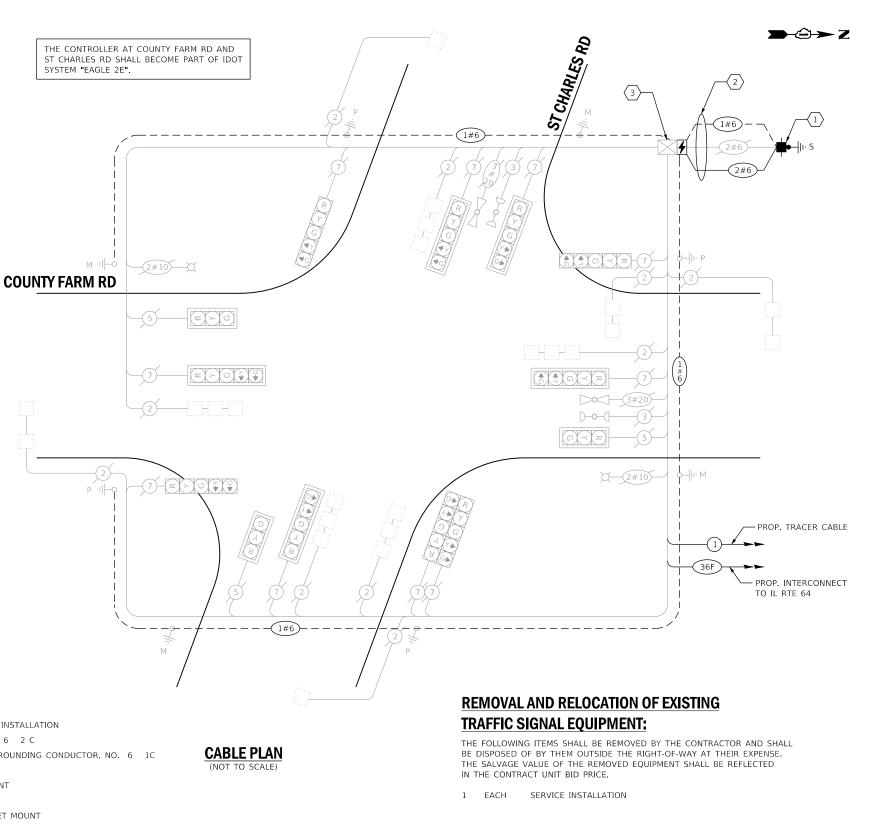
ENERGY SUPPLY: CONTACT: MR. JOE STACHO

DUDOT EAGLE 2E

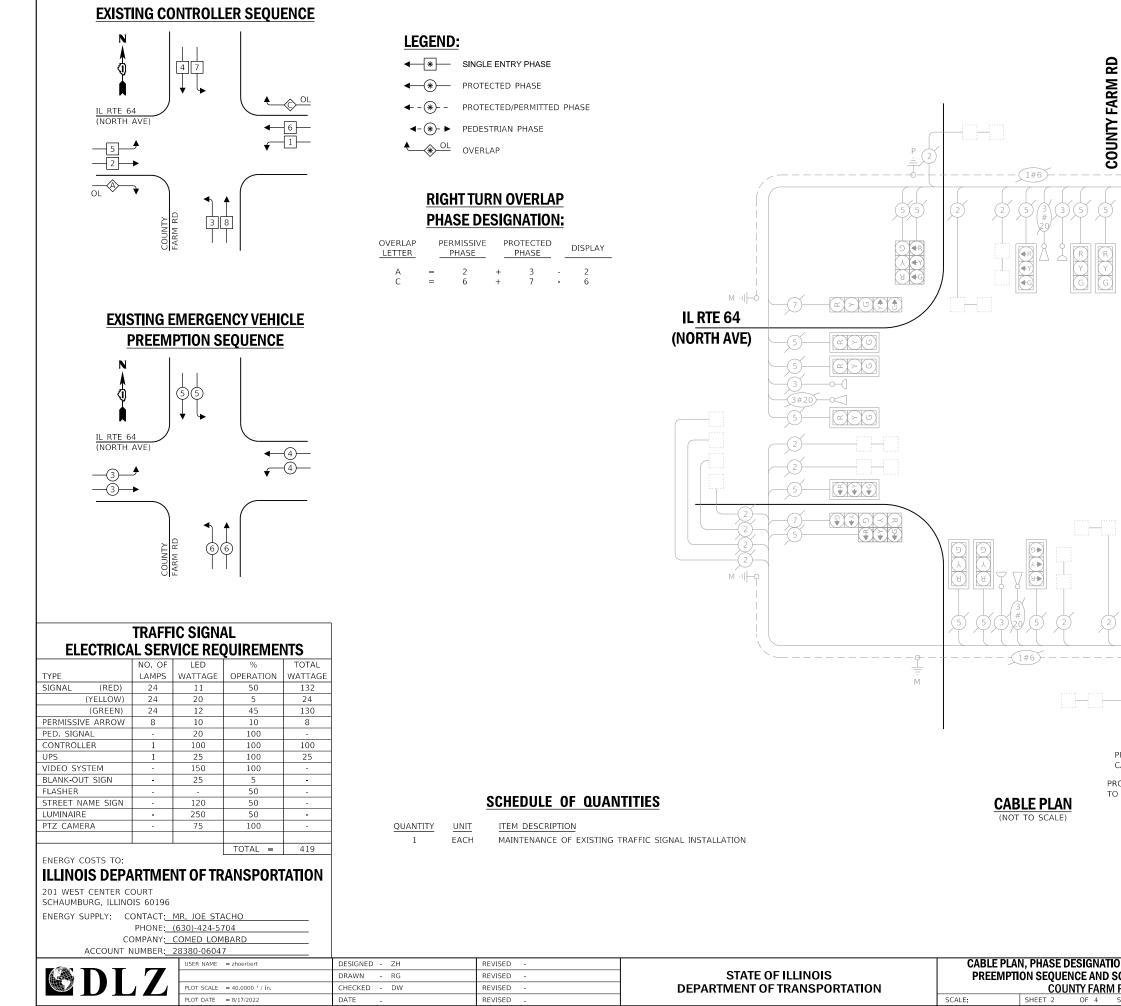


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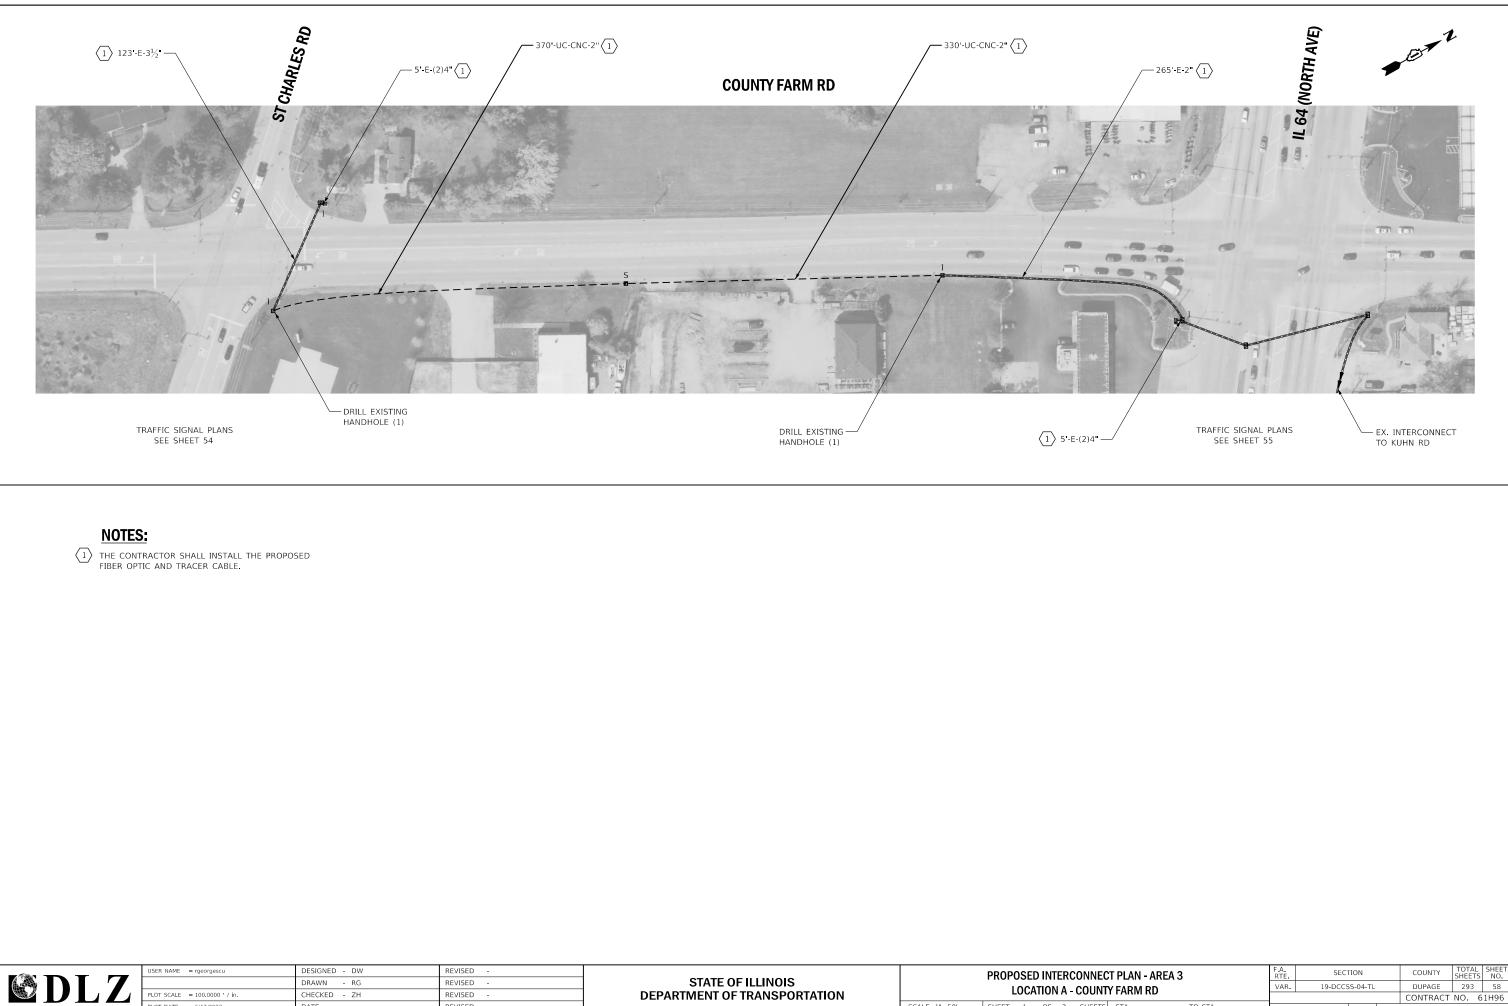


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	IAGRAM, EMERGENCY VEHICLE			E. SECTION			COUNTY	SHEETS	NO.
		QUANTITIES - AREA 3	VAR.	19-DCCSS-04-TL			DUPAGE	293	57
GARY AVE							CONTRACT	NO. 6	51H96
TS	STA.	TO STA.			ILLINOIS	FED. A	ID PROJECT		

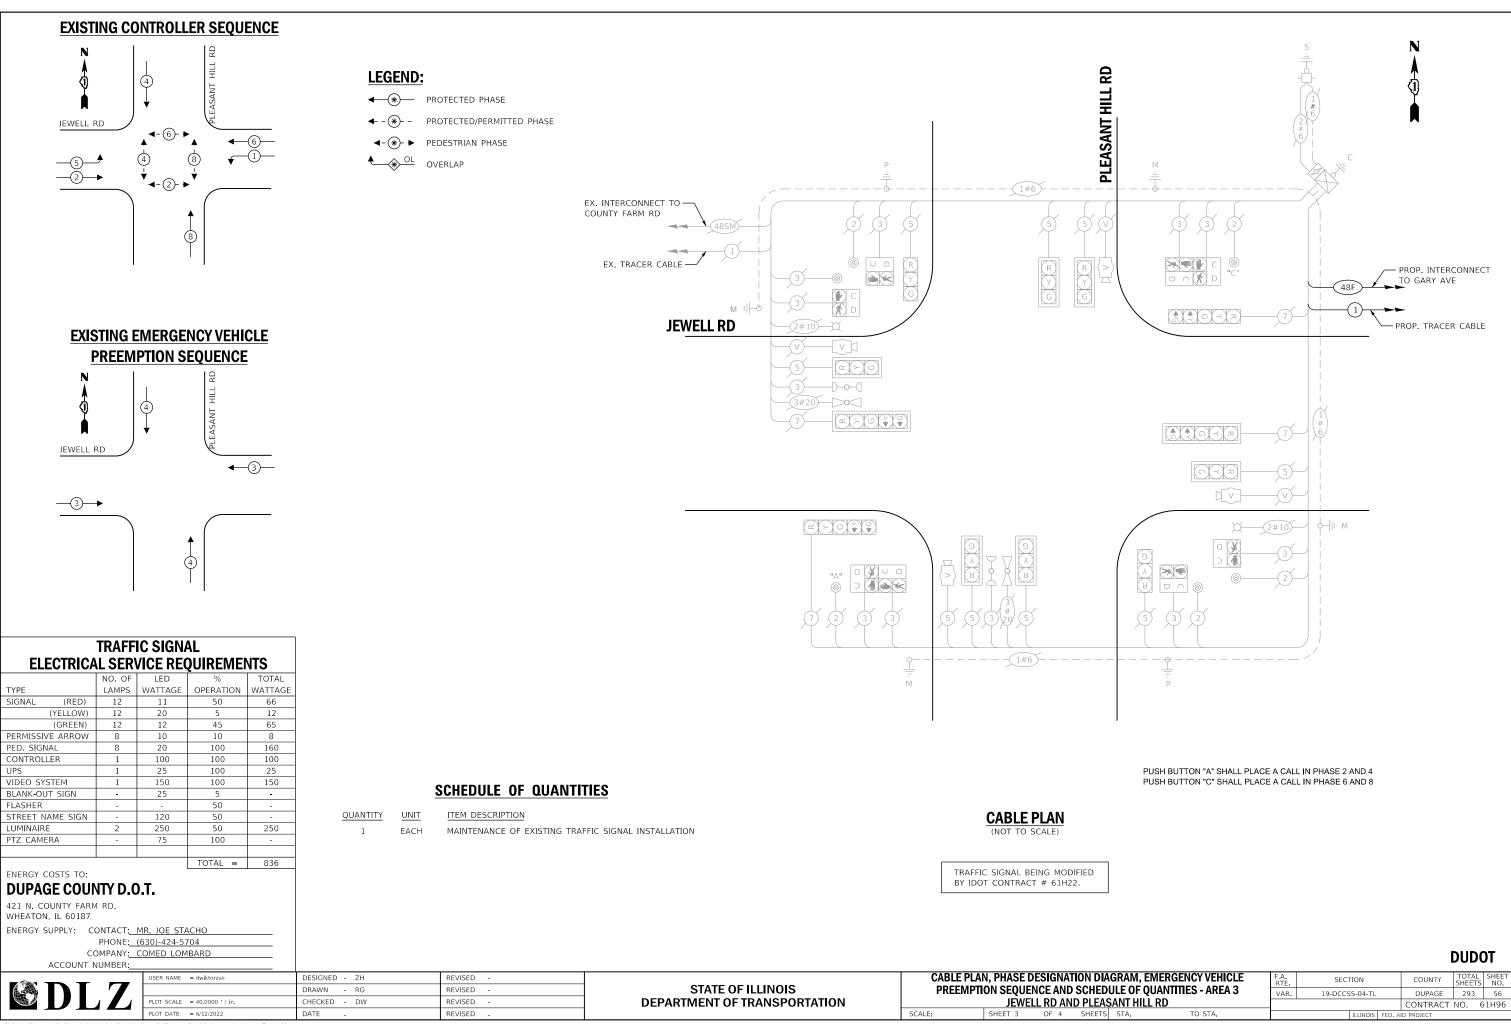

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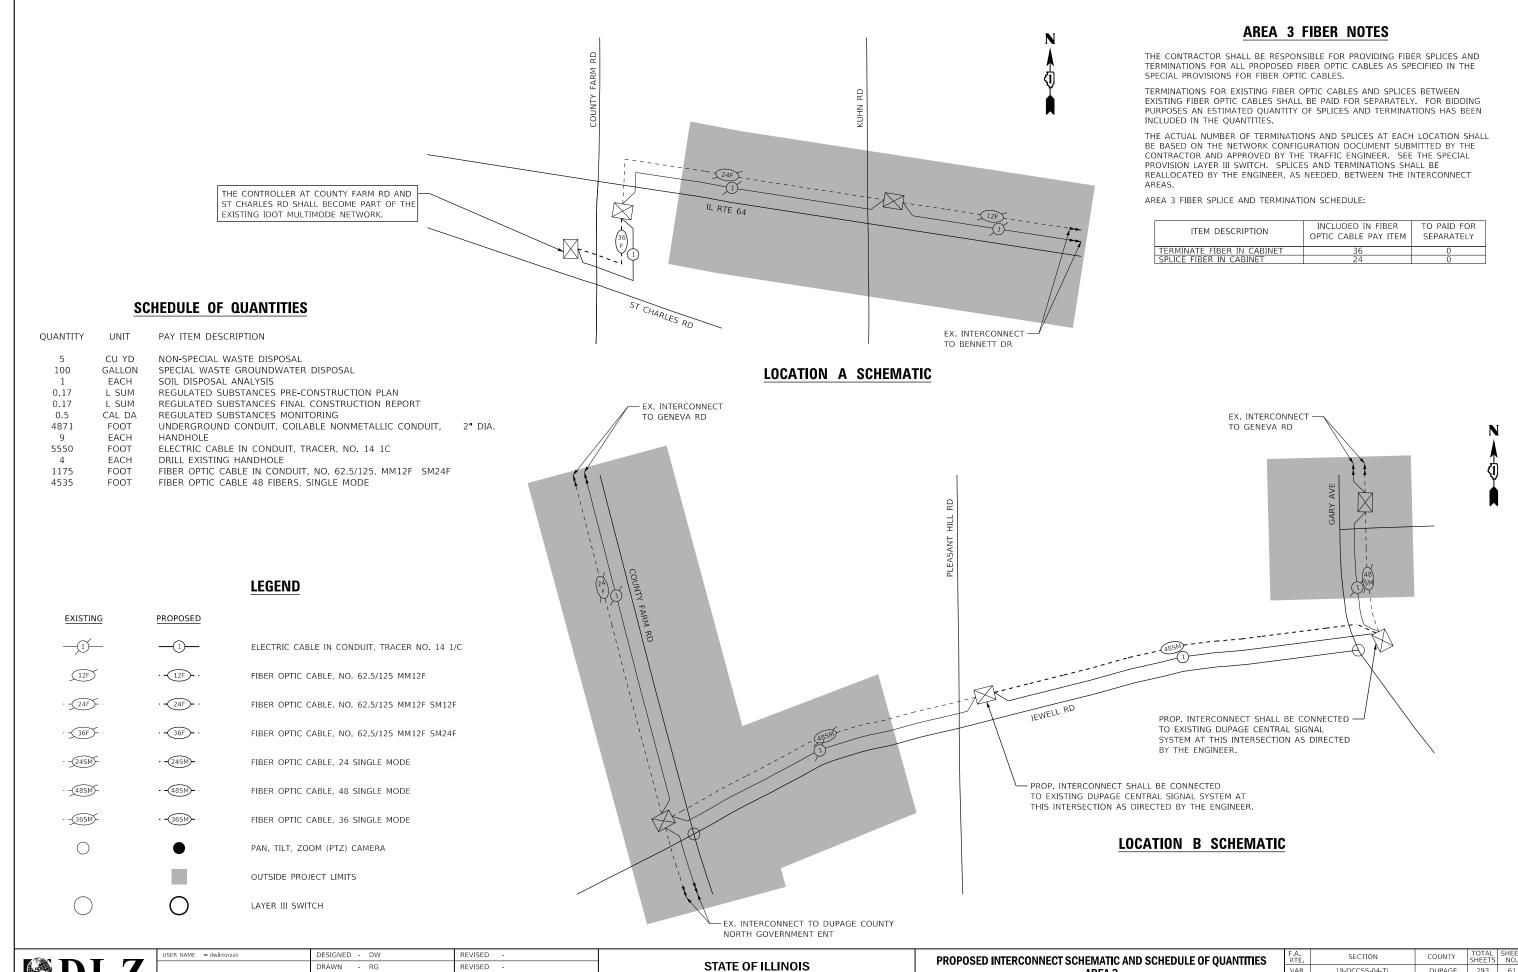
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EC	T PLAN - AREA 3		F.A. RTE	SECT	ΠΟΝ		COUNTY	TOTAL SHEETS	SHEET NO.
	Y FARM RD		VAR.	19-DCCS	S-04-TL		DUPAGE	293	58
11							CONTRACT	NO. 6	51H96
٢S	STA.	TO STA.			ILLINOIS	FED, AI	D PROJECT		

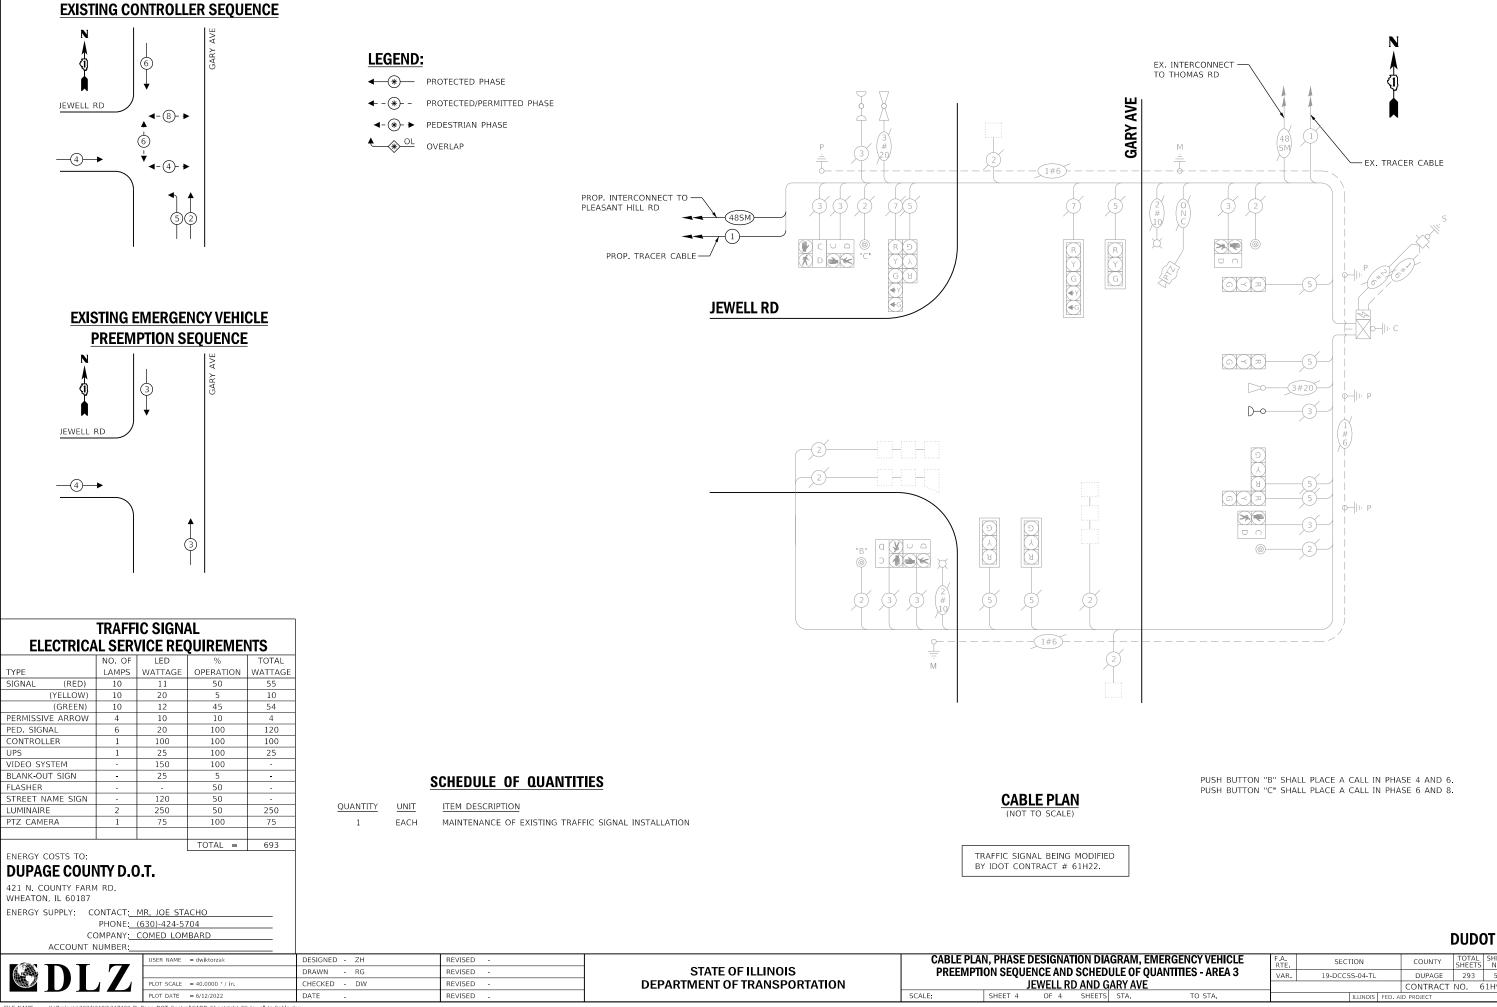



ECT PLAN -	- AREA 3	F.A. RTE	SECT	ΠΟΝ		COUNTY	TOTAL SHEETS	SHEET NO.
WELL RD		VAR.	19-DCCS	S-04-TL		DUPAGE	293	60
		_				CONTRACT	NO. 6	1H96
S STA.	TO STA.			ILLINOIS	FED. A	ID PROJECT		



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SHEET 1 OF 1 SHEETS STA.

SCALE:

AREA 3

ITEM DESCRIPTION	INCLUDED IN FIBER OPTIC CABLE PAY ITEM	TO PAID FOR SEPARATELY
TERMINATE FIBER IN CABINET	36	0
SPLICE FIBER IN CABINET	24	0


VAR.

TO STA.

19-DCCSS-04-TL

DUPAGE 293 61

CONTRACT NO. 61H96

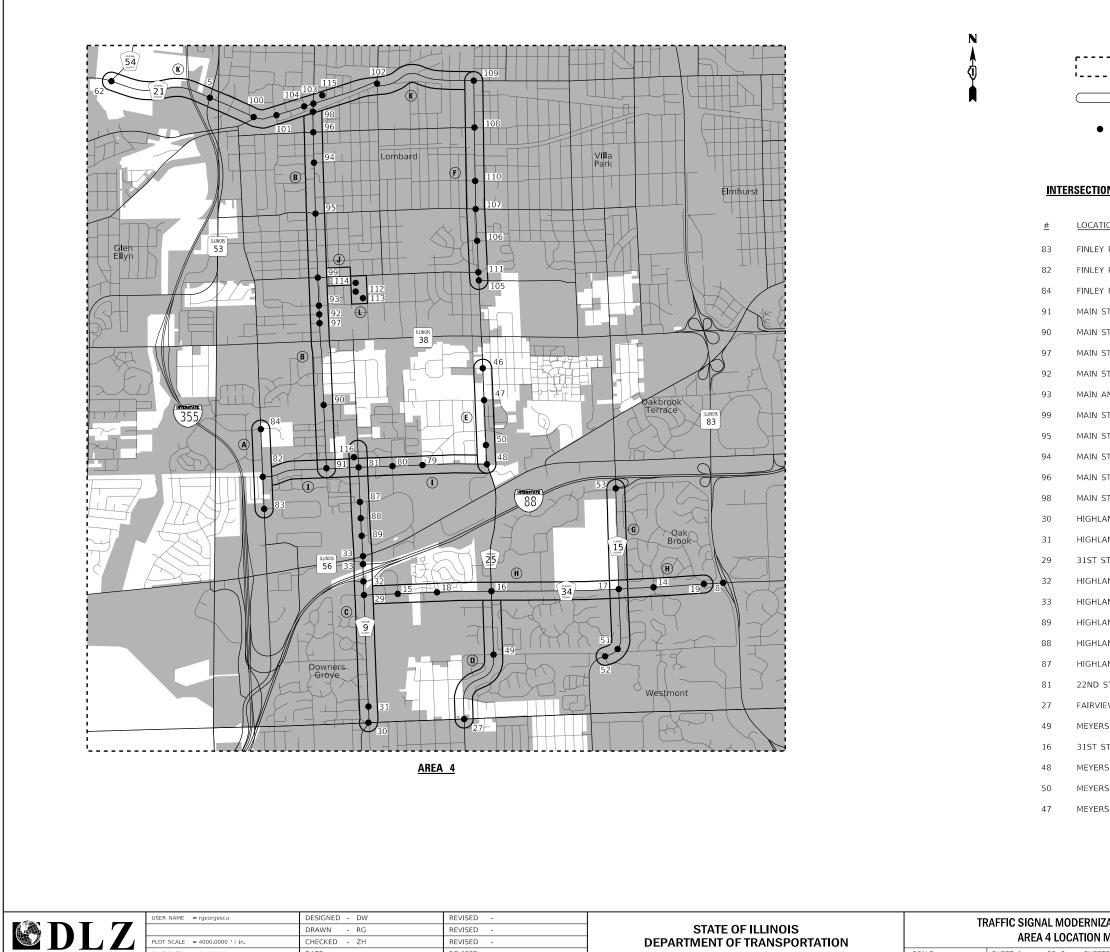

REVISED

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Area 4							

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PLOT DATE = 6/13/2022

DATE

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PROPOSED INTERCONNECT AREA - SEE INTERCONNECT PLANS PROPOSED SIGNAL IMPROVEMENT CORRIDOR

PROPOSED SIGNAL IMPROVEMENT LOCATION

INTERSECTION PLANS

LOCATION	<u>SHEETS</u>
FINLEY RD AND EISENHOWER LN	66 - 67
FINLEY RD AND 22ND ST	68 - 69
FINLEY RD AND OAK CREEK DR	70 - 71
MAIN ST AND 22ND ST	72 - 74
MAIN ST AND 16TH ST	75 - 76
MAIN ST AND MORRIS AVE	77
MAIN ST AND EDWARD AVE	78 - 79
MAIN AND GE HIGH SCHOOL ENT	80
MAIN ST AND WILSON AVE	81 - 82
MAIN ST AND MADISON ST	83 - 84
MAIN ST AND HICKORY ST	85 - 86
MAIN ST AND MAPLE ST	87 - 88
MAIN ST AND PARKSIDE AVE	89 - 90
HIGHLAND AVE AND 39TH ST	91 - 92
HIGHLAND AVE AND GOOD SAMARITAN HOSPITAL	93
31ST ST AND HIGHLAND AVE	94 - 96
HIGHLAND AVE AND I-88 EB RAMP (SOUTH)	97 - 98
HIGHLAND AVE AND IL RTE 56	99 - 100
HIGHLAND AVE AND YORKTOWN SOUTH	101 - 102
HIGHLAND AVE AND YORKTOWN CENTER	103
HIGHLAND AVE AND MAJESTIC DR	104 - 105
22ND ST AND HIGHLAND AVE	106 - 108
FAIRVIEW AVE AND 39TH ST	109 - 110
MEYERS RD AND 35TH ST	111
31ST ST AND MEYERS RD	112 - 114
MEYERS RD AND 22ND ST	115 - 116
MEYERS RD AND CORPORATE	117
MEYERS RD AND 16TH ST	118

ZATIO	N PLAN - ARE	A 4	F.A. RTE	SECT	FION		COUNTY	TOTAL SHEETS	SHEET NO.
ΜΔΡ	-10F2		VAR.	19-DCCS	S-04-TL		DUPAGE	293	62
	-1012						CONTRACT	NO. 6	51H96
TS ST	Ā.	TO STA.			ILLINOIS	FED. AI	ID PROJECT		

AREA 4 LOCATION M SCALE: SHEET 1 OF 2 SHEETS

INTERSECTION PLANS (CONT.)

<u>#</u>	LOCATION	SHEETS
46	MEYERS RD AND 14TH ST	119 - 120
105	WESTMORE-MEYERS RD AND HIGHRIDGE RD	121
111	WESTMORE-MEYERS RD AND WILSON RD	122 - 123
106	WESTMORE-MEYERS RD AND JACKSON ST	124
107	WESTMORE-MEYERS RD AND MADISON ST	125 - 126
110	WESTMORE-MEYERS RD AND WASHINGTON BLVD	127
108	WESTMORE-MEYERS RD AND MAPLE ST	128 - 129
109	WESTMORE AVE AND ST CHARLES RD	130 - 132
52	MIDWEST RD AND 35TH ST (SOUTH)	133 - 134
51	MIDWEST RD AND 35TH ST (NORTH)	135 - 136
53	MIDWEST RD AND I-88/BAYBROOK	137 - 138
15	31ST AND HIGHLAND PKWY	139
18	31ST ST AND MIDWEST U ENT/AVE LA TOURS	140
17	31ST ST AND MIDWEST RD	141 - 143
14	31ST ST AND CONCORD DR	144
19	31ST ST AND REGENT DR	145
80	22ND ST AND GRACE ST	146 - 147
79	22ND ST AND CONVENTION WAY	148
62	ST CHARLES RD AND SWIFT RD	149 - 150
100	ST CHARLES RD AND CRESCENT BLVD	151 - 152
101	ST CHARLES RD AND ELIZABETH ST	153 - 155
104	ST CHARLES RD AND PARK AVE	156
103	ST CHARLES RD AND MAIN ST	157 - 158
102	ST CHARLES RD AND GRACE ST	159 - 161

INTERCONNECT PLANS

	LOCATION	SHEETS
(A)	FINLEY RD	162 - 163
В	MAIN ST	164 - 169
C	HIGHLAND AVE	170 - 175
D	FAIRVIEW AVE/MEYERS RD	176 - 178
E	MEYERS RD	179 - 180
F	WESTMORE-MEYERS RD	181 - 183
G	MIDWEST RD	184 - 186
(H)	31ST ST	187 - 191
	22ND ST	192 - 195
	WILSON AVE	196
K	ST CHARLES RD	197 - 204
L	MUNICIPAL COMPLEX	205

JSER NAME = rgeorgescu PLOT SCALE = 4000.0000 ' / in.	DESIGNED - DW DRAWN - RG CHECKED - ZH	REVISED - REVISED - REVISED -	STATE OF ILLINOIS DEPARTMENT OF TRANSPORTATION		TRAFFIC SIGNAL MODERNIZATION PLAN - AREA 4 AREA 4 LOCATION MAP - 2 OF 2	F.A. RTE. VAR.	SECTION 19-DCCSS-04-TL	COUNTY TOTAL SHEETS SHEE NO. DUPAGE 293 63 CONTRACT NO. 61H96
PLOT DATE = 6/13/2022	DATE -	REVISED -		SCALE:	SHEET 2 OF 2 SHEETS STA. TO STA.		ILLINOIS FED.	AID PROJECT

AREA 4 SIGNAL IMPROVEMENTS (DUDOT)


					HIGHL	AND AN	/E AND				M	EYERS	RD AI	ND		MIDW	EST RI	D AND		319	ST ST /	AND		
PAY ITEM NO.	PAY ITEM DESCRIPTION	UNIT	TOTAL	TH ST	good samaritan hospital dr	31ST ST	8 EB RAMP (SOUTH)	RTE 56	FAIRVIEW AVE AND 39TH ST	35TH ST	YERS RD	2ND ST	CORPORATE CENTER ENT	16TH ST	TH ST	TH ST/WILLOW CREST DR	35TH ST (NORTH)	I-88/BAYBROOK LN	HIGHLAND PKWY	MIDWESTERN PKWYAVENUE LA TOURS	ST ST	CONCORD DR/TRINITY LN	EGENT DR/SAINT PASCHAL DR	CHARLES RD AND SWIFT RD
				39			1-88	=			W	2			14	351					315		<u>~</u>	ST
85000200	MAINTENANCE OF EXISTING TRAFFIC SIGNAL INSTALLATION	EACH	21	1	1	1	1	1	1	1	1	1	1	1	1	1	1	1	1	1	1	1	1	1
85700200	FULL-ACTUATED CONTROLLER AND TYPE IV CABINET	EACH	1	-	-	<u> </u>		1								6		<u> </u>				-	-	
87300010	GROUNDING EXISTING HANDHOLE FRAME AND COVER	EACH	56	5	6	4	220				8	117	120	21	4	6	3	7	25			5	5	3
87301805	ELECTRIC CABLE IN CONDUIT, SERVICE, NO. 6 2 C	FOOT	1071	183	33	58	229				75.0	117	130		26	112			35			75.0	750	750
87301900	ELECTRIC CABLE IN CONDUIT, EQUIPMENT GROUNDING CONDUCTOR, NO. 6 1C	FOOT	8792	750	750	750	229	15	-	0	750	117	130	31	750	750	750	750	35		0	750	750	/50
88500100		EACH	38			1	1	15	7	8								<u> </u>			8	1		
89501410	RELOCATE EXISTING EMERGENCY VEHICLE PRIORITY SYSTEM, PHASING UNIT	EACH	7	226	20	1	1	1 774	1	1		722	220	22	10	104	104	<u> </u>	20		1	1	1	011
89502300 89502375	REMOVE ELECTRIC CABLE FROM CONDUIT REMOVE EXISTING TRAFFIC SIGNAL EQUIPMENT	FOOT	7582	326	26	3710			1	1	1		220		12		194	\vdash	30		1	102		811
89502375	REMOVE EXISTING TRAFFIC SIGNAL EQUIPMENT	EACH EACH	20	1	1	1	1	1		1	1	1	1	1	1	1	1	1	1		1	1	1	1
X0322765	REMOVE EXISTING HANDHOLE RELOCATE VIDEO VEHICLE DETECTION SYSTEM	EACH	2			5	1											<u> </u>				1		
X0322703	ROD AND CLEAN EXISTING CONDUIT	FOOT	851	163	13	38	209					97	110	11	6	92	97	<u>├</u> ──┤	15			1		
X0326104	RELOCATE RADAR DETECTOR SYSTEM	EACH	1	105	15	50	205					57	110	11	0	52	51		15		1			\vdash
X1400102	OUTDOOR RATED NETWORK CABLE	FOOT	2302	190		211	123		271		198	369			156	172	68	230			211			103
X1400102 X1400150	SERVICE INSTALLATION, GROUND MOUNTED, METERED	EACH	1	150		211	125		2/1		150	505			150	1/2	00	230	1		211			105
X1400158	FIBER OPTIC SPLICE ENCLOSURE	EACH	4			1						1							1		1			1
X1400215	REMOTE CONTROLLED VIDEO SYSTEM	EACH	12	1		1	1		1		1	1			1	1	1	1			1			1
X1400216	LAYER II (DATALINK) SWITCH	EACH	16	1	1		1	1	1	1	1	_	1	1	1	1	1	1	1	1	_	1		
X1400221	UPGRADE EXISTING CONTROLLER TO NTCIP SPECIAL	EACH	3	1	1															1				
X1400303	FIBER OPTIC PATCH PANEL, 24 PORT, CABINET MOUNT	EACH	15	1	1		1	1	1	1	1		1	1	1	1	1	1	1			1		
X1400460	LAYER III (NETWORK) SWITCH	EACH	4			1						1									1			1
X8050095	SERVICE INSTALLATION (SPECIAL)	EACH	10	1	1	1	1					1	1	1	1	1	1							
X8570215	FULL-ACTUATED CONTROLLER IN EXISTING CABINET	EACH	10								1	1	1	1	1	1	1	1	1				1	
X8570226	FULL-ACTUATED CONTROLLER AND TYPE IV CABINET, SPECIAL	EACH	6			1	1		1	1											1	1		
X8620200	UNINTERRUPTABLE POWER SUPPLY, SPECIAL	EACH	12		1				1	1		1	1	1	1	1	1		1			1		1
X8950212	MODIFY EXISTING CONTROLLER CABINET, SPECIAL	EACH	14	1	1						1	1	1	1	1	1	1	1	1	1			1	1
XX005800	RELOCATE EXISTING UPS BATTERY BACK-UP SYSTEM	EACH	3			1	1														1			
XX007622	ELECTRIC METER	EACH	5						1	1								1		1				1
XX008396	CAMERA MOUNTING ASSEMBLY, SPECIAL	EACH	2	1								1												
XX009046	VEHICLE DETECTION SYSTEM, SPECIAL	EACH	3			1						1												1
Z0050400	REMOVE AND REPLACE ANCHOR BOLTS	EACH	1																1					
	POE EXTENDER	EACH	2						1			1												

USER NAME = zhoerbert	DESIGNED -	REVISED -					F.A. RTE	SECTION	COUNTY TOTAL SHEET SHEETS NO.
	DRAWN -	REVISED -	STATE OF ILLINOIS		SCHEDULE OF QUANTITIES		VAR.	19-DCCSS-04-TL	DUPAGE 293 64
PLOT SCALE = 100.0000 / in.	CHECKED -	REVISED -	DEPARTMENT OF TRANSPORTATION						CONTRACT NO. 61H96
PLOT DATE = 6/14/2022	DATE -	REVISED -		SCALE:	SHEET 1 OF 2 SHEETS STA.	TO STA.		ILLINOIS FED	AID PROJECT


AREA 4 SIGNAL IMPROVEMENTS (LOMBARD)

				FINL	EY RD A	ND				MA	AIN ST	AND					HIGHLA	ND AV	AND		WES	STMORE-	MEYER	S AND		22N	ID ST #	AND	ST	CHARLE	ES RD) ANC	,
PAY ITEM NO.	PAY ITEM DESCRIPTION	UNIT	TOTAL	EISENHOWER LN	22ND ST	OAK CREEK DR/WOODMOOR DR	22ND ST	16TH ST	MORRIS AVE/LOMBARD PINES SOUTH ENT	EDWARD AVE	ENBARD EAST HIGH SCHOOL	SON AVE	MADISON ST	HICKORY ST	MAPLE ST	side ave	TOWN ENT (SOUTH)	MARETIC DR		HIGHRIDGE RD	WILSON AVE	CIR/JACKSON ST				SI CHARLES RD GRACE ST/NORTHLAKE RD		VENTION WAY	NT BLVD	BETH ST	PARK AVE	ST CHARLES RD	GRACE ST
85000200	MAINTENANCE OF EXISTING TRAFFIC SIGNAL INSTALLATION	EACH	31	1	1	1	1	1	1	1	1	1	1	1	1	1	1	1 1	1	1	1	1	1	. :	1	1 1	-	1	1	1	1	1	1
86400100	TRANSCEIVER - FIBER OPTIC	EACH	2																1							1							
87300010	GROUNDING EXISTING HANDHOLE FRAME AND COVER	EACH	90	4	9		7						7	4					4	3	5	4 4	4 4	μ _ 4	t	4 8			5	4	4	6	
87301900	ELECTRIC CABLE IN CONDUIT, EQUIPMENT GROUNDING CONDUCTOR, NO. 6 1C	FOOT	13500	750	750		750						750	750					750	750	750	750 7	50 75	50 75	7 0ز	50 750	0		750	750 7	750	750	
88500100	INDUCTIVE LOOP DETECTOR	EACH	56	8	9		11					8							13							7							
89501410	RELOCATE EXISTING EMERGENCY VEHICLE PRIORITY SYSTEM, PHASING UNIT	EACH	18	1	1		1	1				1	1	1		1			1	1		1	1	L :	1	1 1					1	1	
89502300	REMOVE ELECTRIC CABLE FROM CONDUIT	FOOT	9069						15	12	94	16 4	136	296	340	480 5	90 4	46 72	3	272	556	617 3	98 38	32 54	19 3	86 21	ı 3	396 4	458 1	1050	73	188	275
89502375	REMOVE EXISTING TRAFFIC SIGNAL EQUIPMENT	EACH	30	1	1		1	1	1	1	1	1	1	1	1	1	1	1 1	1	1	1	1	1	. :	1	1 1		1	1	1	1	1	1
89502380	REMOVE EXISTING HANDHOLE	EACH	7														2								-	3			1	1			
X0322765	RELOCATE VIDEO VEHICLE DETECTION SYSTEM	EACH	3					1																							1	1	
X1400102	OUTDOOR RATED NETWORK CABLE	FOOT	4193	68	257	178	266	195		233		84 :	183	156	84	147 3	46	39	3 61		164	6	57	16	68 9	94 327	7		72	105		155	390
X1400158	FIBER OPTIC SPLICE ENCLOSURE	EACH	2				1																									1	
X1400215	REMOTE CONTROLLED VIDEO SYSTEM	EACH	24	1	1	1	1	1		1		1	1	1	1	1	1	1	1		1		1		1	1 1			1	1		1	2
X1400216	LAYER II (DATALINK) SWITCH	EACH	29	1	1	1		1	1	1	1	1	1	1	1	1	1	1 1	1	1	1	1	1	ı :	1	1 1		1	1	1	1		1
X1400221	UPGRADE EXISTING CONTROLLER TO NTCIP SPECIAL	EACH	7			1			1	1	1																	1		1			1
X1400303	FIBER OPTIC PATCH PANEL, 24 PORT, CABINET MOUNT	EACH	29	1	1	1		1	1	1	1	1	1	1	1	1	1	1 1	1	1	1	1	1	. :	1	1 1		1	1	1	1		1
X1400460	LAYER III (NETWORK) SWITCH	EACH	2				1							-+						1					+		+	\square		\neg	$\neg \uparrow$	1	
X8570215	FULL-ACTUATED CONTROLLER IN EXISTING CABINET	EACH	5												1		1	1 1											1		_		1
X8570226	FULL-ACTUATED CONTROLLER AND TYPE IV CABINET, SPECIAL	EACH	19	1	1		1	1	+			1	1	1		1			1	1	1	1	1	. :	1	1 1	-				1	1	
X8950212	MODIFY EXISTING CONTROLLER CABINET, SPECIAL	EACH	11			1			1	1	1				1			1 1	-						-		-	1	1	1			1
XX005800	RELOCATE EXISTING UPS BATTERY BACK-UP SYSTEM	EACH	19	1	1		1	1	+			1	1	1		1			1	1	1	1	1		1	1 1	-				1	1	
XX007029	RELOCATE EXISTING TRANSCEIVER	EACH	1																						+	1	+				$\neg \uparrow$		
XX007536	PAINT TRAFFIC SIGNAL EQUIPMENT	EACH	3			1																			+	1	+			1	$\neg \uparrow$		
XX007952	TERMINAL SERVER	EACH	2																1							1	1						
XX008396	CAMERA MOUNTING ASSEMBLY, SPECIAL	EACH	3			1								\rightarrow											\top	1	+			1	\neg		
XX009046	VEHICLE DETECTION SYSTEM, SPECIAL	EACH	15										1	1	1	1	1	1 1		1	1	1	1	. :	1	1	+	1		\neg	$\neg \uparrow$		
	POE EXTENDER	EACH	6		1		1										1	1							+	1	+				$\neg \uparrow$		1
																				1					\top		+				\neg		
																									-		-				-		


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		DRAWN -	REVISED -	STATE OF ILLINOIS		SCHEDULE OF QUANTITIES	VA	R. 19-DCCSS-04-TL	DUPAGE 293 65
	PLOT SCALE = 100.0000 / in	CHECKED -	REVISED -	DEPARTMENT OF TRANSPORTATION					CONTRACT NO. 61H96
	PLOT DATE = 6/14/2022	DATE -	REVISED -		SCALE:	SHEET 2 OF 2 SHEETS STA.	TO STA.	ILLINOIS FE	D. AID PROJECT
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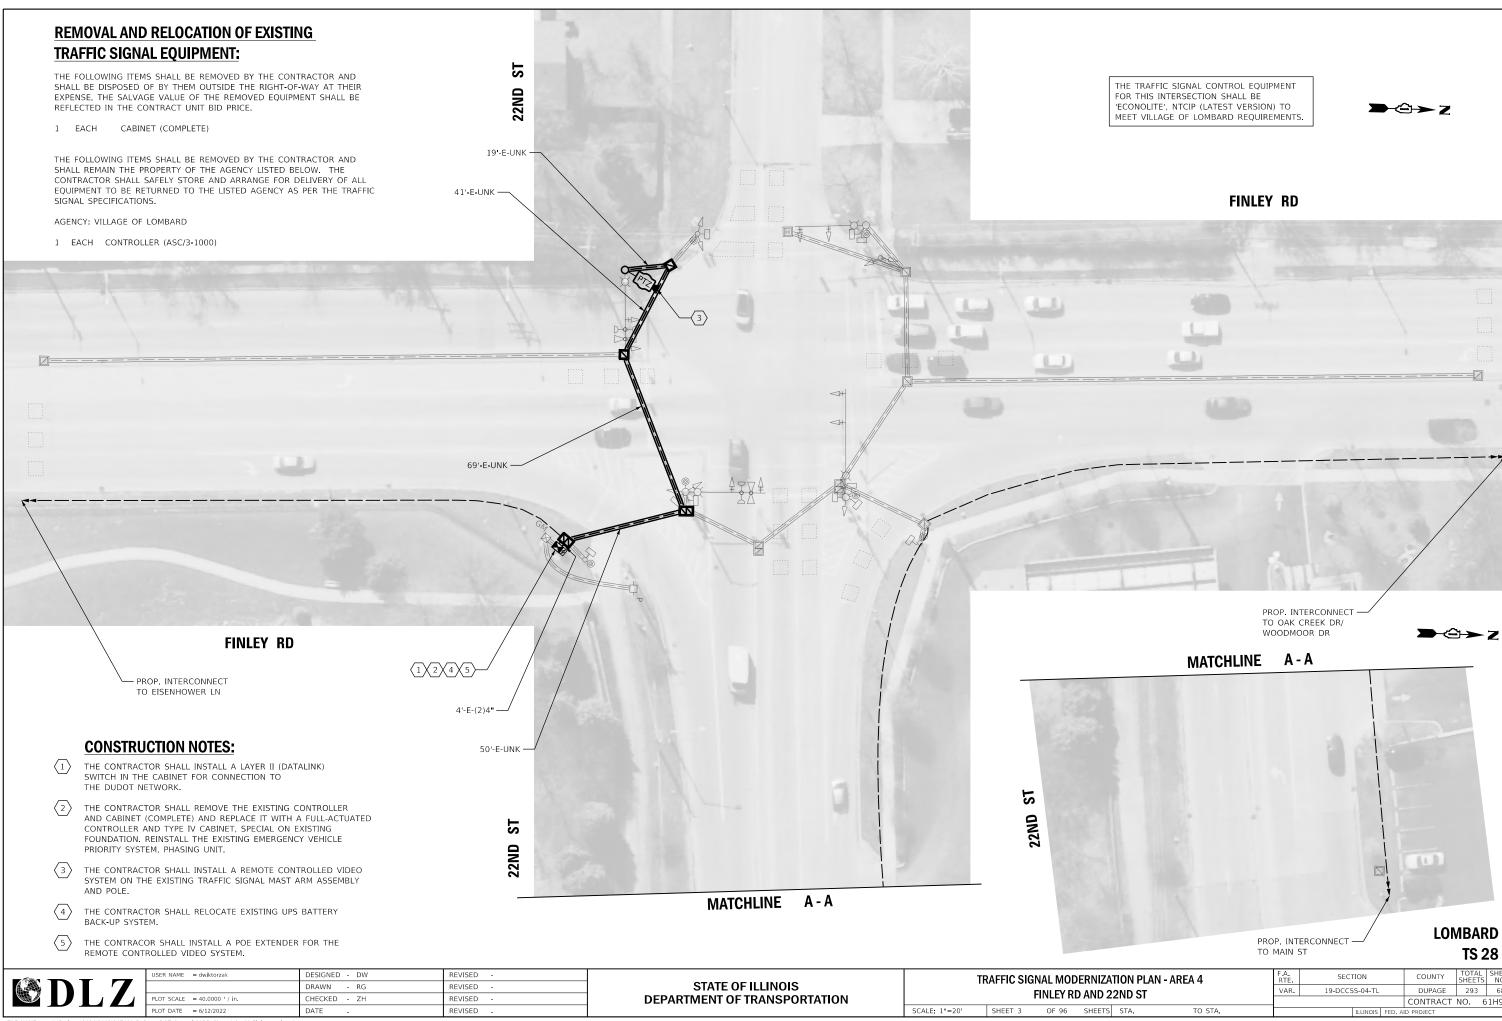


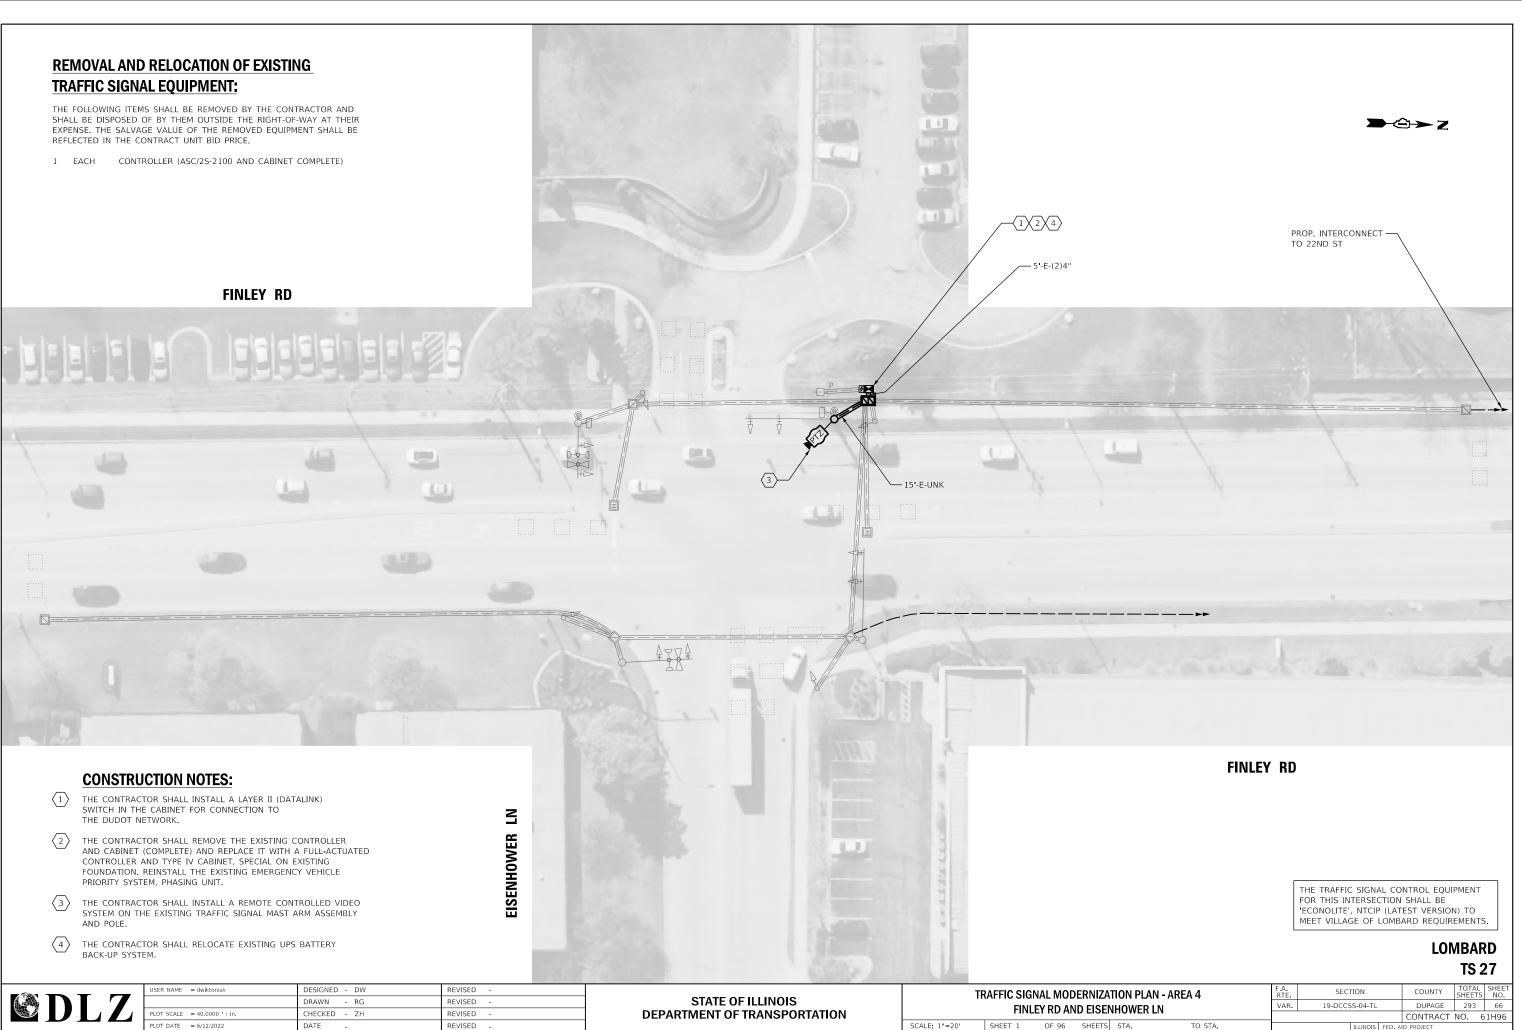		DRAWN - RG	REVISED -
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	PLOT DATE = 6/12/2022	DATE -	REVISED -
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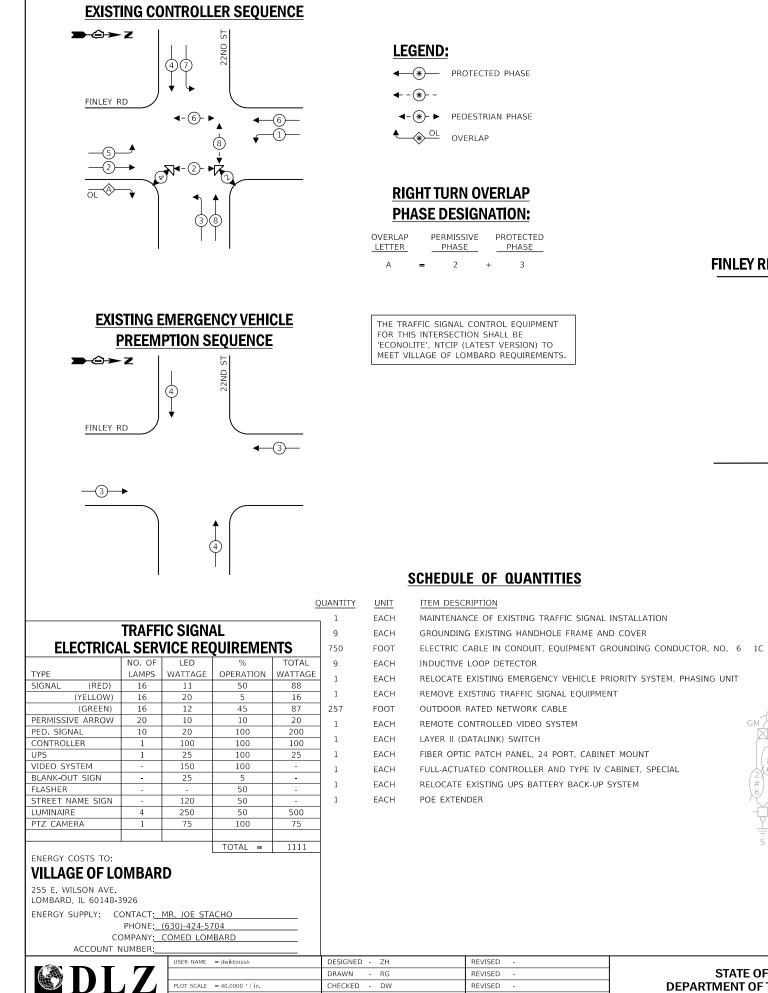


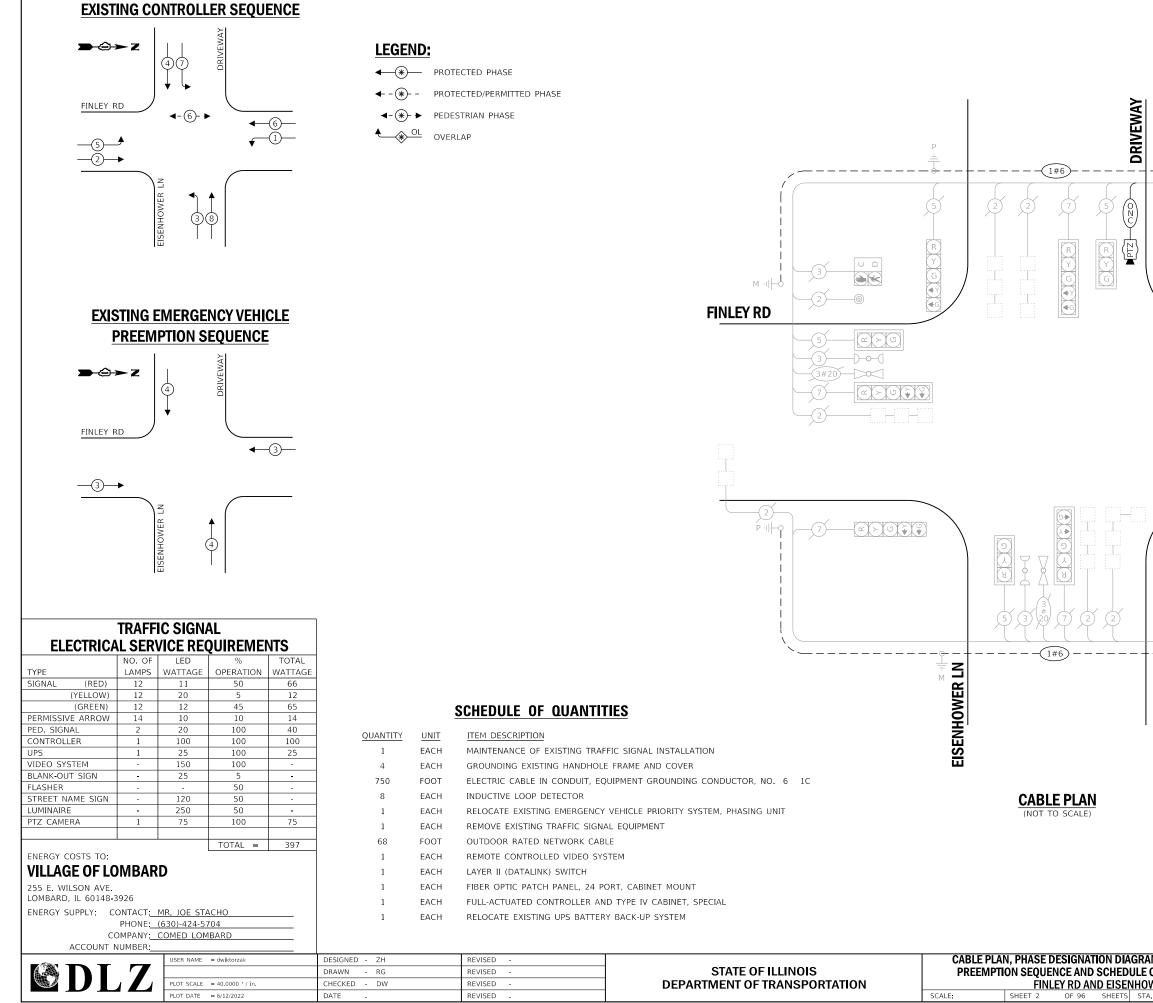


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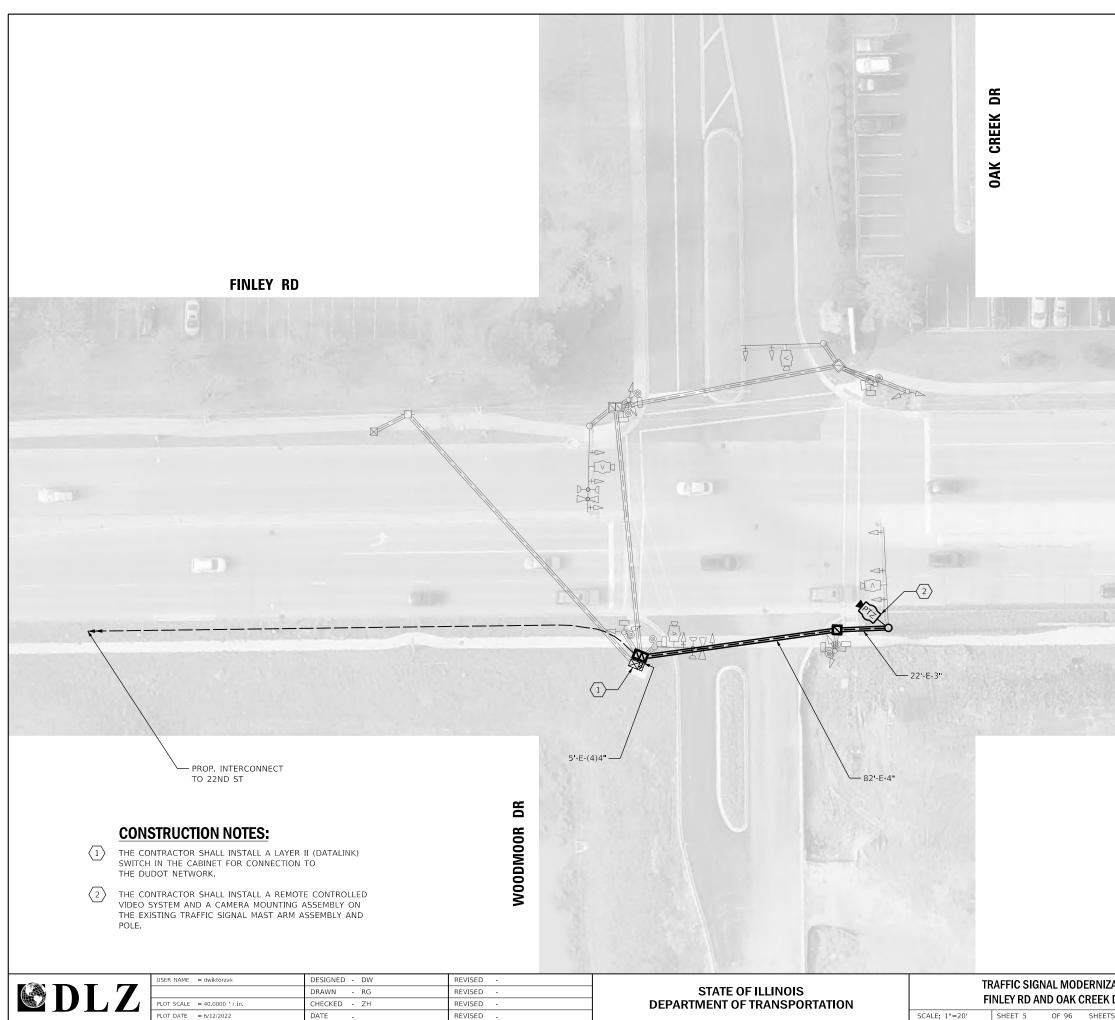
LOMBARD TS 28

A	TION PLA	N - AREA 4	F.A. RTE	SECT	TION		COUNTY	TOTAL SHEETS	SHEET NO.
2	2ND ST		VAR.	19-DCCS	S-04-TL		DUPAGE	293	68
2	2110 31						CONTRACT	NO. 6	1H96
S	STA.	TO STA.			ILLINOIS	FED. A	ID PROJECT		

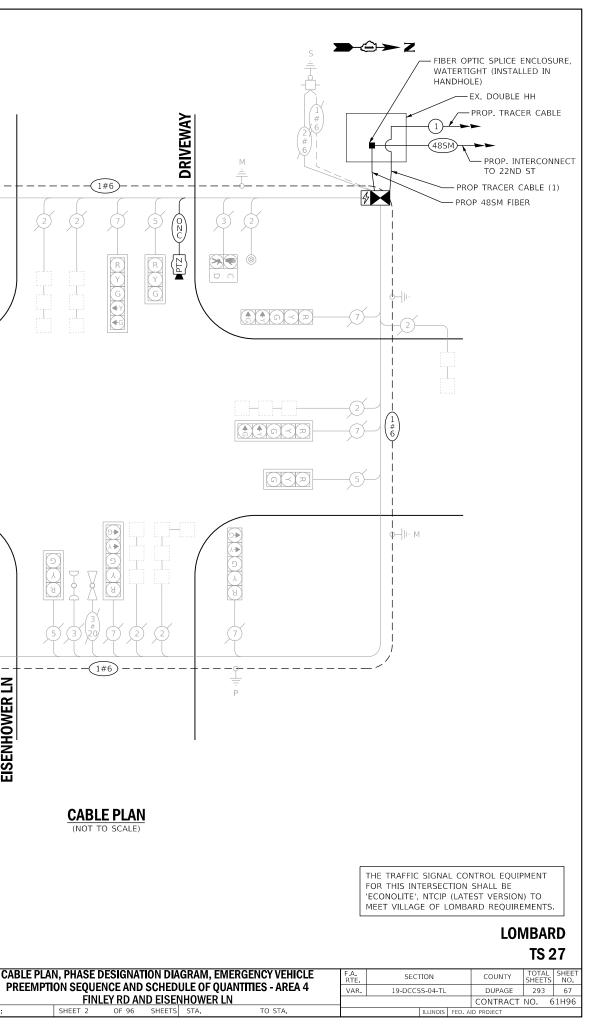

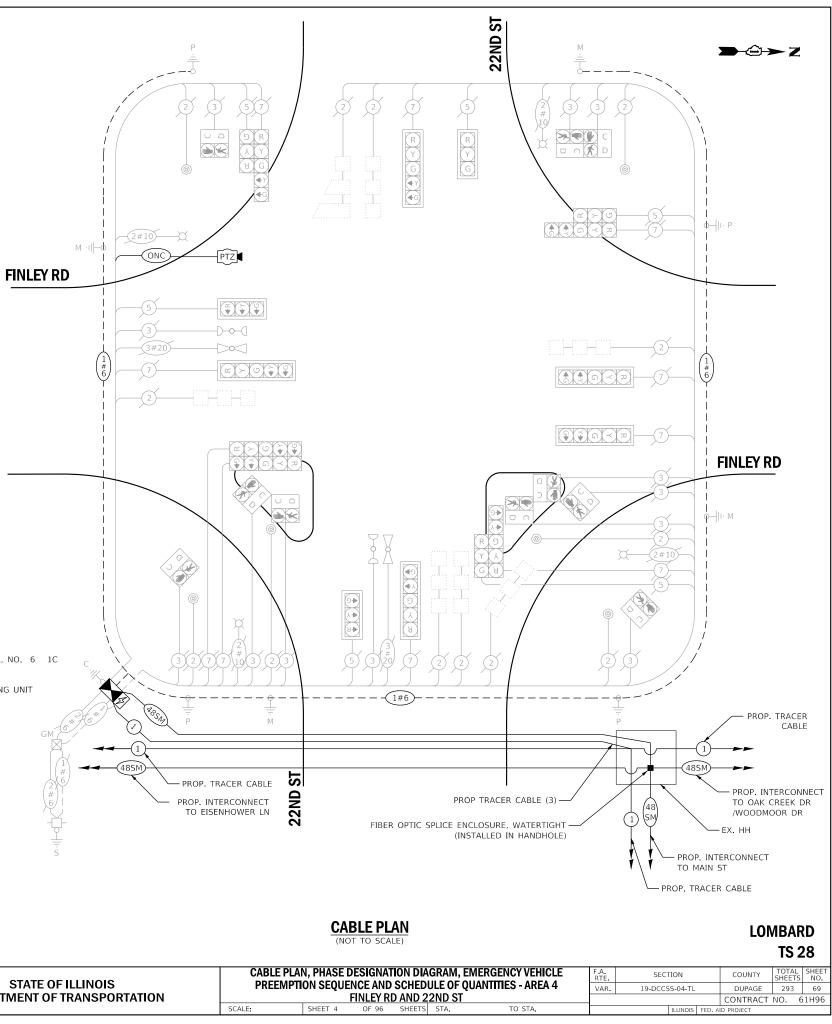

ACCOUNT NOMBER.								
	USER NAME = dwiktorzak	DESIGNED - ZH	REVISED -		CABLE PLAN	1, PHASE DE	SIGNATI	ION DIA
		DRAWN - RG	REVISED -	STATE OF ILLINOIS	PREEMPTI	ON SEQUENC	CE AND 3	SCHED
	PLOT SCALE = 40.0000 / in.	CHECKED - DW	REVISED -	DEPARTMENT OF TRANSPORTATION		FI/	NLEY RD) AND 2
	PLOT DATE = 6/12/2022	DATE -	REVISED -		SCALE:	SHEET 4	OF 96	SHEETS
FILE NAME = X\Projects\2021\2182\217400 Dul Int 82	Page DOT Central\CADD_Sheets\sht-4A-Finley-ts-Cable.d	lgn						



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SCALE: 1"=20' SHEET 5 OF 96 SHEETS






FINLEY RD

THE CAMERA MOUNTING ASSEMBLY SHALL BE PAINTED BLACK TO MATCH EXISTING TRAFFIC SIGNAL EQUIPMENT.

EX VIDEO DETECTION ZONES SHALL REMAIN UNCHANGED, UNLESS DIRECTED OTHERWISE BY THE ENGINEER.


LOMBARD TS 29

ZA [.]		AN - AREA 4	F.A. RTE	SECT	TION		COUNTY	TOTAL SHEETS	SHEET NO.
CDR/WOODMOOR DR				19-DCCS	DUPAGE	293	70		
	10 100	DINIOUN DI	_				CONTRACT	NO. 6	1H96
TS	STA.	TO STA.			ILLINOIS	FED. A	ID PROJECT		
_									

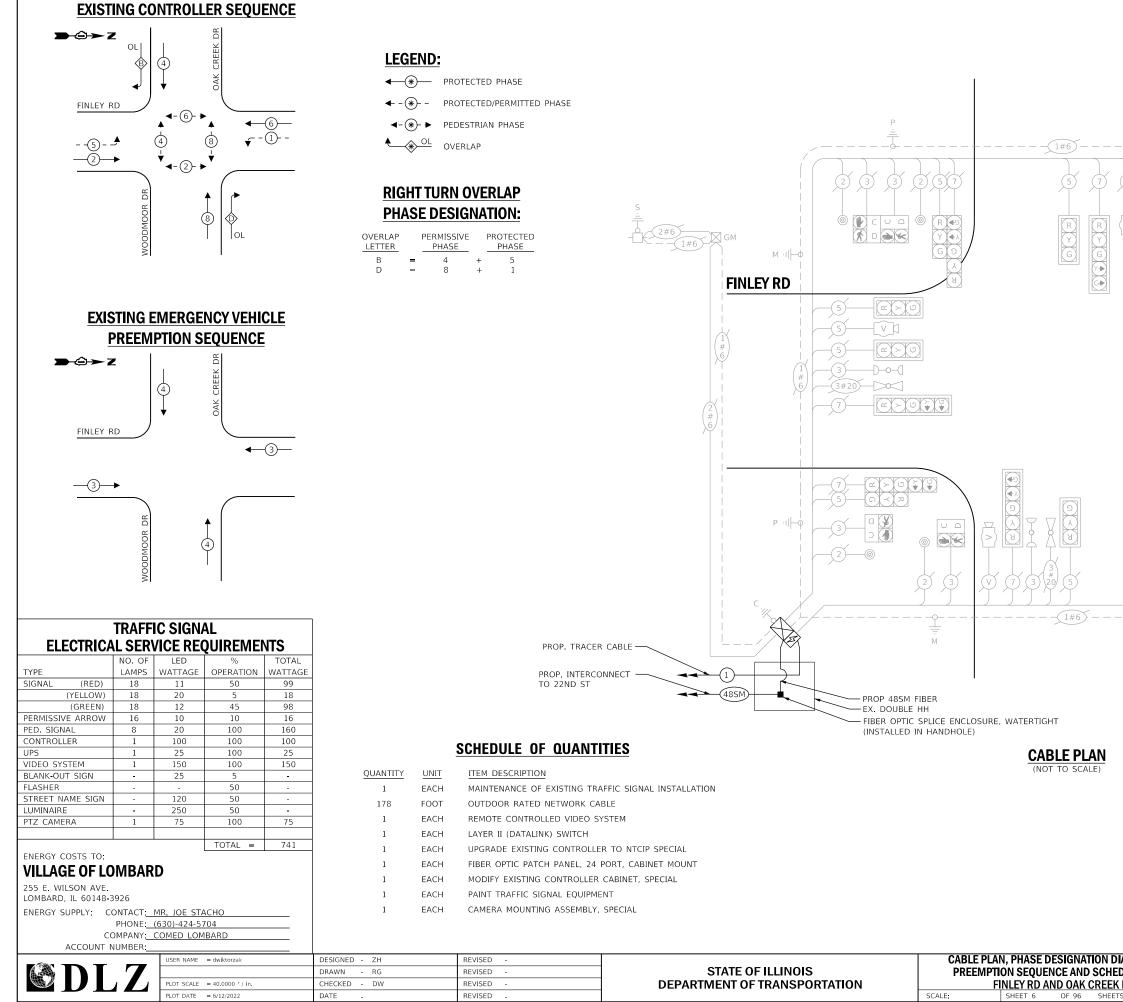


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10	23

IAGRAM, EMERGENCY VEHICLE	F.A. RTE	SECT	TION		COUNTY	TOTAL SHEETS	SHEET NO.
DULE OF QUANTITIES - AREA 4	VAR.	19-DCCS	S-04-TL		DUPAGE	293	71
<u>CDR/WOODMORE DR</u>					CONTRACT	NO. 6	51H96
TS STA. TO STA.			ILLINOIS	FED. A	ID PROJECT		

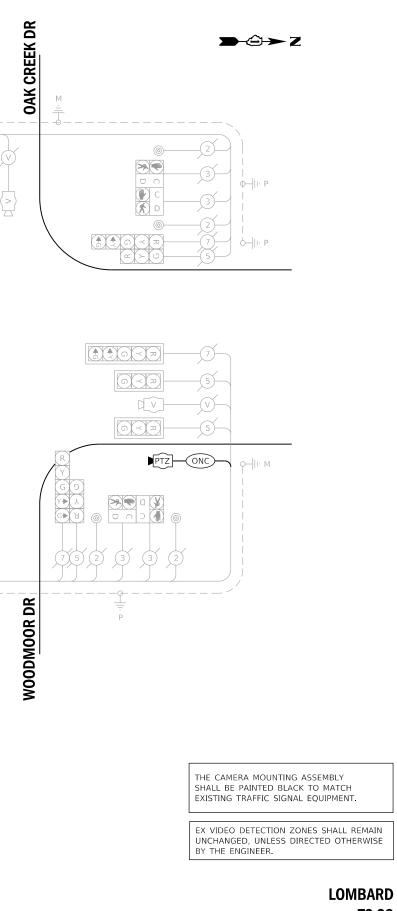

PLOT DATE = 6/12/2022

DATE

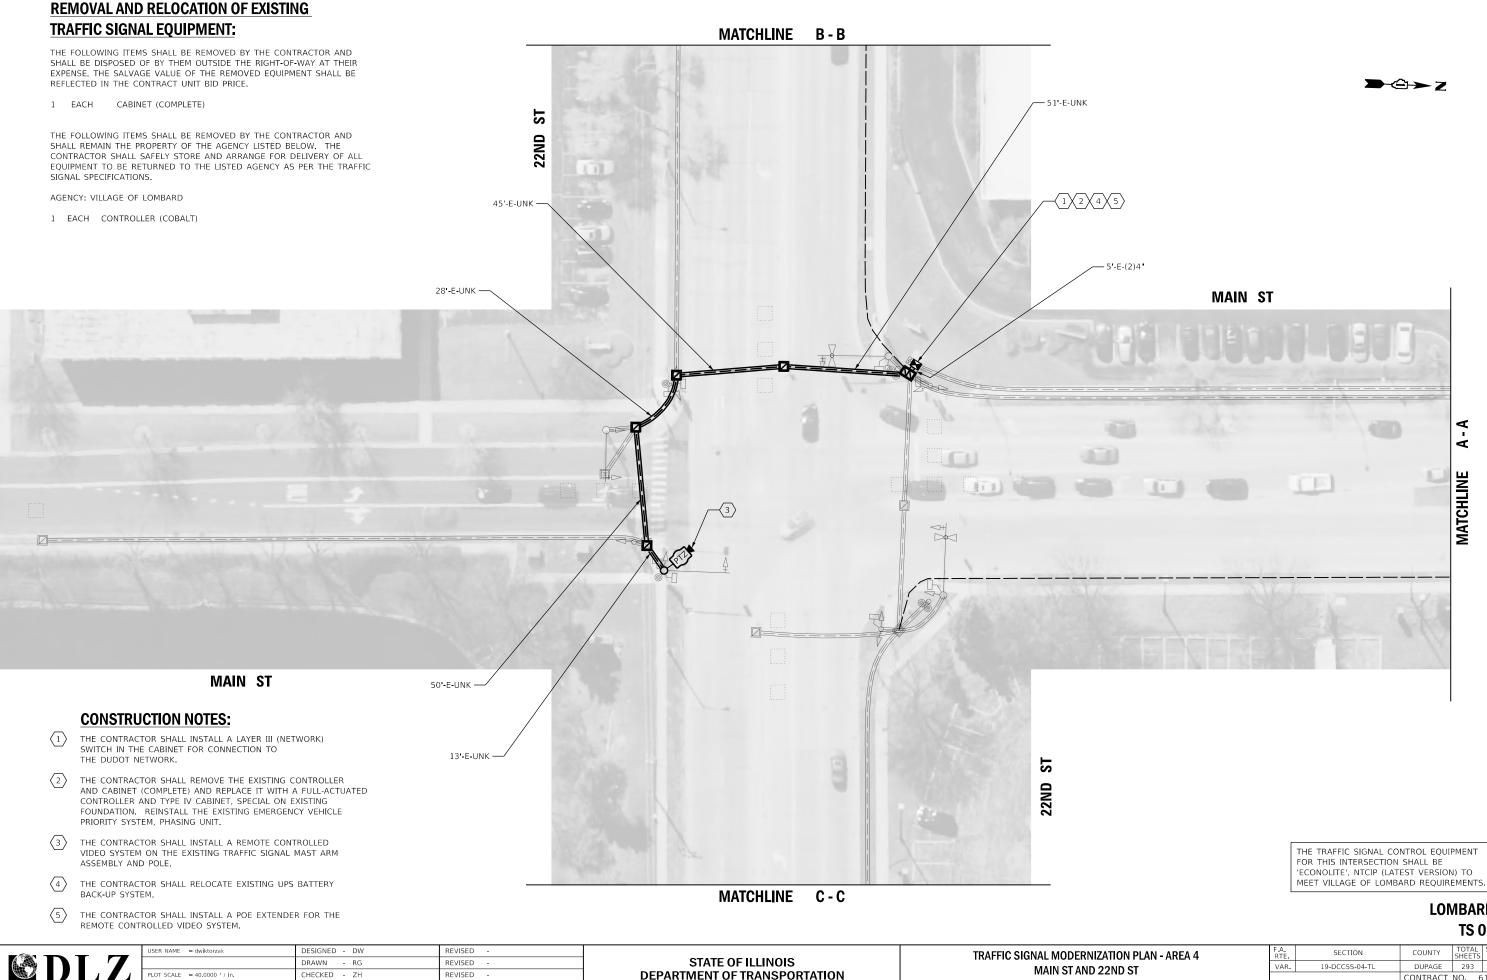REVISED



LOMBARD **TS 01**


ATION PLAN - AREA 4	F.A. RTE	SECT	TION		COUNTY	TOTAL SHEETS	SHEET NO.
22ND ST	VAR.	19-DCCS	S-04-TL		DUPAGE	293	72
					CONTRACT	NO. 6	1H96
TS STA. TO STA.			ILLINOIS	FED. A	ID PROJECT		

SCALE: 1"=20' SHEET 7 OF 96 SHEETS




MAIN	ST		_	^		
ATCHLINE A-A	n.					
			PROP. INTERCON TO 16TH ST	NECT		
		Г	THE TRAFFIC SIGNAL COM	ITROL EQUI	PMENT	
			FOR THIS INTERSECTION ECONOLITE', NTCIP (LATE MEET VILLAGE OF LOMBA	SHALL BE EST VERSION RD REQUIRE	I) TO EMENTS	-
				LON	MBAR TS (01
GNAL MODERNIZATION PLAN - ARE MAIN ST AND 22ND ST	A 4	F.A RTE VAR	SECTION 19-DCCSS-04-TL	COUNTY DUPAGE	TOTAL SHEETS 293	SHEET NO. 73
OF 96 SHEETS STA.	TO STA.		ILLINOIS FED. AI	CONTRACT		1H96
5. 50 SHEETS STA.	·• JIA.	1	LLLINUIS FED. AI	D PROJECT		

SHEET 8 OF 96 SHEETS

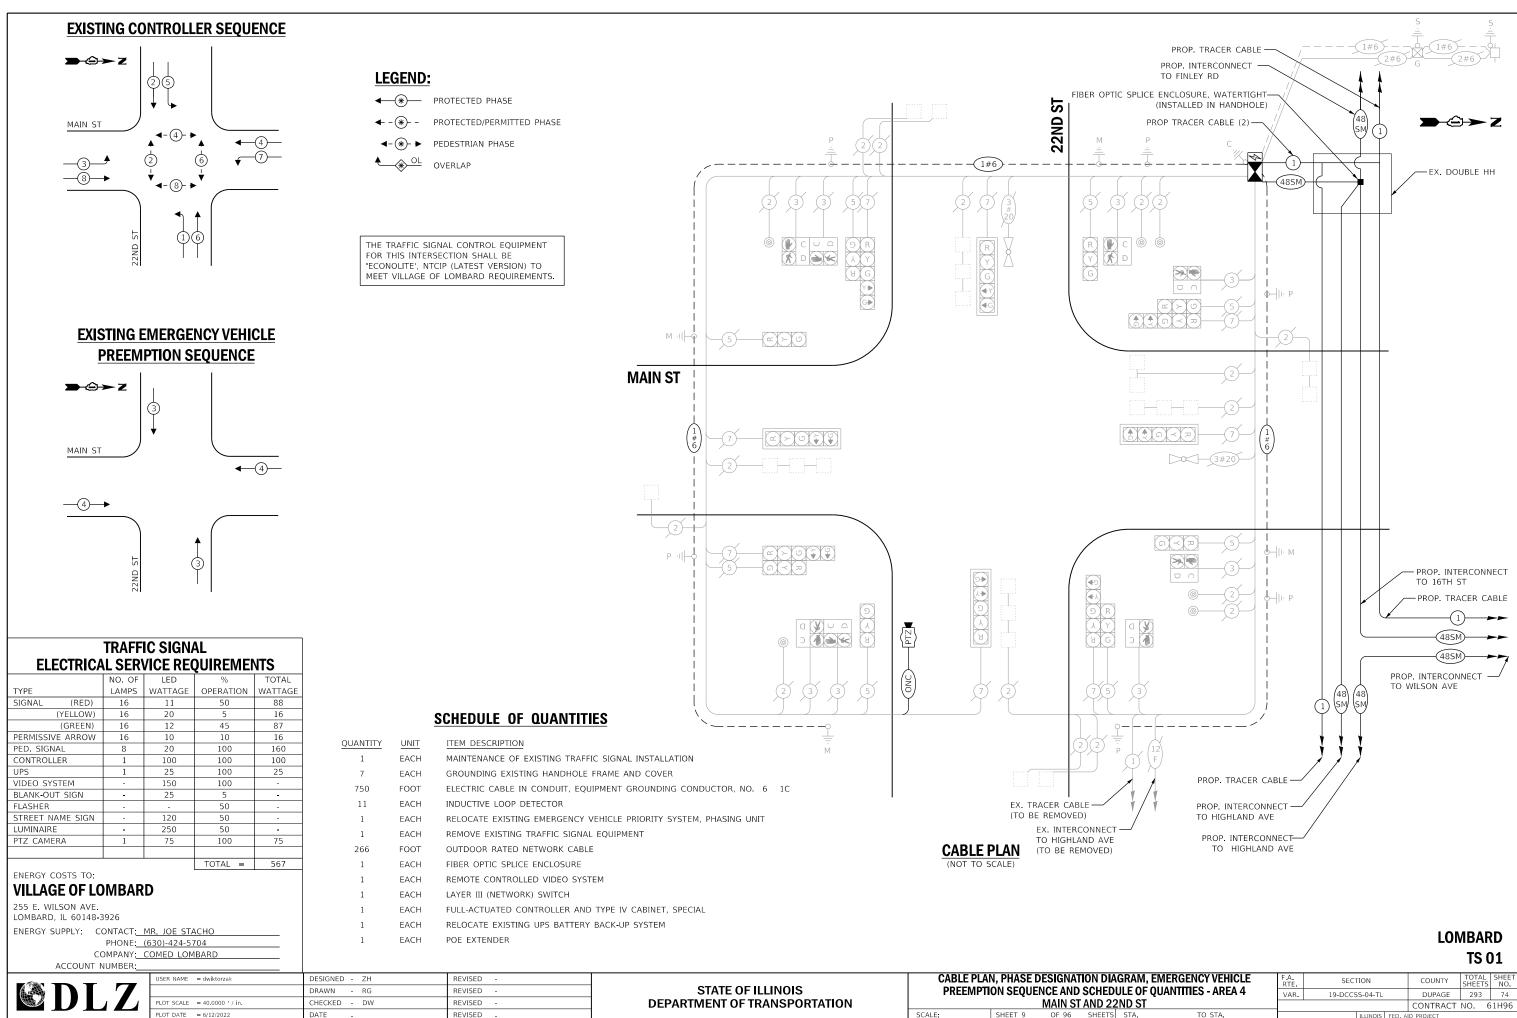


SCALE: SHEET 9

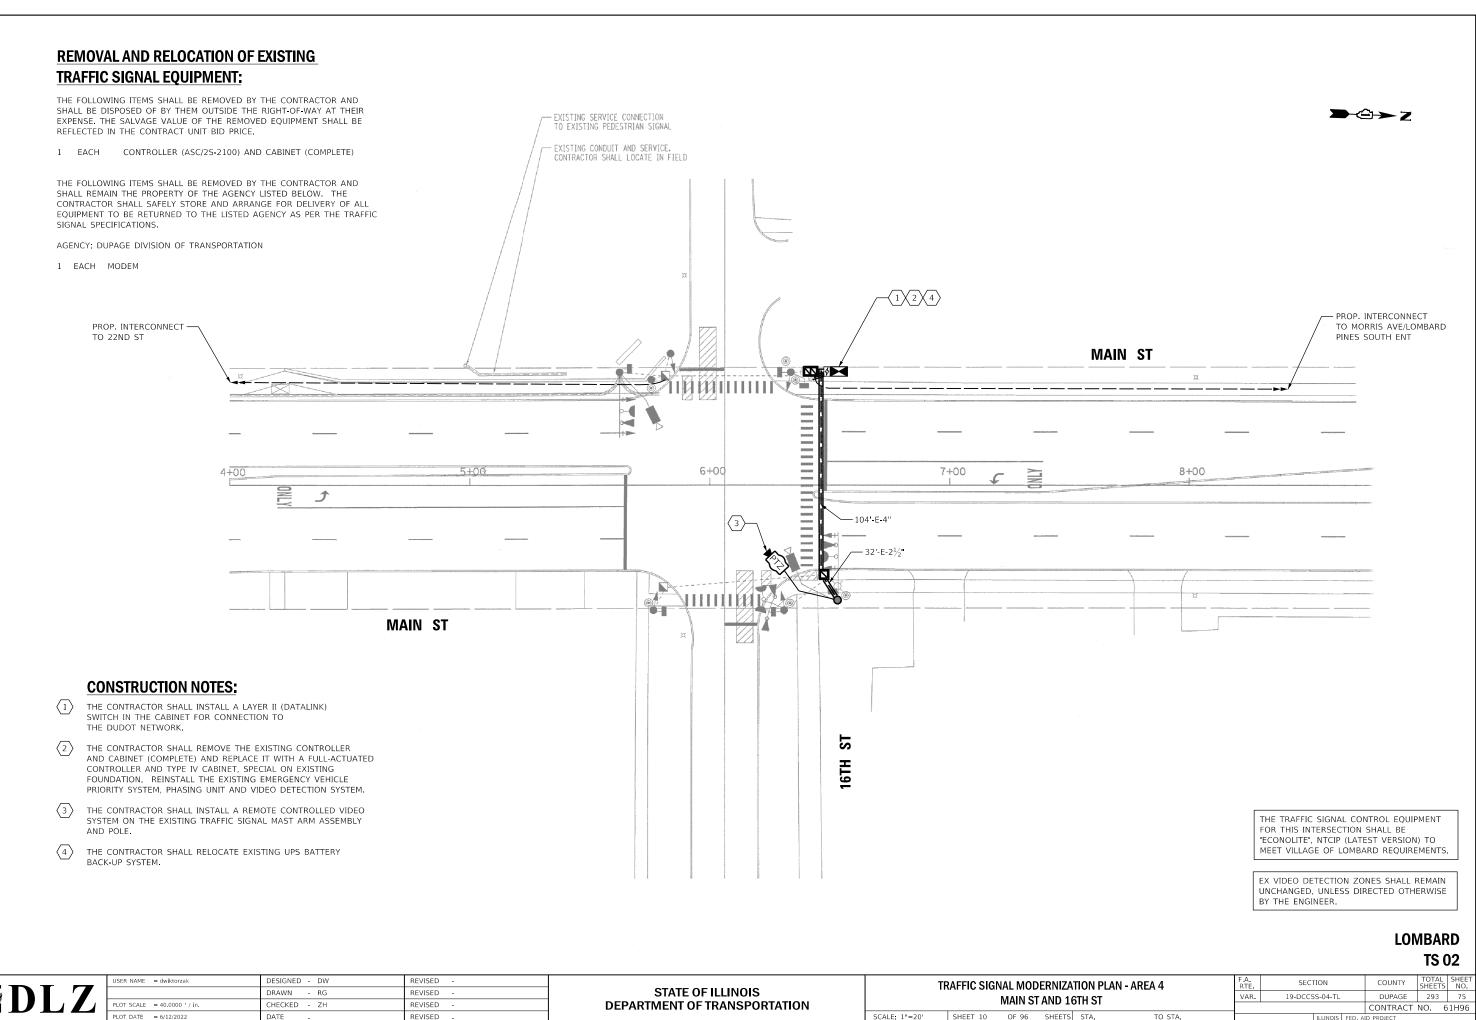

ILLINOIS FED, AID PF

	USER NAME = dwiktorzak	DESIGNED - DW	REVISED -		т	RAFFIC SIGI			ATION PL
		DRAWN - RG	REVISED -	STATE OF ILLINOIS	''		MAIN CT		
	PLOT SCALE = 40.0000 ' / in.	CHECKED - ZH	REVISED -	DEPARTMENT OF TRANSPORTATION			MAIN SI	AND 10	618 21
	PLOT DATE = 6/12/2022	DATE -	REVISED -		SCALE: 1"=20'	SHEET 10	OF 96	SHEETS	STA.

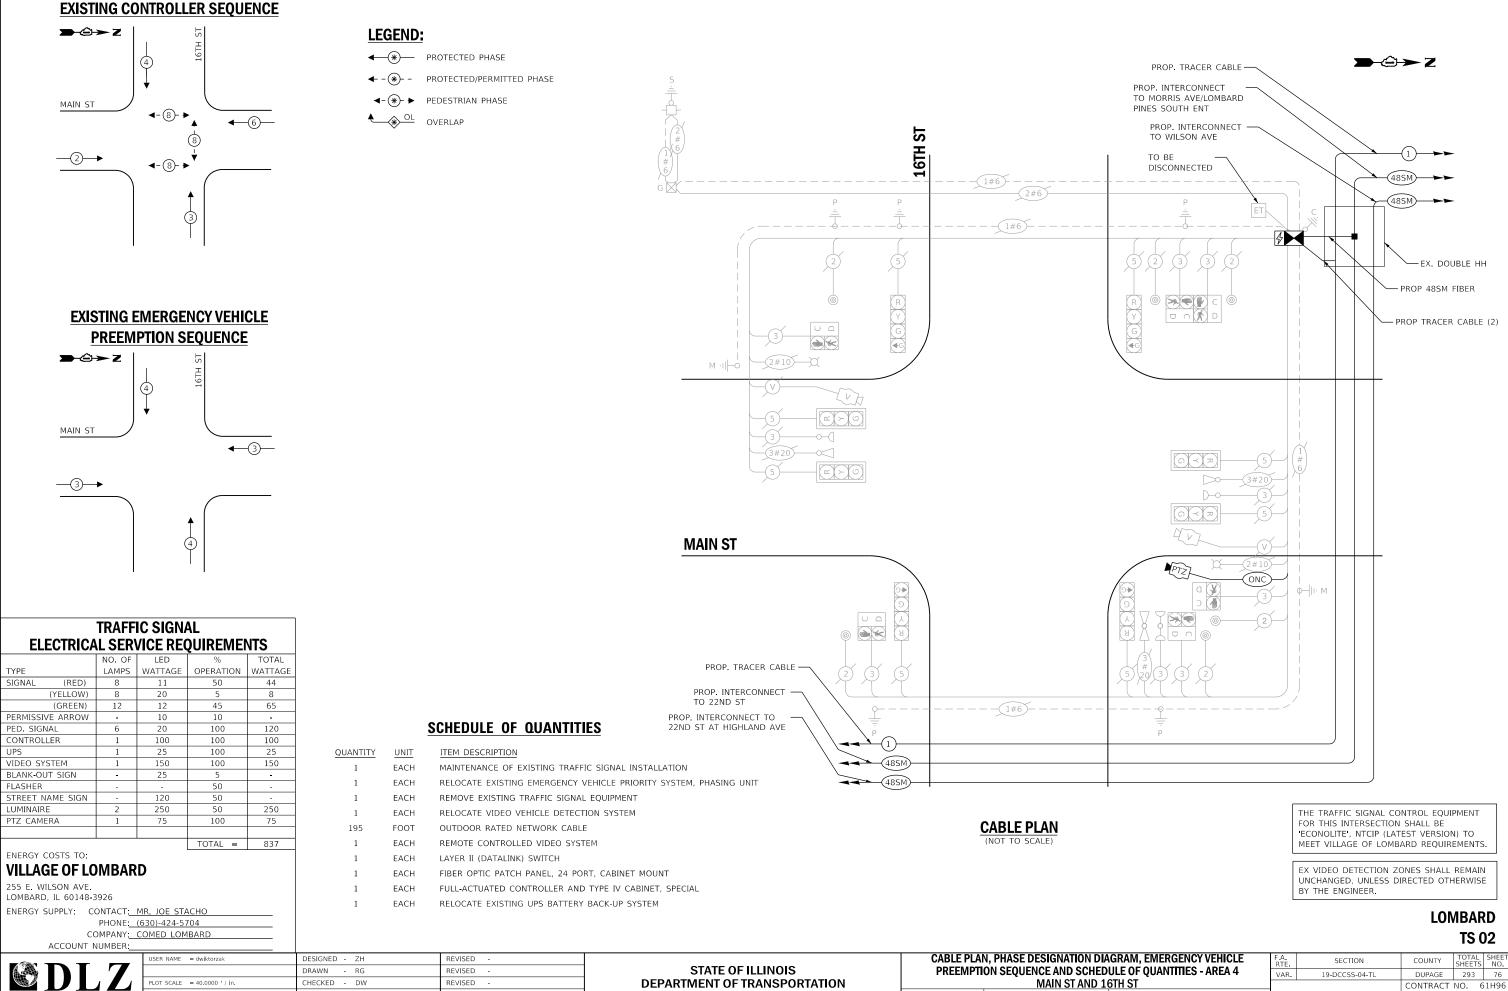

PLOT DATE = 6/12/2022

DATE

REVISED


SCALE:

SHEET 11

OF 96 SHEET

LOM	BA	RD
	TS	02

IAGRAM, EMERGENCY VEHICLE	F.A. RTE	SECTION		COUNTY	TOTAL SHEETS	SHEET NO.
DULE OF QUANTITIES - AREA 4 16th st	VAR.	19-DCCSS-04-TL		DUPAGE	293	76
1010.01				CONTRACT	NO. 6	1H96
TS STA. TO STA.		ILLINOIS	FED. AI	ID PROJECT		

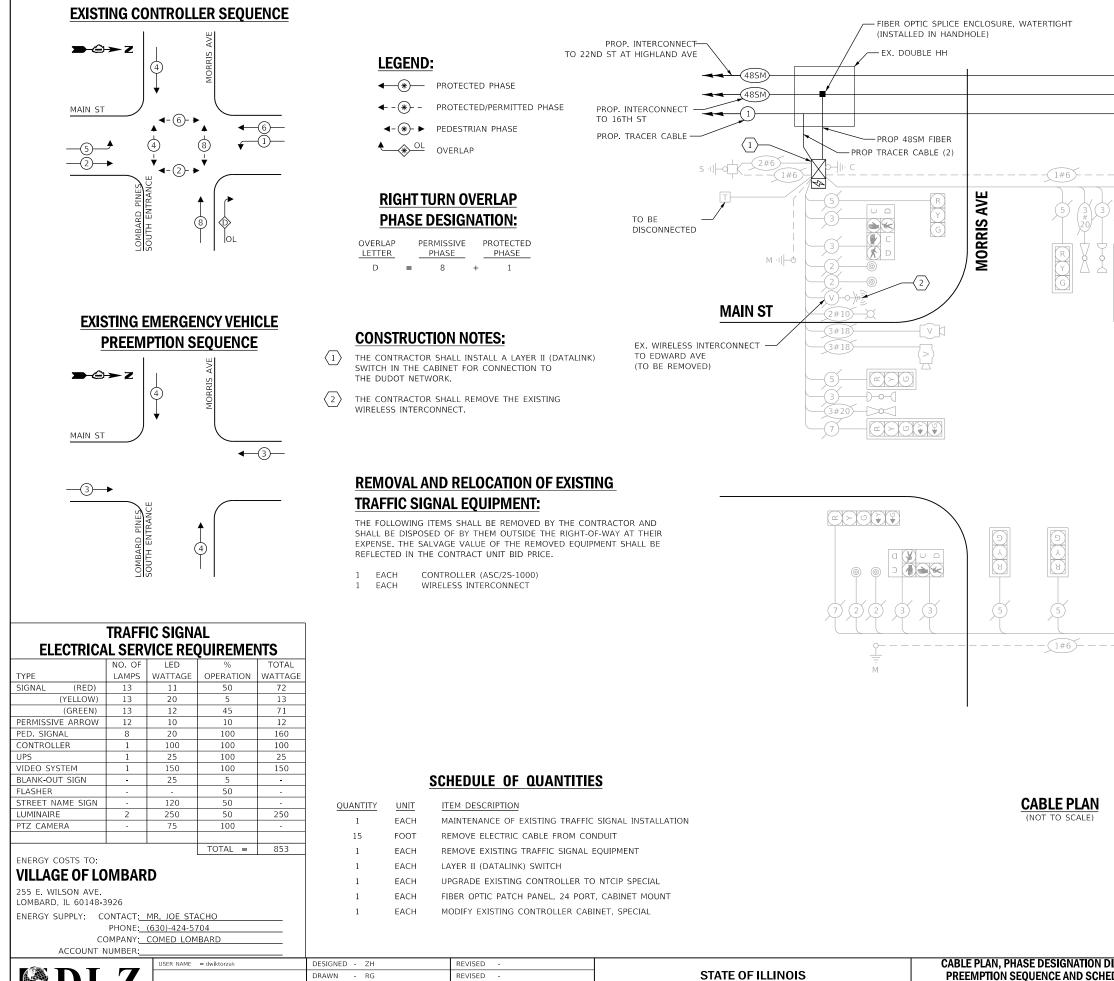

OT SCALE = 40.0000 ' / in.

PLOT DATE = 6/12/2022

HECKED - DW


DATE

REVISED

REVISED

DEPARTMENT OF TRANSPORTATION

MAIN ST AND MORRIS AVE/LOMBA SCALE: SHEET 12 OF 96 SHEET

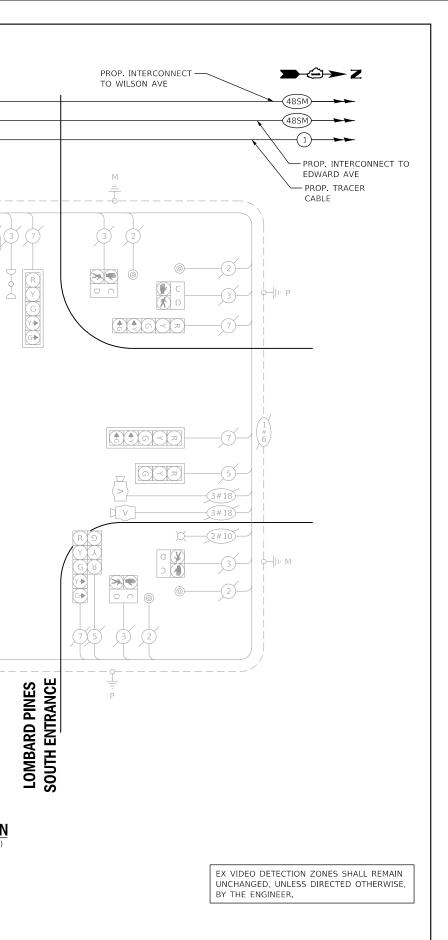

LOMBARD TS 03

DIAGRAM, EMERGENCY VEHICLE		F.A. RTE	SECTION		COUNTY	TOTAL SHEETS	SHEET NO.	
EDULE OF QUANTITIES - AREA 4			VAR.	19-DCCSS-04-TL		DUPAGE	293	77
ARD PINES SOUTH ENTRANCE						CONTRACT	NO. 6	51H96
ΤS	STA.	TO STA.		ILLINOIS	FED. AI	ID PROJECT		



THE FOLLOWING ITEMS SHALL BE REMOVED BY THE CONTRACTOR AND SHALL BE DISPOSED OF BY THEM OUTSIDE THE RIGHT-OF-WAY AT THEIR EXPENSE. THE SALVAGE VALUE OF THE REMOVED EQUIPMENT SHALL BE REFLECTED IN THE CONTRACT UNIT BID PRICE.

2 EACH WIRELESS INTERCONNECT


THE FOLLOWING ITEMS SHALL BE REMOVED BY THE CONTRACTOR AND SHALL REMAIN THE PROPERTY OF THE AGENCY LISTED BELOW. THE CONTRACTOR SHALL SAFELY STORE AND ARRANGE FOR DELIVERY OF ALL EQUIPMENT TO BE RETURNED TO THE LISTED AGENCY AS PER THE TRAFFIC SIGNAL SPECIFICATIONS.

SEV

108+6

AGENCY: DUPAGE DIVISION OF TRANSPORTATION

EACH MASTER CONTROLLER (ASC/2M-1000) EACH MODEM 1

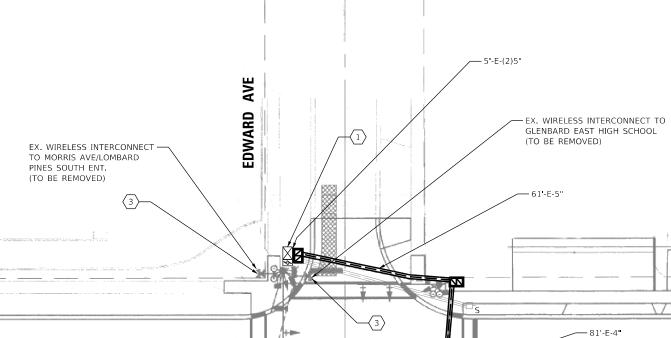

4

CONSTRUCTION NOTES:

PROP. INTERCONNECT TO MORRIS AVE/LOMBARD

PINES SOUTH ENT.

- THE CONTRACTOR SHALL INSTALL A LAYER II (DATALINK) SWITCH IN THE CABINET FOR CONNECTION TO $\langle 1 \rangle$ THE DUDOT NETWORK.
- THE CONTRACTOR SHALL INSTALL A REMOTE CONTROLLED $\langle 2 \rangle$ VIDEO SYSTEM ON THE EXISTING LUMINAIRE ARM.
- $\langle 3 \rangle$ THE CONTRACTOR SHALL REMOVE THE EXISTING WIRELESS INTERCONNECT.

EX VIDEO DETECTION ZONES SHALL REMAIN UNCHANGED, UNLESS DIRECTED OTHERWISE BY THE ENGINEER.

11

EDWARD AVE

-18'-E-3"

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MATCHLIN

 $\langle 2 \rangle$

523227

ONLY

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ľ	 USER NAME = dwiktorzak	DESIGNED - DW	REVISED -		п	RAFFIC SIGN		
		DRAWN - RG	REVISED -	STATE OF ILLINOIS	"			
	PLOT SCALE = 40.0000 ' / in.	CHECKED - ZH	REVISED -	DEPARTMENT OF TRANSPORTATION		IVI	AIN ST A	IND EL
	PLOT DATE = 6/12/2022	DATE -	REVISED -		SCALE: 1"=20'	SHEET 13	OF 96	SHEE


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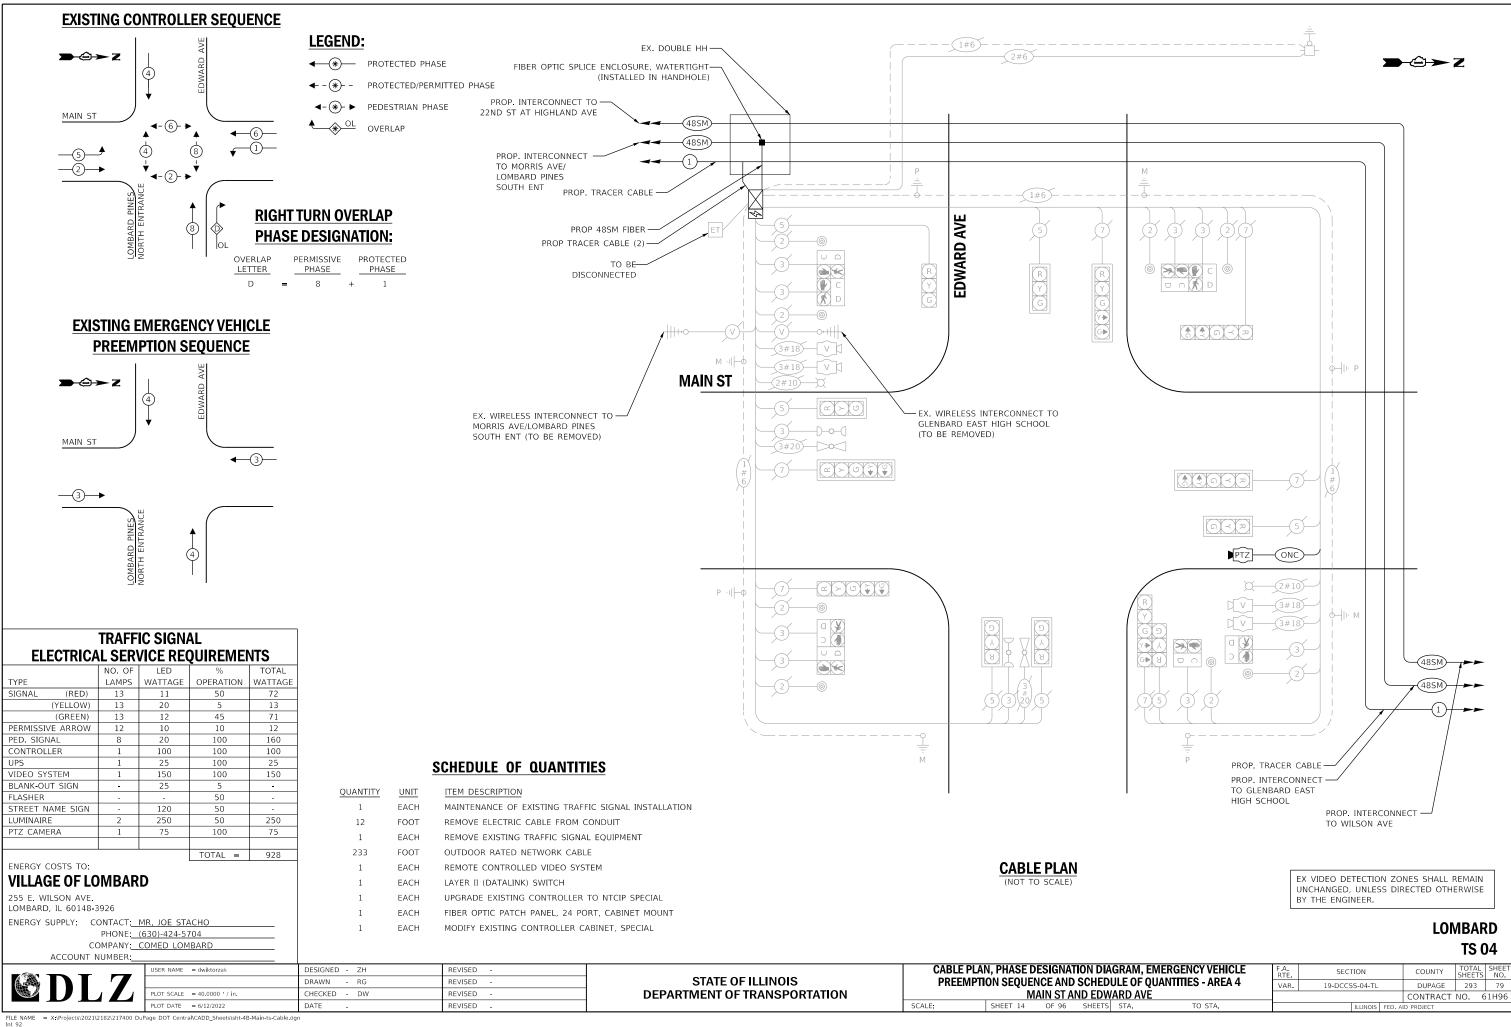
109+00


MAIN ST

1





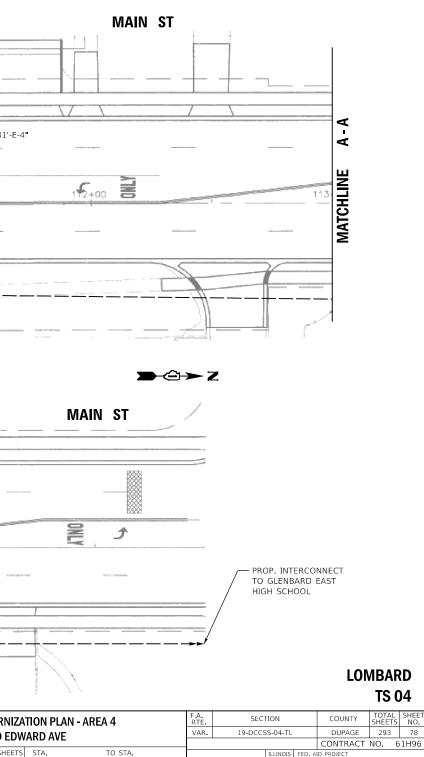

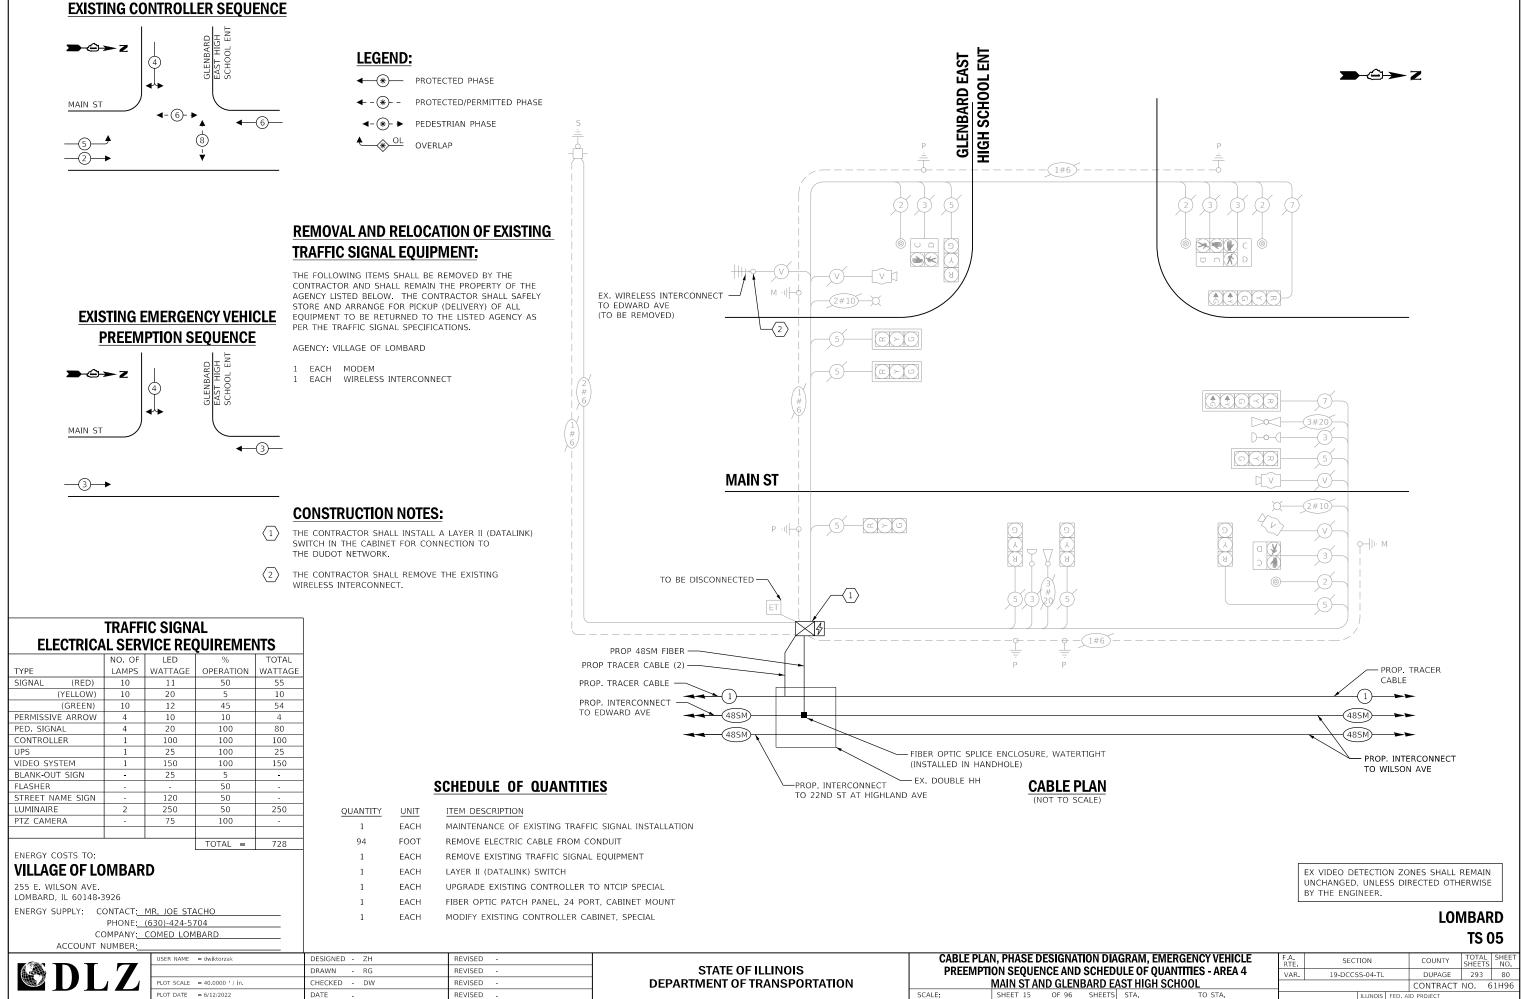

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REMOVAL AND RELOCATION OF EXISTING TRAFFIC SIGNAL EQUIPMENT:

THE FOLLOWING ITEMS SHALL BE REMOVED BY THE CONTRACTOR AND SHALL BE DISPOSED OF BY THEM OUTSIDE THE RIGHT-OF-WAY AT THEIR EXPENSE. THE SALVAGE VALUE OF THE REMOVED EQUIPMENT SHALL BE REFLECTED IN THE CONTRACT UNIT BID PRICE.

EACH CABINET (COMPLETE) WIRELESS INTERCONNECT EACH 1

THE FOLLOWING ITEMS SHALL BE REMOVED BY THE CONTRACTOR AND SHALL REMAIN THE PROPERTY OF THE AGENCY LISTED BELOW. THE CONTRACTOR SHALL SAFELY STORE AND ARRANGE FOR DELIVERY OF ALL EQUIPMENT TO BE RETURNED TO THE LISTED AGENCY AS PER THE TRAFFIC SIGNAL SPECIFICATIONS

AGENCY: VILLAGE OF LOMBARD

1 EACH CONTROLLER (ASC/3-2100)

PROP. INTERCONNECT TO GLENBARD EAST HIGH SCHOOL

DESIGNED - DW

DRAWN - RG

CHECKED - ZH

DATE

CONSTRUCTION NOTES:

- THE CONTRACTOR SHALL INSTALL A LAYER II (DATALINK) $\langle 1 \rangle$ SWITCH IN THE CABINET FOR CONNECTION TO THE DUDOT NETWORK.
- $\langle 2 \rangle$ THE CONTRACTOR SHALL REMOVE THE EXISTING CONTROLLER AND CABINET (COMPLETE) AND REPLACE IT WITH A FULL-ACTUATED CONTROLLER AND TYPE IV CABINET, SPECIAL ON EXISTING FOUNDATION. REINSTALL THE EXISTING EMERGENCY VEHICLE PRIORITY SYSTEM, PHASING UNIT.

MAIN ST

- $\langle 3 \rangle$ THE CONTRACTOR SHALL INSTALL A REMOTE CONTROLLED VIDEO SYSTEM ON THE EXISTING TRAFFIC SIGNAL MAST ARM ASSEMBLY AND POLE.
- THE CONTRACTOR SHALL REMOVE THE EXISTING WIRELESS $\langle 4 \rangle$ INTERCONNECT.
- $\langle 5 \rangle$ THE CONTRACTOR SHALL RELOCATE EXISTING UPS BATTERY BACK-UP SYSTEM.

JSER NAME = rgeorgescu

PLOT DATE = 6/14/2022

OT SCALE = 40.0000 ' / in.

EX. WIRELESS INTERCONNECT -TO EDWARD AVE (TO BE REMOVED)

 $\langle 1 \rangle \langle 2 \rangle \langle 5 \rangle$

11'-E-UNK

4

5'-E-(2)4"

AVE

WILSON

PROP. INTERCONNECT -TO VILLAGE COMPLEX

REVISED

REVISED

REVISED

REVISED

STATE OF ILLINOIS

DEPARTMENT OF TRANSPORTATION

INSTALLED AS PART OF INTERCONNECT WORK

TRAFFIC SIGNAL MODERNIZATION PLAN - AREA 4 MAIN ST AND WIL

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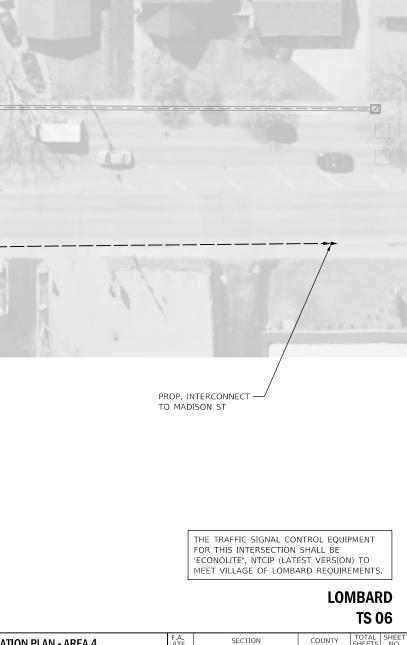
SCALE: 1"=20' SHEET 16 OF 96 SHEETS

AVE


WILSON



MAIN ST



л	HUN FLAN		RIE.					SHEELS	NO.
LSON AVE		VAR.	19-DCCS	5S-04-TL		DUPAGE	293	81	
						CONTRACT	NO. 6	1H96	
S	STA.	TO STA.			ILLINOIS	FED. A	ID PROJECT		

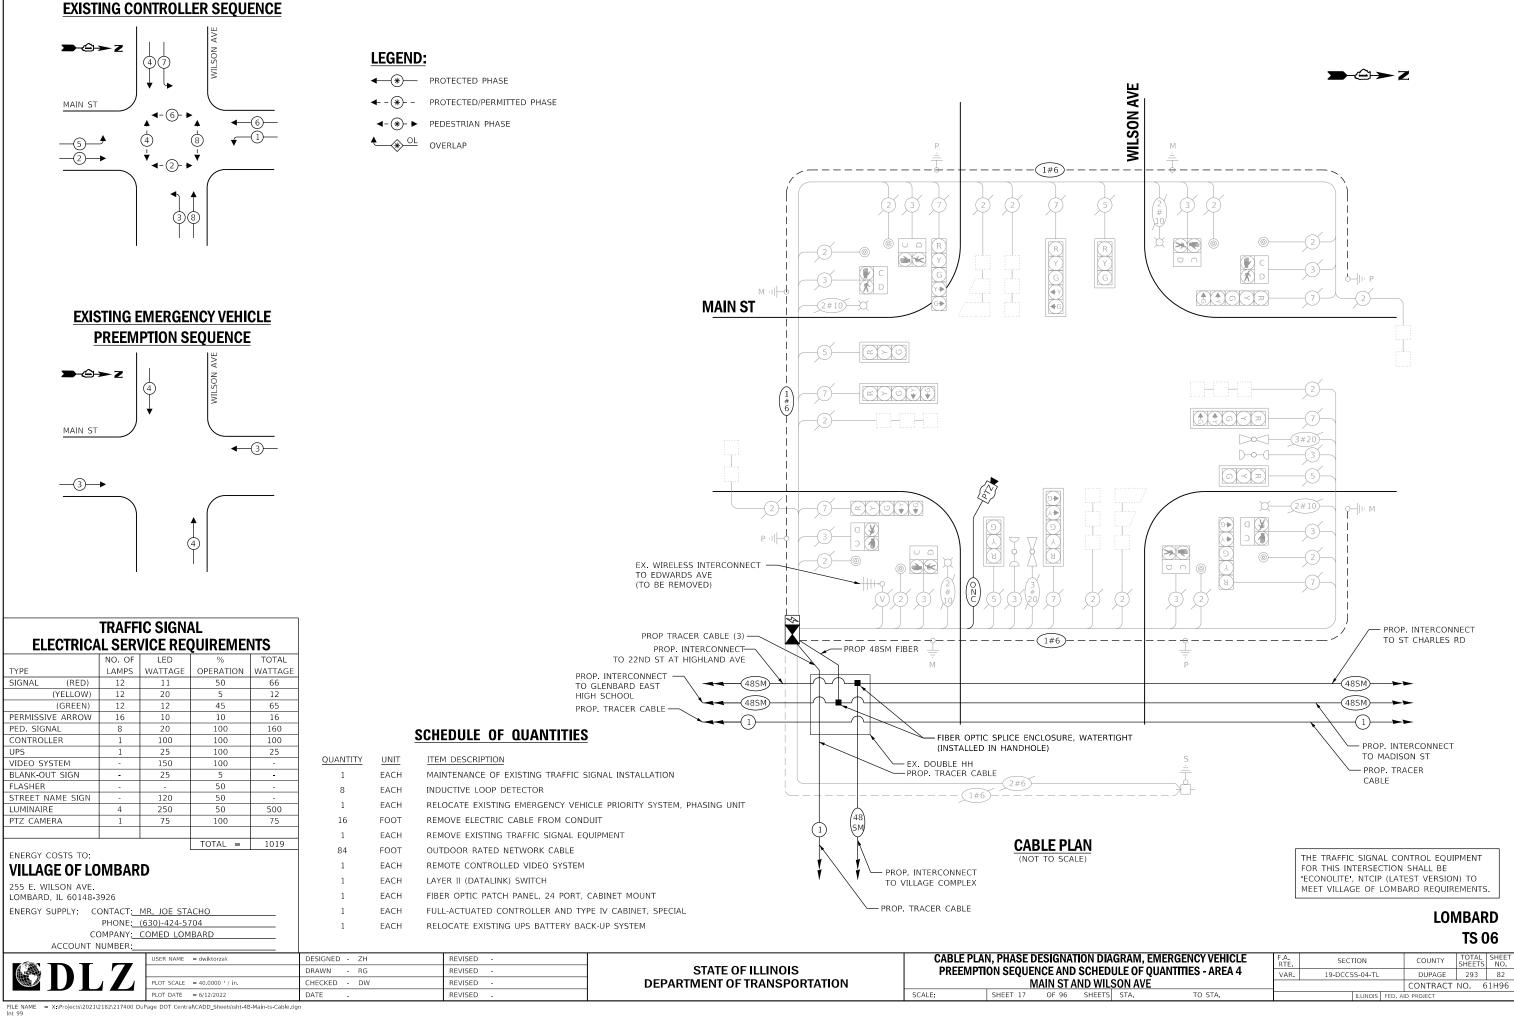

REMOVAL AND RELOCATION OF EXISTING TRAFFIC SIGNAL EQUIPMENT:

THE FOLLOWING ITEMS SHALL BE REMOVED BY THE CONTRACTOR AND SHALL BE DISPOSED OF BY THEM OUTSIDE THE RIGHT-OF-WAY AT THEIR EXPENSE. THE SALVAGE VALUE OF THE REMOVED EQUIPMENT SHALL BE REFLECTED IN THE CONTRACT UNIT BID PRICE.


1 EACH CABINET (COMPLETE) 1 EACH VIDEO DETECTION (COMPLETE)

THE FOLLOWING ITEMS SHALL BE REMOVED BY THE CONTRACTOR AND SHALL REMAIN THE PROPERTY OF THE AGENCY LISTED BELOW. THE CONTRACTOR SHALL SAFELY STORE AND ARRANGE FOR DELIVERY OF ALL EQUIPMENT TO BE RETURNED TO THE LISTED AGENCY AS PER THE TRAFFIC SIGNAL SPECIFICATIONS.

AGENCY: VILLAGE OF LOMBARD

1 EACH CONTROLLER (COBALT)



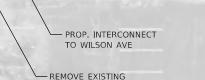

HANDHOLE (1)

MAIN ST

CONSTRUCTION NOTES:

- $\langle 1 \rangle$ THE CONTRACTOR SHALL INSTALL A LAYER II (DATALINK) SWITCH IN THE CABINET FOR CONNECTION TO THE DUDOT NETWORK.
- $\langle 2 \rangle$ THE CONTRACTOR SHALL REMOVE THE EXISTING CONTROLLER AND CABINET (COMPLETE) AND REPLACE IT WITH A FULL-ACTUATED CONTROLLER AND TYPE IV CABINET, SPECIAL ON EXISTING FOUNDATION. REINSTALL THE EXISTING EMERGENCY VEHICLE PRIORITY SYSTEM, PHASING UNIT.
- $\langle 3 \rangle$ THE CONTRACTOR SHALL INSTALL A REMOTE CONTROLLED VIDEO SYSTEM ON THE EXISTING LUMINAIRE ARM.
- $\langle 4 \rangle$ THE CONTRACTOR SHALL RELOCATE EXISTING UPS BATTERY BACK-UP SYSTEM.
- THE CONTRACTOR SHALL REMOVE THE EXISTING VEHICLE $\langle 5 \rangle$ DETECTION SYSTEM AND INSTALL THE PROPOSED VEHICLE DETECTION SYSTEM, SPECIAL.

			and the second		and the second second
	USER NAME = dwiktorzak	DESIGNED - DW	REVISED -		
		DRAWN - RG	REVISED -	STATE OF ILLINOIS	
	PLOT SCALE = 40.0000 / in.	CHECKED - ZH	REVISED -	DEPARTMENT OF TRANSPORTATION	
	PLOT DATE = 6/12/2022	DATE -	REVISED -		SCALE:
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ST

MADISON

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TRAFFIC SIGNAL MODERNIZA MAIN ST AND MA


-5'-E-(2)4"

ST


MADISON

FILE

LE: 1"=20' SHEET 18 OF 96 SHEETS

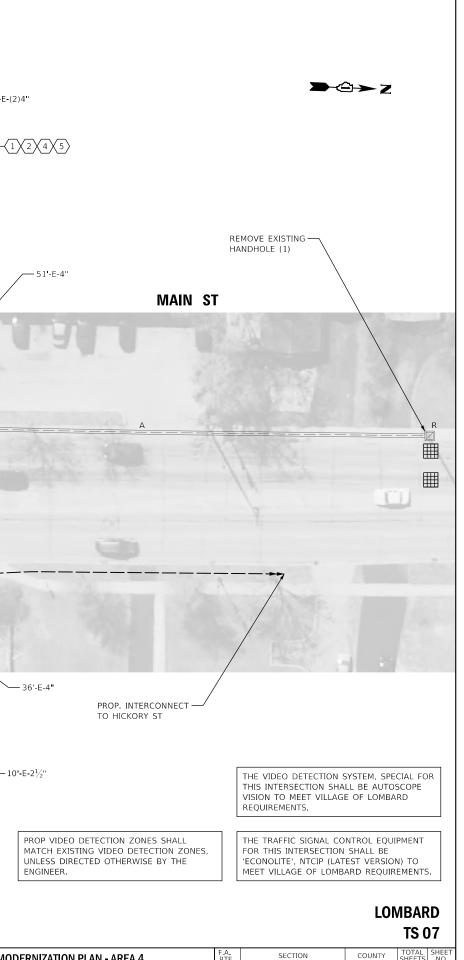

ZA'	TION PLAN - AREA 4	RTE	SECTIO	ON		COUNTY	SHEETS	NO.
ΔΠ	ISON ST	VAR.	19-DCCSS	-04-TL		DUPAGE	293	83
						CONTRACT	NO. 6	51H96
٢S	STA. TO STA.		П	LLINOIS	FED. AI	ID PROJECT		

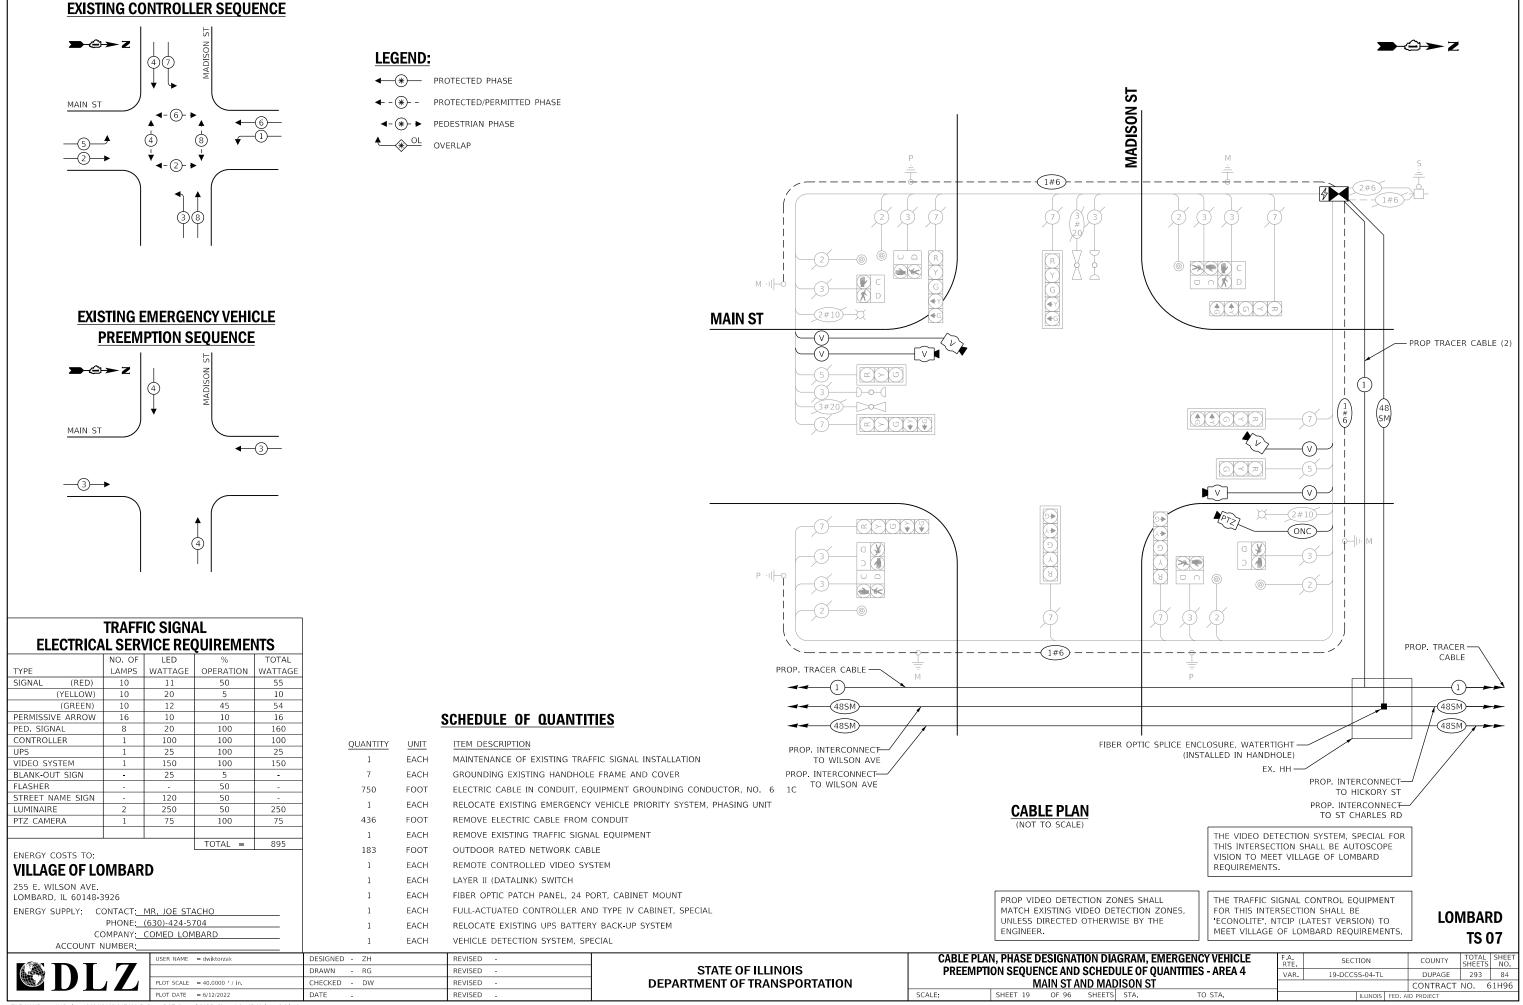

REMOVAL AND RELOCATION OF EXISTING TRAFFIC SIGNAL EQUIPMENT:

THE FOLLOWING ITEMS SHALL BE REMOVED BY THE CONTRACTOR AND SHALL BE DISPOSED OF BY THEM OUTSIDE THE RIGHT-OF-WAY AT THEIR EXPENSE. THE SALVAGE VALUE OF THE REMOVED EQUIPMENT SHALL BE REFLECTED IN THE CONTRACT UNIT BID PRICE.

CABINET (COMPLETE) VIDEO DETECTION (COMPLETE) EACH 1 1 EACH

THE FOLLOWING ITEMS SHALL BE REMOVED BY THE CONTRACTOR AND SHALL REMAIN THE PROPERTY OF THE AGENCY LISTED BELOW. THE CONTRACTOR SHALL SAFELY STORE AND ARRANGE FOR DELIVERY OF ALL EQUIPMENT TO BE RETURNED TO THE LISTED AGENCY AS PER THE TRAFFIC SIGNAL SPECIFICATIONS.

AGENCY: VILLAGE OF LOMBARD

 $\langle 1 \rangle$

 $\langle 2 \rangle$

 $\langle 3 \rangle$

 $\langle 4 \rangle$

 $\langle 5 \rangle$

1 EACH CONTROLLER (COBALT)

7'-E-2¹/₂" · MAIN ST 70'-E-4" - PROP. INTERCONNECT **CONSTRUCTION NOTES:** 5 -E-(2)4 THE CONTRACTOR SHALL INSTALL A LAYER II (DATALINK) SWITCH IN THE CABINET FOR CONNECTION TO ST THE CONTRACTOR SHALL REMOVE THE EXISTING CONTROLLER AND CABINET (COMPLETE) AND REPLACE IT WITH A FULL-ACTUATED CONTROLLER AND TYPE IV CABINET, SPECIAL ON EXISTING FOUNDATION. REINSTALL THE EXISTING EMERGENCY VEHICLE PRIORITY SYSTEM, PHASING UNIT. 1/2/4/5HICKORY THE CONTRACTOR SHALL INSTALL A REMOTE CONTROLLED VIDEO SYSTEM ON THE EXISTING LUMINAIRE ARM. THE CONTRACTOR SHALL RELOCATE EXISTING UPS BATTERY THE CONTRACTOR SHALL REMOVE THE EXISTING VEHICLE

STATE OF ILLINOIS

DEPARTMENT OF TRANSPORTATION

ENGINEER.

OT SCALE = 40.0000 ' / in.

PLOT DATE = 6/12/2022

DETECTION SYSTEM, SPECIAL. SER NAME = dwiktorzak

TO MADISON ST

DETECTION SYSTEM AND INSTALL THE PROPOSED VEHICLE

DESIGNED - DW

DRAWN - RG

CHECKED - ZH

DATE

REVISED

REVISED

REVISED


REVISED

THE DUDOT NETWORK.


BACK-UP SYSTEM.





MAIN ST

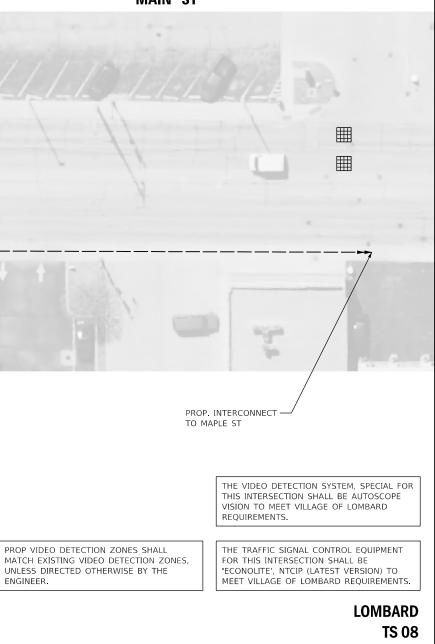


ATION PLAN - AREA 4	F.A. RTE	SECT	ΠΟΝ		COUNTY	TOTAL SHEETS	SHEET NO.
CKORY ST	VAR.	19-DCCS	S-04-TL		DUPAGE	293	85
					CONTRACT	NO. 6	1H96
TS STA. TO STA.			ILLINOIS	FED. A	ID PROJECT		

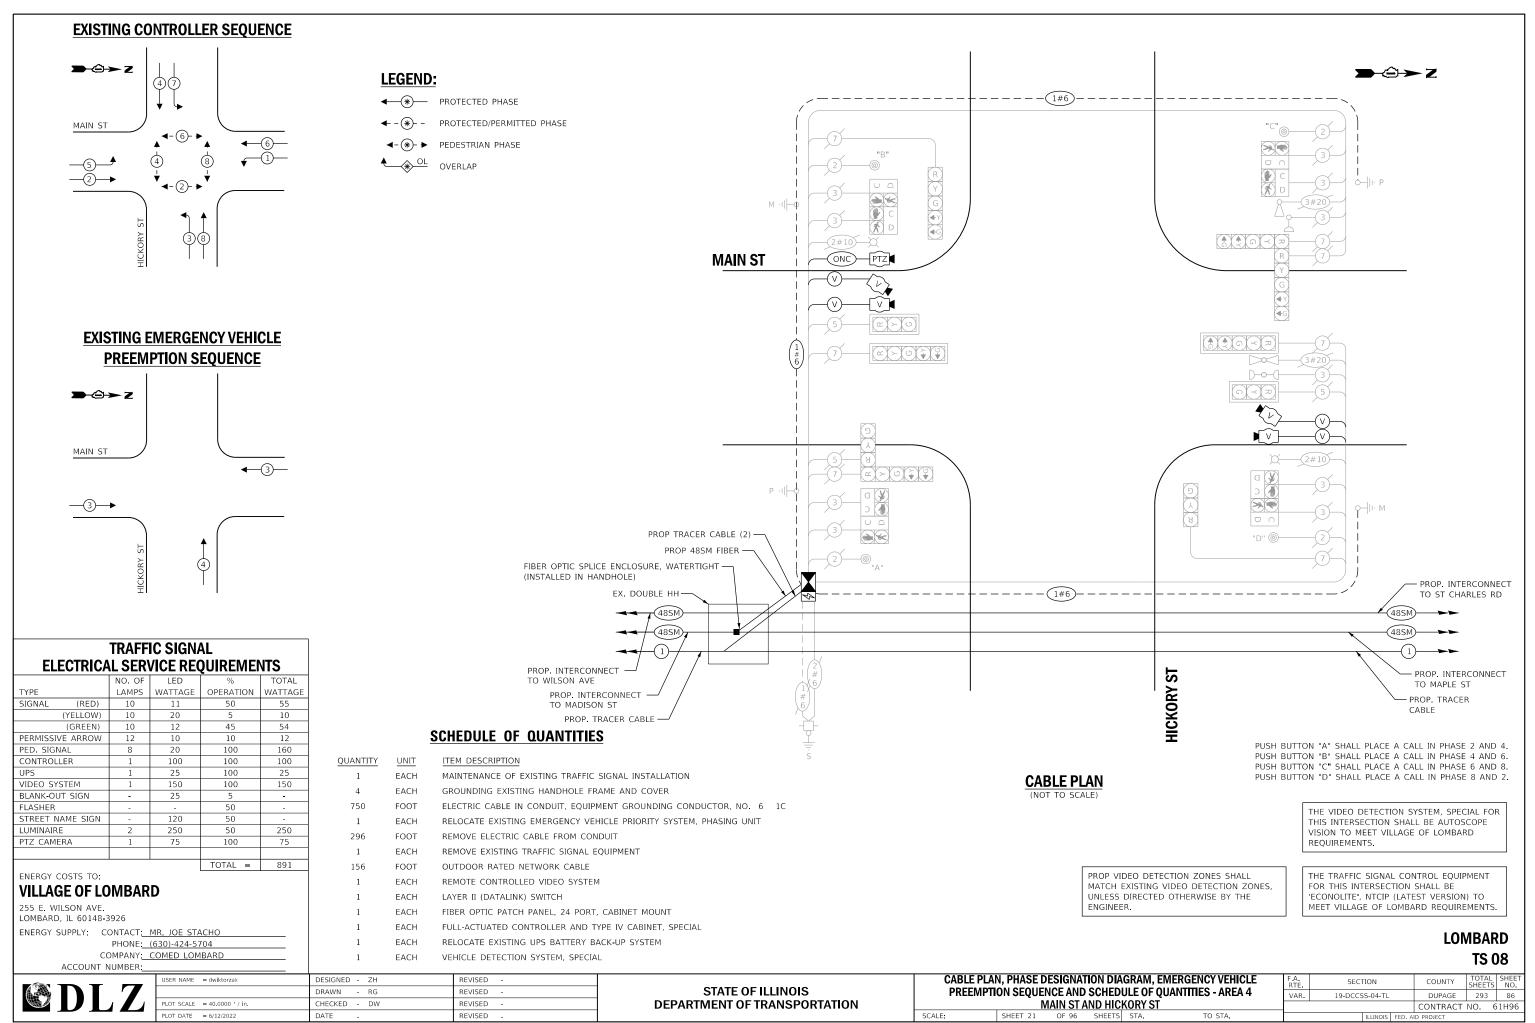


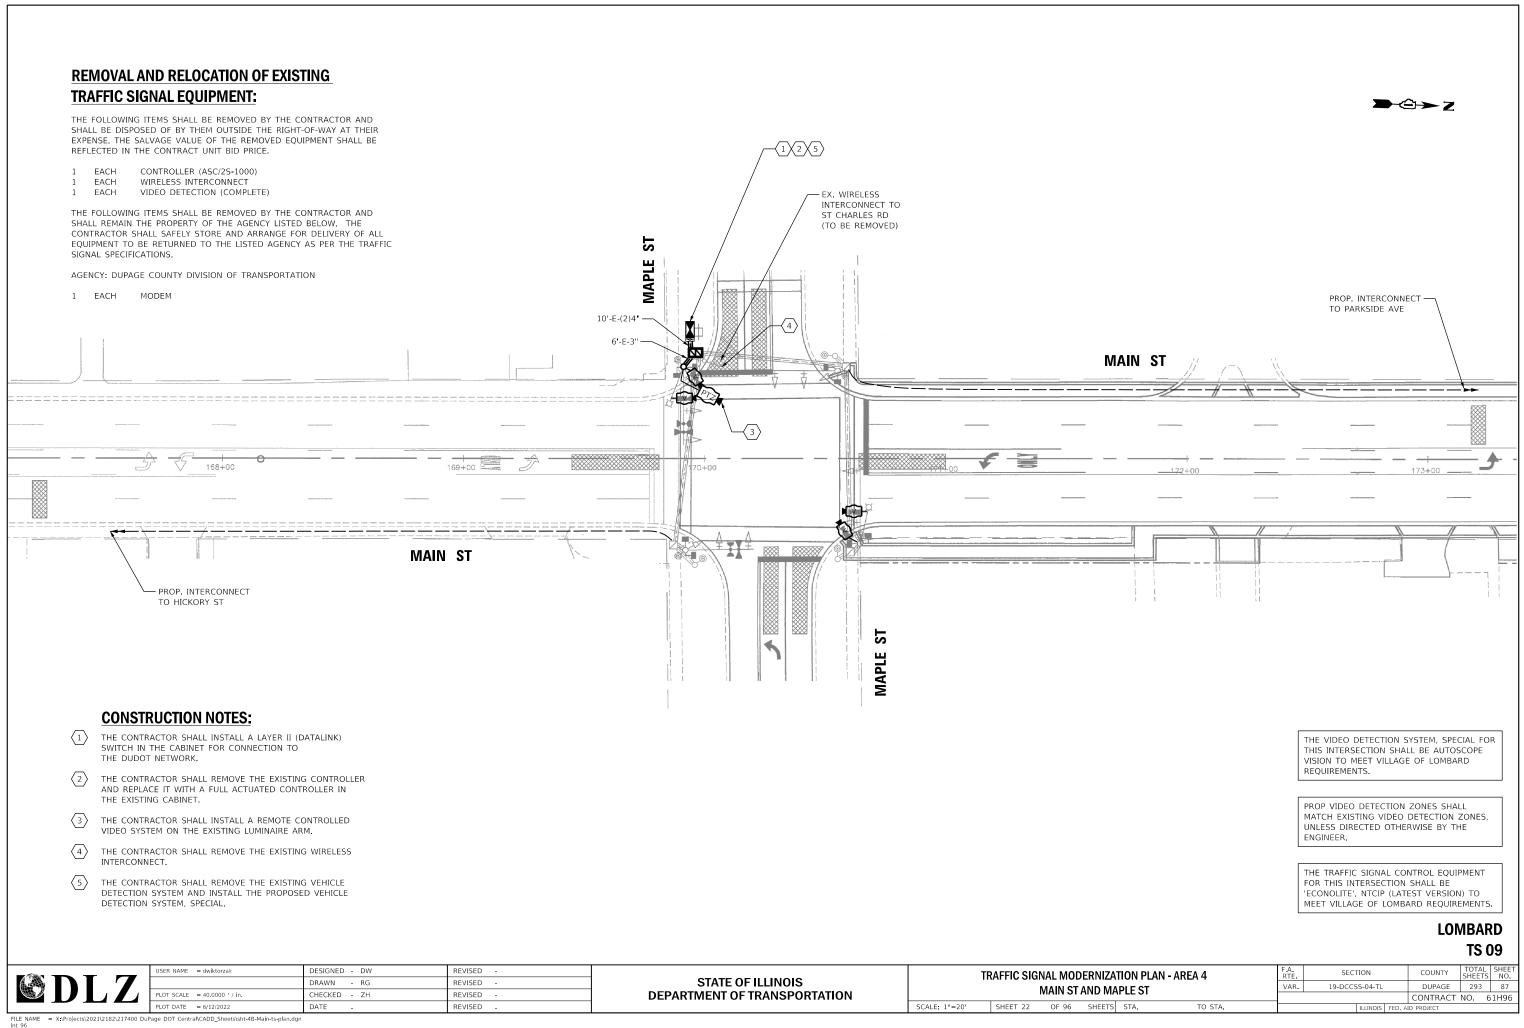

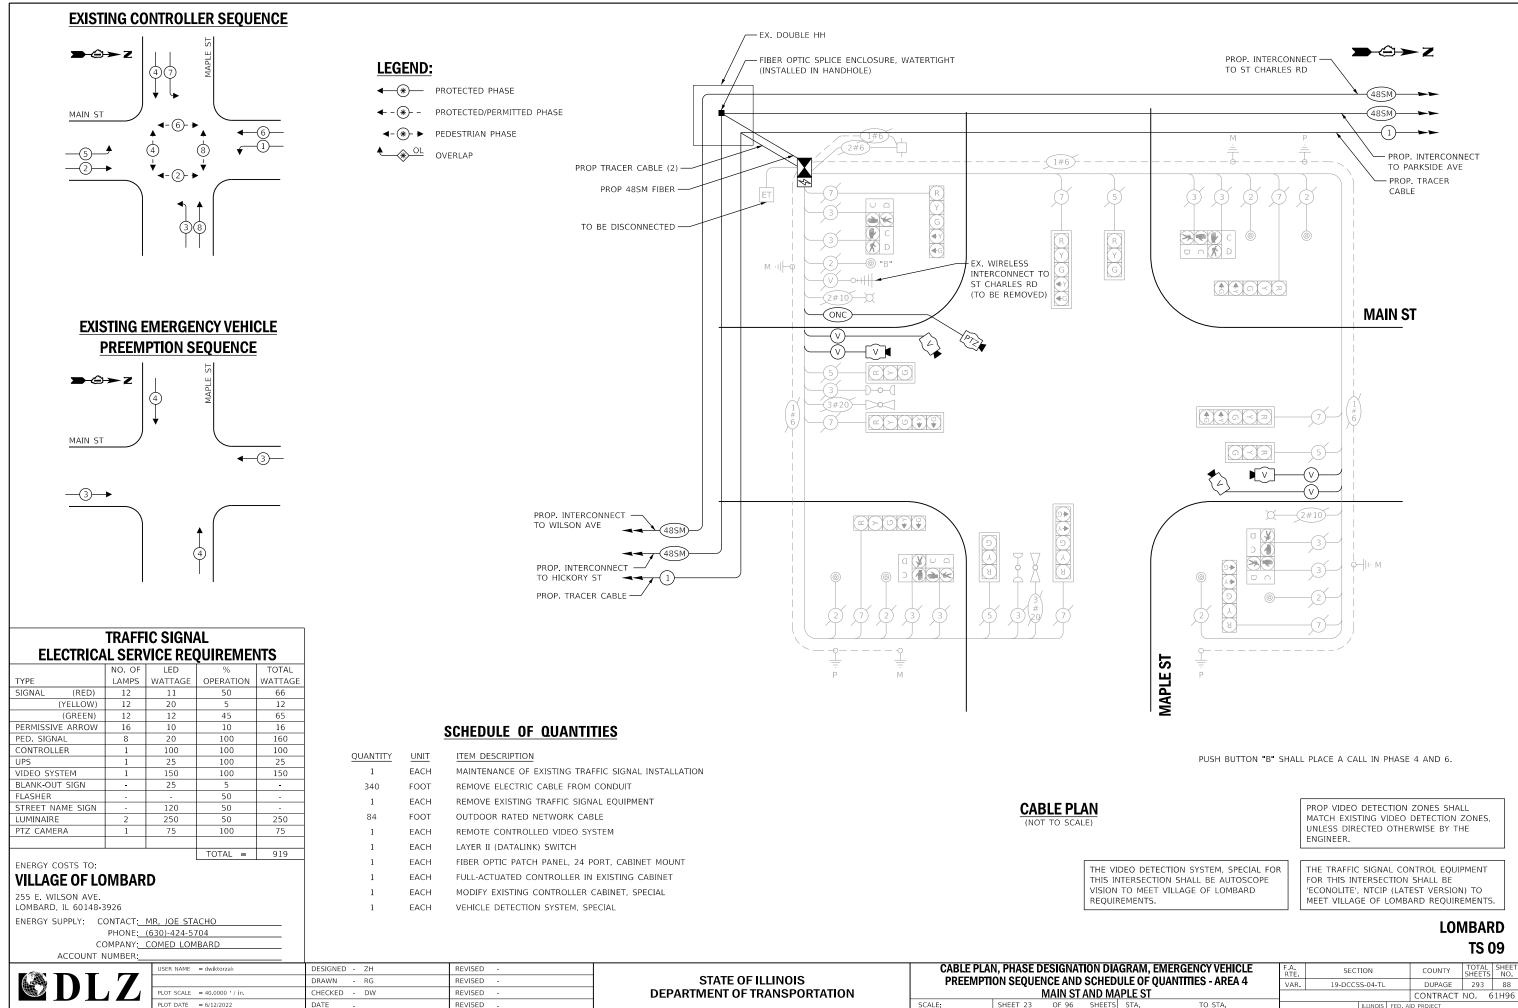

	•	UANTITIES - AREA 4	VAR.	19-DCCS	5S-04-TL		DUPAGE	293	88
ИĄ	PLE ST						CONTRACT	NO.	61H96
TS	STA.	TO STA.			ILLINOIS	FED. A	ID PROJECT		

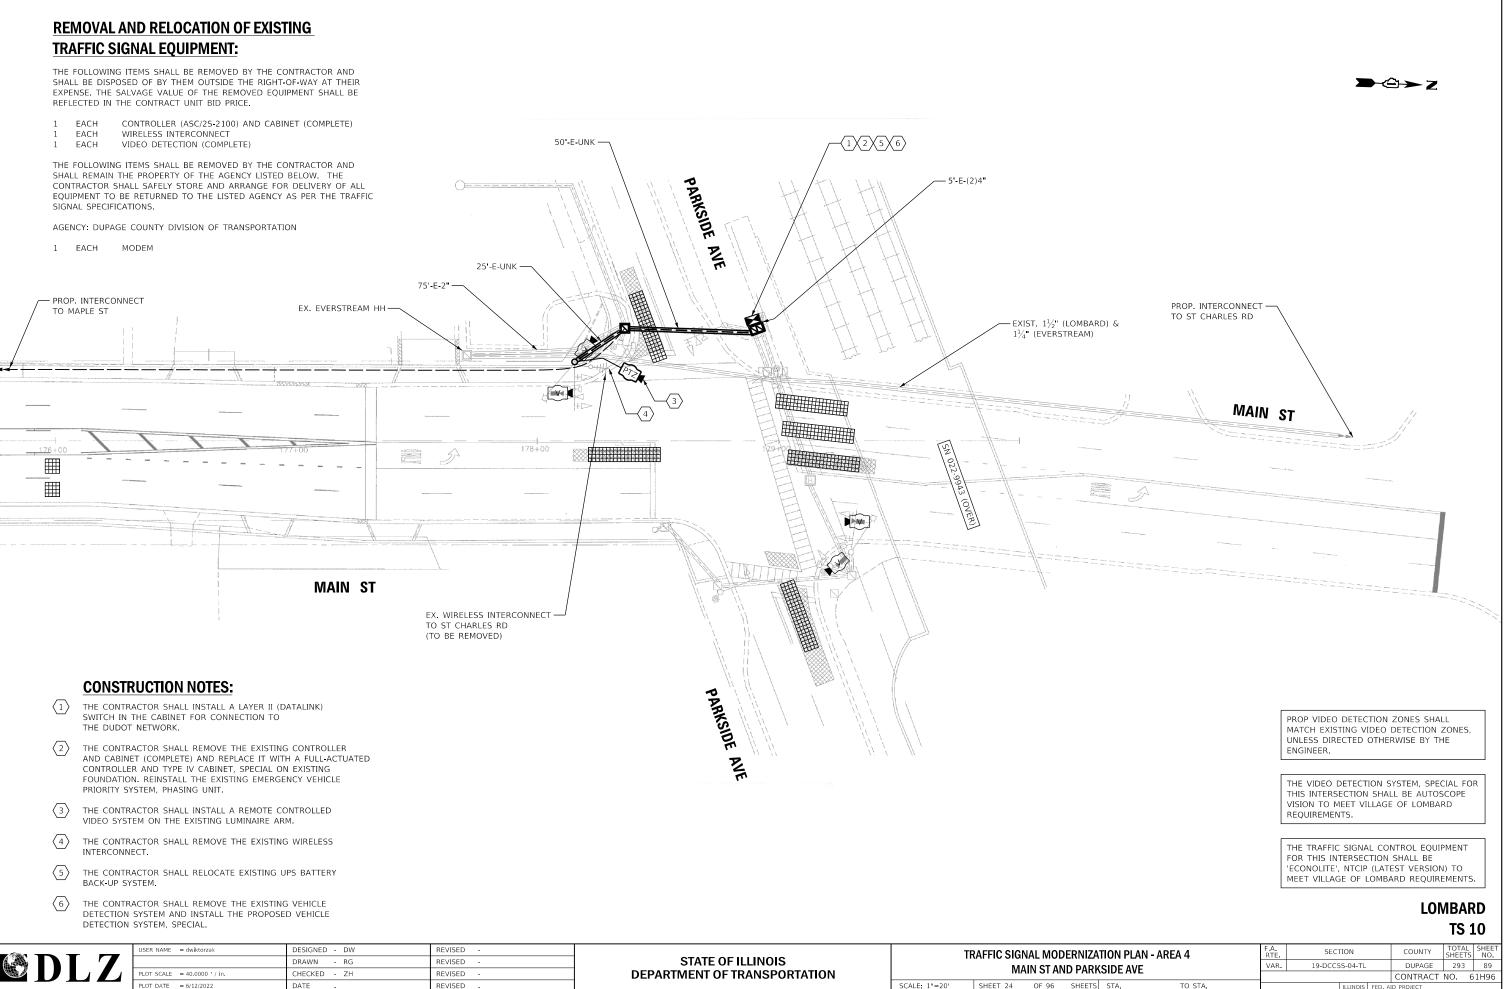


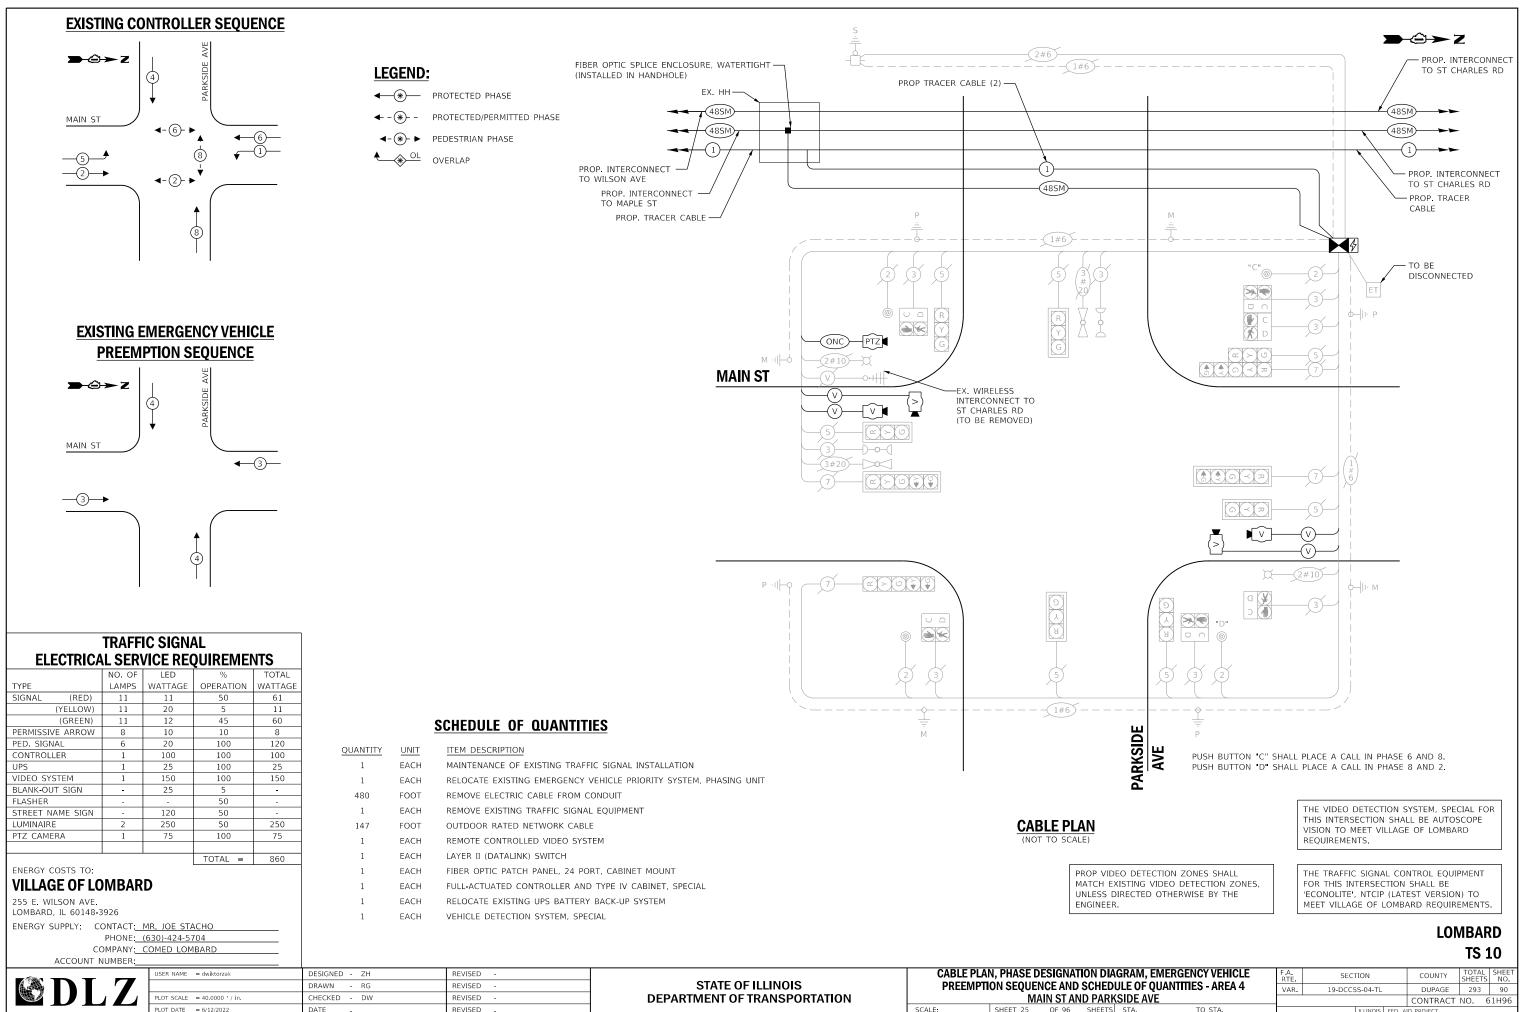

SCALE:


ILLINOIS FED AID PRO


REMOVAL AND RELOCATION OF EXISTING TRAFFIC SIGNAL EQUIPMENT:

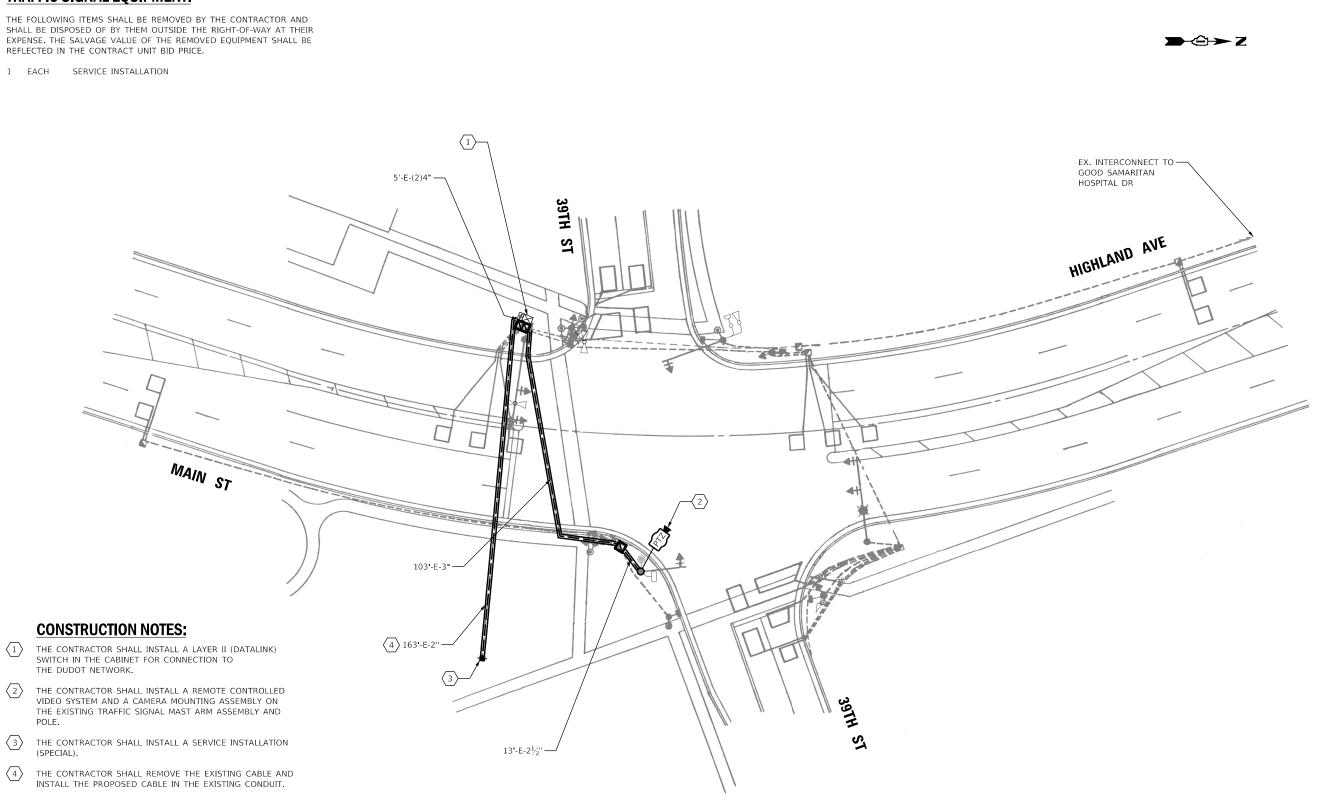


USER NAME = dwiktorzak	DESIGNED - DW	REVISED -		TRAFFIC SIGNAL MODERNIZATION PLAN - AREA 4	F.A. SECTION	COUNTY TOTAL SHEET SHEETS NO.
	DRAWN - RG	REVISED -	STATE OF ILLINOIS		VAR. 19-DCCSS-04-TL	DUPAGE 293 91
PLOT SCALE = 40.0000 / in.	CHECKED - ZH	REVISED -	DEPARTMENT OF TRANSPORTATION	HIGHLAND AVE/MAIN ST AND 39TH ST		CONTRACT NO. 61H96
PLOT DATE = 6/12/2022	DATE -	REVISED -		SCALE: 1"=20' SHEET 26 OF 96 SHEETS STA. TO STA.	ILLINOIS F	ED. AID PROJECT

DUDOT

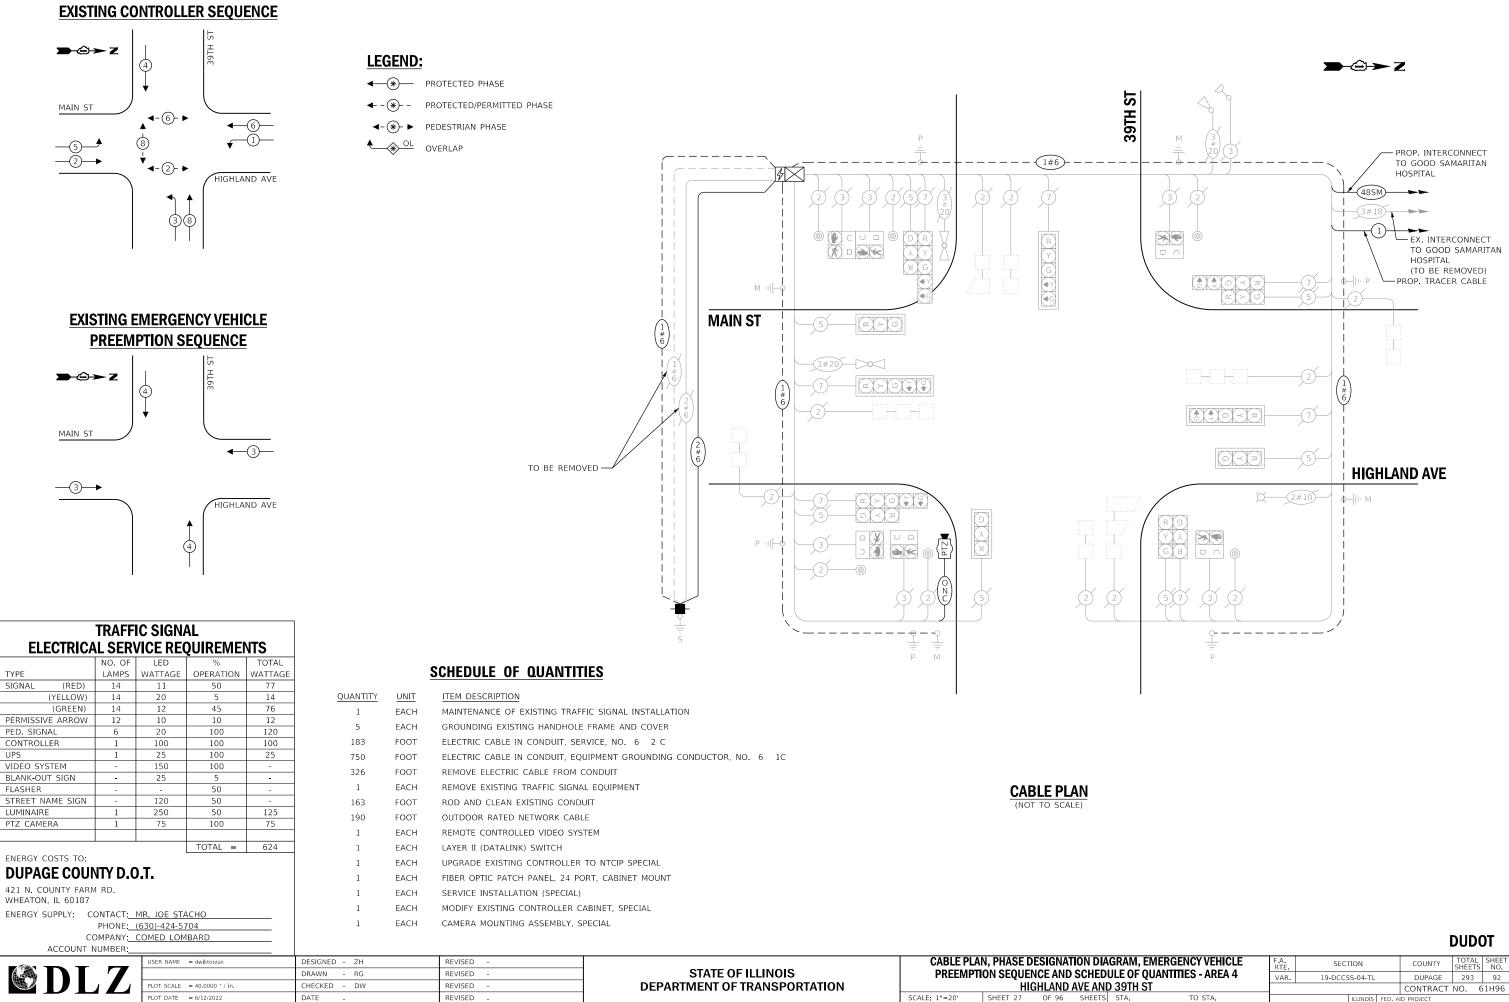

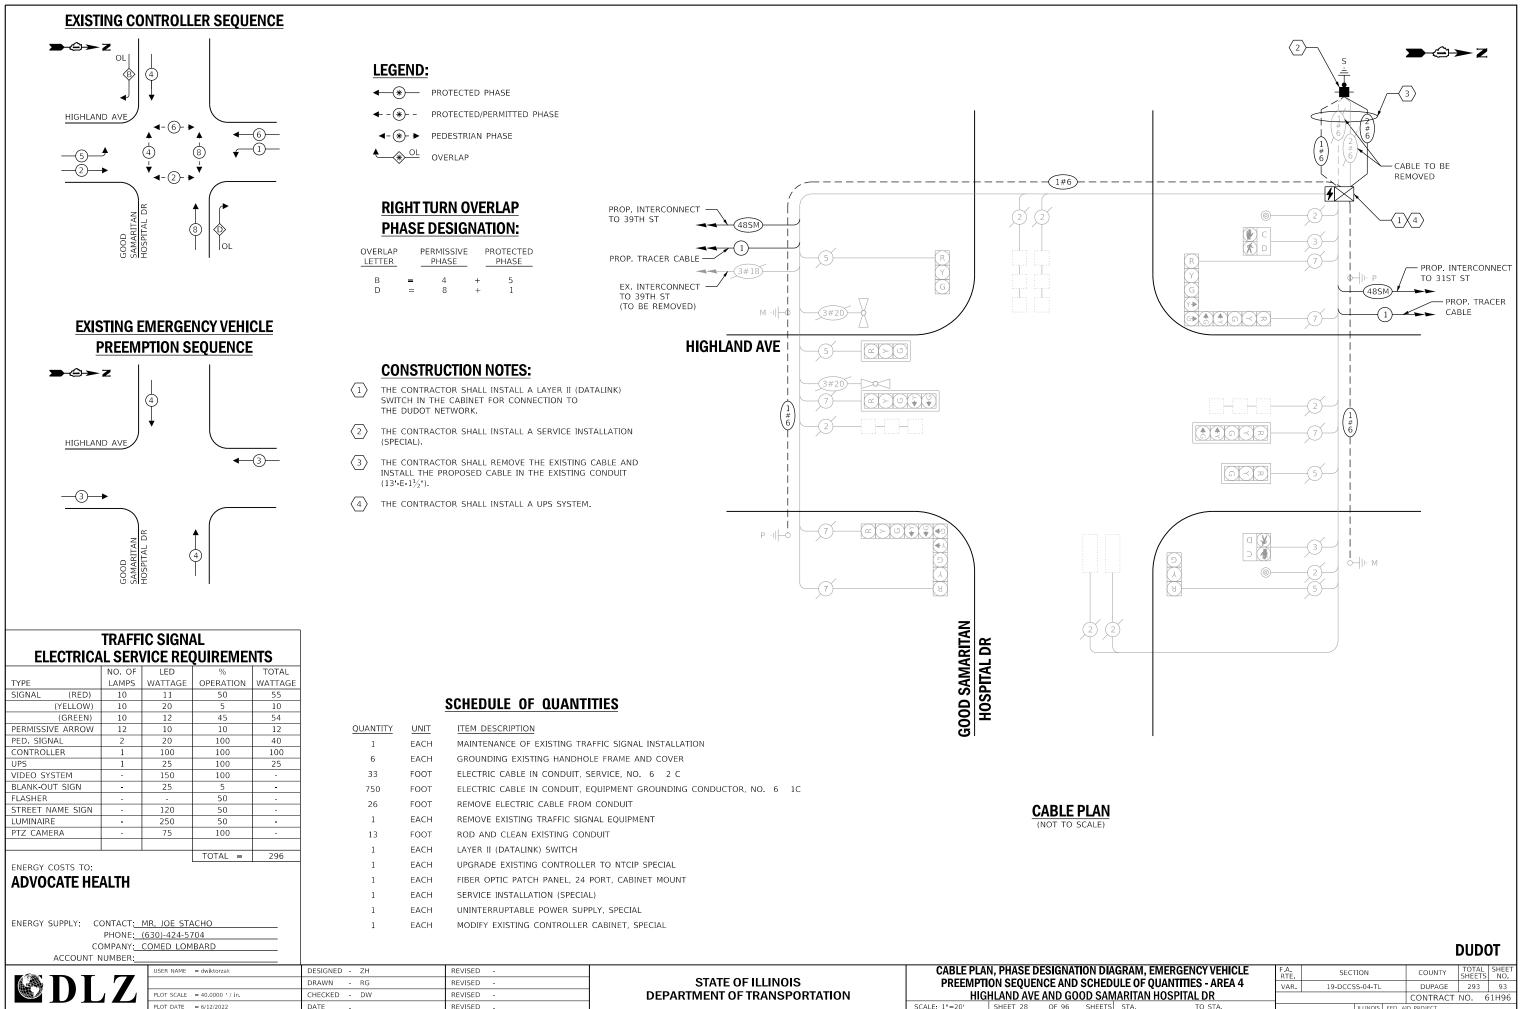

SCALE: 1"=20' SHEET 28 OF 96 SHEETS STA.

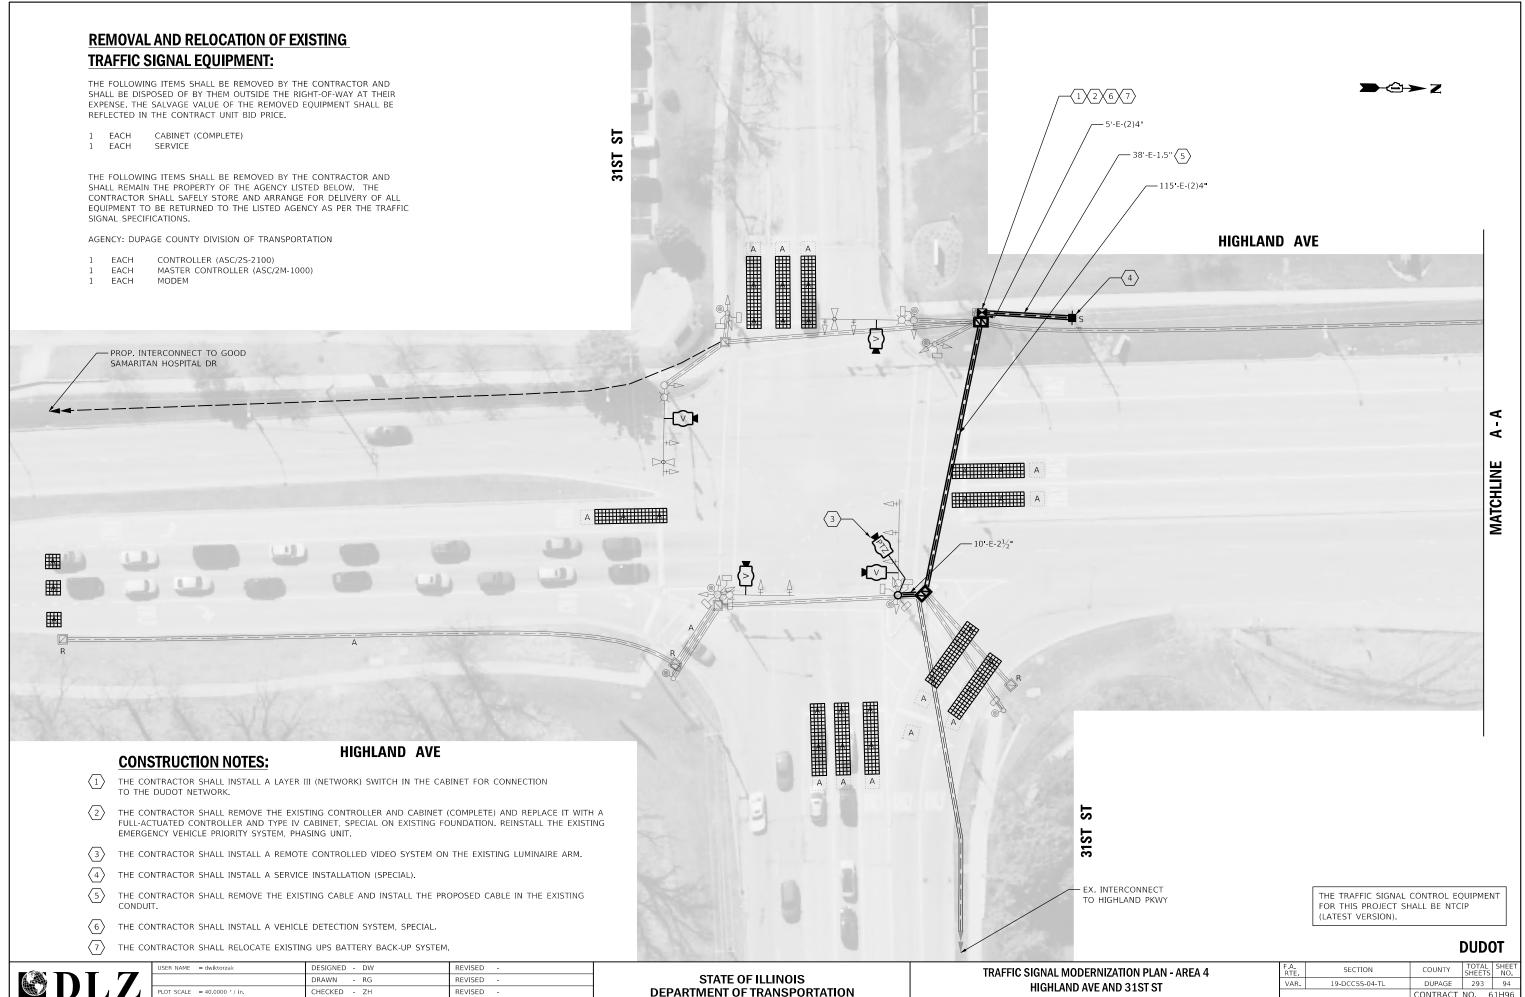

FILE NAME Int 29 X:\Projects\2021\2182\217400 DuPage DOT Central\CADD_Sheets\sht-4C-Highland-ts-plan.dgn

PLOT DATE = 6/12/2022


DATE

DEPARTMENT OF TRANSPORTATION

REVISED

SCALE: 1"=20' SHEET 29 OF 96 SHEET!


ZATION PLAN - AREA 4 ND 31ST ST		SECTION			COUNTY	TOTAL SHEETS	SHEET NO.
		19-DCCSS-04-TL			DUPAGE	293	94
					CONTRACT	NO. 6	1H96
TS STA. TO STA.	ILLINOIS FED.				ID PROJECT		

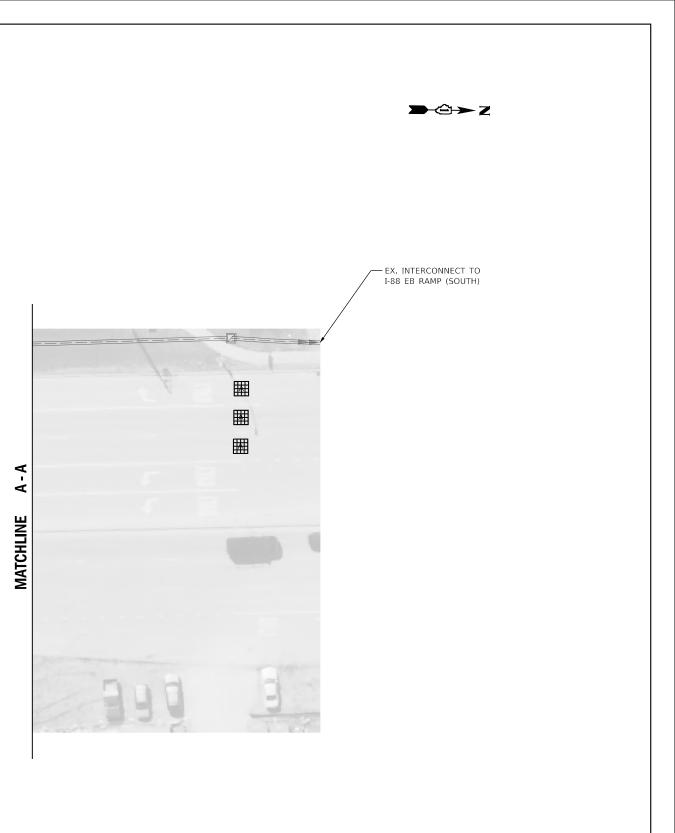


	USER NAME = dwiktorzak DESIGNED - DW REVISED -		REVISED -			TRAFFIC SIGNAL MODERNIZATION PLAN - AREA 4	F.A. RTE	SECTION	COUNTY TOTAL SHEET SHEETS NO.
	DRAWN RG REVISED STATE OF ILLINOIS PLOT SCALE = 40.0000 / in CHECKED ZH REVISED DEPARTMENT OF TRANSPORTATION	STATE OF ILLINOIS			VAR.	19-DCCSS-04-TL	DUPAGE 293 95		
		CHECKED - ZH REVISED -	DEPARTMENT OF TRANSPORTATION	HIGHLAND AVE AND 31ST ST				CONTRACT NO. 61H96	
	PLOT DATE = 6/12/2022	DATE -	REVISED -		SCALE:	SHEET 30 OF 96 SHEETS STA. TO STA.		ILLINOIS FED. A	D PROJECT


THE TRAFFIC SIGNAL CONTROL EQUIPMENT FOR THIS PROJECT SHALL BE NTCIP (LATEST VERSION).


DUDOT

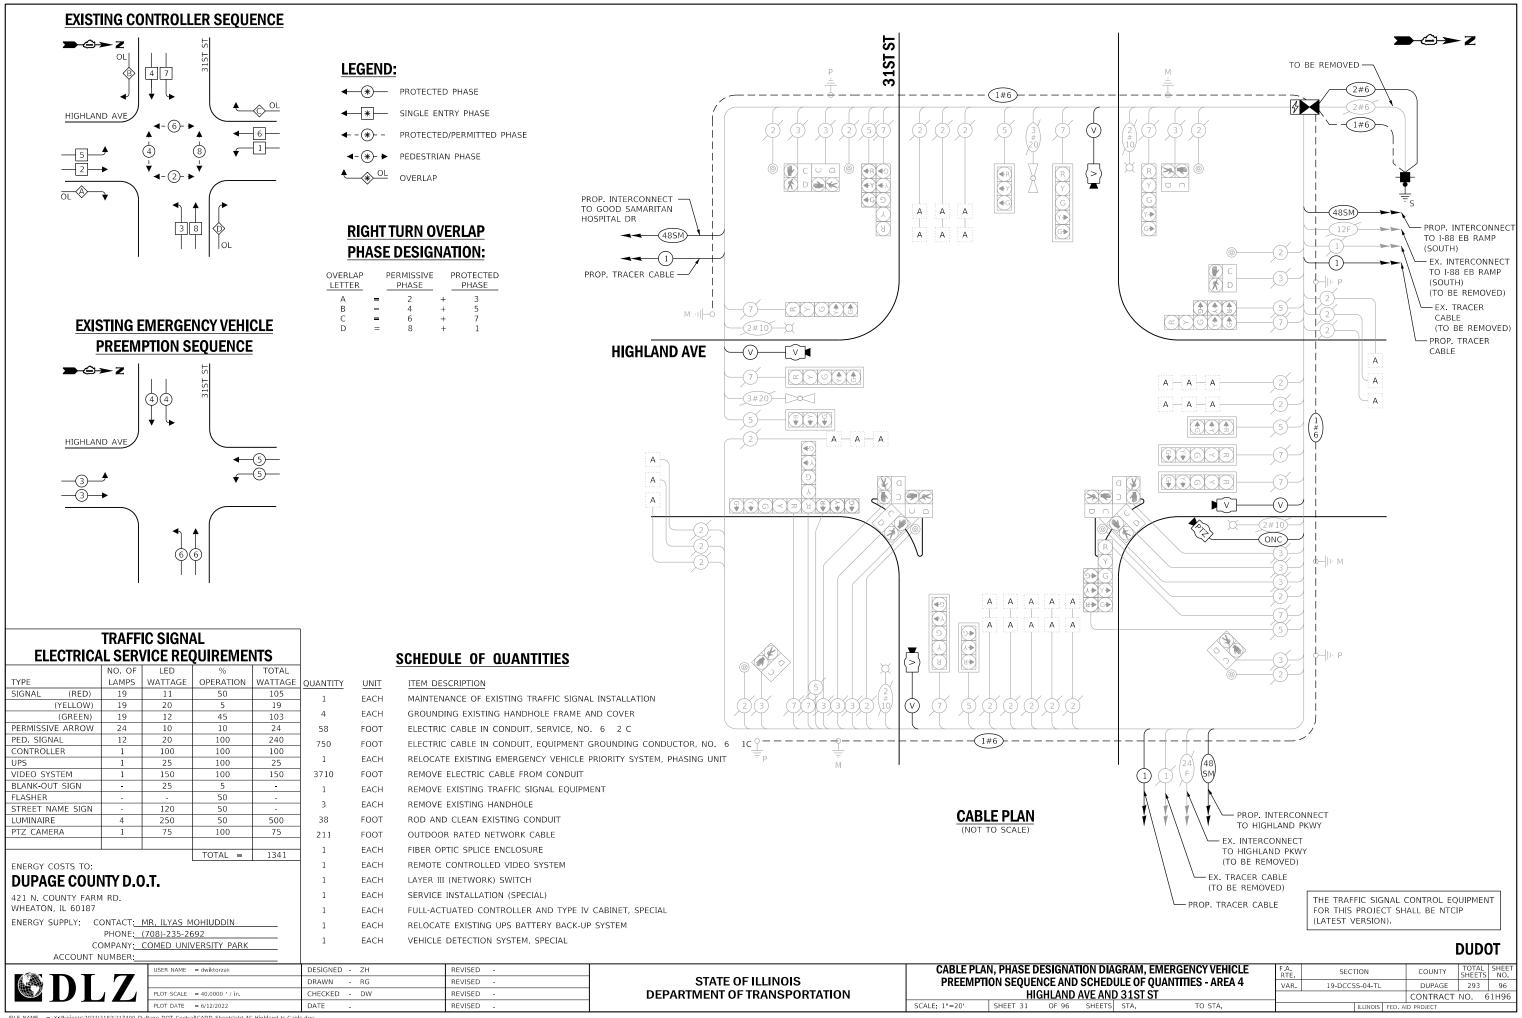


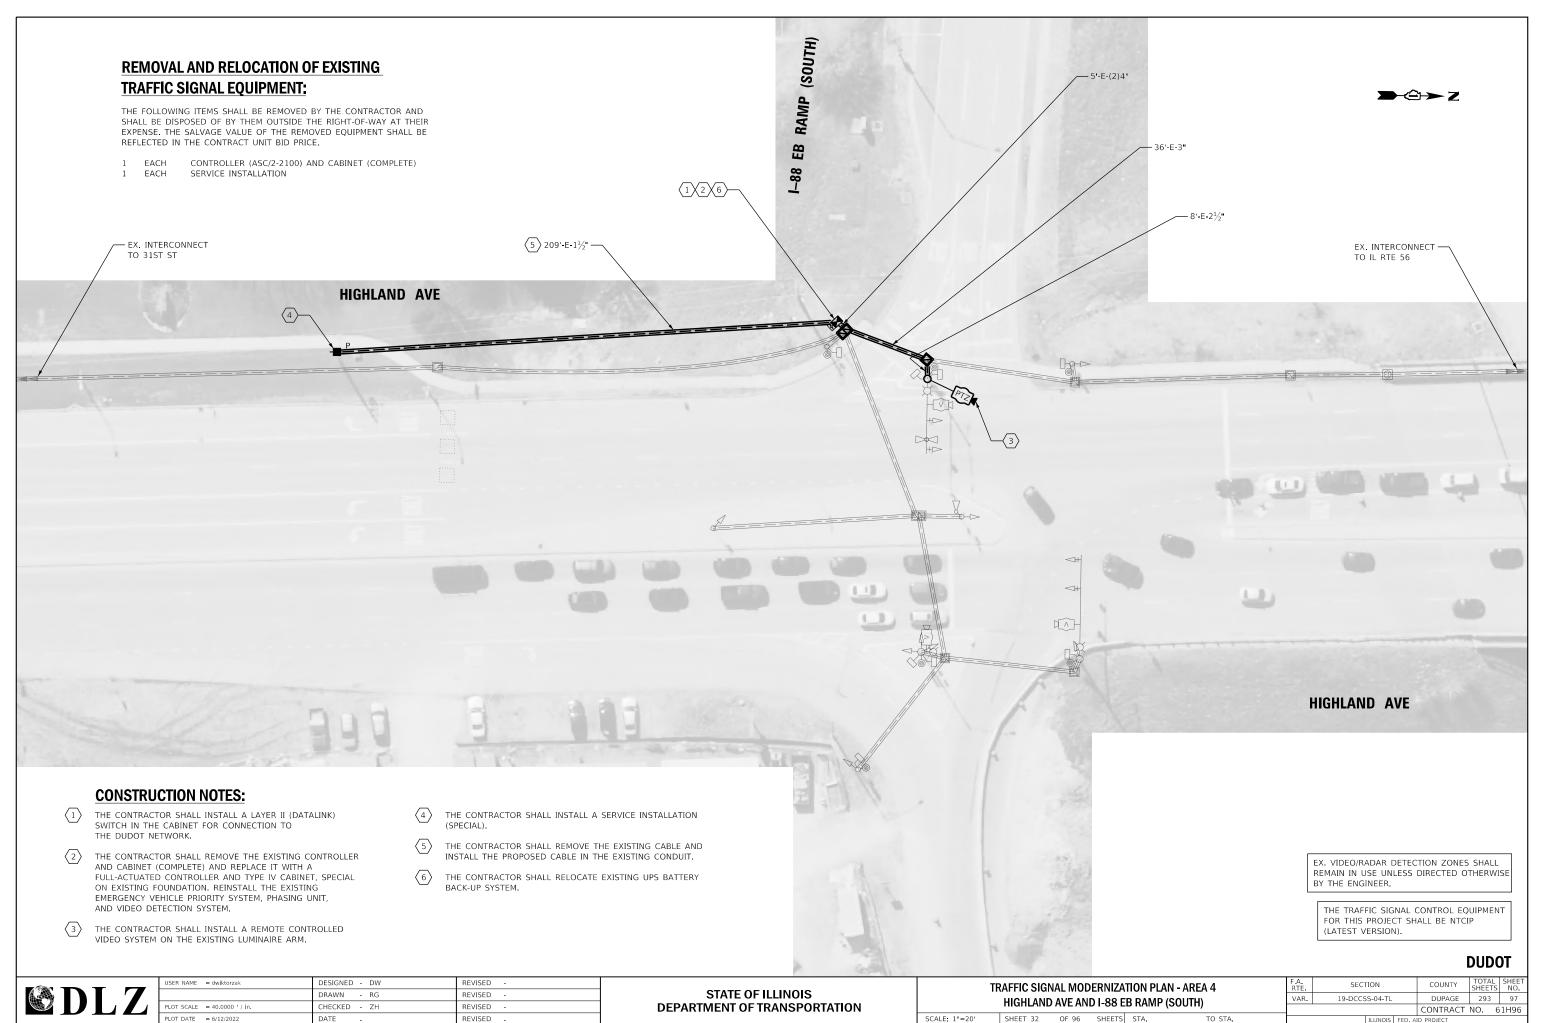

FILE NAME Int 32 = X:\Projects\2021\2182\217400 DuPage DOT Central\CADD_Sheets\sht-4C-Highland-ts-plan.dgn SCALE: 1"=20'

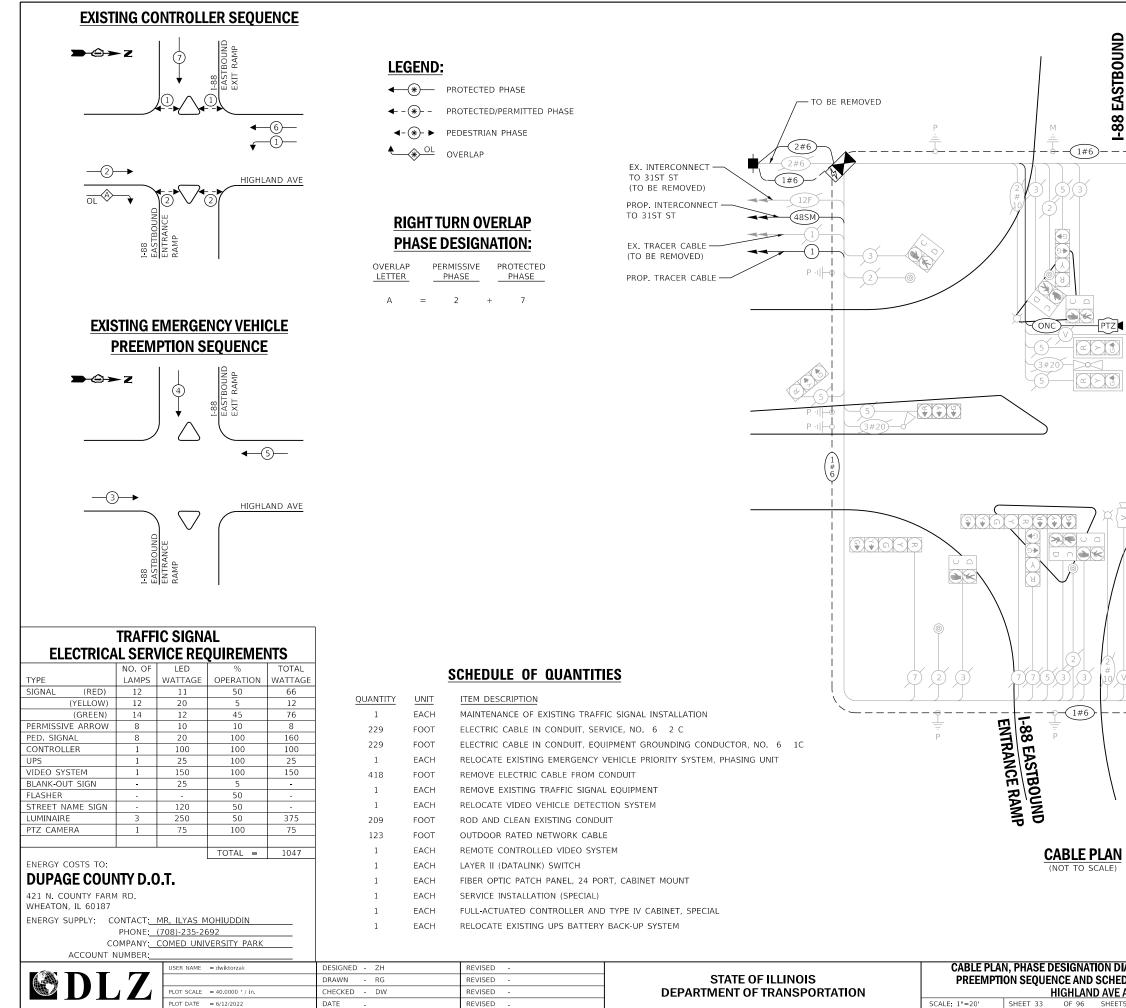

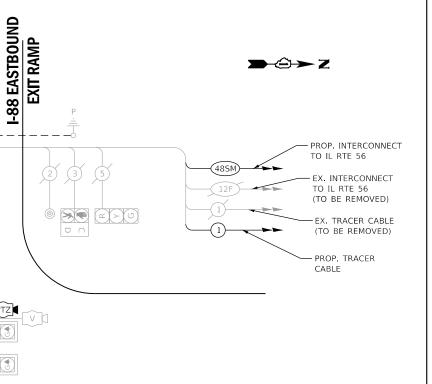

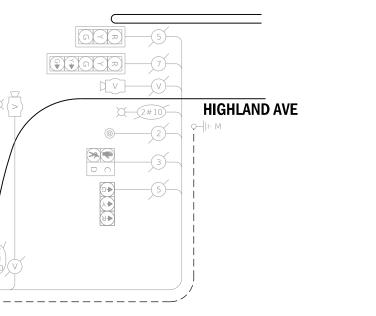


THE TRAFFIC SIGNAL CONTROL EQUIPMENT FOR THIS INTERSECTION SHALL BE 'ECONOLITE', NTCIP (LATEST VERSION) TO MEET VILLAGE OF LOMBARD REQUIREMENTS.

EX VIDEO DETECTION ZONES SHALL REMAIN UNCHANGED, UNLESS DIRECTED OTHERWISE BY THE ENGINEER.

IAGRAM, EMERGENCY VEHICLE DULE OF QUANTITIES - AREA 4		F.A. RTE	SECTION			COUNTY	TOTAL SHEETS	SHEET NO.	
		VAR.	19-DCCSS-04-TL			DUPAGE	293	98	
AND I-88							CONTRACT	NO. 6	51H96
٢S	STA.	TO STA.		II	LLINOIS	FED. AI	D PROJECT		


DUDOT

land-ts-Cable.dgn

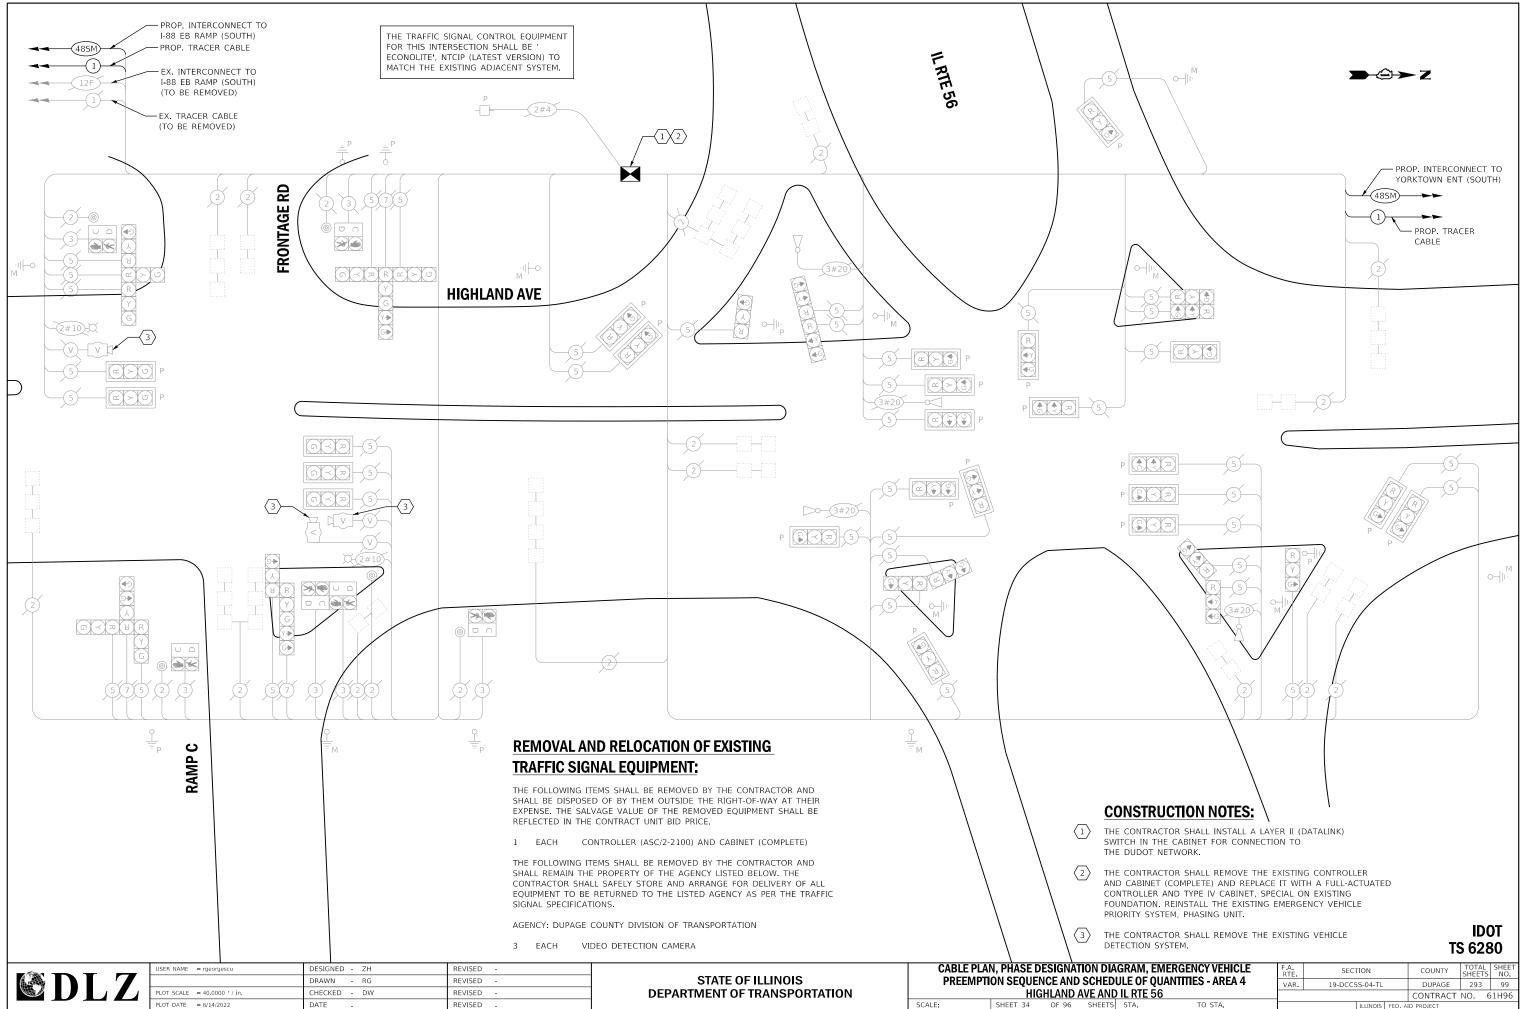

FILE NAME = X1Projects/2021/2182/217400 DuPage DOT Central/CADD_Sheets/sht-4C-Highland-ts-Cable.dgn Int 33

DIAGRAM, EMERGENCY VEHICLE		F.A. RTE	SECTION			COUNTY	TOTAL SHEETS	SHEET NO.	
EDULE OF QUANTITIES - AREA 4		VAR.	19-DCCSS-04-TL			DUPAGE	293	99	
ND IL RTE 56							CONTRACT	NO. 6	51H96
TS	STA.	TO STA.			ILLINOIS	FED. A	ID PROJECT		

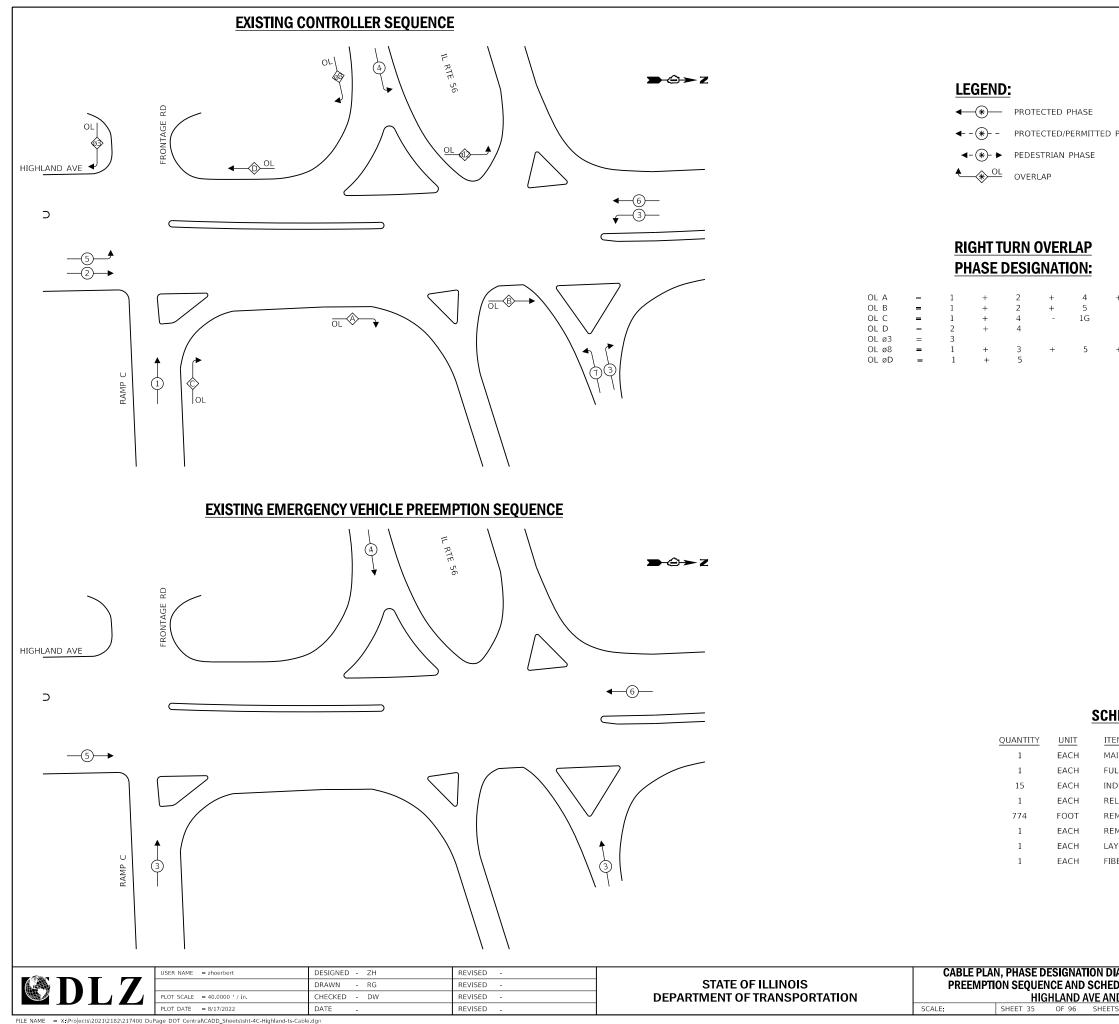

FILE NAME = X1Projects/2021/2182/217400 DuPage DOT Central/CADD_Sheets/sht-4C-Highland-ts-Cable.dgn Int 33

					AITC					
	ELECTRICAL SERVICE REQUIREMENTS									
		NO. OF	LED	%	TOTAL					
	TYPE	LAMPS	WATTAGE	OPERATION	WATTAGE					
	SIGNAL (RED)	44	11	50	242					
	(YELLOW)	44	20	5	44					
	(GREEN)	45	12	45	243					
	PERMISSIVE ARROW	4	10	10	4					
	PED. SIGNAL	6	20	100	120					
HASE	CONTROLLER	1	100	100	100					
17.0 L	UPS	-	25	100	-					
	VIDEO SYSTEM	-	150	100	-					
	BLANK-OUT SIGN	-	25	5	-					
	FLASHER	-	-	50	-					
	STREET NAME SIGN	-	120	50	-					
	LUMINAIRE	2	250	50	250					
	PTZ CAMERA	-	75	100	-					
	ENERGY COSTS TO:			TOTAL =	1003					
	VILLAGE OF LO	MBAR	D							
	255 E. WILSON AVE LOMBARD, ILLINOIS 6	0148-3920	6							
5	ENERGY SUPPLY: CO	ONTACT:	MR. JOE STA	асно						
		PHONE: (630)-424-5704								
	co	COMPANY: COMED LOMBARD								
				9 & 05462-350	209					

SCHEDULE OF QUANTITIES

ITEM DESCRIPTION

- MAINTENANCE OF EXISTING TRAFFIC SIGNAL INSTALLATION
- FULL-ACTUATED CONTROLLER AND TYPE IV CABINET
- INDUCTIVE LOOP DETECTOR
- RELOCATE EXISTING EMERGENCY VEHICLE PRIORITY SYSTEM, PHASING UNIT
- REMOVE ELECTRIC CABLE FROM CONDUIT
- REMOVE EXISTING TRAFFIC SIGNAL EQUIPMENT
- LAYER II (DATALINK) SWITCH
- FIBER OPTIC PATCH PANEL, 24 PORT, CABINET MOUNT

THE TRAFFIC SIGNAL CONTROL EQUIPMENT FOR THIS INTERSECTION SHALL BE 'ECONOLITE', NTCIP (LATEST VERSION) TO MATCH THE EXISTING ADJACENT SYSTEM.

IDOT TS 6280

IAGRAM, EMERGENCY VEHICLE DULE OF QUANTITIES - AREA 4		F.A. RTE	SECTION			COUNTY	TOTAL SHEETS	SHEET NO.	
		VAR. 19-DCCSS-04-TL				DUPAGE	293	100	
ID IL RTE 56							CONTRACT	NO. 6	51H96
S	STA.	TO STA.			ILLINOIS	FED. A	ID PROJECT		