

FILE NAME	= X\\Projects\2021\2182\217400 DuPage DOT Central\CADD_Sheets\sht-4C-Highland-ts-plan.dgr
Int 89	

PLOT DATE = 6/12/2022

DATE


DEPARTMENT OF TRANSPORTATION

REVISED

HIGHLAND AVE AND YORK SHEET 36 OF 96 SHEET SCALE: 1"=20'





стr	OWN ENT (SOU	TH)	VAR.	19-DCCS	S-04-TL		DUPAGE	293	101
						CONTRACT	NO. (51H96	
ГS	STA.	TO STA.			ILLINOIS	FED. A	D PROJECT		

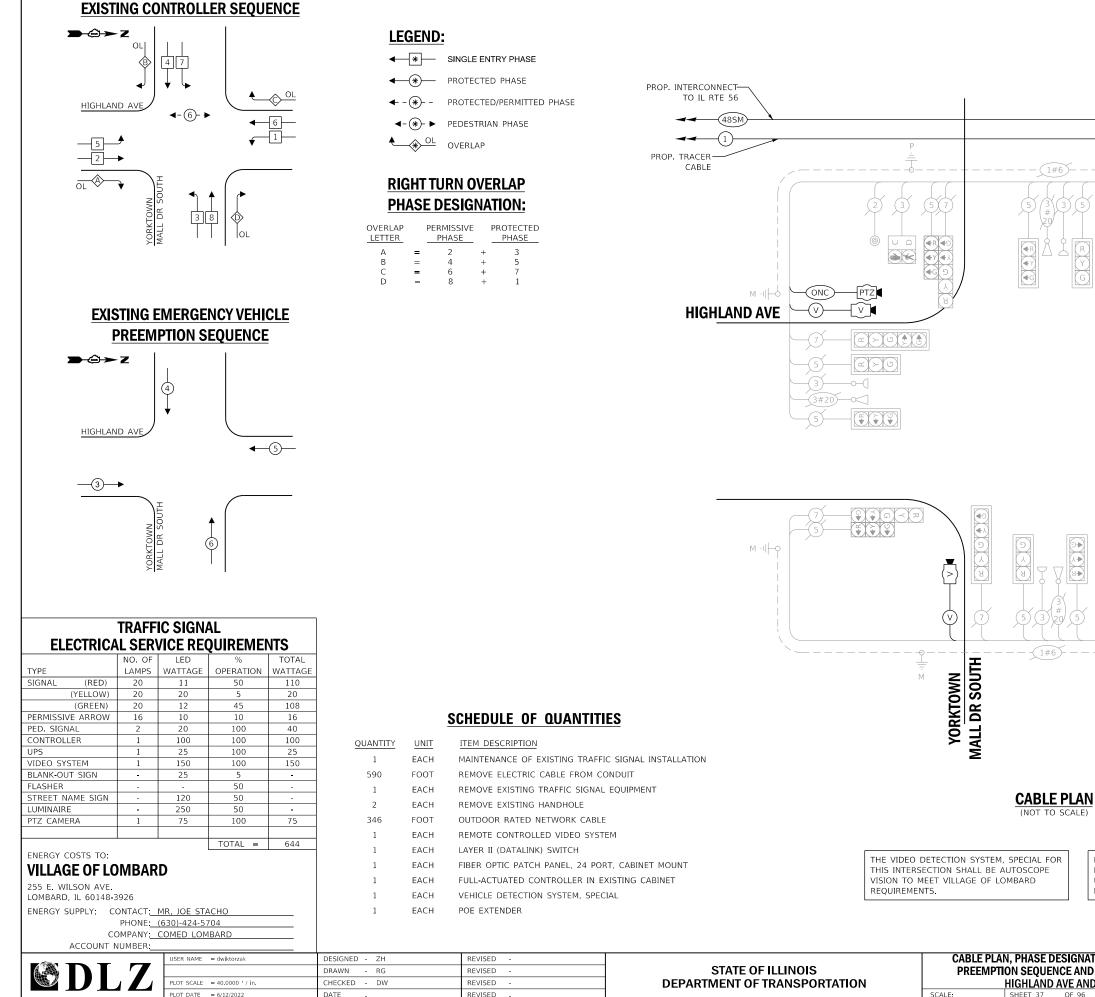

FILE NAME = X1Projects\2021\2182\217400 DuPage DOT Central\CADD_Sheets\sht-4C-Highland-ts-Cable.dgr Int 89

SCALE OF 96 SHEETS STA. SHEET 37

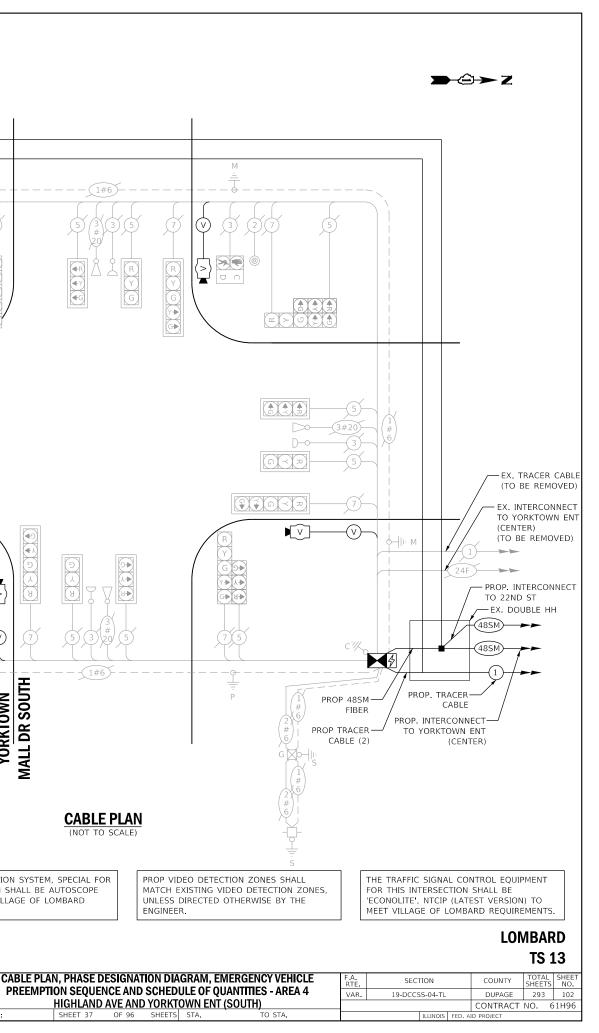

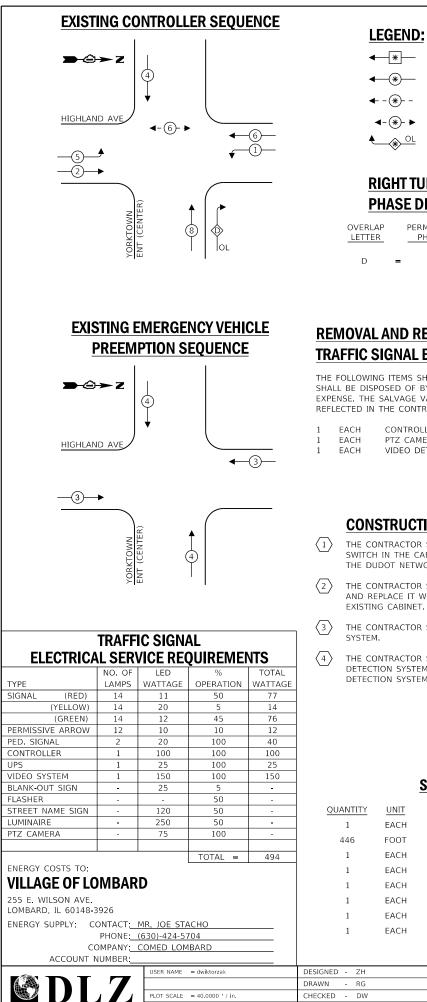

SINGLE ENTRY PHASE ← (*) PROTECTED PHASE

← - (*)- - PROTECTED/PERMITTED PHASE

◄-(*)- ► PEDESTRIAN PHASE

OVERLAP

RIGHT TURN OVERLAP PHASE DESIGNATION:

PERMISSIVE PROTECTED PHASE PHASE

8 + 1


REMOVAL AND RELOCATION OF EXISTING TRAFFIC SIGNAL EQUIPMENT:


THE FOLLOWING ITEMS SHALL BE REMOVED BY THE CONTRACTOR AND SHALL BE DISPOSED OF BY THEM OUTSIDE THE RIGHT-OF-WAY AT THEIR EXPENSE. THE SALVAGE VALUE OF THE REMOVED EQUIPMENT SHALL BE REFLECTED IN THE CONTRACT UNIT BID PRICE.

- CONTROLLER (ASC/2S-1000)
- PTZ CAMERA VIDEO DETECTION (COMPLETE)



- THE CONTRACTOR SHALL INSTALL A LAYER II (DATALINK) SWITCH IN THE CABINET FOR CONNECTION TO THE DUDOT NETWORK.
- THE CONTRACTOR SHALL REMOVE THE EXISTING CONTROLLER AND REPLACE IT WITH A FULL ACTUATED CONTROLLER IN THE EXISTING CABINET
- THE CONTRACTOR SHALL REMOVE THE EXISTING PTZ CAMERA
- THE CONTRACTOR SHALL REMOVE THE EXISTING VEHICLE DETECTION SYSTEM AND INSTALL THE PROPOSED VEHICLE DETECTION SYSTEM, SPECIAL.

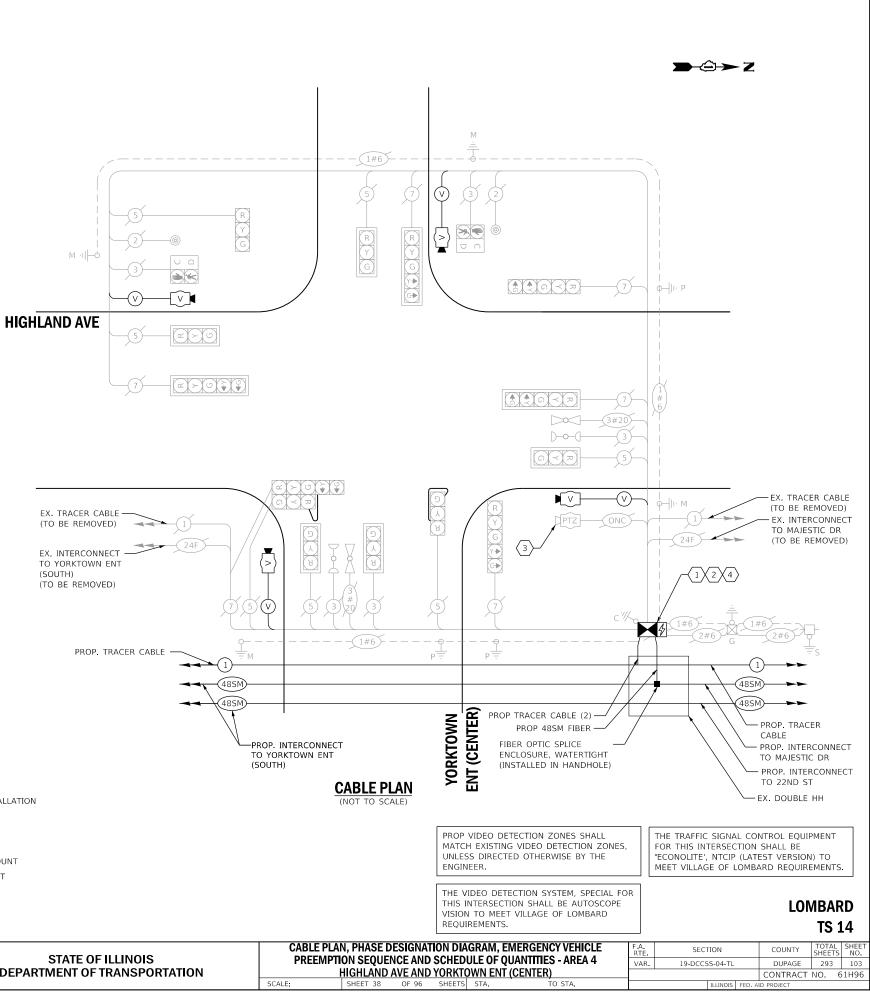

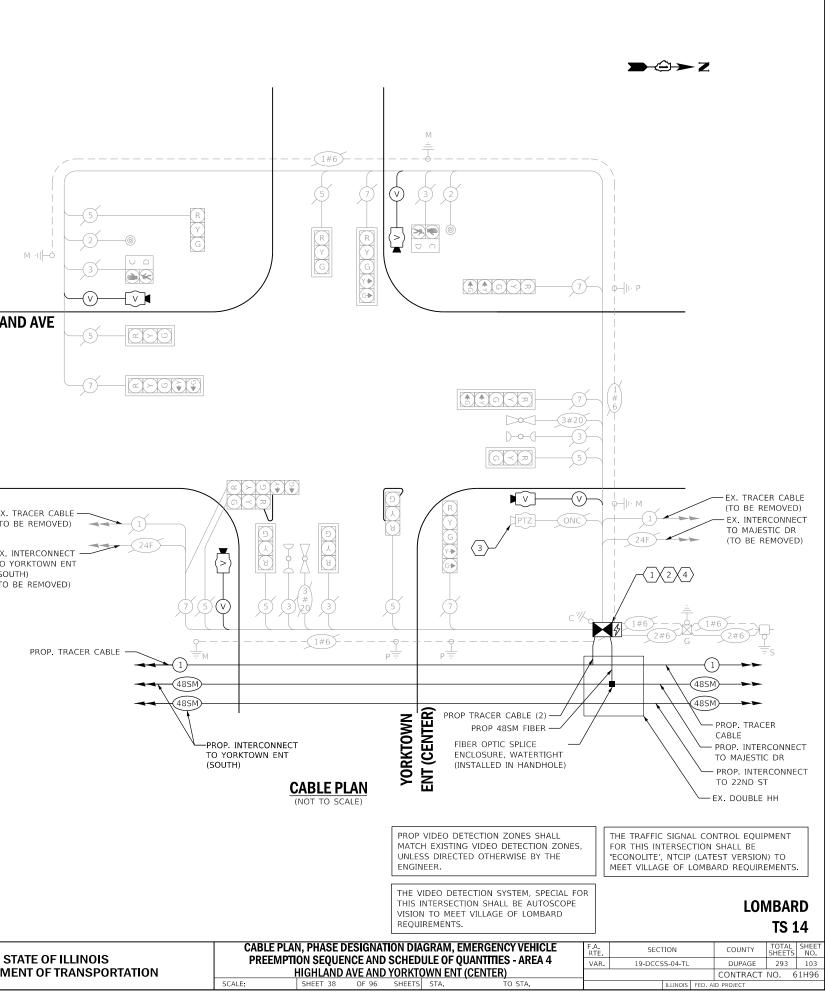


QUANTITY	UNIT	ITEM DESCRIPTION
1	EACH	MAINTENANCE OF EXISTING TRAFFIC SIGNAL INSTALLATION
446	FOOT	REMOVE ELECTRIC CABLE FROM CONDUIT
1	EACH	REMOVE EXISTING TRAFFIC SIGNAL EQUIPMENT
1	EACH	LAYER II (DATALINK) SWITCH
1	EACH	FIBER OPTIC PATCH PANEL, 24 PORT, CABINET MOUNT
1	EACH	FULL-ACTUATED CONTROLLER IN EXISTING CABINET
1	EACH	MODIFY EXISTING CONTROLLER CABINET, SPECIAL
1	EACH	VEHICLE DETECTION SYSTEM, SPECIAL

SCHEDULE OF QUANTITIES


M. UI Eľ
TH TH

	ACCOUNT NORIBLIN.								
ſ		USER NAME = dwiktorzak	DESIGNED - ZH	REVISED -		CABLE PLA	N, PHASE DES	SIGNATI	ION DIA(
			DRAWN - RG	REVISED -	STATE OF ILLINOIS	PREEMPT	ION SEQUENC	SE AND S	SCHEDL
		PLOT SCALE = 40.0000 ' / in.	CHECKED - DW	REVISED -	DEPARTMENT OF TRANSPORTATION	ſ	HIGHLAND AV	YE AND ۱	YORKTO
		PLOT DATE = 6/12/2022	DATE -	REVISED -		SCALE:	SHEET 38	OF 96	SHEETS

rojects\2021\2182\217400 DuPage DOT Central\CADD_Shi FILE NAME Int 88

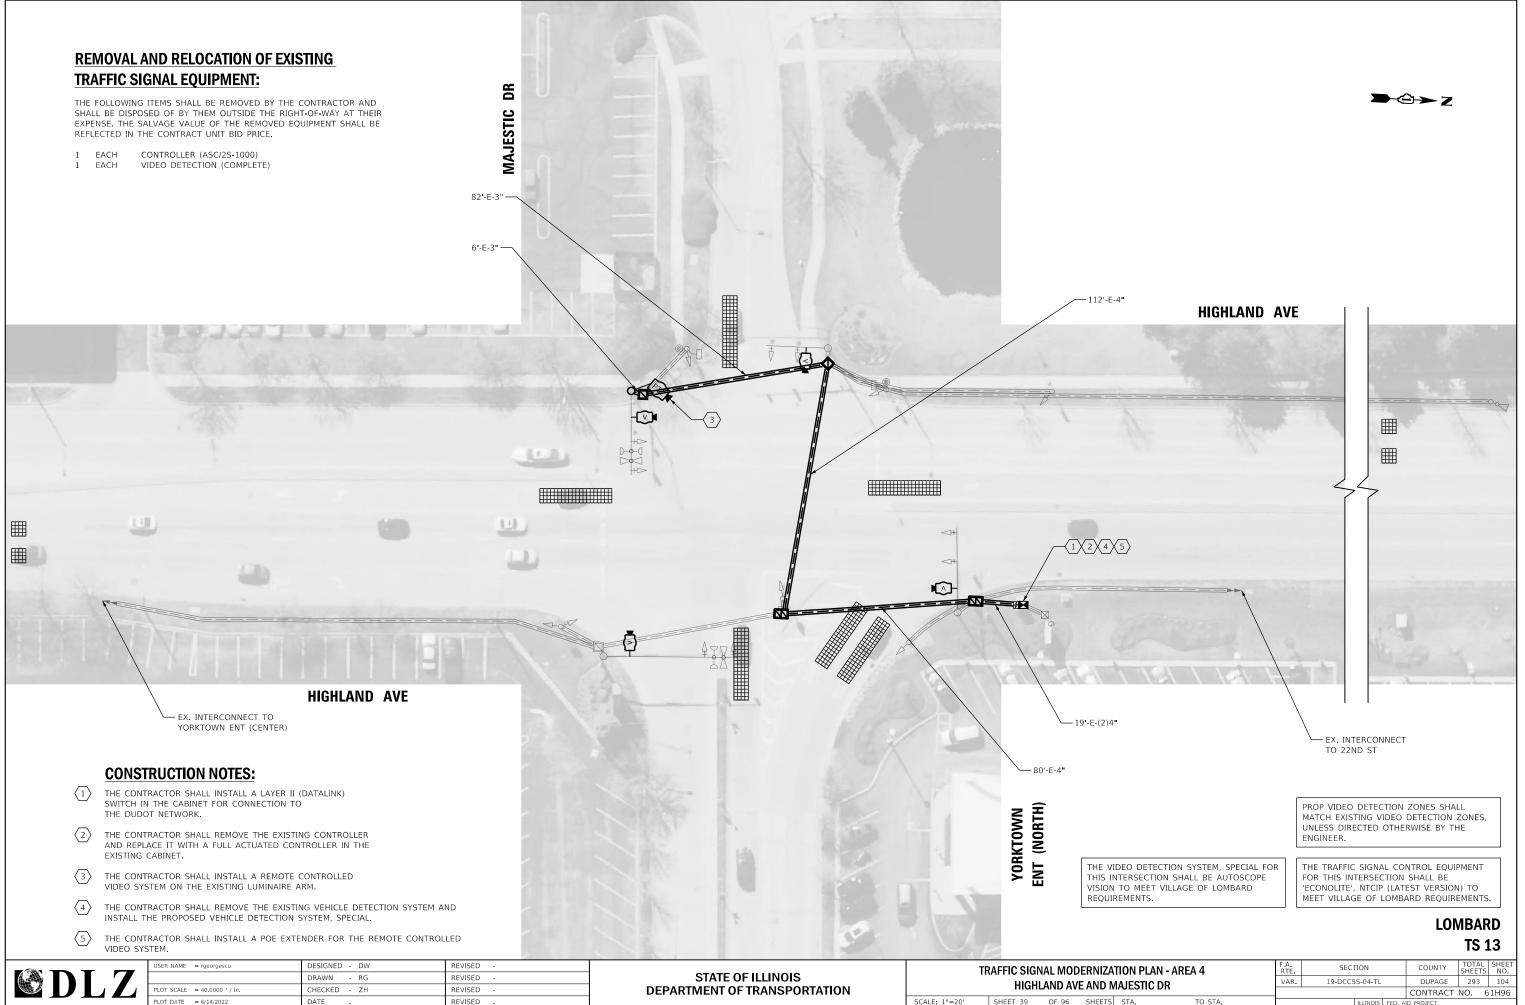

FILE NAME = X Projects\2021\2182\217400 DuPage DOT Central\CADD_Sheets\sht-4C-Highland-ts-plan.dgn Int 87

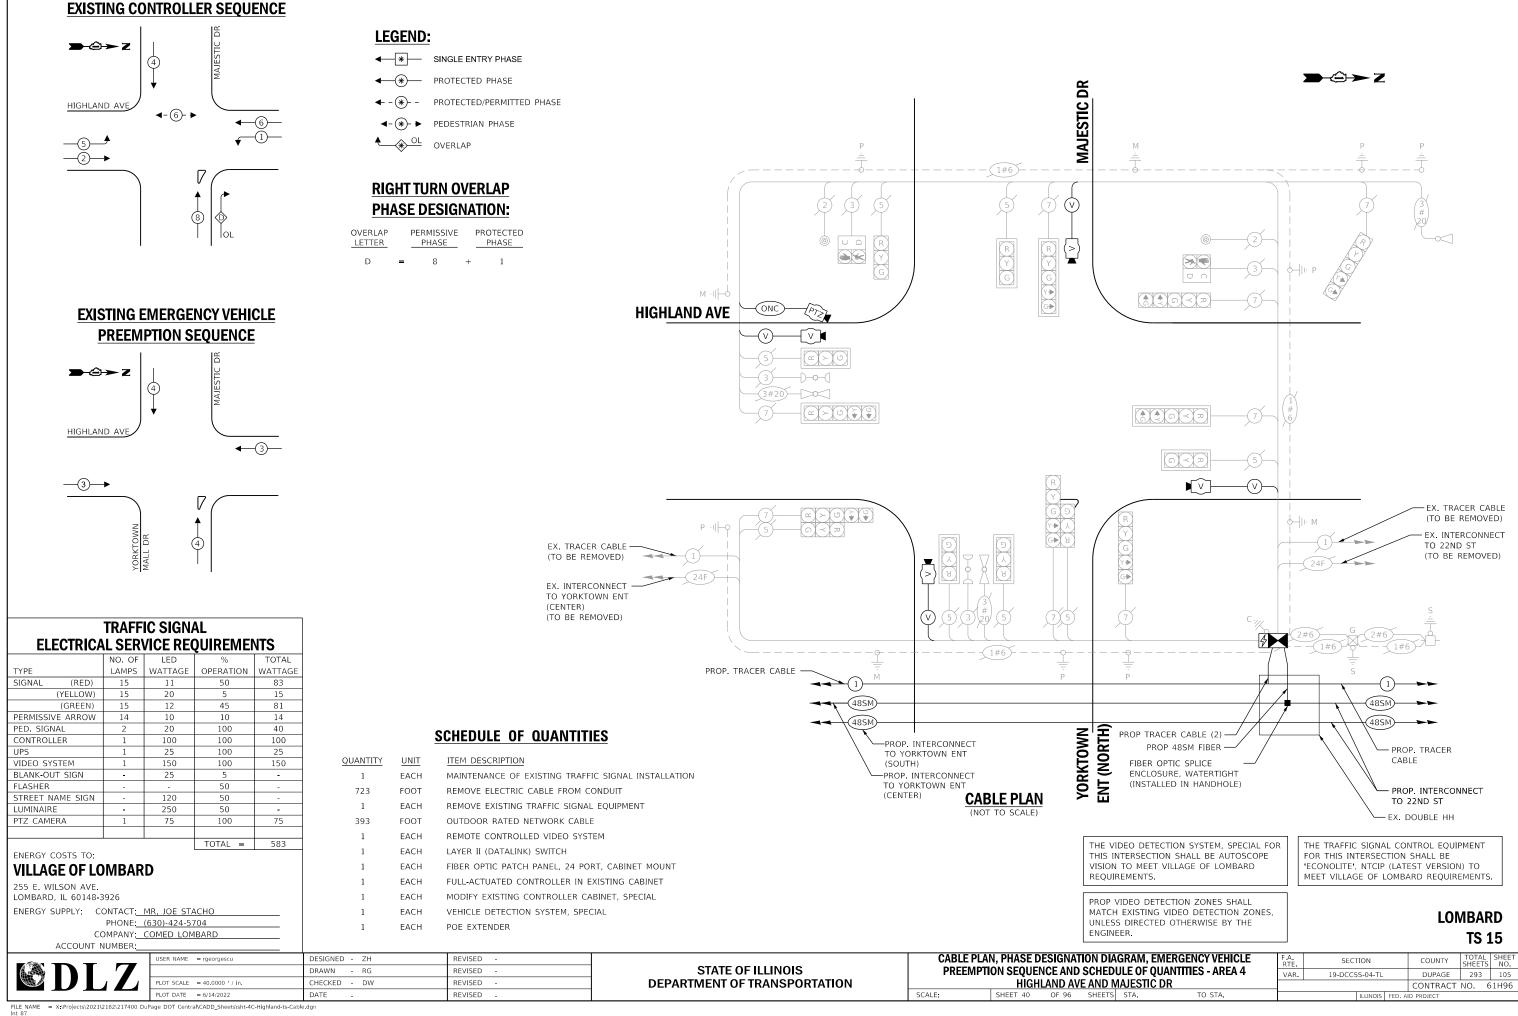

THE TERMINAL SERVER SHALL BE CONFIGURED TO ESTABLISH CONNECTION BETWEEN THE EXISTING SIGNAL AT HIGHLAND/EASTGATE AND THE ETHERNET-BASED DUPAGE COUNTY CENTRAL SIGNAL SYSTEM

THE TRAFFIC SIGNAL CONTROL EQUIPMENT FOR THIS INTERSECTION SHALL BE 'ECONOLITE', NTCIP (LATEST VERSION) TO MEET VILLAGE OF LOMBARD REQUIREMENTS. MATCHLINE B-B AVE **REMOVAL AND RELOCATION OF EXISTING** HIGHLAND **TRAFFIC SIGNAL EQUIPMENT:** THE FOLLOWING ITEMS SHALL BE REMOVED BY THE CONTRACTOR AND SHALL BE DISPOSED OF BY THEM OUTSIDE THE RIGHT-OF-WAY AT THEIR EXPENSE. THE SALVAGE VALUE OF THE REMOVED EQUIPMENT SHALL BE REFLECTED IN THE CONTRACT UNIT BID PRICE. 1 EACH CONTROLLER (ASC/2S-2100) AND CABINET (COMPLETE) — 5'-E-(2)4" THE FOLLOWING ITEMS SHALL BE REMOVED BY THE CONTRACTOR AND SHALL REMAIN THE PROPERTY OF THE AGENCY LISTED BELOW. THE UNC) CONTRACTOR SHALL SAFELY STORE AND ARRANGE FOR DELIVERY OF ALL EQUIPMENT TO BE RETURNED TO THE LISTED AGENCY AS PER THE TRAFFIC SIGNAL SPECIFICATIONS. $\left< 1 \right> 2 \left< 4 \right>$ AGENCY: DUPAGE COUNTY DIVISION OF TRANSPORTATION (EACH MASTER CONTROLLER (ASC/2M-1000) 1 2 EACH MODEM INSTALLED AS PART OF INTERCONNECT WORK $\langle 3 \rangle$ 8'-E-2¹/₂" · 4 ◄ LШ MATCHLIN 128+00 NX N 2 Ż FIN 22ND ST $\langle 1 \rangle$ re AVE $\langle 2 \rangle$ HIGHLAND $\langle 3 \rangle$ MATCHLINE C-C $\langle 4 \rangle$ SYSTEM. JSER NAME = rgeorgescu DESIGNED - DW REVISED **TRAFFIC SIGNAL MODERNIZATION PLAN - AREA 4** STATE OF ILLINOIS DRAWN - RG REVISED **HIGHLAND AVE AND DEPARTMENT OF TRANSPORTATION**

FILE NAME Int 81 = X \Projects\2021\2182\217400 DuPage DOT Central\CADD_Sheets\sht-4C-Highland-ts-plan.dgn

OT SCALE = 40.0000 ' / in.


PLOT DATE = 6/14/2022

HECKED - ZH

DATE


REVISED


REVISED

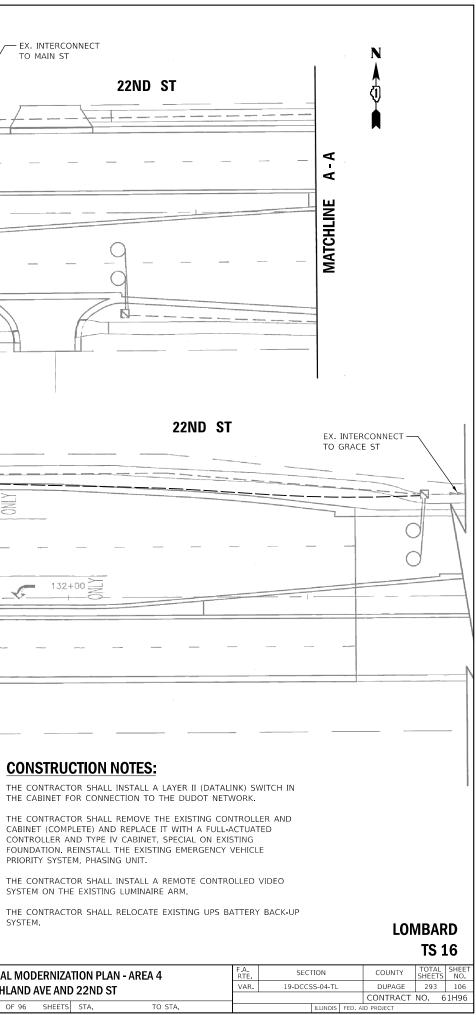


) 22ND ST		VAR.	19-DCCS	6S-04-TL		DUPAGE	293	106
2210 01						CONTRACT	NO. #	61H9
STA.	TO STA.			ILLINOIS	FED, A	D PROJECT		

SCALE: 1"=20' SHEET 41 OF 96 SHEETS

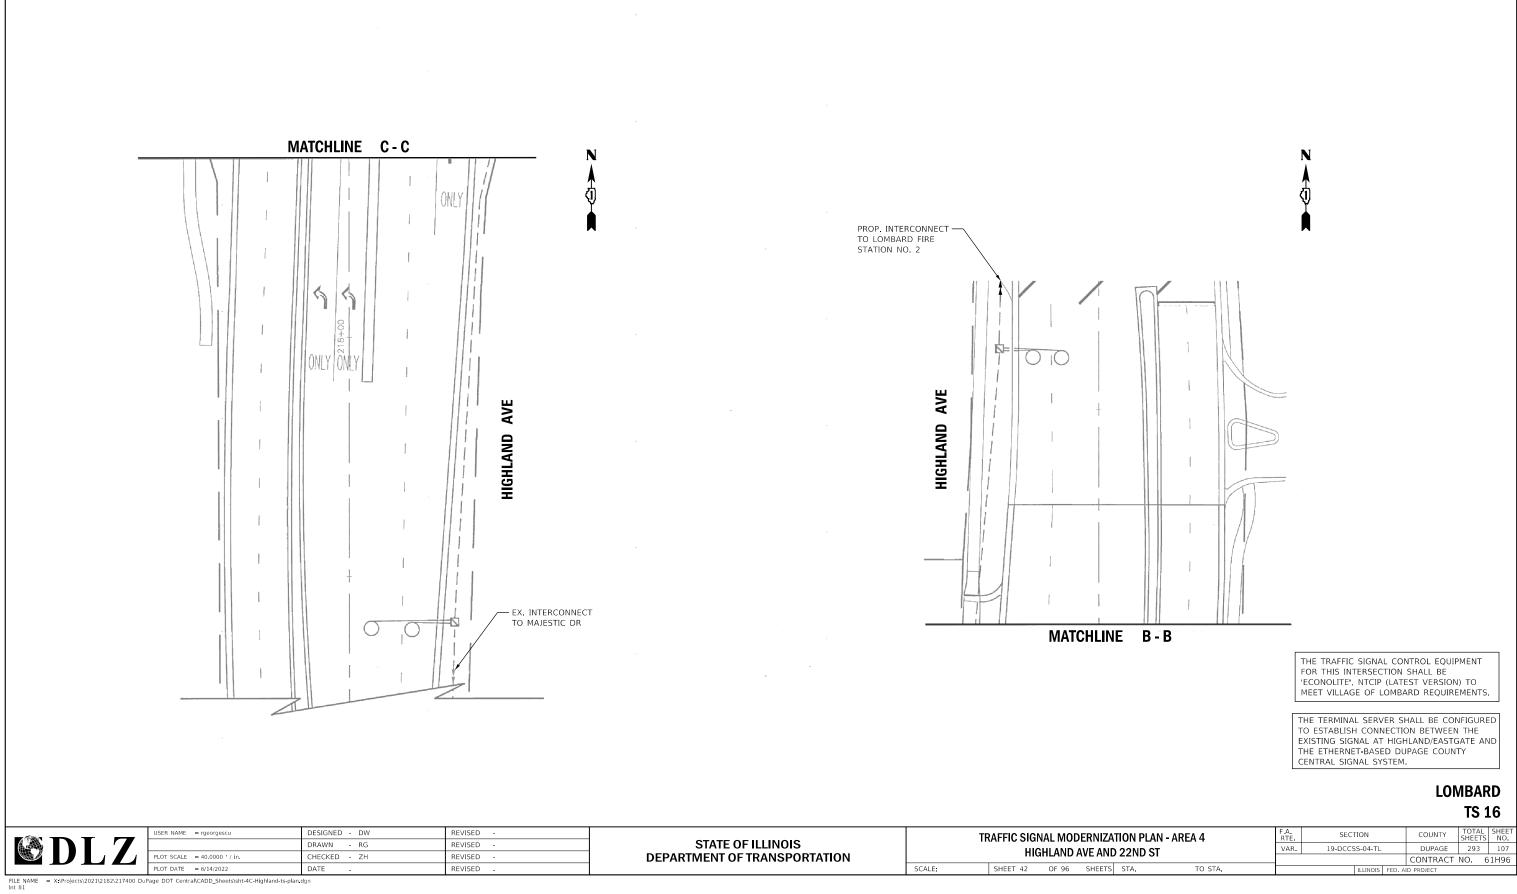

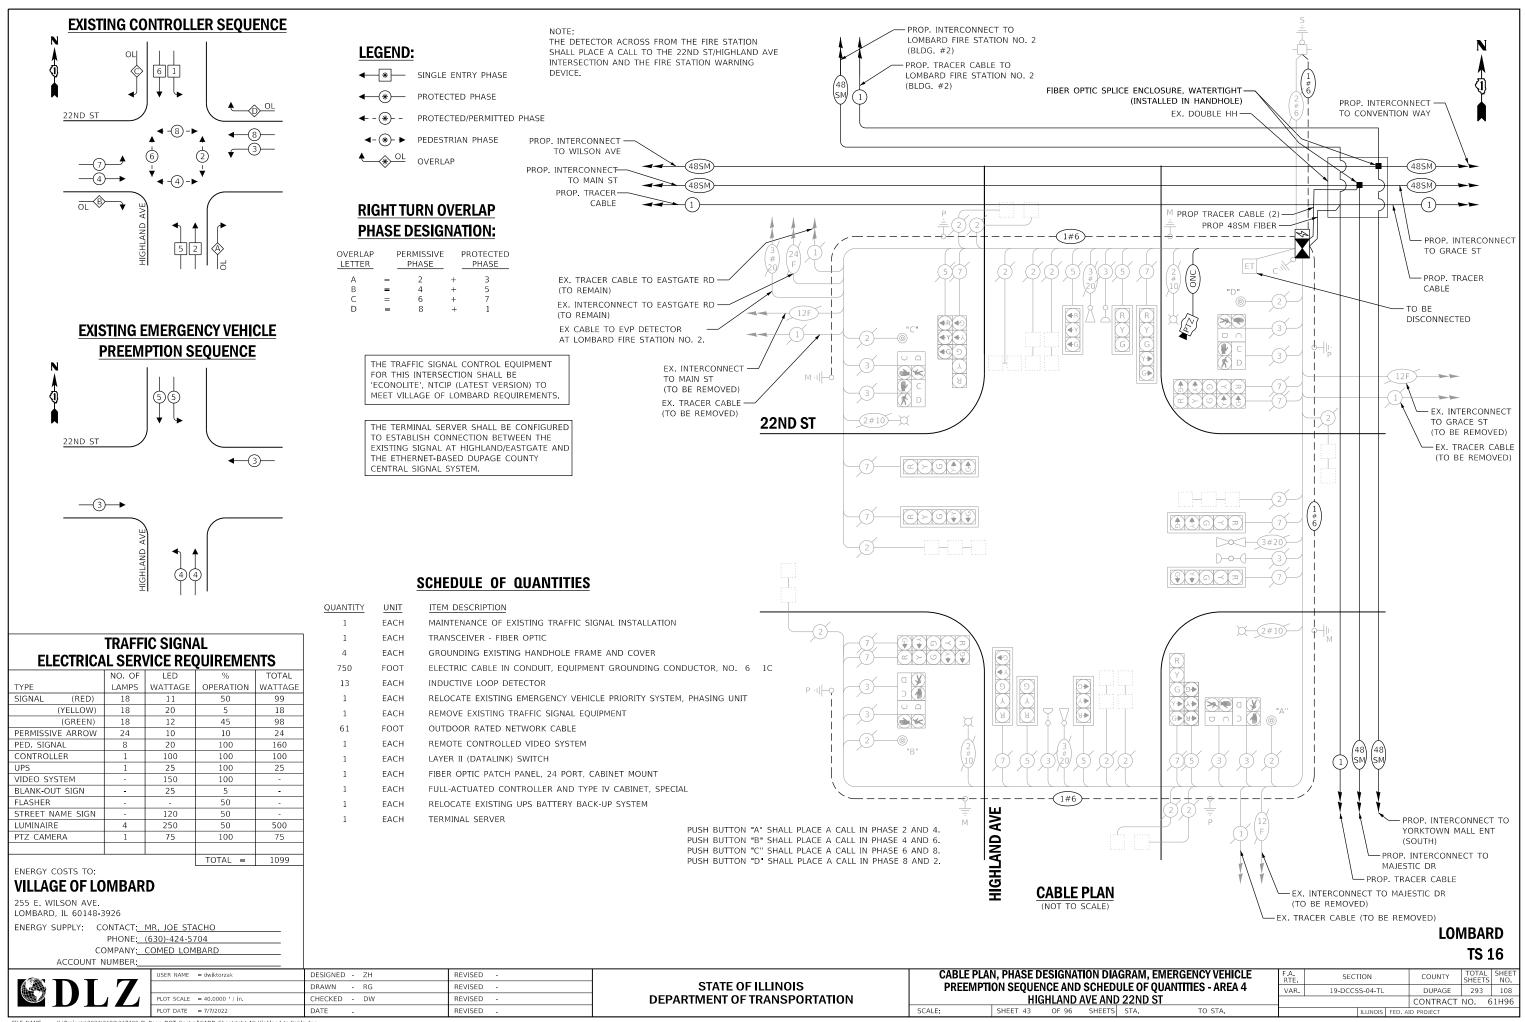

= X:\Projects\2021\2182\217400 DuPage DOT Central\CADD_Sheets\sht-4C-Highland-ts-Cable.dgr FILE NAME Int 81

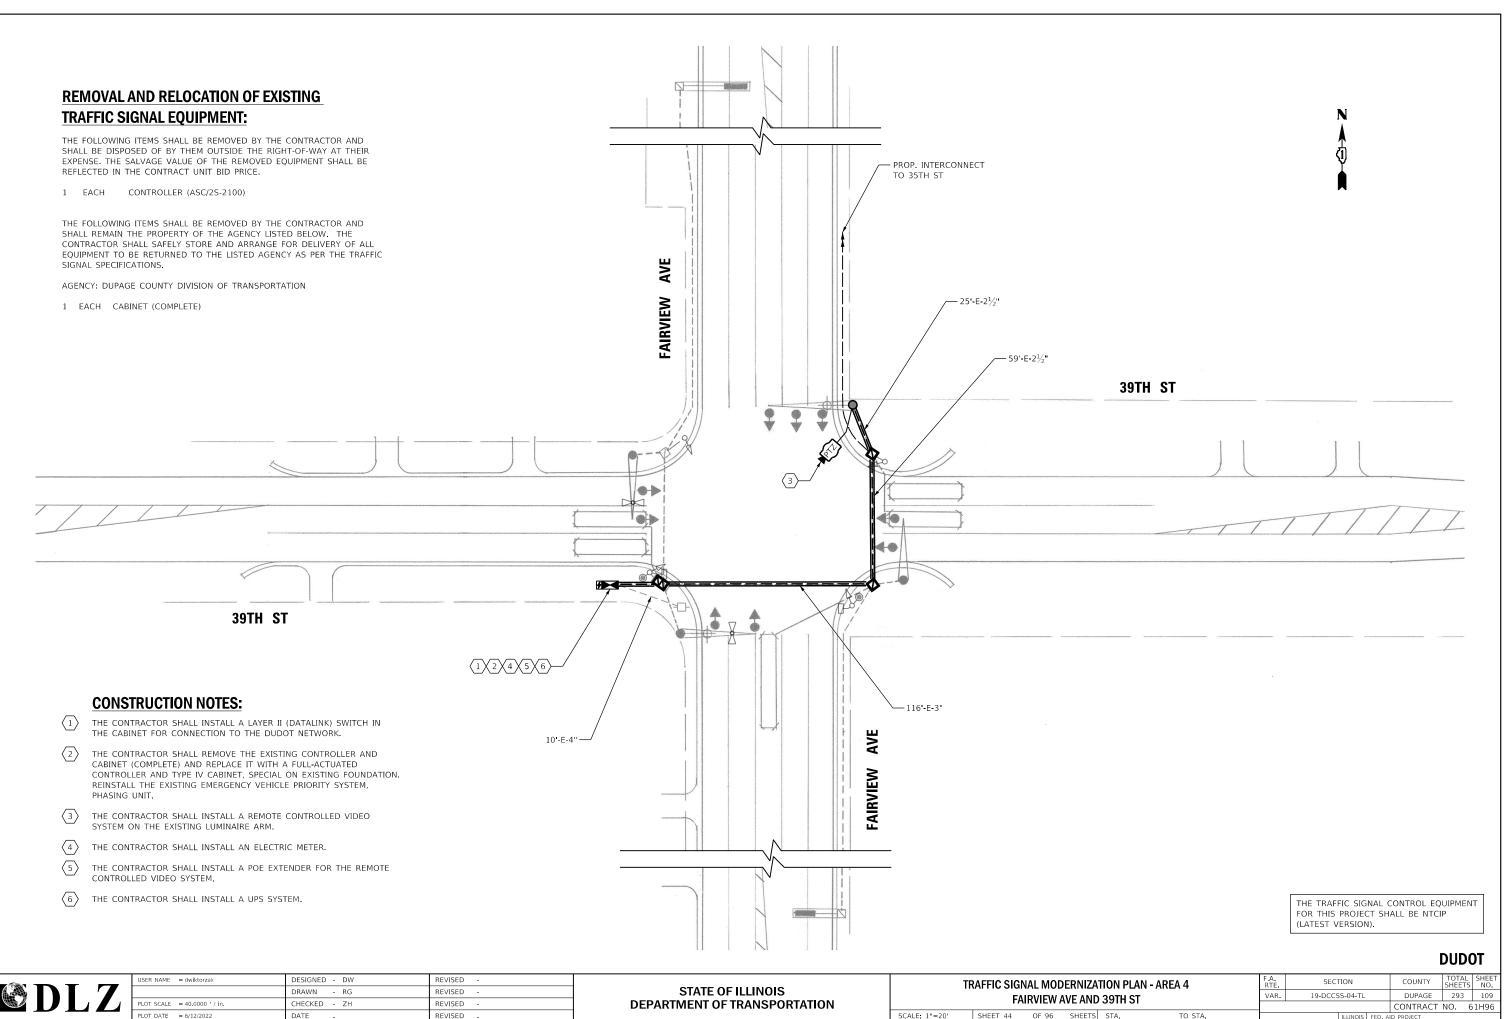


DATE

PLOT DATE = 6/12/2022

REVISED

ULUNOIS FED AID

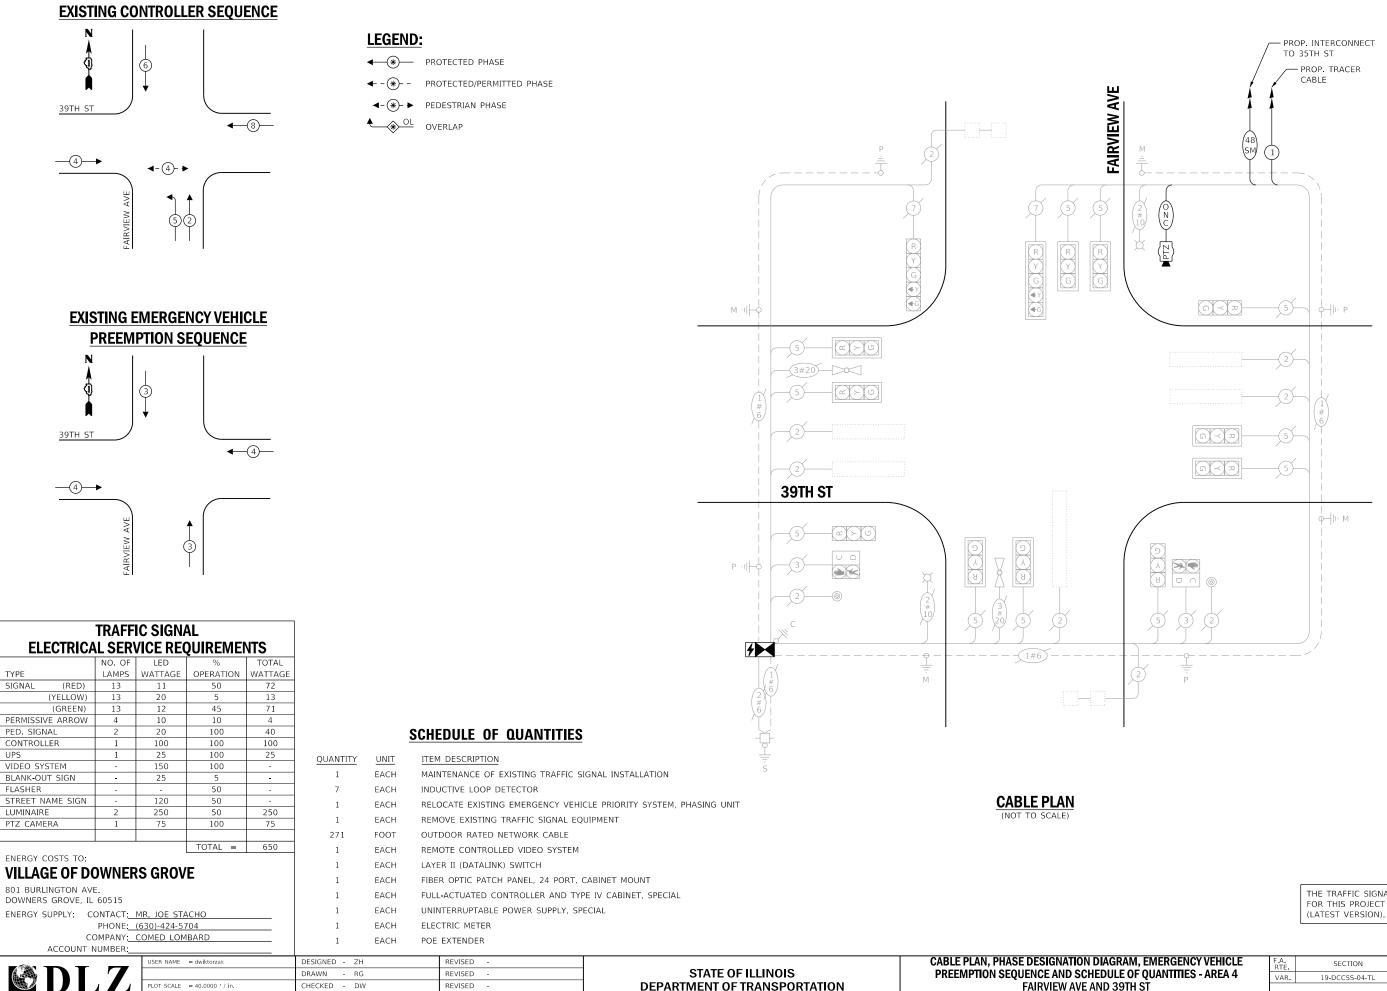

FILE NAME = X:Projects\2021\2182\217400 DuPage DOT Central\CADD Sheets\sht-4D-Meyers ts-Cable.dgn Int 27

PLOT DATE = 6/12/2022

DATE

REVISED

FAIRVIEW AVE ANI SHEET 45 OF 96 SHEETS SCALE:


THE TRAFFIC SIGNAL CONTROL EQUIPMENT FOR THIS PROJECT SHALL BE NTCIP

N

यो

DUDOT

IAGRAM, EMERGENCY VEHICLE		SECT	SECTION			TOTAL SHEETS	SHEET NO.
DULE OF QUANTITIES - AREA 4		19-DCCSS-04-TL			DUPAGE	293	110
ID 39TH ST					CONTRACT	NO. 6	1H96
TS STA. TO STA.			ILLINOIS	FED. A	ID PROJECT		

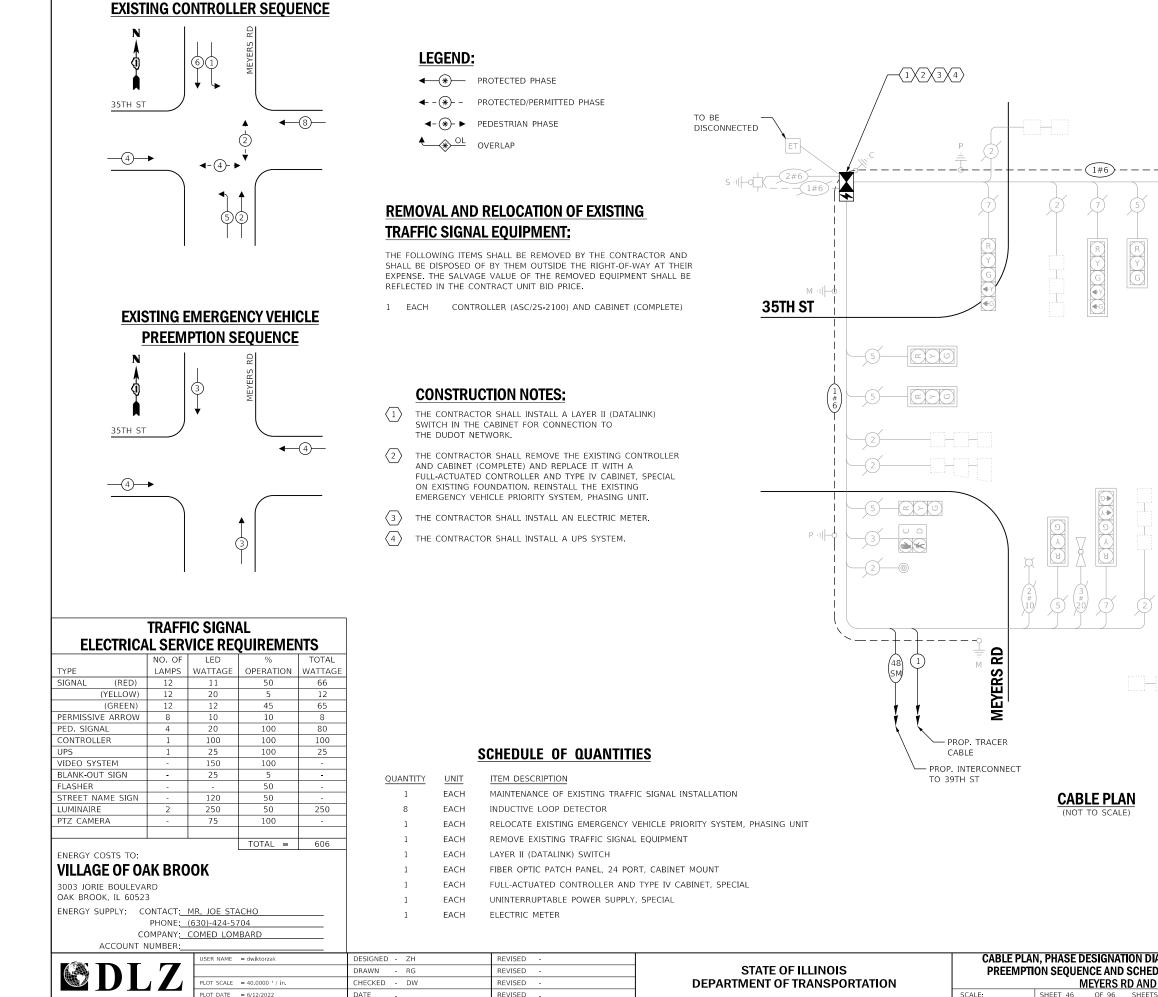


FILE NAME = X Projects\2021\2182\217400 DuPage DOT Central\CADD Sheets\sht-4D-Meyers-ts-Cable.dgn Int 49

(1#6)

(† (†


CABLE PLAN

(NOT TO SCALE)

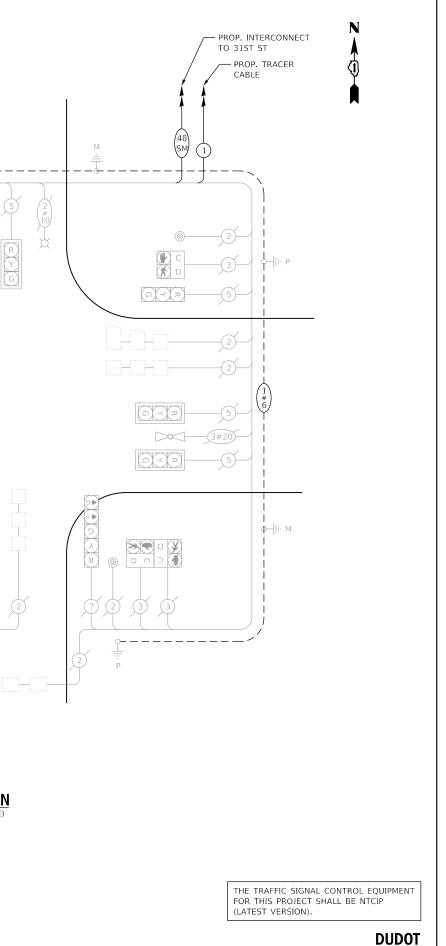

		F.A. RTE	SECTION	COUNTY	TOTAL SHEETS	SHEET NO.
DULE OF QUANTITIES - AREA 4		VAR.	19-DCCSS-04-TL	DUPAGE	293	111
<u>) 35th s</u>	ST			CONTRACT	NO. 6	51H96
S STA.	TO STA.		ILLINOIS FEI	D. AID PROJECT		

MEYERS RD AND SCALE: SHEET 46 OF 96 SHEET

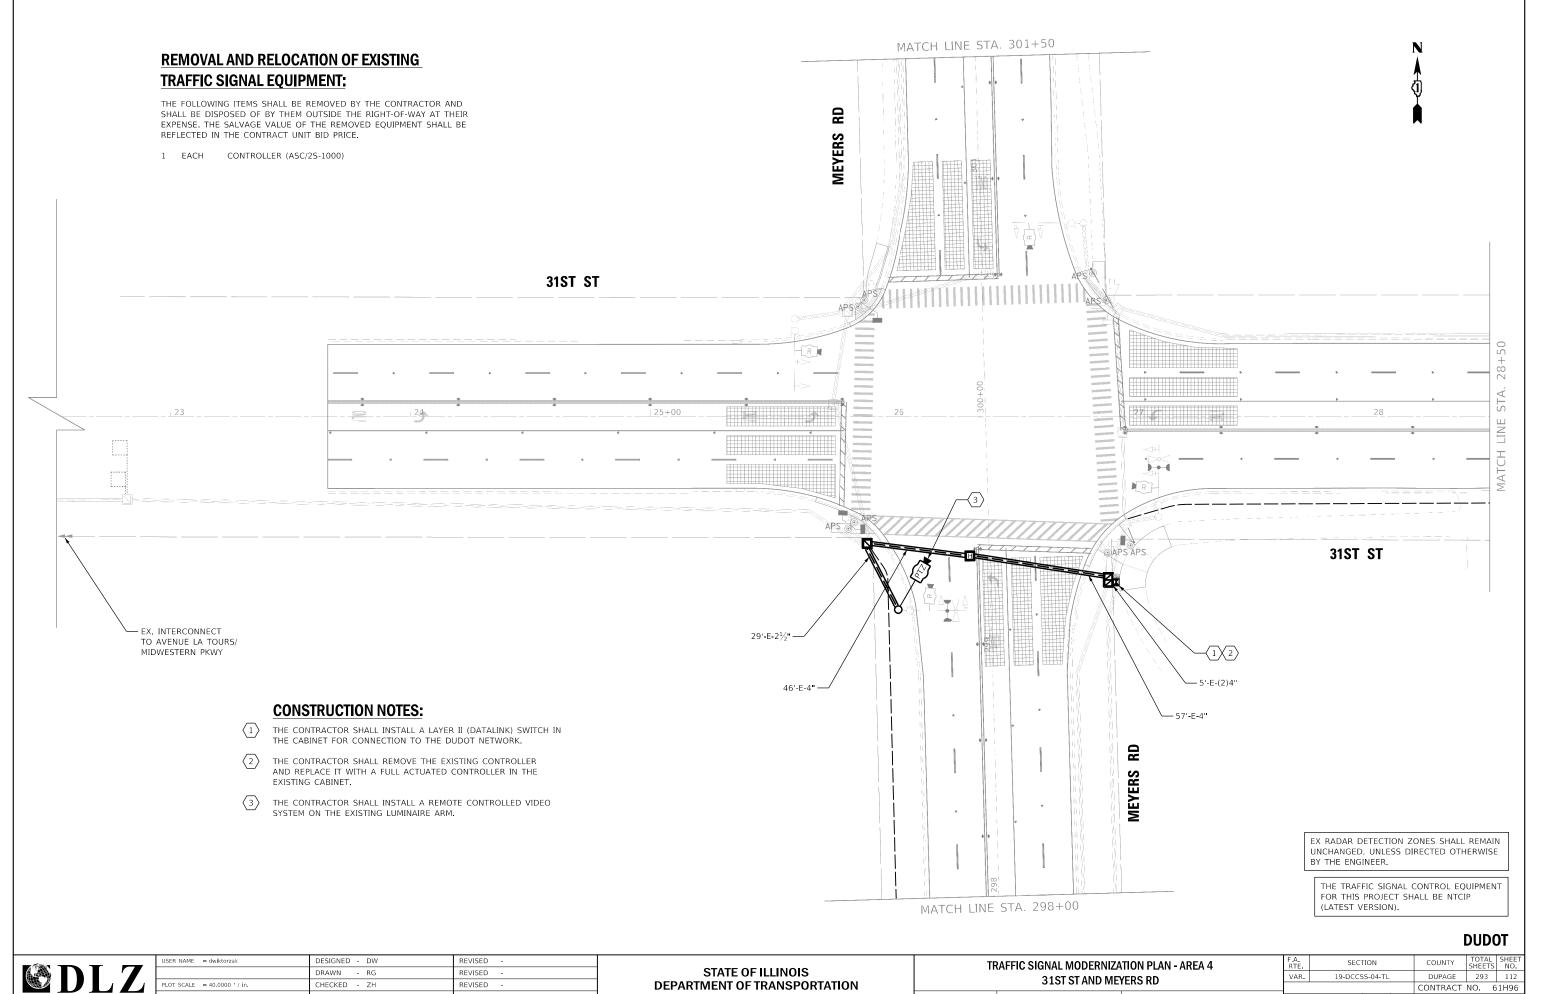

FILE NAME	-	X \Projects	\2021\2182	\217400	DuPage	DOT	Central\CADD	Sheets\sht-4D-	Mevers-ts-plan.

PLOT DATE = 6/12/2022


DATE


REVISED

FILE NAME = X:\Projects\2021\2182\217400 DuPage DOT Central\CADD_Sheets\sht-4D-Meyer: Int 16 SCALE: 1"=20' SHEET 47 OF 96 SHEETS STA.

TO STA.


ARTIMENT OF TRANSFORTATION

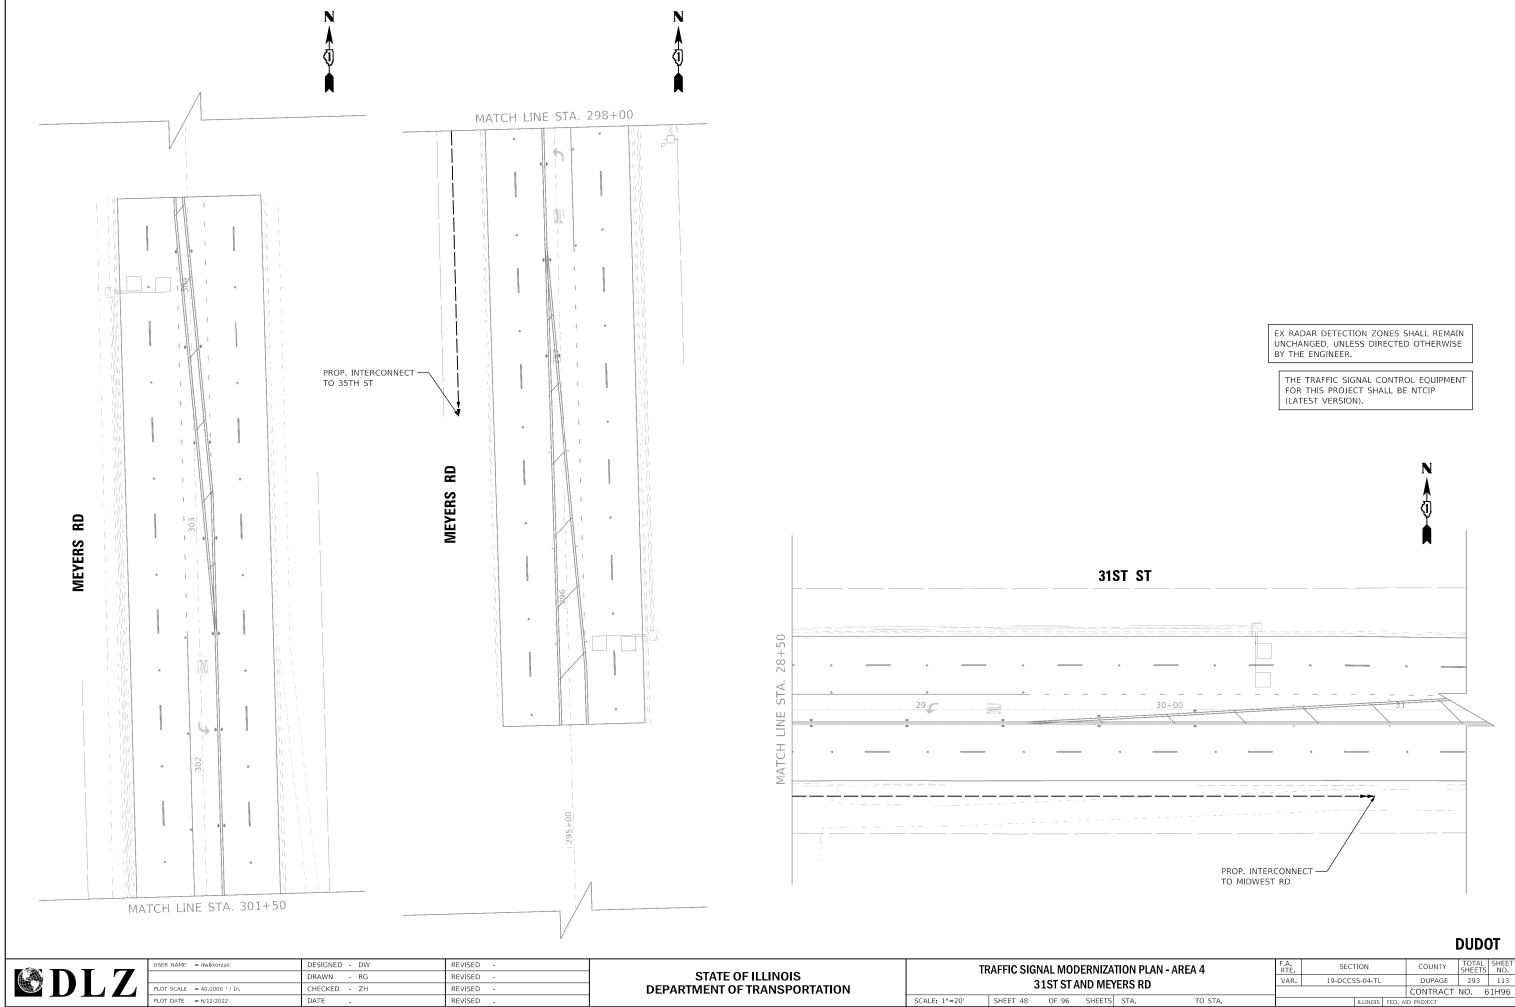

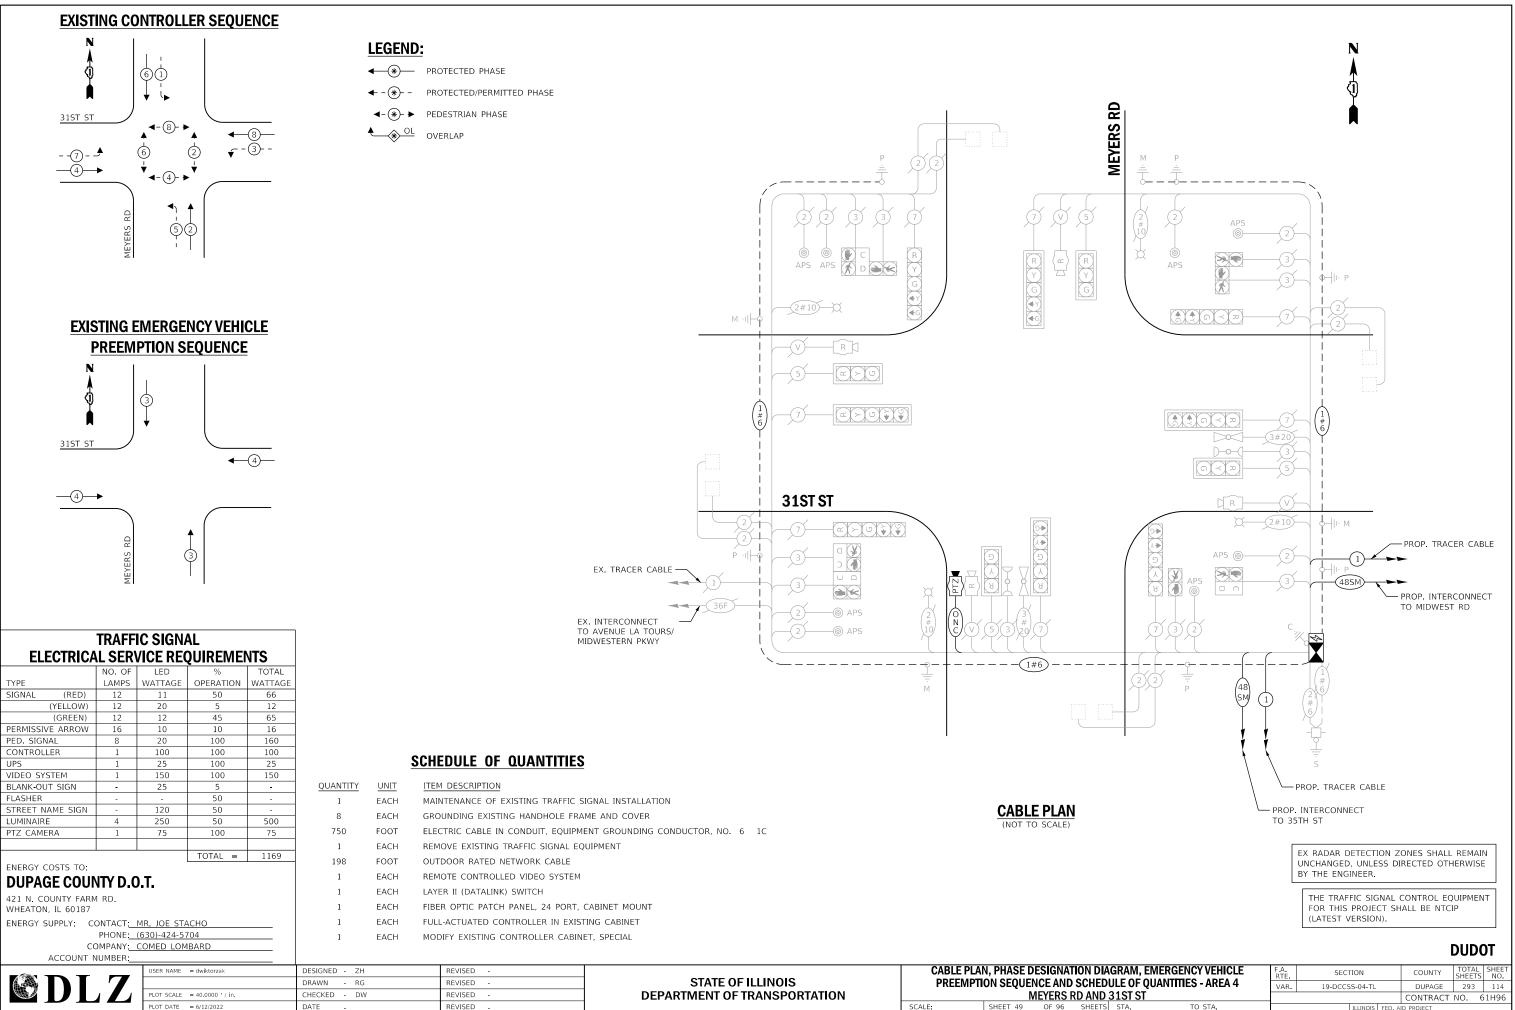

FILE NAME = X Projects/2021/2182/217400 DuPage DOT Central/CADD Sheets/sht-4D-Meyers-ts-Cable.dgn Int 16

SCALE:

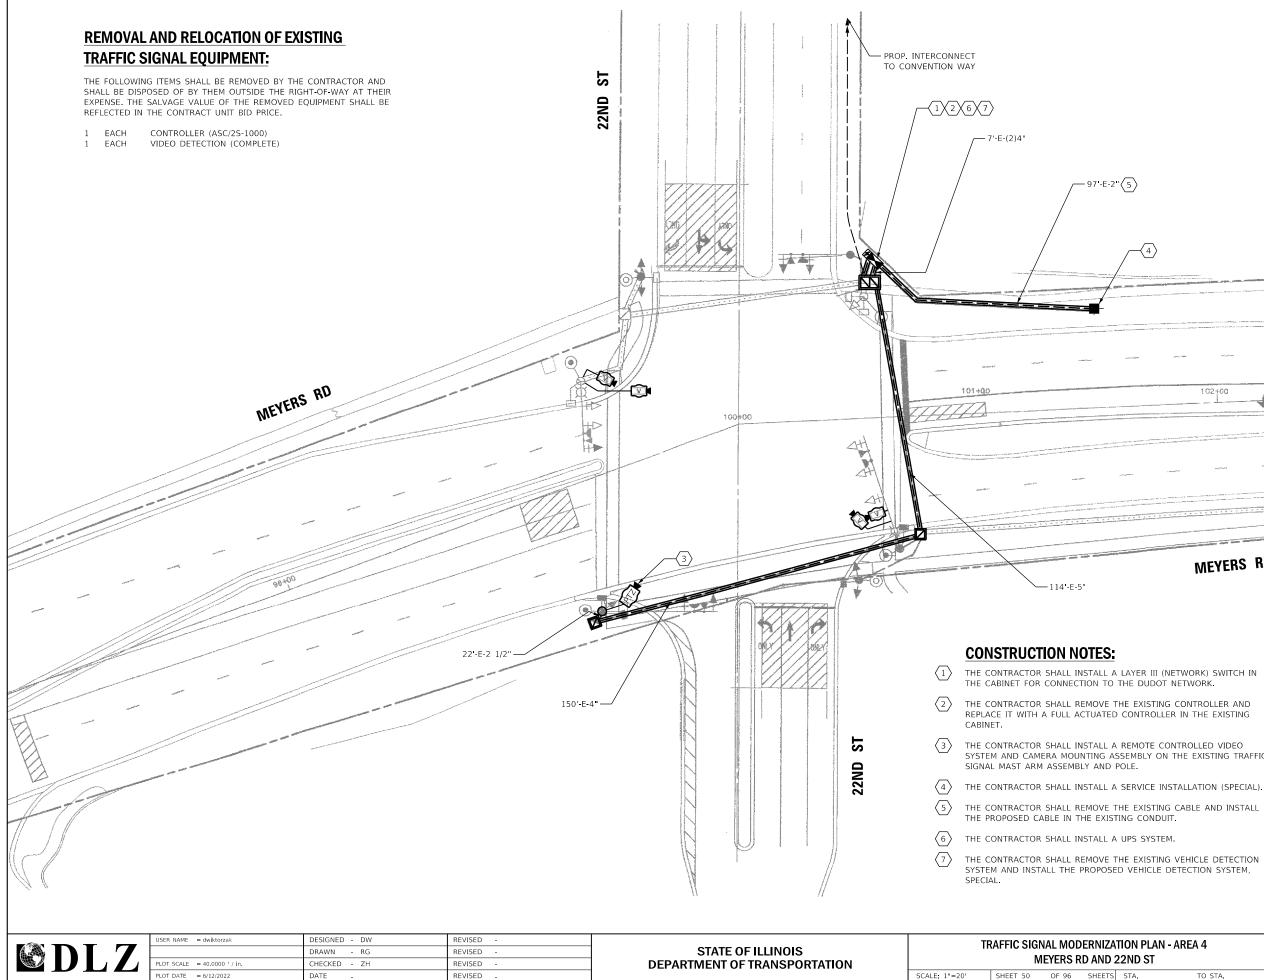

FILE NAME Int 48 = X:\Projects\2021\2182\217400 DuPage DOT Central\CADD_Sheets\sht-4D-Meyers-ts

4						
					And the provide statement with the second se	
ang	ماه الا الم معالم المحمد ال 	ann annan 1977 agus ann an annan ann an Array Agus a	na analasanan, y MAA amamaalashi Yofoton a a a analasana ka ya ay	ana ang sa ang sa	9	
upun dilaten sakad	nga na hakan		ngantan anatérés Many Kate, Mart		3+00	
	102+00					
ال المراجع التي المراجع المراجع المراجع المراجع	الم المساور العالم الي المراجع			man	an a	1999-19
	میرکاریک مربعہ ایک سال کی میں معلم کر میں ایک میں					7-
						/
	MEYERS	RD				
			EX. INTER TO CORPC CENTER E	DRATE		
<u>):</u>						
A LAYER III (NET O THE DUDOT NE	WORK) SWITCH I TWORK.	N				

SYSTEM AND CAMERA MOUNTING ASSEMBLY ON THE EXISTING TRAFFIC


THE VIDEO DETECTION SYSTEM, SPECIAL FOR THIS INTERSECTION SHALL BE AUTOSCOPE VISION TO MEET VILLAGE OF LOMBARD REOUIREMENTS.


PROP VIDEO DETECTION ZONES SHALL MATCH EXISTING VIDEO DETECTION ZONES, UNLESS DIRECTED OTHERWISE BY THE ENGINEER.


THE TRAFFIC SIGNAL CONTROL EQUIPMENT FOR THIS PROJECT SHALL BE NTCIP (LATEST VERSION).

DUDOT

ZATION PLAN - AREA 4 D 22ND ST		SECTION			COUNTY	TOTAL SHEETS	SHEET NO.
		R. 19-DCCSS-04-TL			DUPAGE	293	115
					CONTRACT	NO. 6	1H96
TS STA. TO STA.			ILLINOIS	FED. A	ID PROJECT		

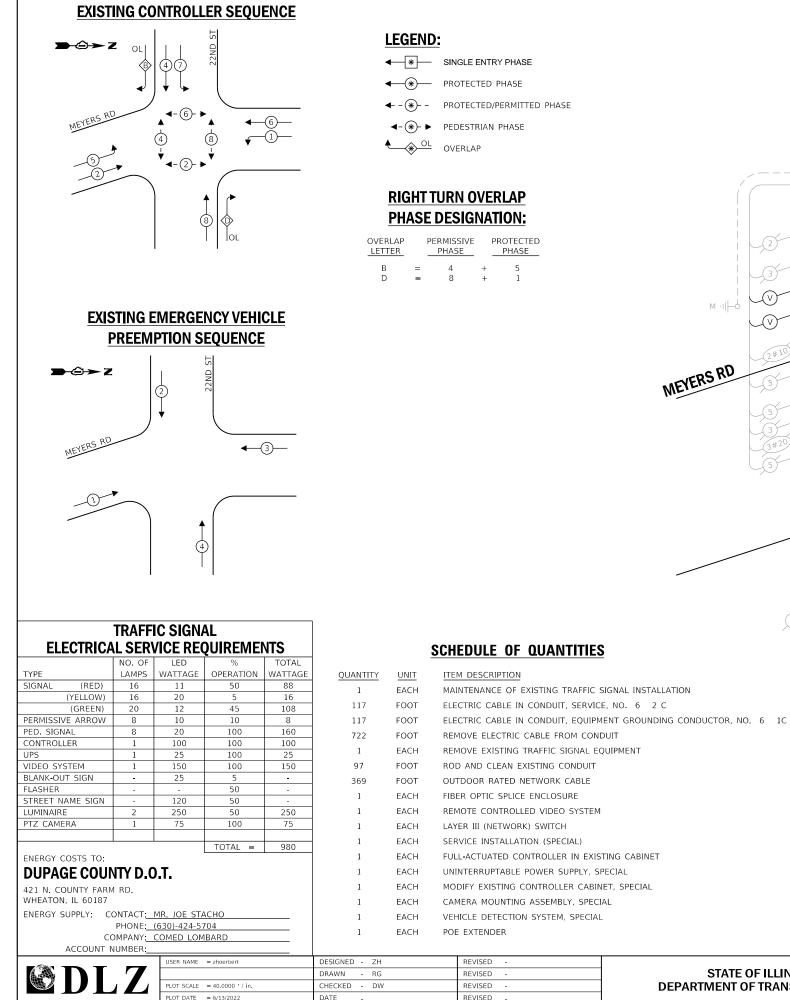

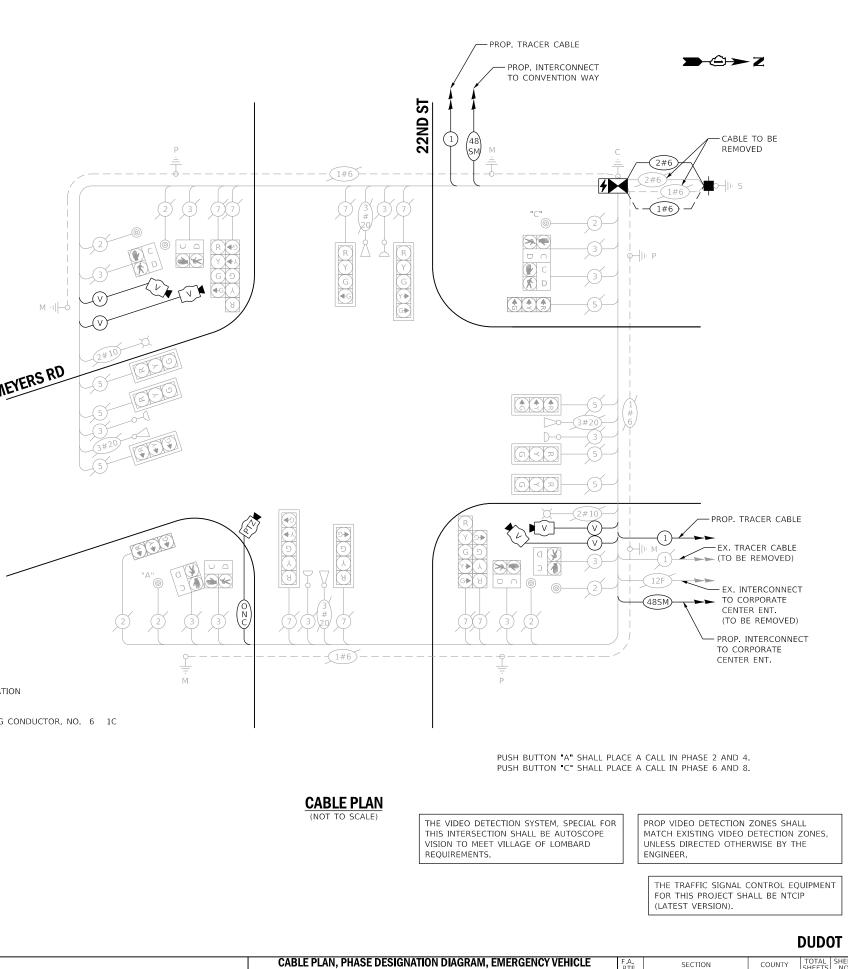

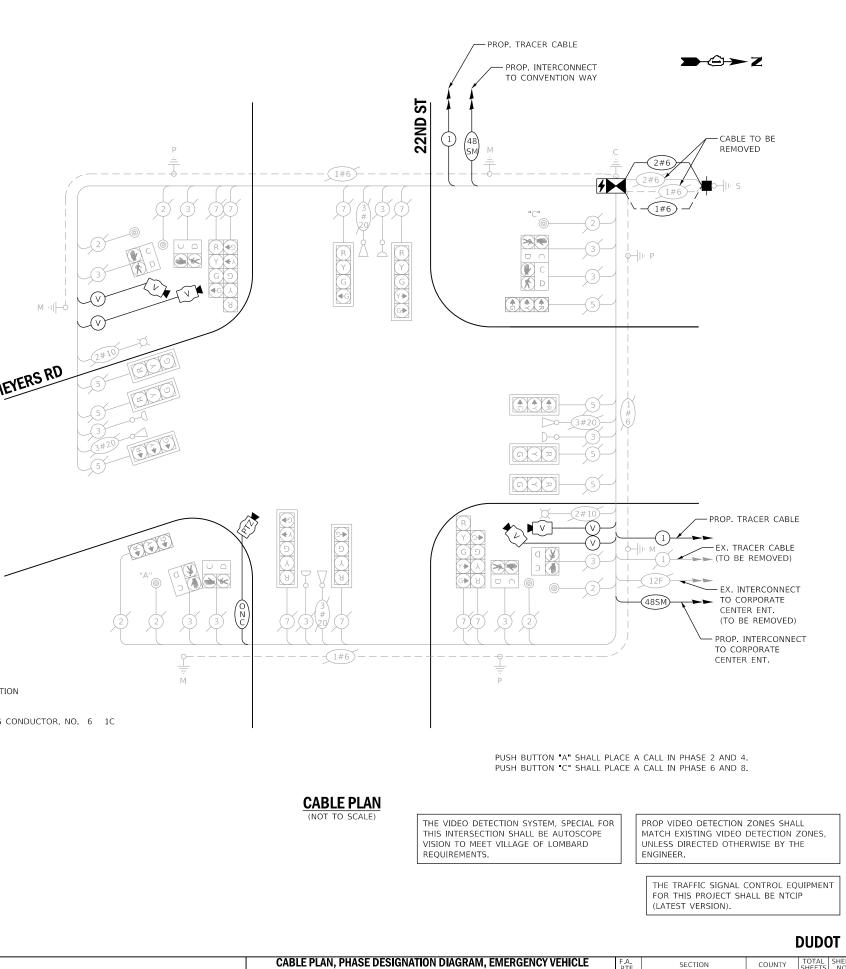





	CABLE PLA	.,			· • • • • • • • • • • • • • • • • • • •	, EMERGENCY VEHICLE	F.A. RTE	SECTION	COUNTY	TOTAL SHEETS	SHEET NO.
 STATE OF ILLINOIS	PREEMPTI					QUANTITIES - AREA 4	VAR.	19-DCCSS-04-TL	DUPAGE	293	116
DEPARTMENT OF TRANSPORTATION		M	EYERS R	<u>D AND 2</u>	<u>22ND S</u>	ST			CONTRACT	NO. 6	1H96
	SCALE:	SHEET 51	OF 96	SHEETS	STA.	TO STA.		ILLINOIS FED. A	ID PROJECT		

FILE NAME = X Projects/2021/2182/217400 DuPage DOT Central/CADD Sheets/sht-4D-Meyers-ts-Cable.dgn Int 48



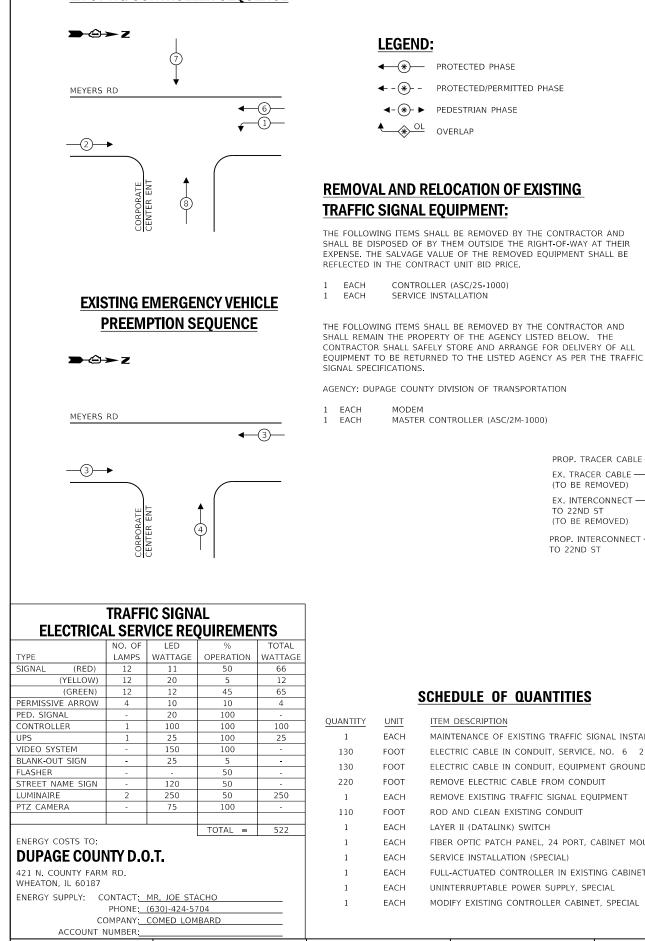

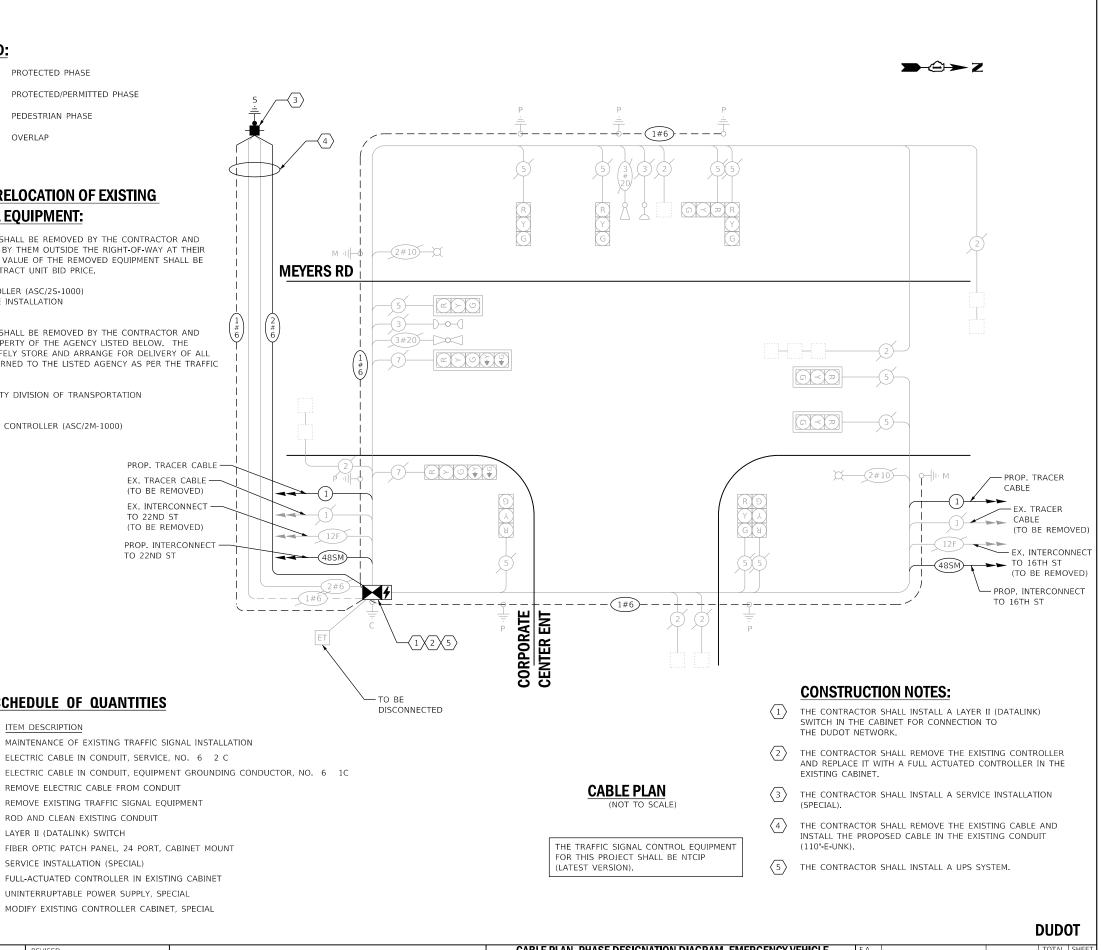


REMOVE EXISTING TRAFFIC SIGNAL EQUIPMENT


- ROD AND CLEAN EXISTING CONDUIT
- LAYER II (DATALINK) SWITCH
- FIBER OPTIC PATCH PANEL, 24 PORT, CABINET MOUNT
- SERVICE INSTALLATION (SPECIAL)
- FULL-ACTUATED CONTROLLER IN EXISTING CABINET
- UNINTERRUPTABLE POWER SUPPLY, SPECIAL
 - MODIFY EXISTING CONTROLLER CABINET, SPECIAL

ACCOUNT NUMBER:										
ØDLZ	USER NAME = dwiktorzak	DESIGNED - ZH	REVISED -			,	GRAM, EMERGENCY VEHICLE	F.A. BTE	SECTION	COUNTY TOTAL SHEET
		DRAWN - RG	REVISED -	STATE OF ILLINOIS	PREEMP	PTION SEQUENCE AND SCHED	ULE OF QUANTITIES - AREA 4	VAR.	19-DCCSS-04-TL	DUPAGE 293 117
	PLOT SCALE = 40.0000 / in.	CHECKED - DW	REVISED -	DEPARTMENT OF TRANSPORTATION		MEYERS RD AND CORPOR	ATE CENTER ENT			CONTRACT NO. 61H96
	PLOT DATE = 6/12/2022	DATE -	REVISED -		SCALE:	SHEET 52 OF 96 SHEETS	STA. TO STA.		ILLINOIS FED.	AID PROJECT
FUE NAME	B. Base DOT ControlicaDD Characteristic 4D Manager to Calif	a de la								

FILE NAME = X:\Projects\2021\2182\217400 DuPage DOT Central\CADD_Sheets\sht-4D-Meyers-ts-Cable.dg Int 50

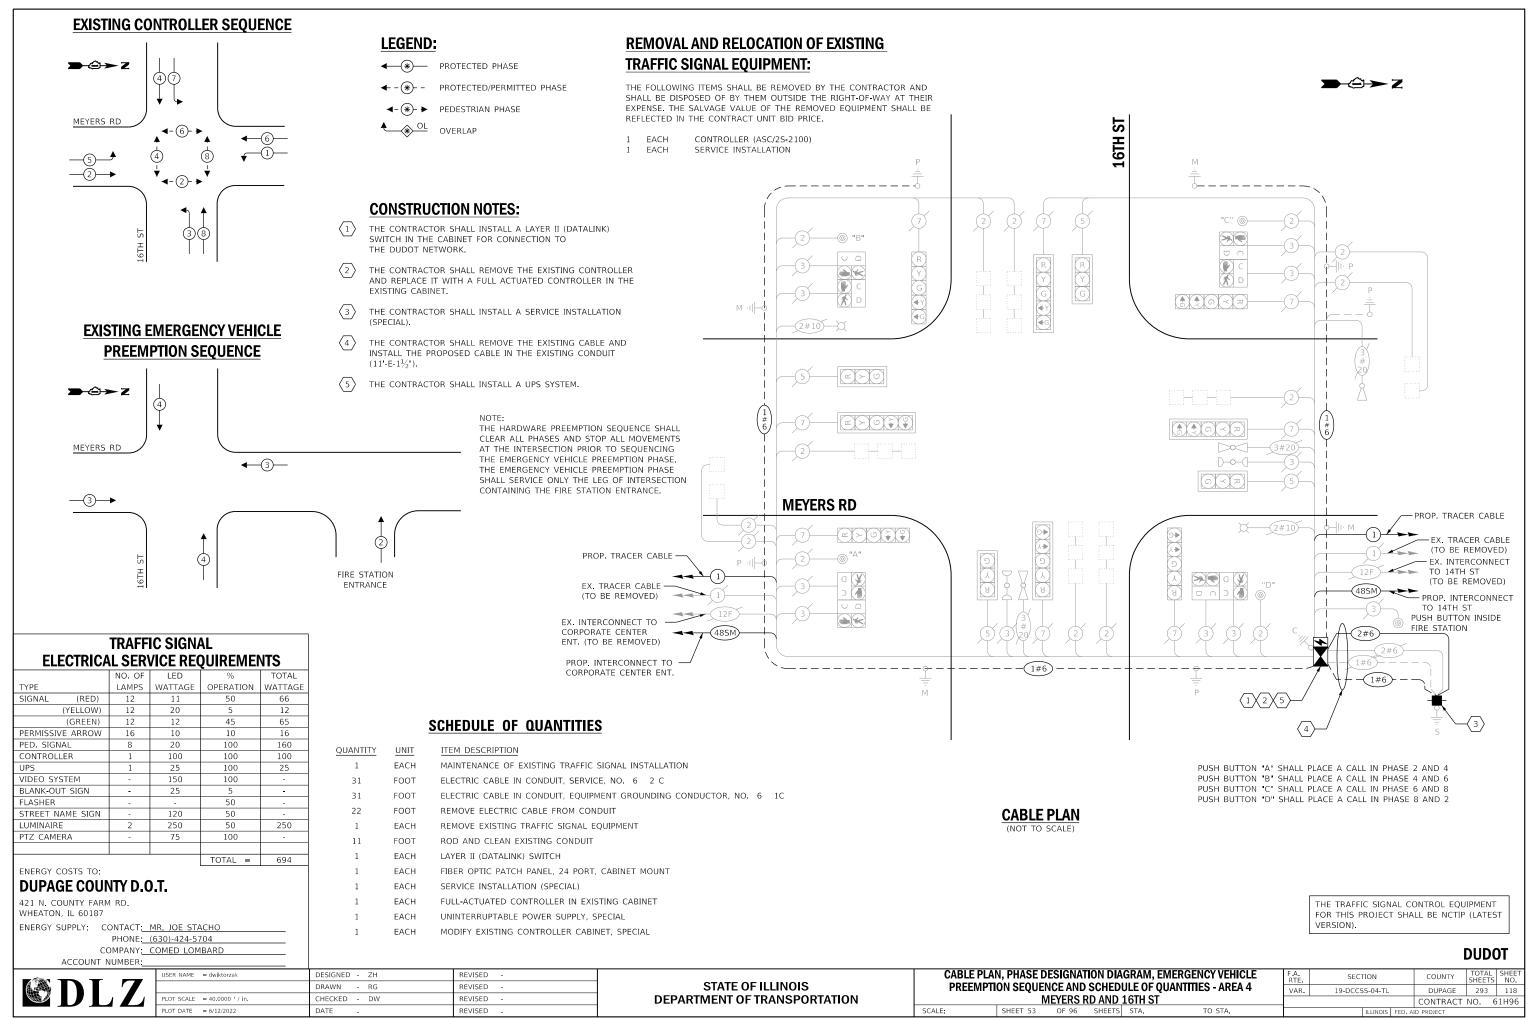

FILE NAME = X:Projects/2021/2182/217400 DuPage DOT Central/CADD Sheets/sht-4D-Meyers-ts-Cable.dgn Int 47

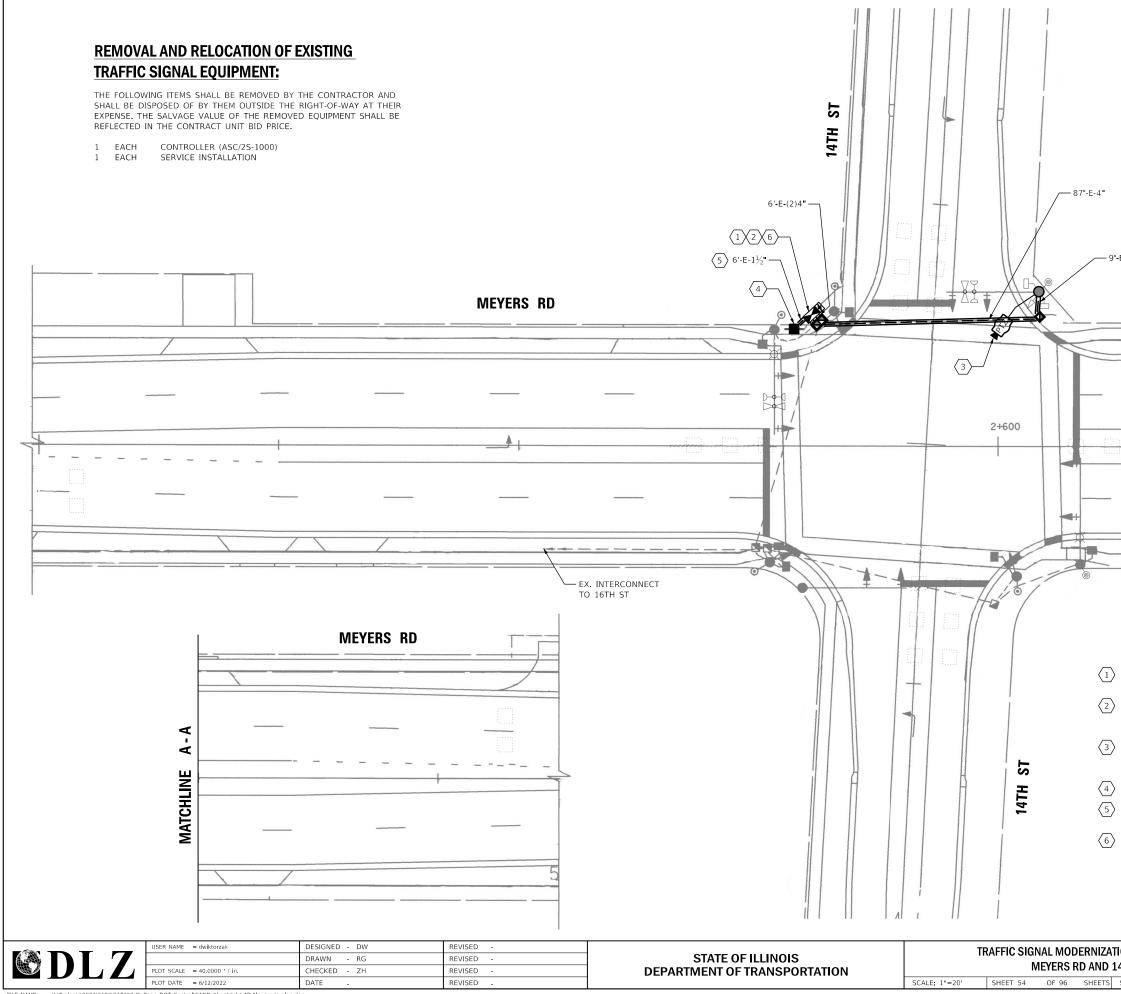

FILE NAME = X.\Projects\2021\2182\217400 DuPage DOT Central\CADD_Sheets\sht-4D-Meyers-ts-plan.dg Int 46

rs-ts-plan.dgn

> - 2 → 2	
-----------	--

– 9'-E-2½"

	 				-
	 			/	
					A - A
	 	(-		MATCHLINE
-					MATC
	 			/	
5. 	 		l	I	-

MEYERS RD


CONSTRUCTION NOTES:

- THE CONTRACTOR SHALL INSTALL A LAYER II (DATALINK) SWITCH IN THE CABINET FOR CONNECTION TO THE DUDOT NETWORK.
- 2 THE CONTRACTOR SHALL REMOVE THE EXISTING CONTROLLER AND REPLACE IT WITH A FULL ACTUATED CONTROLLER IN THE EXISTING CABINET.
- THE CONTRACTOR SHALL INSTALL A REMOTE CONTROLLED VIDEO SYSTEM ON THE EXISTING TRAFFIC SIGNAL MAST ARM ASSEMBLY AND POLE.
- THE CONTRACTOR SHALL INSTALL A SERVICE INSTALLATION (SPECIAL).
- THE CONTRACTOR SHALL REMOVE THE EXISTING CABLE AND INSTALL THE PROPOSED CABLE IN THE EXISTING CONDUIT (6'-E- $1\frac{1}{2}$ ").
- 5 THE CONTRACTOR SHALL INSTALL A UPS SYSTEM.

THE TRAFFIC SIGNAL CONTROL EQUIPMENT FOR THIS PROJECT SHALL BE NTCIP (LATEST VERSION).

DUDOT


ATION PLAN - AREA 4	F.A. RTE	SECTION			COUNTY	TOTAL SHEETS	SHEET NO.
D 14TH ST		19-DCCSS-04-TL			DUPAGE	293	119
5 14111 51					CONTRACT	NO. 6	51H96
IS STA. TO STA.	ILLINOIS FED.				ID PROJECT		

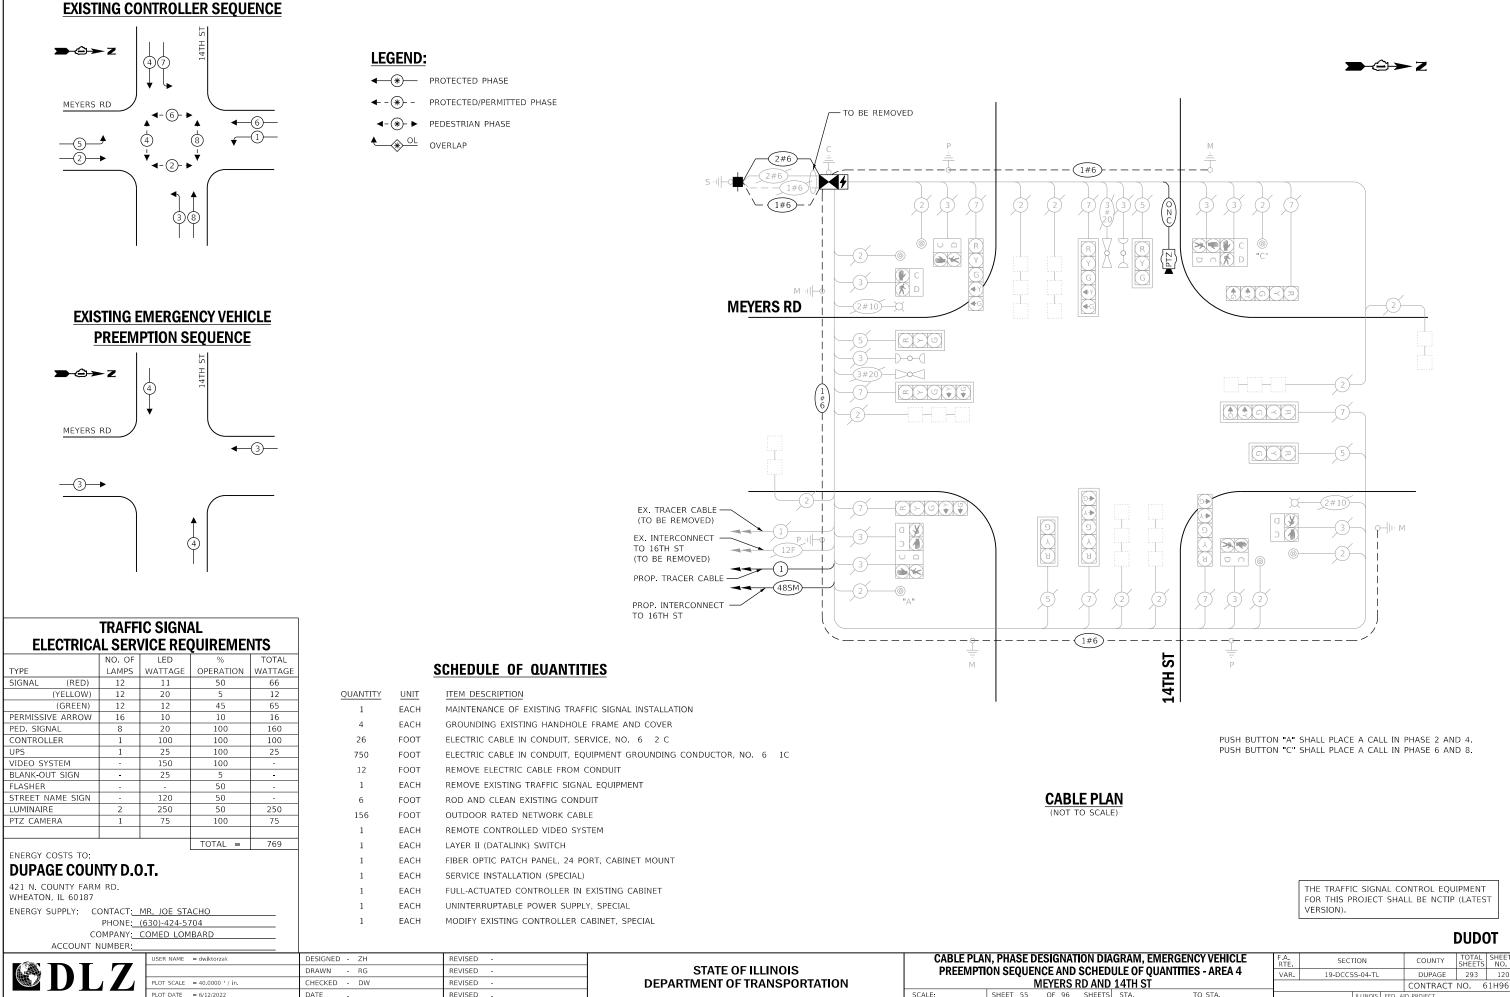

FILE NAME = X Projects\2021\2182\217400 DuPage DOT Central\CADD Sheets\sht-4D-Meyers-ts-Cable.dgn Int 46

	ULE OF QUANTI	1ES - AREA 4	VAR.	19-DCCSS-04-TL			DUPAGE	293	120
<u>ND</u>	14TH ST						CONTRACT	NO. (61H96
TS	STA.	TO STA.			ILLINOIS	FED. A	ID PROJECT		

EXISTING CONTROLLER SEQUENCE

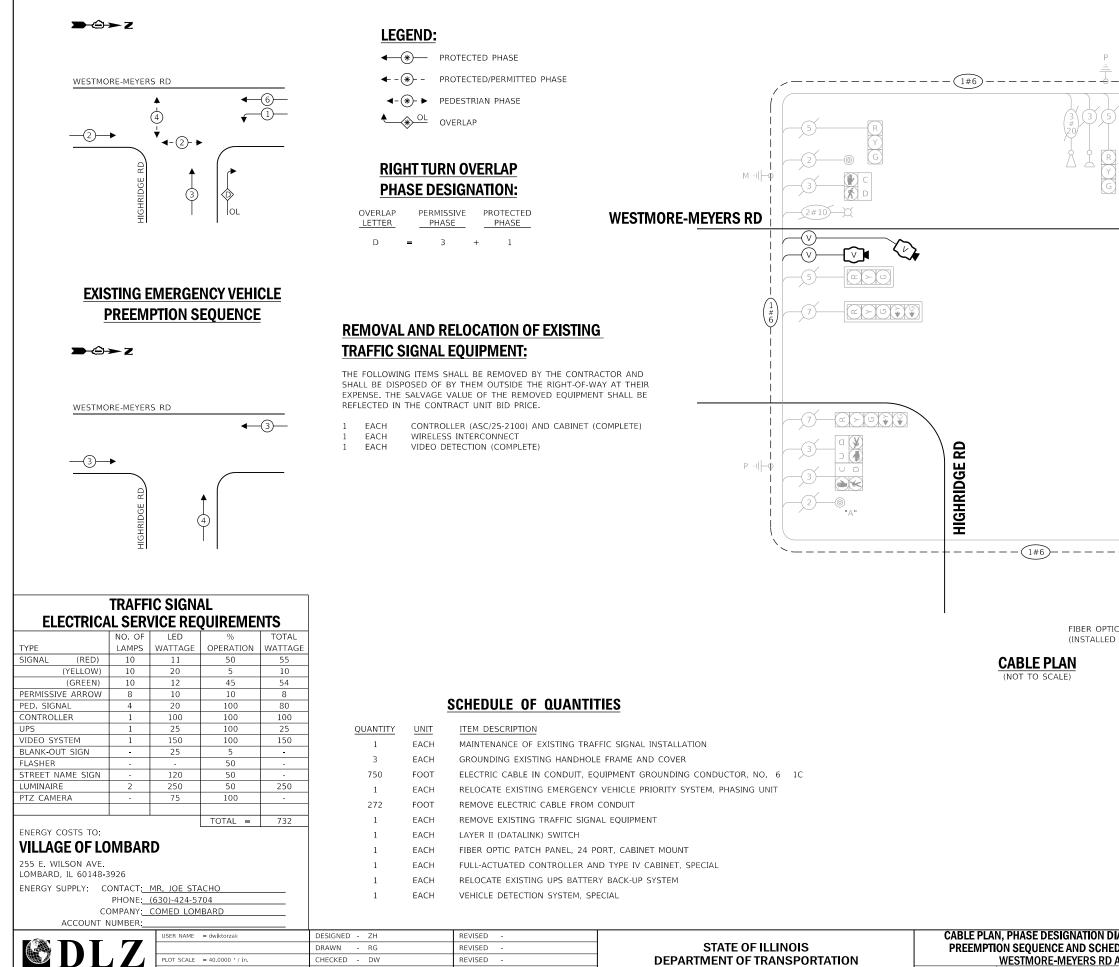



FILE NAME = X\Projects\2021\2182\217400 DuPage DOT Central\CADD_Sheets\sht-4D-Meyers-ts-Cable.dgn Int 105

PLOT DATE = 6/12/2022

DATE

REVISED

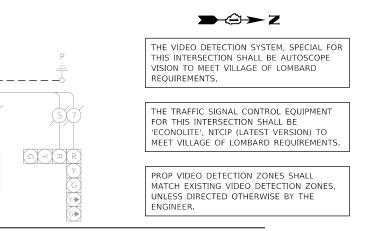

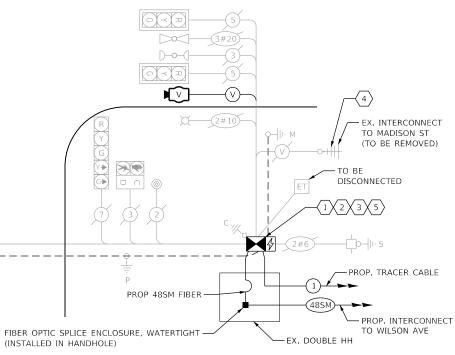

PUSH BUTTON "A" SHALL PLACE A CALL IN PHASE 2 AND 4.

CONSTRUCTION NOTES:


- 1) THE CONTRACTOR SHALL INSTALL A LAYER II (DATALINK) SWITCH IN THE CABINET FOR CONNECTION TO THE DUDOT NETWORK.
- (2) THE CONTRACTOR SHALL REMOVE THE EXISTING CONTROLLER AND CABINET (COMPLETE) AND REPLACE IT WITH A FULL-ACTUATED CONTROLLER AND TYPE IV CABINET, SPECIAL ON EXISTING FOUNDATION. REINSTALL THE EXISTING EMERGENCY VEHICLE PRIORITY SYSTEM, PHASING UNIT.
- ${\footnotesize \hline \ }$ The contractor shall relocate existing ups battery back-up system.
- 4 THE CONTRACTOR SHALL REMOVE THE EXISTING WIRELESS INTERCONNECT.
- 5 THE CONTRACTOR SHALL REMOVE THE EXISTING VEHICLE DETECTION SYSTEM AND INSTALL THE PROPOSED VIDEO DETECTION SYSTEM, SPECIAL.

SCALE


SHEET 56 OF 96 SHEET

LOMBARD TS 18

IAGRAM, EMERGENCY VEHICLE EDULE OF QUANTITIES - AREA 4		F.A. RTE	SECTION		COUNTY	TOTAL SHEETS	SHEET NO.		
		VAR.	19-DCCSS-0	19-DCCSS-04-TL			293	121	
A	<u>VD HIGI</u>	HRIDGE RD				CONTRACT NO. 61H96			51H96
TS	STA.	TO STA.		ILL	LINOIS	FED. AI	D PROJECT		

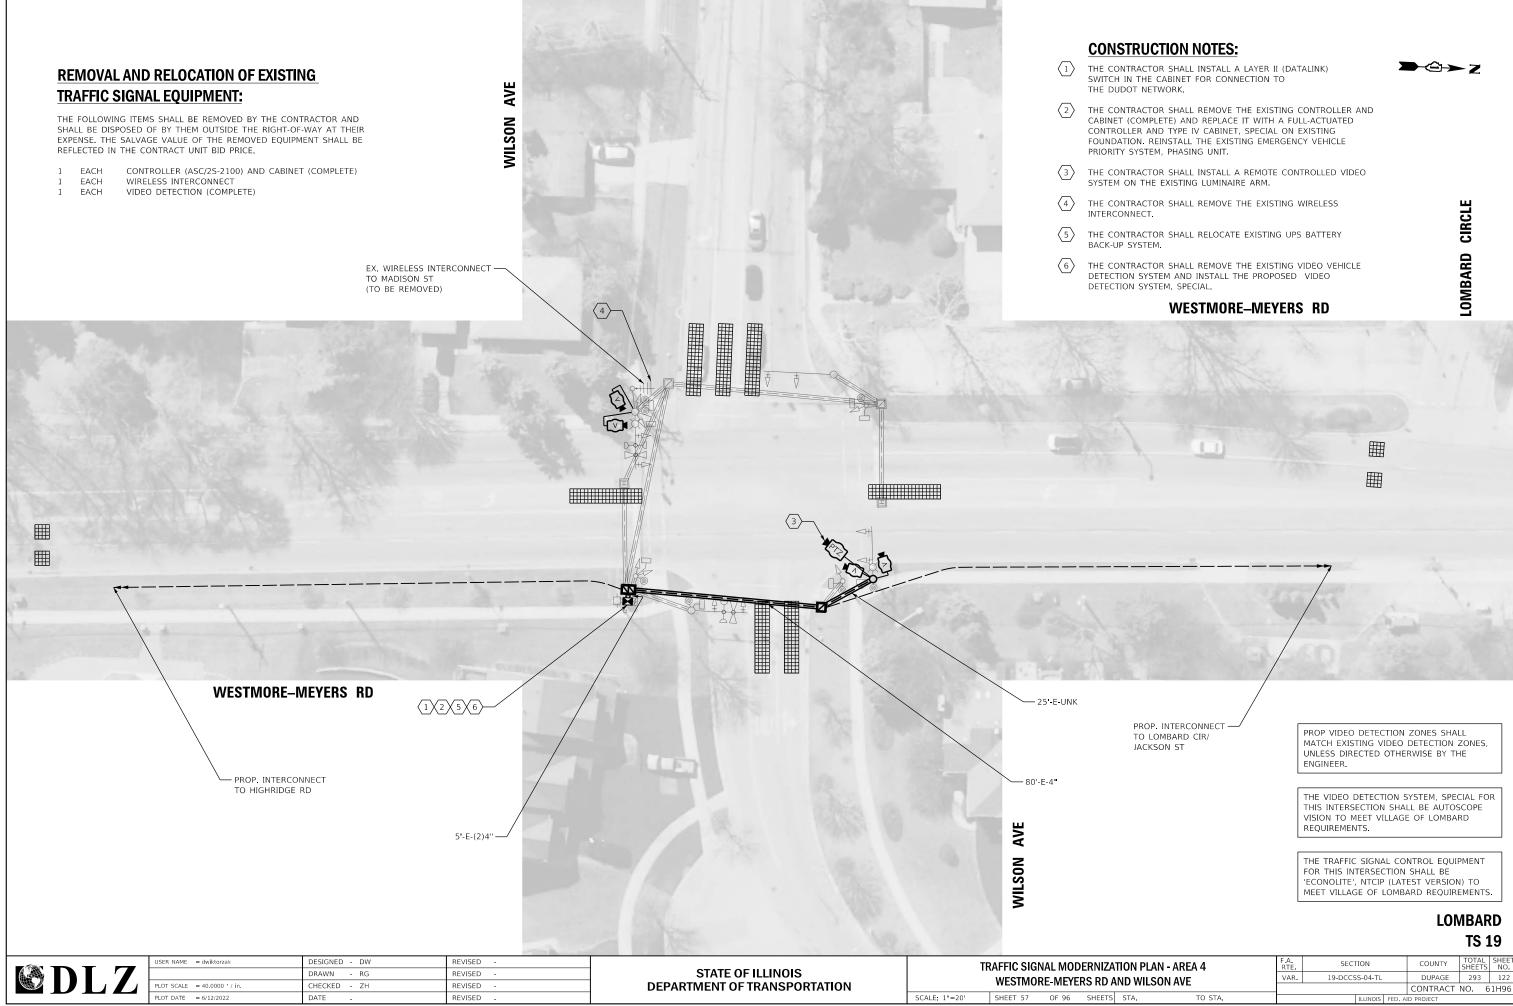

= X\Projects\2021\2182\217400 DuPage DOT Central\CADD_Sheets\sht-4D-Meye

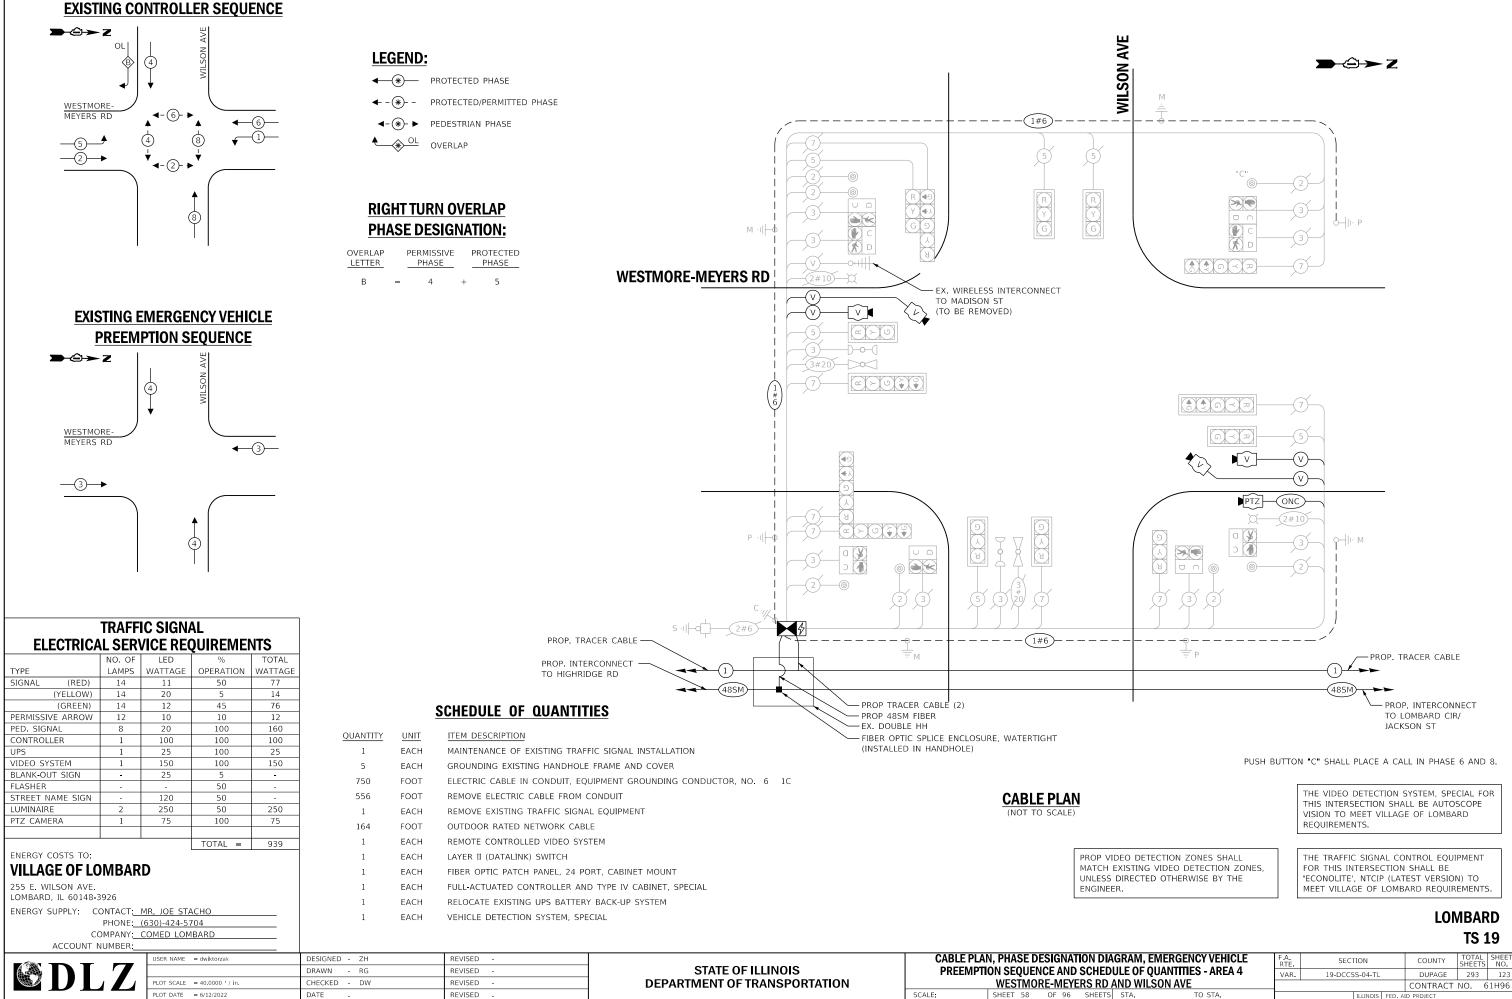


FILE NAME = X1Projects\2021\2182\217400 DuPage DOT Central\CADD Sheets\sht-4D-Meyers to Cable.dgn Int 111

	F.A. RTE	SECTION			COUNTY	TOTAL SHEETS	SHEET NO.
•	VAR.	19-DCCS	S-04-TL		DUPAGE	293	123
D AND WILSON AVE					CONTRACT	NO. 6	1H96
TS STA. TO STA.			ILLINOIS	FED. A	ID PROJECT		

EXISTING CONTROLLER SEQUENCE

>-⊖≻z WESTMORE-MEYERS RD **∢**-②-► (4)(8) 🗲 **∢**-6)- ► (8) EXISTING EMERGENCY VEHICLE PREEMPTION SEQUENCE **>**-⊖→ z 0 (4) WESTMORE-MEYERS RD <--(3)-_(3)_→

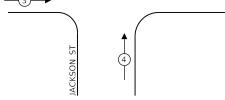

ELECTRICA		IC SIGN/ /ICE RE(NTS		
	NO. OF	LED	%	TOTAL		
TYPE	LAMPS	WATTAGE	OPERATION	WATTAGE		
SIGNAL (RED)	10	11	50	55		
(YELLOW)	10	20	5	10		
(GREEN)	10	12	45	54		
PERMISSIVE ARROW	4	10	10	4		
PED. SIGNAL	8	20	100	160		
CONTROLLER	1	100	100	100		
UPS	1	25	100	25		
VIDEO SYSTEM	1	150	100	150	QUANTITY	UN
BLANK-OUT SIGN	-	25	5	-	1	EAG
FLASHER	-	-	50	-	4	EAG
STREET NAME SIGN	-	120	50	-		
LUMINAIRE	2	250	50	250	750	FOG
PTZ CAMERA	-	75	100	-	1	EAG
			TOTAL =	808	617	FOO
ENERGY COSTS TO:			TOTAL -	000	1	EAG
VILLAGE OF LC	MBAR	D			1	EAG
255 E. WILSON AVE.		-			1	EAG
LOMBARD, IL 60148-3	3926				1	EAG
ENERGY SUPPLY: C					1	EAG
		(630)-424-57			1	EAG
		COMED LOM	IBAKU			
ACCOUNT I	NOWREK.					
		USER NAME	= dwiktorzak		DESIGNED -	ZH
					DRAWN -	RG

LEGEND:

- ← (*) PROTECTED PHASE
- ← (*)- PROTECTED/PERMITTED PHASE
- ◄-(*)- ► PEDESTRIAN PHASE
- OVERLAP


CONSTRUCTION NOTES:

- THE CONTRACTOR SHALL INSTALL A LAYER II (DATALINK) SWITCH IN THE CABINET FOR CONNECTION TO $\langle 1 \rangle$ THE DUDOT NETWORK.
- THE CONTRACTOR SHALL REMOVE THE EXISTING CONTROLLER $\langle 2 \rangle$ AND CABINET (COMPLETE) AND REPLACE IT WITH A FULL-ACTUATED CONTROLLER AND TYPE IV CABINET, SPECIAL ON EXISTING FOUNDATION. REINSTALL THE EXISTING EMERGENCY VEHICLE PRIORITY SYSTEM, PHASING UNIT.
- $\langle 3 \rangle$ THE CONTRACTOR SHALL REMOVE THE EXISTING WIRELESS INTERCONNECT.
- $\langle 4 \rangle$ THE CONTRACTOR SHALL RELOCATE EXISTING UPS BATTERY BACK-UP SYSTEM.
- $\langle 5 \rangle$ THE CONTRACTOR SHALL INSTALL A VIDEO DETECTION SYSTEM, SPECIAL.

REMOVAL AND RELOCATION OF EXISTING TRAFFIC SIGNAL EOUIPMENT:

THE FOLLOWING ITEMS SHALL BE REMOVED BY THE CONTRACTOR AND SHALL BE DISPOSED OF BY THEM OUTSIDE THE RIGHT-OF-WAY AT THEIR EXPENSE. THE SALVAGE VALUE OF THE REMOVED EQUIPMENT SHALL BE REFLECTED IN THE CONTRACT UNIT BID PRICE.

- CONTROLLER (ASC/2S-2100) AND CABINET (COMPLETE) EACH
- EACH WIRELESS INTERCONNECT
- EACH VIDEO DETECTION (COMPLETE)

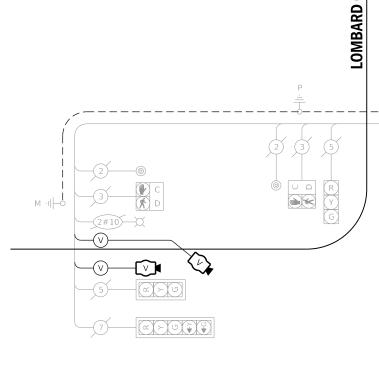

CIR


WESTMORE-MEYERS RD

(↺≬≩≬♥ **JACKSON ST** $\left(1\right)\left(2\right)\left(4\right)\left(5\right)$ TO BE DISCONNECTED s ·II-q_--(2#6) (1#6) PROP. TRACER CABLE -PROP. INTERCONNECT TO WILSON AVE (48SM) PROP TRACER CABLE (2) - PROP 48SM FIBER -EX. DOUBLE HH - FIBER OPTIC SPLICE ENCLOSURE, WATERTIGHT (INSTALLED IN HANDHOLE)


SCHEDULE OF QUANTITIES

UANTITY	UNIT	ITEM DESCRIPTION	
1	EACH	MAINTENANCE OF EXISTING TRAFFIC SIGNAL INSTALLATION	
4	EACH	GROUNDING EXISTING HANDHOLE FRAME AND COVER	
750	FOOT	ELECTRIC CABLE IN CONDUIT, EQUIPMENT GROUNDING CONDUCTOR, NO. 6 1C	
1	EACH	RELOCATE EXISTING EMERGENCY VEHICLE PRIORITY SYSTEM, PHASING UNIT	
617	FOOT	REMOVE ELECTRIC CABLE FROM CONDUIT	
1	EACH	REMOVE EXISTING TRAFFIC SIGNAL EQUIPMENT	
1	EACH	LAYER II (DATALINK) SWITCH	
1	EACH	FIBER OPTIC PATCH PANEL, 24 PORT, CABINET MOUNT	
1	EACH	FULL-ACTUATED CONTROLLER AND TYPE IV CABINET, SPECIAL	CABLE PLAN
1	EACH	RELOCATE EXISTING UPS BATTERY BACK-UP SYSTEM	(NOT TO SCALE)
1	EACH	VEHICLE DETECTION SYSTEM, SPECIAL	(
SIGNED -	ZH	REVISED -	CABLE PLAN, PHASE

ABLE PLAN, PHASE DESIGNATION DIAGRAM, EMERGENCY VEHICLE STATE OF ILLINOIS PREEMPTION SEQUENCE AND SCHEDULE OF QUANTITIES - AREA 4 REVISED PLOT SCALE = 40.0000 ' / in. CHECKED - DW REVISED **DEPARTMENT OF TRANSPORTATION** WESTMORE-MEYERS RD AND LOMBARD CIR/JACKSON ST PLOT DATE = 6/12/2022 DATE REVISED SCALE SHEET 59 OF 96 SHEETS STA. FILE NAME = X\Projects\2021\2182\217400 DuPage DOT Central\CADD_Sheets\sht-4D-Meyers-ts-Cable.dgn Int 106

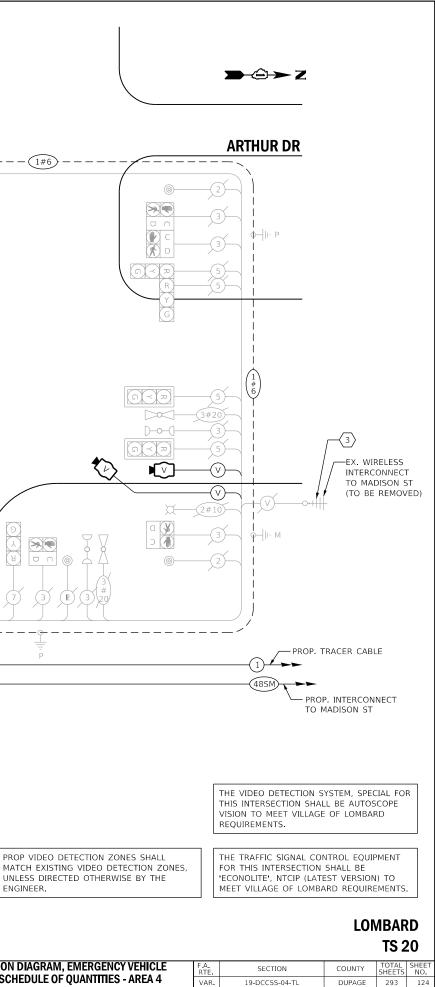

DUPAGE 293 124 CONTRACT NO. 61H96 TO STA

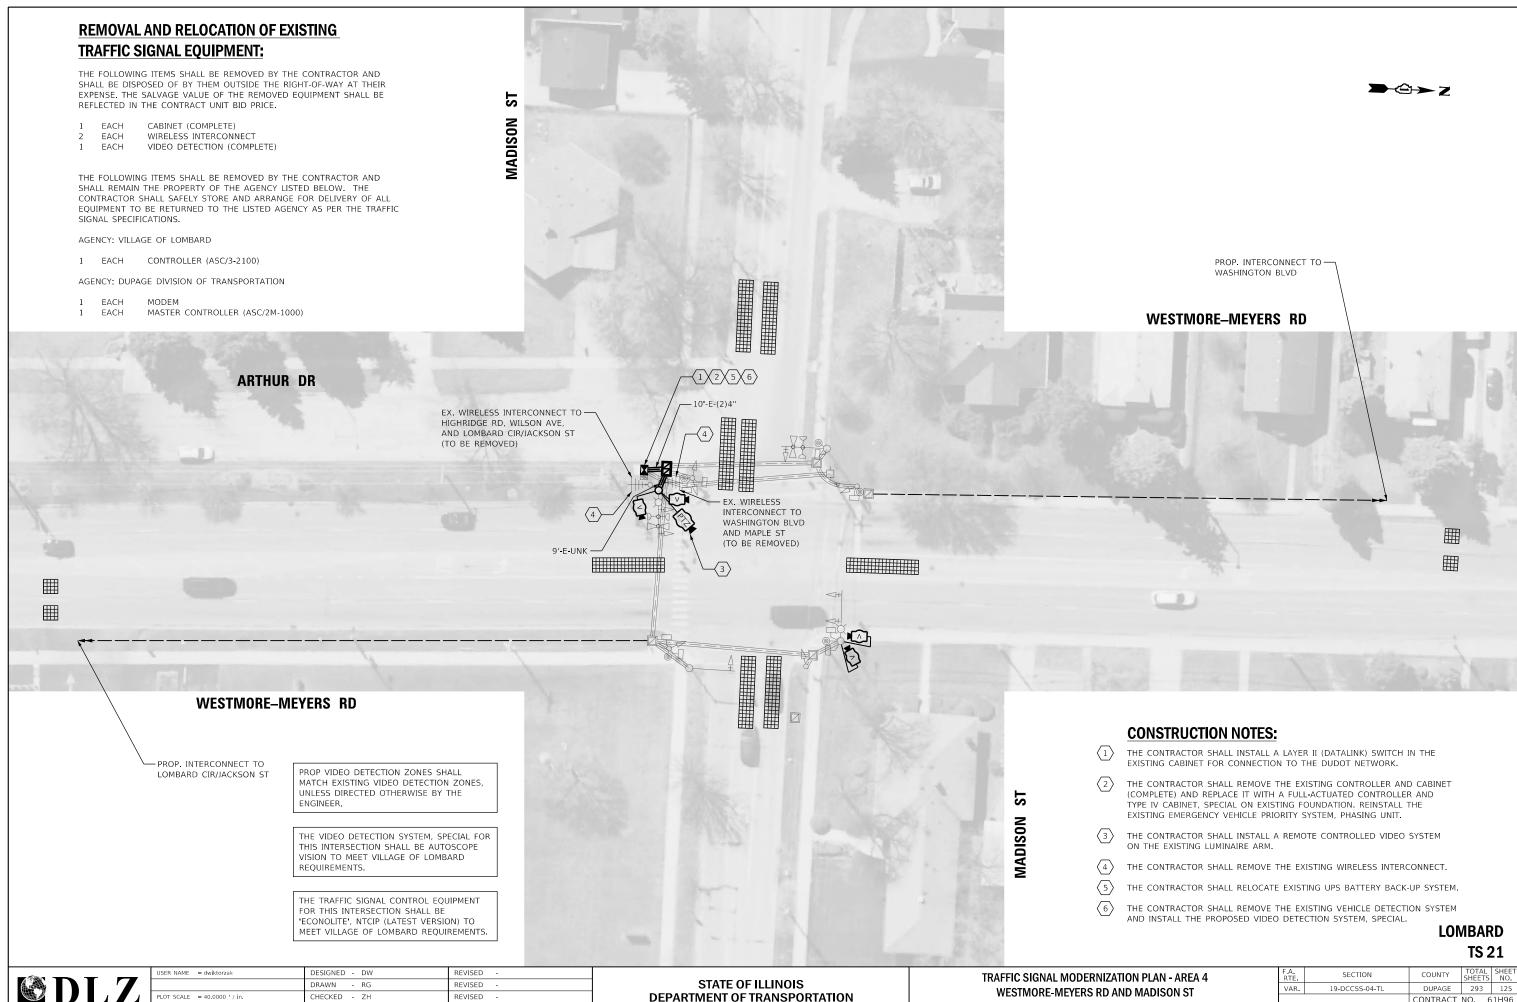

⁼ X \Projects\2021\2182\217400 DuPage DOT Central\CADD_Sheets\sht-4D-Meyers-ts-plan.dg


PLOT DATE = 6/12/2022

DATE


REVISED

SCALE: 1"=20' SHEET 60 OF 96 SHEETS

ZATION PLAN - AREA 4			F.A. RTE	SECT	SECTION			TOTAL SHEETS	SHEET NO.
AND MADISON ST		VAR.	19-DCCSS-04-TL			DUPAGE	293	125	
		CONTRACT NO. (51H96				
ΓS	STA.	TO STA.			ILLINOIS	FED. A	ID PROJECT		

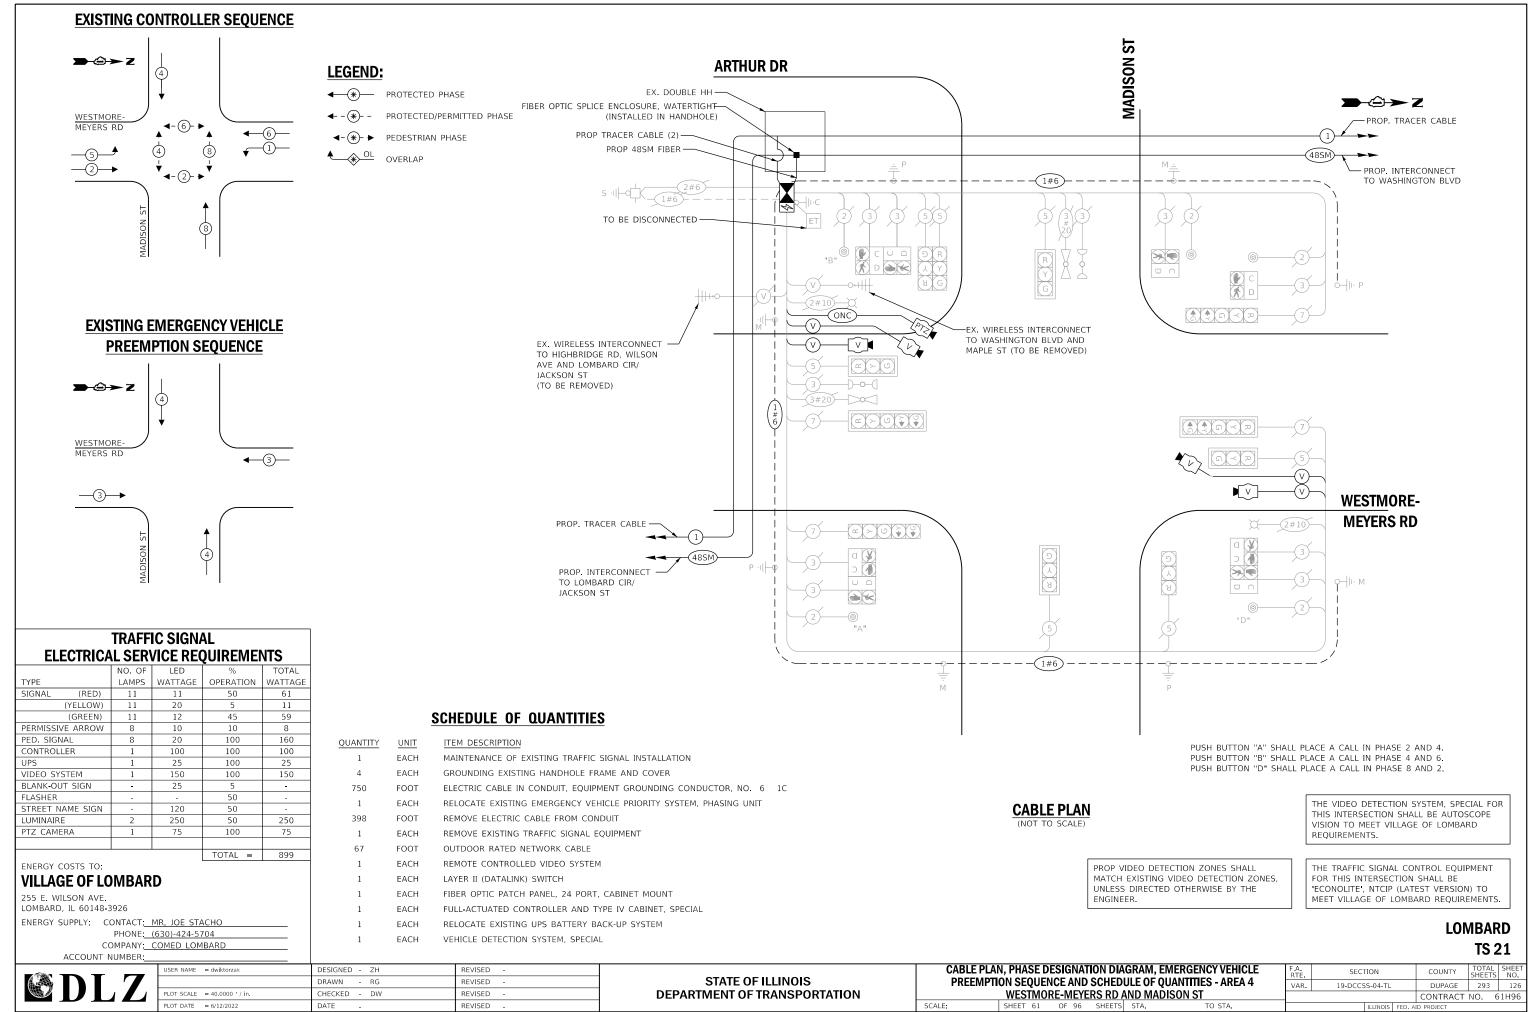

FILE NAME = X\Projects\2021\2182\217400 DuPage DOT Central\CADD_Sheets\sht-4D-Meyers-ts-Cable.dgn Int 107

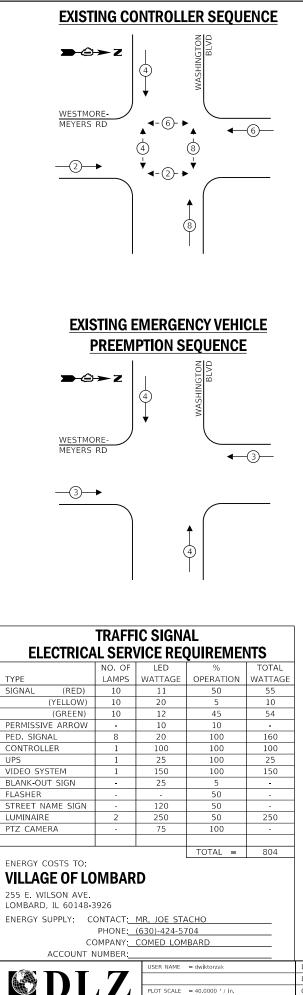

LEGEND:

- ← (*) PROTECTED PHASE
- ← (*)- PROTECTED/PERMITTED PHASE
- ◄-(*)- ► PEDESTRIAN PHASE
- OVERLAP


REMOVAL AND RELOCATION OF EXISTING TRAFFIC SIGNAL EQUIPMENT:

THE FOLLOWING ITEMS SHALL BE REMOVED BY THE CONTRACTOR AND SHALL BE DISPOSED OF BY THEM OUTSIDE THE RIGHT-OF-WAY AT THEIR EXPENSE. THE SALVAGE VALUE OF THE REMOVED EQUIPMENT SHALL BE REFLECTED IN THE CONTRACT UNIT BID PRICE.

CONTROLLER (ASC/2S-2100) AND CABINET (COMPLETE) EACH EACH WIRELESS INTERCONNECT

CONSTRUCTION NOTES:


- THE CONTRACTOR SHALL INSTALL A LAYER II (DATALINK) $\langle 1 \rangle$ SWITCH IN THE CABINET FOR CONNECTION TO THE DUDOT NETWORK
- THE CONTRACTOR SHALL REMOVE THE EXISTING CONTROLLER $\langle 2 \rangle$ AND CABINET (COMPLETE) AND REPLACE IT WITH A FULL-ACTUATED CONTROLLER AND TYPE IV CABINET, SPECIAL ON EXISTING FOUNDATION. REINSTALL THE EXISTING EMERGENCY VEHICLE PRIORITY SYSTEM, PHASING UNIT.
- $\langle 3 \rangle$ THE CONTRACTOR SHALL REMOVE THE EXISTING WIRELESS INTERCONNECT.
- THE CONTRACTOR SHALL RELOCATE EXISTING UPS BATTERY $\langle 4 \rangle$ BACK-UP SYSTEM.
- THE CONTRACTOR SHALL REMOVE THE EXISTING VEHICLE $\langle 5 \rangle$ DETECTION SYSTEM AND INSTALL THE PROPOSED VEHICLE DETECTION SYSTEM, SPECIAL.

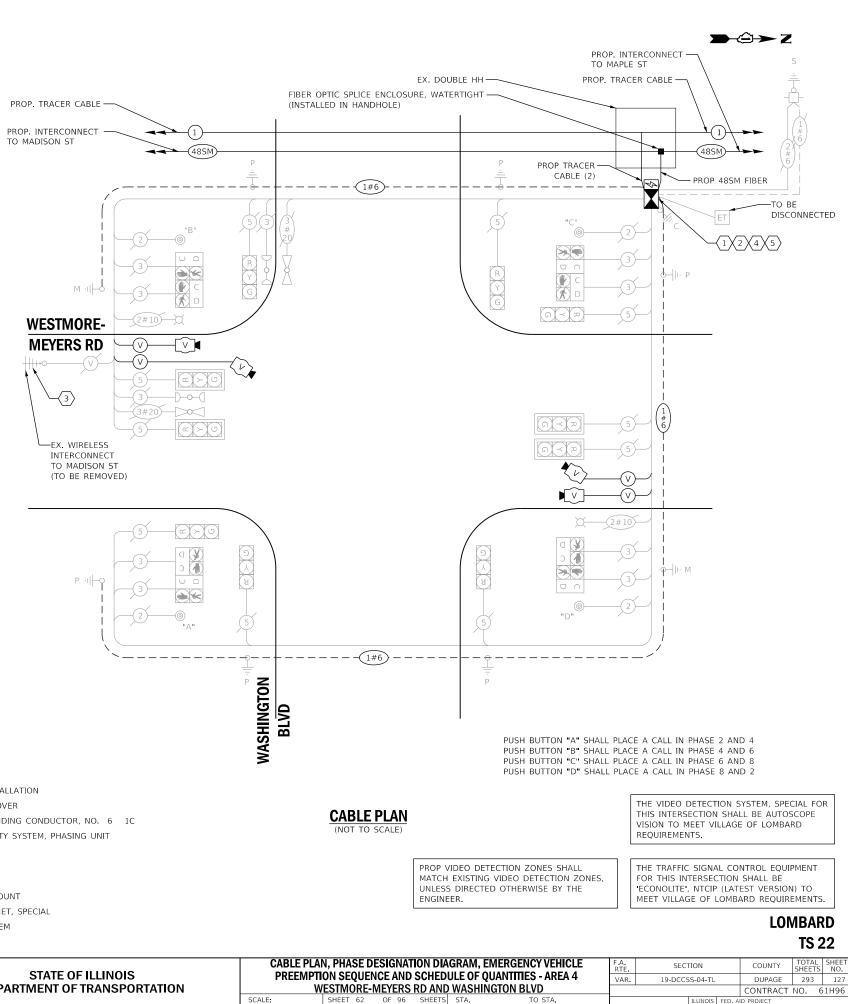

SCHEDULE OF QUANTITIES


D - 7H		REVISED -	CARLE PLAN PHASE DESIGNATION
1	EACH	VEHICLE DETECTION SYSTEM, SPECIAL	
1	EACH	RELOCATE EXISTING UPS BATTERY BACK-UP SYSTEM	
1	EACH	FULL-ACTUATED CONTROLLER AND TYPE IV CABINET, SPECIAL	
1	EACH	FIBER OPTIC PATCH PANEL, 24 PORT, CABINET MOUNT	E
1	EACH	LAYER II (DATALINK) SWITCH	M
1	EACH	REMOVE EXISTING TRAFFIC SIGNAL EQUIPMENT	P
382	FOOT	REMOVE ELECTRIC CABLE FROM CONDUIT	
1	EACH	RELOCATE EXISTING EMERGENCY VEHICLE PRIORITY SYSTEM, PHASING UNIT	(NOT TO SCALE)
750	FOOT	ELECTRIC CABLE IN CONDUIT, EQUIPMENT GROUNDING CONDUCTOR, NO. 6 1C	
4	EACH	GROUNDING EXISTING HANDHOLE FRAME AND COVER	
1	EACH	MAINTENANCE OF EXISTING TRAFFIC SIGNAL INSTALLATION	
QUANTITY	UNIT	ITEM DESCRIPTION	

DESIGNED - ZH DRAWN - RG REVISED OT SCALE = 40.0000 ' / in. HECKED - DW REVISED **DEPARTMENT OF TRANSPORTATION** REVISED PLOT DATE = 6/12/2022 DATE FILE NAME = X:Projects/2021/2182/217400 DuPage DOT Central/CADD Sheets/sht-4D-Meyers-ts-Cable.dgn Int 110

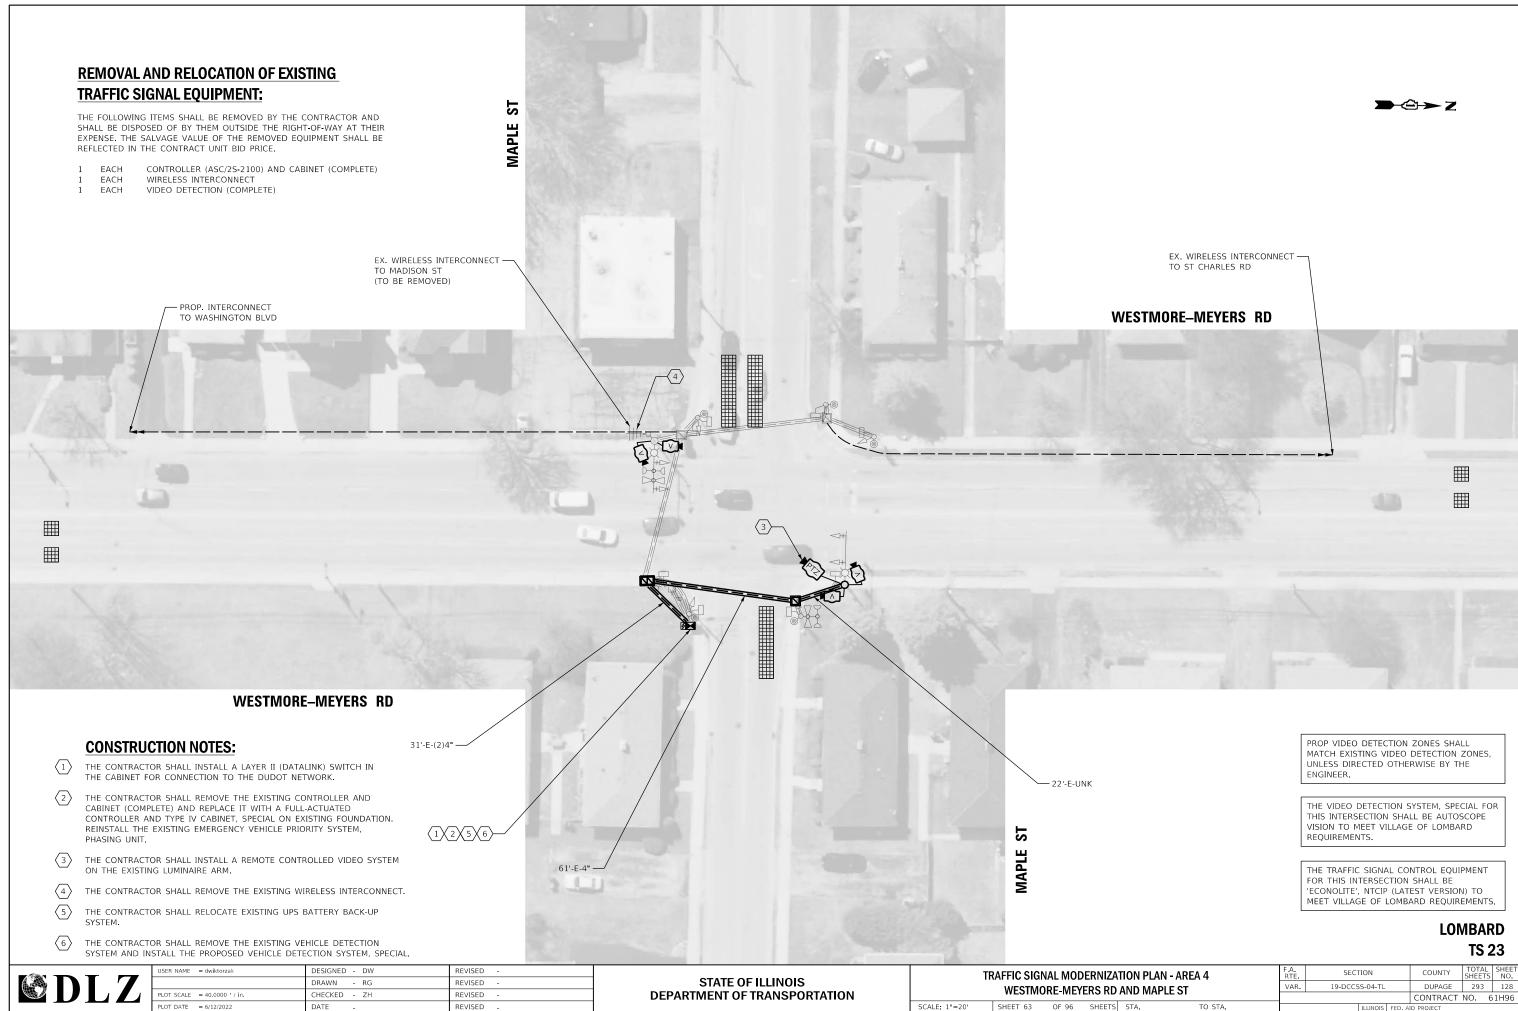


FILE NAME = X\Projects\2021\2182\217400 DuPage DOT Central\CADD_Sheets\sht-4D-Meyers-ts-plan.dg int 108

ZATION PLAN - AREA 4		F.A. RTE	SECTION		COUNTY	TOTAL SHEETS	SHEET NO.		
חי	AND MA	PI F ST	VAR.	19-DCCS	S-04-TL		DUPAGE	293	128
							CONTRACT	NO. 6	51H96
TS	STA.	TO STA.			ILLINOIS	FED. A	ID PROJECT		

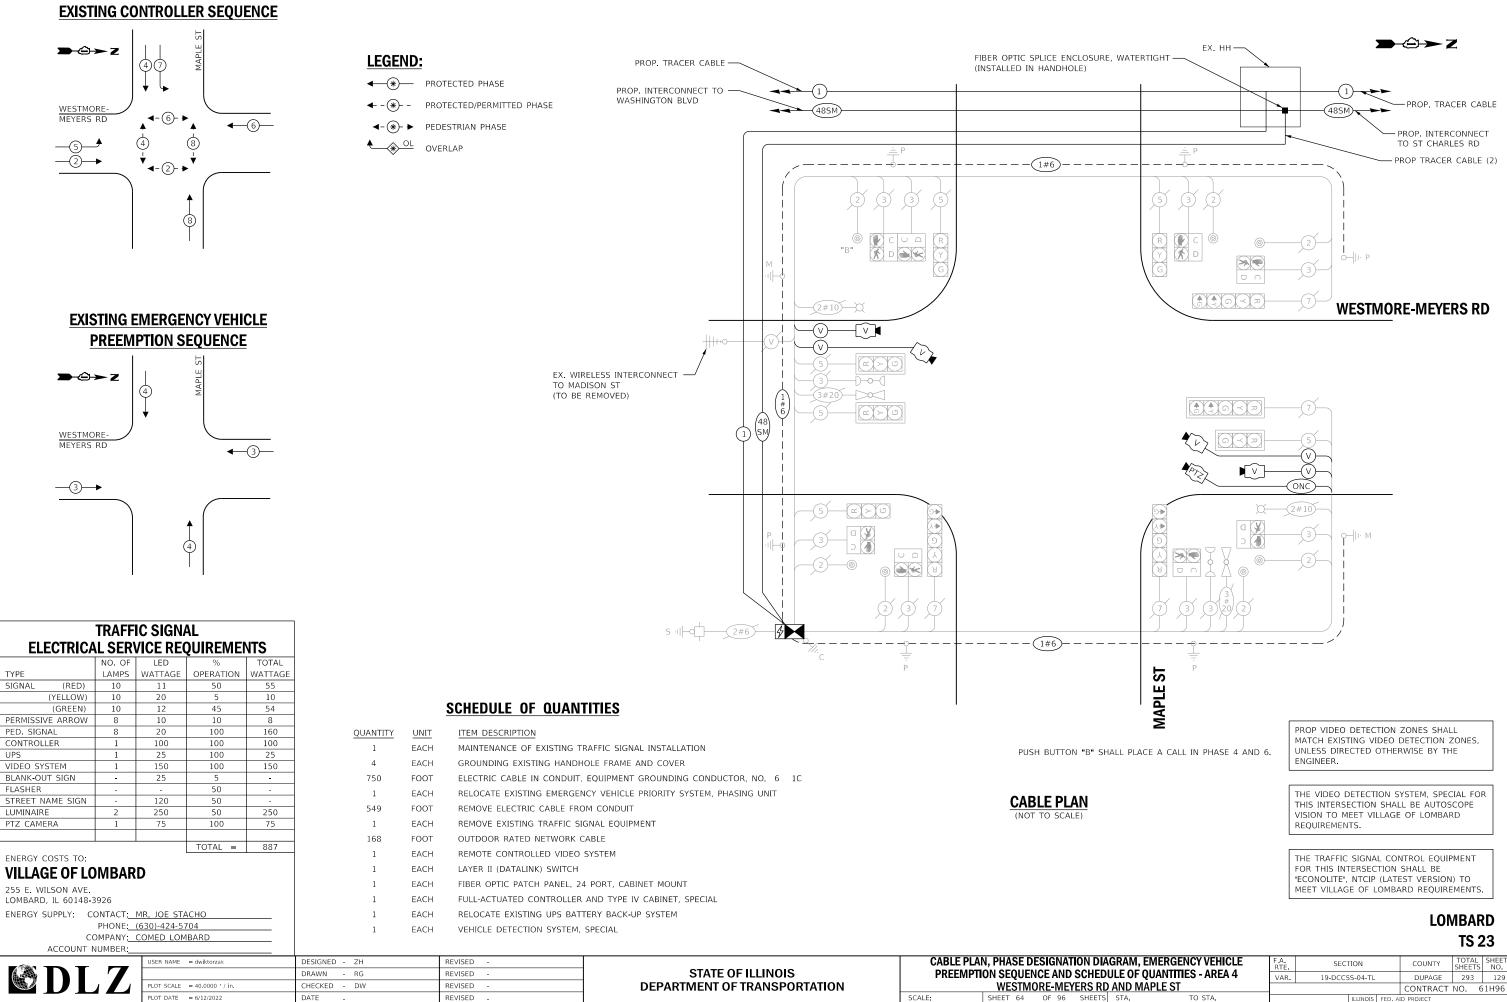

FILE NAME = X Projects/2021/2182/217400 DuPage DOT Central/CADD Sheets/sht-4D-Meyers-ts-Cable.dgn Int 108

			VAR.	I 19-DCCS	5-04-1L		DUPAGE	293	
D	AND MAPLE ST						CONTRACT	NO.	61⊦
5	STA.	TO STA.			ILLINOIS	FED. A	ID PROJECT		

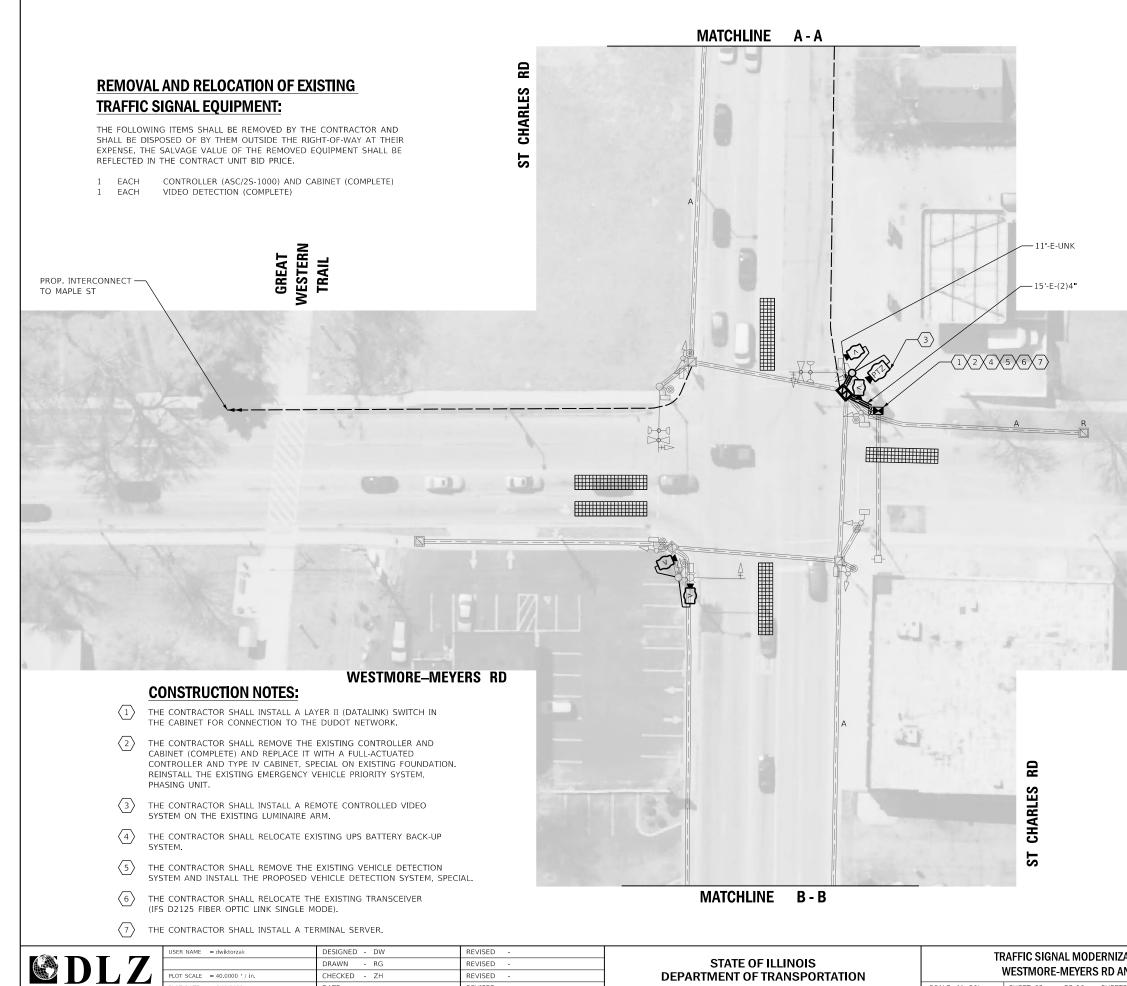

REVISED

FILE NAME	= X \Projects\2021\2182\217400	DuPage DOT	Central\CADD	Sheets\sht-4D-Meyers-ts-plan.c
int 109				

LOT DATE = 6/12/2022

DATE

SCALE: 1"=20' SHEET 65 OF 96 SHEET



WESTMORE-MEYERS RD

	the second second		
		0	
1	Y -		
	Y		

THIS INTERSECTION SHALL REMAIN ON THE IDOT CLOSED LOOP SYSTEM "ECON 36".

THE TRAFFIC SIGNAL CONTROL EQUIPMENT FOR THIS PROJECT SHALL BE "ECONOLITE" TO MATCH THE EXISTING ADJACENT SYSTEM.


THE VIDEO DETECTION SYSTEM, SPECIAL FOR THIS INTERSECTION SHALL BE AUTOSCOPE VISION TO MEET VILLAGE OF LOMBARD REQUIREMENTS.

PROP VIDEO DETECTION ZONES SHALL MATCH EXISTING VIDEO DETECTION ZONES, UNLESS DIRECTED OTHERWISE BY THE ENGINEER.


THE CONTROLLER SHALL CONTINUE OPERATING WITH THE IDOT CLOSED LOOP SYSTEM. THE LAYER II SWITCH, VIDEO DETECTION AND PTZ CAMERA WILL BE CONFIGURED AND CONNECTED TO OPERATE WITHIN THE DUDOT CENTRAL SIGNAL SYSTEM FIELD NETWORK.


LOMBARD **TS 24 ECON 36**

ZAT		AN - AREA 4	F.A. RTE	SECTION		COUNTY	TOTAL SHEETS	SHEET NO.
١N	п ст сн	ARLES RD	VAR.	19-DCCSS-04-TL		DUPAGE	293	130
	0 31 01	AREES RD	_			CONTRACT	NO. 6	1H96
TS	STA.	TO STA.		ILLINOIS	FED. A	ID PROJECT		

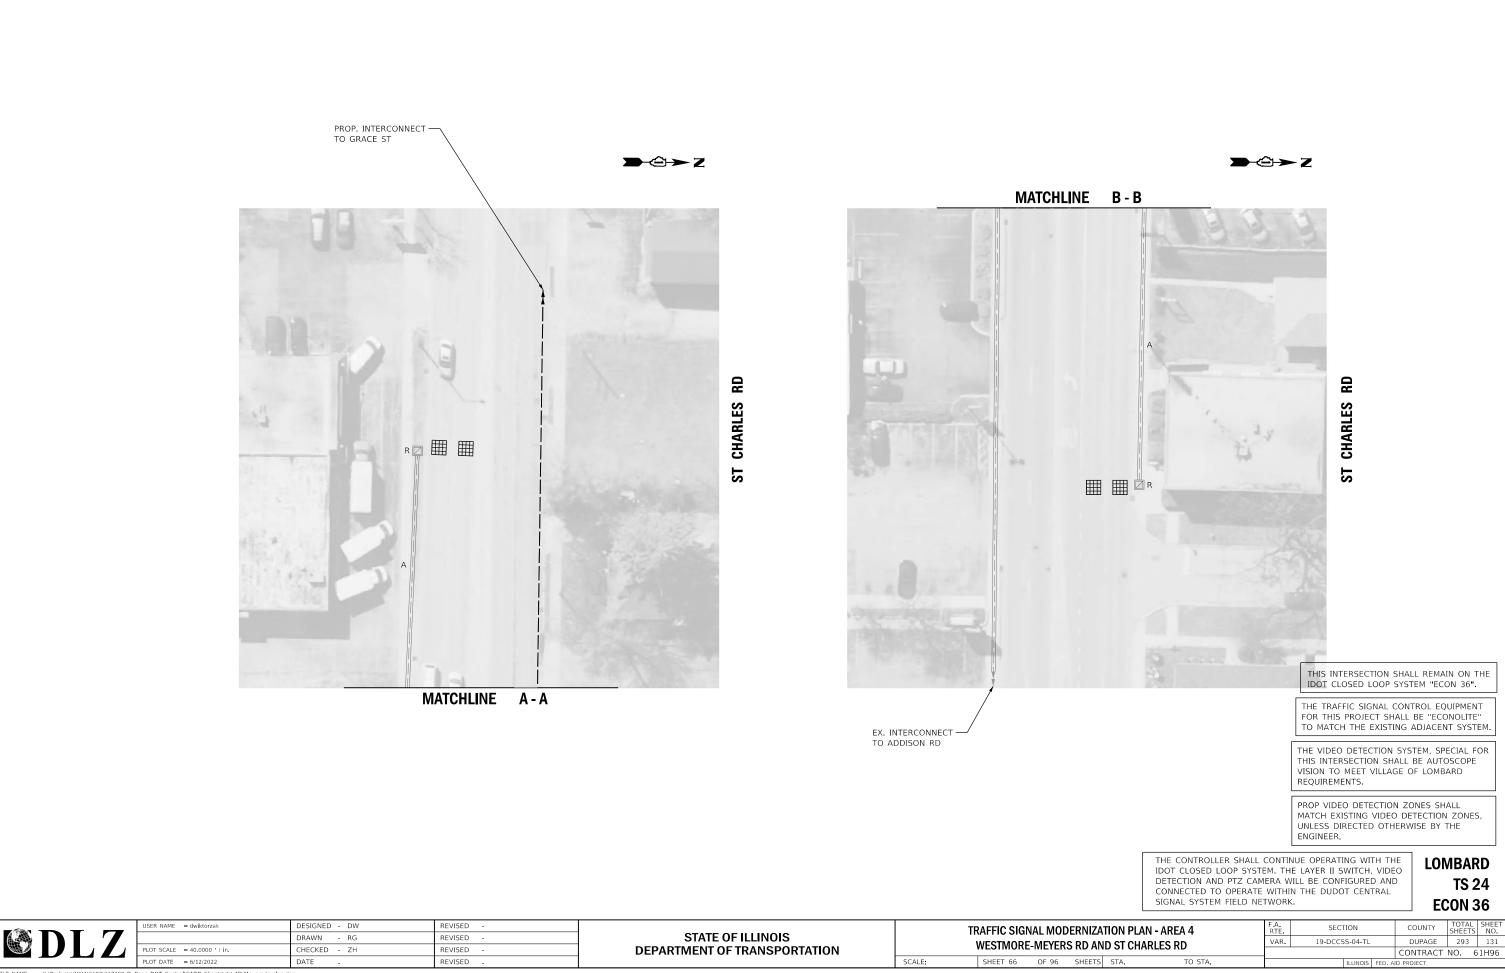


FILE NAME = X:Projects/2021/2182/217400 DuPage DOT Central/CADD_Sheets/sht-4D-Mey int 109

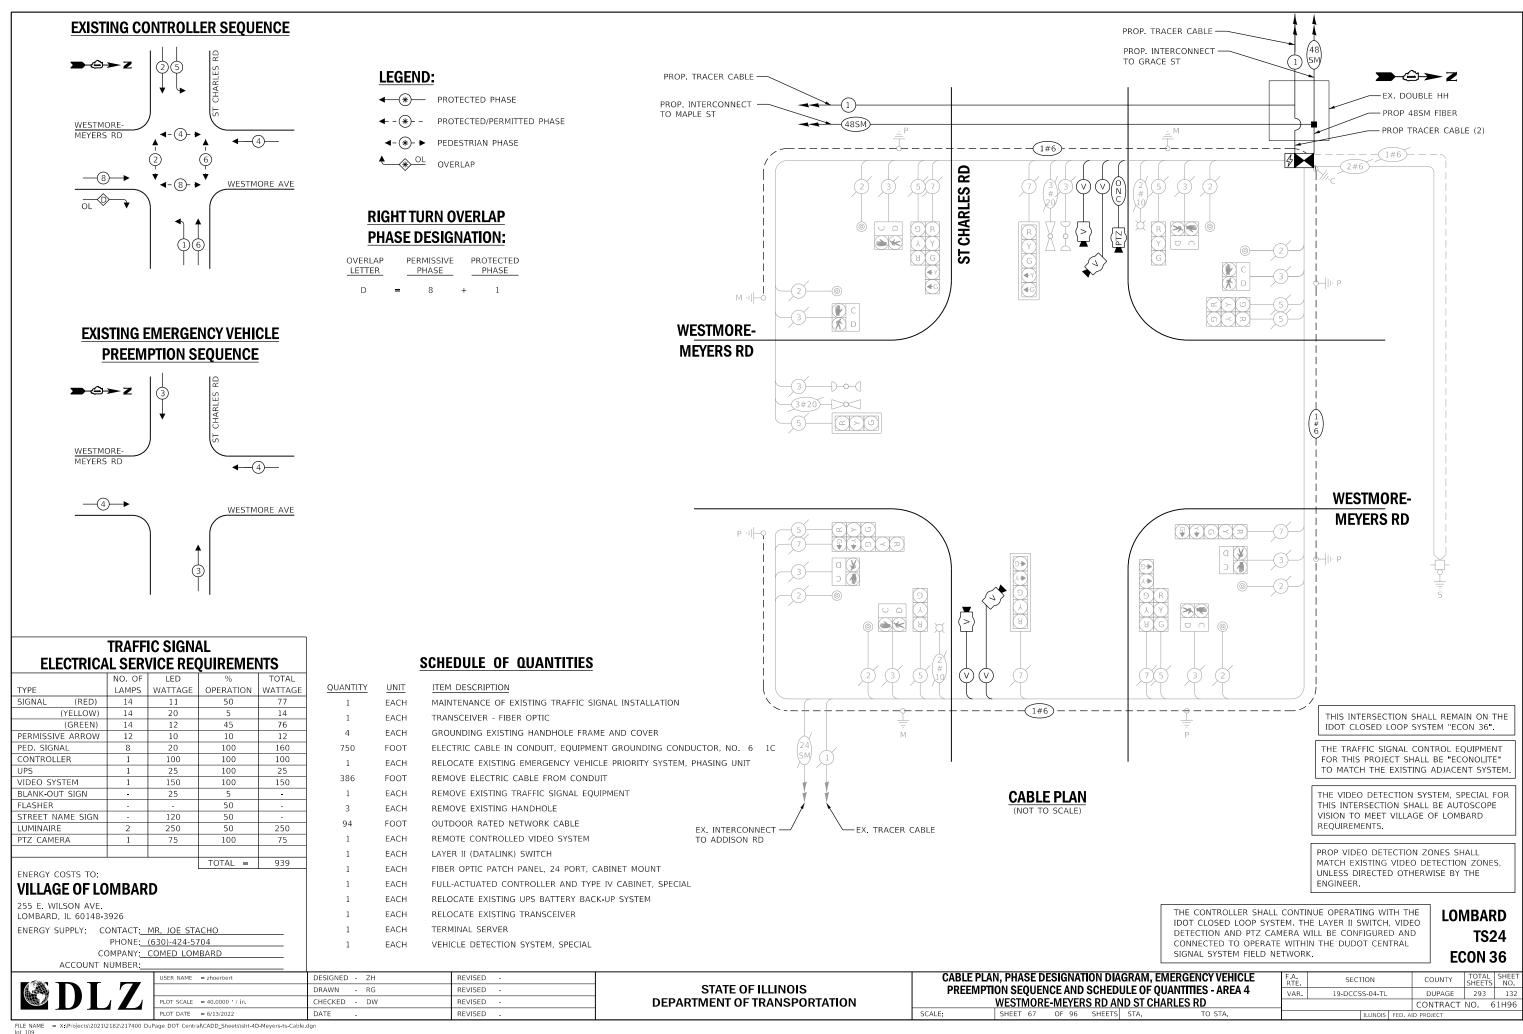


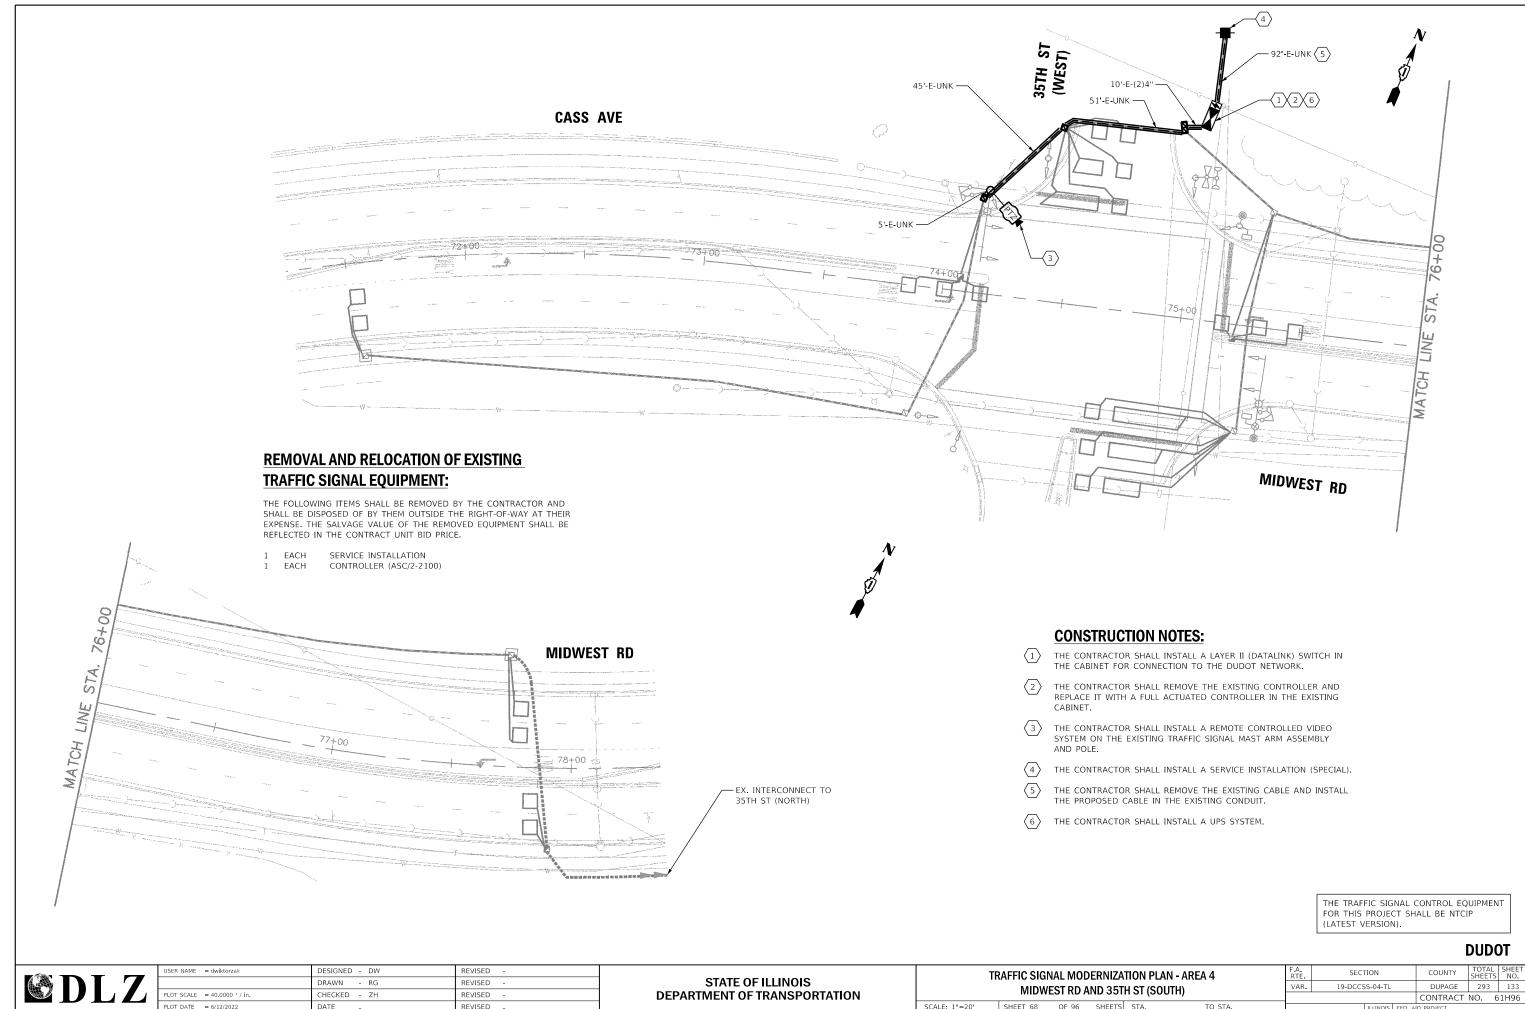


ZATION PLAN - AREA 4	F.A. RTE	SECT	ION		COUNTY	TOTAL SHEETS	SHEET NO.
5TH ST (SOUTH)	VAR.	19-DCCS	S-04-TL		DUPAGE	293	133
					CONTRACT	NO. 6	1H96
TS STA. TO STA.			ILLINOIS	FED. A	ID PROJECT		

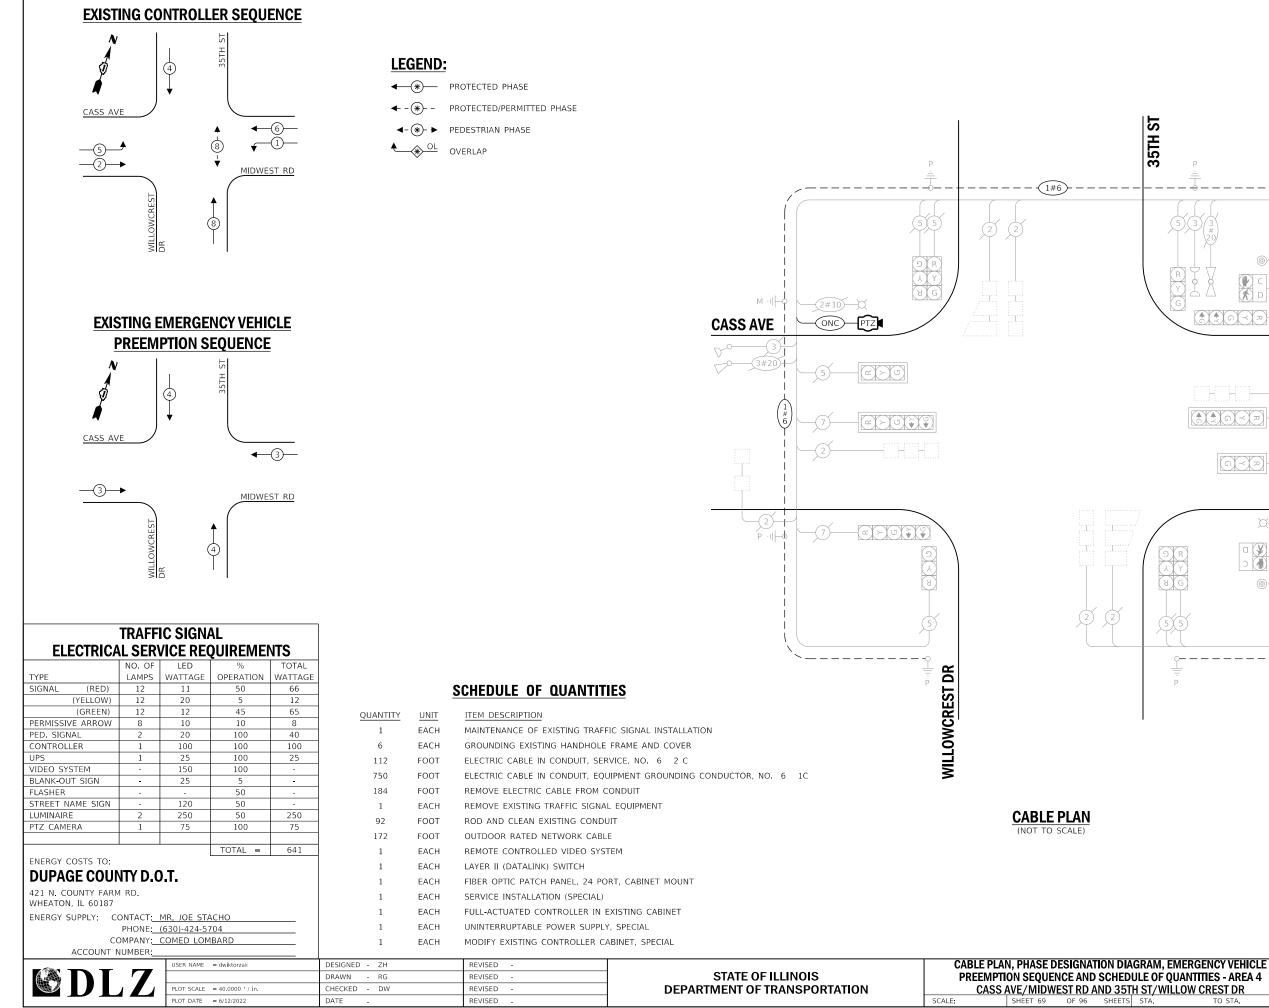

FILE NAME = X1Projects\2021\2182\217400 DuPage DOT Central\CADD_Sheets\sht-4E-Cass-ts-Cable.dg Int 52

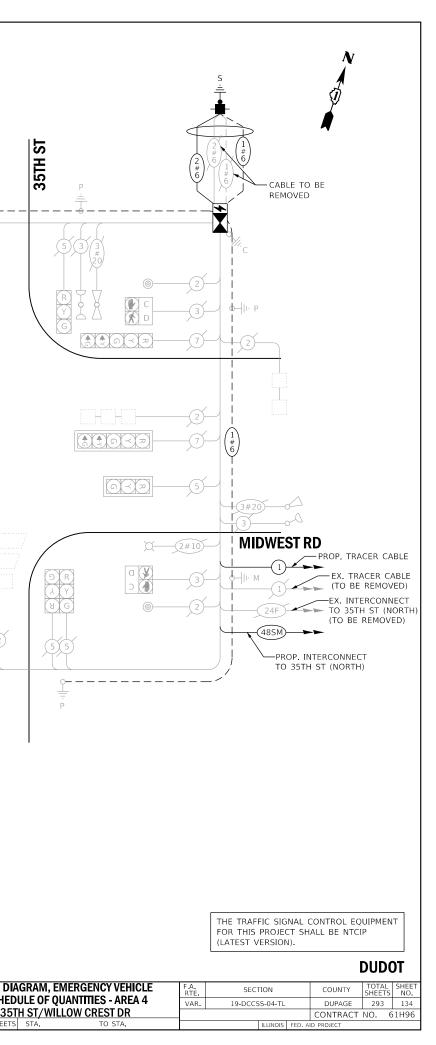

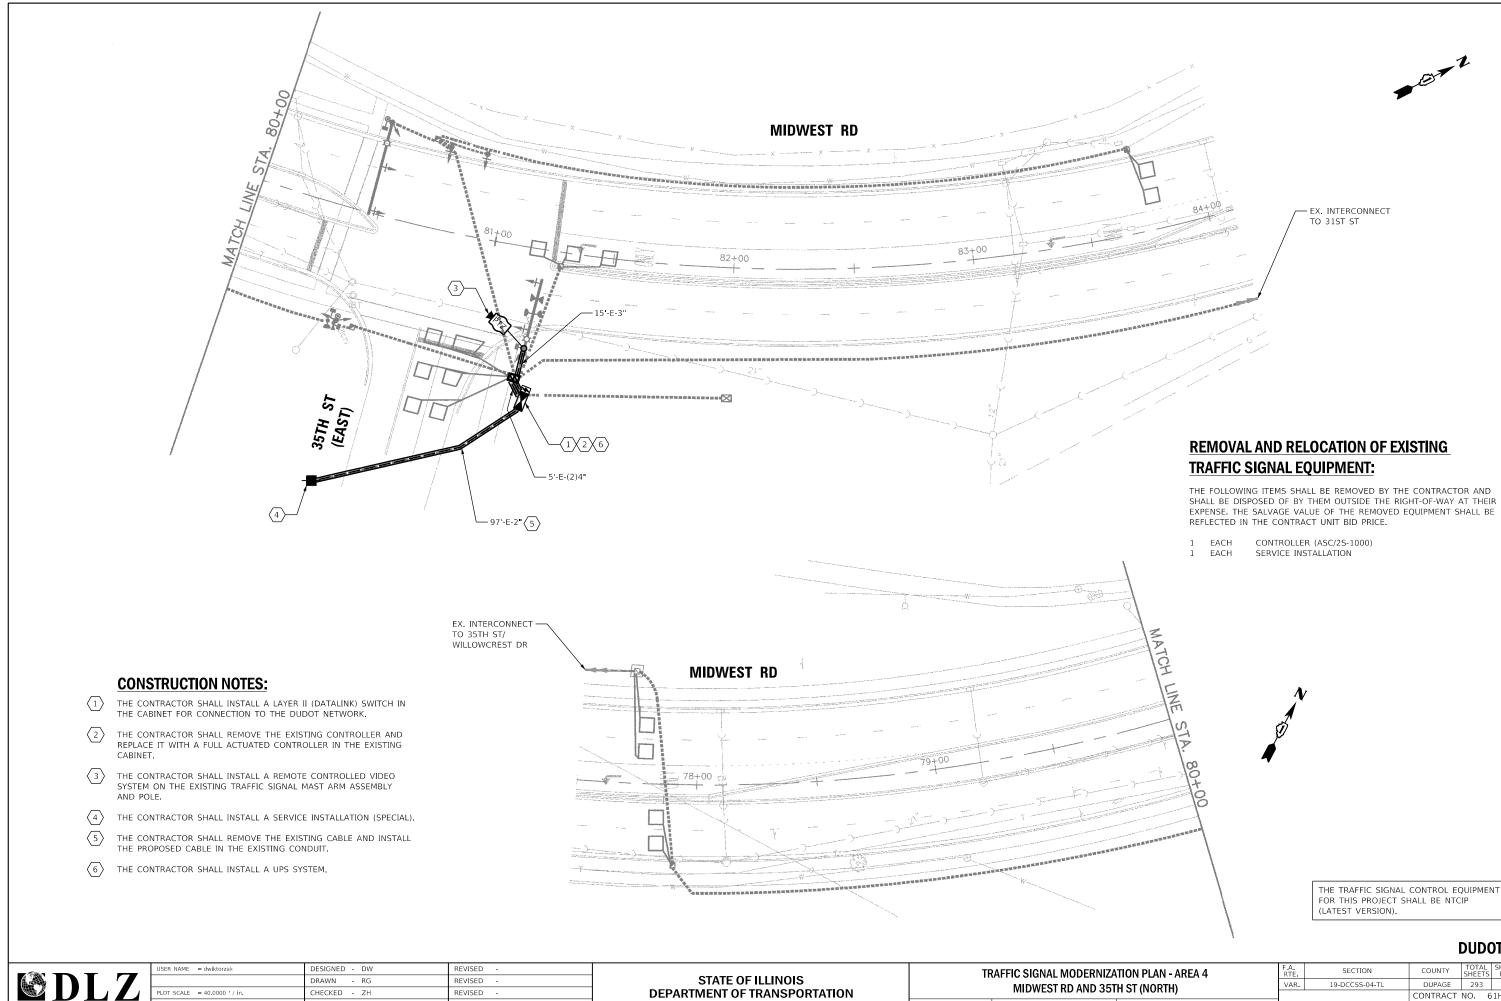

FILE NAME Int 51 \Projects\2021\2182\217400 DuPage DOT Central\CADD_Sheets\sht-4E-Cas

PLOT DATE = 6/12/2022

DATE

REVISED

SCALE: 1"=20' SHEET 70 OF 96 SHEET!

EXPENSE. THE SALVAGE VALUE OF THE REMOVED EQUIPMENT SHALL BE


1	EACH	CONTROLLER (ASC/2S-1000)
1	EACH	SERVICE INSTALLATION

THE TRAFFIC SIGNAL CONTROL EQUIPMENT FOR THIS PROJECT SHALL BE NTCIP (LATEST VERSION).

DUDOT

5TH ST (NORTH) VAR. 19-DCCSS-04-TL DUPAGE 2'	3 135
CONTRACT NO.	61H96
TS STA TO STA. ILLINOIS FED. AID PROJECT	

EXISTING CONTROLLER SEQUENCE

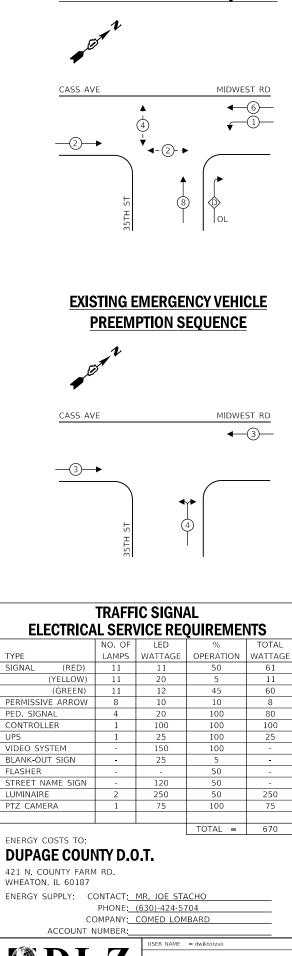

LEGEND:

← (*) PROTECTED PHASE

- ← (*)- PROTECTED/PERMITTED PHASE
- ◄-(*)- ► PEDESTRIAN PHASE
- ♦ OL OVERLAP

RIGHT TURN OVERLAP PHASE DESIGNATION:

OVERLAP	PERMISSIVE	PROTECTED
LETTER	PHASE	PHASE

D 8 + 1 =

ITEM DESCRIPTION

ROD AND CLEAN EXISTING CONDUIT

OUTDOOR RATED NETWORK CABLE

SERVICE INSTALLATION (SPECIAL)

LAYER II (DATALINK) SWITCH

REMOTE CONTROLLED VIDEO SYSTEM

QUANTITY

1

3

117

750

194

1

97

68

1

1

1

1

1

1

1

UNIT

EACH

EACH

FOOT

FOOT

FOOT

EACH

FOOT

FOOT

EACH

FACH


EACH

EACH

EACH

EACH


EACH

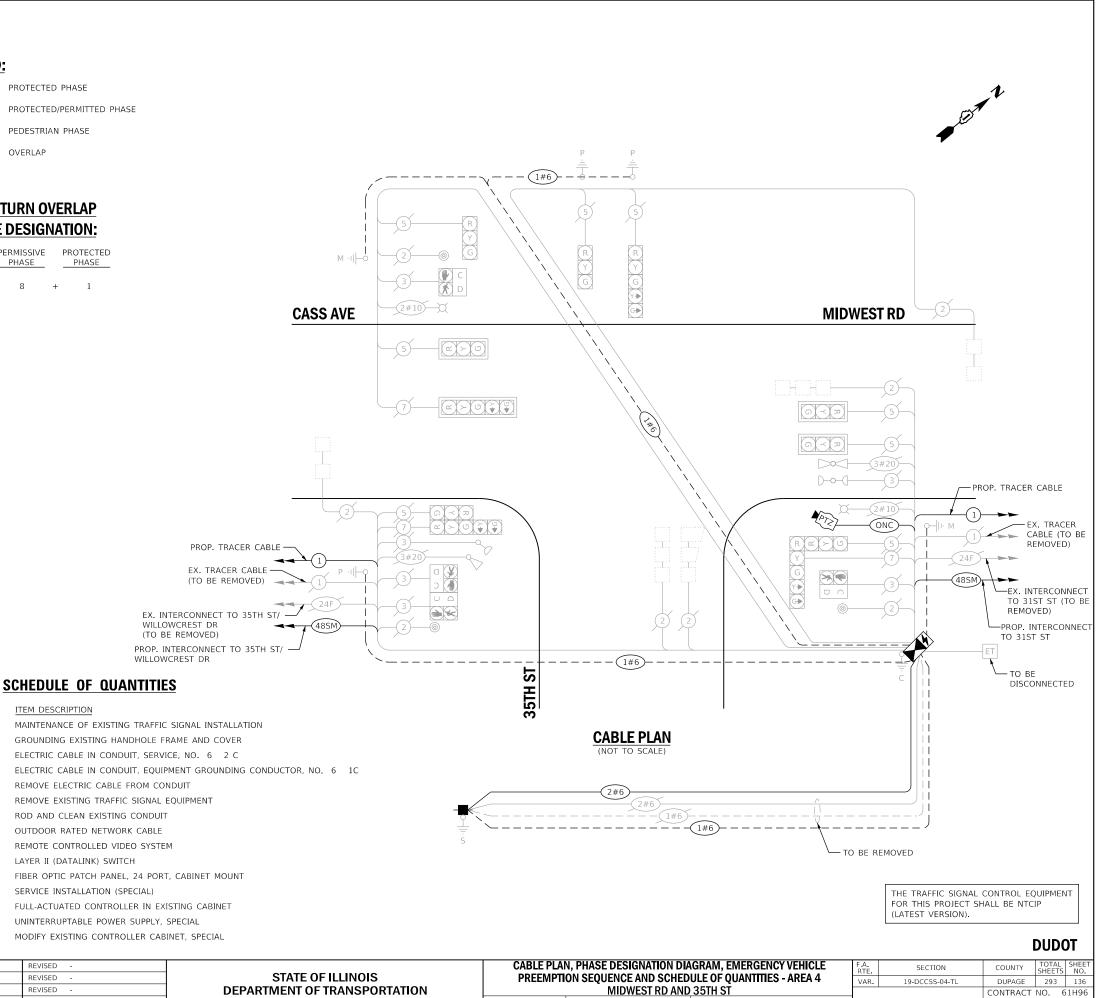


TO STA.


DESIGNED - ZH REVISED DRAWN - RG REVISED OT SCALE = 40.0000 ' / in. HECKED - DW REVISED **DEPARTMENT OF TRANSPORTATION** REVISED SCALE: PLOT DATE = 6/12/2022 DATE SHEET 71 OF 96 SHEETS STA

FILE NAME Int 51 X:\Projects\2021\2182\217400 DuPage DOT Central\CADD_Sheets\sht-4E-Cass-ts-Cable.dg

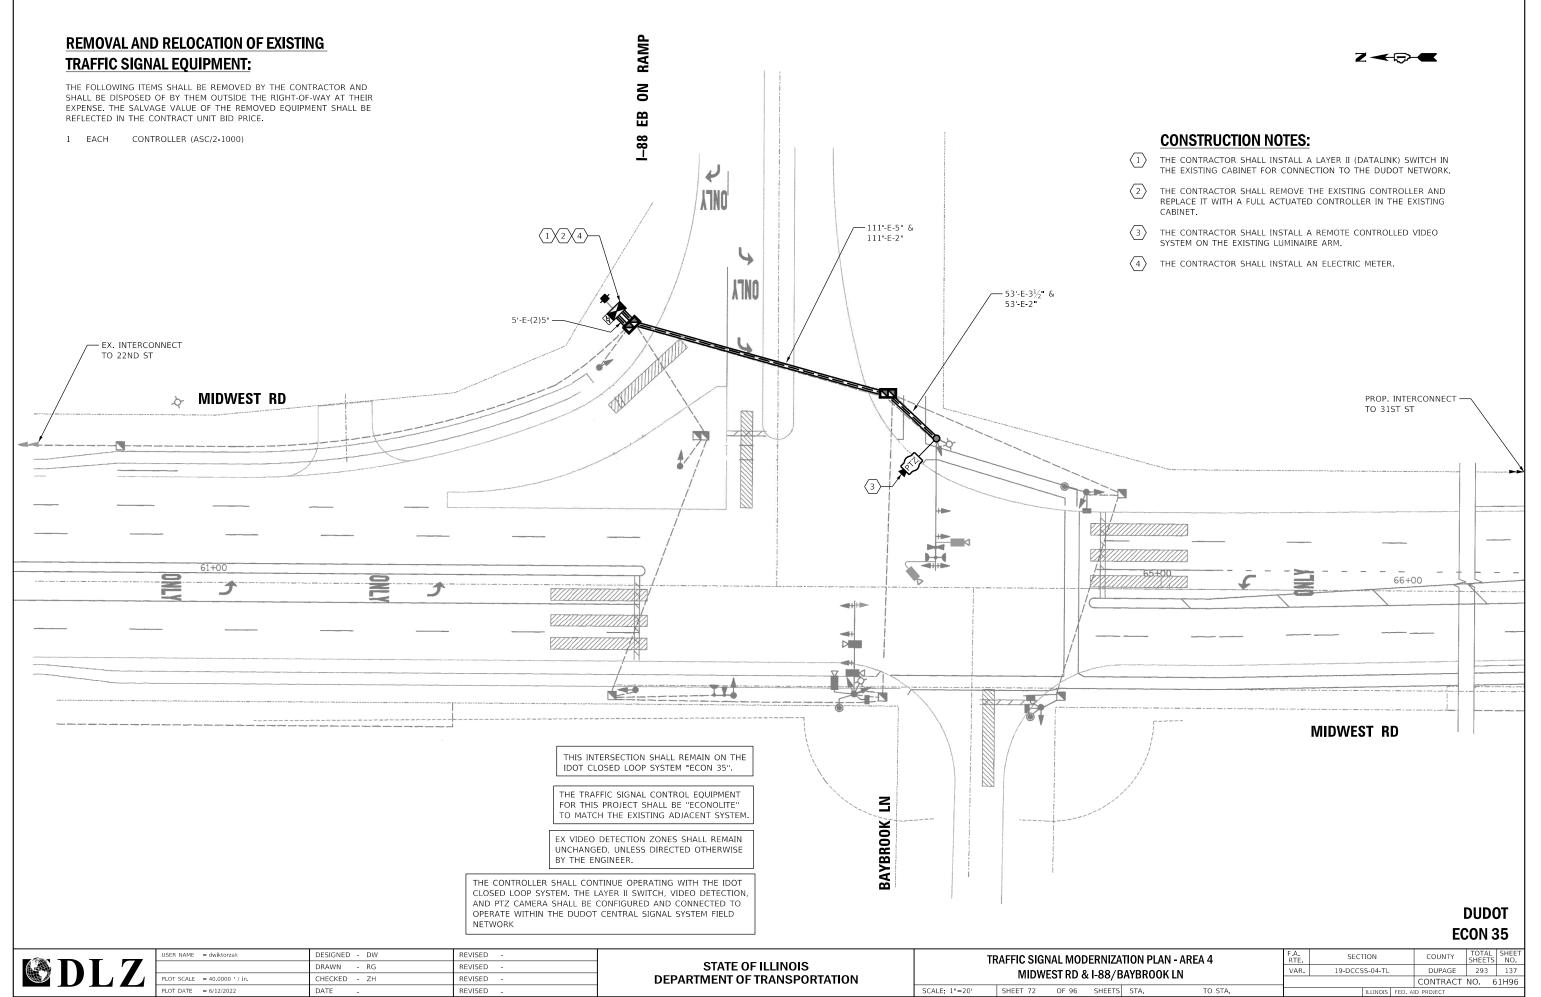

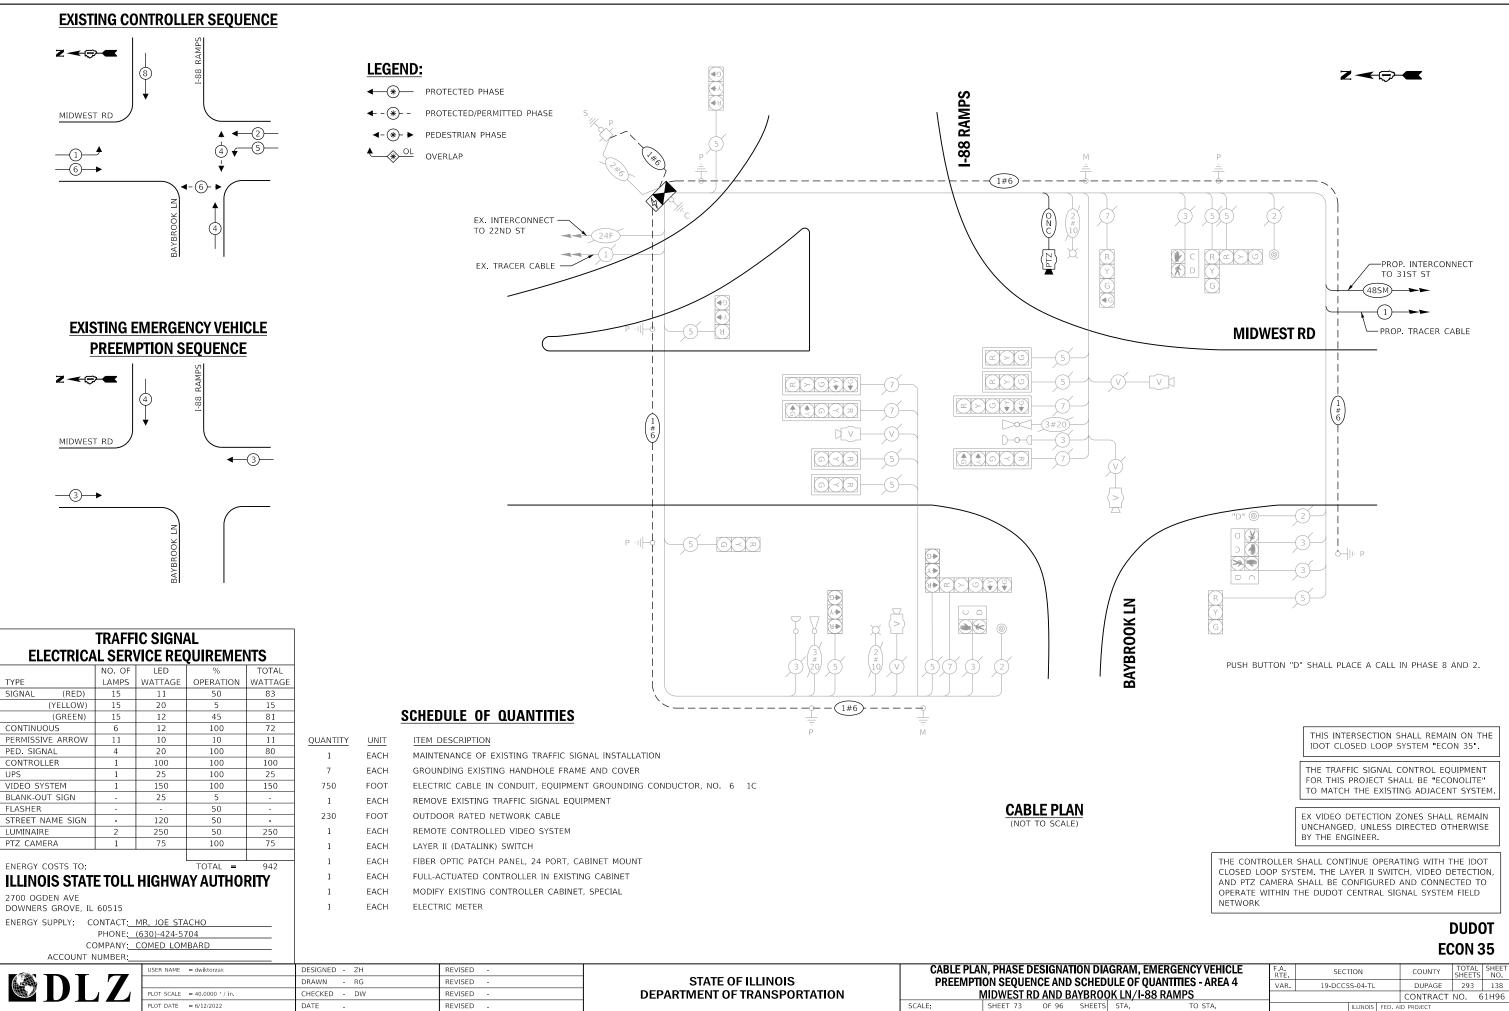


FILE NAME = X1Projects\2021\2182\217400 DuPage DOT Central\CADD Sheets\sht-4E-Cass ts-Cable.dg Int 53

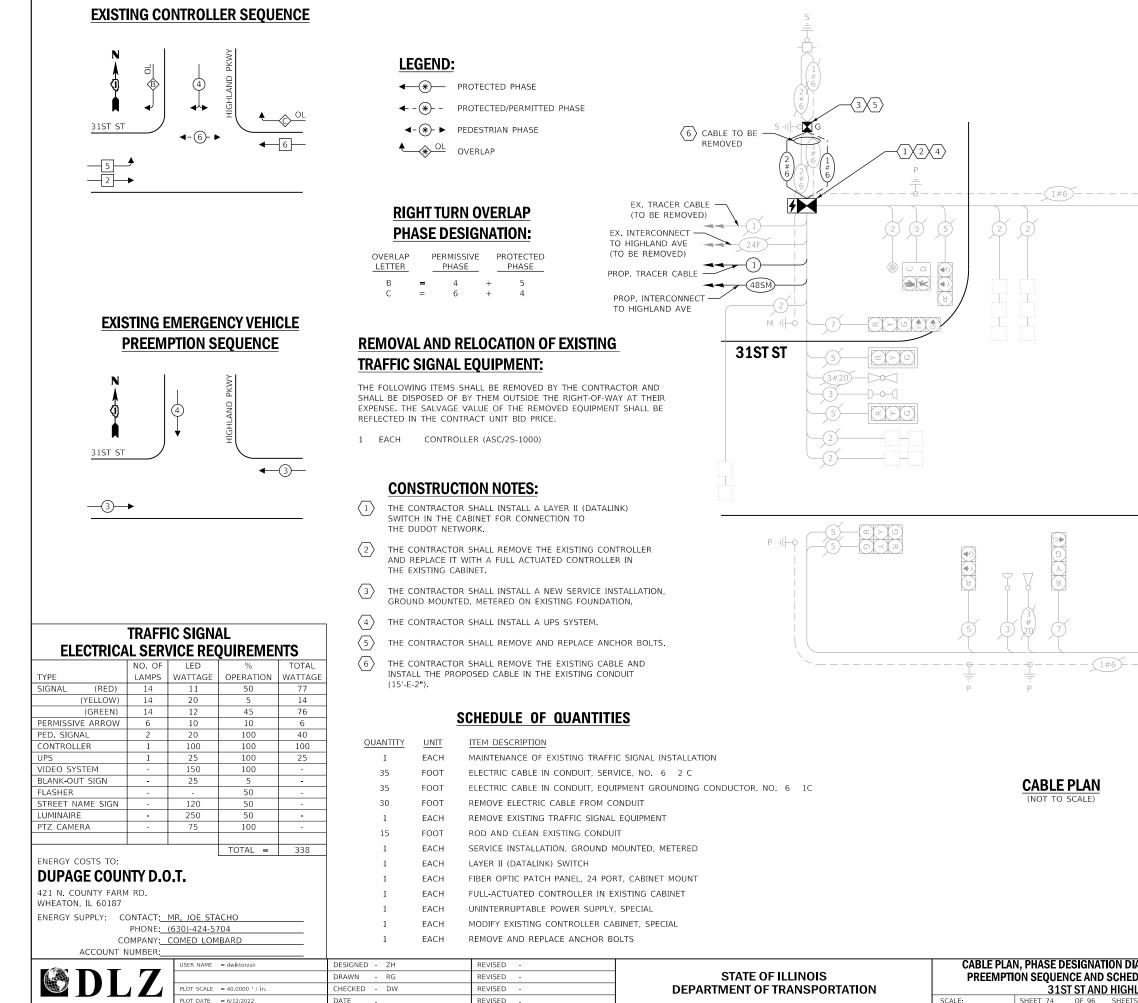


FILE NAME = X\Projects\2021\2182\217400 DuPage DOT Central\CADD_Sheets\sht-4F-31st-ts-Cable.de Int 15

SCALE: SHEET 74 OF 96 SHEET


(1#6)-

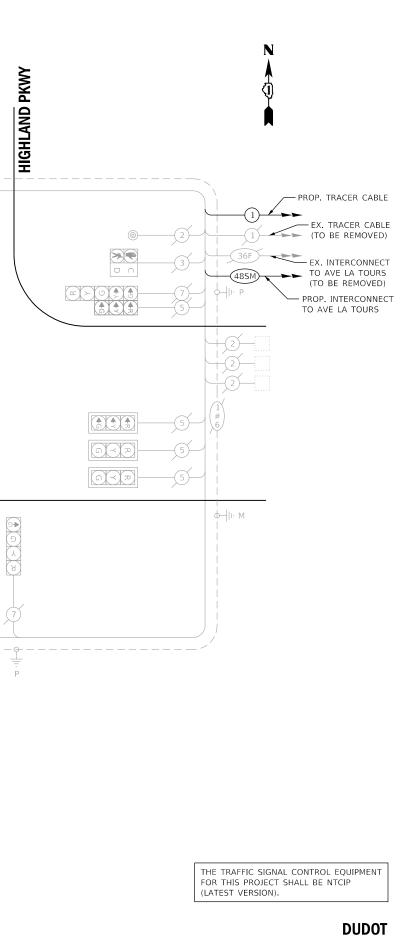

F.A. RTE	SECT	SECTION		COUNTY	TOTAL SHEETS	SHEET NO.
VAR.	19-DCCSS-04-TL		DUPAGE	293	139	
				CONTRACT	NO. 6	51H96
		ILLINOIS	FED. A	ID PROJECT		
	RTE.	RTE. SEC	VAR. 19-DCCSS-04-TL	VAR. 19-DCCSS-04-TL	RTE SECTION COUNTY VAR 19-DCCSS-04-TL DUPAGE CONTRACT CONTRACT	RTE SECTION COUNTY SHEETS VAR. 19-DCCSS-04-TL DUPAGE 293 CONTRACT NO. CONTRACT NO. CONTRACT NO.

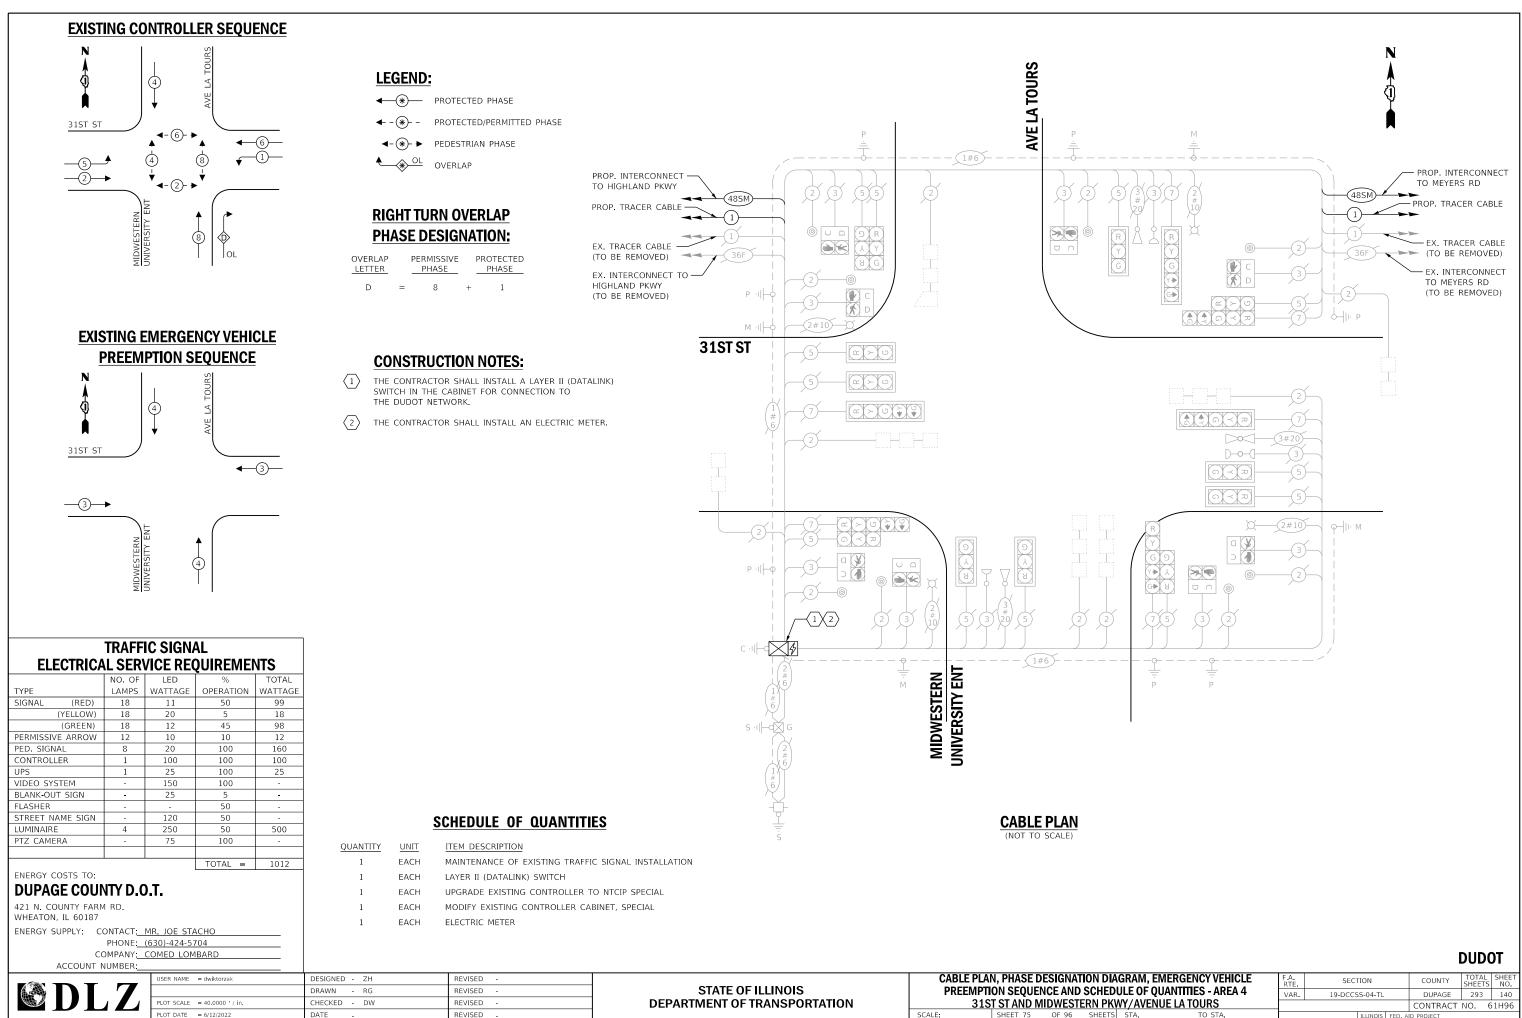

FILE NAME = X\Projects\2021\2182\217400 DuPage DOT Central\CADD_Sheets\sht-4F-31st-ts-Cable.de Int 18

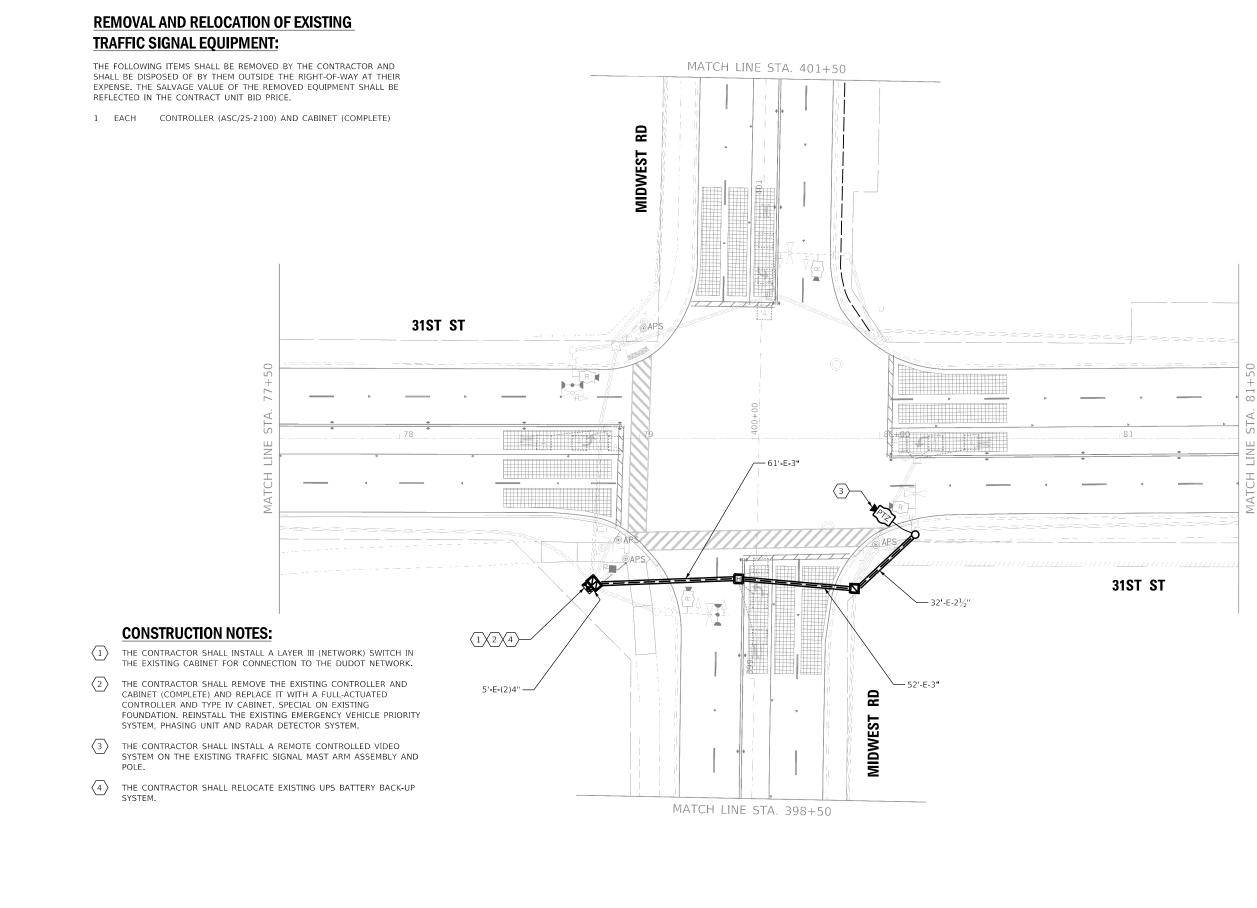


	USER NAME = dwiktorzak	DESIGNED - DW	REVISED -		TRAFFIC SIGNAL MODERNIZATION PLAN - AREA 4 PTZ PLAN - 31ST ST AND MIDWEST RD			F.A. RTE	SECTION	COUNTY TOTAL SHI
		DRAWN - RG	REVISED -	STATE OF ILLINOIS DEPARTMENT OF TRANSPORTATION SCALE: 1"=20				VAR.	19-DCCSS-04-TL	DUPAGE 293 14
	PLOT SCALE = 40.0000 / in	CHECKED - ZH	REVISED -							CONTRACT NO. 61H
	PLOT DATE = 6/12/2022	DATE -	REVISED -		SCALE: 1"=20'	SHEET 76 OF 96 SHEETS STA.	TO STA.		ILLINOIS FED	, AID PROJECT
FILE NAME = X\Projects\2021\2182\217400 Du	age DOT Central\CADD_Sheets\sht-4F-31st-ts-plan.dgn									




EX RADAR DETECTION ZONES SHALL REMAIN UNCHANGED, UNLESS DIRECTED OTHERWISE BY THE ENGINEER.

THE TRAFFIC SIGNAL CONTROL EQUIPMENT FOR THIS PROJECT SHALL BE NTCIP (LATEST VERSION).


DUDOT

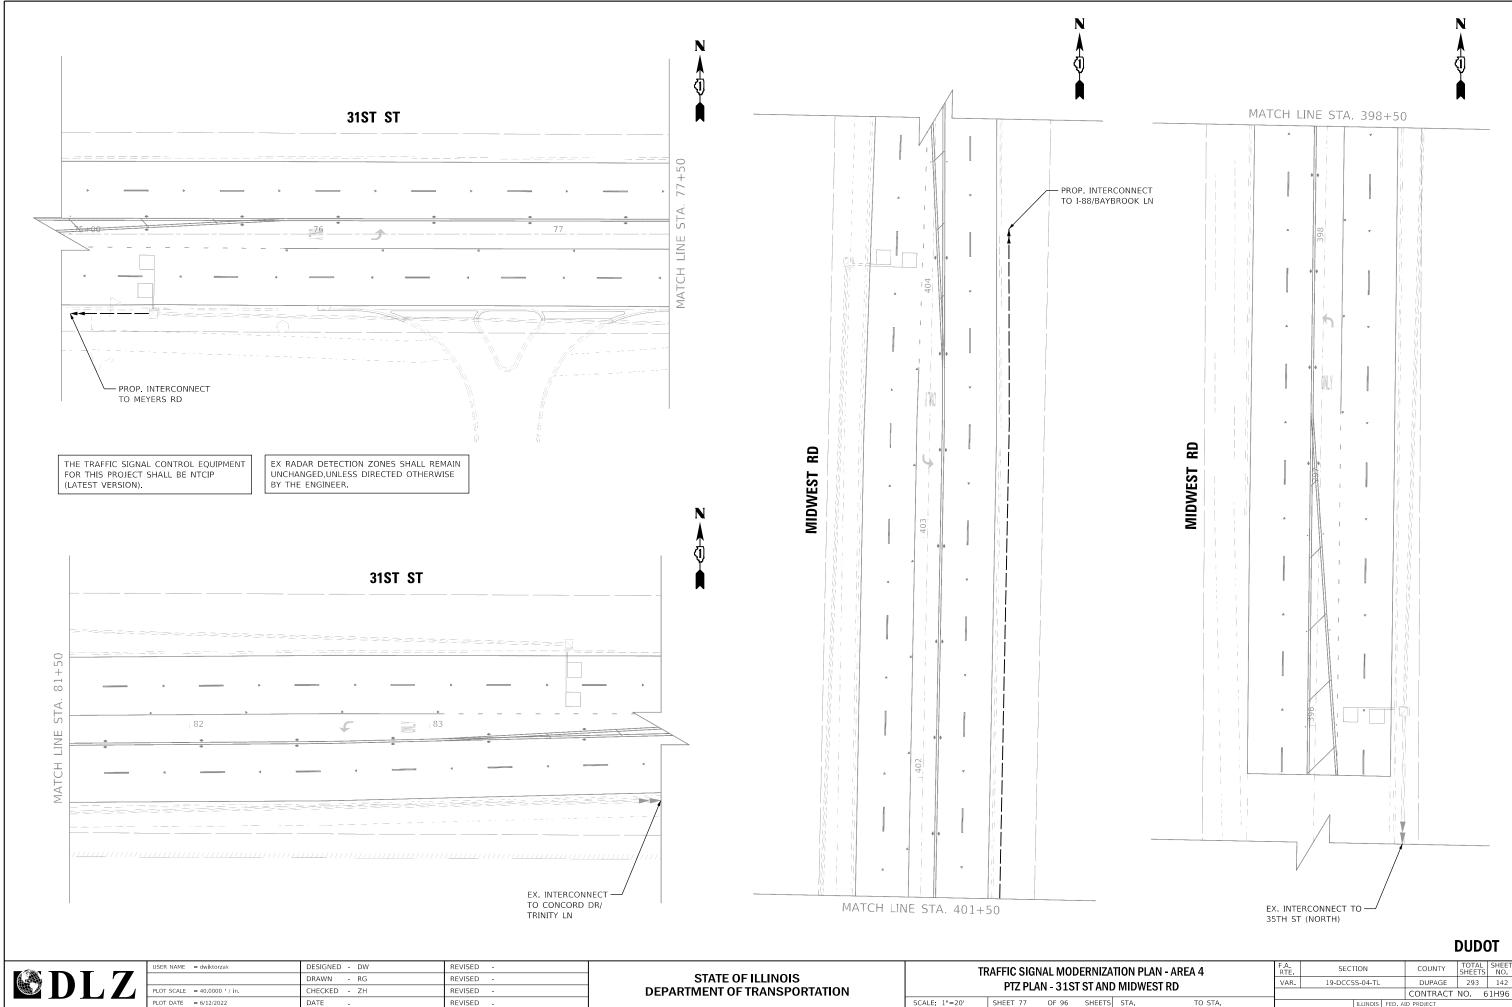

TO STA.

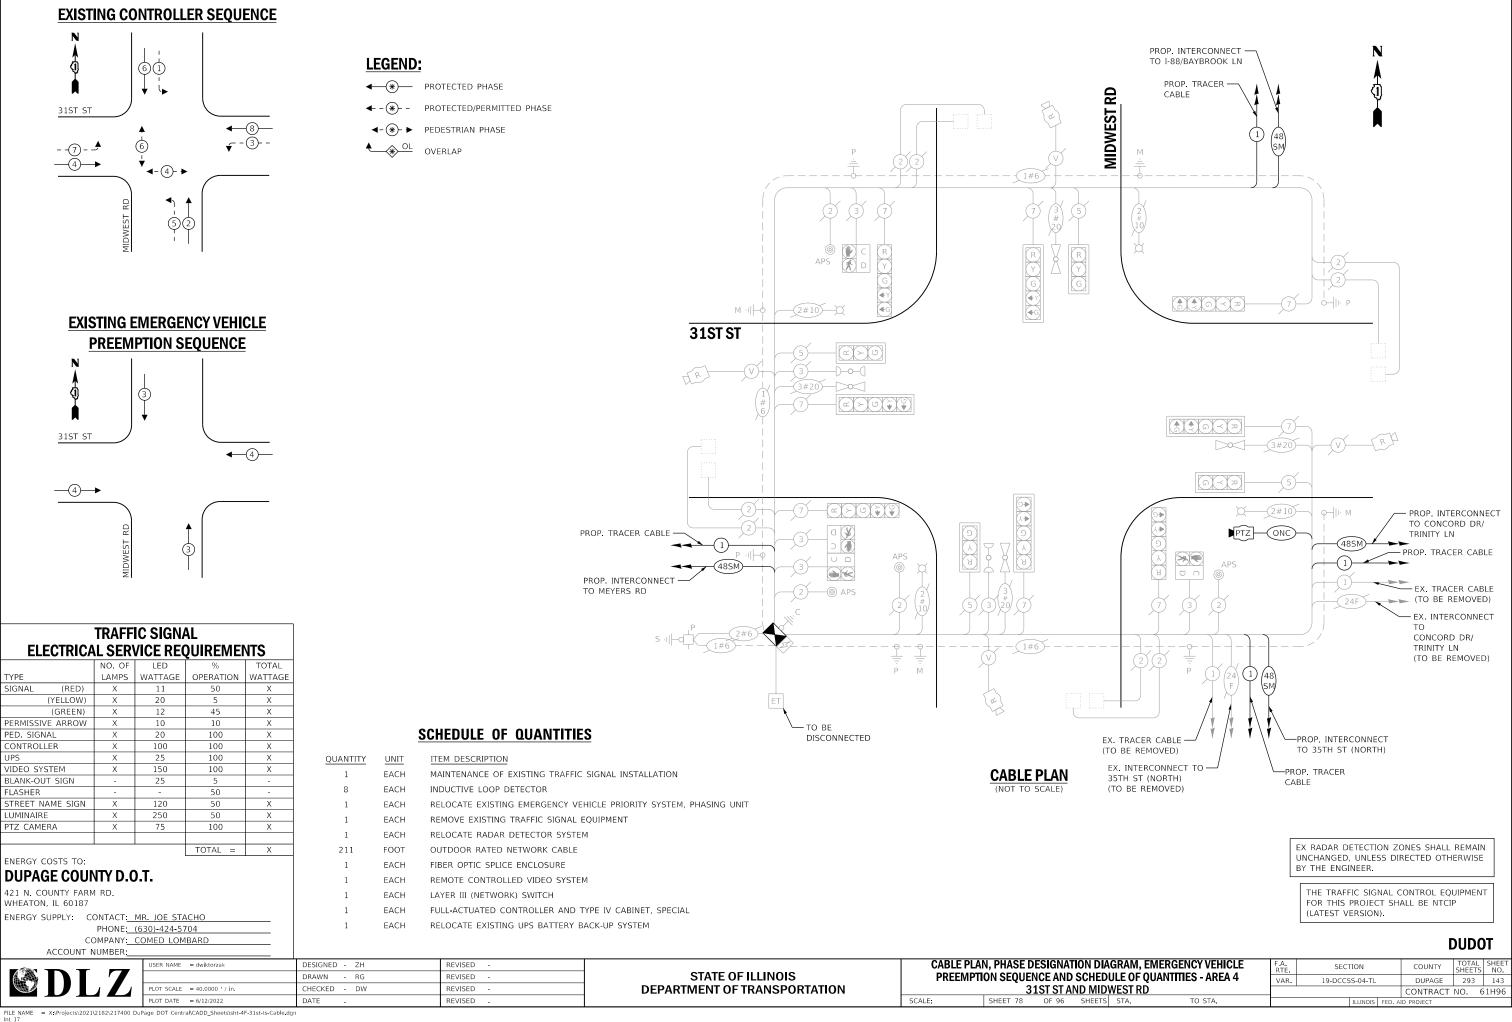



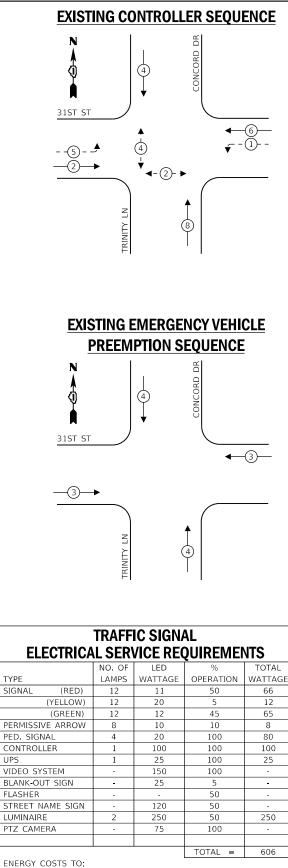

DUPAGE COUNTY D.O.T.

421 N. COUNTY FARM RD. WHEATON, IL 60187

NERGY SUPPLY:	CONTACT:	MR. JOE STACHO	
	PHONE:	(630)-424-5704	
	COMPANY:	COMED LOMBARD	
	IT NILIMPED.		ĺ

LEGEND:

- ← (*) PROTECTED PHASE
- ← (*)- PROTECTED/PERMITTED PHASE
- ◄-(*)- ► PEDESTRIAN PHASE
- OVERLAP

REMOVAL AND RELOCATION OF EXISTING TRAFFIC SIGNAL EQUIPMENT:

THE FOLLOWING ITEMS SHALL BE REMOVED BY THE CONTRACTOR AND SHALL BE DISPOSED OF BY THEM OUTSIDE THE RIGHT-OF-WAY AT THEIR EXPENSE. THE SALVAGE VALUE OF THE REMOVED EQUIPMENT SHALL BE REFLECTED IN THE CONTRACT UNIT BID PRICE.

1 EACH CONTROLLER (ASC/2S-2100) AND CABINET (COMPLETE)


THE FOLLOWING ITEMS SHALL BE REMOVED BY THE CONTRACTOR AND SHALL REMAIN THE PROPERTY OF THE AGENCY LISTED BELOW. THE CONTRACTOR SHALL SAFELY STORE AND ARRANGE FOR DELIVERY OF ALL EQUIPMENT TO BE RETURNED TO THE LISTED AGENCY AS PER THE TRAFFIC SIGNAL SPECIFICATIONS.


AGENCY: DUPAGE COUNTY DIVISION OF TRANSPORTATION

- 1 EACH WIRELESS INTERCONNECT 1 EACH TERMINAL SERVER

CONSTRUCTION NOTES:

- $\langle 1 \rangle$ THE CONTRACTOR SHALL INSTALL A LAYER II (DATALINK) SWITCH IN THE CABINET FOR CONNECTION TO THE DUDOT NETWORK.
- $\langle 2 \rangle$ THE CONTRACTOR SHALL REMOVE THE EXISTING CONTROLLER AND CABINET (COMPLETE) AND REPLACE IT WITH A FULL-ACTUATED CONTROLLER AND TYPE IV CABINET, SPECIAL ON EXISTING FOUNDATION. REINSTALL THE EXISTING EMERGENCY VEHICLE PRIORITY SYSTEM, PHASING UNIT AND VIDEO DETECTION SYSTEM.
- $\langle 3 \rangle$ THE CONTRACTOR SHALL REMOVE THE EXISTING WIRELESS INTERCONNECT.
- $\langle 4 \rangle$ THE CONTRACTOR SHALL INSTALL A UPS SYSTEM.

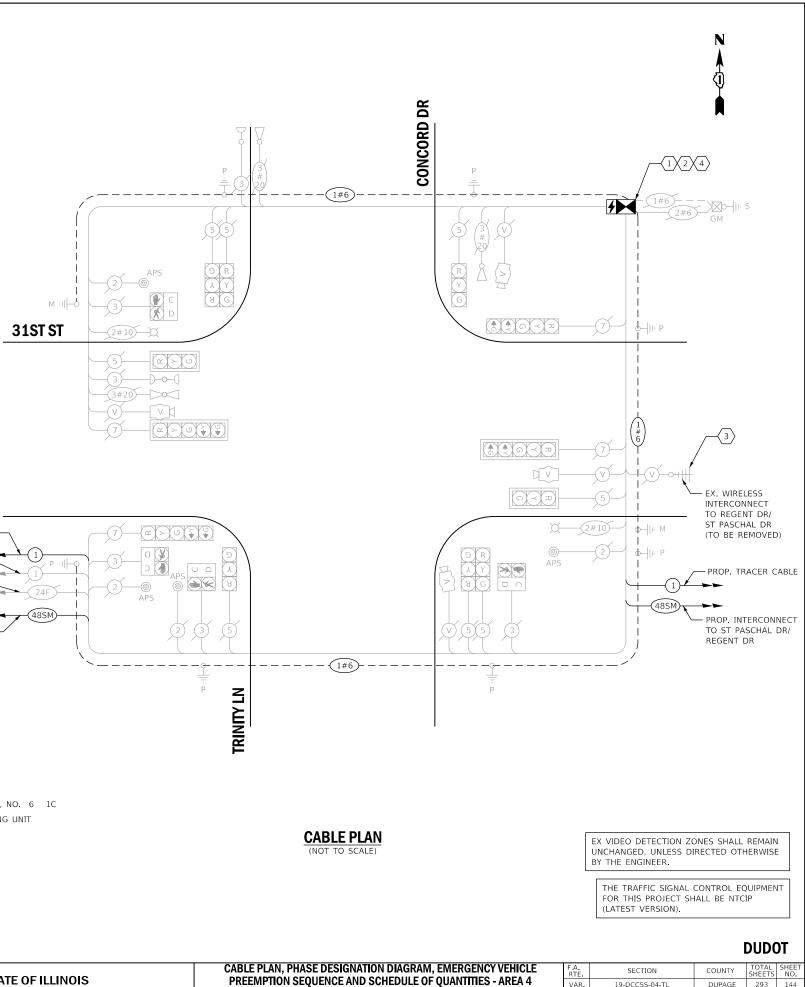

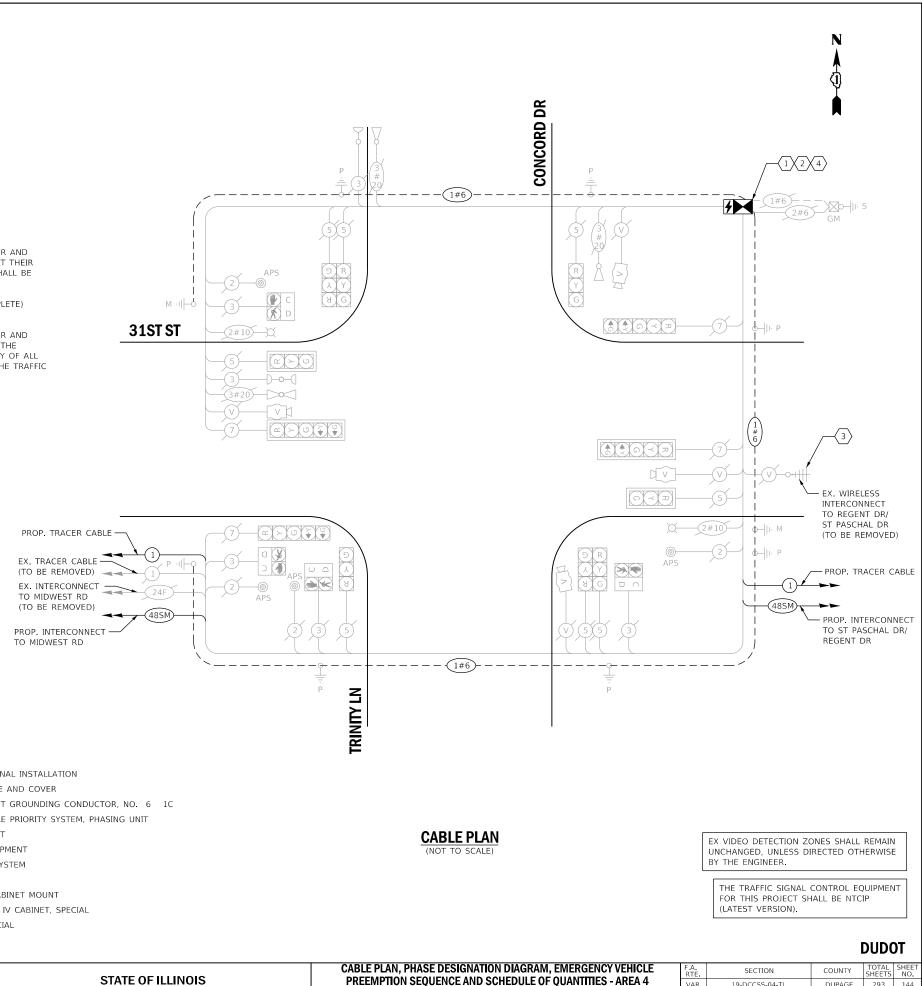

31ST ST AND CONCOR

SHEET 79

OF 96 SHEE

SCALE:

SCHEDULE OF QUANTITIES

REVISED

REVISED

REVISED

DESIGNED - ZH REVISED -		REVISED -	CABLE PLAN, PHASE DESIGNATION D
1	EACH		
1	EACH	FULL-ACTUATED CONTROLLER AND TYPE IV CABINET, SPECIAL UNINTERRUPTABLE POWER SUPPLY, SPECIAL	
1	EACH	FIBER OPTIC PATCH PANEL, 24 PORT, CABINET MOUNT	
1	EACH	LAYER II (DATALINK) SWITCH	
1	EACH	RELOCATE VIDEO VEHICLE DETECTION SYSTEM	
1	EACH	REMOVE EXISTING TRAFFIC SIGNAL EQUIPMENT	(NOT TO SCALE)
102	FOOT	REMOVE ELECTRIC CABLE FROM CONDUIT	CABLE PLAN
1	EACH	RELOCATE EXISTING EMERGENCY VEHICLE PRIORITY SYSTEM, PHASING UNIT	
750	FOOT	ELECTRIC CABLE IN CONDUIT, EQUIPMENT GROUNDING CONDUCTOR, NO. 6 1C	
5	EACH	GROUNDING EXISTING HANDHOLE FRAME AND COVER	
1	EACH	MAINTENANCE OF EXISTING TRAFFIC SIGNAL INSTALLATION	
QUANTITY	UNIT	ITEM DESCRIPTION	F

FILE NAME Int 14 = X\Projects\2021\2182\217400 DuPage DOT Central\CADD_Sheets\sht-4F-31st-ts-Cable de

JSER NAME = dwiktorzak

PLOT DATE = 6/12/2022

OT SCALE = 40.0000 ' / in.


DRAWN - RG

CHECKED - DW

DATE

DEPARTMENT OF TRANSPORTATION

	- ,		RTE.	SECT	TION		COUNTY	SHEETS	NO.
	DULE OF QUANTITIES - AREA 4			19-DCCS	S-04-TL		DUPAGE	293	144
D DR/TRINITY LN							CONTRACT	NO. 6	51H96
ΤS	STA.	TO STA.			ILLINOIS	FED. A	D PROJECT		
								-	

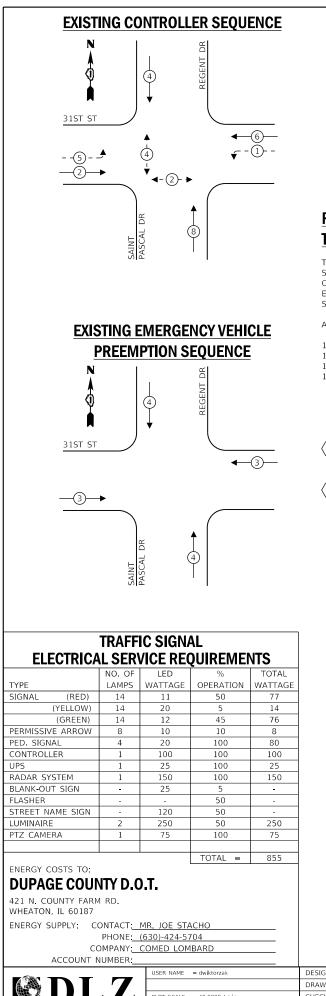

LEGEND:

- ← (*) PROTECTED PHASE
- ← (*)- PROTECTED/PERMITTED PHASE
- ◄-(*)- ► PEDESTRIAN PHASE
- OVERLAP

REMOVAL AND RELOCATION OF EXISTING TRAFFIC SIGNAL EQUIPMENT:


THE FOLLOWING ITEMS SHALL BE REMOVED BY THE CONTRACTOR AND SHALL REMAIN THE PROPERTY OF THE AGENCY LISTED BELOW. THE CONTRACTOR SHALL SAFELY STORE AND ARRANGE FOR DELIVERY OF ALL EQUIPMENT TO BE RETURNED TO THE LISTED AGENCY AS PER THE TRAFFIC SIGNAL SPECIFICATIONS.

AGENCY: DUPAGE COUNTY DIVISION OF TRANSPORTATION

- 1 EACH CONTROLLER (ASC/2-1000) (MEADE SPARE)
- 1 EACH CELL MODEM
- EACH WIRELESS INTERCONNECT
- 1 EACH TERMINAL SERVER

CONSTRUCTION NOTES:


- $\langle 1 \rangle$ THE CONTRACTOR SHALL REMOVE THE EXISTING CONTROLLER AND REPLACE IT WITH A FULL ACTUATED CONTROLLER IN THE EXISTING CABINET.
- $\langle 2 \rangle$ THE CONTRACTOR SHALL REMOVE THE EXISTING WIRELESS INTERCONNECT.

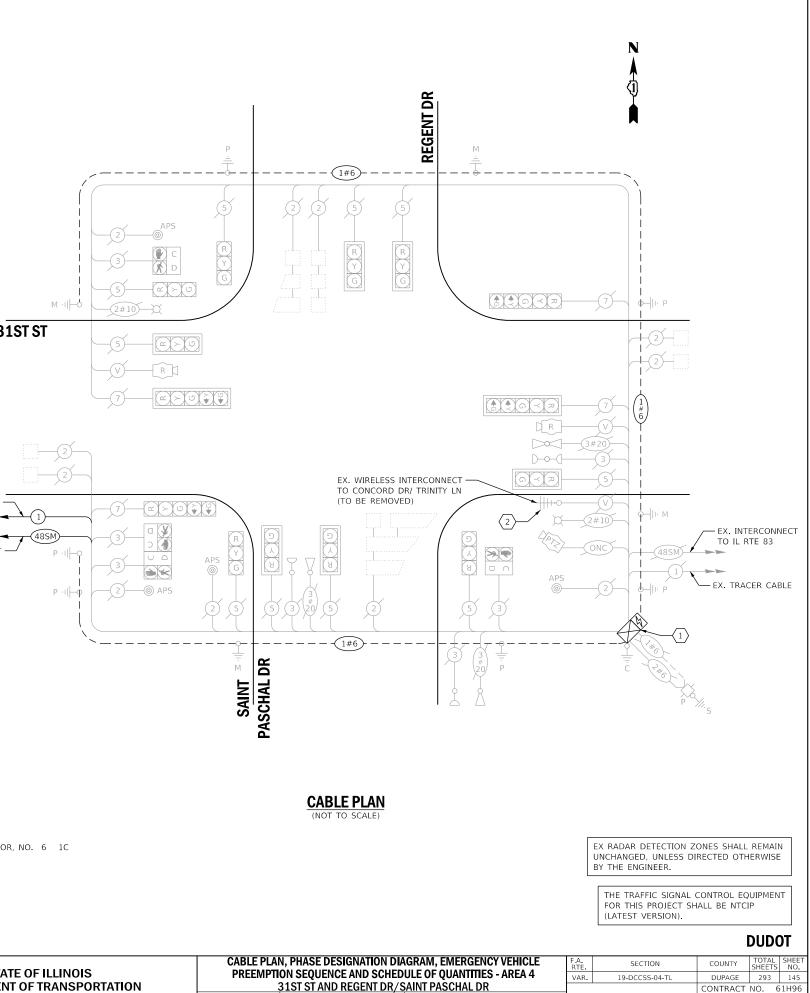

STA.

TO STA

ILLINOIS FED AID PRO

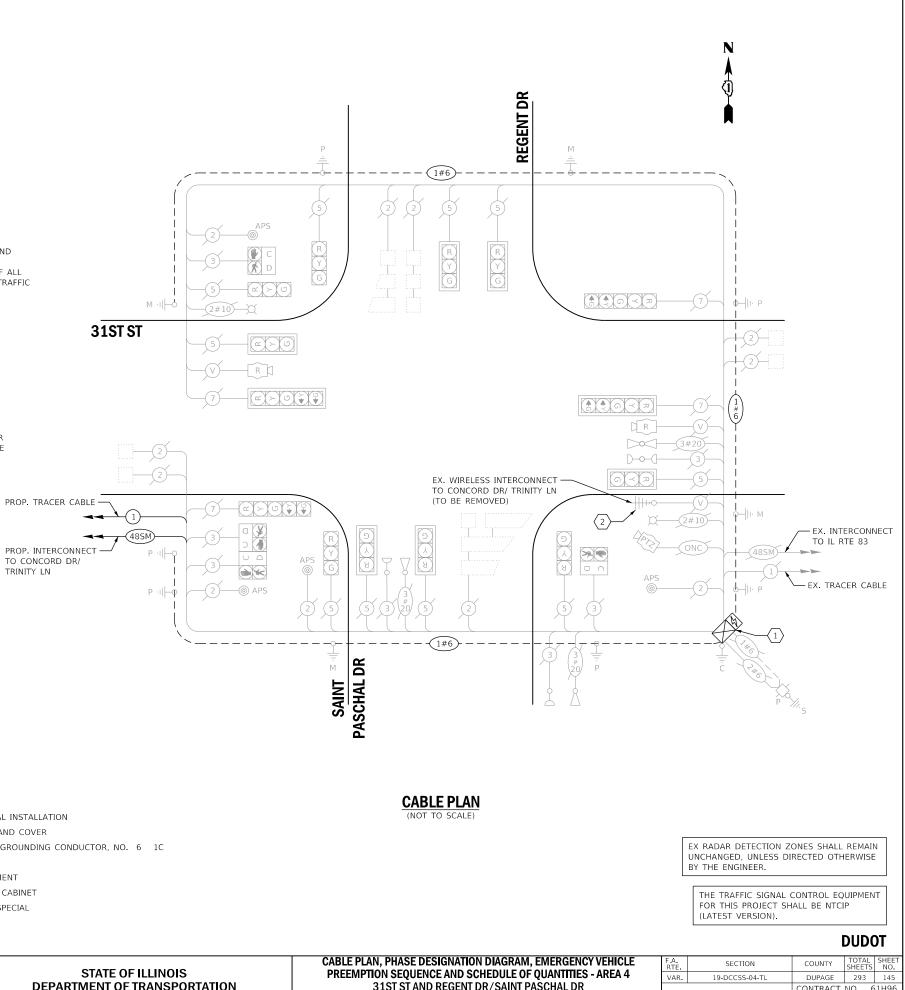


SCHEDULE OF QUANTITIES

QUANTITY	UNIT	ITEM DESCRIPTION	CAB
1	EACH	MAINTENANCE OF EXISTING TRAFFIC SIGNAL INSTALLATION	(NOT
5	EACH	GROUNDING EXISTING HANDHOLE FRAME AND COVER	
750	FOOT	ELECTRIC CABLE IN CONDUIT, EQUIPMENT GROUNDING CONDUCTOR, NO. 6 1C	
31	FOOT	REMOVE ELECTRIC CABLE FROM CONDUIT	
1	EACH	REMOVE EXISTING TRAFFIC SIGNAL EQUIPMENT	
1	EACH	FULL-ACTUATED CONTROLLER IN EXISTING CABINET	
1	EACH	MODIFY EXISTING CONTROLLER CABINET, SPECIAL	


	Account NonDen								
		USER NAME = dwiktorzak	DESIGNED - ZH	REVISED -		CABLE PLAN, PHASE DESIGNATION			
			DRAWN - RG	REVISED -	STATE OF ILLINOIS	PREEMPT	10N SEQUENCE	E AND SCHE	EDUL
		PLOT SCALE = 40.0000 ' / in.	CHECKED - DW	REVISED -	DEPARTMENT OF TRANSPORTATION		31ST ST AND F	REGENT DR	/SAI
		PLOT DATE = 6/12/2022	DATE -	REVISED -		SCALE:	SHEET 80 C	OF 96 SHEE	:TS S
	FILE NAME XIDroinstei 2021/2122/217400 Du	Dage DOT Control/CADD Sheets)sht 45 31st to Cable do							

rojects\2021\2182\217400 DuPage DOT Central\CADD_She FILE NAME Int 19

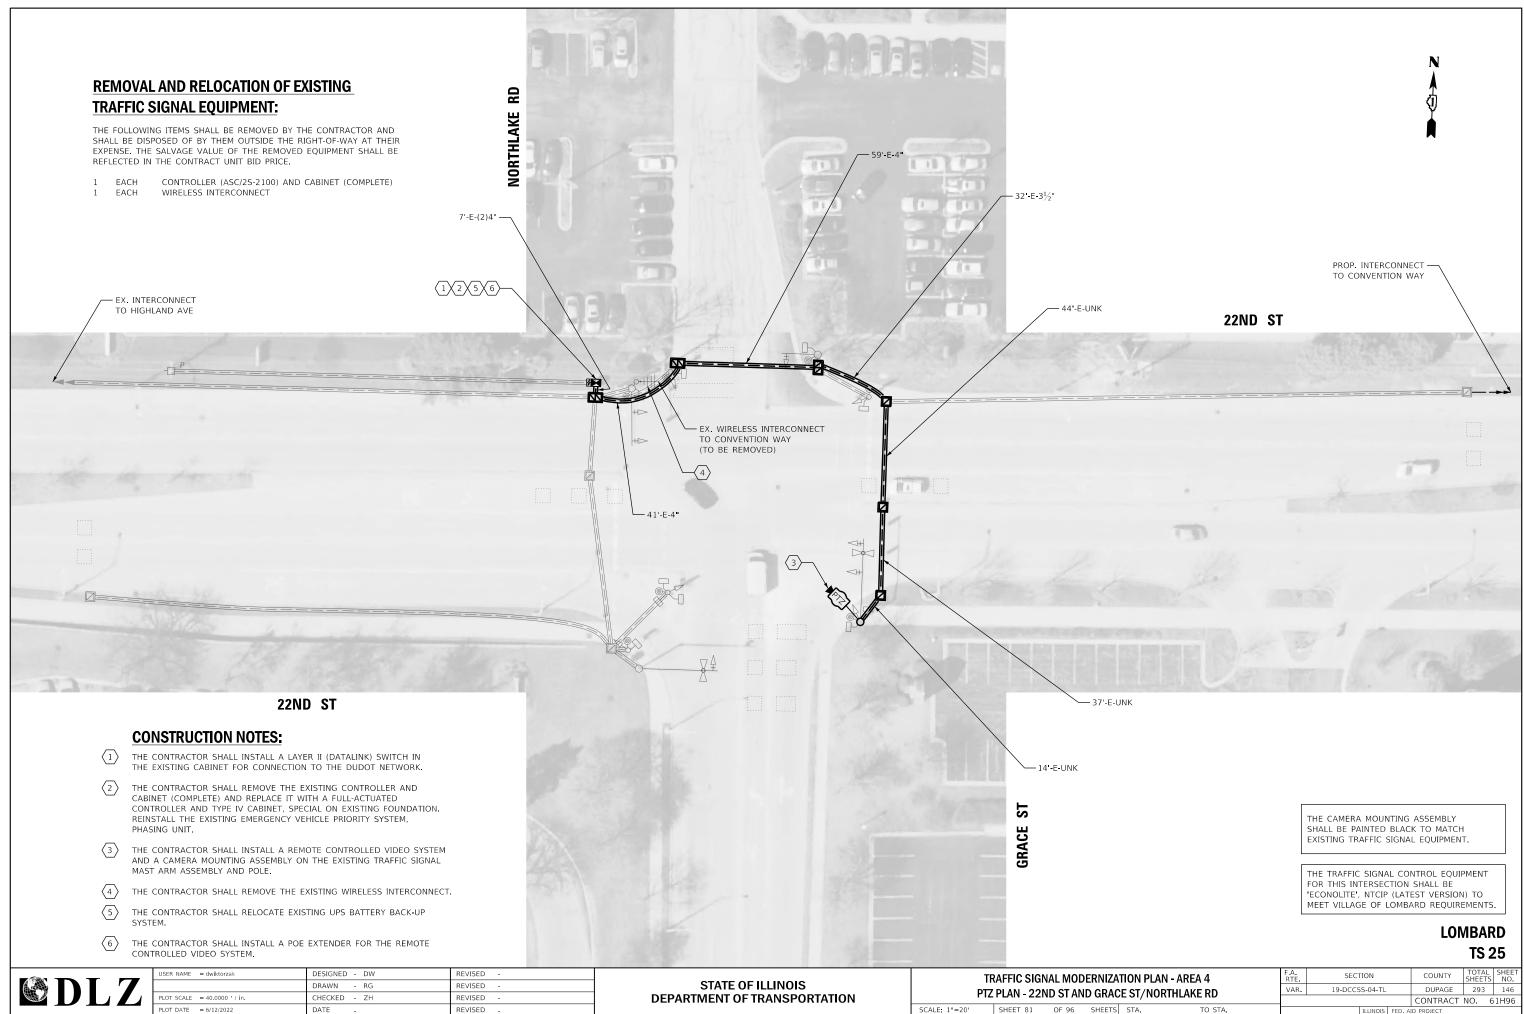


FILE NAME Int 80 = X:\Projects\2021\2182\217400 DuPage DOT Central\CADD_Sheets\sht-4G-22nd-ts-plan.dgr

ZATION PLAN - AREA 4 ACE ST/NORTHLAKE RD		SECT	CTION		COUNTY	COUNTY TOTAL SHEETS	
		19-DCCS	19-DCCSS-04-TL		DUPAGE	293	146
					CONTRACT	NO. 6	1H96
TS STA. TO STA.	ILLINOIS FED. /			FED. A	ID PROJECT		
ACE ST/NORTHLAKE RD TS STA. TO STA.	VAR.				CONTRACT		

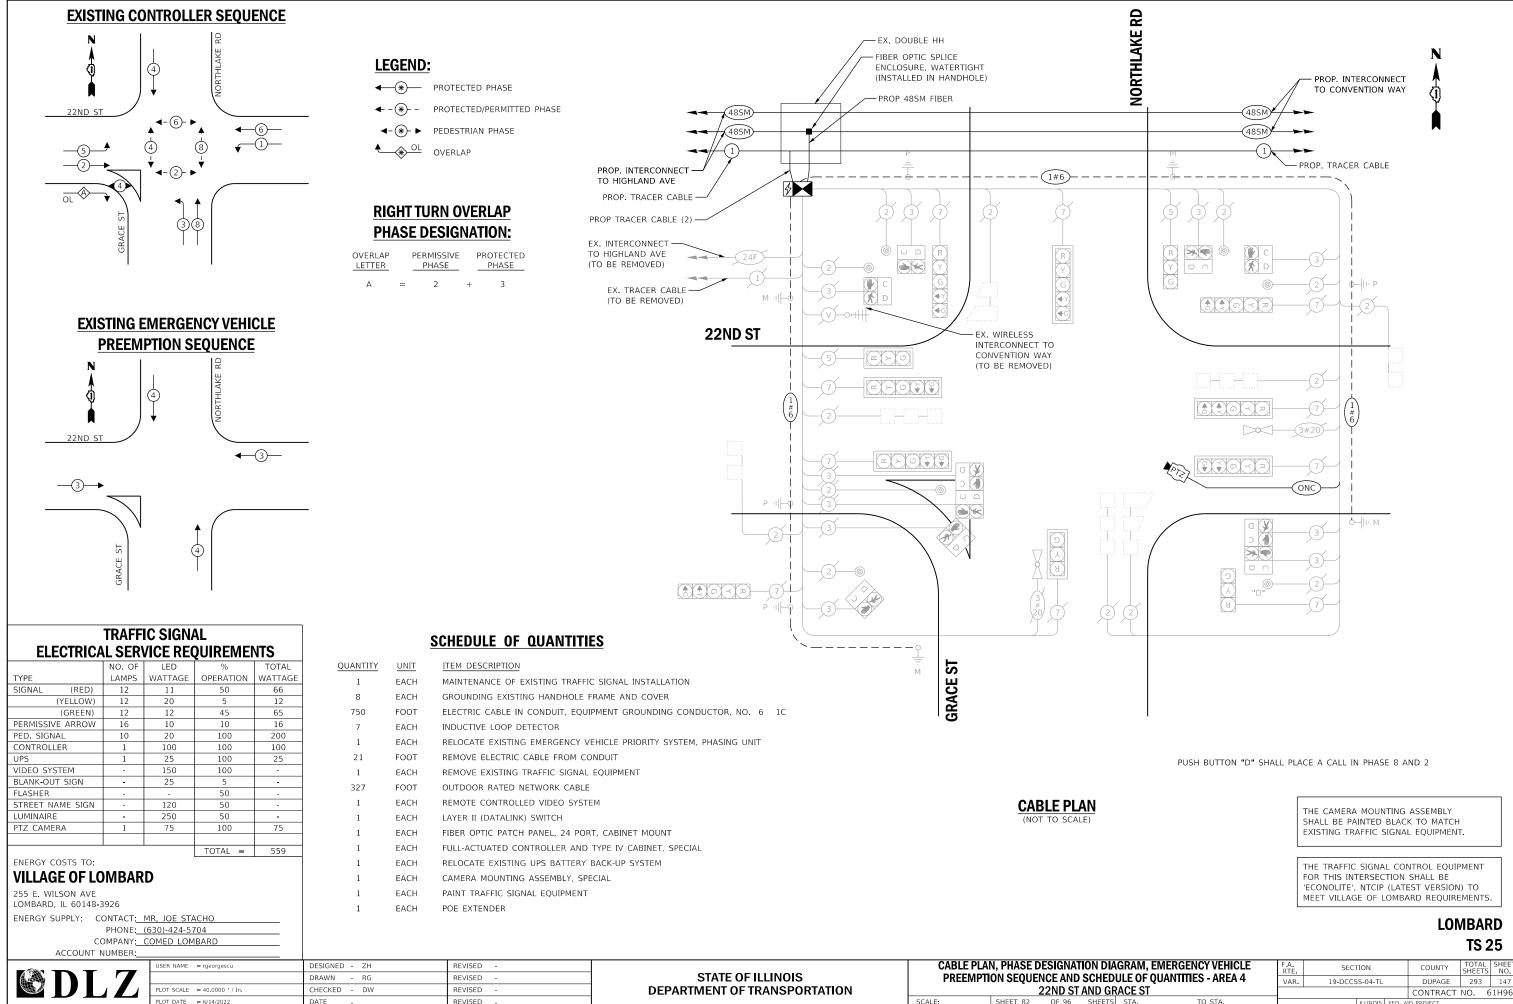

FILE NAME = X\Projects\2021\2182\217400 DuPage DOT Central\CADD_Sheets\sht-4G-22nd-ts-Cable.dg Int 80

	AGRAM, EMERGENCY VEHICLE			SECTION			COUNTY	TOTAL SHEETS	SHEET NO.
DULE OF QUANTITIES - AREA 4		VAR.	19-DCCSS-04-TL		DUPAGE	293	147		
GRACE ST							CONTRACT	NO. 6	51H96
rs	STA.	TO STA.			ILLINOIS	FED. A	ID PROJECT		

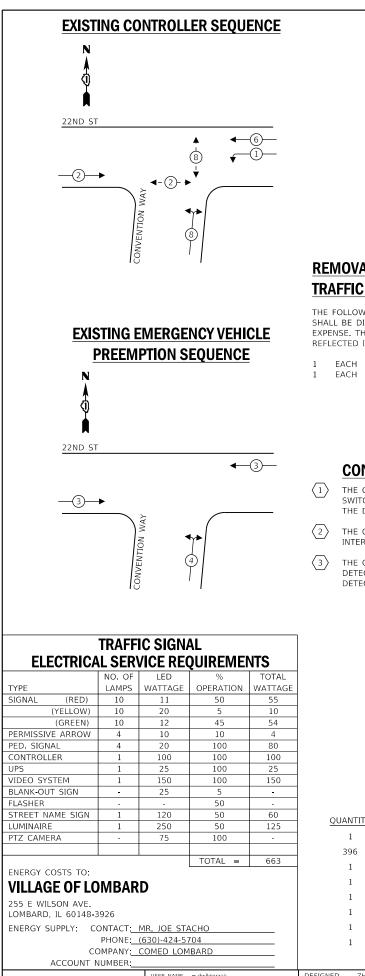

LEGEND:

- ← (*) PROTECTED PHASE ← - (*)- - PROTECTED/PERMITTED PHASE
- ◄-(*)- ► PEDESTRIAN PHASE
- ♦ OL OVERLAP


REMOVAL AND RELOCATION OF EXISTING TRAFFIC SIGNAL EQUIPMENT:

THE FOLLOWING ITEMS SHALL BE REMOVED BY THE CONTRACTOR AND SHALL BE DISPOSED OF BY THEM OUTSIDE THE RIGHT-OF-WAY AT THEIR EXPENSE. THE SALVAGE VALUE OF THE REMOVED EQUIPMENT SHALL BE REFLECTED IN THE CONTRACT UNIT BID PRICE.

WIRELESS INTERCONNECT VIDEO DETECTION (COMPLETE)

CONSTRUCTION NOTES:

- THE CONTRACTOR SHALL INSTALL A LAYER II (DATALINK) SWITCH IN THE CABINET FOR CONNECTION TO THE DUDOT NETWORK.
- THE CONTRACTOR SHALL REMOVE THE EXISTING WIRELESS INTERCONNECT.
- THE CONTRACTOR SHALL REMOVE THE EXISTING VEHICLE DETECTION SYSTEM AND INSTALL THE PROPOSED VEHICLE DETECTION SYSTEM, SPECIAL.

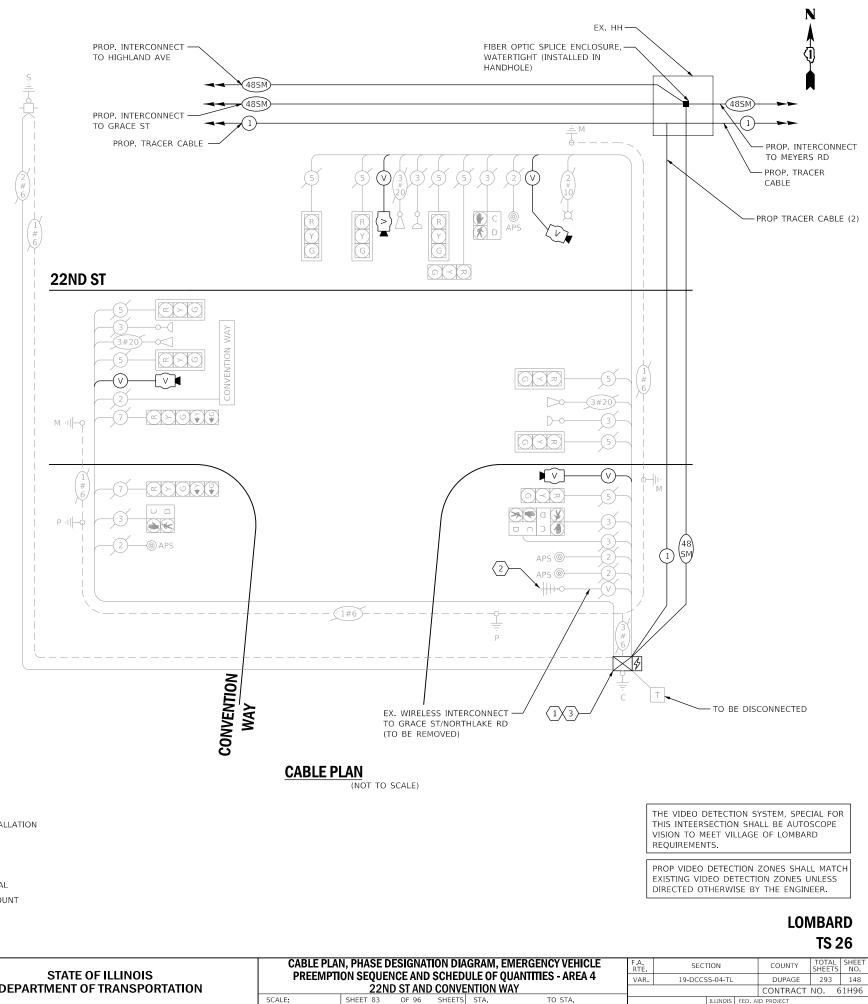


SCHEDULE OF QUANTITIES

QUANTITY	UNIT	ITEM DESCRIPTION
1	EACH	MAINTENANCE OF EXISTING TRAFFIC SIGNAL INSTALLATION
396	FOOT	REMOVE ELECTRIC CABLE FROM CONDUIT
1	EACH	REMOVE EXISTING TRAFFIC SIGNAL EQUIPMENT
1	EACH	LAYER II (DATALINK) SWITCH
1	EACH	UPGRADE EXISTING CONTROLLER TO NTCIP SPECIAL
1	EACH	FIBER OPTIC PATCH PANEL, 24 PORT, CABINET MOUNT
1	EACH	MODIFY EXISTING CONTROLLER CABINET, SPECIAL
1	EACH	VEHICLE DETECTION SYSTEM, SPECIAL

SLE	PLAN	

L	ACCOUNT NOTIBER.									
ſ		USER NAME = dwiktorzak	DESIGNED - ZH	REVISED -		CABLE PLAN, PHASE DESIGNATION DIAG				
			DRAWN - RG	REVISED -	STATE OF ILLINOIS	PREEMPTION SEQUENCE AND SCHEDU				
		PLOT SCALE = 40.0000 / in.	CHECKED - DW	REVISED -	DEPARTMENT OF TRANSPORTATION		22ND	ST AND C	CONVEN	N٦
		PLOT DATE = 6/12/2022 DATE - REVISE	REVISED -		SCALE:	SHEET 83	OF 96 5	SHEETS	Ş	
										_

FILE NAME = X\Projects\2021\2182\217400 DuPage DOT Central\CADD_Sheets\sht-4G-22nd-ts-Cable.dgn Int 79

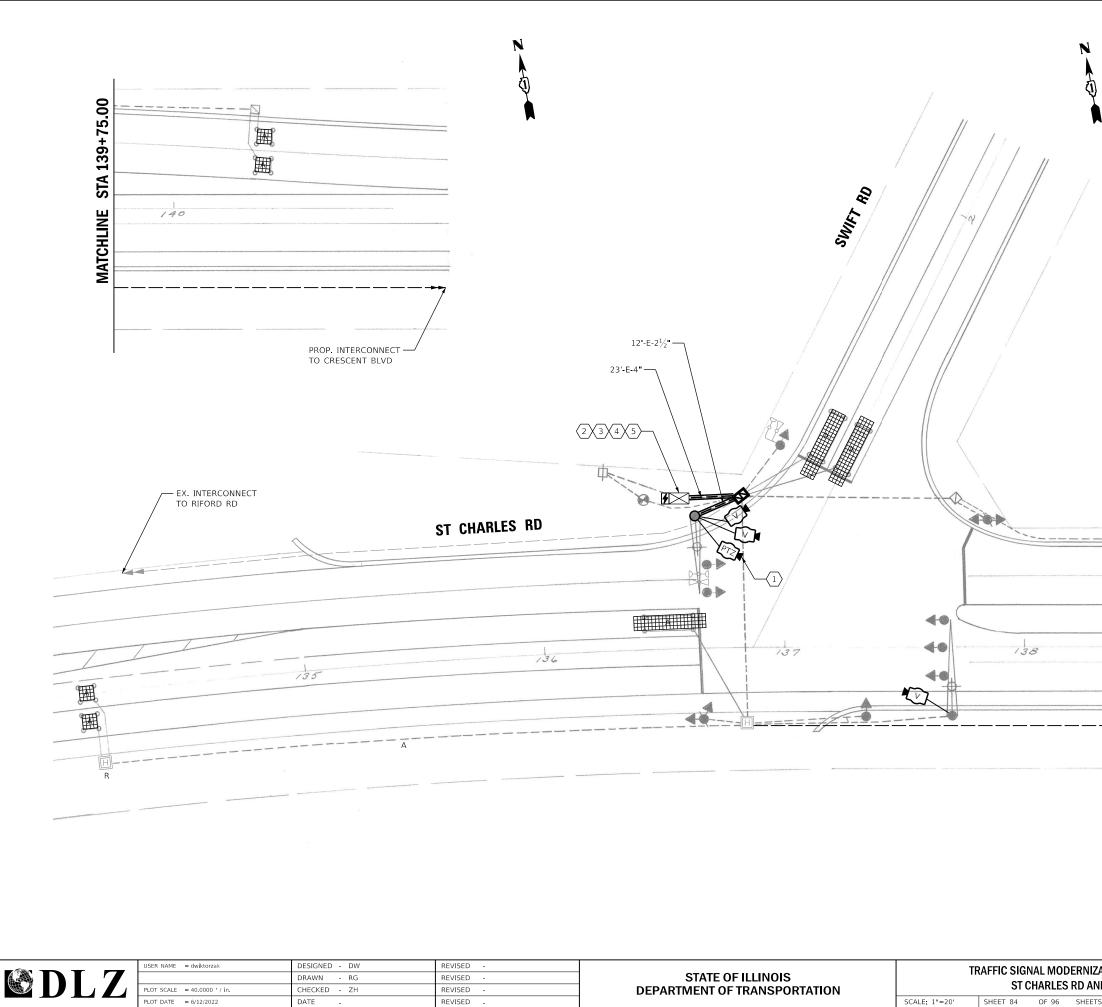

CONSTRUCTION NOTES:

THE CONTRACTOR SHALL INSTALL A REMOTE CONTROLLED VIDEO SYSTEM ON THE EXISTING LUMINAIRE ARM. $\langle 1 \rangle$

 $\langle 2 \rangle$ THE CONTRACTOR SHALL INSTALL AN ELECTRIC METER.





THE CONTRACTOR SHALL INSTALL A LAYER III (NETWORK SWITCH) IN THE EXISTING CABINET FOR CONNECTION TO THE DUDOT NETWORK.



THE CONTRACTOR SHALL INSTALL A VEHICLE DETECTION SYSTEM, SPECIAL.

REMOVAL AND RELOCATION OF EXISTING TRAFFIC SIGNAL EQUIPMENT:

THE FOLLOWING ITEMS SHALL BE REMOVED BY THE CONTRACTOR AND SHALL REMAIN THE PROPERTY OF THE AGENCY LISTED BELOW. THE CONTRACTOR SHALL SAFELY STORE AND ARRANGE FOR DELIVERY OF ALL EQUIPMENT TO BE RETURNED TO THE LISTED AGENCY AS PER THE TRAFFIC SIGNAL SPECIFICATIONS.

AGENCY: DUPAGE COUNTY DIVISION OF TRANSPORTATION


1 EACH LAYER II SWITCH

8	
+75.0	
A 135	
LE SI	
K	
MATCHLINE STA 139+75.00	


ST CHARLES RD

DUDOT


ZAI	FION PL	AN - AREA 4	F.A. RTE	SECTION	COUNTY	TOTAL SHEETS	SHEET NO.
n	SWIFT	RD.	VAR.	19-DCCSS-04-TL	DUPAGE	293	149
10	50011		_		CONTRACT	NO. 6	1H96
ГS	STA.	TO STA.		ILLINOIS FED. A	ID PROJECT		

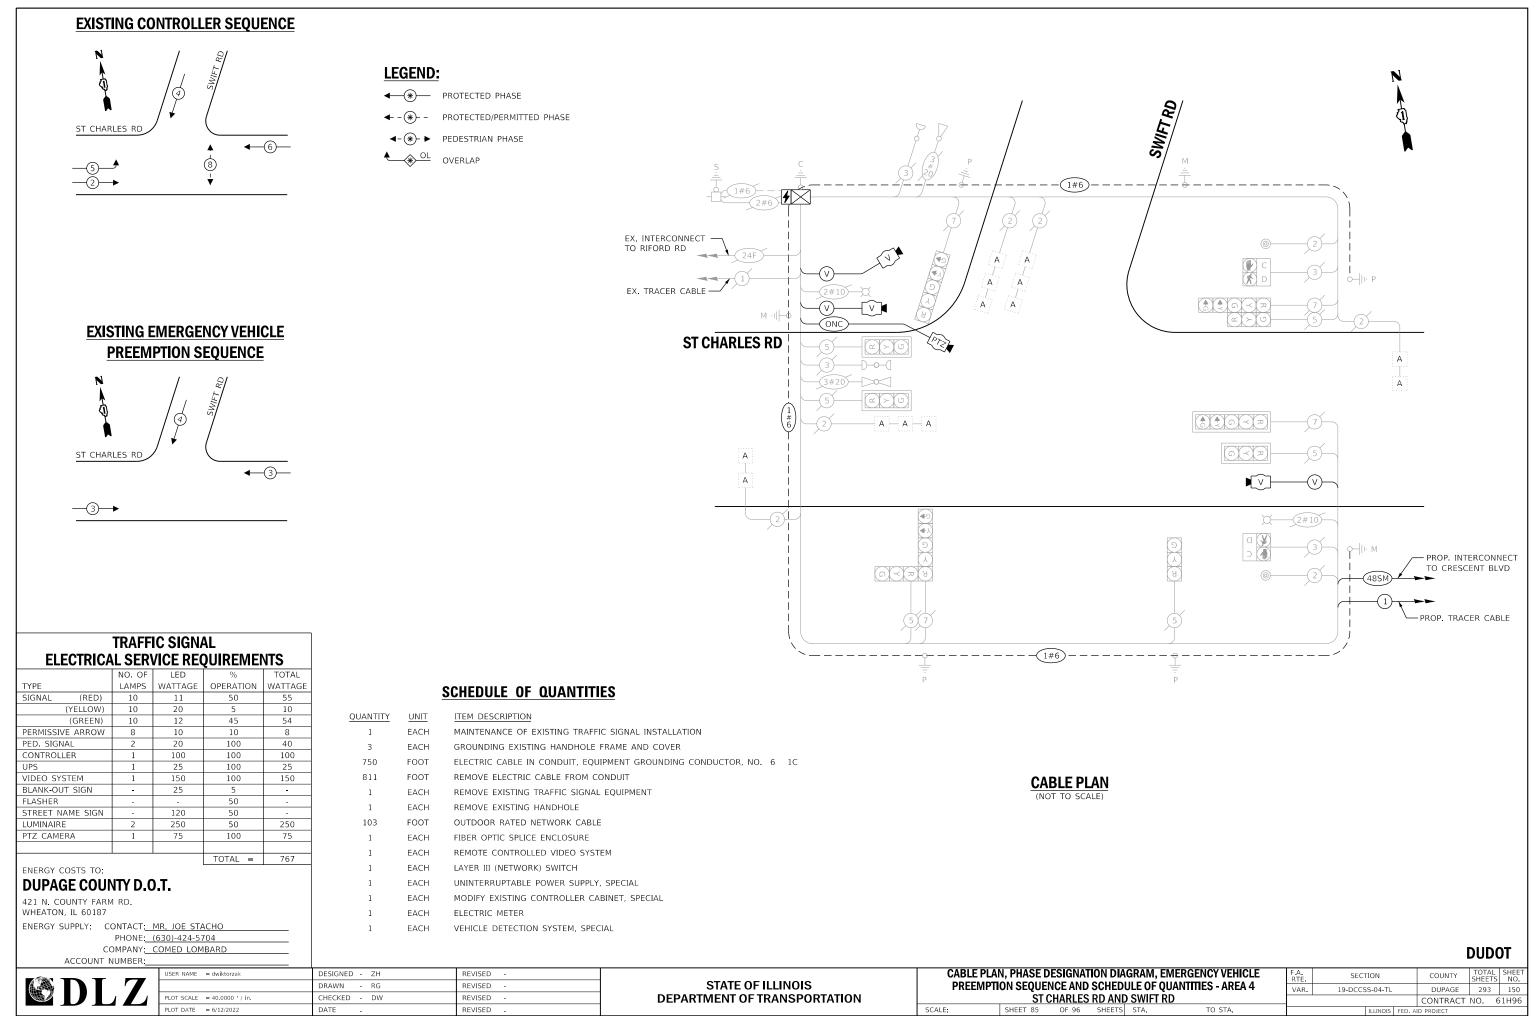


FILE NAME = X.Projects\2021\2182\217400 DuPage DOT Central\CADD Sheets\sht-4H-St Charles ts-Cable.dgn Int 62

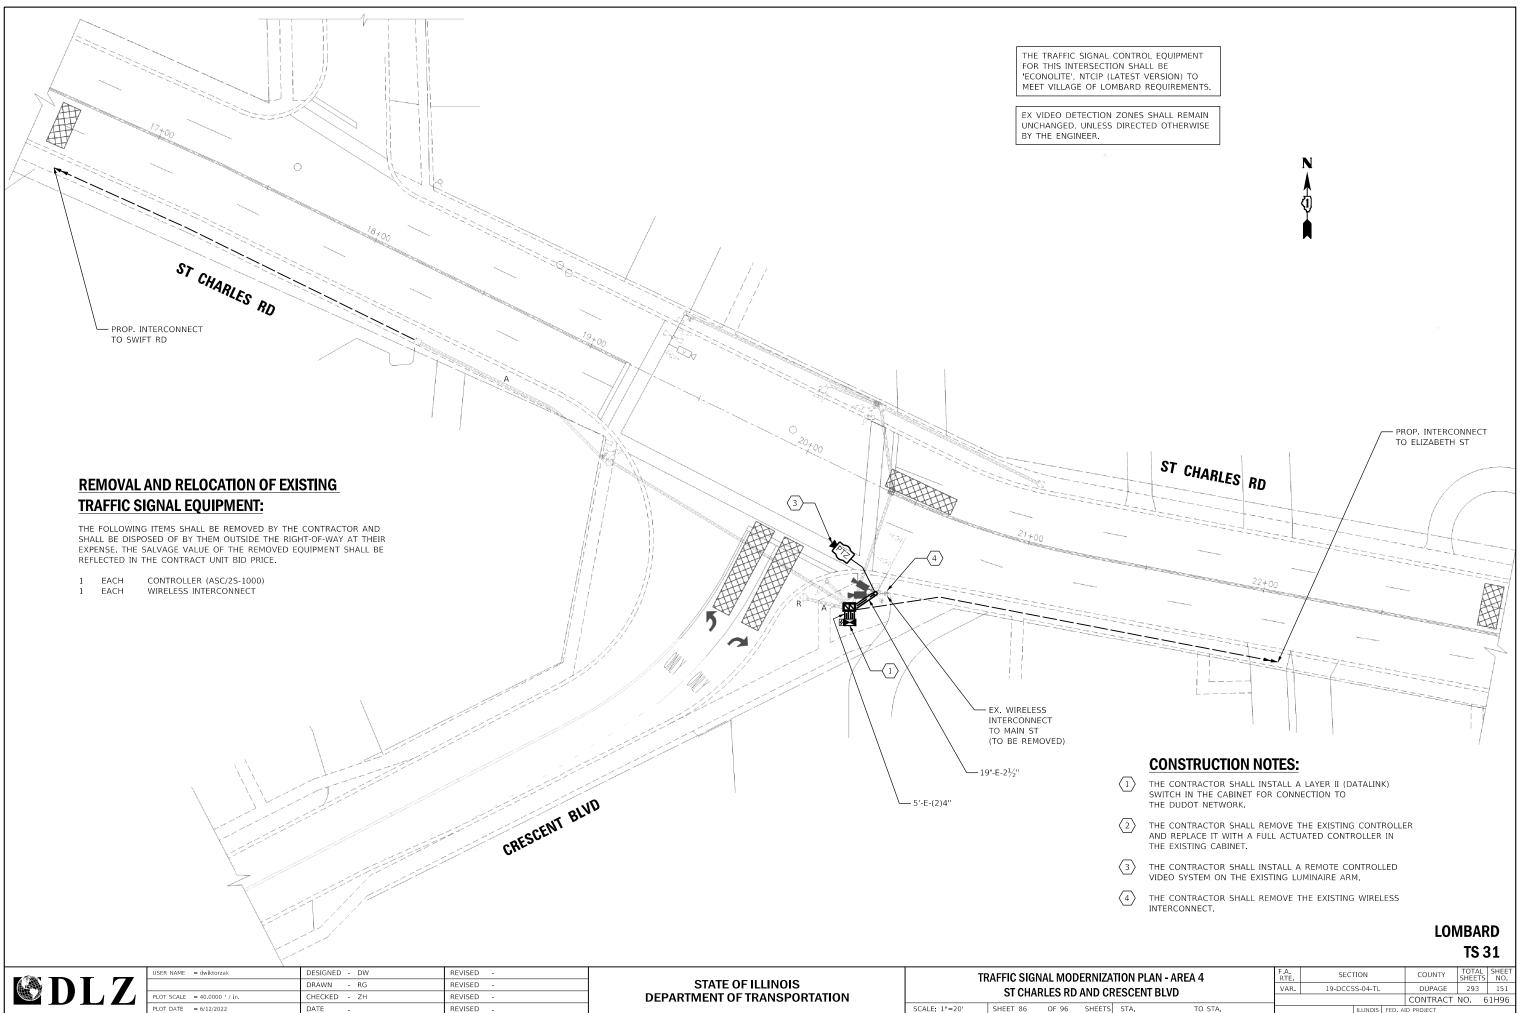


А	HUN PLAN - ARE	A 4	RIE.		-			SHEETS	NO.
)E	RESCENT BLVD		VAR.	19-DCCS	S-04-TL		DUPAGE	293	151
Л							CONTRACT	NO. (51H96
S	STA.	TO STA.			ILLINOIS	FED. A	ID PROJECT		

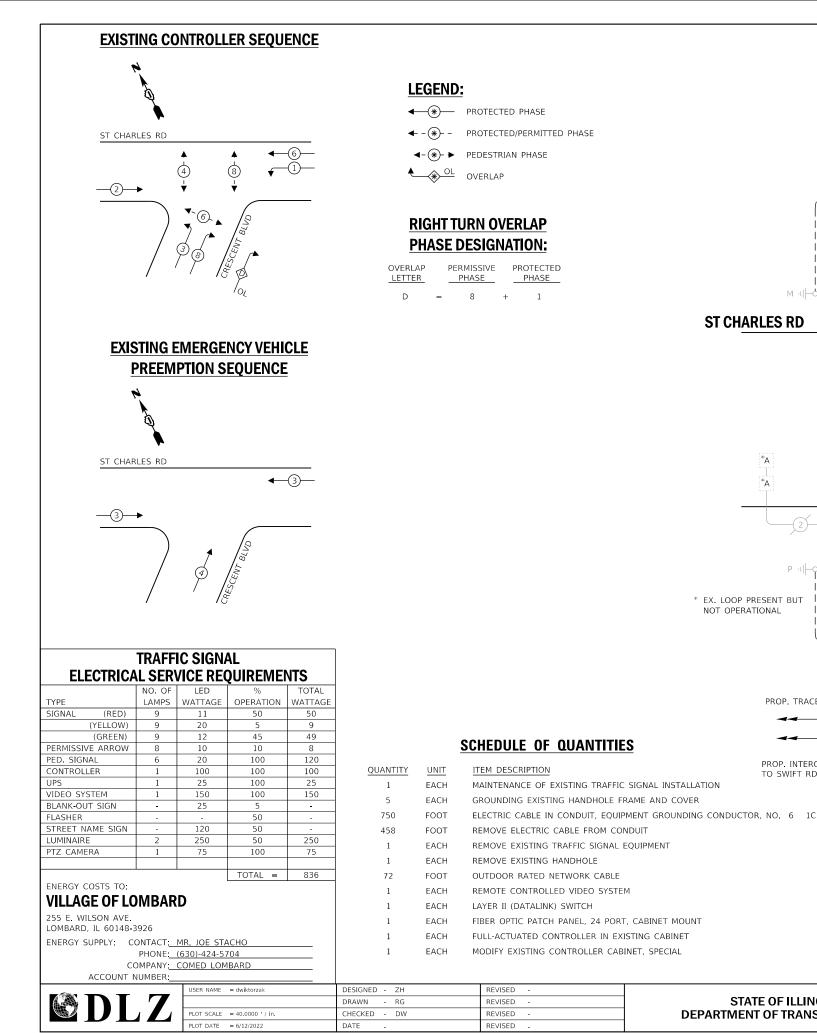

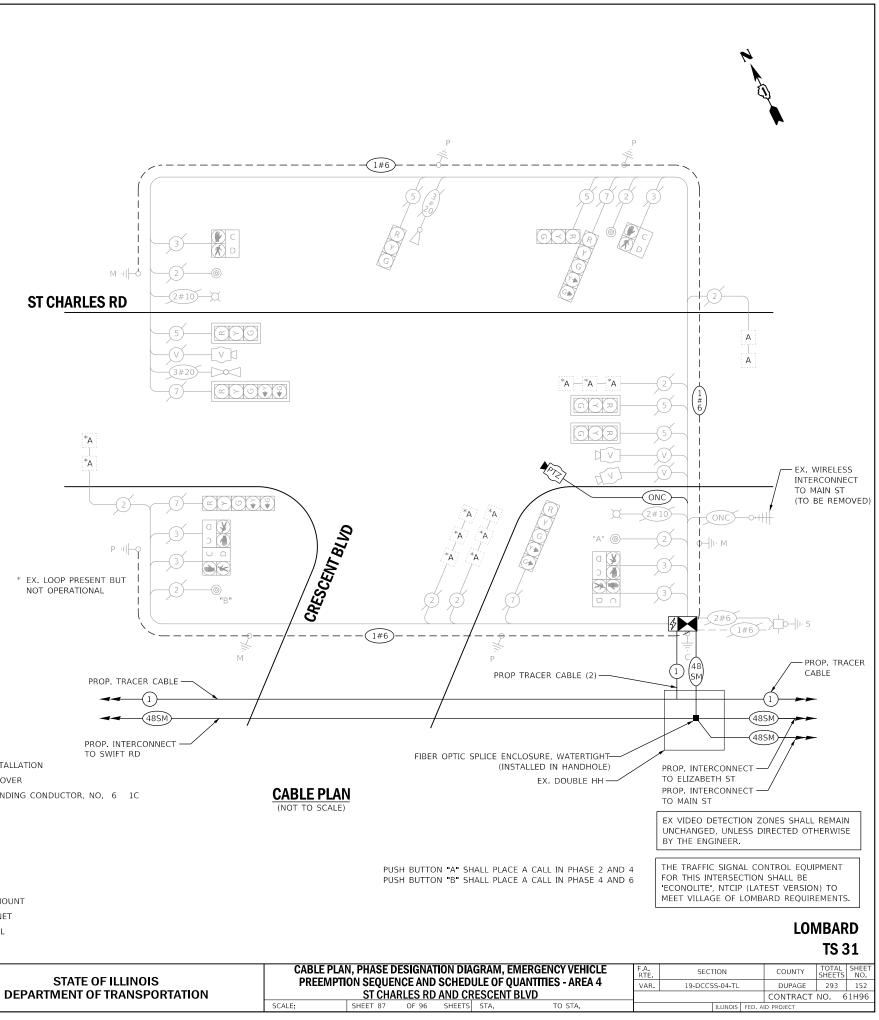

FILE NAME = X \Projects\2021\2182\217400 DuPage DOT Central\CADD_Sheets\sht-4H-St Charles-ts-Cable.dgn Int 100

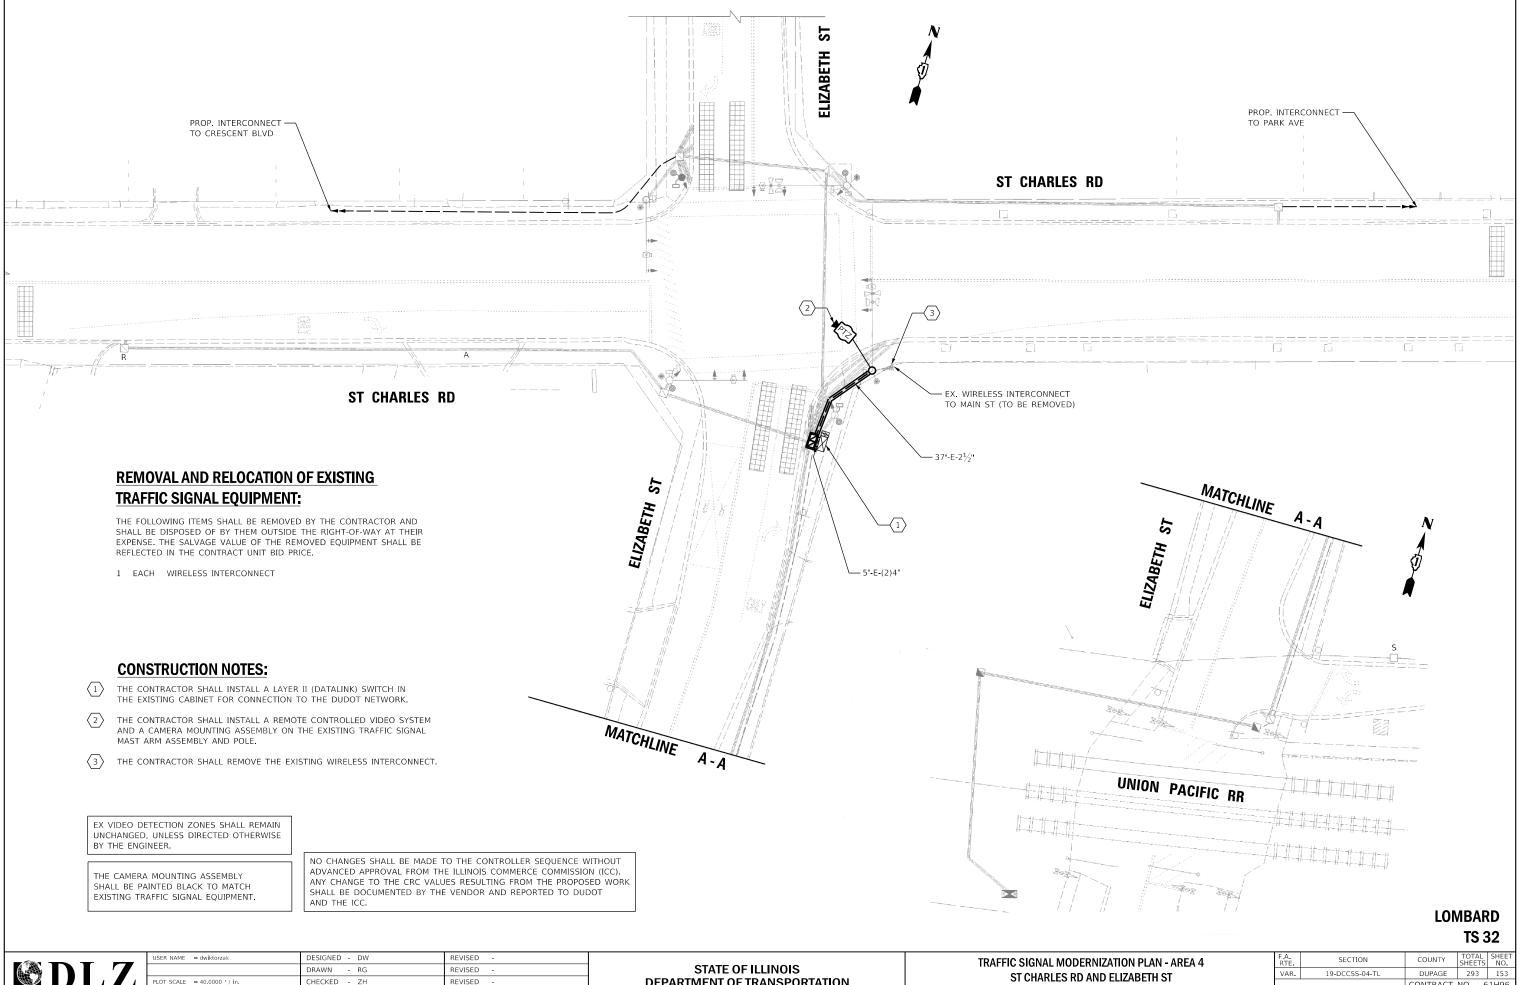

HECKED - ZH

REVISED

OT SCALE = 40.0000 ' / in.

STATE OF ILLINOIS **DEPARTMENT OF TRANSPORTATION**

SCALE: 1"=20'

TF	AFFIC SIGN	IAL MOD	ERNIZA	TION PLAN	I - AREA 4	F.A. RTE	SECTIO	ON		COUNTY	TOTAL SHEETS	SHEET NO.
	ST CH			LIZABETH	ST	VAR.	19-DCCSS-	-04-TL		DUPAGE	293	153
	51 017				51					CONTRACT	NO. 6	1H96
	SHEET 88	OF 96	SHEETS	STA.	TO STA.		IL	LLINOIS	FED. AI	D PROJECT		


EX VIDEO DETECTION ZONES SHALL REMAIN UNCHANGED, UNLESS DIRECTED OTHERWISE BY THE ENGINEER.

THE CAMERA MOUNTING ASSEMBLY SHALL BE PAINTED BLACK TO MATCH EXISTING TRAFFIC SIGNAL EQUIPMENT.

NO CHANGES SHALL BE MADE TO THE CONTROLLER SEQUENCE WITHOUT ADVANCED APPROVAL FROM THE ILLINOIS COMMERCE COMMISSION (ICC). ANY CHANGE TO THE CRC VALUES RESULTING FROM THE PROPOSED WORK SHALL BE DOCUMENTED BY THE VENDOR AND REPORTED TO DUDOT AND THE ICC.

SCHEDULE OF QUANTITIES

QUANTITY	UNIT	ITEM DESCRIPTION
1	EACH	MAINTENANCE OF EXISTING TRAFFIC SIGNAL INSTALLATION
4	EACH	GROUNDING EXISTING HANDHOLE FRAME AND COVER
750	FOOT	ELECTRIC CABLE IN CONDUIT, EQUIPMENT GROUNDING CONDUCTOR, NO. 6 1C
1050	FOOT	REMOVE ELECTRIC CABLE FROM CONDUIT
1	EACH	REMOVE EXISTING TRAFFIC SIGNAL EQUIPMENT
1	EACH	REMOVE EXISTING HANDHOLE
105	FOOT	OUTDOOR RATED NETWORK CABLE
1	EACH	REMOTE CONTROLLED VIDEO SYSTEM
1	EACH	LAYER II (DATALINK) SWITCH
1	EACH	UPGRADE EXISTING CONTROLLER TO NTCIP SPECIAL
1	EACH	FIBER OPTIC PATCH PANEL, 24 PORT, CABINET MOUNT
1	EACH	MODIFY EXISTING CONTROLLER CABINET, SPECIAL
1	EACH	PAINT TRAFFIC SIGNAL EQUIPMENT
1	EACH	CAMERA MOUNTING ASSEMBLY, SPECIAL

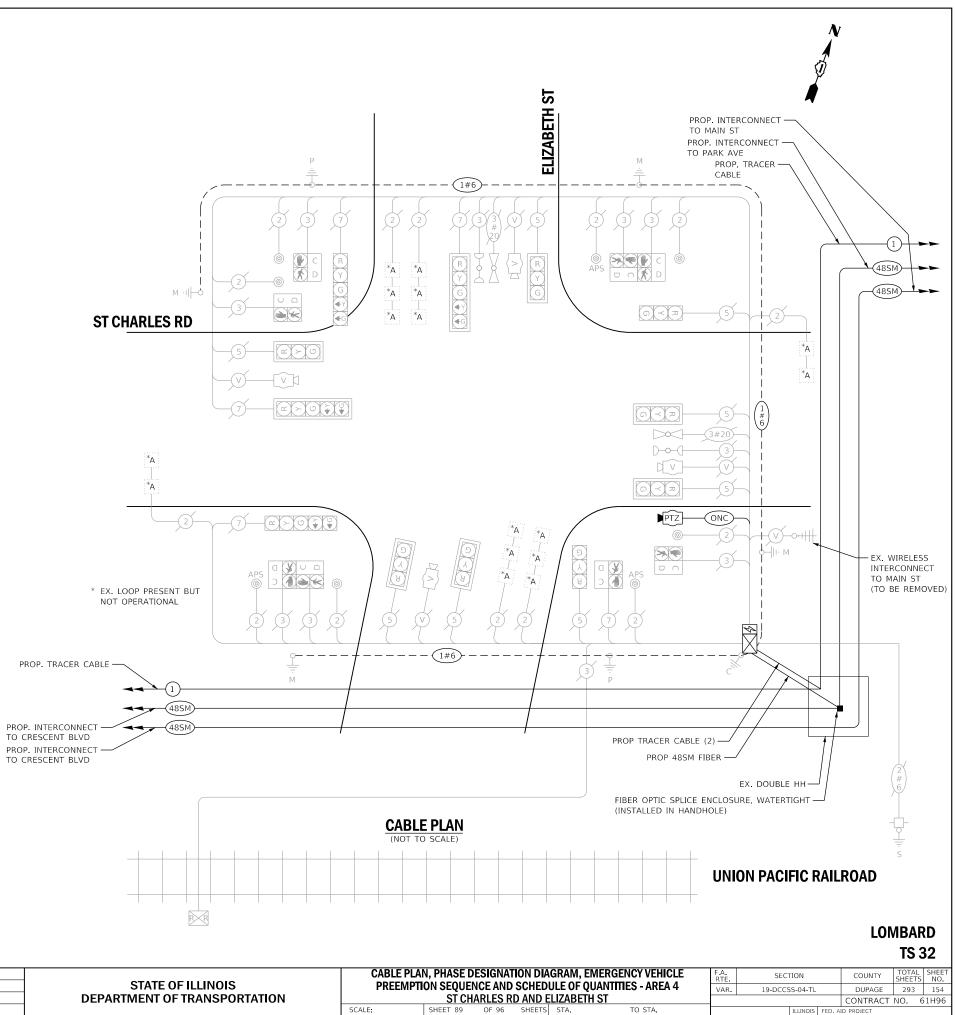

	TRAFF	IC SIGN/	AL	
ELECTRICA	L SER	VICE REC	QUIREMEI	NTS
	NO. OF	LED	%	TOTAL
TYPE	LAMPS	WATTAGE	OPERATION	WATTAGE
SIGNAL (RED)	12	11	50	66
(YELLOW)	12	20	5	12
(GREEN)	12	12	45	65
PERMISSIVE ARROW	8	10	10	8
PED. SIGNAL	8	20	100	160
CONTROLLER	1	100	100	100
UPS	1	25	100	25
VIDEO SYSTEM	1	150	100	150
BLANK-OUT SIGN	-	25	5	-
FLASHER	-	-	50	-
STREET NAME SIGN	-	120	50	-
LUMINAIRE	-	250	50	-
PTZ CAMERA	1	75	100	75
			TOTAL =	661
ENERGY COSTS TO:				
DUPAGE COU	NTY D.C).T.		
421 N. COUNTY FARM WHEATON, IL 60187	1 RD.			
ENERGY SUPPLY: C	ONTACT:	MR. JOE STA	СНО	
		(630)-424-57		
C		COMED LOM		
ACCOUNT				
C 1		USER NAME	= dwiktorzak	

	USER NAME = UWIRTOZAR		KLVIJLD -			AN, E 117
		DRAWN - RG	REVISED -	STATE OF ILLINOIS	PREEMPT	ION SE
	PLOT SCALE = 40.0000 ' / in.	CHECKED - DW	REVISED -	DEPARTMENT OF TRANSPORTATION		9
	PLOT DATE = 6/12/2022	DATE -	REVISED -		SCALE:	SHEET
FILE NAME = X:\Projects\2021\2182\217400 Duf Int 101	Page DOT Central\CADD_Sheets\sht-4H-St Charles-ts-Cal	ole.dgn				

DEVICE

SEQUENCE OF OPERATION: ST. CHARLES ROAD / ELIZABETH STREET

MOVEMENT		F	,	P - 6 - 1			- 2-	P 6 P			▲ 3	● P 8 P		P P	4	▲ P 		A H
PHASE			1 +	6			2 ·	+ 6			3	+ 8			4 +	8		4
INTERVAL	1	2	3	4 A	4B	5	6	7A	7B	8	9	101	1A11	3 12	13	14A	14B	
CHANGE TO PHASE	θ	θ	2+6	3-4-	+8 +8	θ/	θ/	3+ 4+	8	θ	θ/	4+8	1+6 2+6	θ	θ/	1+2+		
ELIZABETH ST. NORTHBOUND FAR LEFT SIGNAL AND END MAST ARM SIGNAL	R	R	R	R	R	R	R	R	R	G	G	G Y	Y R	G	G	Υ	R	R
ELIZABETH ST. NORTHBOUND RIGHT MAST ARM SIGNAL	R	R	R	R	R	R	R	R	R	G	G	G	Y R	G	G	Υ	R	R
ELIZABETH ST. SOUTHBOUND FAR LEFT SIGNAL AND END MAST ARM SIGNAL	R	R	R	R	R	R	R	R	R	R	R	R	R R	G	G	Υ	R	R
ST CHARLES ROAD WESTBOUND FAR LEFT AND END MAST ARM SIGNAL	G	G	GY	Y	R	G	G	Y	R	R	R	R	R R	R	R	R	R	R
ST CHARLES ROAD WESTBOUND RIGHT MAST ARM SIGNAL	G	G	G	Y	R	G	G	Y	R	R	R	R	RR	R	R	R	R	R
ST CHARLES ROAD EASTBOUND FAR LEFT AND MAST ARM SIGNAL	R	R	R	R	R	G	G	Y	R	R	R	R	RR	R	R	R	R	R
PEDESTRIAN SIGNALS NORTH LEG 6	P	κ * ≯ ΓΗ	H	н	н	P*	** FH	н	н	н	Н	н	н н	Н	Н	н	Н	~
PEDESTRIAN SIGNALS SOUTH LEG ②	Н	Н	н	н	Н	Ρ*	** FH	н	Н	н	Н	н	н н	Н	Н	н	Н	с С
PEDESTRIAN SIGNALS WEST LEG (4)	Н	Н	Н	н	н	н	н	н	н	н	Н	н	н н	Ρ*	FH	Н	Н	4
PEDESTRIAN SIGNALS EAST LEG (8)	Н	Н	н	н	н	н	н	н	н	Р*	** FH	н	нн	P*	= ** FH	Н	Н	

** FLASHING " 🚺 " IS TO TERMINATE AT THE COMPLETION OF THE PEDESTRIAN INTERVAL CLEARANCE.

P = ILLUMINATED PERSON = WALK FH = ILLUMINATED FLASHING HAND = FLASHING DON'T WALK H = ILLUMINATED SOLID HAND = DON'T WALK



EMERGENCY VEHICLE PRIORITY SEQUENCE OF OPERATION																						PREEMPTOR NUMBER 3	PREEMPTOR NUMBER 4	
FROM NORMAL SEQUENCE				1				5					8					1	2					
EMERGENCY VEHICLE INTERVAL	1 A	1B	1 C	1 D	1E	1 F	1 G	1H	1 I	1J	1K	1L	1 M	1N	10	1P	1 Q	1R	1 S	1 T	1 U	2	3	2
CHANGE TO	1B	2	1D	1E	3	1 G	2	1 I	1J	3	1L	2	1N	10	3	10	1R	2	1 T	1 U	3			CLEAR TO
ELIZABETH ST. NORTHBOUND FAR LEFT SIGNAL AND END MAST ARM SIGNAL	R	R	R	R	R	R	R	R	R	R	G	Y	R	G	G	G G	Y	R	G	G	G	R	G	Ť
ELIZABETH ST. NORTHBOUND RIGHT MAST ARM SIGNAL	R	R	R	R	R	R	R	R	R	R	G	Y	R	G	G	G	Y	R	G	G	G	R	G	T
ELIZABETH ST. SOUTHBOUND FAR LEFT SIGNAL AND END MAST ARM SIGNAL	R	R	R	R	R	R	R	R	R	R	G	Y	R	G	G	R	R	R	R	R	R	R	Ĝ	T
ST CHARLES ROAD WESTBOUND FAR LEFT AND END MAST ARM SIGNAL	G	G	G	Y	R	G ▲ G	G	G	Y	R	R	R	R	R	R	R	R	R	R	R	R	G	R	T
T CHARLES ROAD WESTBOUND RIGHT MAST ARM SIGNAL	G	G	G	Y	R	G		G	Y	R	R	R	R	R	R	R	R	R	R	R	R	G	R	1
T CHARLES ROAD EASTBOUND FAR LEFT AND MAST ARM SIGNAL	G	G	G	Y	R	R	R	R	R	R	R	R	R	R	R	R	R	R	R	R	R	G	R	1
EDESTRIAN SIGNALS NORTH LEG 6	FH	н	F٢	н	Н	ΕH	Н	FΗ	н	Н	Н	н	н	н	н	Н	Н	Н	н	Н	Н	н	н	1
PEDESTRIAN SIGNALS SOUTH LEG ②	FH	н	Ft	н	н	н	Н	н	н	Н	Н	н	н	н	Н	Н	Н	н	н	Н	Н	н	н	1
EDESTRIAN SIGNALS WEST LEG ④	Н	н	н	н	н	н	Н	н	н	н	FH	н	н	н	н	Н	Н	н	н	н	н	н	н	1
PEDESTRIAN SIGNALS EAST LEG (8)	Н	н	н	н	н	н	н	н	н	н	FH	н	Н	FH	н	FH	Н	н	FH	нн	Н	н	н	1

RAILROAD PREEMPTION SEQUENCE OF OPERATION										PREE	MPTOR ER 3		MPTOR ER 4		PREEM			
CHANGE FROM NORMAL SEQUENCE OF OPERATION INTERVAL NUMBE	R	1	1	ļ	5		3	1	2			-						1
CHANGE FROM EMERGENCY VEHICLE PREEMPTION SEQUENCE OF OPERATION INTERVAL NUMBER										â	2		3					
RAILROAD PREEMPTION SEQUENCE OF OPERATION INTERVAL NUMBER		1 A	1 B	1 C	1D	1E	1F	1 G	1H	11	1J	1 K	1L	2	3	4	5	e .
CHANGE TO EMERGENCY VEHICLE PREEMPTION SEQUENCE OF OPERATION INTERVAL NUMBER		1 B	2	1D	2	1F	2	1 H	2	1 J	2	1L	2	3	4	5		CLEAR TO NORVAL
ELIZABETH ST. NORTHBOUND FAR LEFT SIGNAL AND END MAST ARM SIGNAL		R	R	R	R	G	G	G G	G	R	R	G	G	G	Y	R	R	
ELIZABETH ST. NORTHBOUND RIGHT MAST ARM SIGNAL		R	R	R	R	G	G	G	G	R	R	G	G	G	Y	R	R	
ELIZABETH ST. SOUTHBOUND FAR LEFT SIGNAL AND END MAST ARM SIGNAL		R	R	R	R	Y	R	R	R	R	R	Y	R	R	R	R	R	
ST CHARLES ROAD WESTBOUND FAR LEFT AND END MAST ARM SIGNAL		Y	R	Y	R	R	R	R	R	Y	R	R	R	R	R	R	G	
ST CHARLES ROAD WESTBOUND RIGHT MAST ARM SIGNAL		Y	R	Y	R	R	R	R	R	Y	R	R	R	R	R	R	G	
ST CHARLES ROAD EASTBOUND FAR LEFT AND MAST ARM SIGNAL		Y	R	R	R	R	R	R	R	Y	R	R	R	R	R	R	G	
PEDESTRIAN SIGNALS NORTH LEG 6		FΗ	Н	FH	Н	н	Н	Н	н	н	н	н	н	н	н	Н	н	
PEDESTRIAN SIGNALS SOUTH LEG (2)		FΗ	Н	Н	Н	н	Н	Н	н	н	н	н	Н	н	н	н	н	
PEDESTRIAN SIGNALS WEST LEG ④		Н	Н	Н	Н	FH	Н	Н	н	н	н	н	Н	Н	н	Н	Н	
PEDESTRIAN SIGNALS EAST LEG 🛞		Н	н	н	н	FH	Н	FH	н	Н	Н	н	Н	Н	н	Н	Н	

RAILROAD PREEMPTION SEQUENCE SHALL PROVIDE THE PROPER CLEARANCE INTERVAL TO RESUME THE NORMAL SEQUENCE OF OPERATION OR PROPER △ CLEARANCE INTERVAL TO DISPLAY AN EMERGENCY VEHICLE INTERVAL (IF APPLICABLE) AFTER PREEMTION INTERVAL 5 IS TERMINATED.

DURING RAILROAD PREEMPTION. THE TRAFFIC SIGNAL CONTROLLER WILL CLEAR NORTHBOUND THROUGH AND LEFT MOVEMENTS (3+8). AFTER THE REQUIRED CLEARANCE INTERVAL. THE TRAFFIC SIGNAL CONTROLLER WILL BE PERMITTED TO CYCLE THROUGH 2+6, 3+8 AND 2+6 DURING THE HOLD PHASE.


USER NAME = dwiktorzak	DESIGNED - ZH	REVISED -		CABLE	,		SECTION	COUNTY TOTAL SHEET SHEETS NO.
	DRAWN - RG	REVISED -	STATE OF ILLINOIS	PREE	EMPTION SEQUENCE AND SCHEDULE OF QUANTITIES - A	AREA 4 VAR.	19-DCCSS-04-TL	DUPAGE 293 155
PLOT SCALE = 40.0000 / in.	CHECKED - DW	REVISED -	DEPARTMENT OF TRANSPORTATION		ST CHARLES RD AND ELIZABETH ST			CONTRACT NO. 61H96
PLOT DATE = 6/12/2022	DATE -	REVISED -		SCALE:	SHEET 90 OF 96 SHEETS STA. TO ST	ΓA.	ILLINOIS FED	AID PROJECT

* TO APPEAR ONLY UPON PUSH BUTTON ACTUATION

HIS " of flashing " P " interval way finish timing in the bidirectional straight through movement IF THE ARROW TIME IS NOT SUFFICIENT TO COMPLETE " OR FLASHING "

FOR INFORMATION ONLY

LOMBARD TS 32

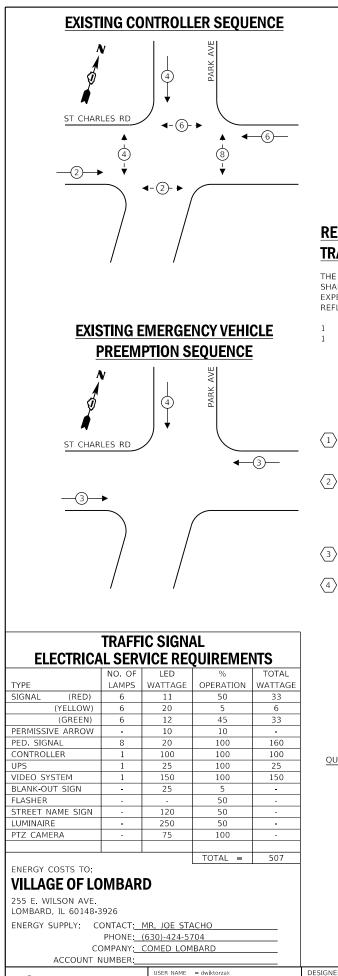




REMOVAL AND RELOCATION OF EXISTING TRAFFIC SIGNAL EQUIPMENT:


THE FOLLOWING ITEMS SHALL BE REMOVED BY THE CONTRACTOR AND SHALL BE DISPOSED OF BY THEM OUTSIDE THE RIGHT-OF-WAY AT THEIR EXPENSE. THE SALVAGE VALUE OF THE REMOVED EQUIPMENT SHALL BE REFLECTED IN THE CONTRACT UNIT BID PRICE.

1 EACH CONTROLLER (ASC/2S-2100) AND CABINET (COMPLETE) 1 EACH WIRELESS INTERCONNECT

CONSTRUCTION NOTES:

- THE CONTRACTOR SHALL INSTALL A LAYER II (DATALINK) SWITCH IN THE CABINET FOR CONNECTION TO THE DUDOT NETWORK.
- THE CONTRACTOR SHALL REMOVE THE EXISTING CONTROLLER AND CABINET (COMPLETE) AND REPLACE IT WITH A FULL-ACTUATED CONTROLLER AND TYPE IV CABINET, SPECIAL ON EXISTING FOUNDATION. REINSTALL THE EXISTING EMERGENCY VEHICLE PRIORITY SYSTEM, PHASING UNIT AND VIDEO DETECTION SYSTEM.
- THE CONTRACTOR SHALL REMOVE THE EXISTING WIRELESS INTERCONNECT.
- THE CONTRACTOR SHALL RELOCATE EXISTING UPS BATTERY BACK-UP SYSTEM.

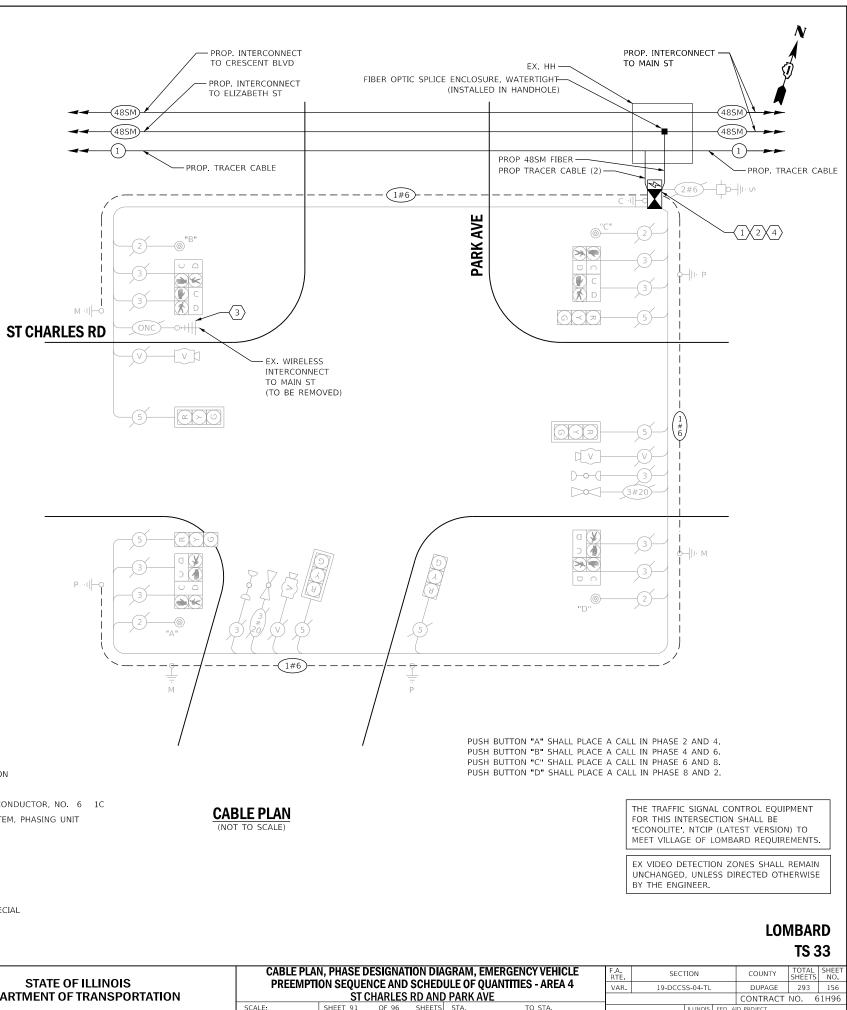

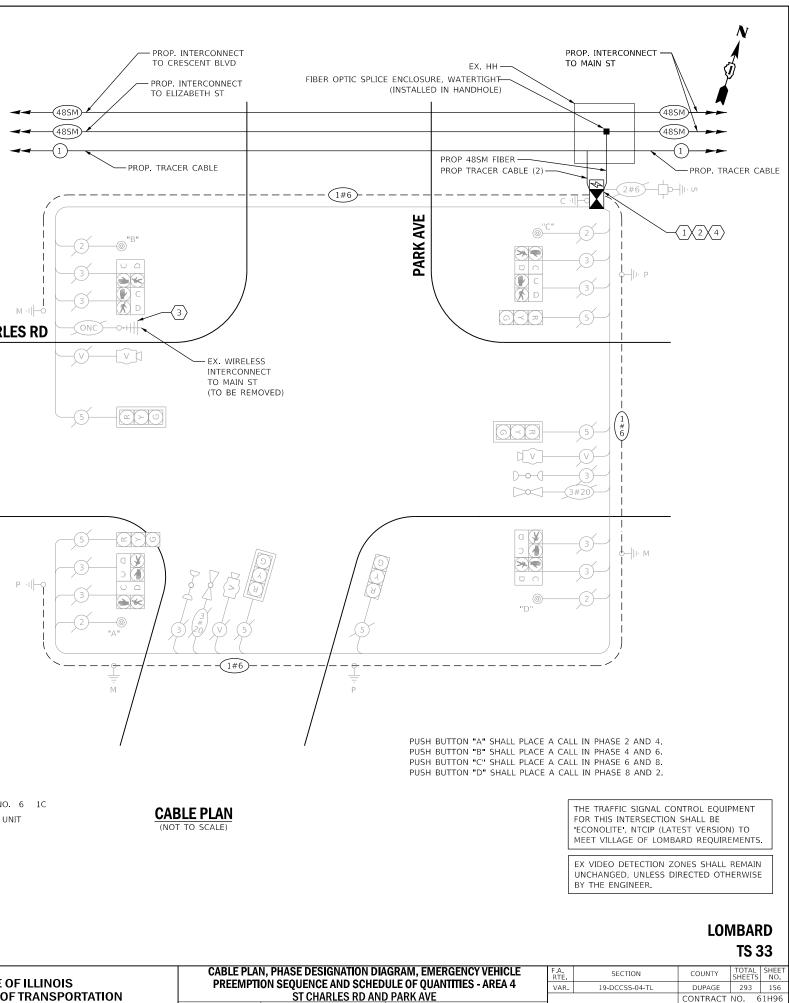

STA.

ILLINOIS FED AID PE


SCHEDULE OF QUANTITIES

QUANTITY	UNIT	ITEM DESCRIPTION
1	EACH	MAINTENANCE OF EXISTING TRAFFIC SIGNAL INSTALLATION
4	EACH	GROUNDING EXISTING HANDHOLE FRAME AND COVER
750	FOOT	ELECTRIC CABLE IN CONDUIT, EQUIPMENT GROUNDING CONDUCTOR, NO. 6 1C
1	EACH	RELOCATE EXISTING EMERGENCY VEHICLE PRIORITY SYSTEM, PHASING UNIT
73	FOOT	REMOVE ELECTRIC CABLE FROM CONDUIT
1	EACH	REMOVE EXISTING TRAFFIC SIGNAL EQUIPMENT
1	EACH	RELOCATE VIDEO VEHICLE DETECTION SYSTEM
1	EACH	LAYER II (DATALINK) SWITCH
1	EACH	FIBER OPTIC PATCH PANEL, 24 PORT, CABINET MOUNT
1	EACH	FULL-ACTUATED CONTROLLER AND TYPE IV CABINET, SPECIAL
1	EACH	RELOCATE EXISTING UPS BATTERY BACK-UP SYSTEM

CABLE PLAN	
(NOT TO SCALE)	

L	ACCOUNT NOTIBER.									
- [USER NAME = dwiktorzak	DESIGNED - ZH	REVISED -		CABLE PLAN	N, PHASE DF	ESIGNATI/	ION DIA	١GI
			DRAWN - RG	REVISED -	STATE OF ILLINOIS	PREEMPT	ION SEQUEN	ICE AND S	SCHED!	UL
		PLOT SCALE = 40.0000 ' / in.	CHECKED - DW	REVISED -	DEPARTMENT OF TRANSPORTATION	1	ST C	HARLES F	RD AND) P
		PLOT DATE = 6/12/2022	DATE -	REVISED -		SCALE:	SHEET 91	OF 96	SHEETS	5

FILE NAME = X1Projects\2021\2182\217400 DuPage DOT Central\CADD Sheets\sht-4H-St Charles-ts-Cable.dgn Int 104

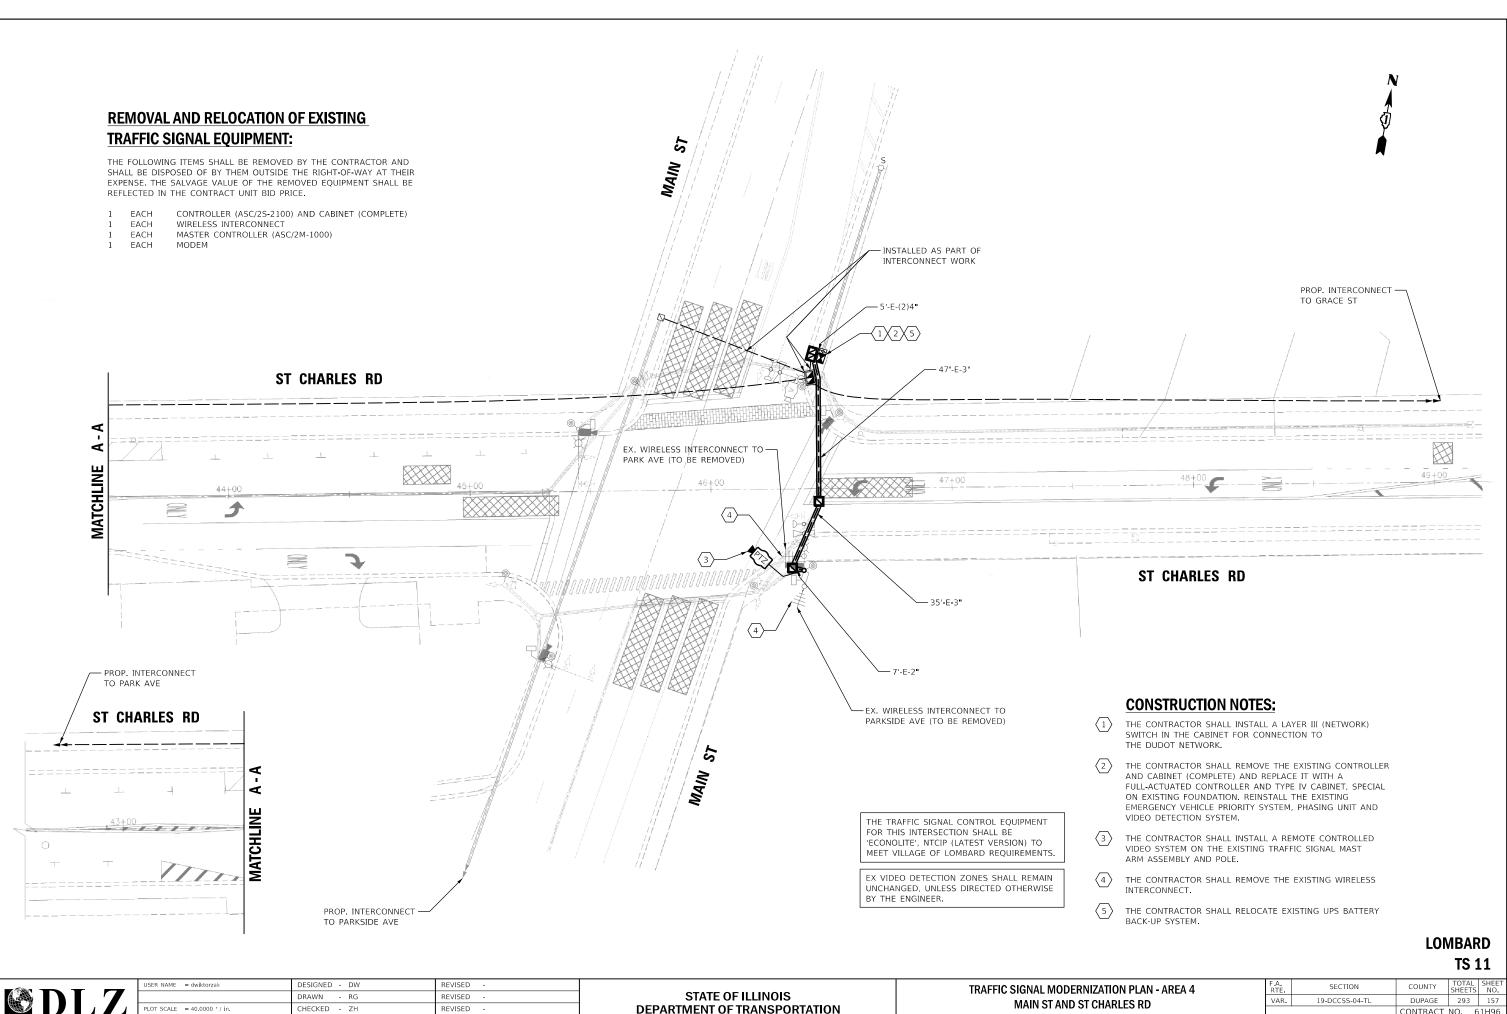

X:\Projects\2021\2182\217400 DuPage DOT Central\CADD_Sheets\sht-4B-Main-ts-plan.dg


PLOT DATE = 6/14/2022


DATE

REVISED


SCALE: 1"=20' SHEET 92 OF 96 SHEET

ZA'	TION PL	AN - AREA 4	F.A. RTE	SEC	ΓΙΟΝ		COUNTY	TOTAL SHEETS	SHEET NO.
Ъ	ARLES R	20	VAR.	19-DCCS	5S-04-TL		DUPAGE	293	157
			_				CONTRACT	NO. 6	51H96
TS	STA.	TO STA.			ILLINOIS	FED, A	ID PROJECT		

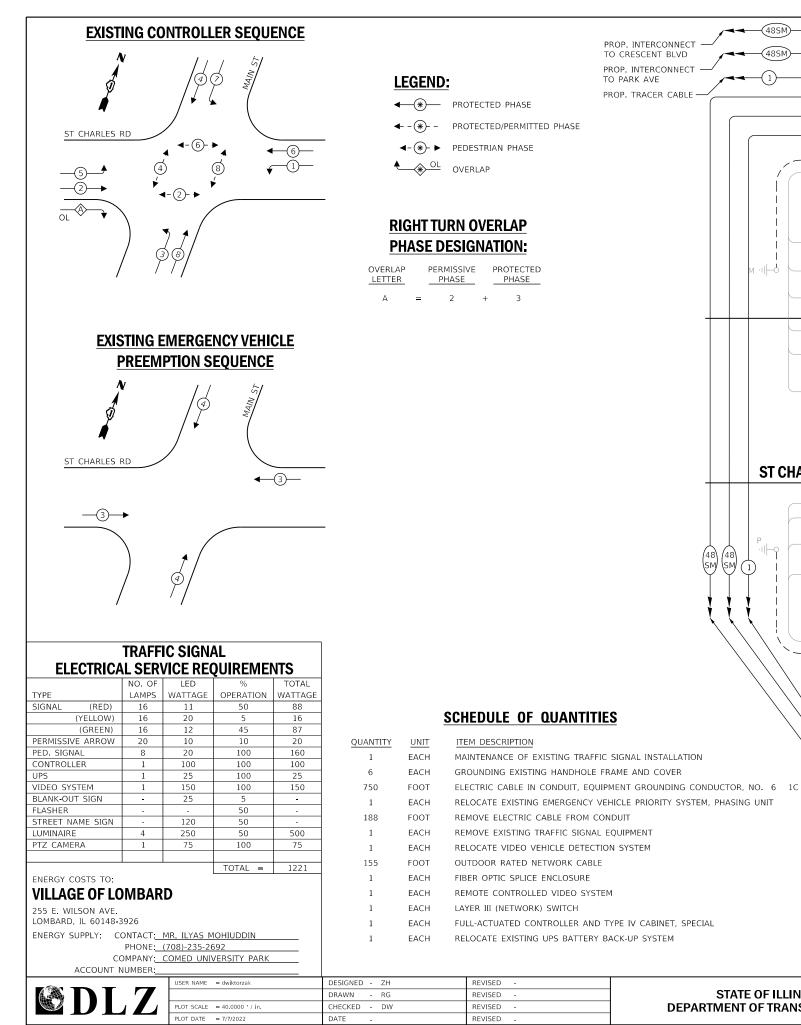

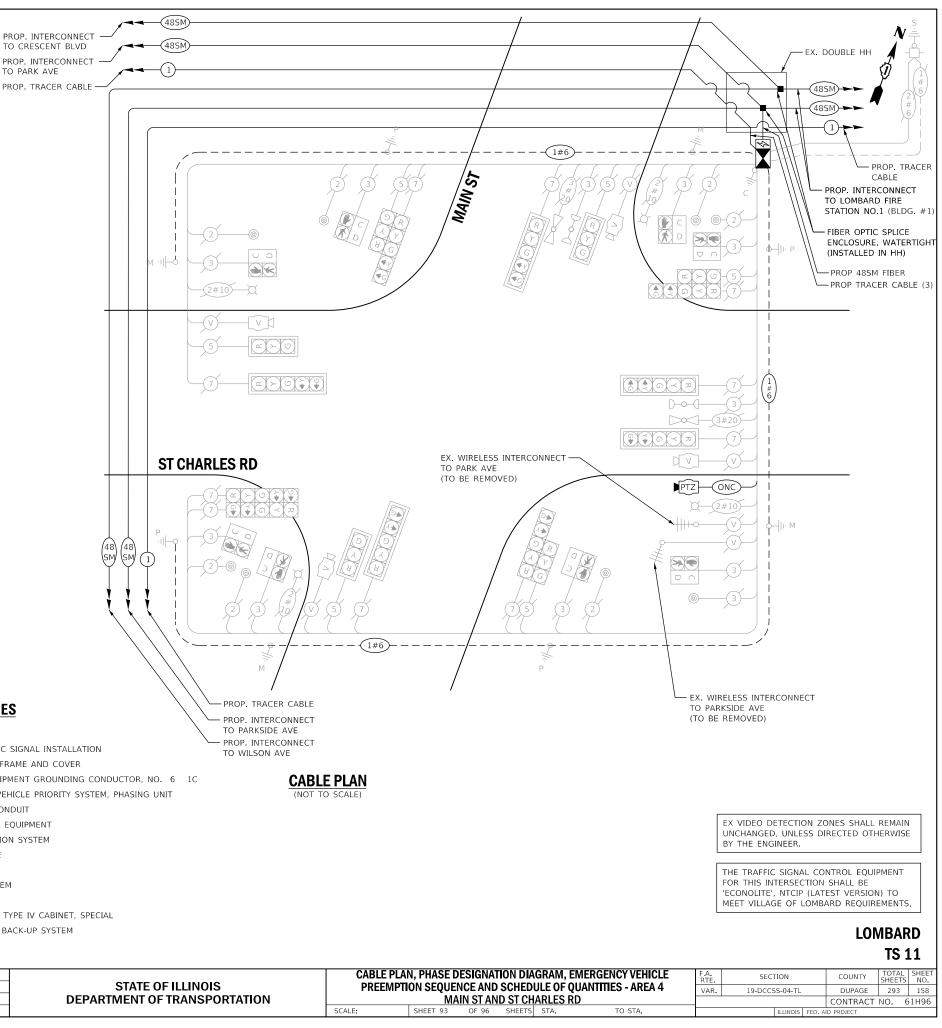

FILE NAME = X\Projects\2021\2182\217400 DuPage DOT Central\CADD_Sheets\sht-4B-Main-ts-Cable.dgr Int 103

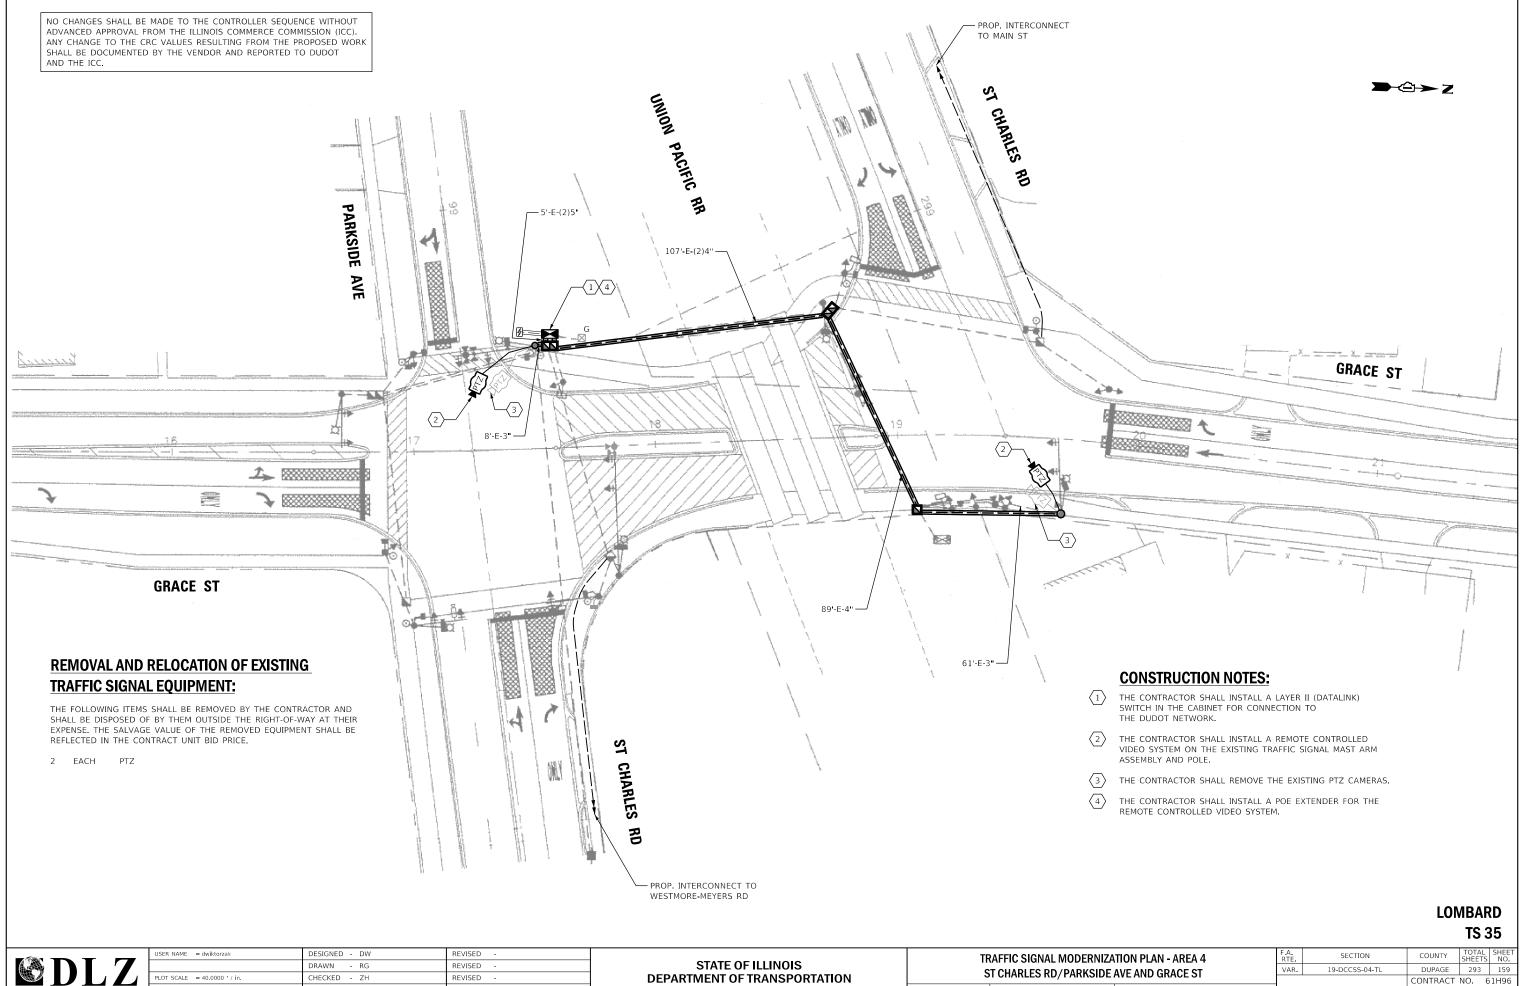

FILE NAME Int 102 X:\Projects\2021\2182\217400 DuPage DOT Central\CADD_Sheets\sht-4H-St Charles-ts-plan.dgr


PLOT DATE = 6/12/2022

DATE

REVISED

SCALE: 1"=20' SHEET 94 OF 96 SHEET

ZA	TION PLA	N - AREA 4	F.A. RTE	SECT	FION		COUNTY	TOTAL SHEETS	SHEET NO.
E /		GRACE ST	VAR.	19-DCCS	5S-04-TL		DUPAGE	293	159
							CONTRACT	NO. 6	1H96
TS	STA.	TO STA.			ILLINOIS	FED, A	ID PROJECT		

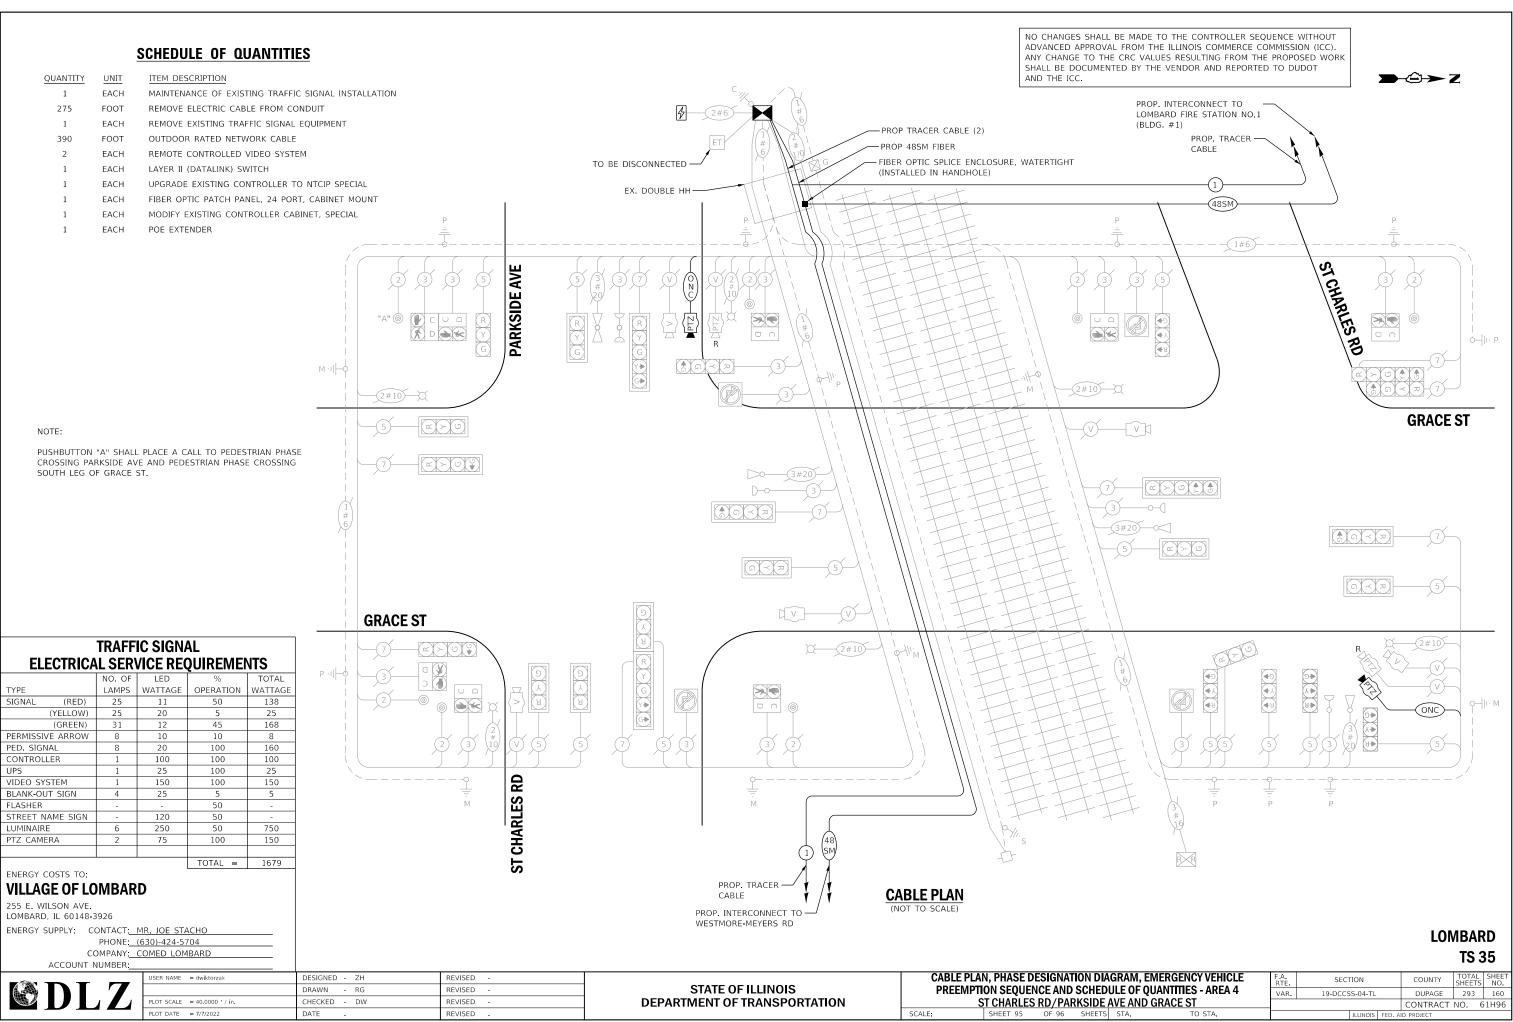

FILE NAME = X\Projects\2021\2182\217400 DuPage DOT Central\CADD_Sheets\sht-4H-St Charles-ts-Cable.dgn Int 102

.

														-				PREEMPTOR NUMBER 2				
ROM NORMAL SEQUENCE INTERVAL NO.			4	1	0	1	5	1	9	\geq	\leq	2	\leq		\leq	\geq	-					
ROM E.V. PREEMPT SEQUENCE INT. NO.		18	Ř	10	Se l	15	16	TH	11	1K	11	1M	1N	1P]	10	1R I	, 1S	- 2	3	4	5	CLEAR TO
R PREEMPT SEQUENCE INTERVAL NO. HANGE TO R.R. PREEMPT SEQUENCE NO.	18	2	2	1E	2	1G	2	11	2	1L	2	1N	2	10	2	15	2	3	4	5		NORM. SEC
//8 ST, CHARLES ROAD - NEAR RIGHT AND		· · · ·	8												_							~
AR RIGHT MAST ARM MOUNTED SIGNALS	Y	R	Ŷ>	R	R	R	R	R	R	Y	R	R	R	R	R	R	R	R	R	R	G	
VB ST. CHARLES ROAD + FAR LEFT POST AND																						~
	Y	Ŕ	R	R	R	R	8	R	R	Y	R	8	R	R	R	R	R	Ŕ	R	R	G	\bigtriangleup
ND MAST ARM MOUNTED SIGNALS					****																	^
/B PARKSIDE AVENUE - ALL SIGNALS	Y	R	R	R	R	R	R	R	R	Y	R	R	R	R	R	R	R	R	R	Ŕ	G	\bigtriangleup
B GRACE STREET - FAR LEFT POST AND				~		-	R	Y	R	8	R	R	R	R	R	Y	R	R	R	R	R	\wedge
ND MAST ARM MOUNTED SIGNALS	R	R	R	R	R	R	к	T	ĸ	ĸ	~	ĸ	`	`	r,			'n	<u>^</u>	<u> </u>	n	<u> </u>
B GRACE STREET - FAR RIGHT			_	_	-				_	_		-		R	R	Y	R	R	B	R	R	\wedge
AST ARM MOUNTED SIGNAL	R	R	R	R	R	R	R	Y	R	R	R	R	R	к	к	ĩ	к	к	ĸ	^	ĸ	\bigtriangleup
VE GRACE STREET (NORTH OF TRACKS) - FAR LEFT	G	G	G					G	G	G	G					G	G	G				\wedge
OST AND END MAST ARM MOUNTED SIGNALS	<g< td=""><td>-©</td><td><g< td=""><td>R</td><td>R</td><td>R</td><td>R</td><td>ŝ</td><td>×G</td><td>Ś</td><td><Ğ</td><td>R</td><td>R</td><td>R</td><td>R</td><td><Ğ</td><td><g< td=""><td><Ğ</td><td>Y</td><td>R</td><td>R</td><td>\bigtriangleup</td></g<></td></g<></td></g<>	-©	<g< td=""><td>R</td><td>R</td><td>R</td><td>R</td><td>ŝ</td><td>×G</td><td>Ś</td><td><Ğ</td><td>R</td><td>R</td><td>R</td><td>R</td><td><Ğ</td><td><g< td=""><td><Ğ</td><td>Y</td><td>R</td><td>R</td><td>\bigtriangleup</td></g<></td></g<>	R	R	R	R	ŝ	×G	Ś	<Ğ	R	R	R	R	<Ğ	<g< td=""><td><Ğ</td><td>Y</td><td>R</td><td>R</td><td>\bigtriangleup</td></g<>	<Ğ	Y	R	R	$ \bigtriangleup $
UB GRACE STREET (NORTH OF TRACKS) - FAR	1	G																				\wedge
IGHT MAST ARM MOUNTED SIGNAL	G	-G	G	R	R	8	R	Ģ	G	G	G	R	R	R	R	G	G	G	Ŷ	R	R	
28 ST, CHARLES ROAD - NEAR RIGHT, FAR RIGHT, AND	+																					~
	R>	R>	Y>	Y>	R>	R>	R>	R>	R>	R>	R>	1 22	R>	R>	₽⊳	R>	R>	R>	R>	R>	R>	Δ
ENTER FAR RIGHT POST SIGNALS												<u> </u>									h	^
B ST. CHARLES ROAD - FAR LEFT AND	<r< td=""><td><r< td=""><td>≺R</td><td><y :<="" td=""><td><r< td=""><td><r< td=""><td><r< td=""><td>≺R</td><td><r< td=""><td><r< td=""><td>`<r< td=""><td><y< td=""><td><r< td=""><td><r< td=""><td><r td="" <=""><td><r< td=""><td>≺R</td><td><r< td=""><td><r< td=""><td>KR:</td><td><g< td=""><td>\square</td></g<></td></r<></td></r<></td></r<></td></r></td></r<></td></r<></td></y<></td></r<></td></r<></td></r<></td></r<></td></r<></td></r<></td></y></td></r<></td></r<>	<r< td=""><td>≺R</td><td><y :<="" td=""><td><r< td=""><td><r< td=""><td><r< td=""><td>≺R</td><td><r< td=""><td><r< td=""><td>`<r< td=""><td><y< td=""><td><r< td=""><td><r< td=""><td><r td="" <=""><td><r< td=""><td>≺R</td><td><r< td=""><td><r< td=""><td>KR:</td><td><g< td=""><td>\square</td></g<></td></r<></td></r<></td></r<></td></r></td></r<></td></r<></td></y<></td></r<></td></r<></td></r<></td></r<></td></r<></td></r<></td></y></td></r<>	≺R	<y :<="" td=""><td><r< td=""><td><r< td=""><td><r< td=""><td>≺R</td><td><r< td=""><td><r< td=""><td>`<r< td=""><td><y< td=""><td><r< td=""><td><r< td=""><td><r td="" <=""><td><r< td=""><td>≺R</td><td><r< td=""><td><r< td=""><td>KR:</td><td><g< td=""><td>\square</td></g<></td></r<></td></r<></td></r<></td></r></td></r<></td></r<></td></y<></td></r<></td></r<></td></r<></td></r<></td></r<></td></r<></td></y>	<r< td=""><td><r< td=""><td><r< td=""><td>≺R</td><td><r< td=""><td><r< td=""><td>`<r< td=""><td><y< td=""><td><r< td=""><td><r< td=""><td><r td="" <=""><td><r< td=""><td>≺R</td><td><r< td=""><td><r< td=""><td>KR:</td><td><g< td=""><td>\square</td></g<></td></r<></td></r<></td></r<></td></r></td></r<></td></r<></td></y<></td></r<></td></r<></td></r<></td></r<></td></r<></td></r<>	<r< td=""><td><r< td=""><td>≺R</td><td><r< td=""><td><r< td=""><td>`<r< td=""><td><y< td=""><td><r< td=""><td><r< td=""><td><r td="" <=""><td><r< td=""><td>≺R</td><td><r< td=""><td><r< td=""><td>KR:</td><td><g< td=""><td>\square</td></g<></td></r<></td></r<></td></r<></td></r></td></r<></td></r<></td></y<></td></r<></td></r<></td></r<></td></r<></td></r<>	<r< td=""><td>≺R</td><td><r< td=""><td><r< td=""><td>`<r< td=""><td><y< td=""><td><r< td=""><td><r< td=""><td><r td="" <=""><td><r< td=""><td>≺R</td><td><r< td=""><td><r< td=""><td>KR:</td><td><g< td=""><td>\square</td></g<></td></r<></td></r<></td></r<></td></r></td></r<></td></r<></td></y<></td></r<></td></r<></td></r<></td></r<>	≺R	<r< td=""><td><r< td=""><td>`<r< td=""><td><y< td=""><td><r< td=""><td><r< td=""><td><r td="" <=""><td><r< td=""><td>≺R</td><td><r< td=""><td><r< td=""><td>KR:</td><td><g< td=""><td>\square</td></g<></td></r<></td></r<></td></r<></td></r></td></r<></td></r<></td></y<></td></r<></td></r<></td></r<>	<r< td=""><td>`<r< td=""><td><y< td=""><td><r< td=""><td><r< td=""><td><r td="" <=""><td><r< td=""><td>≺R</td><td><r< td=""><td><r< td=""><td>KR:</td><td><g< td=""><td>\square</td></g<></td></r<></td></r<></td></r<></td></r></td></r<></td></r<></td></y<></td></r<></td></r<>	` <r< td=""><td><y< td=""><td><r< td=""><td><r< td=""><td><r td="" <=""><td><r< td=""><td>≺R</td><td><r< td=""><td><r< td=""><td>KR:</td><td><g< td=""><td>\square</td></g<></td></r<></td></r<></td></r<></td></r></td></r<></td></r<></td></y<></td></r<>	<y< td=""><td><r< td=""><td><r< td=""><td><r td="" <=""><td><r< td=""><td>≺R</td><td><r< td=""><td><r< td=""><td>KR:</td><td><g< td=""><td>\square</td></g<></td></r<></td></r<></td></r<></td></r></td></r<></td></r<></td></y<>	<r< td=""><td><r< td=""><td><r td="" <=""><td><r< td=""><td>≺R</td><td><r< td=""><td><r< td=""><td>KR:</td><td><g< td=""><td>\square</td></g<></td></r<></td></r<></td></r<></td></r></td></r<></td></r<>	<r< td=""><td><r td="" <=""><td><r< td=""><td>≺R</td><td><r< td=""><td><r< td=""><td>KR:</td><td><g< td=""><td>\square</td></g<></td></r<></td></r<></td></r<></td></r></td></r<>	<r td="" <=""><td><r< td=""><td>≺R</td><td><r< td=""><td><r< td=""><td>KR:</td><td><g< td=""><td>\square</td></g<></td></r<></td></r<></td></r<></td></r>	<r< td=""><td>≺R</td><td><r< td=""><td><r< td=""><td>KR:</td><td><g< td=""><td>\square</td></g<></td></r<></td></r<></td></r<>	≺R	<r< td=""><td><r< td=""><td>KR:</td><td><g< td=""><td>\square</td></g<></td></r<></td></r<>	<r< td=""><td>KR:</td><td><g< td=""><td>\square</td></g<></td></r<>	KR:	<g< td=""><td>\square</td></g<>	\square
ENTER FAR LEFT POST SIGNALS	+			<u> </u>					<u> </u>			<u>+</u>		I							R	
VB GRACE STREET - NEAR RIGHT POST AND	R	R	R	R	R	Y	R	R	8	R	R	R Y>	R	Y	R	R	R	R	R	R	ŝ	\square
AR RIGHT MAST ARM MOUNTED SIGNALS				ļ			<u> </u>					ļ										
VB GRACE STREET - FAR LEFT POST AND	R	R	R	R	R	Y Y	R	R	R	R	R	R	R	Ŷ	R	R	R	R	8	f R	R	
IND MAST ARM MOUNTED SIGNALS	. 			ļ						Į		<u> </u>								<u> </u>		~
VB GRACE STREET (SOUTH OF TRACKS) - FAR LEFT	8	R	G S	G ≪G	G KG	G KG	G ≺G	R	R	R	8	G	6	G G	e S	R	R	G ≼G	Y	R	R	\square
POST AND END MAST ARM MOUNTED SKSNALS	<u>_</u>	ļ	~~	<u> </u>			~~~	ļ		 	<u> </u>	<u> </u>					}				<u> </u>	
VB GRACE STREET (SOUTH OF TRACKS) - FAR	R	R	G	G	G	G	G	R	R	R	R	G	G	G	G	R	R	G	Y	R	R	$ \wedge$
RIGHT MAST ARM MOUNTED SIGNAL		ļ	ļ	ļ				Ļ	ļ	ļ	ļ	ļ	L	ļ		ļ				<u> </u>	<u> </u>	
78 & W/8 ST. CHARLES ROAD INTERNALLY	NRT	NRT	NRT	NRT	NRT	NRT	NRT	NRT	NRT	NRT	NRT	NRT	NRT	NRT	NRT	NRT	NRT	NRT	NRT	NRT	NRT	$ \land $
LLUMINATED FIBER OPTIC SIGN - NO RIGHT TURN										L		L	1	ļ		ļ	ļ		<u> </u>	ļ	ļ	
78 PARKSIDE AVENUE INTERNALLY	NET	NLT	NLT	NLT	NLT	NI.T	NLT	NLT	NLT	NLT	NUT	NLT	NLT	NLT	NLT	NLT	NLT	NLT	NLT	NLT	NLT	$ \land $
LUMINATED FIBER OPTIC SIGN - NO LEFT TURN				L			L	L	.	L	ļ	_	ļ	ļ	ļ		.		<u> </u>			
EDESTRIAN SIGNALS CROSSING	*FL	DW	DW	DW	DW	DW	DW	DW	DW	DW	DW.	DW	DW	ow	DW	ow	DW	ow	0W	DW	DW	\wedge
SRACE STREET, SOUTH LEG. SOUTH OF TRACKS	DW	·	l	<u> </u>		Ľ			<u> </u>			<u> </u>			-				L	ļ	ļ	<u>_</u>
PEDESTRIAN SIGNALS CROSSING	DW	DW.	*FL	*FL	DW	*FL	ow	DW	DW	DW	DW	ow	DW	DW	DW	DW	DW	ow	DW	DW	DW	
PARKSIDE AVENUE, WEST LEG, SOUTH OF TRACKS	10"		DW	pw		DW	Ŭ	<u> </u>					1			<u> </u>			L	ļ		<u> </u>
EDESTRIAN SIGNALS CROSSING	ow	ΰw	DW	DW	DW	DW	DW	*FL	DW	OW	DW	DW.	DW	DW	DW	DW	l ow	DW	DW	DW	wa	\wedge
ST. CHARLES ROAD, EAST LEG, SOUTH OF TRACKS	100	0	L."	1.1	10.0	<u> </u>		DW	100	L	1	1		<u> </u>	1	Ľ	L		L	ļ	L	
PEDESTRIAN SIGNALS CROSSING		-		-	DW	*FL	DW	DW	mu	DW	DW	DW	ow	DW	DW	DW	ow	DW	0W	DW	DW.	DARK
ST. CHARLES ROAD, WEST LEG, NORTH OF TRACKS	DW	DW	DW	DW	101	DW	DW	100	DW	1‴	j	100	1044	1	1011	1	1		0.0			ă
			d=1.0.00				dommon:	dessentes	decembring to		-		descention:								н	[
																					0	

FLASHING DON'T WALK' IS TO TERMINATE AT THE COMPLETION	
OF THE PEDESTRIAN CLEARANCE INTERVAL.	

W * WALK

**

. FLASHING DON'T WALK

* TO APPEAR ONLY UPON PUSH-BUTTON ACTUATION

- FL DW ĐW . DON'T WALK
- 🕅 NRT
- 🗭 NLT
- DARK . NO DISPLAY

PHASE "B" SHALL BE PLACED ON RECALL

														PR	OPC	DSE	DSE	QUE	INC	EOF	OP	ERA	TIO	4																				
MOVEMENT N	1			_ <u>+</u>				•	t							-	<u>, </u>						+	t		1444444		+	_] L	.	-	4 4	,	-			*		-		HHHH		1+	
SHACE	1		1				~~~~~	********					3									1					3									L			T		5	5		1 5
NTERVA	1	12	1 34	30	-	1 1	64	195	6C	60	24	70 1	Tor	101	-	30	ec	50	34	90	KC	10	30	+1	124	179	I I AC	38 13	130	1 144	142	15	15	17.4	173	170	170	154	140	10	20	23A	218	×
Change To.	V	V	1	2	V	V		:			,.d.,	4				:				, ,			A	1				5 00 1	*****		:	/	/		30	< 1		2		1	/	10		
WE ST, CHARLES POAD - NEAR RIGHT AND	4	0	Y a	R	RG	R	R	R	R	8	R	8	R	R	8	R	R	R	Ra	R	R	RGA	R	*	R	R	R	RR	R	R	R	R	8	R	8	R	R	R	R	R	R	R	R	R
WE ST. CHARLES ROAD - FAR LEFT POST AND		+	+		1	+										-							+	-+			÷		+-	+							+	t						1-
END MAST ARM NOUNTED SIGNALS	G	G	Y	R	R	R	R	R	R	R	R	R	R	R	R	2	R	8	R	R	R	R	R	R	R	R	8	RR	R	R	R	R	R	R	R	R	R	R	R	8	R	R	R	R
EB PARKSIDE AVENUE - ALL SADNALS	6	6	Y	R	R	R	8	R	R	R	8	8	8	8	R	R	9	R	R	R	R	R	8	R	R	R	R	RR	R	R	R	R	R	R	R	R	R	R	R	R	R	R	R	R
NO GRACE STREET -FAR LEFT POST AND	R	R	R	R	R	R	R	R	R	R	R	R	R	R	R	8	R	fi .	R	R	R	R	R	R	R	R	R	RR	R	R	R	R	R	R	R	R	R	R	8	00	80	¥	R	R
END MAST ARK MOUNTED SIGNALS		· · ·	+		 		<u> </u>					-+-																	-	-								·+					-	ļ
us grace street - far right Agt arminounted signal	R	R	R	R	R	R	R.	R	R	R	R	R	8	R	R	R	R	R	R	R	8	R	R	R	R	R	8	RA	R	8	R	8	R	R	R	8	R	R	R	G	G	Y	R	P
IB GRACE STREET (NORTH OF TRACKS) - FAR LEFT OST AND END MAST ARM MOUNTED SIGNALS-	80	80	90		40	0	90	50	۲	R		90	Y	R	40	40	åo	30	90	60	30	99	R	8	R	R	R	RR	R	R	R	R	8	R	R	8	R	R	R	00	90	80	80	R
IB GRACE STREET (NORTH OF TRACKS) - FAR	1	1		G	-	1.		G	~	R	-	-	¥	R		0					_	0	P	8	8	*	8	8 8	R	1 6	R	8	B	R	R	R	R		8		6	G	G	1.
SCHT MAST ARM MOUNTED SIGNAL	Ģ	G	c	6	0	0	¢	6	Y	R	0	6	*	8	•	•	G	0	G	0	a	° ;	* 1	R	* [*	×	× ×	K	×		*	R	*	ĸ		ĸ	. "	×		°	G	c	1 *
AS ST. CHARLES ROAD - NEAR ROUHT, FAR ROUHT, AND	8>	-	RÞ	-	0	0.	0	4	0	a.	Y=	R*	R	-	Y=	82	*	R	Yr	R#,	-	R	0	0	n	P	n 1	2+ R	8	Y=	Ro	R.	80	8.	RÞ	*	R	R	R	R.	R	R>	R	Ro
A ST. CHARLES ROAD - FAR LEFT AND	1	1 -	1	-	48			-1	-	-	-8			-	-12		-8	-8	47	•8	-	-		+0		-		6 4		44	-	-	-	48	*	-8	-18	<r< td=""><td>-</td><td>48</td><td><r i<="" td=""><td></td><td>R</td><td>-2</td></r></td></r<>	-	48	<r i<="" td=""><td></td><td>R</td><td>-2</td></r>		R	-2
CENTER FAR LEFT POST SKANALS	148	1 48	-1	2	**	*8	**	-98	*	*	*8	-	*	4	-22	-52	*8	- 48	-44	eR	- 82	٩R .	*6	10	**	-	· · ·	6 4	1 4	44	~	-94	~	48	માન :	**	<r td="" <=""><td>42</td><td>-</td><td>48</td><td><r td="" <=""><td>4R</td><td>R</td><td>*8</td></r></td></r>	42	-	48	<r td="" <=""><td>4R</td><td>R</td><td>*8</td></r>	4R	R	*8
SIS GRACE STREET - NEAR RIGHT POST AND FAR RIGHT WAST ARM MOUNTED SIGNALS	R	R	R	R	R	R	R	R	R	R	R	R	R	R	R	R	R	R	R	R	R	R	RA	Ra	RG		R	RR	R	R	8	0	G	۲	Ŕ	R	R	۲.	R	R		R	R	R
SA GRACE STREET . PAR LEFT POST AND	P	8	10	10		-	0	8	P		8			R	R	8	R		.8	R	R		8		al	8		RER	18	R	8	6	6	*	8		8	-		R	8	R		1.
SNO MAST ARM MOUNTED SKINALS	1 *	. *	. "	1 *	1	I.M.		X	ĸ	-	~]	~	1	- 1	"	*		*	×	-	~			-	-	<u>^</u>	2		1 "	1	-	~	-	1	-	-	~	i. I	1	-	_	-	R	
STO GRACE STREET (SOUTH OF TRACKS) - FAR LEFT	R	R	R	1.0	0	4	40	30	6	90	90	0	0	G	4	0	Y	R	00	0 0	Y		80	0	0	c	9	9 y	R	0	0	0	0	0	0	Y	R	0	0	8	8	R	8	R
POST AND END MAST ARM MOUNTED SICHWUS	1	1 "	1	1	1	1 -5	*5	10	-	-0	~	-0	-6	*6	-	46			-	-5		-	-0	-	-0	-5	s -	C Y	1	1 .0	•6	-	*0	*3	-0			10	-0					1
sig grace street (south of tracks) - far	8	R	R	8	G	0	G	a	6	0	0	0	0	0	0	G	Y	R	a	G	Y	R	6	0	0	4	a 1	aly	R	6	0	0	6	6	0	Y	R	0	G	R	R	8	8	
BENT MAST ARM MOUNTED SIGNAL	1	1	1	1	1	1	-		-		1	_	_	-					-	_			_	-	-	-	_	-	1	1		-	-							-				
UB & W/B ST, CHARLES ROAD INTERNALLY LUIMMATED FIBER OFTIC SION - NO RIGHT TURN	24	Q.A.	222	24	94	ant	24	0104	204	24	ta l	244	234	24	24	an	and .	24	Org.	0434	anot	2404	94	ava 1	244	200 10	en 9	4 942	1 20	1º54	24	CHA	Drat 1	org.	24	040	01.04	2484	era	24	aut	ere	Care.	24
EA PARKSIDE AVENUE WTERNALLY	NIT	NAT	3		NUT	HLT	NLT	HLT			NLT	NT	NT			HLY	NLT	NLT	N.T	NLT	HLY	N.T		NAT	NAT	4.T N	AT N	LT NL	TNLT	NLT	NLT	NUT	-	NT	HAT	MT	HLT .	NLT	NO.T	NET	HLT	NLT	NL7	NT
ELUMINATED FIBER OFTIC SIGN - NO LEFT TURN	1	L				+							-+																-	+					-				\rightarrow					1
edestran signals crossing Brace Street, south leg, south of tracks	*	DW		ow	w	OW	-	DW	DW	OW 1	047		DWI	OW .	DW	DW	-	OW	OW	DW	OW	OW .	ow	OW	wo	ow a	** 0	** 04	1 000	0W	OW	CW	-	-	044	DW	CNV	ONY	w	OW	DW	OW		
EDESTREAN SIGNALS GROSSING WRISSDE AVENUE, WEST LEO, SOUTH OF TRACKS	OW	DW	OW	OW	~	TR. DW	OW	DW	DW	DW	DW	DW	DW	DW	DW	W	DW	OW	Der	OW	OW	DW		TTL OW	OW	DW C	~ 0		N DW	DW	DW	*	THL OW	044	-	OW	OW	OW	DW	OW	ON	DW	0w	0
PEDESTRIAN SIGNALS CROSSING	DW	DW	OW	DW	OW		OW	DW	DW.	DW .	ON	DW	OW	OW	OW	DW	OW	OW	DW	DW	DW	DW			ow	ow to		NY ON	V DW	OW	OW	DW		ow	DW	DW	DW	OW	DW	~	-72	DW	OW	RX
ST. CHARLES ROAD, EAST LEG, SOUTH OF TRACKS PEDESTRIAN SIGNALS CROSSING	DW	DNY	Ow	DW	ow	10w	OW	04	DW	OW	DW	CW	OW	DW	OW	DW	DW	04/	ow	DW	DW	ow	DW	DW	OW	Dw to	~ 0	NV OV	1 04	DW	OW	~	-72	DW	DW	OW	OW	OW	owl	DW	DW	ONY	DW	
ST. GHARLES ROAD, WEST LEG. NORTH OF TRADIS	1	1	1	1		1	1	-		1	1		_	-			_		_					_					_	1			ow											1

													PF	OPC	DSEC	EM	ERG	ENC	Y VE	HIC	E P	REE	MPT	ION S	SEQU	JENC	EOF	OP	ERAT	ION																						OR PREDAP			
FROM NORMAL SEQUENCE INTERVAL NO.	1			1		1	1	1	T		4		T			•		1		4			1		4		1 10	1	10			10	2		15		15			1	15	T TP		19			17								
E.V. PREEMPT SEQUENCE INTERVAL NO.	14	10 1	IC 1	0 1	tÉ	sf y	G ti	NIL	1 18	11	HE	58	1P	10	TR	5 1	T n	1 11	1 1X	11	17	144	100	100	100 1	8E 1F	F 100	11484	1.1	1XX	TLL 10	-	N 195	100	1RR	135 5	TT IN	1 1000	100	try	322 TA	MA. 188	8 1000	1000	1EEE	1.575 1	GGO SHE	91 14	1100K	2	2	1		5	CLEAR TO
CHANNEE TO E.V. PREEMPT SECUENCE NO.	2	tc	10 1	1	15 3	04 1	N 1	3 5	5 TL	. 1 784	111	1 10	2	tR	15	r 1	v 3	1X	tY	NZ.	144	+	100	100	186 1	FF 5	3	1.11	SKOK .	4	1	NN IP	P 100	2 205	4	177 5	N m	1000	2015	122	tAAA :	0 5	10000	152.6	7	1000 1	14441 1.11	11 1100	K Jord					,	KORM. SEC
WIT ST. CHARLES ROAD - NEAR RIGHT AND	G	a			. 1				R	R	R	R	R	R	R			8	R	10		0	R	8				0	0					P					1.				1.	1.0				1.	0	ė	1 .		T,		\sim
FAR RIGHT MAST ARM MOUNTED DONALS	<u> </u>	-					<u> </u>		0	0	0	6>	\$	0	*	1.		6	10	1	1.	1 "	G*	70	<u></u>	<u> </u>	-	1							1			1	1	1 1	<u> </u>		1 "	1	<u> </u>						1			<u> </u>	\sim
WID ST. CHARLES ROAD - FAR LEFT POST AND	6	4								10				0	0							0	p	0		0 0	R					0 0		0						0									8				1 1		1
END MAST ARM MOUNTED SIGNALS						<u> </u>	1		1	1	1.	1 1	-	_	-			1	<u> </u>	1.	1 .	1						1					1					1	1				1.	1	1			1						<u> </u>	V
er particide avenue - all signals	0	4	Y	R	8	R	3 ,		R	R	P	R	R	R	R	RA	R	R	R	R	R	R	R		R	RR	8	R	R	R	R	RR	R	R	R	8	R	8	R	R	R	RR	*	R	R	R	RR	R	R	¢	R	8		R	\Diamond
NO ORACE STREET - FAR LEFT POST AND END MAST ASMINICUNTED SIGNALS	8	R	8 1	R	R	RF	2 5	R R	R	R	R	R	R	R	R	RR	R	R	R	R	R	8	R	8	R	RR	R	R	R	R	R	RR	R	R	8	R	R	R	A	8	R	RG	0	Y	R	6	YR	A 5	R	R	R	R	9	0	$\overline{\Delta}$
END MAST ARM MOUNTED SIGNALS								-+				++						-										+					-	- 	 	-+-		÷	+	łł				+					+						
NOS GRACE STREET - FAR RICHT	R	8	RJ	RII	R	R	2 4	A IS	8	R	R	R	R	8	R	a s	8	R	1 8	R	R	R	R	R	R 1	RR	8	R	R	R	R	RR	R	R	8	R	RR	R	R	R	RI	RG	G	Y	R	0	YR	R	R	R	8	8		۵.	$\langle \rangle$
NO GRACE STREET (NORTH OF TRACKS) - FAR LEFT		0	a 1 4		-	-+	-	-		+	-	+			-+-					+			6			6 6		+	++			-+-	+	+	tt-			+	+	++		+-		+			=	-			+			+	~~~~~
POST AND END MAST ARM NOLATED SIGNALS	00			0	*	R .		40 0	40				40		-0	3 Y	R	4	30		Y	R			· ·			R	8	R	R	RR	R	R	R	R	R	8	R	R	RI	R 40	80	00	3		808		R	\$0	R	R	~	6	\Diamond
N'S GRACE STREET (NORTH OF TRACKS) - FAR RECHT MAST ARM MOUNTED SIGNAL	G	G	9	9	۲	R		3 6	0	0	G	c	•	0	¢	3 9	R	0	0	0	Y	8	G		6 1	G G	R	R	R	R	R	RR	R	*	R	R	2 8	R		R	A 1	R G	Ģ	G	G	0	G G	3 Y	8	G	R	R	6	9	\Diamond
EIS ST. CHARLES ROAD - HEAR RICHT, FAR RICHT, AND CENTER FAR RICHT POET SIGNALS	Rt	R	R» F		.,	> R	• R	R	. 0	• m	8.	Ro	Ro	G .	0 0	. a	> 0		1	10	RH	R=	an	Y+	Rt F	* *	. 00	04	12	R>	G= 1	AR	R>	R	*	R> 6	R.	-	8.	Ro	R. P		R.+	R	R>	*	80 R.	-	-	R	0.	R	1	R	\Diamond
LE ST. CHARLES ROAD . FAR LEFT AND		+					+					++							-	-		+		+				+	+										-	++				1	+						+				-×
CENTER FAR LEFT POST SCHALS	æ	48	8 4	8 .	8 .	8	8 4	8 3	R 4	1 18	*R	48		R	-R -	RIT	8 4	-	R	R	4	1 2	-R	-	- 8	RA	40	10	-*	-	-	1	49	*	-8		8 4	-R	1	1R	-8 -	R 48	-		4	4	** *	1 48	1 12	18		R	F	R	$\langle \rangle$
STO GRACE STREET . NEAR RIGHT POST AND							-+					++							+					-+			R	R	R	0	R	P		+						1					+				1						Ň
TAR PROHT WAST ASM MOUNTED SIGNALS	8	R	R	R	R	9 1	R S	1 1	R	R	R	R	R	R	R	a s	R	R	R	R	R	R	R	8	R	8 8	G	10	a l	0		R	8	R	•	9	8	R	R	0	× 1 /	RR	R	P	R	8	RR	8 8	R	R	R	G	P	R	\bigtriangledown
ST GRACE STREET - FAR LEFT POST AND		0							-			11							1	-							-	1	1		-		10	1				-	1	1			1	1				1.			1			-	X
END WAST AND WOUNTED SIGNALS	R	R	R	R 1	R	R S	2 1	R I R	1 8	8	R	R	R	8	8	8	8	R	R	R	R	R	R	R	R	R	1 *	8	R	R	R	8 8	R	8	9	G	R	R	1 8	0	1	RR	R	R	8	8	RR	R	R	R	R	0	1 "	*	\sim
SIS GRACE STREET (SOUTH OF TRACKS) - FAR LEFT		P	-	-	-		-		-	T c	1 c	1		-	a	0 0	da	10	10	G	6	a	G	01	0		6	G	0	G	GI	0 0		1	0	0 1	1 9		+	G	6 1	0		1.				-	1		G	G			X
POST AND END WAST ARM MOUNTED SIGNALS	*]	R	R /	R [1	R	R		1 8	0	1 40	-0	1 1		-		0 4		10	+0	-0	•6	+0		*6	-0	Y N	-6	-0	1			G 4		1 R	-0	- 0	6 .	T	R	-	-6 -	G R	R		R	R	RR	+	R	8	. 4	-		۴ (V
S'B GRACE STREET (SOUTH OF TRACKS) - FAR	R	R	R	R	R	8 1		R		6	1 0	Y	8		0	3 0	10	10	0	G	G	G	0	4		YR	10	10	6	6	G .	0 0	TY	8	6			1 v	R	6	6 0		R	R	B	R 1	RIP	R	8	R	6	0	T ,		0
RIGHT MAST ARM MOUNTED SIGNAL		-	_		_	_	_	_	_	-	1	1	_				_		_	1	_				-		-	-			_		-	1			-	-				_	-	1		_						-			<u></u>
EG & W/B ST. CHARLES ROAD INTERNALLY ILLUMINATED FIDER OPTIC SIGN - HO RIGHT TURN	0.84	Cray 0.	10 20	4 9	4 9	64 20	4 94	4 04	4 94	4 94.94	ant.	24	234	244 0	14 9	4 94	4 94	1 200		ant	0.04	erat	24	Stal C	104 34	24 240	924	022	org	G. 84	24 4	24 94	+ 020	Qua.	344	24 9	2 23	24	24	223	014 9	St 949	244	era	94	014	54 014	4 049	244	DARK	OWER	ONO	C DW	wex	\diamond
EAR PARYSIDE AVENUE INTERNALLY ILLUMINATED FIBER OPTIC SIGN - NO LEFT TURN	NLT	NET	RT N	TN	RT H	LT N	TH	-	.7 14.1	-	NLT	NET	HÍ	HET P	NET	17 14	7 12	TNUT	NET	NET	NLT	NAT	HET	NT I	NT N	17 H	T NLT	NT	NT	NLT	AT N	LT NL	7 18.1	NUT	NT	NLT N	17 14.1	NT	NLT	NT	NLT N	LT MI	NET	NT	NT	NLY I	NET NET	T NET	NLT	HLT	14.7	HLT	N	LT	\Diamond
	-	m		-	-	-	2		-	-	-	1-1						-	-	1	1	-					-	1	1					-			-	-	1	1			1	1		_		-			1		-		X
GRACE STREET, SOUTH LEG, SOUTH OF YRACKS		DW		* 0	w, c	W D	~ ~	~ 0	* 0	WO W	DW	DW					-	-	CW	OW	DW	DW	OW	040	DW D			1		DW		~ ~	N ON	DW			-		1	04			-	-	OW			w ow	CNY	DW:	DW .	OW	09	*	V
EDESTRIAN SIGNALS CROSSING	OW .	ON	w	-	~	~ 0	* 0	w DV	N DA	- ow	ON	OW	OW	THE CON IS	ow to	-	-	V OW	OW	OW	DW	0W	TR.	DW	0 00		OW	OW	DW	OW	TL C	~ ~	-	OW	DW	W O	* 04	DW	DW	OW	DW D	-	-	OW	OW	-	DW DW	w ow	OW	DW	DW	DW	0	~	\Diamond
						-					-	1.1						-	+	1	1	1					-		1		-		-	1			~~~~			++		-		1		72			1		1				X
ST. CHARLES ROAD, EAST LEG. SOUTH OF TRACKS	OW .			* 0	2 1	* 0	~ ~	N DN	~ 04	V DW	OW	-	DW	-				V ON	-	-					_	** 0*						w ov	V .DW	OW			_	-	-	OW		DW	DW	OW	-	DW	DA DA		044	OW	DW	0₩		*	X
PEDESTRIAN SIGNALS CROSSING ST. CHARLES ROAD, WEST LEG, NORTH OF TRACKS	DW	DW C		w o	~ 6	w o	-	-	~ 04	v ow	OW	-	wo	OW I	ow c	* 0	NO	DN	OW	CW	DW	DW	DW	OW	OW O	w ov	· Ow	DW	DW	W	OW D		V ON	DW	DW	ON O		WO I	DW	DW	DWY D		OW	DW	DW	OW I	ONV DM	* 24	-	DW	DW	OW	0	~	\Diamond

FOR INFORMATION ONLY

USER NAME = dwiktorzak	DESIGNED - ZH	REVISED -			LAN, PHASE DESIGNATION DIAGRAM, EMERGENCY VEHI		SECTION	COUNTY TOTAL SHEET
	DRAWN - RG	REVISED -	STATE OF ILLINOIS	PREEM	PTION SEQUENCE AND SCHEDULE OF QUANTITIES - ARE	4 VAR	19-DCCSS-04-TL	DUPAGE 293 161
PLOT SCALE = 40.0000 / in.	CHECKED - DW	REVISED -	DEPARTMENT OF TRANSPORTATION		ST CHARLES RD/PARKSIDE AVE AND GRACE ST			CONTRACT NO. 61H96
PLOT DATE = 6/12/2022	DATE -	REVISED -		SCALE:	SHEET 96 OF 96 SHEETS STA. TO STA.		ILLINOIS FED.	AID PROJECT

ALROAD PREEMPTION SEQUENCE SHALL PROVIDE PROPER CLEARANCE INTERVAL TO RESUME TO NORMAL SEQUENCE OF OPERATION OR PROPER CLEARANCE INTERVAL TO DISPLAY AN EMERSANCY VERICLE INTERVAL (IF APPLICABLE) AFTER RAILROAD PREEMPTION INTERVAL 5 IS TERMINATED.

* THE FLASHING DON'T WALK INTERVALS MAY BE SHORTENED TO PROVIDE FOR PROPER TIMING OF THE RAILROAD PREEMPTION SEQUENCE.


CLEARANCE INTERVAL TO RESUME SHALL PROVIDE THE PROPER CLEARANCE INTERVAL TO RESUME THE NORMAL SEQUENCE OF OPERATION OR PROPER CLEARANCE INTERVAL TO DISPLAY A DIFFERENT EMERGENCY VEHICLE INTERVAL ATER EMERGENCY VEHICLE INTERVAL 2, 3.4, OR 5 IS TERMINATED.

FLASHING DON'T WALK IS TO TERMINATE AT THE COMPLETION OF THE PEDESTRIAN CLEARANCE INTERVAL.


FL * FLASHING DON'T WALK DW

DW "DON'T WALK"

LOMBARD TS 35

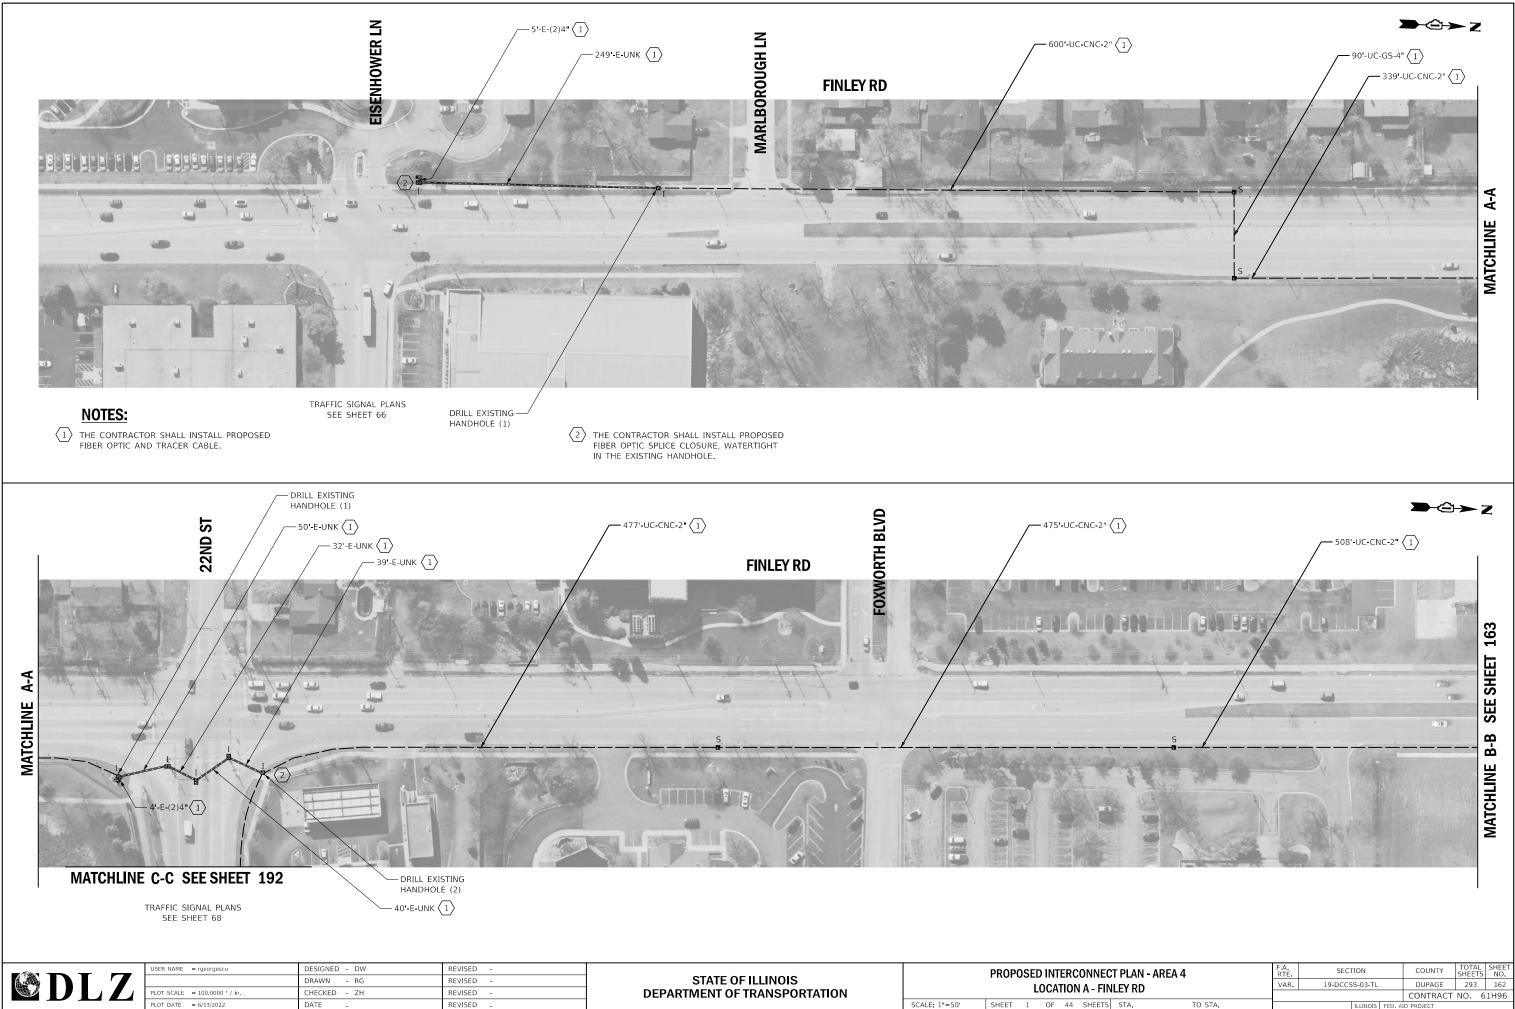

FILE NAME = X:\Projects\2021\2182\217400 DuPage DOT Central\CADD_Sheets\sht-Int-A4-A-FInley.dg Default JUALL I -JU JHEET I OF

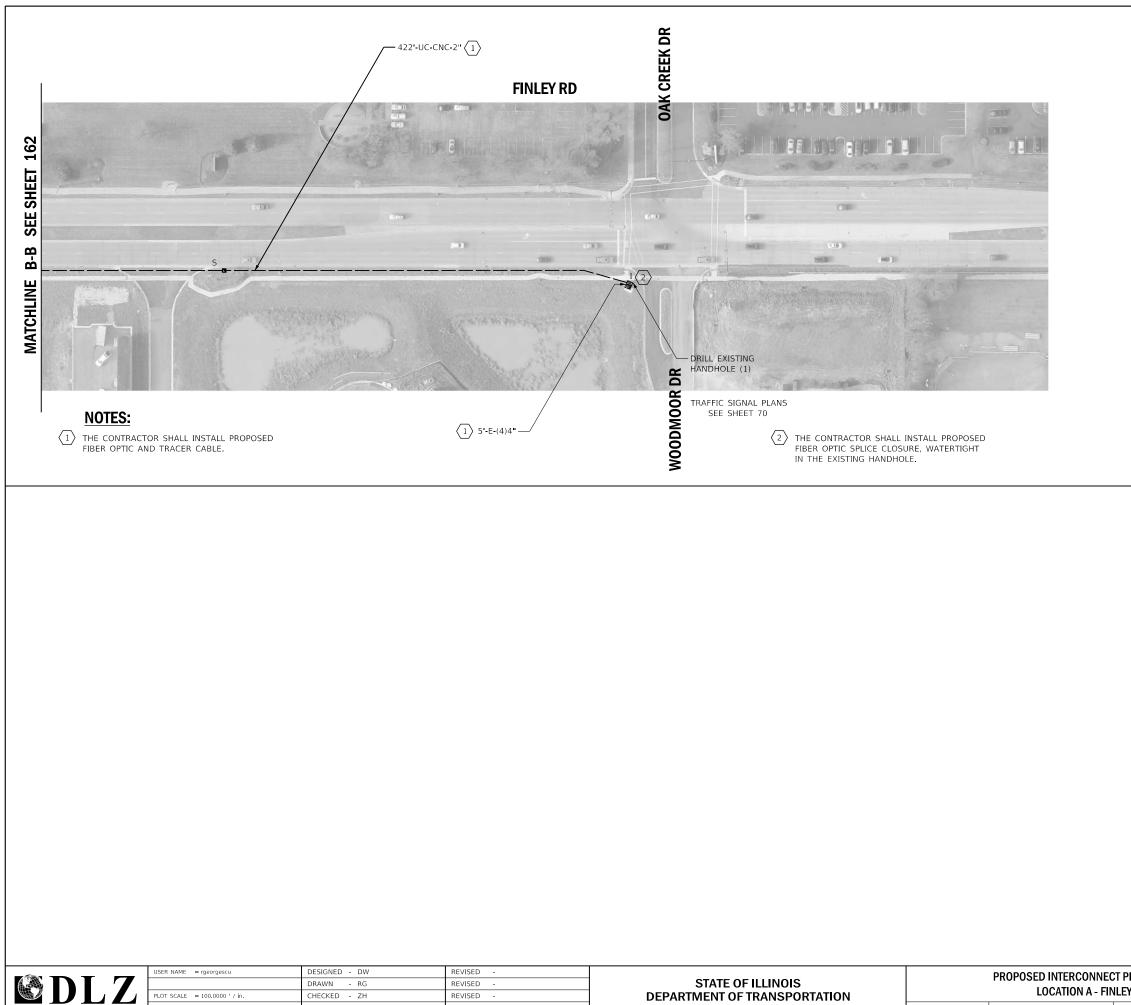


PLOT DATE = 6/14/2022

DATE


REVISED


PLAN - AREA 4		F.A. RTE	SEC	FION		COUNTY	TOTAL SHEETS	SHEET NO.
EY RD		VAR.	19-DCC5	S-03-TL		DUPAGE	293	163
						CONTRACT	NO. 6	1H96
ITA. T	O STA.			ILLINOIS	FED. A	ID PROJECT		

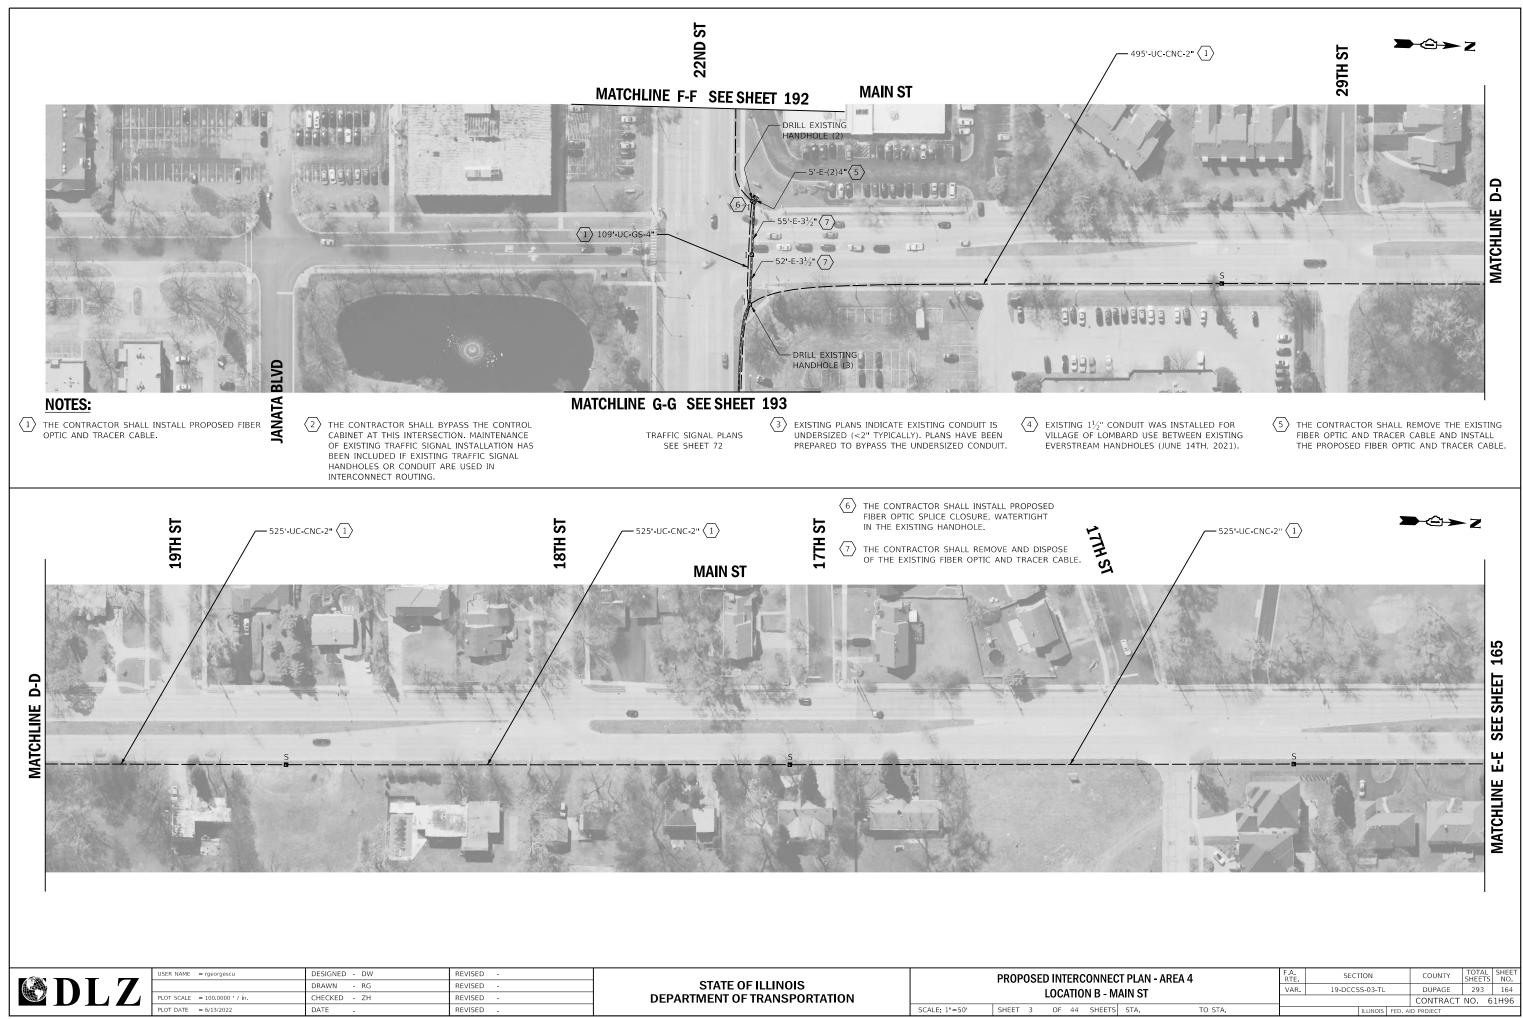


= X:\Projects\2021\2182\217400 DuPage DOT Central\CADD_Sheets\sht-Int-A4-B-Main.dg

EC	T PLAN -	AREA 4	F.A. RTE	SECT	ION		COUNTY	TOTAL SHEETS	SHEET NO.
M.	AIN ST		VAR.	19-DCCS	S-03-TL		DUPAGE	293	164
W1/							CONTRACT	NO. 6	1H96
S	STA.	TO STA.			ILLINOIS	FED. AI	ID PROJECT		

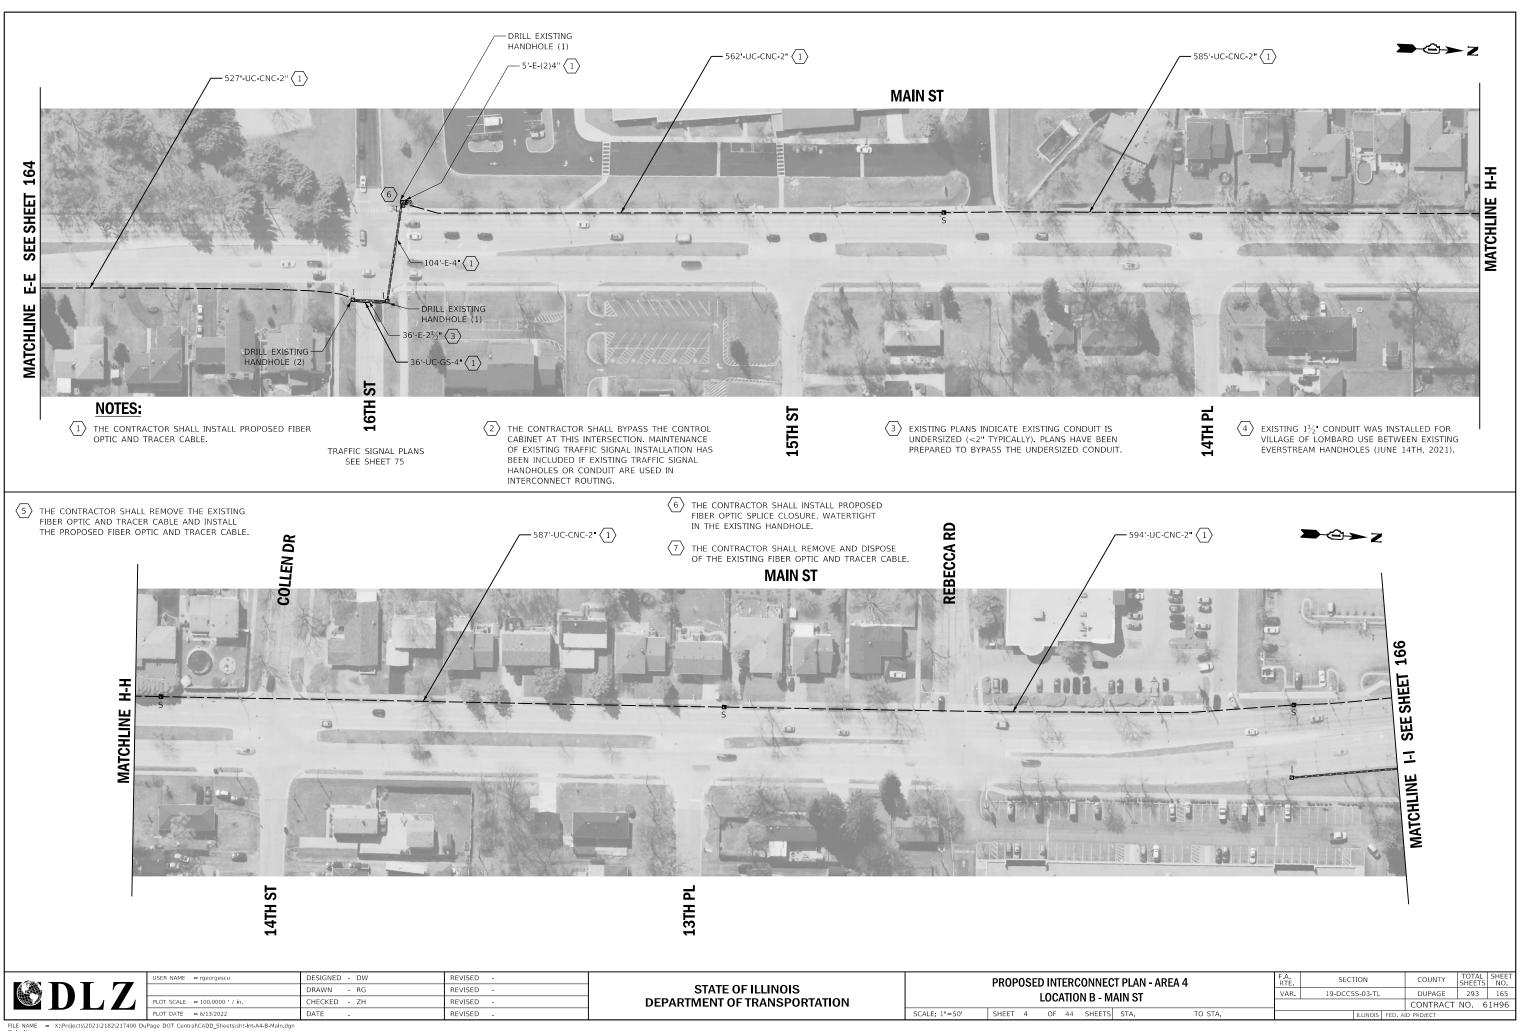


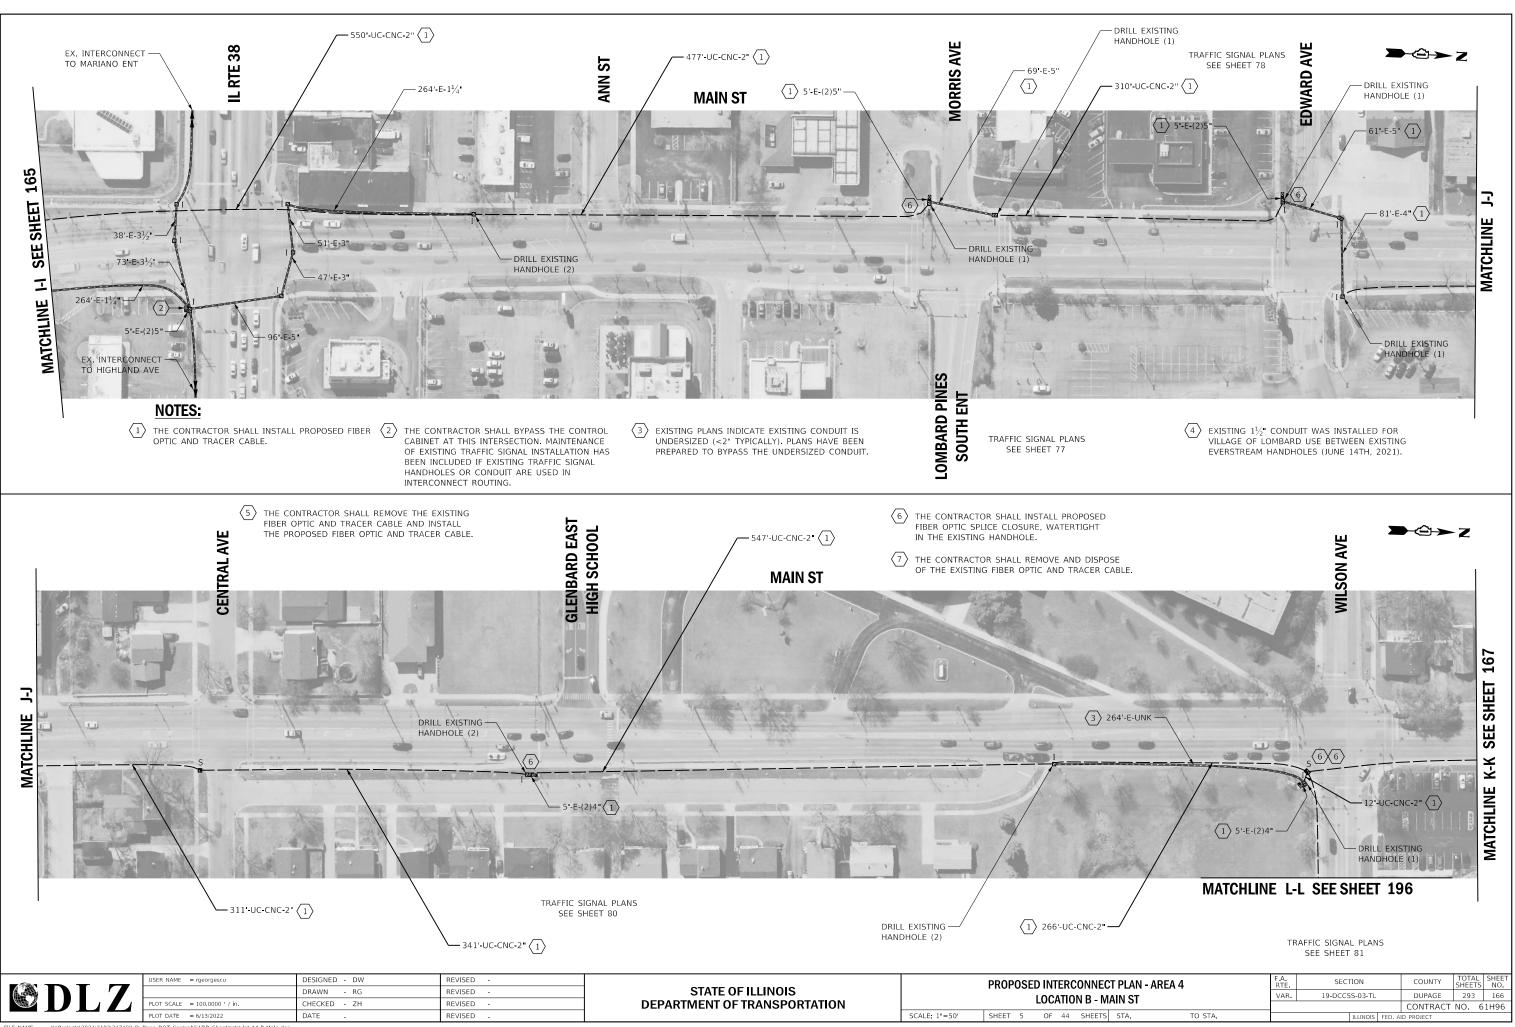


FILE NAME = X:\Projects\2021\2182\217400 DuPage DOT Central\CADD_Sheets\sht-Int-A4-B-Main.dg

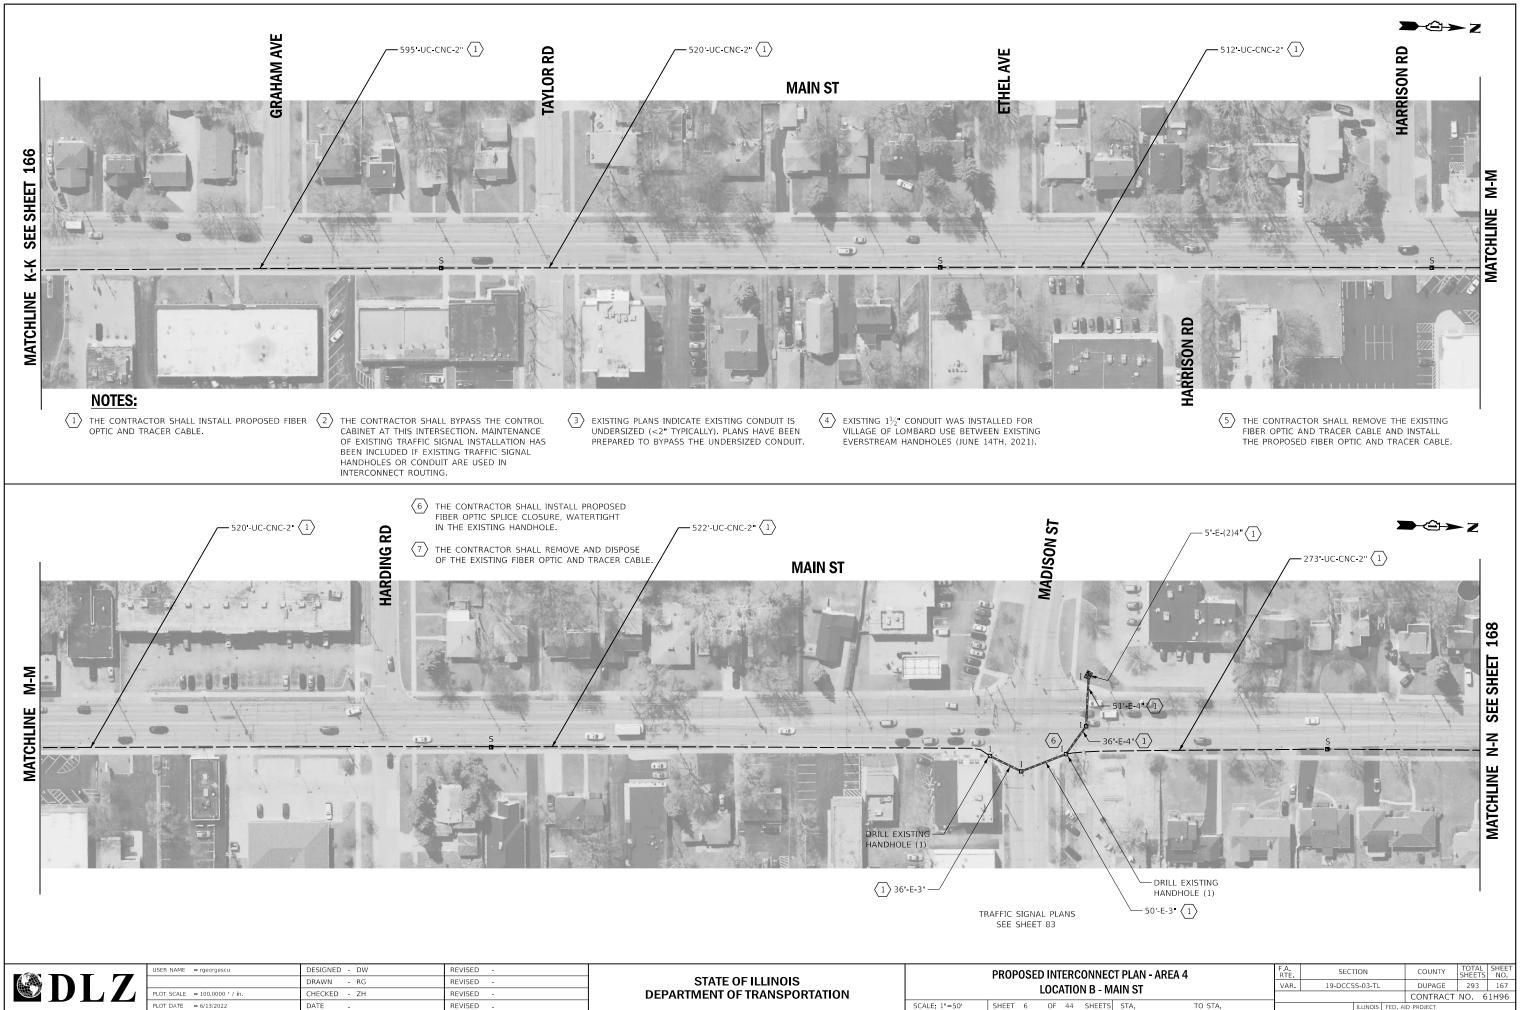


FILE NAME Default = X:\Projects\2021\2182\217400 DuPage DOT Central\CADD_Sheets\sht-Int-A4-B-MaIn.dg

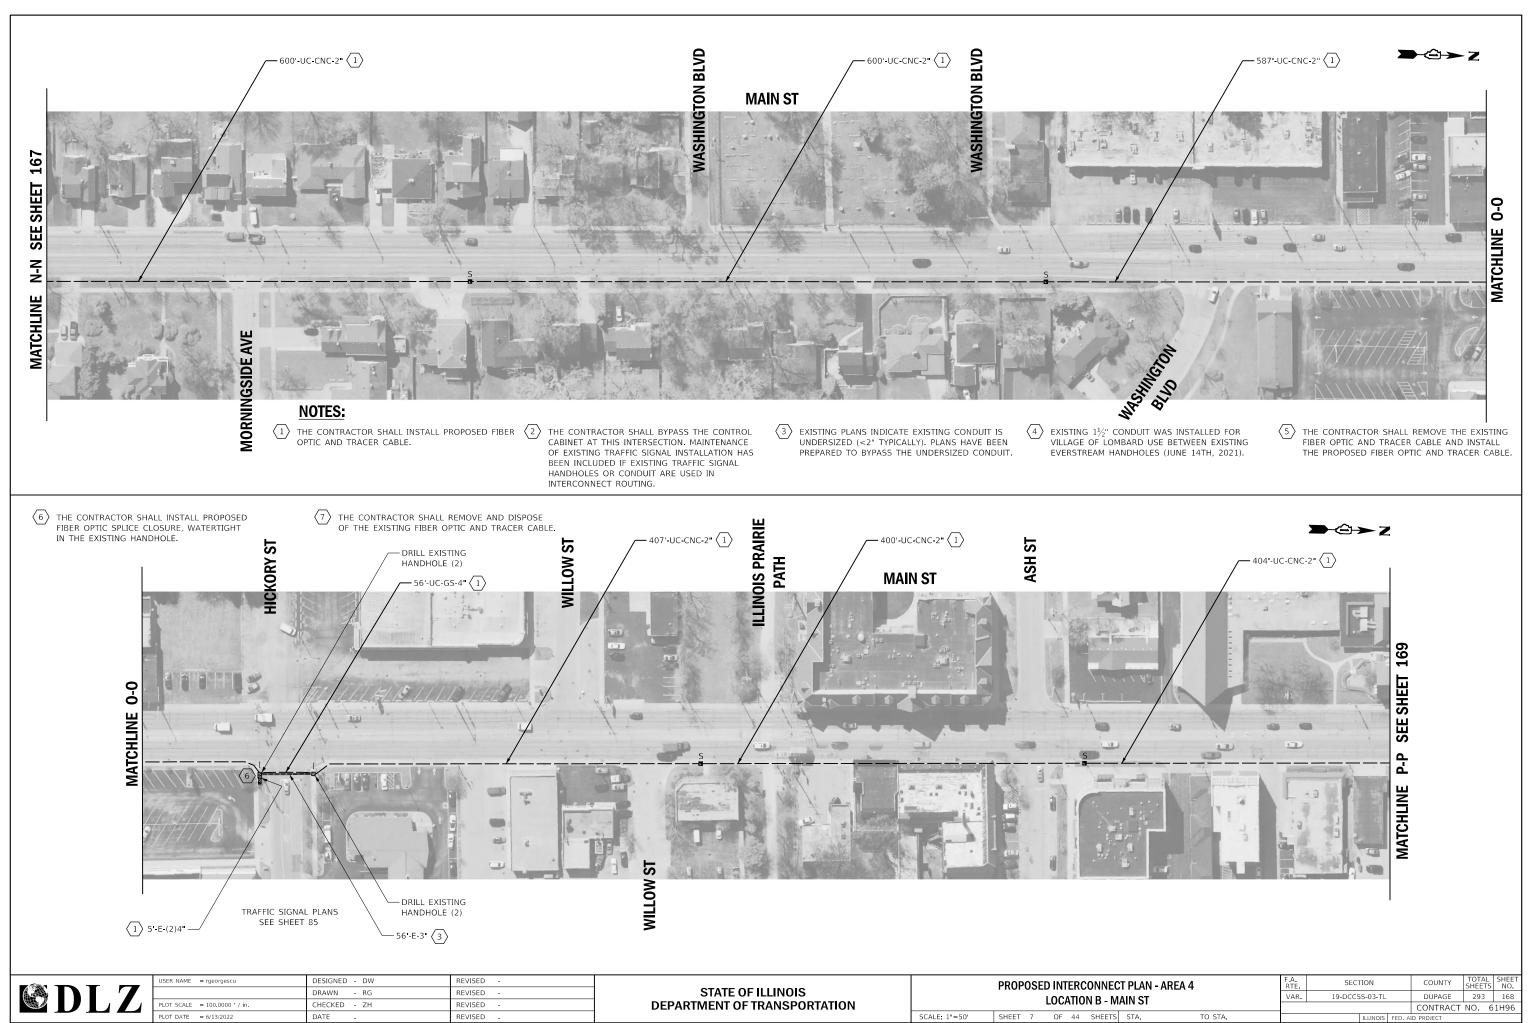


FILE NAME = X \Projects\2021\2182\217400 DuPage DOT Central\CADD_Sheets\sht-Int-A4-B-Main.dg

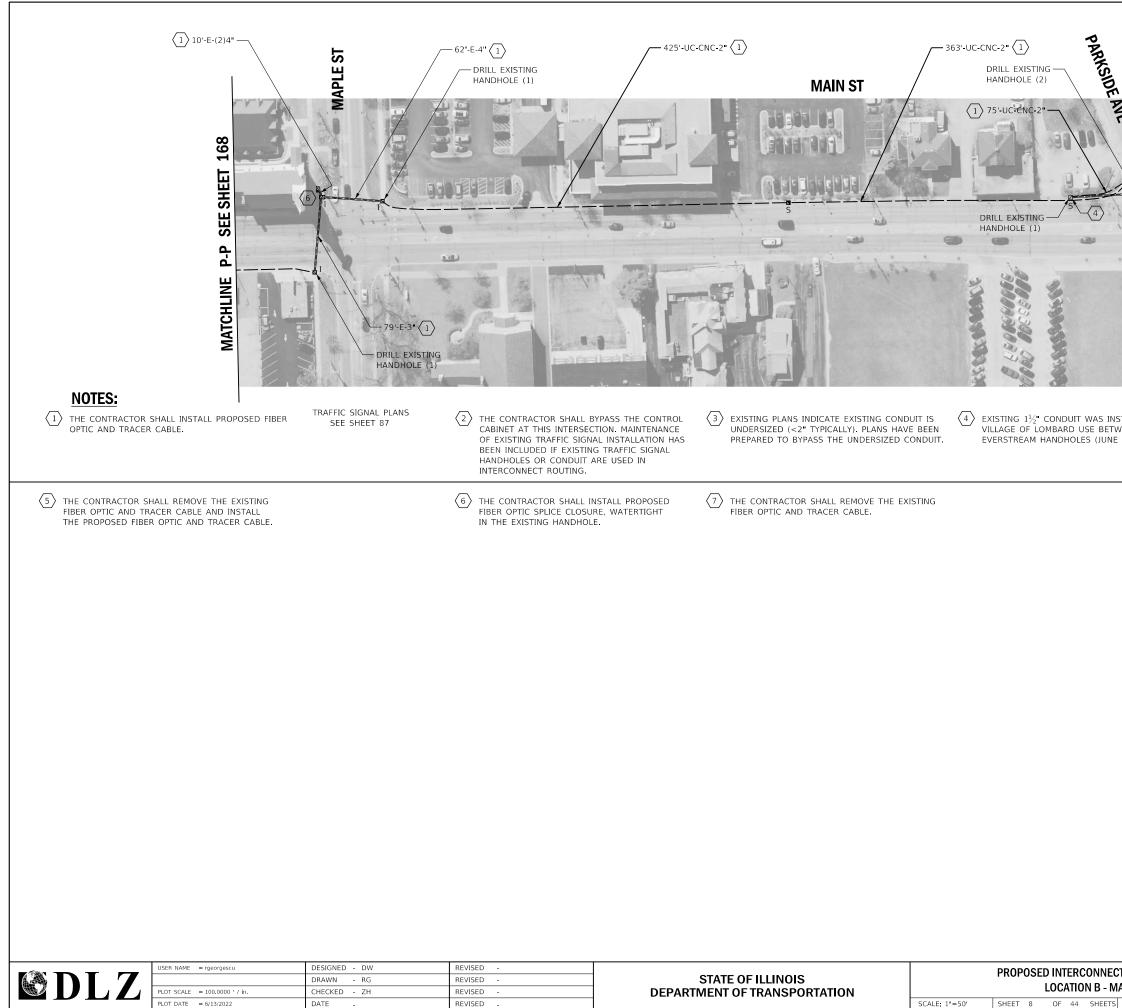


Аннала 50'-E-UNK (1) 5'-E-(2)4" (1) 5'-E-(2)4" (1)	
MATCHLINE Q-Q SEE SHEET 200	
TRAFFIC SIGNAL PLANS INSTALLED FOR SEE SHEET 89 ETWEEN EXISTING INE 14TH, 2021).	
IECT PLAN - AREA 4 RTE. SECTION COUNTY SHEETS MAIN ST VAR. 19-DCCSS-03-TL DUPAGE 293	NO. 169 H96

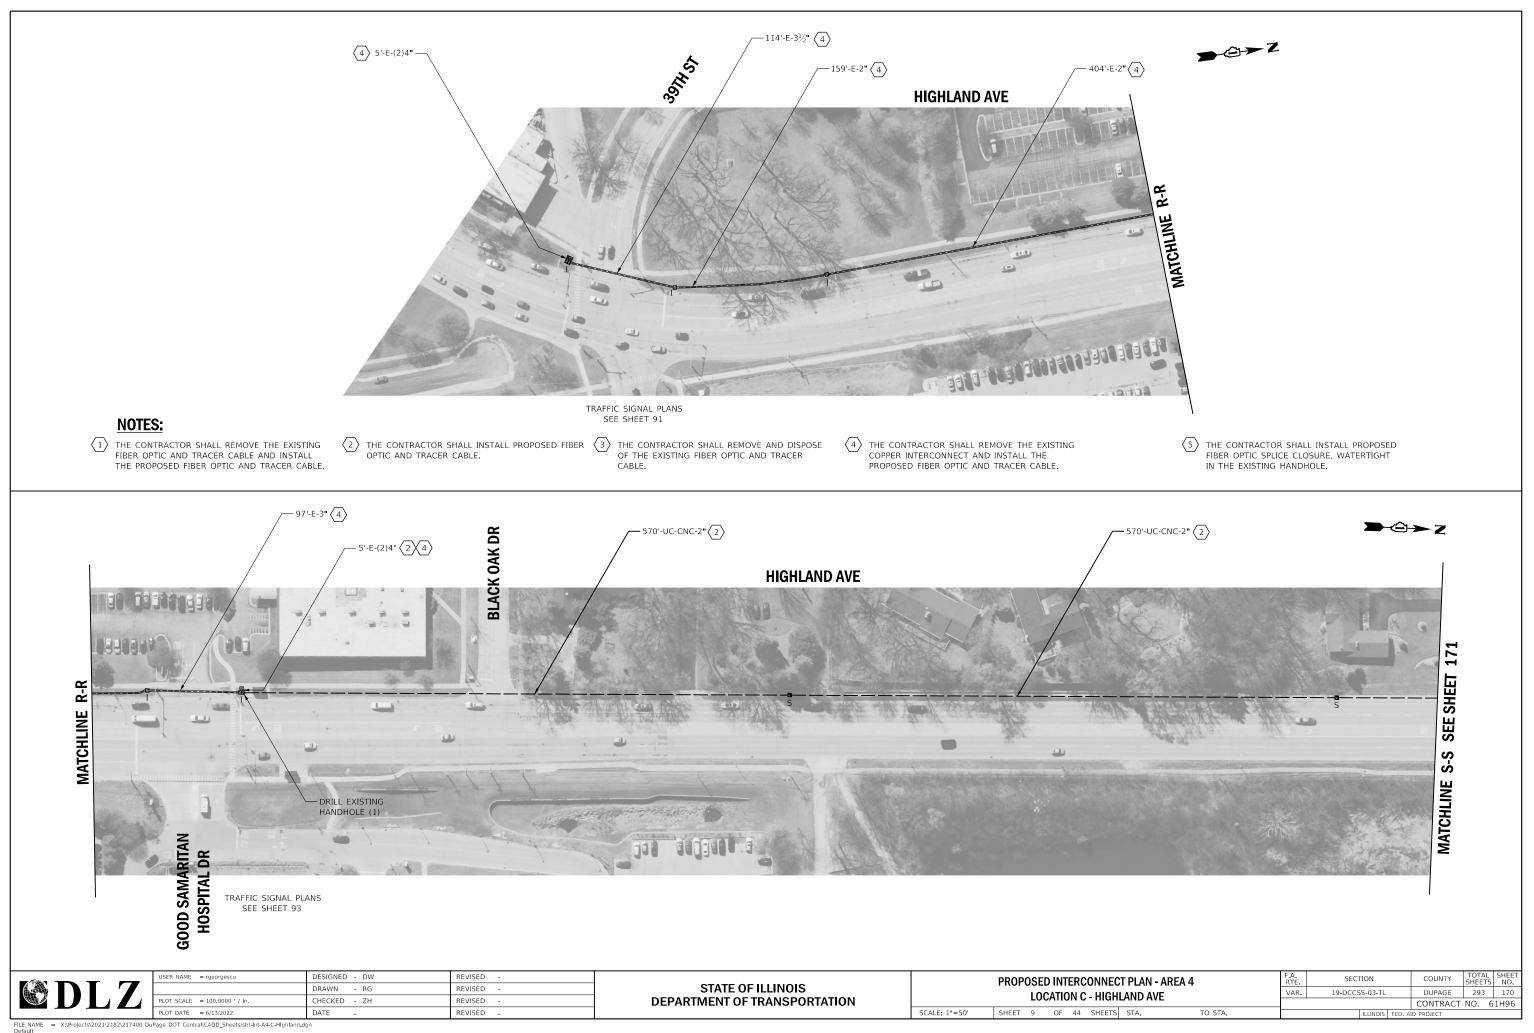

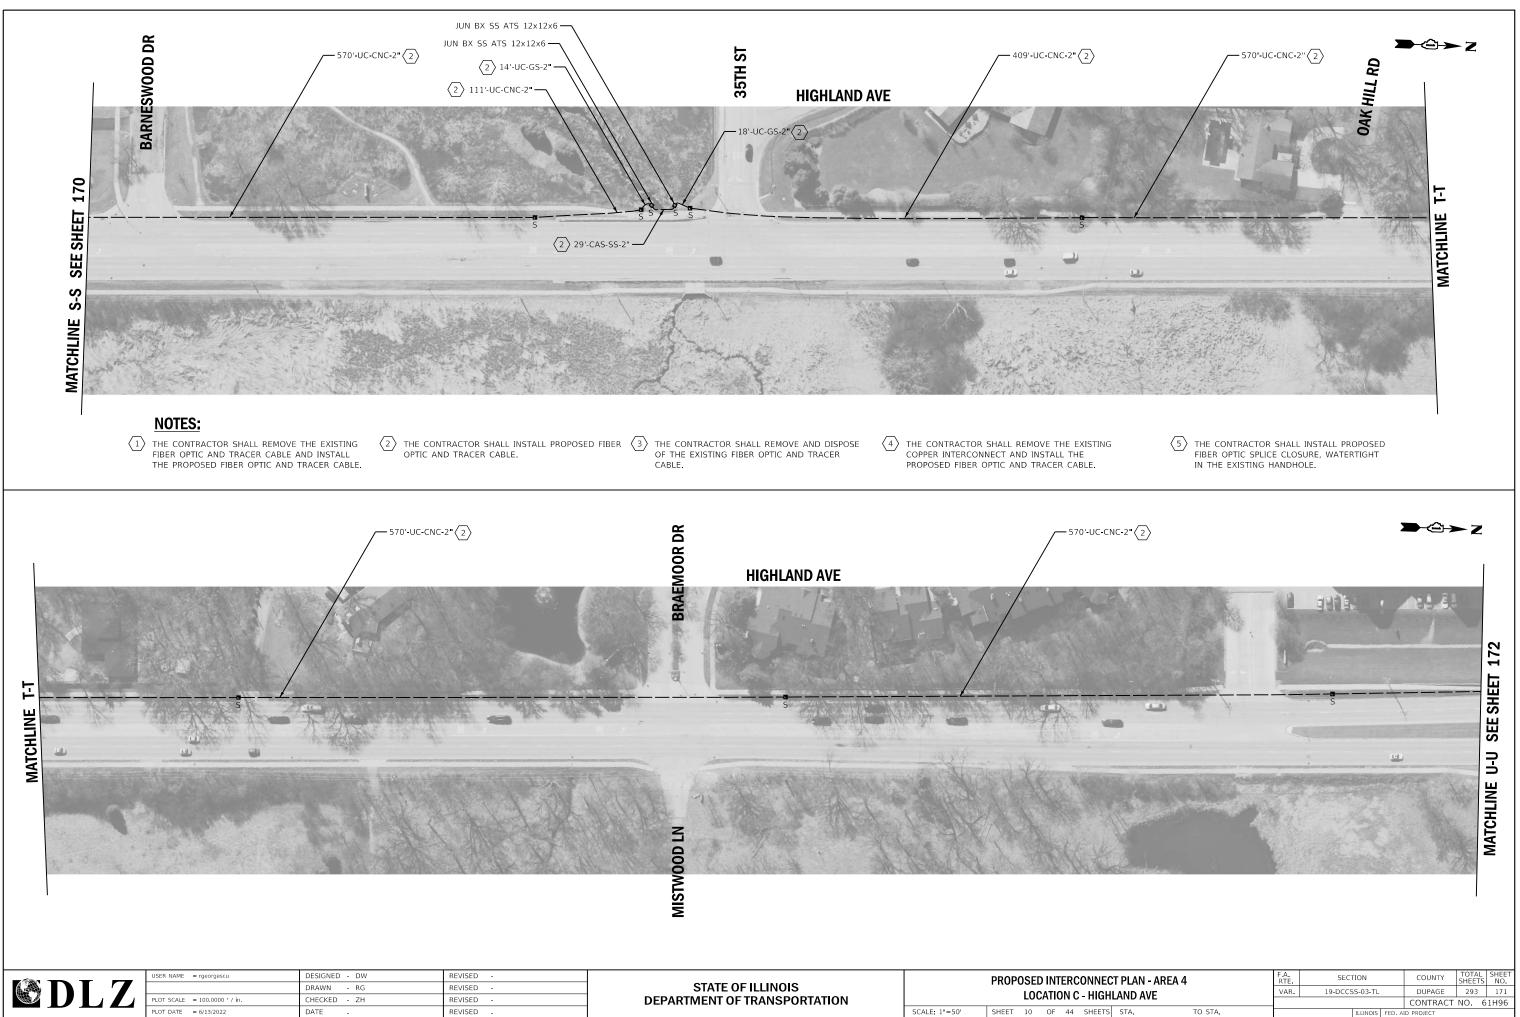


FILE NAME Default = X\Projects\2021\2182\217400 DuPage DOT Central\CADD_Sheets\sht-Int-A4-C-Highland.dg


HLAND AVE		 15 8 6 6 5 5 6 5 1 6		BOILIGE	200	-		
					CONTRACT	NO.	61H	
٢S	STA.	TO STA.		ILLINOIS	FED. A	ID PROJECT		
							-	

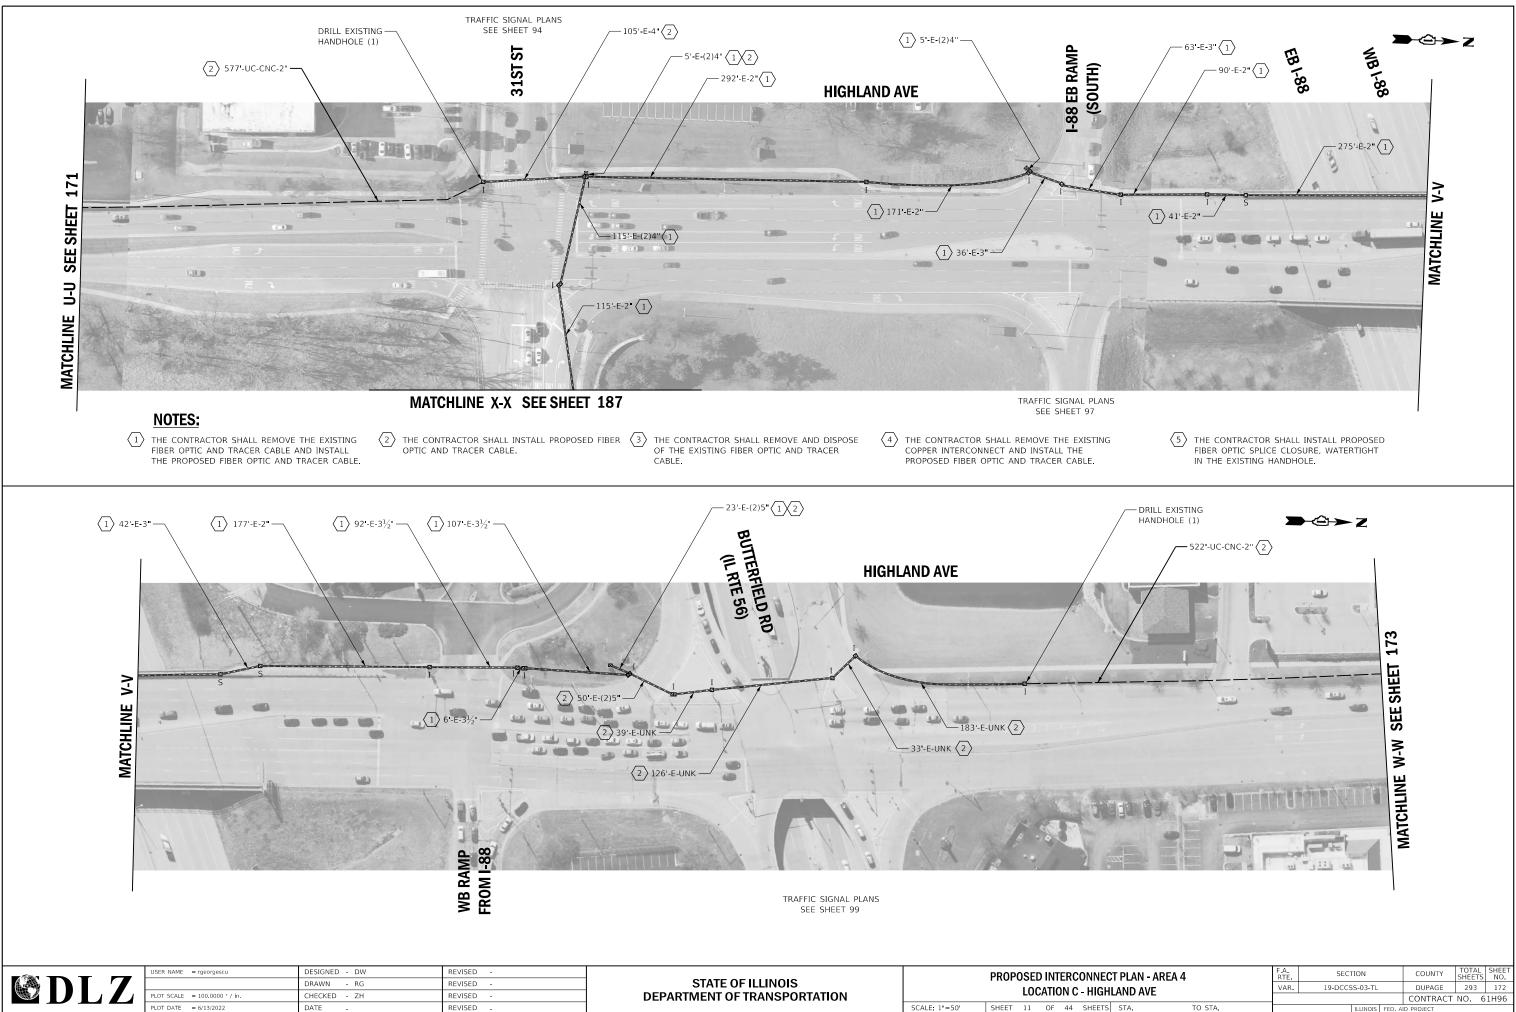


FILE NAME Default X \Projects\2021\2182\217400 DuPage DOT Central\CADD_Sheets\sht-Int-A4-C-Highland.dg

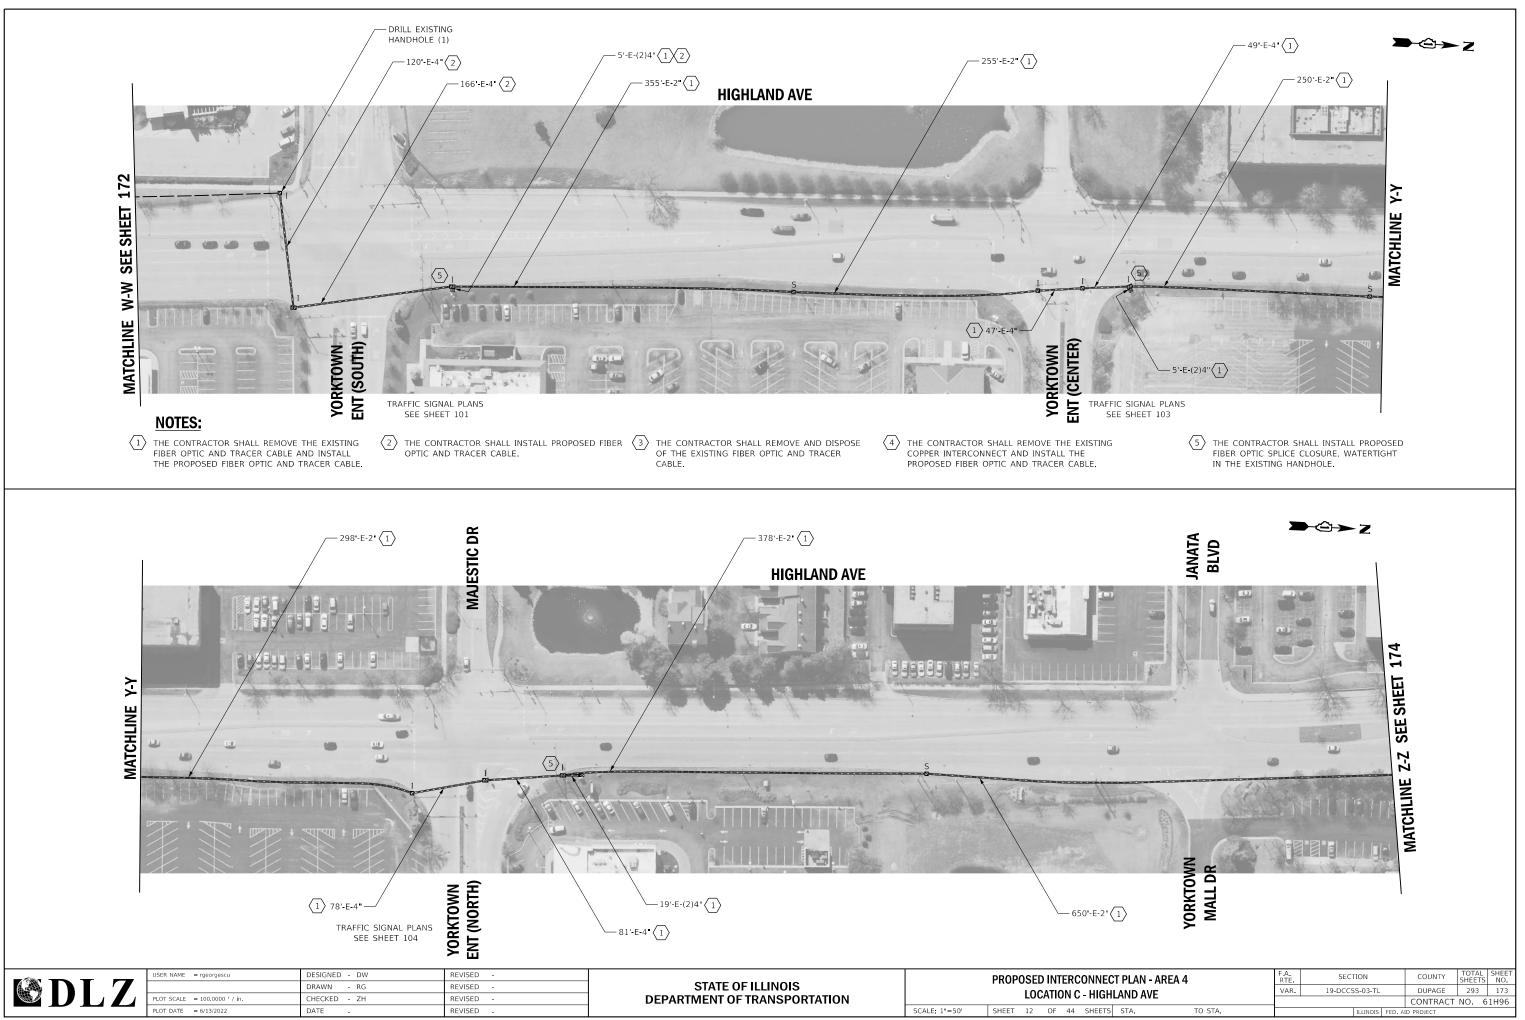

FILE NAME = X:\Projects\2021\2182\217400 DuPage DOT Central\CADD_Sheets\sht-Int-A4-C-Highland do

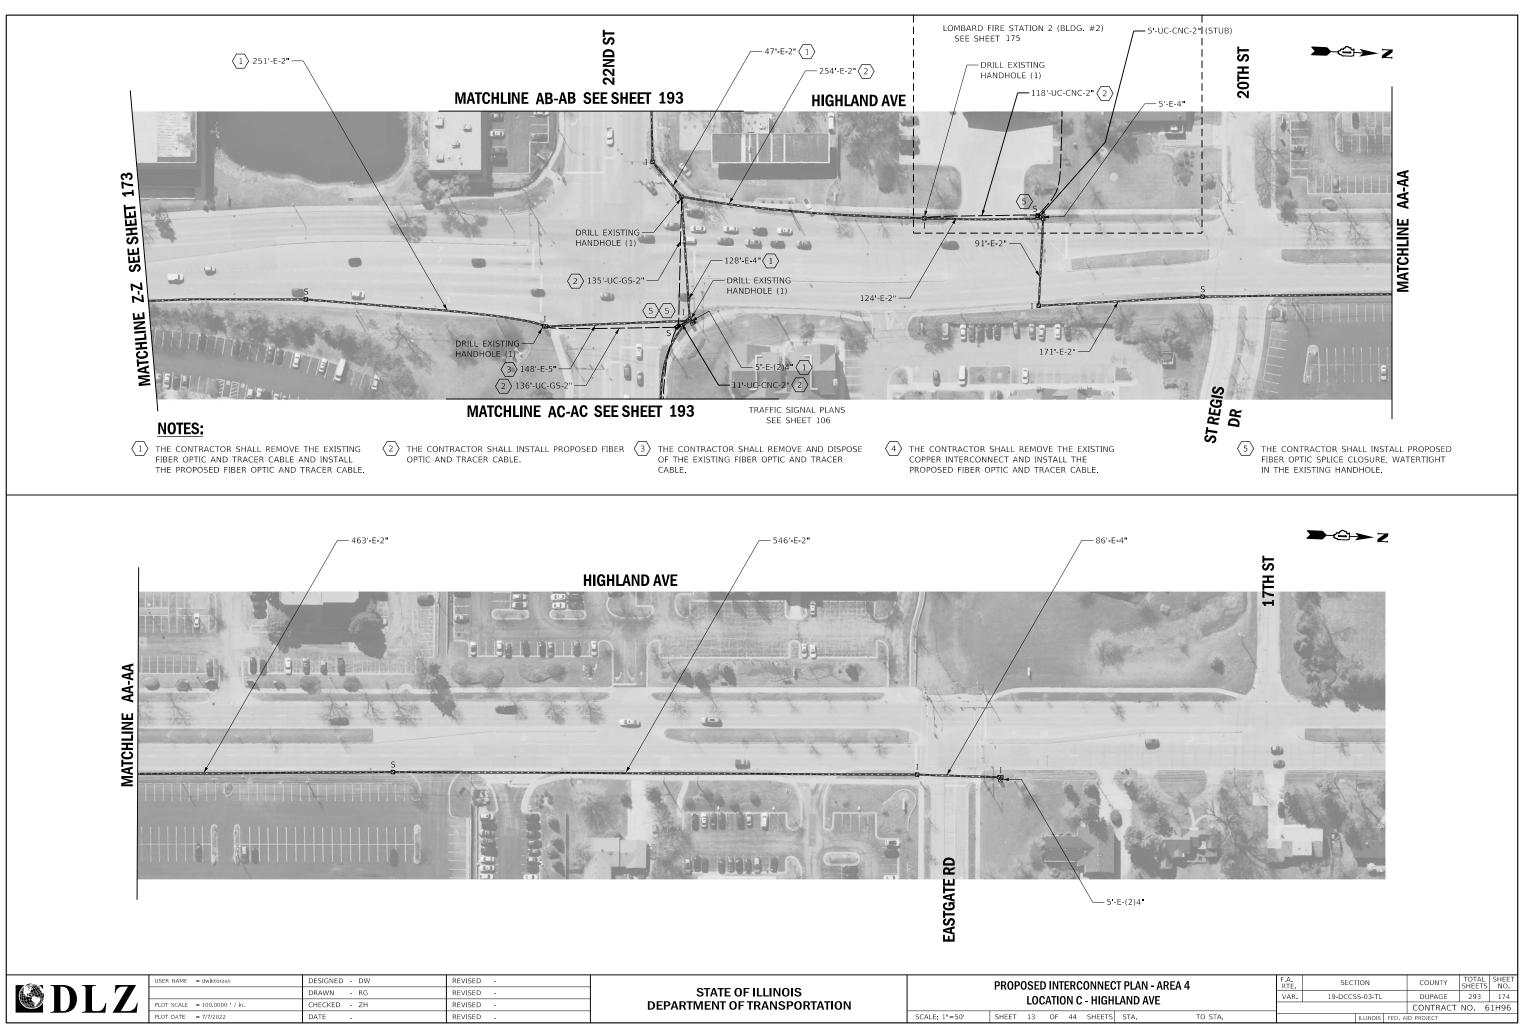

ILE NAME = X:\Projects\2021\2182\217400 DuPage DOT Central\CADD_Sheets\sht-Int-A4-C-Highland.dc

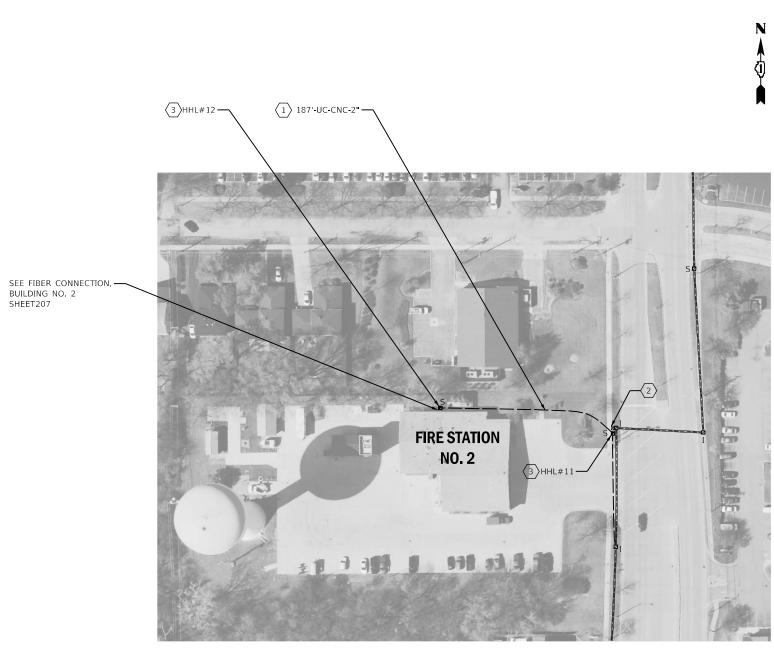



LOMBARD FIRE STATION NO. 2

NOTES:


- $\left<1\right>$ The contractor shall install proposed fiber optic and tracer cable.
- (2) THE CONTRACTOR SHALL BYPASS THE CONTROL CABINET AT THIS INTERSECTION.
- VILLAGE OF LOMABRD COMMUNICATION HANDHOLE (HHL#_), THE COVER OF THE HANDHOLE FRAME SHALL BE LABELED "LOMBARD COMMS".

	USER NAME = dwiktorzak	DESIGNED -	REVISED -			PROPOSED INTERCONNECT PLAN - AREA 4			SECTION	COUNTY TOTAL SHEE
DLZ		DRAWN -	REVISED -	STATE OF ILLINOIS	LOCATION C - LOMBARD FIRE STATION NO. 2			VAR.	19-DCCSS-04-TL	DUPAGE 293 175
	PLOT SCALE = 100.0000 ' / in.	CHECKED -	REVISED -	DEPARTMENT OF TRANSPORTATION						CONTRACT NO. 61H96
	PLOT DATE = 7/7/2022	DATE -	REVISED -		SCALE:	SHEET 14 OF 44 SHEETS STA.	TO STA.		ILLINOIS FED.	AID PROJECT
FILE NAME = X:\Projects\2021\2182\217400 Du Default	Page DOT Central\CADD_Sheets\sht-int-A4-J-Wilson.dgn		1	1				1		

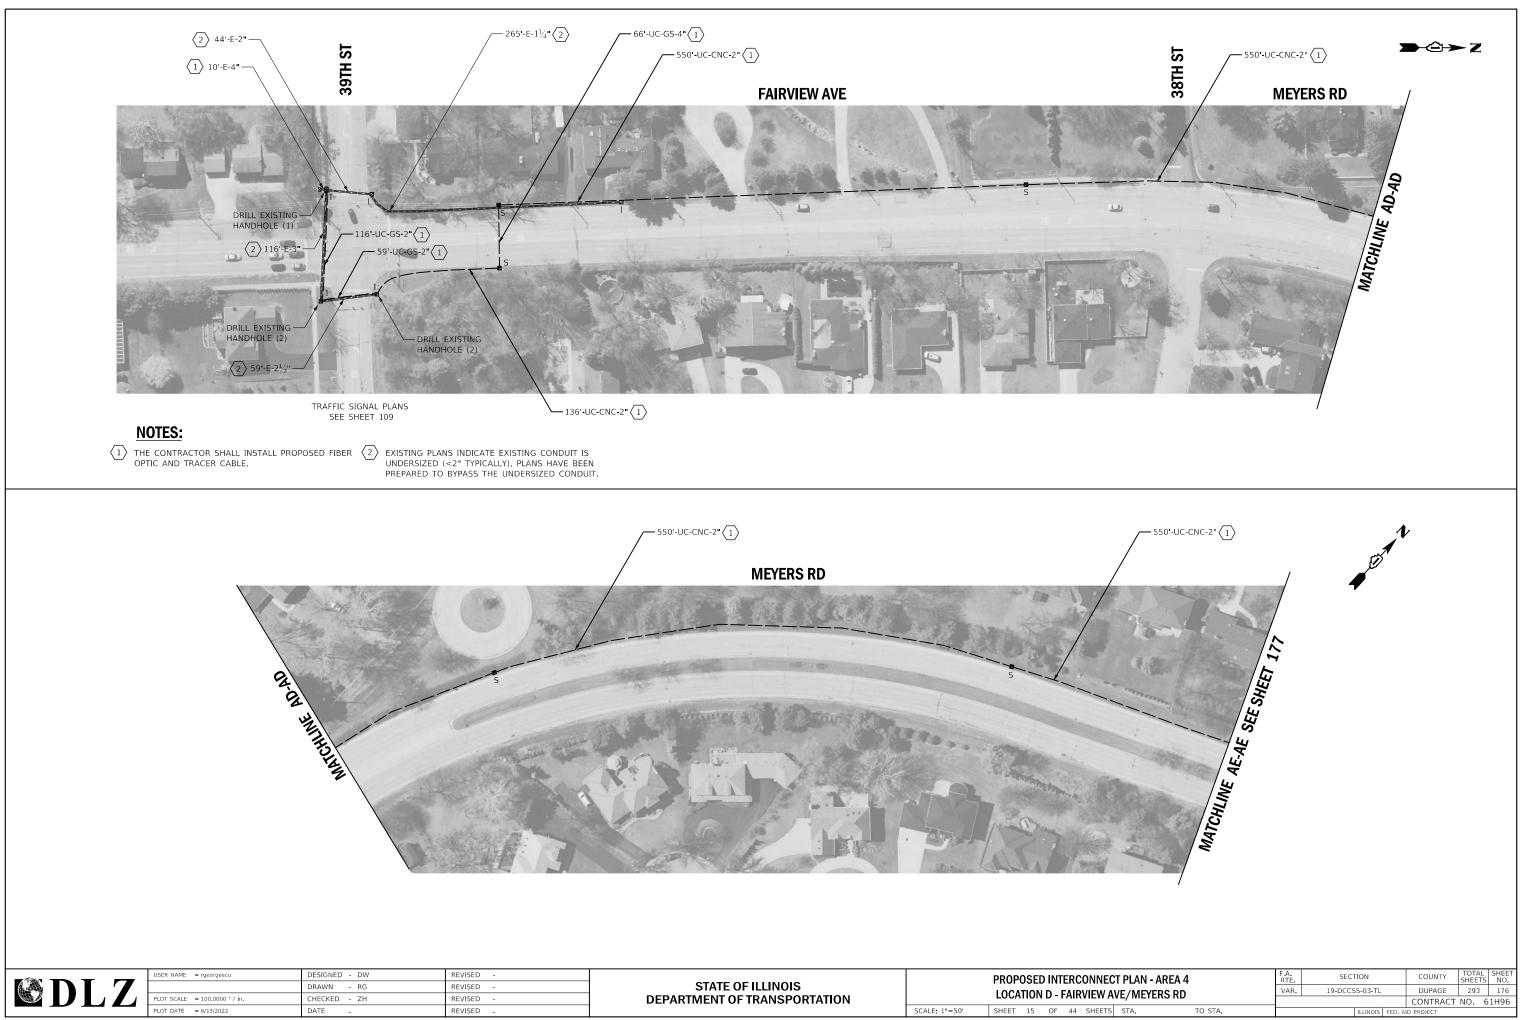


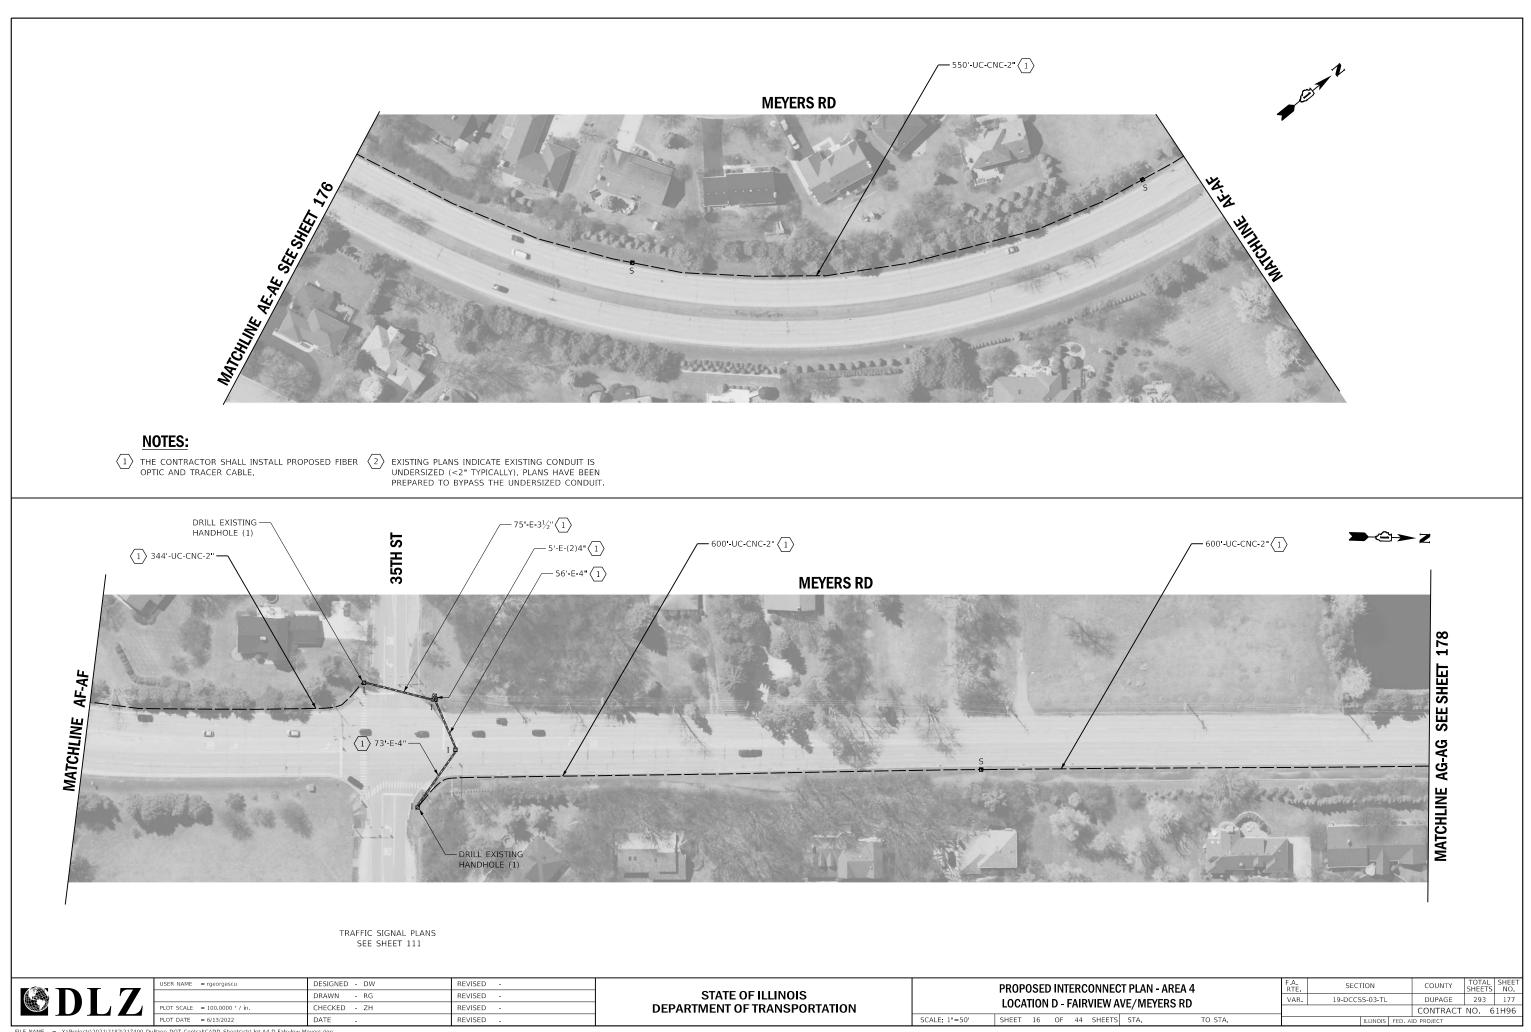

FILE NAME Default X:\Projects\2021\2182\217400 DuPage DOT Central\CADD_Sheets\sht-Int-A4-D-Fairview-Meyers.dgn

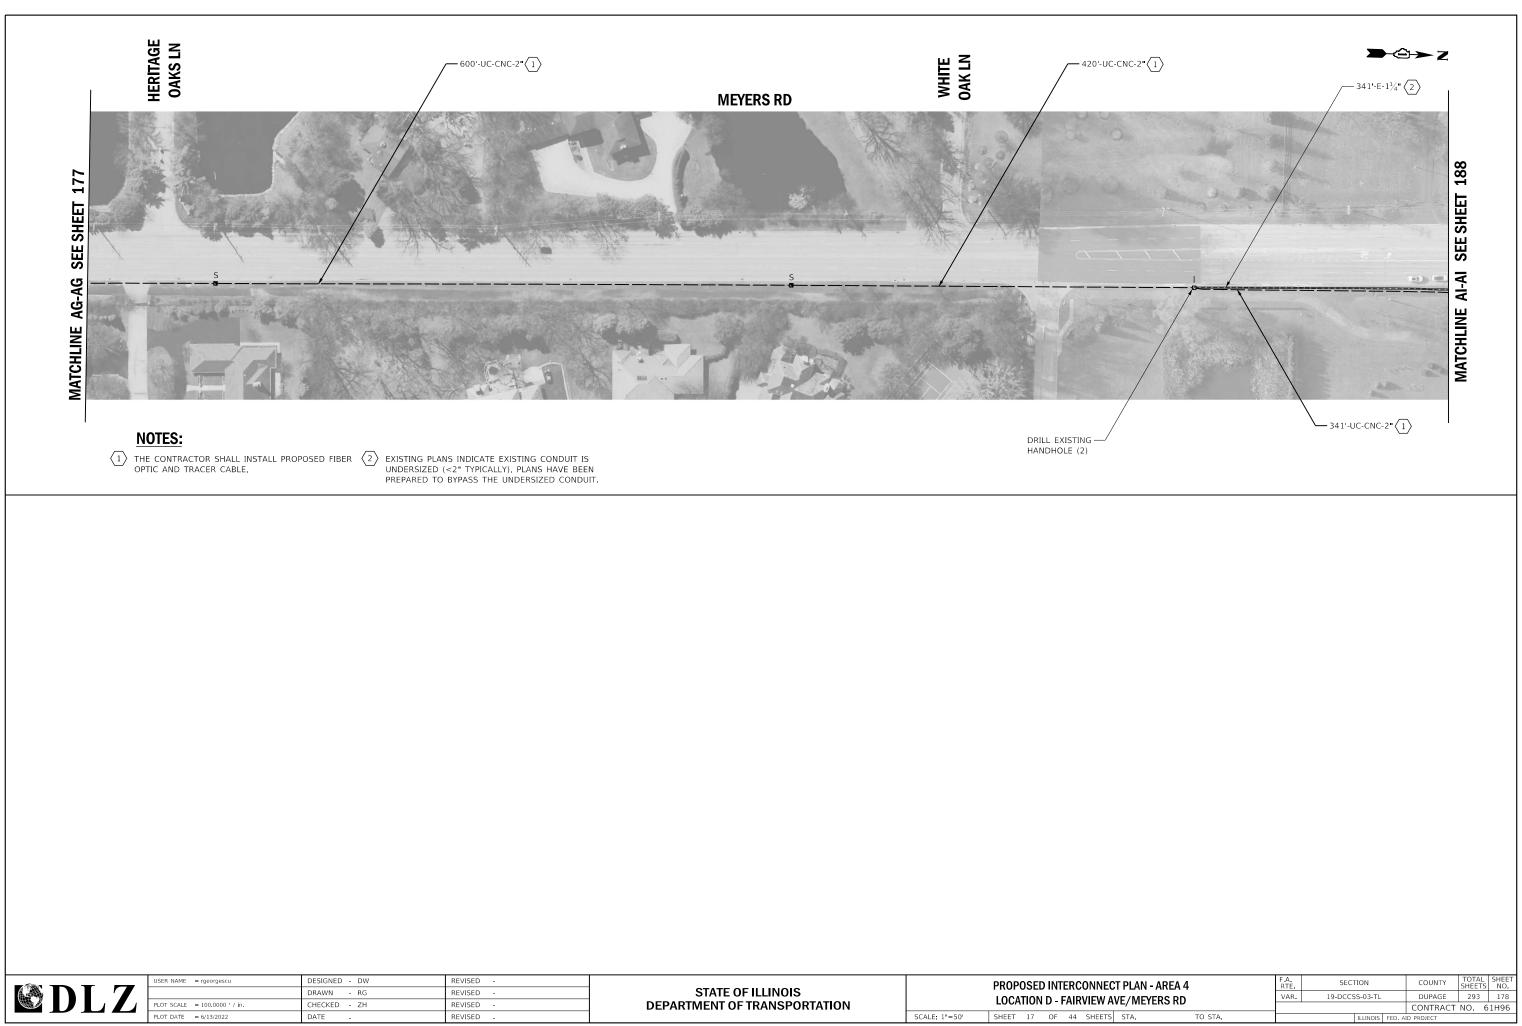


FILE NAME	=	X \Projects\2021\2182\217400	DuPage	DOT	Central\CADD	Sheets\sht-Int-A4-D-Fairvlew-Meyers.dgn
Default						

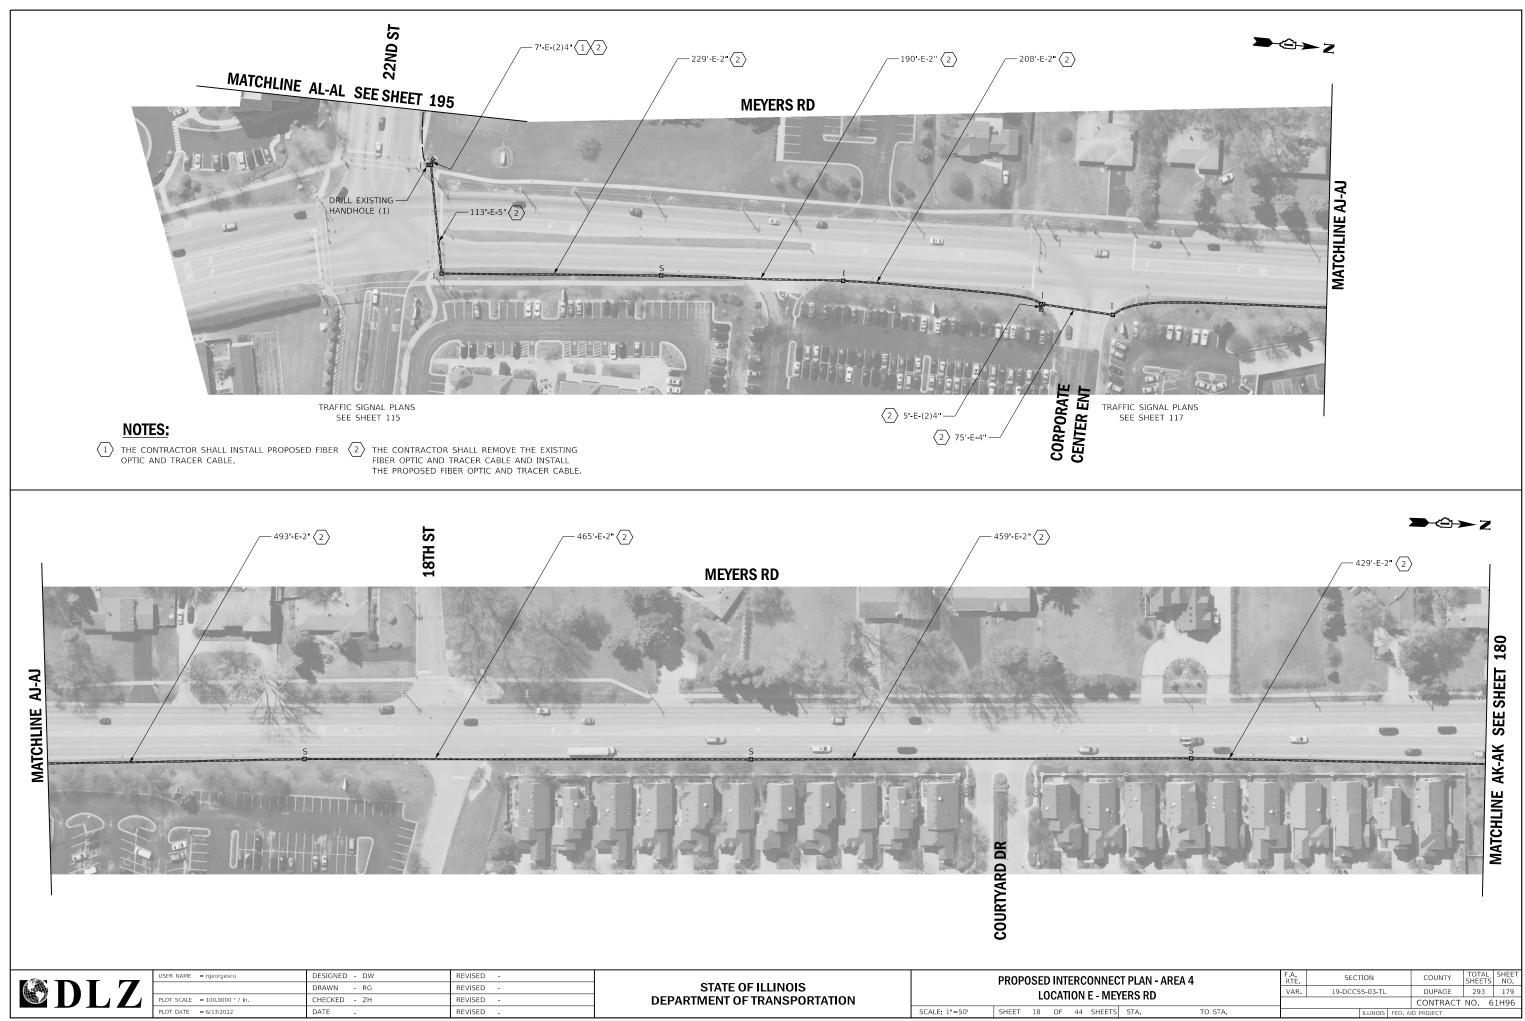


FILE NAME = X:\Projects\2021\2182\217400 DuPage DOT Central\CADD_Sheets\sht-Int-A4-E-Meyers.de


ECT PLAN - AREA 4 EYERS RD			F.A. RTE	SEC	SECTION			TOTAL SHEETS	SHEET NO.
			VAR.	19-DCCSS-03-TL			DUPAGE	293	179
							CONTRACT	NO. 6	1H96
S	STA.	TO STA.			ILLINOIS	FED. A	ID PROJECT		

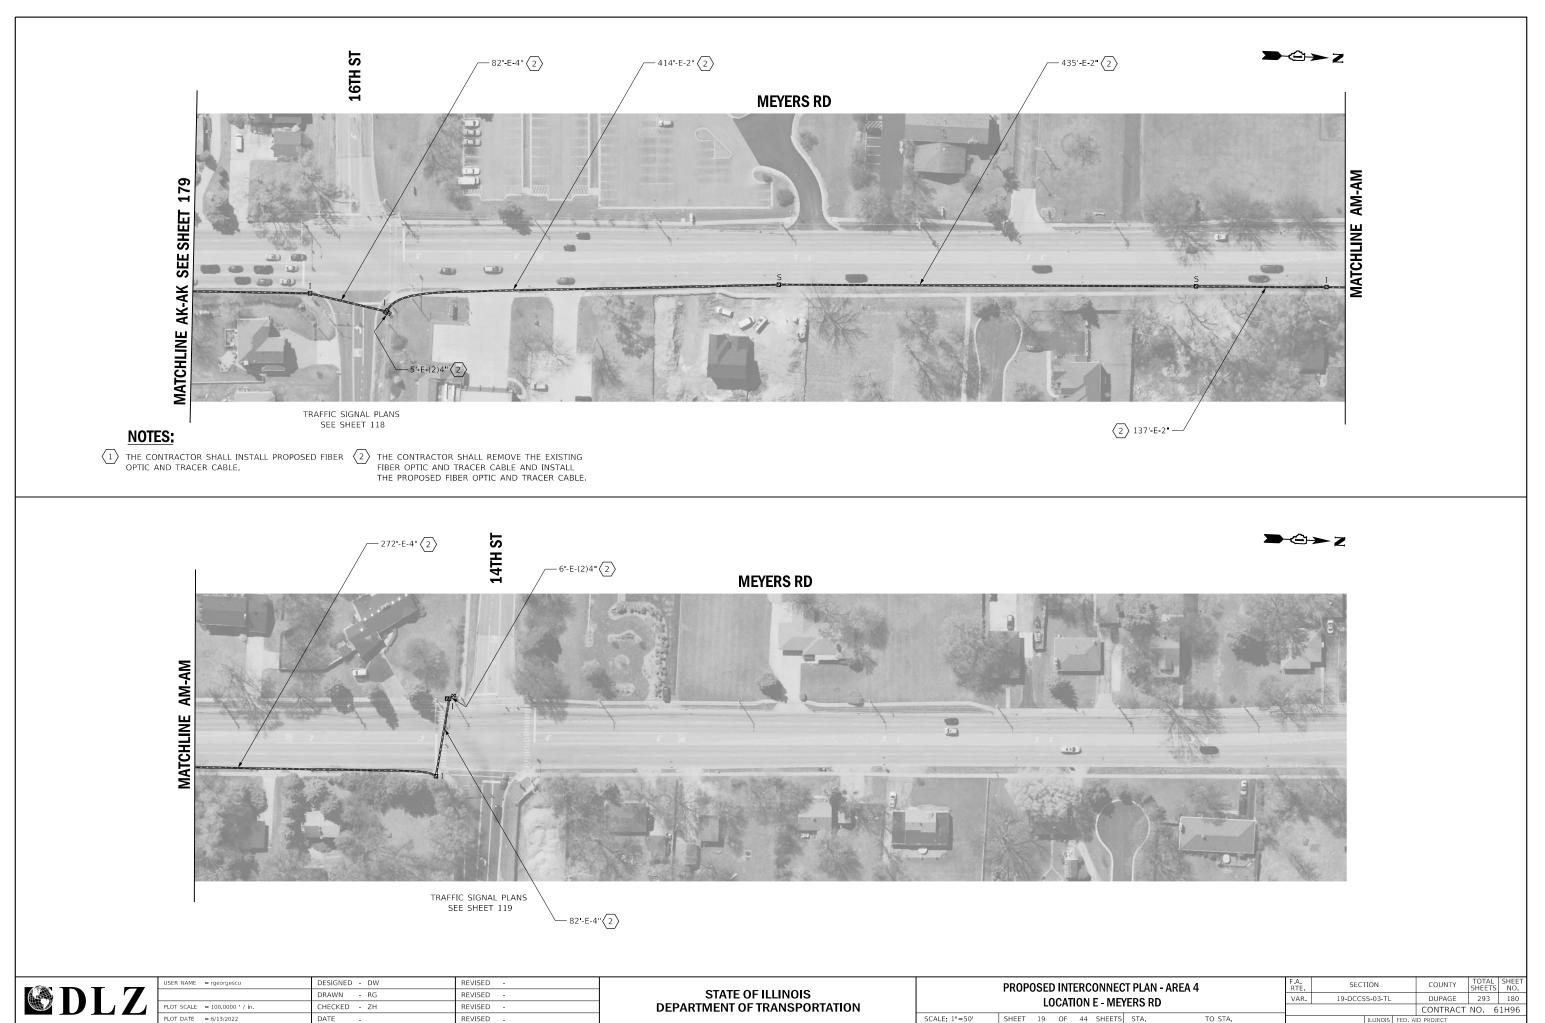


FILE NAME = X:\Projects\2021\2182\217400 DuPage DOT Central\CADD_Sheets\sht-Int-A4-E-Meyers.dgr Default

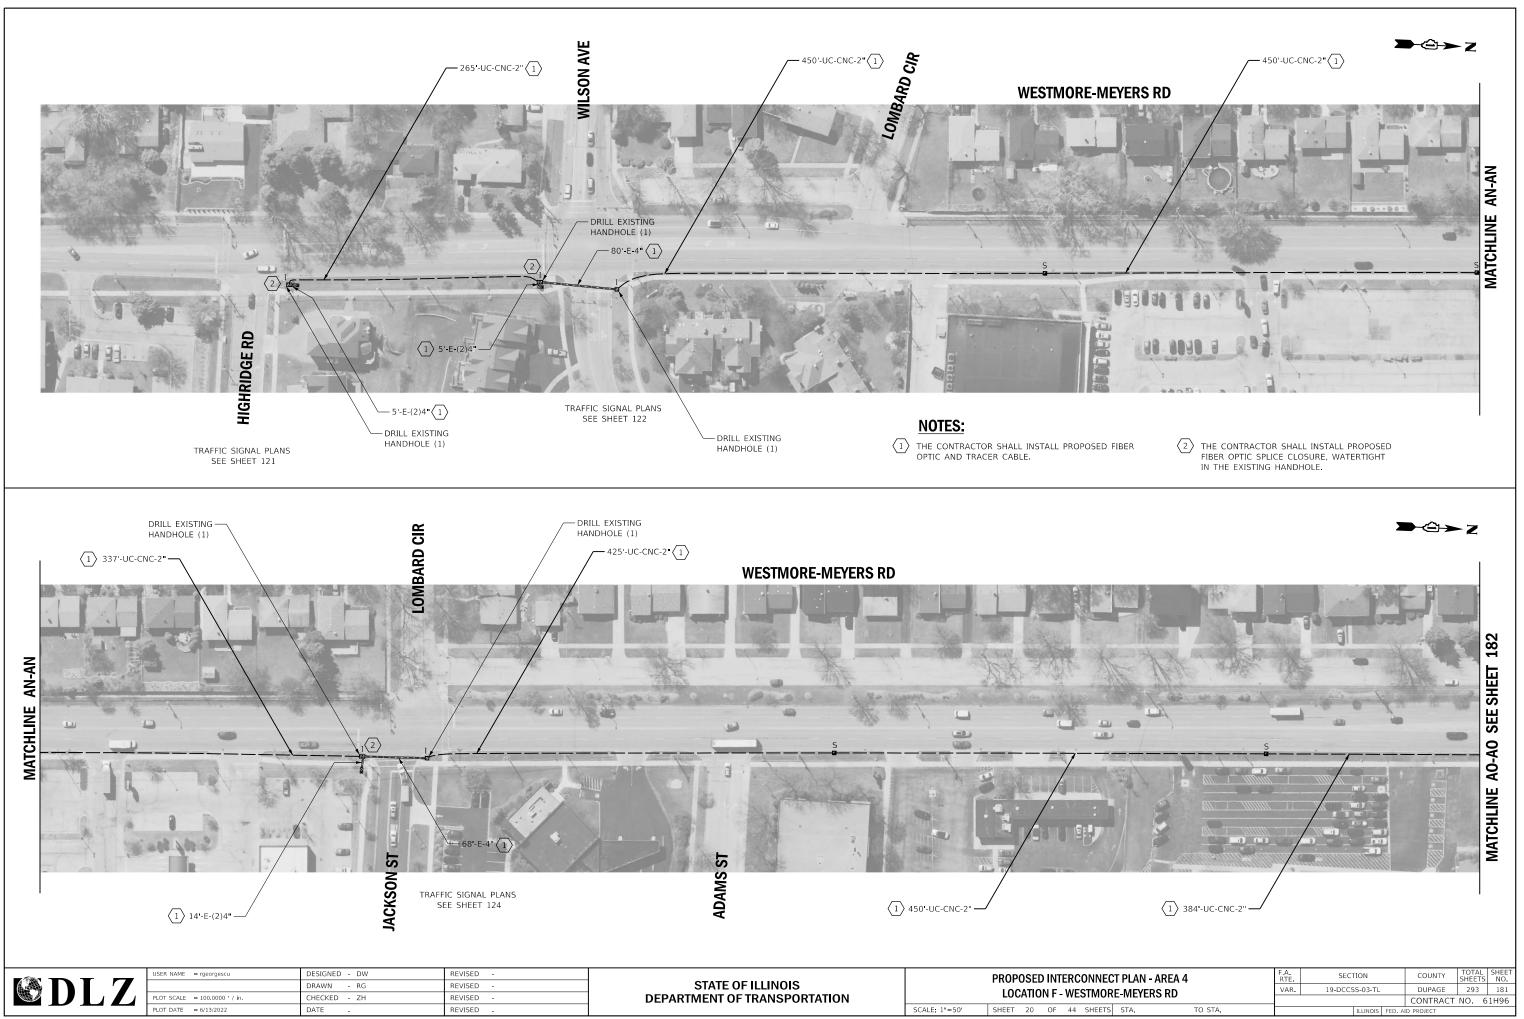

X:\Projects\2021\2182\217400 DuPage DOT Central\CADD_Sheets\sht-Int-A4-F-Westn Meyers.dgr

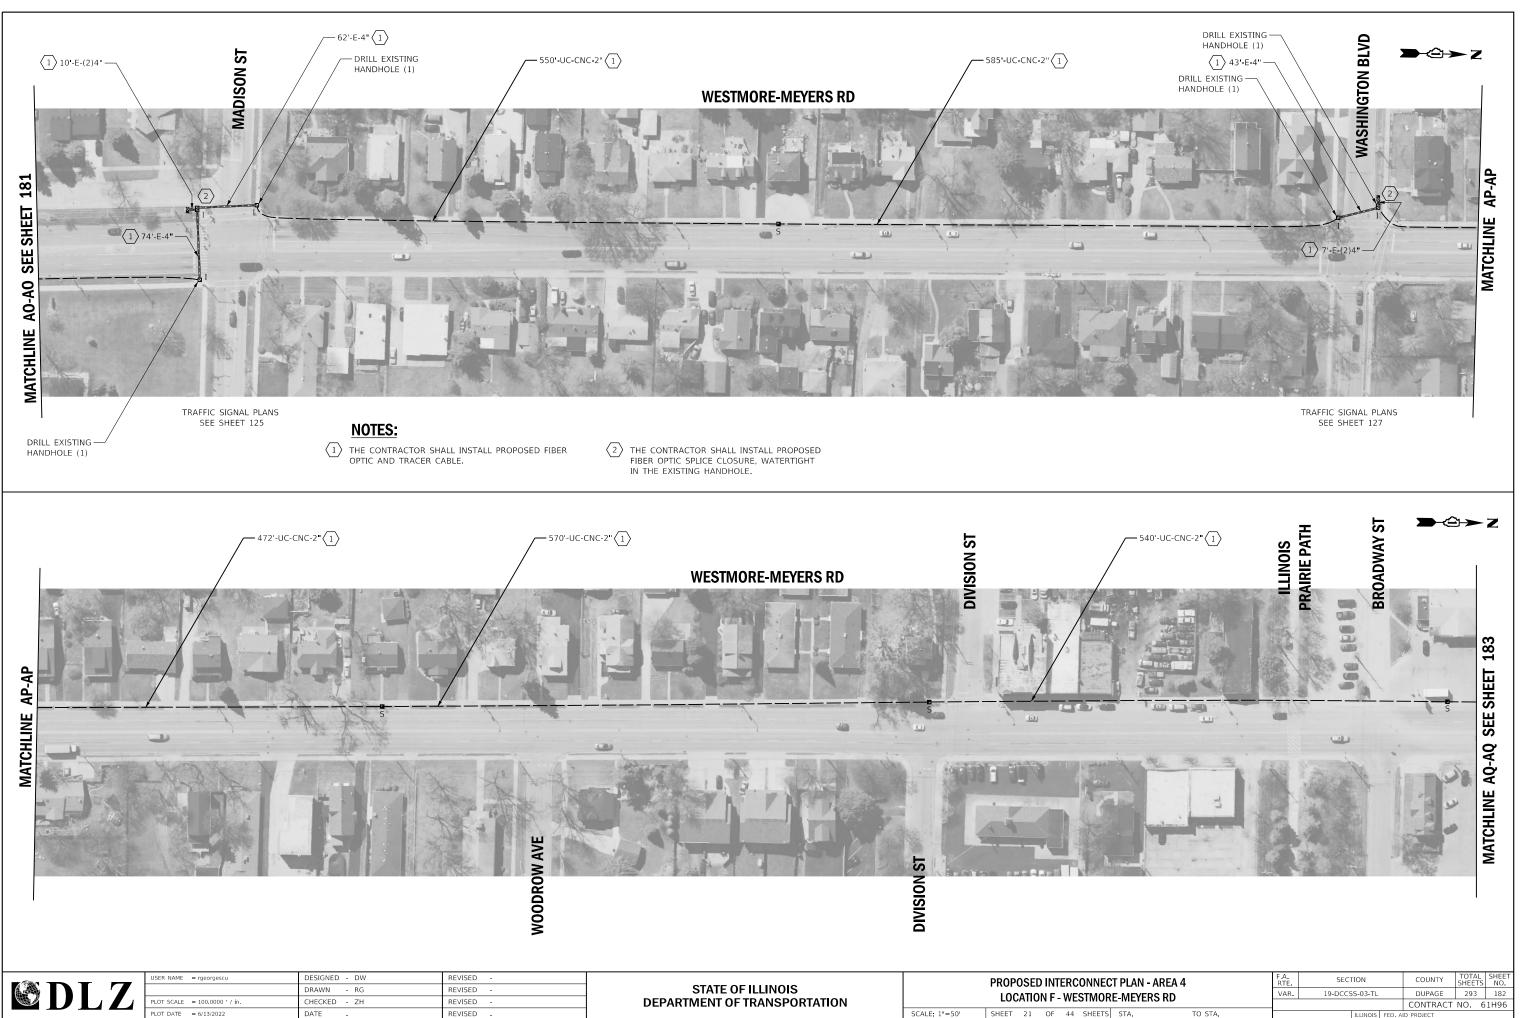


FILE NAME Default = X:\Projects\2021\2182\217400 DuPage DOT Central\CADD_Sheets\sht-Int-A4-F-Westn Meyers.dgr

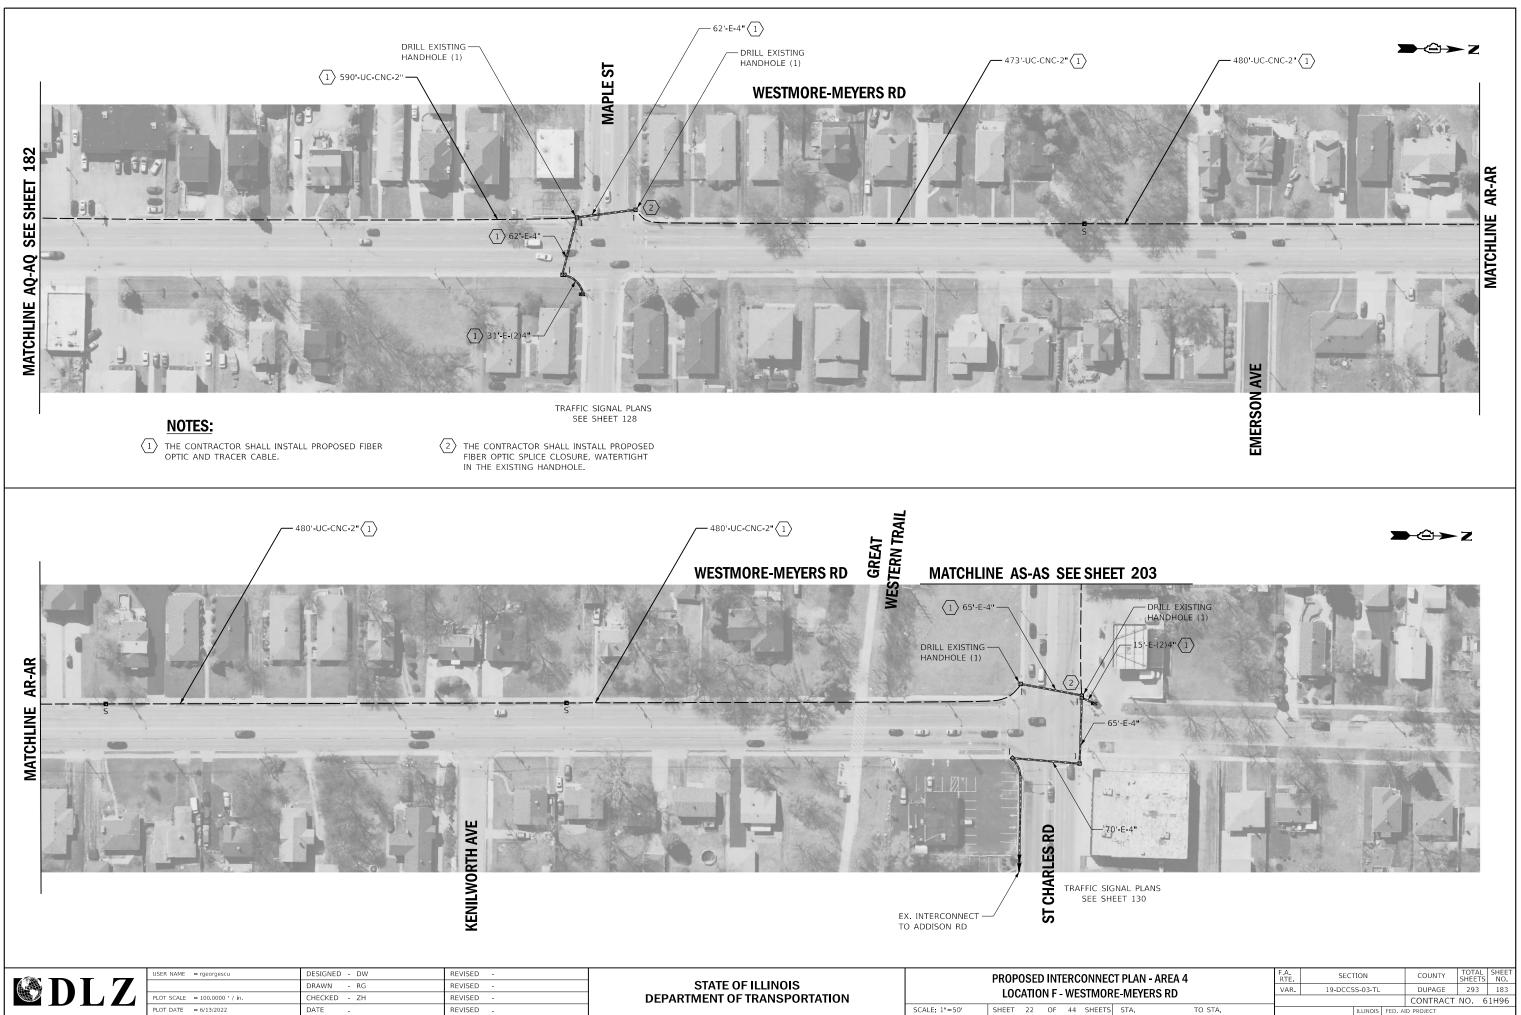


FILE NAME Default X:\Projects\2021\2182\217400 DuPage DOT Central\CADD_Sheets\sht-Int-A4-F-West Meyers.dgr

ECT PLAN - AREA 4			F.A. RTE	SECTION			COUNTY	TOTAL SHEETS	SHEET NO.
DRE-MEYERS RD		VAR.	19-DCCSS-03-TL			DUPAGE	293	183	
							CONTRACT	NO. 6	1H96
TS	STA.	TO STA.			ILLINOIS	FED. A	ID PROJECT		

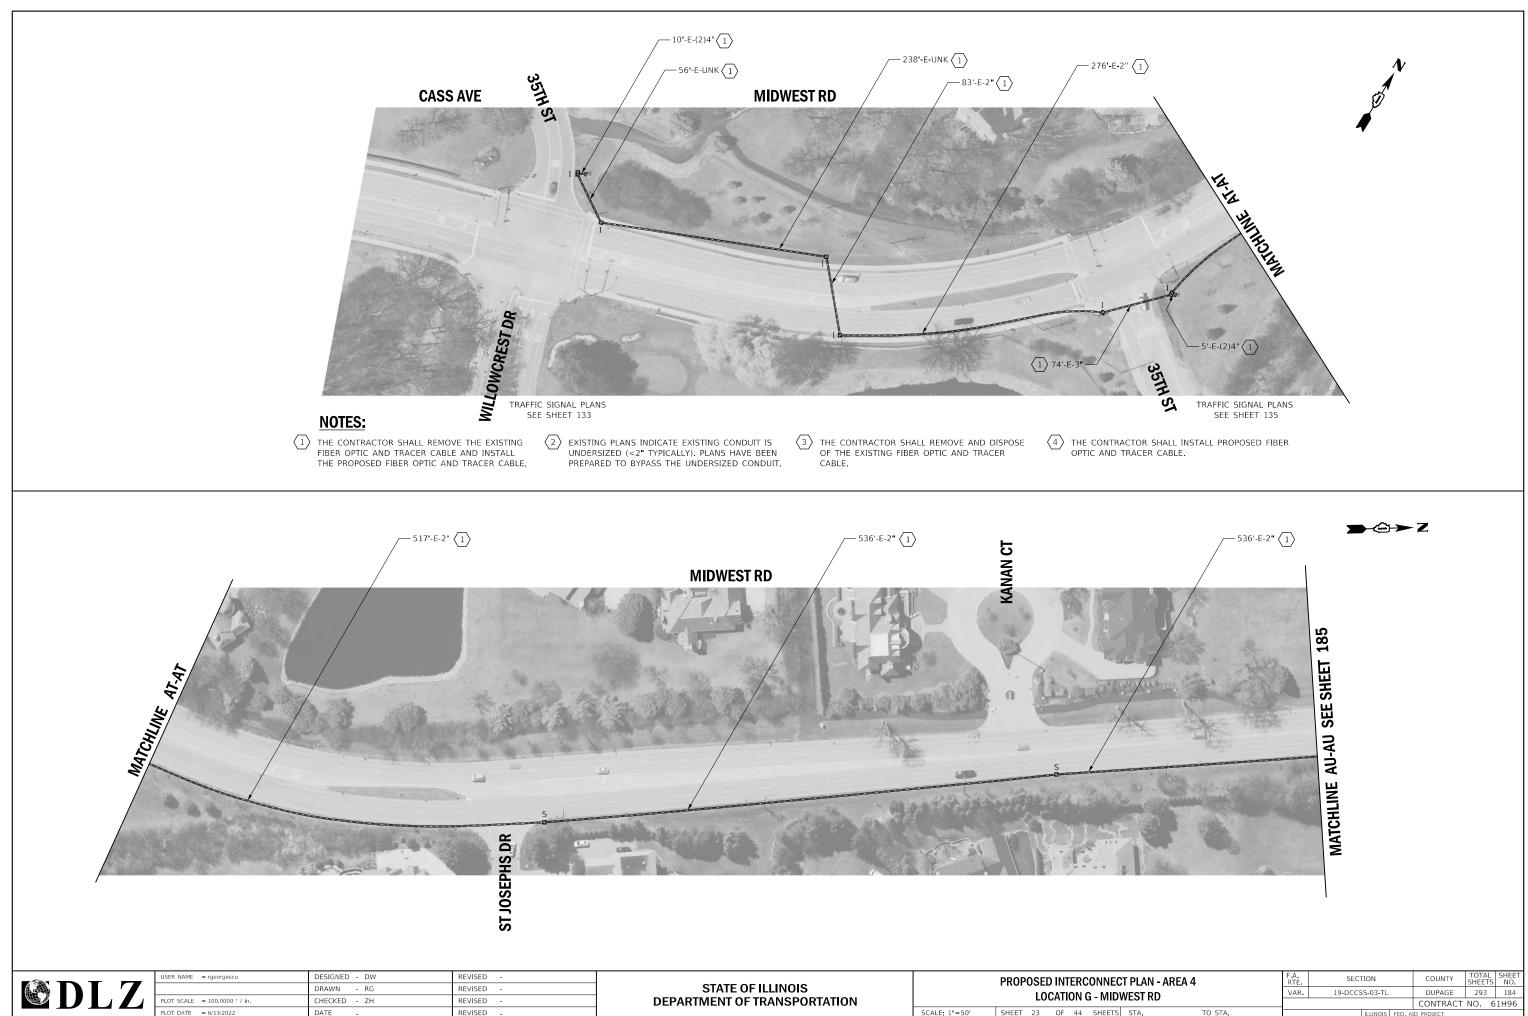


SCALE: 1"=50' SHEET 23 OF 44 SHEETS STA.

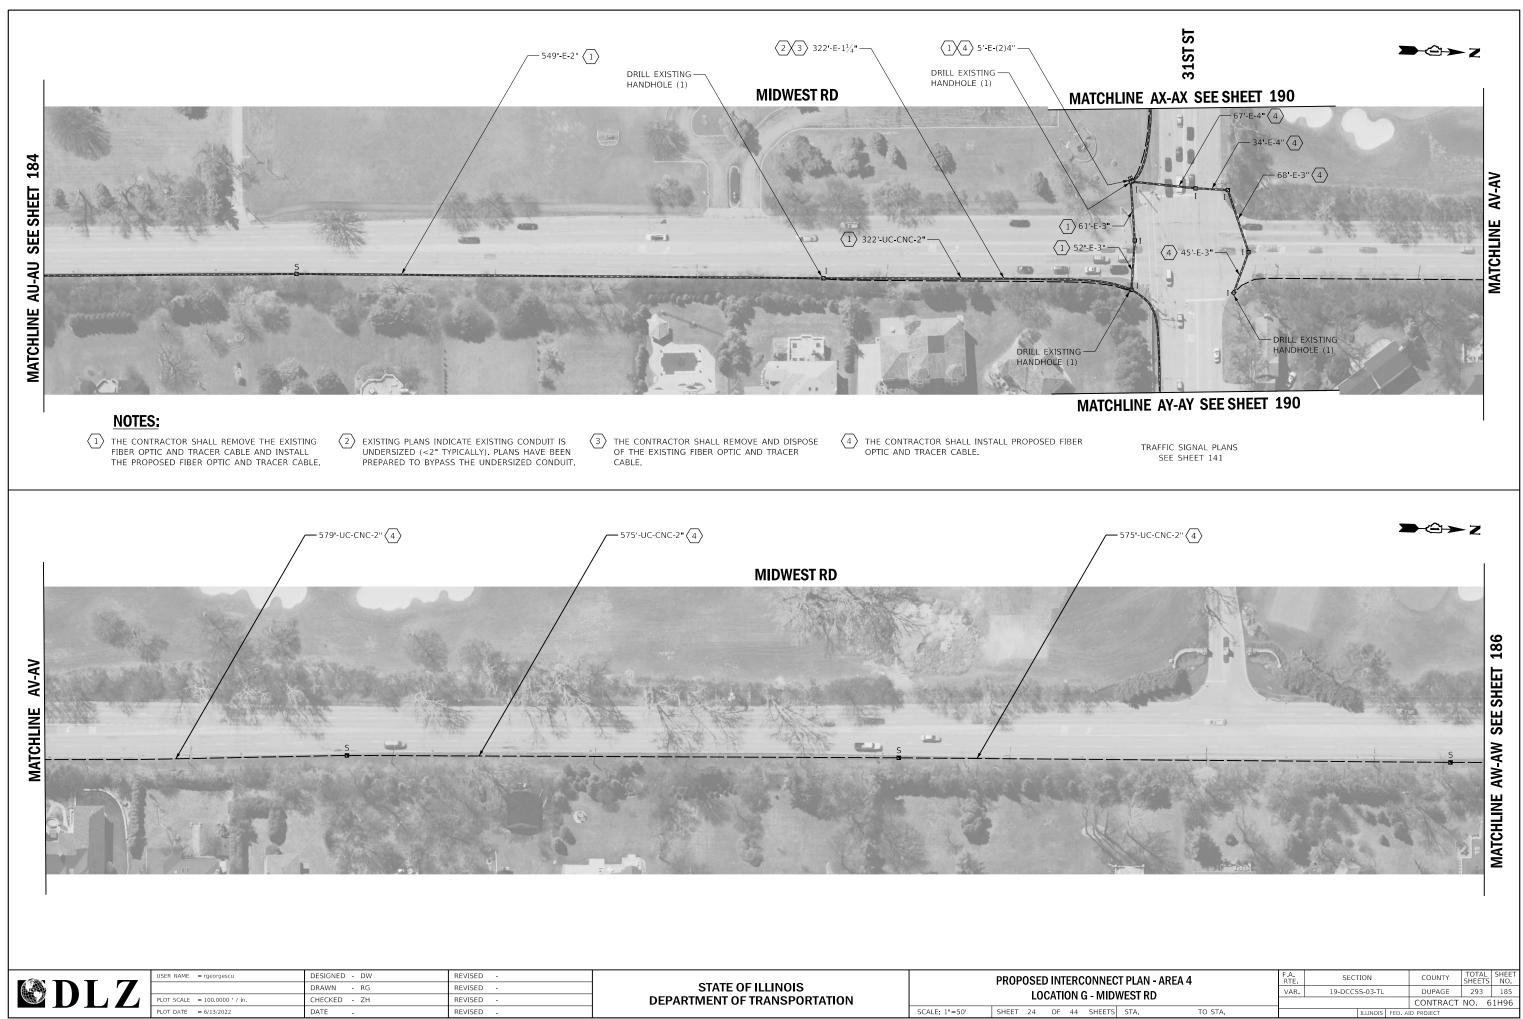


FILE NAME Default X:\Projects\2021\2182\217400 DuPage DOT Central\CADD_Sheets\sht-Int-A4-G-Midwe

ECT PLAN - AREA 4			F.A. RTE	SECTION			COUNTY	TOTAL SHEETS	SHEET NO.
DWEST RD		VAR.	VAR. 19-DCCSS-03-TL			DUPAGE	293	185	
							CONTRACT	NO. 6	1H96
TS	STA.	TO STA.			ILLINOIS	FED. AI	D PROJECT		

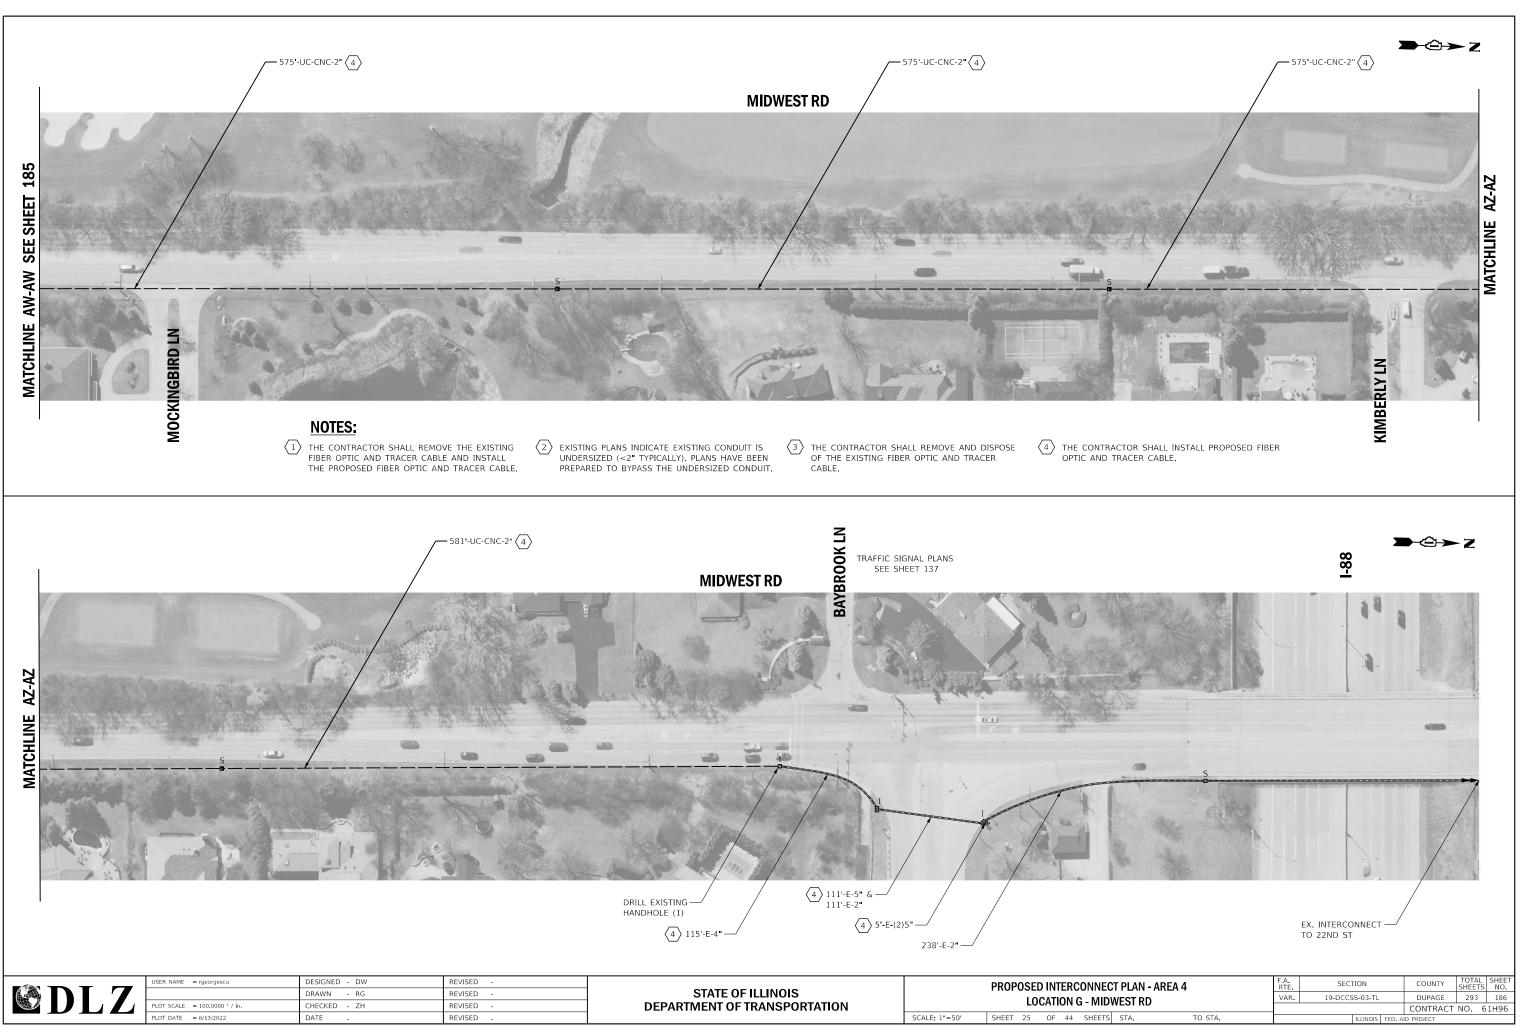


FILE NAME = X:\Projects\2021\2182\217400 DuPage DOT Central\CADD_Sheets\sht-Int-A4-G-Midwest

DuPage DOT Central\CADD_Sheets\sht-Int-A4-G-MIdwest,dgn

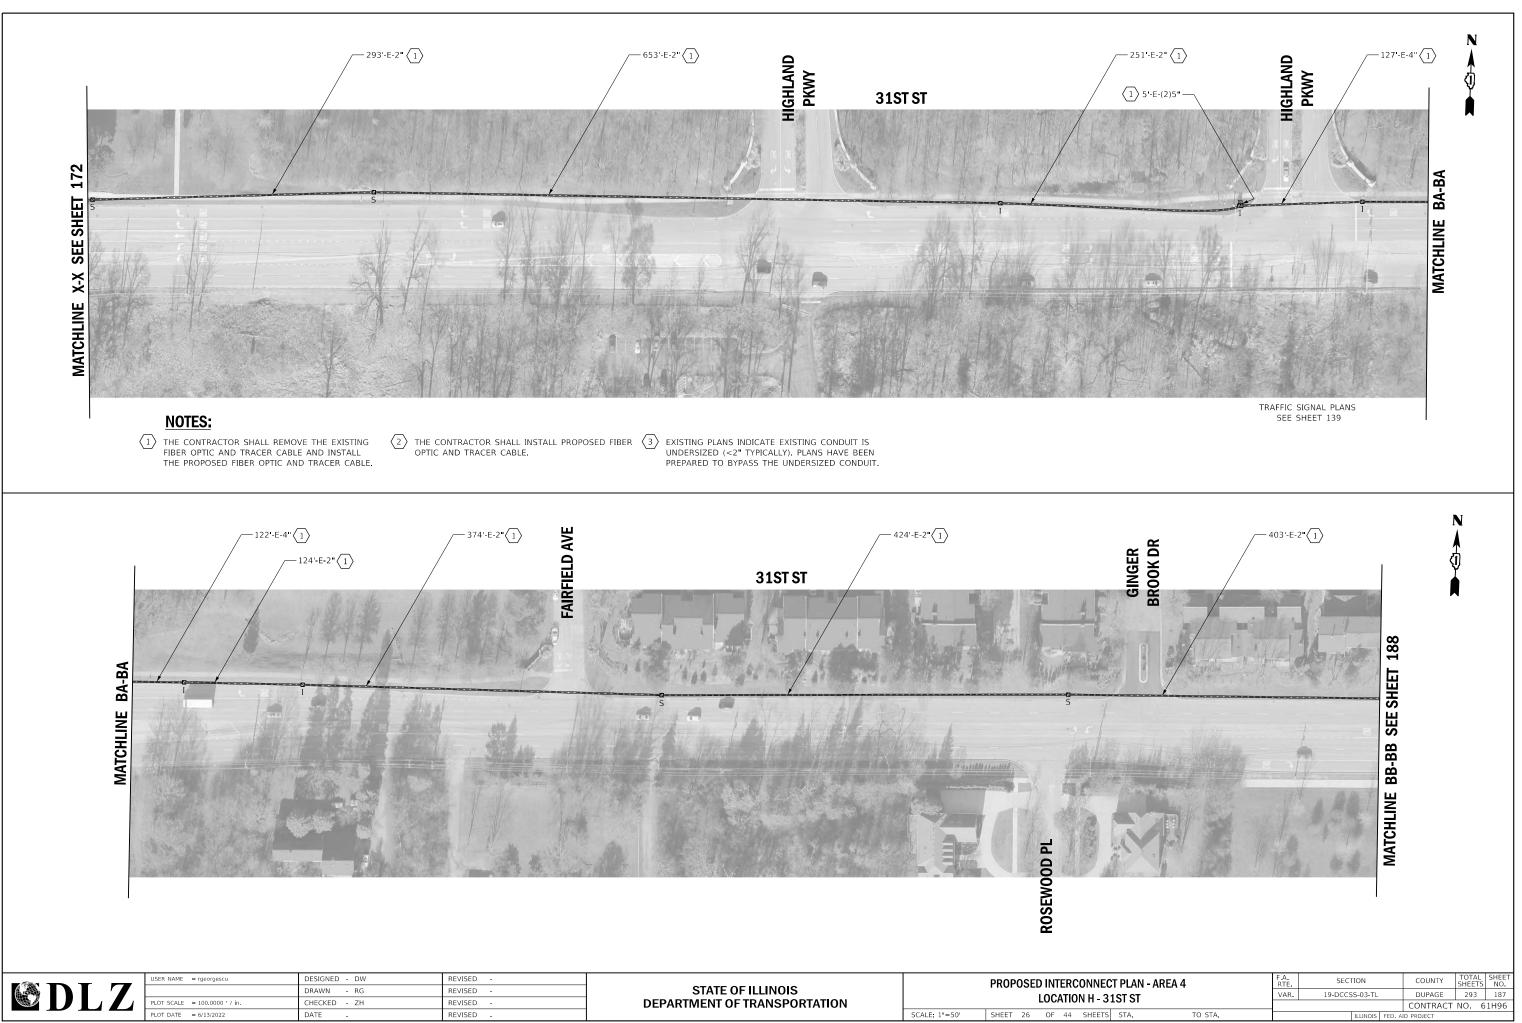

FILE NAME = X:\Projects\2021\2182\217400 DuPage DOT Central\CADD_Sheets\sht-Int-A4-H-31st.dgn Default

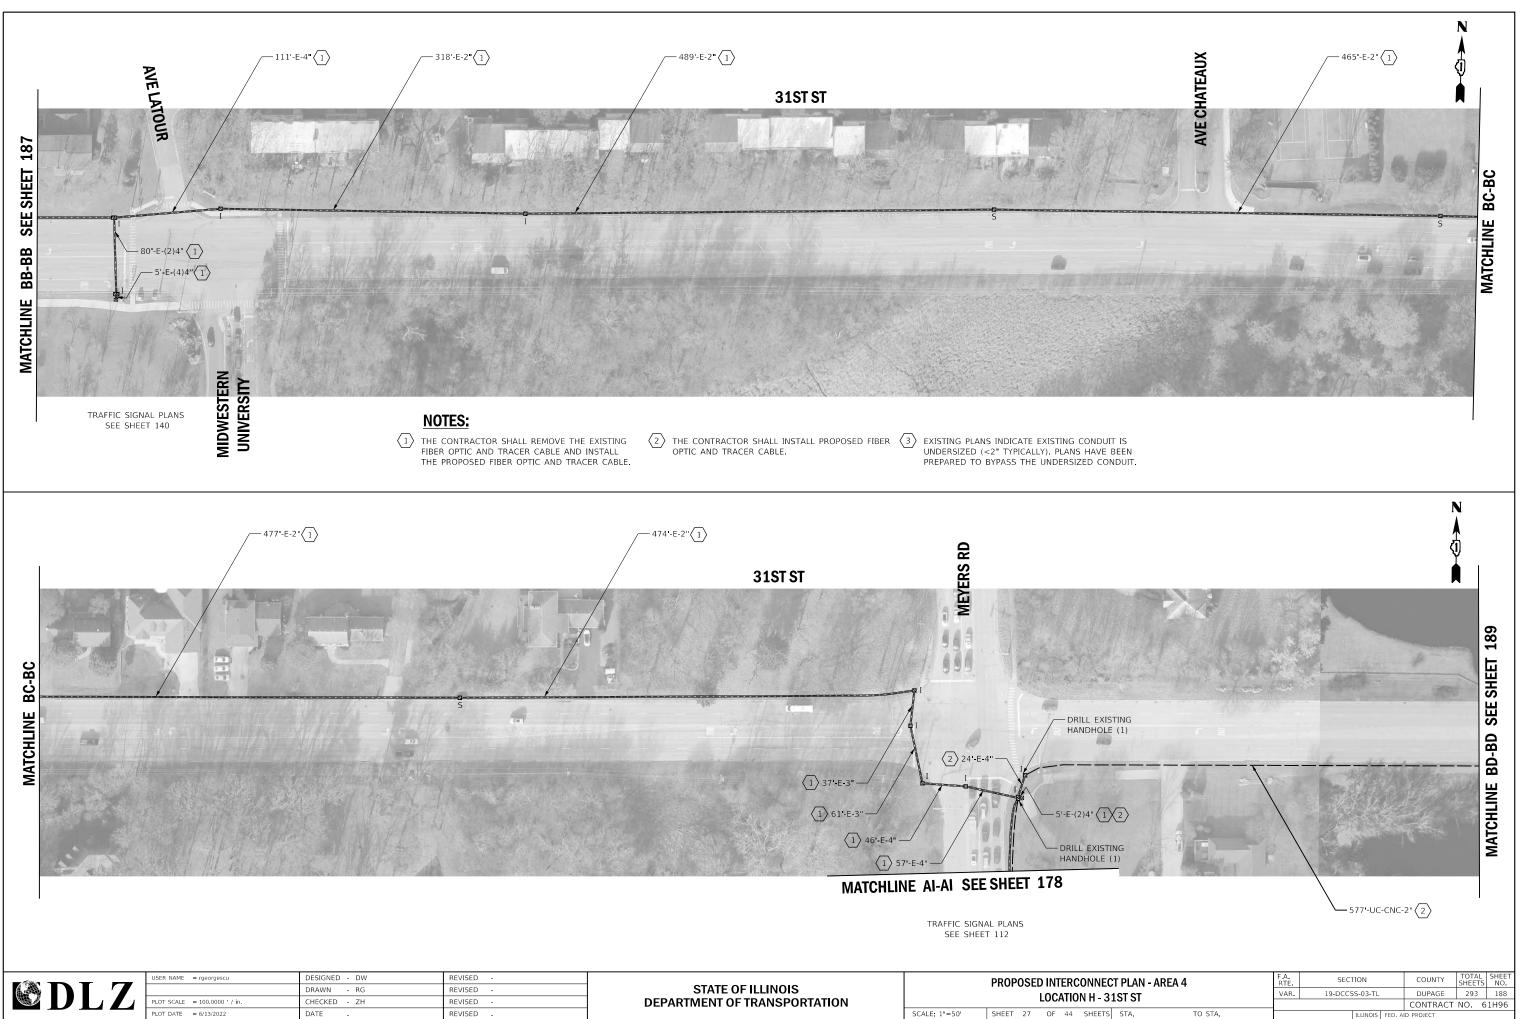

FILE NAME = X:\Projects\2021\2182\217400 DuPage DOT Central\CADD_Sheets\sht-Int-A4-H-31st.dgn Default



FILE NAME = X:\Projects\2021\2182\217400 DuPage DOT Central\CADD Sheets\sht-Int-A4-H-31st.dgn Default

ECT PLAN - AREA 4			F.A. RTE	SECTION			COUNTY	TOTAL SHEETS	SHEET NO.
31ST ST		VAR.	19-DCCSS-03-TL			DUPAGE	293	189	
01	101 01						CONTRACT	NO. 6	1H96
ΓS	STA.	TO STA.			ILLINOIS	FED. AI	ID PROJECT		



= X:\Projects\2021\2182\217400 DuPage DOT Central\CADD_Sheets\sht-Int-A4-H-31st.dgn FILE NAME Default


PLOT DATE = 6/13/2022

DATE

REVISED

2'	B1ST ST		VAR. 19-DCCSS-03-TL			DUPAGE	293	1	90	
	101 01						CONTRACT	NO.	61H	96
5	STA.	TO STA.			ILLINOIS	FED. A	ID PROJECT			

SCALE: 1"=50' SHEET 29 OF 44 SHEETS

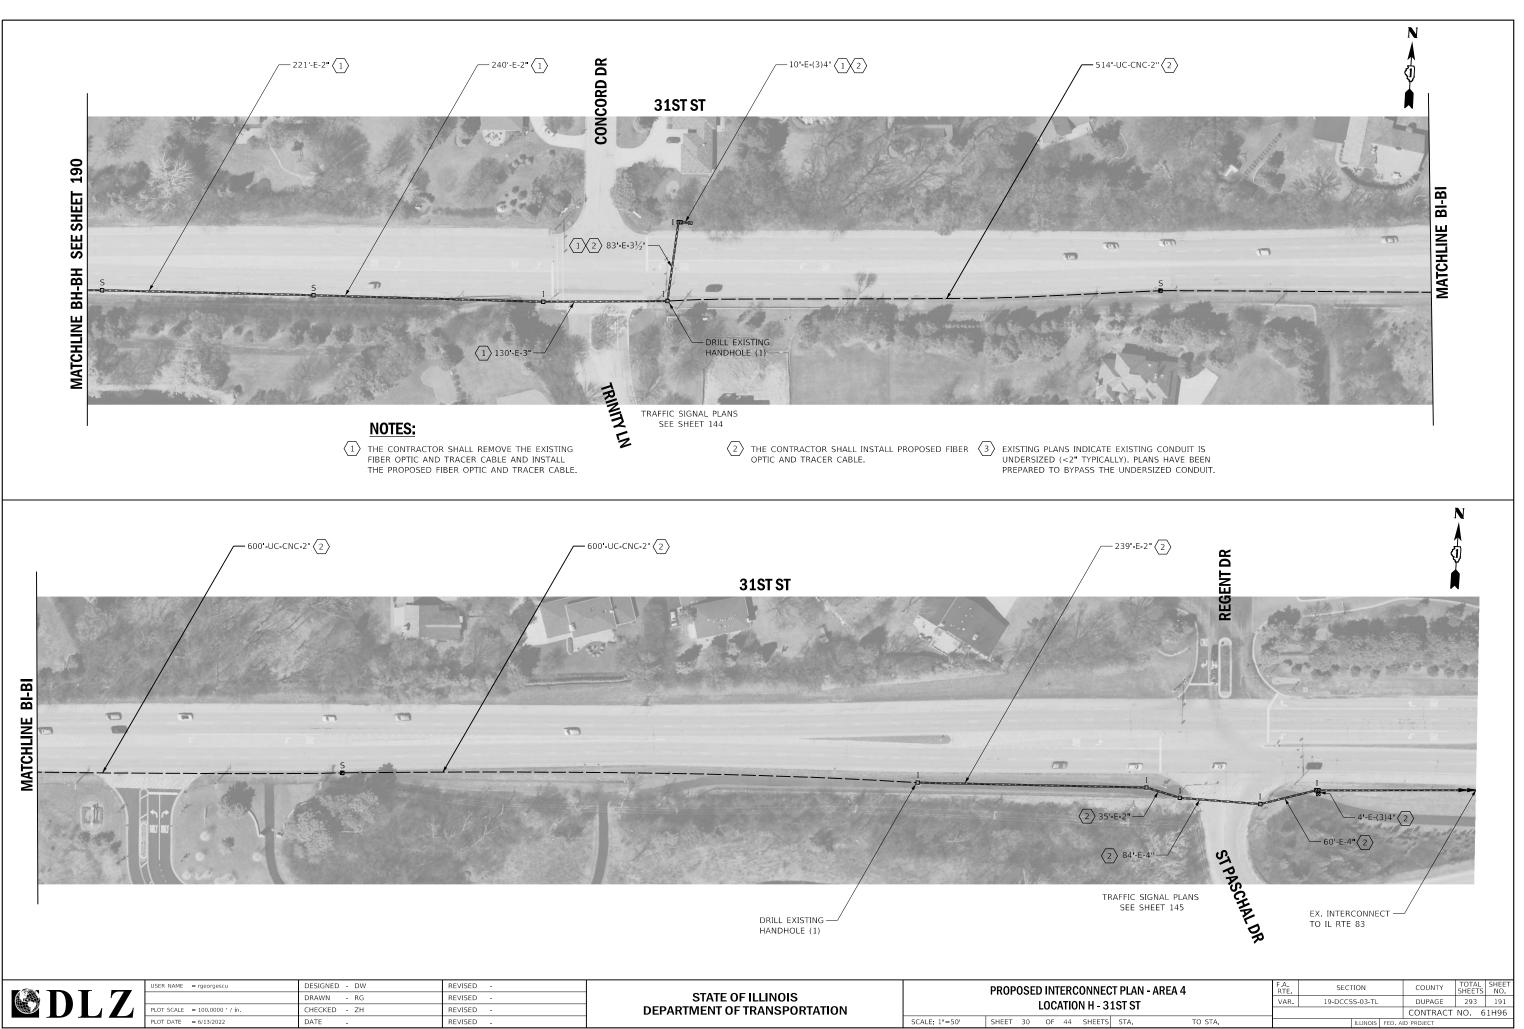


FILE NAME = X:\Projects\2021\2182\217400 DuPage DOT Central\CADD_Sheets\sht-Int-A4-H-31st.dgn Default



FILE NAME Default X:\Projects\2021\2182\217400 DuPage DOT Central\CADD_Sheets\sht-Int-A4-I-22nd.dg




FILE NAME Default X:\Projects\2021\2182\217400 DuPage DOT Central\CADD_Sheets\sht-Int-A4-I-22nd.dg

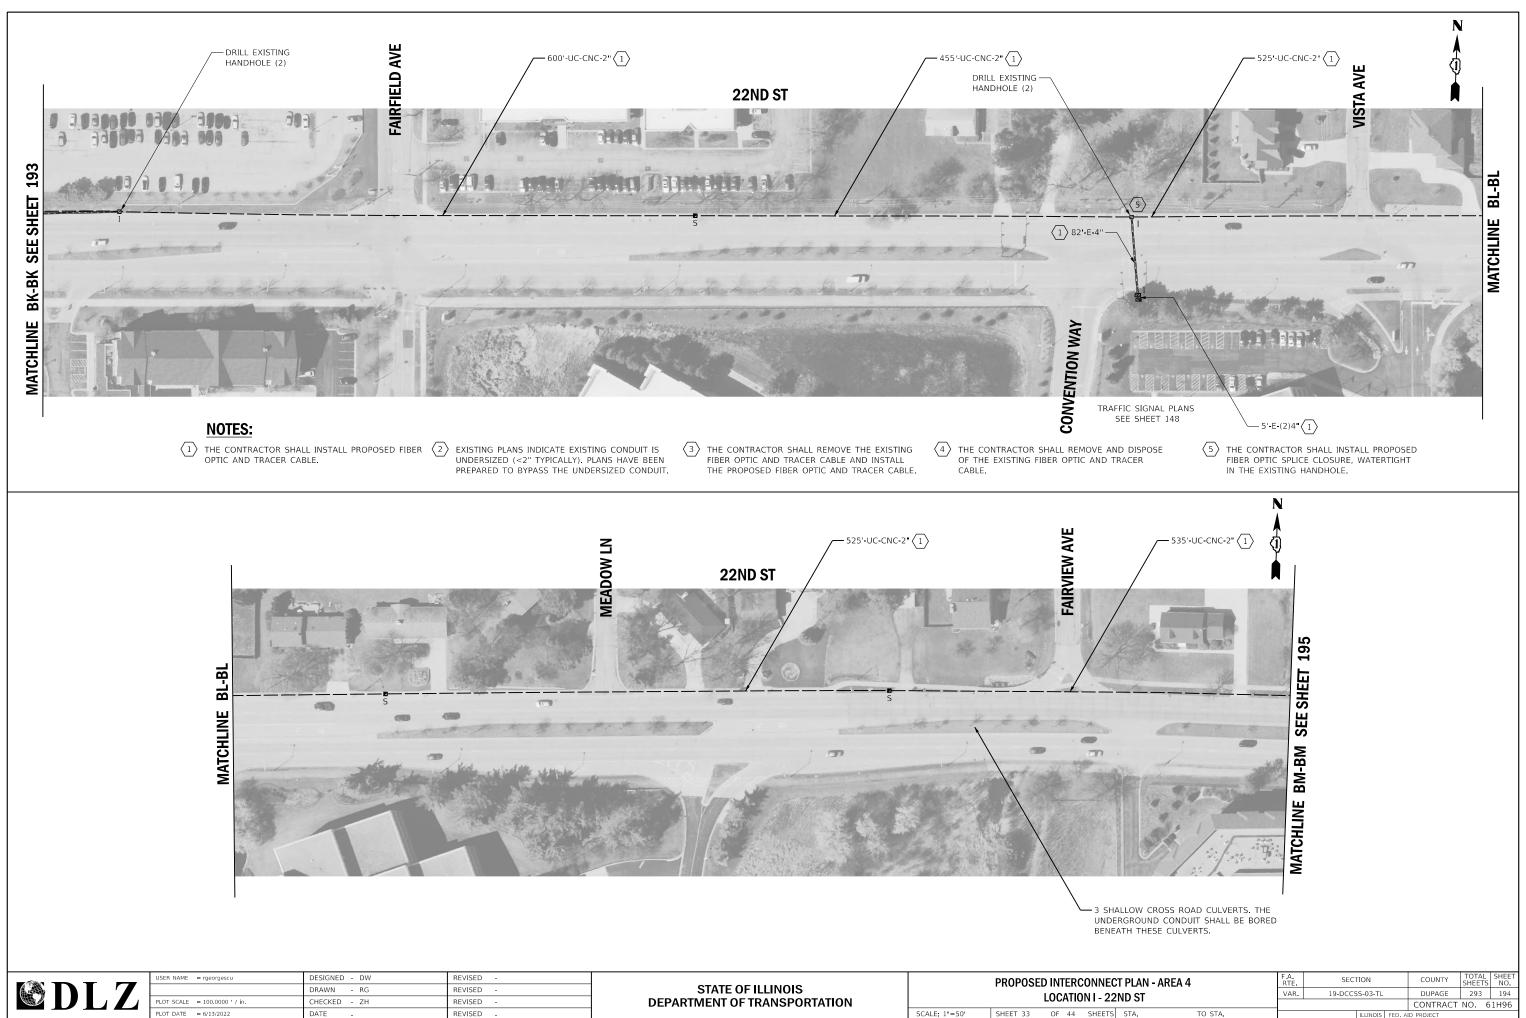

FILE NAME Default = X:\Projects\2021\2182\217400 DuPage DOT Central\CADD_Sheets\sht-Int-A4-I-22nd.dg

TO STA.

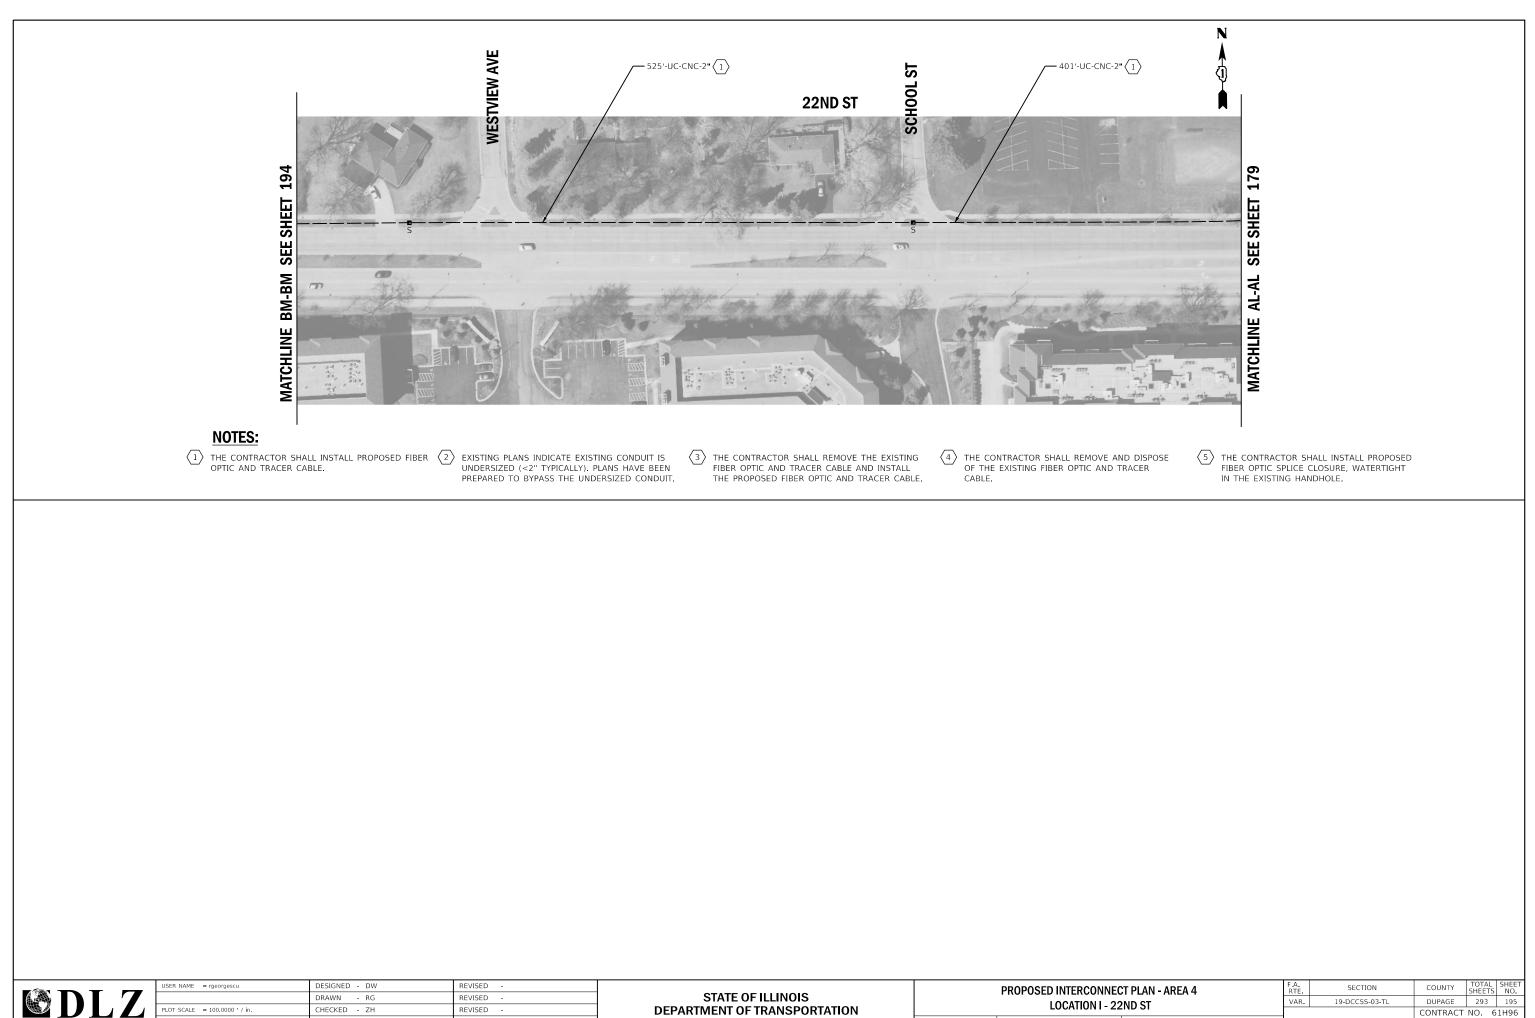


PLOT DATE = 6/13/2022

DATE

REVISED

2ND ST		VAR.	VAR. 19-DCCSS-03-TL			DUPAGE	293	195	
2110 01						CONTRACT	NO.	61H96	
5	STA.	TO STA.			ILLINOIS	FED. A	ID PROJECT		

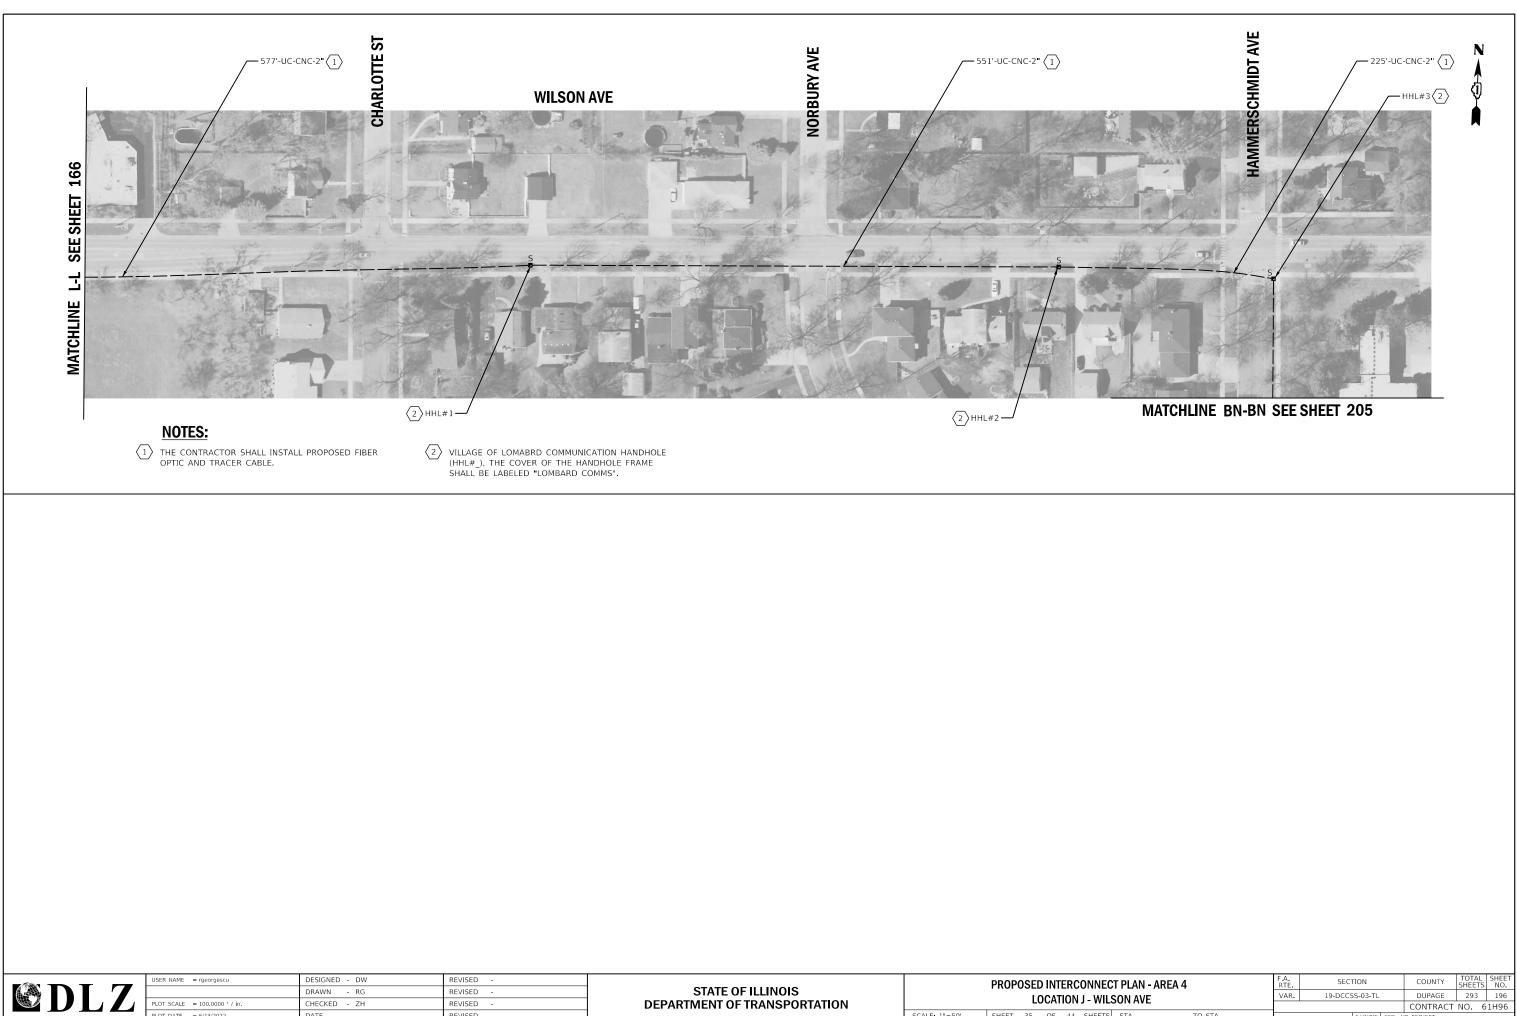


FILE NAME	=	X:\Projects\2021\2182\217400	DuPage DOT	Central\CADD	Sheets\sht-Int-A4-J-Wilson.dgn
Default					

PLOT DATE = 6/13/2022


DATE

REVISED

					CONTRACT	NO.
IEETS	STA.	TO STA.	ILLINOIS	FED. AI	ID PROJECT	

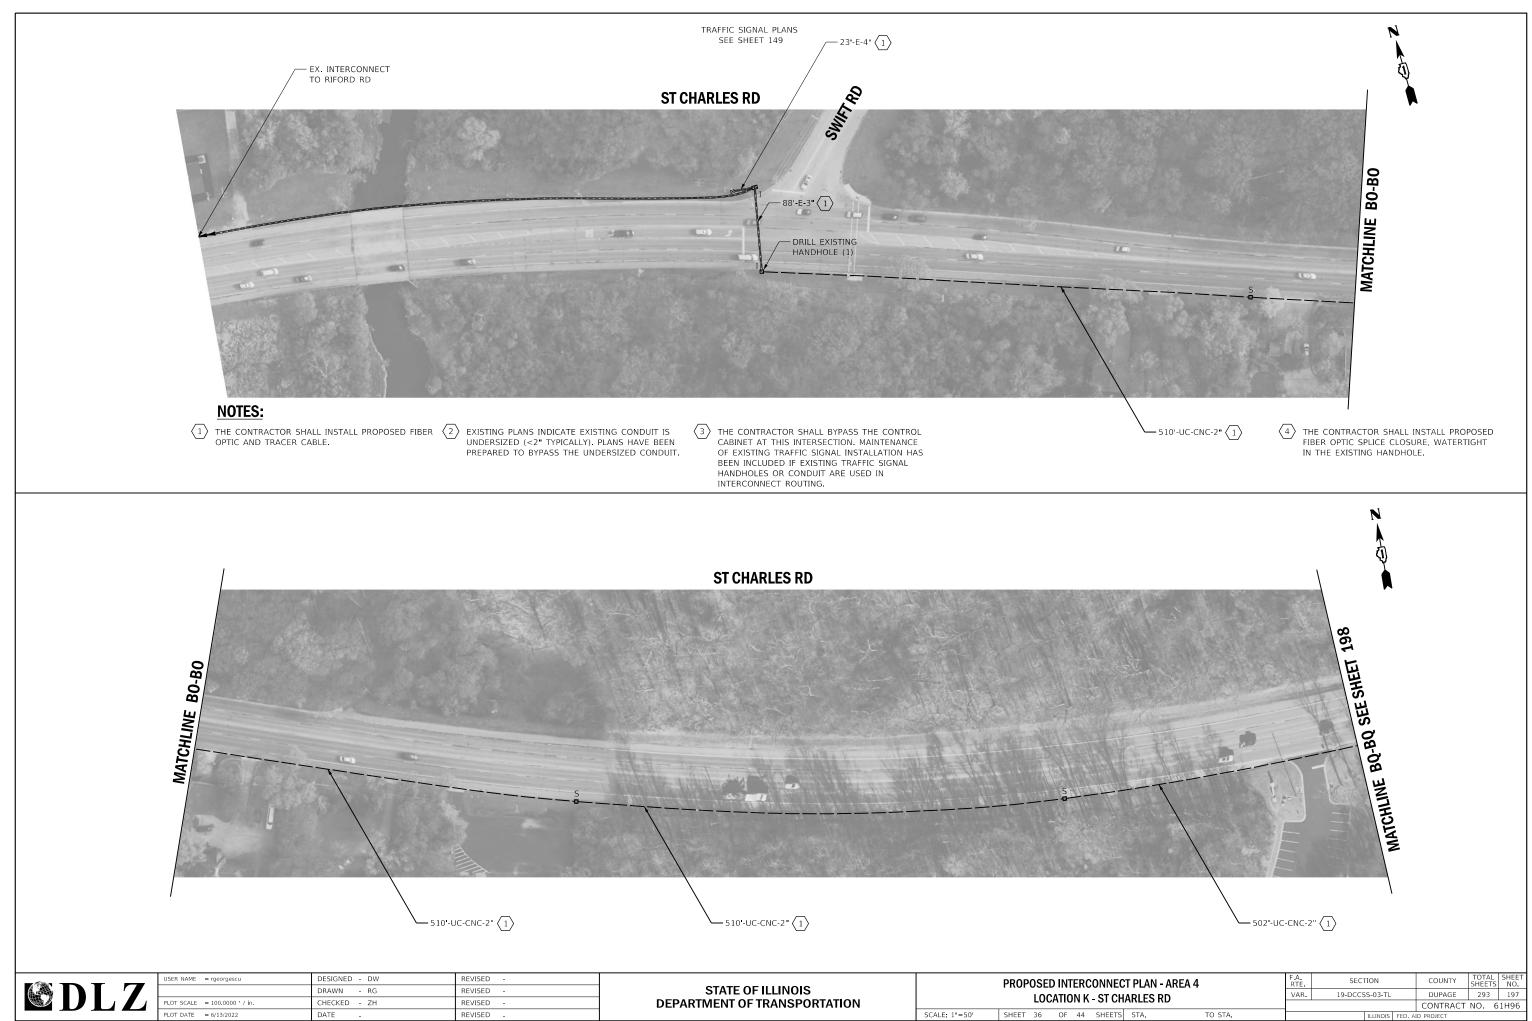


FILE NAME = X:\Projects\2021\2182\217400 DuPage DOT Central\CADD Sheets\sht-Int-A4-K-St Charles.dgn Default

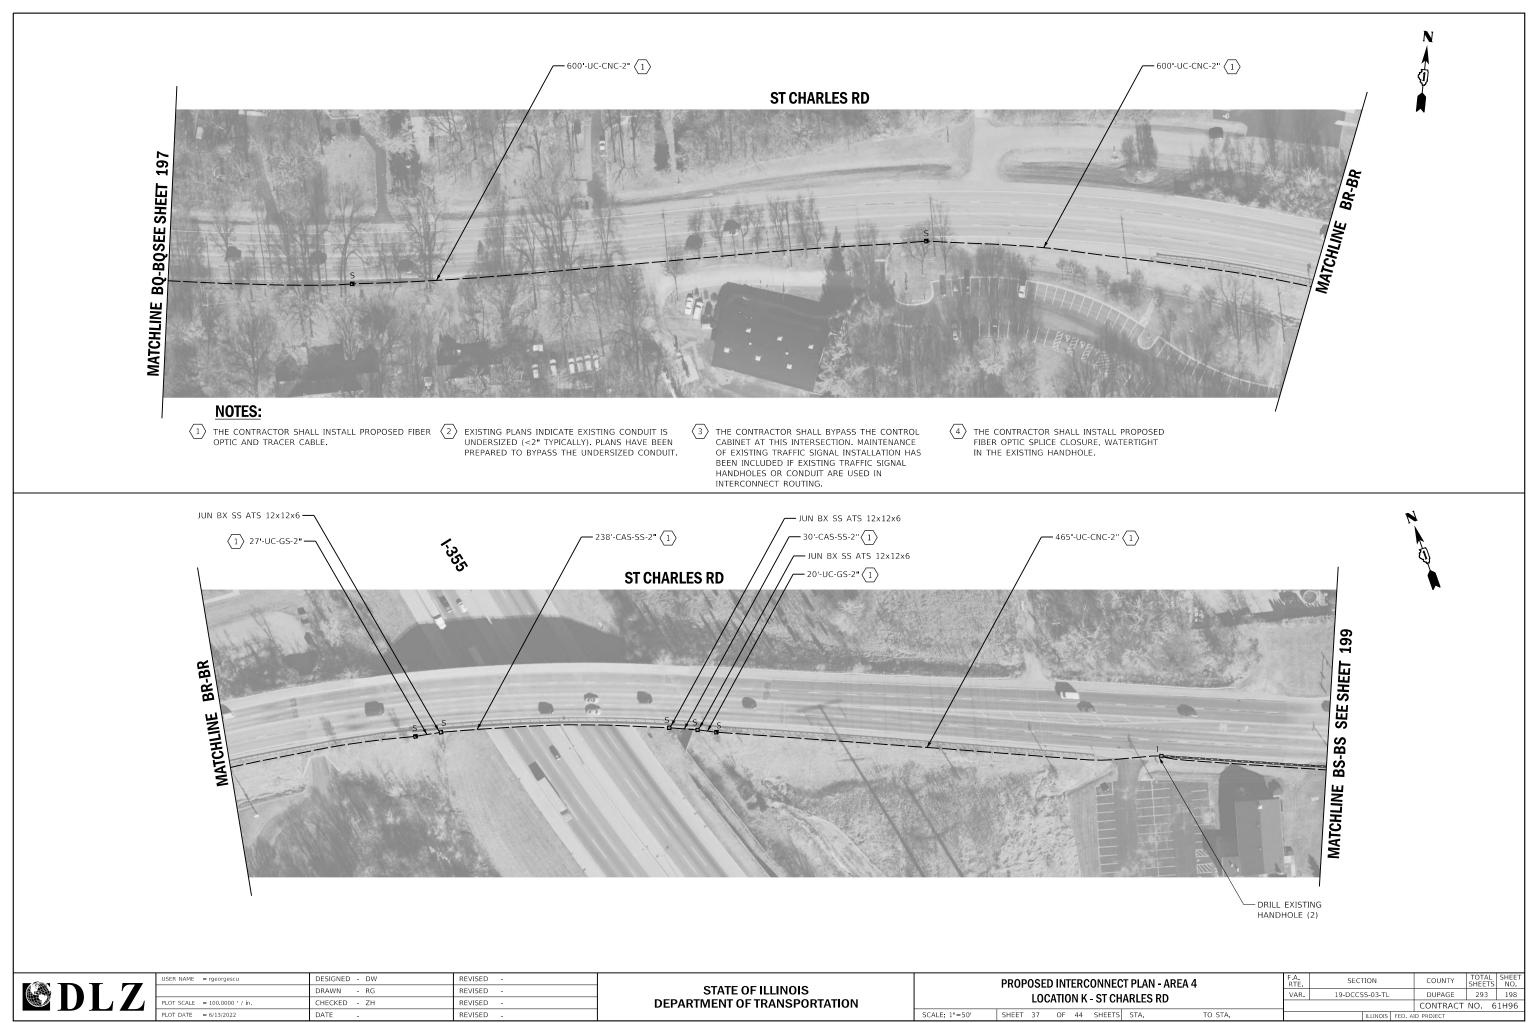



X:\Projects\2021\2182\217400 DuPage DOT Central\CADD_Sheets\sht-Int-A4-K-St Charles dgr

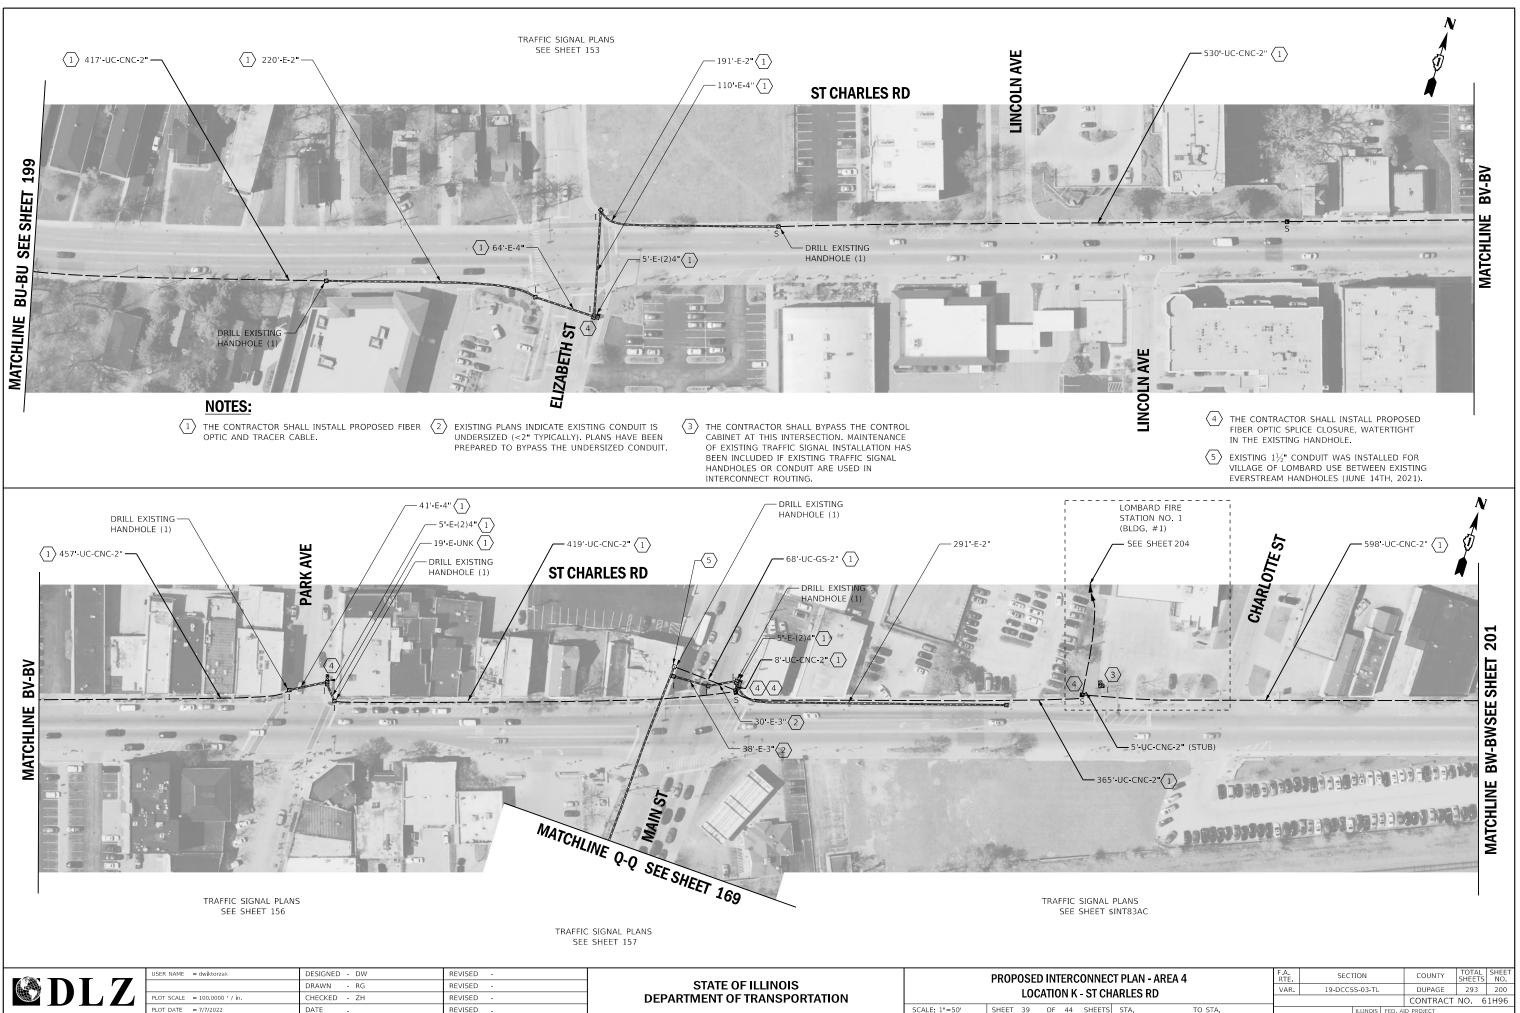

X:\Projects\2021\2182\217400 DuPage DOT Central\CADD_Sheets\sht-Int-A4-K-St Charles.dgr

SCALE: 1"=50' SHEET 39 OF 44 SHEETS STA.