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SPRINGINSGUTH ROAD PLANS

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STATE OF ILLINOIS **DEPARTMENT OF TRANSPORTATION DIVISION OF HIGHWAYS**

PLANS FOR PROPOSED FEDERAL AID HIGHWAY

FAU 2562 (SPRINGINSGUTH ROAD) FROM FAU 1338 (WISE ROAD) TO FAU 1322 (SCHAUMBURG ROAD) **RESURFACING** SECTION 10-00104-00-RS PROJECT NO. M-9003(703) **COOK COUNTY** VILLAGE OF SCHAUMBURG

JOB #: C-91-761-10

000001-05 STANDARD SYMBOLS, ABBREVIATIONS AND PATTERNS 280001-05 TEMPORARY EROSION CONTROL SYSTEMS 424001-05 **CURB RAMPS FOR SIDEWALKS** 442201-03 CLASS C AND D PATCHES SPRINGINSGUTH ROAD 602001--01 CATCH BASIN TYPE A **IMPROVEMENT ENDS** 604001-03 FRAME AND LIDS, TY 1 STATION 76+40 604051-03 FRAME AND GRATE, TY 11 CONCRETE CURB TY B AND COMBINATION CONCRETE CURB & GUTTER 701606-06 URBAN LANE CLOSURE, MULTILANE, 2W WITH MOUNTABLE MEDIAN 701701-06 **URBAN LANE CLOSURE, MULTILANE INTERSECTION** LANE CLOSURE MULTILANE 1W OR 2W CROSSWALK OR SIDEWALK CLOSURE SPRINGINSGUTH ROAD


IMPROVEMENT BEGINS

STATION 5+63

FULL SIZE PLANS HAVE BEEN PREPARED USING STANDARD ENGINEERING SCALES. REDUCED SIZED PLANS WILL NOT CONFORM TO STANDARD SCALES. IN MAKING MEASUREMENTS ON REDUCED PLANS, THE ABOVE SCALES MAY BE USED.

J.U.L.I.E. JOINT UTILITY LOCATION INFORMATION FOR EXCAVATION 1-800-892-0123

ADT = 15,300 (2007)POSTED SPEED LIMIT = 30 MPH DESIGN SPEED = 30 MPH**DESIGN DESIGNATION = URBAN COLLECTOR** CONTRACT NO. 63500

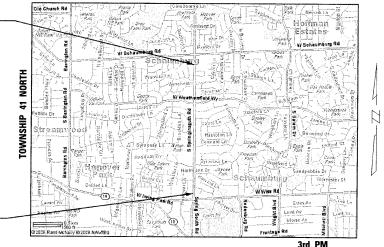


LOCATION MAP SCALE: 1" = 2500' SCHAUMBURG TOWNSHIP GROSS LENGTH = 7077 FT. = 1.34 MILES NET LENGTH = 7077 FT. = 1.34 MILES

PROJECT LOCATED IN THE VILLAGE OF SCHAUMBURG

F.A.U. RTE.		SECTION				COUNTY	TOTAL SHEETS	SHEET NO.	
2562		10-00	104-	00-F	RS	соок	21	1	
FED.	ROAD	DIST	NO.	1	ILLINOIS	CONTRACT	NO. 6	3500	



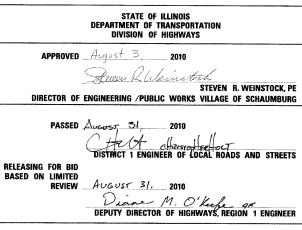

PRINTED BY THE AUTHORITY OF THE STATE OF ILLINOIS



HAMPTON, LENZINI AND RENWICK, INC. 380 SHEPARD DRIVE

PROJECT NUMBER: 10.0038.330 DATE: 4/6/2010

SPECIFICATIONS, STANDARDS, AND SPECIAL PROVISIONS

ALL CONSTRUCTION SHALL BE DONE IN ACCORDANCE WITH THE "STANDARD SPECIFICATIONS FOR ROAD AND BRIDGE CONSTRUCTION," ADDRED JANUARY 1, 2007 (HEREINAFTER REFERRED TO AS THE STANDARD SPECIFICATIONS; THE "SUPPLEMENTAL SPECIFICATIONS AND RECURRING SPECIAL PROVISIONS," ADDRED JANUARY 1, 2010; THE LATEST EDITION OF THE "ILLINOIS MANUAL ON UNIFORM TRAFFIC CONTROL DEVICES FOR STREETS AND HIGHWAYS"; THE "STANDARD SPECIFICATIONS FOR WATER & SEWER MAIN CONSTRUCTION IN ILLINOIS", LATEST EDITION; THE DETAILS IN THE PLANS; AND THE SPECIAL PROVISIONS INCLUDED IN THE CONTRACT DOCUMENTS.

ALL TRAFFIC CONTROL AND OTHER ADVISORY SIGNS NEEDED FOR CONSTRUCTION ARE TO BE FURNISHED BY THE CONTRACTOR IN ACCORDANCE WITH ARTICLE 107.14 OF THE STANDARD SPECIFICATIONS.

THE CONTRACTOR SHALL AT ALL TIMES PROVIDE PROTECTION FOR TRAFFIC AS CALLED FOR IN THE APPLICATION OF TRAFFIC CONTROL DEVICES, THE STANDARD SPECIFICATIONS, THE SPECIAL PROVISIONS, AND THE PLANS.

UTILITIES

THE CONTRACTOR SHALL BE RESPONSIBLE FOR CONTACTING THE OWNERS OF ALL UTILITIES PRIOR TO CONSTRUCTION TO DETERMINE THE LOCATION OF ALL UTILITY EQUIPMENT. THE CONTRACTOR SHALL COOPERATE WITH ALL UTILITY OWNERS AS PROVIDED FOR IN THE STANDARD SPECIFICATIONS IF UTILITY RELOCATION, ADJUSTMENT, OR PROTECTION IS NECESSARY.

THE LOCATION OF EXISTING DRAINAGE STRUCTURES, STORM SEWERS, WATER MAINS, SANITARY SEWERS, AND ANY OTHER PUBLIC OR PRIVATE UTILITIES AS SHOWN ON THE PLANS IS APPROXIMATE, AND THEIR EXACT LOCATION IS TO BE DETERMINED IN THE FIELD BY THE CONTRACTOR. THIS WORK SHALL BE CONSIDERED INCLUDED IN THE COST OF THE CONTRACT.

THE CONTRACTOR SHALL BE RESPONSIBLE FOR THE PROTECTION OF ALL UNDERGROUND AND SUPFACE UTILITIES EVEN THOUGH THEY MAY NOT BE SHOWN ON THE PLANS, ANY UTILITY THAT IS DAMAGED DURING CONSTRUCTION SHALL BE REPAIRED OR REPLACED TO THE SATISFACTION OF THE OWNER IN ACCORDANCE WITH 105.07 AND 107.31.

STAKING

SURVEYED PLOTTED ALIGNMENT RT. OF WAY CADD FILE ALL OFFSET LOCATIONS GIVEN ON THE DETAILED PLANS FOR STRUCTURES, BACKS OF CURB, ETC. ARE FROM THE CENTERLINE AS SHOWN ON THE PLANS.

SEWERS AND WATER MAINS

ANY LOOSE MATERIAL DEPOSITED IN THE FLOW LINE OF DRAINAGE STRUCTURES WHICH OBSTRUCTS THE NATURAL FLOW OF WATER SHALL BE REMOVED AT THE CLOSE OF EACH WORKING DAY. PRIOR TO ACCEPTANCE OF THE IMPROVEMENT, ALL DRAINAGE STRUCTURES SHALL BE FREE OF DIRT AND DEBRIS. THIS WORK WILL NOT BE PAID FOR SEPARATELY BUT SHALL BE CONSIDERED INCLUDED IN THE COST OF THE CONTRACT.

WHEN EXISTING DRAINAGE FACILITIES ARE DISTURBED, THE CONTRACTOR SHALL PROVIDE AND MAINTAIN IN AN OPERATING CONDITION TEMPORARY OUTLETS AND CONNECTIONS FOR ALL DRAINS, SEWERS, AND CATCH BASINS. THE CONTRACTOR SHALL PROVIDE FACILITIES WHICH HAVE THE CAPACITY TO RECEIVE AND DISCHARGE THE STORM WATER FLOW RATES NORMALLY ACCEPTED AND RELEASED BY EXISTING DRAINAGE FACILITIES. THIS WORK WILL NOT BE PAID FOR SEPARATELY BUT SHALL BE CONSIDERED INCLUDED IN THE COST OF THE CONTRACT, UNLESS OTHERWISE NOTED IN THE JOANS.

THE CONTRACTOR SHALL NOTIFY THE VILLAGE OF SCHAUMBURG PUBLIC WORKS DEPARTMENT ONE WEEK IN ADVANCE OF ALL WATER MAIN SHUT DOWNS. UNDER NO CIRCUMSTANCE SHALL THE CONTRACTOR OPERATE ANY VALVES OR HYDRANTS.

SIGNS

PRIOR TO THE START OF CONSTRUCTION, THE CONTRACTOR, ENGINEER AND VILLAGE MAINTENANCE PERSONNEL SHALL INVENTORY THE LOCATION, SIZE, TYPE AND CONDITION OF ALL EXISTING SIGNS. ANY SIGN DAMAGED DURING CONSTRUCTION OR STORAGE SHALL BE REPLACED AT THE CONTRACTOR'S EXPENSE IN ACCORDANCE WITH ARTICLE 107,25 OF THE STANDARD SPECIFICATIONS.

THE CONTRACTOR WILL BE REQUIRED TO RELOCATE OR REMOVE AND REPLACE SIGNS WHICH INTERFERE WITH HIS CONSTRUCTION OPERATIONS AND TO TEMPORARILY RESET ALL SUCH SIGNS DURING CONSTRUCTION OPERATIONS. THIS WORK WILL BE CONSIDERED INCLUDED IN THE COST OF THE CONTRACT.

ALL WORK INVOLVING SIGNS SHALL BE GOVERNED BY THE FOLLOWING REQUIREMENTS:

- 1. SIGNS SHALL NOT BE MOVED UNTIL PROGRESS OF WORK NECESSITATES IT.
- 2. EVERY SIGN REMOVED MUST BE RE-ERECTED AT A TEMPORARY LOCATION IN A WORKMANLIKE MANNER AND BE VISIBLE TO TRAFFIC FOR THE NECESSARY WORK AND PAYMENT WHICH IT IS INTENDED. ALL SUCH SIGNS MUST BE MAINTAINED STRAIGHT AND CLEAN FOR THE DURATION OF THE TEMPORARY SETTING. OF THE STANDARD SPECIFICATIONS.
- 3. ALL SIGNS SHALL BE RE-ERECTED IN PERMANENT LOCATIONS AS THE ROADWAY IS COMPLETED, HORIZONTAL LOCATION FROM THE EDGE OF PAVEMENT SHALL BE AS DESIGNATED BY THE ENGINEER.
- 4. ALL UNUSED SIGNS WILL BE RETURNED TO THE VILLAGE OR COUNTY, AS APPLICABLE.
- 5. LONGER POSTS MAY BE REQUIRED AT SOME TEMPORARY OR PERMANENT SIGN LOCATIONS TO MAINTAIN PROPER SIGN ELEVATIONS.

MISCELLANEOUS

THE CONTRACTOR SHALL MAINTAIN EXISTING SIDE STREET ACCESS, EXISTING DRIVEWAY ACCESS, AND PEDESTRIAN ACCESS TO ABUTTING PROPERTY AT ALL TIMES DURING CONSTRUCTION OF THE PROJECT.

THIS WORK SHALL BE PERFORMED AT LOCATIONS SHOWN ON THE PLANS OR AS DIRECTED BY THE ENGINEER OR REPRESENTATIVE OF THE ENGINEER. THE CONTRACTOR SHALL CUT THE JOINT BETWEEN THE PORTION OF THE ITEM TO BE REMOVED AND THAT TO BE LEFT IN PLACE WITH A SAWING MACHINE TO PREVENT SPALLING WHEN THE ITEM IS BROKEN OUT. THIS WORK SHALL BE DONE IN A MANNER THAT A STRAIGHT AND PERPENDICULAR JOINT WILL BE SECURED. ALL SAW CUTTING SHALL BE TO THE FULL DEPTH OF THE PAYEMENT, DRIVEWAY, SIDEWALK, OR CURB TO BE REMOVED.

IT IS THE CONTRACTOR'S RESPONSIBILITY TO DETERMINE THE THICKNESS OF THE EXISTING ITEM BEING REMOVED AND WHETHER OR NOT IT CONTAINS REINFORCEMENT.

THIS WORK SHALL BE INCLUDED IN THE COST OF THE ITEMS TO BE REMOVED. NO ADDITIONAL COMPENSATION WILL BE ALLOWED FOR SAWING REINFORCEMENT.

AT ALL BUTT JOINT LOCATIONS, THE EXISTING SURFACE SHALL BE CUT TO A MINIMUM THICKNESS OF ONE AND ONE HALF $(\frac{1}{2})$ INCHES. THE THICKNESSES OF ASPHALT MIXTURES SHOWN IN THE PLANS ARE NOMINAL. DEVIATIONS MAY OCCUR DUE TO IRREGULARITIES IN THE SURFACES OR BASES ON WHICH THE ASPHALT MIXTURES ARE TO BE PLACED.

THE CONTRACTOR SHALL BE RESPONSIBLE FOR PROTECTING FRESH CONCRETE FROM DAMAGE AND VANDALISM. ANY DAMAGED OR VANDALIZED CONCRETE SHALL BE REMOVED AND REPLACED AT THE CONTRACTOR'S EXPENSE.

EXISTING PAVEMENT THICKNESSES SHOWN ON THE PLANS ARE APPROXIMATE, BASED ON AVAILABLE INFORMATION AT THE TIME OF DESIGN. ANY ADDITIONAL COSTS REQUIRED BY THE CONTRACTOR DUE TO THICKNESSES OTHER THAN THOSE SHOWN ON THE PLANS WILL BE INCLUDED IN THE COST OF CONTRACT.

IT IS THE CONTRACTOR'S RESPONSIBILITY TO ASCERTAIN EXISTING FIELD CONDITIONS BEFORE BIDDING ON THIS CONTRACT.

WHERE NEW WORK MEETS EXISTING FEATURES TO REMAIN, FIELD CHECK ALL DIMENSIONS AND ELEVATIONS BEFORE PROCEEDING WITH CONSTRUCTION. NOTIFY ENGINEER IMMEDIATELY OF ANY DISCREPANCIES.

THE CONTRACTOR WILL BE REQUIRED TO COMPLY WITH ALL STATE REGULATIONS REGARDING AIR, WATER, AND NOISE POLLUTION. THE CONTRACTOR IS PROHIBITED FROM BURNING ANY MATERIAL WITHIN OR ADJACENT TO THE IMPROVEMENT.

ALL TYPE I AND II BARRICADES SHALL BE WEIGHTED DOWN WITH TWO SANDBAGS EACH. (ONE WEIGHTED SANDBAG ACROSS EACH BOTTOM RAIL). ALL TYPE III BARRICADES SHALL REQUIRE FOUR SANDBAGS EACH.

THE CONTRACTOR SHALL DISPOSE OF ALL SIDEWALK, CURB AND GUTTER, PAVEMENT, AND ALL OTHER EXCAVATED MATERIAL NOT FOR SALVAGE AT HIS EXPENSE, ALL EXCESS EXCAVATED MATERIAL SHALL BE REMOVED FROM THE SITE EACH DAY. THIS SHALL BE INCLUDED IN THE COST OF THE ITEM BEING REMOVED.

PAVEMENT MARKING PAINT

IN ADDITION TO THE REQUIREMENTS OF ARTICLE 105.09 OF THE STANDARD SPECIFICATIONS, THE CONTRACTOR SHALL FURNISH, AT HIS EXPENSE, WHITE, PINK OR PURPLE PAVEMENT MARKING PAINT IN AEROSOL CANS, FOR USE BY THE ENGINEER. THE CONTRACTOR AND SUBCONTRACTORS SHALL ONLY USE THESE SAME COLORS FOR THEIR OWN MARKINGS, THEREFORE NOT USING JULIE UTILITY COLORS.

PROTECTION OF EXISTING DRAINAGE FACILITIES DURING CONSTRUCTION

ALL EXISTING DRAINAGE STRUCTURES ARE TO BE KEPT FREE OF DEBRIS RESULTING FROM CONSTRUCTION OPERATIONS.
ALL WORK AND MATERIAL NECESSARY TO PREVENT ACCUMULATION OF DEBRIS IN THE DRAINAGE STRUCTURES WILL BE
CONSIDERED AS INCLUDED IN THE CONTRACT. ANY DEBRIS IN THE DRAINAGE STRUCTURES RESULTING FROM CONSTRUCTION
OPERATIONS SHALL BE REMOVED AT THE CONTRACTOR'S OWN EXPENSE, AND NO EXTRA COMPENSATION WILL BE ALLOWED.
SHOULD RECONSTRUCTION OR ADJUSTMENT OF A DRAINAGE STRUCTURE BE REQUIRED BY THE ENGINEER IN THE FIELD,
THE NECESSARY WORK AND PAYMENT SHALL BE DONE IN ACCORDANCE WITH SECTION 602 AND ARTICLE 104.02 RESPECTIVELY
OF THE STANDARD SPECIFICATIONS.

DURING CONSTRUCTION, IF THE CONTRACTOR'S FORCES ENCOUNTER OR OTHERWISE BECOMES AWARE OF ANY SEWERS, UNDERDRAINS, OR FIELD DRAINS WITHIN THE RIGHT-OF-WAY OTHER THAN THOSE SHOWN ON THE PLANS. THEY SHALL INFORM THE ENGINEER. THE ENGINEER SHALL DIRECT THE WORK NECESSARY TO MAINTAIN OR REPLACE THE FACILITIES IN SERVICE, AND TO PROTECT THEM FROM DAMAGE DURING CONSTRUCTION IF MAINTAINED. EXISTING FACILITIES TO BE MAINTAINED THAT ARE DAMAGED BECAUSE OF NON COMPLIANCE WITH THIS PROVISION SHALL BE REPLACED AT THE CONTRACTOR'S OWN EXPENSE. SHOULD THE ENGINEER HAVE DIRECTED THE REPLACEMENT OF A FACILITY, THE NECESSARY WORK AND PAYMENT SHALL BE DONE IN ACCORDANCE WITH SECTIONS 550 AND 601 AND ARTICLE 104.02 RESPECTIVELY OF THE STANDARD SPECIFICATIONS.

BITUMINOUS MATERIALS (PRIME COAT)

PRIME COAT SHALL MEET THE SPECIFICATIONS OF ARTICLE 406.05(B) OF THE STANDARD SPECIFICATIONS WITH THE FOLLOWING REVISIONS AND ADDITIONS: PRIME COAT SHALL BE APPLIED AT A RATE OF 0.1 GALLON PER SQUARE YARD. BITUMINOUS MATERIAL SHALL BE SS 1, UNLESS OTHERWISE REQUIRED BY ARTICLE 403.05 OF THE STANDARD SPECIFICATIONS. THE CONTRACTOR WILL BE REQUIRED TO PRESENT A WEIGHT TICKET OF THE TRUCKLOAD PRIOR TO APPLYING THE PRIME COAT. AFTER APPLICATION THE TRUCK SHALL THEN BE WEIGHED AGAIN IN ORDER TO DETERMINE THE NET WEIGHT OF PRIME COAT THAT HAS BEEN PLACED. BOTH TICKETS SHALL BE STAMPED BY THE CERTIFIED WEIGH MASTER.

THE CONTRACTOR SHALL ERECT (TO THE ENGINEER'S SATISFACTION) 48" BY 48" FRESH OIL AHEAD SIGNS 24 HOURS PRIOR TO THE PRIME COAT APPLICATION, WHICH SIGNS SHALL REMAIN UNTIL THE PRIME COAT HAS ADEQUATELY CURED. THE FRESH OIL AHEAD SIGNS SHALL BE INSTALLED IN ADVANCE OF THE AREA TO BE PRIMED. THIS INCLUDES SIGNS ON ADJACENT STREETS, AND NO PARKING SIGNS SHALL BE PLACED THROUGHOUT THE AREA TO BE PRIMED.

THE CONTRACTOR SHALL CONTACT THE VILLAGE 72 HOURS IN ADVANCE OF BEGINNING WORK.

THIS WORK SHALL BE PAID FOR AT THE CONTRACT UNIT PRICE PER TON FOR BITUMINOUS MATERIALS (PRIME COAT).

AGGREGATE (PRIME COAT)

THIS WORK SHALL BE DONE IN ACCORDANCE WITH ARTICLE 406.05(B) OF THE STANDARD SPECIFICATIONS INSOFAR AS APPLICABLE AND THE FOLLOWING PROVISIONS.

THE FINE AGGREGATE SHALL BE MECHANICALLY SPREAD AT A UNIFORM RATE OF 2 POUNDS PER SQUARE YARD-

INCIDENTAL HOT-MIX ASPHALT SURFACING

THIS WORK SHALL BE IN ACCORDANCE WITH SECTION 408 OF THE STANDARD SPECIFICATIONS INSOFAR AS APPLICABLE AND THE FOLLOWING PROVISIONS.

THIS ITEM IS TO BE USED AS: TEMPORARY ASPHALT RAMPS DURING STAGE CONSTRUCTION; TEMPORARY PATCHES ON ALL SEWER OR WATER MAIN TRENCHES; TEMPORARY ASPHALT RAMPS PLACED AROUND PROTRUDING FRAMES AND LIDS PRIOR TO THE PLACEMENT OF THE FINAL ASPHALT CONCRETE SURFACE COURSE: OR AS DIRECTED BY THE ENGINEER.

PAYMENT FOR THIS WORK WILL BE INCLUDED IN THE CONTRACT UNIT PRICE PER SQUARE YARD FOR HOT-MIX ASPHALT SURFACE REMOVAL, VARIABLE DEPTH, WHICH PRICE SHALL INCLUDE ALL MATERIAL, LABOR, AND EQUIPMENT NECESSARY FOR A COMPLETE INSTALLATION.

CLEANING EXISTING DRAINAGE STRUCTURES

ALL EXISTING DRAINAGE STRUCTURES WHICH ARE TO BE ADJUSTED OR RECONSTRUCTED SHALL BE CLEANED IN ACCORDANCE WITH ARTICLE 602.15 OF THE STANDARD SPECIFICATIONS, THE CONTRACTOR AND THE ENGINEER OR REPRESENTATIVE OF THE ENGINEER SHALL INSPECT ALL STRUCTURES PRIOR TO CONSTRUCTION, NOTING THE EXISTING CONDITION. THE COST OF THIS WORK SHALL BE INCLUDED IN THE COST OF THE ITEM FRAMES AND LIDS TO BE ADJUSTED (SPECIAL).

FRAMES AND GRATES OR FRAMES AND LIDS

THIS WORK SHALL BE IN ACCORDANCE WITH THE APPLICABLE PORTIONS OF SECTION 604 OF THE STANDARD SPECIFICATIONS.

A NEENAH FRAME AND OPEN LID, R-2040, OR APPROVED EQUAL, SHALL BE USED FOR FRAMES AND LIDS, TYPE 1, OPEN LID. THIS WORK SHALL BE PAID FOR AT THE CONTRACT UNIT PRICE EACH FOR FRAMES AND LIDS, TYPE 1, OPEN LID, WHICH SHALL INCLUDE REMOVAL AND DISPOSAL OF EXISTING CASTING.

AN EAST JORDAN HEAVY-DUTY 7510 CURB INLET WITH TYPE MI GRATE AND TI BACK (PER IDOT STANDARD 604051 WITH THE ADDITION OF THE CURB BACK LETTERED DUMP NO WASTE AND WITH A CAST-IN FISH LOGO! SHALL BE USED FOR FRAMES AND GRATES, TYPE 11, SPECIAL. THIS WORK SHALL BE PAID FOR AT THE CONTRACT UNIT PRICE EACH FOR FRAMES AND GRATES, TYPE 11, SPECIAL, WHICH SHALL INCLUDE THE REMOVAL AND DISPOSAL OF THE EXISTING CASTING.

DETECTABLE WARNINGS

THE MANUFACTURER FOR THE DETECTABLE WARNINGS SHALL BE ENGINEERED PLASTICS INC. (800-682-2525) OR APPROVED EQUAL

CONCRETE BREAKERS

WHEN REMOVING PAVEMENT, CURB AND GUTTER, SHOULDER, AND/OR ANY OTHER STRUCTURES, THE USE OF ANY TYPE OF CONCRETE BREAKERS THAT MAY DAMAGE UNDERGROUND PUBLIC AND/OR PRIVATE UTILITIES WILL NOT BE PERMITTED. UNDER NO CIRCUMSTANCES WILL THE USE OF A FROST BALL BE PERMITTED.

THE CONTRACTOR IS PROHIBITED FROM BREAKING UP CONCRETE BY DROPPING IT ON PAVEMENT OR IN ANY OTHER MANNER THAT, IN THE OPINION OF THE ENGINEER OR REPRESENTATIVE OF THE ENGINEER, MAY DAMAGE EXISTING OR PROPOSED PAVEMENTS OR OTHER ROADWAY APPURTENANCES.


DRIVEWAY ACCESS

THE CONTRACTOR SHALL, WHERE REQUIRED BY THE ENGINEER OR REPRESENTATIVE OF THE ENGINEER, PROVIDE IMMEDIATE ACCESS TO DRIVEWAYS AND INTERSECTING STREETS. THE CONTRACTOR SHALL AT ALL TIMES PROVIDE ACCESS FOR EMERGENCY VEHICLES DURING THE TIME OF CONSTRUCTION.

ANY DRIVEWAY APRON ADJACENT TO THE CURB AND GUTTER THAT IS REMOVED OR DISTURBED SHALL BE RESTORED OR REPLACED TO THE SATISFACTION OF THE ENGINEER OR REPRESENTATIVE OF THE ENGINEER AFTER THE NEW CURB AND GUTTER HAS BEEN CONSTRUCTED. THE CONTRACTOR MUST SCHEDULE THIS WORK SO THAT ONLY ONE SIDE OF ANY STREET WILL BE UNDER CONSTRUCTION AT ANY ONE TIME. IN NO CASE SHALL AN OPEN EXCAVATION CAUSED BY REMOVAL OF EXISTING CURB AND GUTTER, DRIVEWAY, OR SIDEWALK, WHETHER FORMED OR NOT FORMED, REMAIN OPEN MORE THAN 3 WORKING DAYS.

PRIOR TO REMOVING ANY DRIVEWAY, THE CONTRACTOR SHALL PROVIDE THE VILLAGE SUFFICIENT TIME TO PROVIDE 24 HOURS' ADVANCE WRITTEN NOTICE TO THE RESIDENT/OWNER OF THE DRIVEWAY, ALLOWING THE RESIDENT/OWNER TIME TO REMOVE ANY VEHICLES. ACCESS SHALL BE RESTORED NO LESS THAN 4 DAYS AFTER CURB AND GUTTER HAS BEEN PLACED. IF NECESSARY, THE CONTRACTOR SHALL PLACE TEMPORARY AGGREGATE BEHIND THE NEW CURB AND GUTTER UNTIL THE DRIVEWAY IS RESTORED. THIS TEMPORARY AGGREGATE SHALL BE CONSIDERED AS INCLUDED IN THE DRIVEWAY REPLACEMENT PAY ITEM.

SHEET NO. 1 OF 1 SHEETS STA.

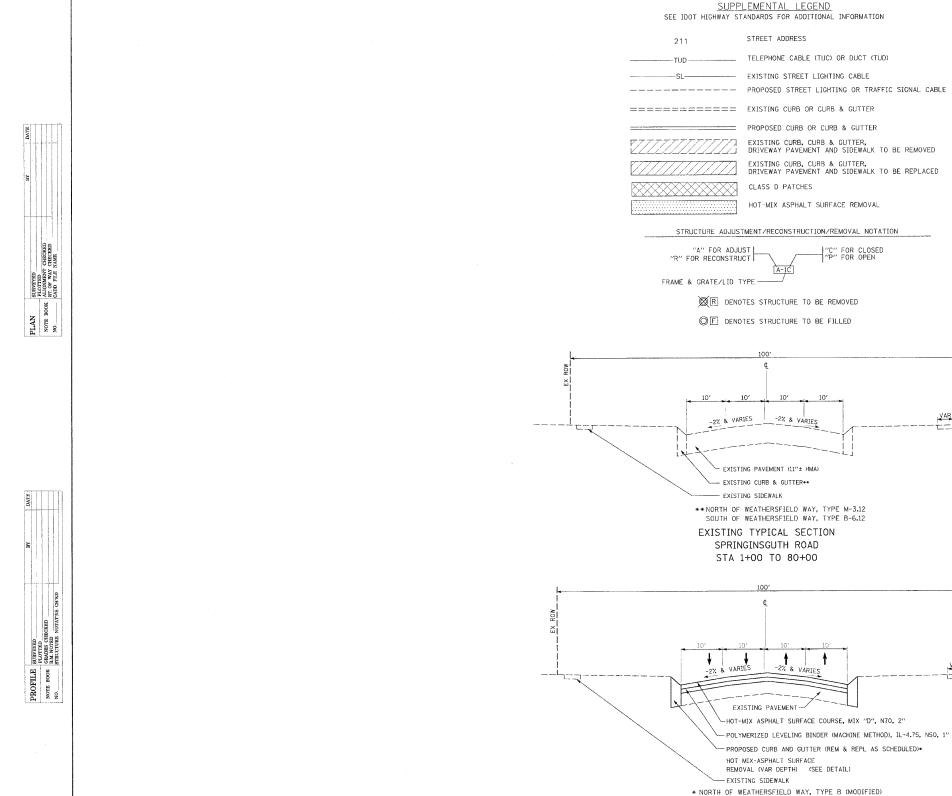

CONTRACTOR SHALL MILL BEFORE PATCHING

HOT-MIX ASPHALT MIXTURE REQUIREMENTS					
MIXTURE TYPE	AIR VOIDS				
PAVEMENT RESURFACING					
HOT-MIX ASPHALT SURFACE COURSE, MIX "D", N70; 2" (IL 9.5mm)	4% @ 70 GYR.				
POLYMERIZED LEVELING BINDER (MACHINE METHOD).IL-4.75, N50; 1"	4% @ 50 GYR.				
DRIVEWAY					
HOT-MIX ASPHALT SURFACE COURSE,MIX "C",N50 (IL 9.5mm)	4% @ 50 GYR.				
PATCHING					
CLASS D PATCHES (HMA BINDER IL-19mm)	4% @ 70 GYR.				

THE UNIT WEIGHT USED TO CALCULATE ALL HMA SURFACE MIXTURE QUANTITIES IS 112 LBS/SQ YD/IN.

THE "AC TYPE" FOR POLYMERIZED HMA MIXES SHALL BE SBS/SBR PG 70-22 AND FOR NON-POLYMERIZED HMA THE "AC TYPE" SHALL BE "PG 64-22 UNLESS MODIFIED BY DISTRICT ONE SPECIAL PROVISIONS. FOR "PERCENT OF RAPP" SEE DISTRICT ONE SPECIAL PROVISIONS.

TLE NAME =	USER NAME =	DESIGNED -	REVISED -	
		DRAWN -	REVISED -	
	PLOT SCALE =	CHECKED	REVISED -	
	PLOT DATE =	DATE -	REVISED -	

STATE OF ILLINOIS DEPARTMENT OF TRANSPORTATION

SOUTH OF WEATHERSFIELD WAY, TYPE B-6.12

PROPOSED TYPICAL SECTION SPRINGINSGUTH ROAD STA 5+63 TO 76+40

HER

VAR

SPRINGINSGUTH ROAD IMPROVEMENTS
TYPICAL SECTIONS

SHEET NO. 1 OF 1 SHEETS STA. TO STA.

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FILE NAME =

Code No.	Items	Unit	Total Quantity	Roadway I000
20201200	REMOVAL AND DISPOSAL OF UNSUITABLE MATERIAL	CU YD	100	100
Z004Z00Z	POROUS GRANULAR EMBANKMENT, SUBGRADE	CU YD	100	100
21101615	TOPSOIL FURNISH AND PLACE, 4"	SQ YD	3355	3355
25000400	NITROGEN FERTILIZER NUTRIENT	POUND	42	42
25000500	PHOSPHORUS FERTILIZER NUTRIENT	POUND	42	42
25000600	POTASSIUM FERTILIZER NUTRIENT	POUND	42	42
25200100	SODDING	SQ YD	3355	3355
25200200	SUPPLEMENTAL WATERING	UNIT	40	40
28000510	INLET FILTERS	EACH	47	47
35101400	AGGREGATE BASE COURSE, TYPE B	TON	68	68
40600200	BITUMINOUS MATERIALS (PRIME COAT)	TON	28	28
40600300	AGGREGATE (PRIME COAT)	TON	68	68
X4060826	POLYMERIZED LEVELING BINDER(MACHINE METHOD), IL-4.75, N50	TON	2028	2028
40600895	CONSTRUCTION TEST STRIP	EACH	1	1
40600982	HOT-MIX ASPHALT SURFACE REMOVAL- BUTT JOINT	SQ YD	286	286
40603310	HOT-MIX ASPHALT SURFACE COURSE, MIX "C", N50	TON	25	25
40603340	HOT-MIX ASPHALT SURFACE COURSE, MIX "D", N70	TON	4056	4056
42300100	PORTLAND CEMENT CONCRETE DRIVEWAY PAVEMENT, 5 INCH	SQ YD	624	624
42400200	PORTLAND CEMENT CONCRETE SIDEWALK 5 INCH	SQ FT	13621	13621
42400800	DETECTABLE WARNINGS	SQ FT	712	712
X4401198	HOT-MIX ASPHALT SURFACE REMOVAL, VARIABLE DEPTH	SQ YD	33805	33805
44000200	DRIVEWAY PAVEMENT REMOVAL	SQ YD	764	764
44000500	COMBNATION CURB AND GUTTER REMOVAL	FOOT	5527	5527
44000600	SIDEWALK REMOVAL	SQ FT	15081	15081
44201717	CLASS D PATCHES, TYPE II, 6 INCH	SQ YD	323	323
44201721	CLASS D PATCHES, TYPE III, 6 INCH	SQ YD	396	396

Code No.	Items	Unit	Total Quantity	Roadway 1000
44201723	CLASS D PATCHES, TYPE IV, 6 INCH	SQ YD	2440	244
60202405	CATCH BASIN, TYPE A, 4'- DIAMETER	EACH	1	
00050000				
60252800	CATCH BASINS TO BE RECONSTRUCTED	EACH	3	
60257900	MANHOLES TO BE RECONSTRUCTED	EACH	2	
x6030310	FRAMES AND LIDS TO BE ADJUSTED (SPECIAL)	EACH	29	2
60404800	FRAMES AND GRATES, TYPE 11	EACH	31	3
60406000	FRAMES AND LIDS, TYPE 1,0PEN LID	EACH	2	
60406100	FRAMES AND LIDS, TYPE 1,CLOSED LID	EACH	2	
60500060	REMOVING INLETS	EACH	1	
60603800	COMBINATION CONCRETE CURB AND GUTTER, TYPE B-6.12	FOOT	1594	159
60611610	COMBINATION CONCRETE CURB AND GUTTER, TYPE B(MODIFIED)	FOOT	3933	393
67000400	ENGINEER'S FIELD OFFICE, TYPE A	CAL MO	3	
67100100	MOBILIZATION	L SUM	1	
70102625	TRAFFIC CONTROL AND PROTECTION, STANDARD 701606	L SUM	1	
70102635	TRAFFIC CONTROL AND PROTECTION, STANDARD 701701	L SUM	1	
70102640	TRAFFIC CONTROL AND PROTECTION, STANDARD 701801	L SUM	1	
70300100	SHORT-TERM PAVEMENT MARKING	FOOT	2560	256
70300520	PAVEMENT MARKING TAPE, TYPE III 4"	FOOT	640	64
70300220	TEMPORARY PAVEMENT MARKING LINE 4"	FOOT	18072	1807
78001100	PAINT PAVEMENT MARKING - LETTERS AND SYMBOLS	SQ FT	210	21
78001110	PAINT PAVEMENT MARKING - LINE 4"	FOOT	16140	1614
78001130	PAINT PAVEMENT MARKING - LINE 6"	FOOT	124	12
78001150	PAINT PAVEMENT MARKING - LINE 12"	FOOT	516	51
78001180	PAINT PAVEMENT MARKING - LINE 24"	FOOT	150	1:
78300200	RAISED REFLECTIVE PAVEMENT MARKER REMOVAL	EACH	400	4(
Z0030850	TEMPORARY INFORMATION SIGNING	SQ FT	51	
Z0076600	TRAINEES	HOUR	500	50
_00,0000	1.1.V M. Charles V	1,501	300	

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PLOT DATE =	DATE	REVISED -

STATE OF ILLINOIS
DEPARTMENT OF TRANSPORTATION

LTY ITEMS			
	SPRINGINSGUTH ROAD IMPROVEMENTS	F.A. U. SECTION	COUNTY TOTAL SHEE
- H⊕∠IR	SUMMARY AND SCHEDULES	2562 10-00104-00-RS	COOK 21 4
SCALE: N.T.S.	SHEET NO. 1 OF 1 SHEETS STA. TO STA.	SPRINGINSGUTH ROAD FED. ROAD DIST. NO. ILLINOIS FED. A	CONTRACT NO. 63500 ID PROJECT M-9003(703)

·	DR	RIVEWAYS		PCC,5"
	Address	Reference	Size	Sq Yd
DATE	1102	L	4X52	
Ã	1017	R	12+18/2X11	18.3
	916	L	24+20/2X18	44.0
	328	L	17+12/2X20	32.2
Ma Ba	327	R	14X19	29.6
	324	L	15+10/2X24	33.3
	323	R	9+14/2X24 + 4X11	35.6
- - -	319	R	8X11+8X20	27.6
	316	L	5X20	11.1
	309	R	12X19	25.3
SURVEYED PLOTTER PLOTTER PLOTTER RT. OF WAY CHECKED CADD FILE NAME	305	R	8X16	14.2
HE NAM	301	R	16X23	40.9
CED CED AENY WAY FILE	230	L	12+18/2X8	13.3
LOTT LIGHT LIGHT LIGHT LIGHT	221	R	9+11/2X24	26.7
2 4 2 4 3	215	R	9+11/2X16 + 8X18	33.8
PLAN NOTE BOOK	211	R	11X22	26.9
PLAN NOTE H	207	R	12X15	20.0
A Z Z	134	Ĺ	21+28/2X9	24.4
	133	R	5X29	16.1
	130	L	20+18/2X15	31.7
	127,125	R	16X24	•
	124	L	9+13/2X23	
	123,121	R	5X34	18.9
	120	L	10+12/2X23	28.1
	119	R	7X23	20.1
	118	Ĺ	5X21	
	114	Ĺ	12+15/2X11	
	110	- Ē	11X21	25.7
	100	Ĺ	16+23/2X14	30.3
	30	Ĺ	10X14	15.6
DATE	•			10.0

НМА	
Sq Yd	
23.1	
42.7	
28.1	
17.9	
11.7 16.4	
139.9	

623.6

ADA

CLASS D PATO


ADA Street Bates Lane Hartmann Drive Church Entrance Hartmann Drive	Location SE Corner NE Corner	Size	Sq Ft	6+21 6+50	Reference L L	Size 4x15 4x92	Sq Yd Ty II 6.7	Sq Yd Ty ⊪	Sq Yd Ty IV
Bates Lane Hartmann Drive Church Entrance	SE Corner	Size	Sq Ft	6+50			6.7		40.0
Bates Lane Hartmann Drive Church Entrance	SE Corner	Size	SUFL			4892			
Hartmann Drive Church Entrance				6+58	R	4x25 +2.5x15		15.3	40.9
Hartmann Drive Church Entrance		2.4	•	6+81	R	4x18 +2.5x114			40.0
Church Entrance	NE Comei	2x4	8	7+37 9+63	R L-R	4x18 6x40	8.0		26.7
Church Entrance		2x4	. 8	10+26	Ĺ	12x20			26.7
	SW Corner NW Corner	2x8	16	10+46 10+93	L L	3x20 8x20	6.7	47.0	
		2x8	16	11+00	R	6x20 + 6x6/2		17.8 15.3	
Jortmann Drive	SW Corner	2x8	16	11+87	R	6x20	13.3		
	NW Corner	2x8	16	12+04 12+93	R R	6x20 + 8x6 7x20		18.7 15.6	
nattinanii Diive	SE Corner	2x4x2	16	13+62	R	15x20			33.3
	NE Corner	2x4x2	16	14+15 14+60	R R	13x10 + 9x23 2.5x232			37.4
	NW Corner	2x4	8	16+11	Ĺ	2.5x32	8.9		64.4
Syracuse Lane	SW Corner	2x8 + 2x4	24	18+34	R	6x20	13.3		
	NW Corner	2x8	16	18+65 19+15	L-R L	6x40 7x20		15.6	26.7
	SE Corner	2x4x2	16		R	7+3/2x20	11,1	15.0	
	NE Corner	2x4	8	19+43	L	14x29 + 6x13	40.0		53.8
Church Entrance	SW Corner	2x8	16	20+32	L R	6x20 15x20	13.3		33.3
	NW Corner	2x8	16	20+92	L	6x28		18.7	55.5
Church Entrance	SW Corner	2x8	16	04.05	R	4x12	5.3		
	NW Corner	2x8	16	21+05 21+93	L R	8x24 4x20 + 5x6	12.2	21.3	
Water Park	SW Corner	2x8	16	22+42	R	5x24	13.3		
- and I will	NW Corner			23+70	L	3x16 + 3x6	7.3		
Janumouth Long		2x8	16	27+85 28+20	R L	8x20 14x34		17.8	50.0
Darymouth Lane	SE Corner	2x4	8	28+29	R R	7x20		15.6	52.9
	NE Corner	2x4x2	16	29+45	R	14x20			31.1
School X-ing	NW Corner	2x4	8	29+98 30+42	L L	6x20	13.3		
School Entrance	SW Corner	2x8	16	31+11	R	20x29 6X20	13.3		64.4
	NW Corner	2x8	16	31+17	L	17X20	10.5		37.8
lorweil Lane	SW Corner	2x8	16	31+48	R	2.5X122			33.9
	NW Corner	2x8	16	33+65 36+90	L L	3X16 4X12	5.3 5.3		
Dedham Lane	SE Corner	2x4	8	37+12	L	17X20	0.0		37.8
	NE Corner	2x4	8		R	5X20	11.1		
(ingston Lane	SW Corner	2x4 2x4		38+08	L L	6X13 5X17	8.7 9.4		
ingston Lane			8	38+28	Ĺ	12X18	5.4	24.0	
	NW Corner	2x4	8	38+44	R	4X26	11.6		
	SE Corner	2x4	8	38+70 39+75	R L	2.5X85 12X28		23.6	27.0
	NE Corner	2x4	8	40+53	Ĺ	13X28			37.3 40.4
Veathersfield Way	SW Corner	2x4x2	16		L ,	19X20			42.2
	NW Corner	2x4x2	16	41+83 42+78	L L	12X36 6X90			48.0
	SE Corner	2x4x2	16	44+15	R	8X20		17.8	60.0
	NE Corner	2x4x2	16	44+25	L	9X20		20.0	
School Entrance	SW Corner	2x4	8	44+68 45+42	L R	15X53 12X20			88.3
	NW Corner	2x4	8	45+50	Ĺ	5X20	11.1		26.7
School X-ing	NW Corner	2x4	8	45+59	L	7X79			61.4
School Entrance	SW Corner				L	12X26			34.7
Choor Entrance		2x4	8	46+72	L-R R	9X82 4X17	7.6		82.0
all-at Lau-	NW Corner	2x4	8	46+96	R	3X26	8.7		
Arlington Lane	SE Corner	2x4	8	48+04	R	20X61			135.6
	NE Corner	2x4	8	51+13 51+23	L R	5X29 4X26	11.6	16.1	
Vinchester Lane	SW Corner	2x4	8	52+85	L-R	5X40	11.0	22.2	
	NW Corner	2x4	8	53+78	R	7X29		22.6	
Varwick Lane	SW Corner	2x4	8	53+96 54+17	L R	4X438 3X226			194.7 75.3
	NW Corner	2x4	8	54+90	È	5X16	8.9		75.5
Revere Circle(South)	SE Corner	2x4	8	55+20	L	5X16	8.9		
	NE Corner	2x4	8	56+43 56+73	R R	4X30 3X107	13.3		05.7
levere Circle (North)	SE Corner			57+80	R	4X85			35.7 37.8
evere Circle (North)		2x4	8	58+65	R	2X58		19.3	01.0
	NE Corner	2x4	8	59+23	R	4X214			95.1
hopping Center Entrance	SE Corner	2x4	8	59+15 61+91	L L	3X360 4X16	7.1		120.0
South)	NE Corner	2x8	16	62+17	R	4X590	***		262.2
hopping Center Entrance	SE Corner	2x8	16	62+50	L	4X16	7.1		
North)	NE Corner	2x8	16	62+67 63+61	L L	8X16 3X20	14.2 6.7		
Vinthrop Lane	SW Corner	2x4x2	16	63+89	L	4X72			32.0
•	NW Corner	2x4x2	16	65+06	L-R	4X28	12.4		
Vinthrop Lane X-ing	SE Corner	2x4	8	65+38 66+48	L L	3+4/2X55 3X440		21.4	440.7
op acro // mg	NE Corner	2x4 2x4		67+30	L L-R	5X33		18.3	146.7
	NE COME	4X 1	8	67+85	L-R	8X33			29.3
				68+90	R	3X251			83.7
			712	69+92 70+20	L-R L-R	8X34 5X34		18.8	30.2
				71+07	L	4X32	14.2	10.0	
						TOTALS	322.5	395.8	2440.4


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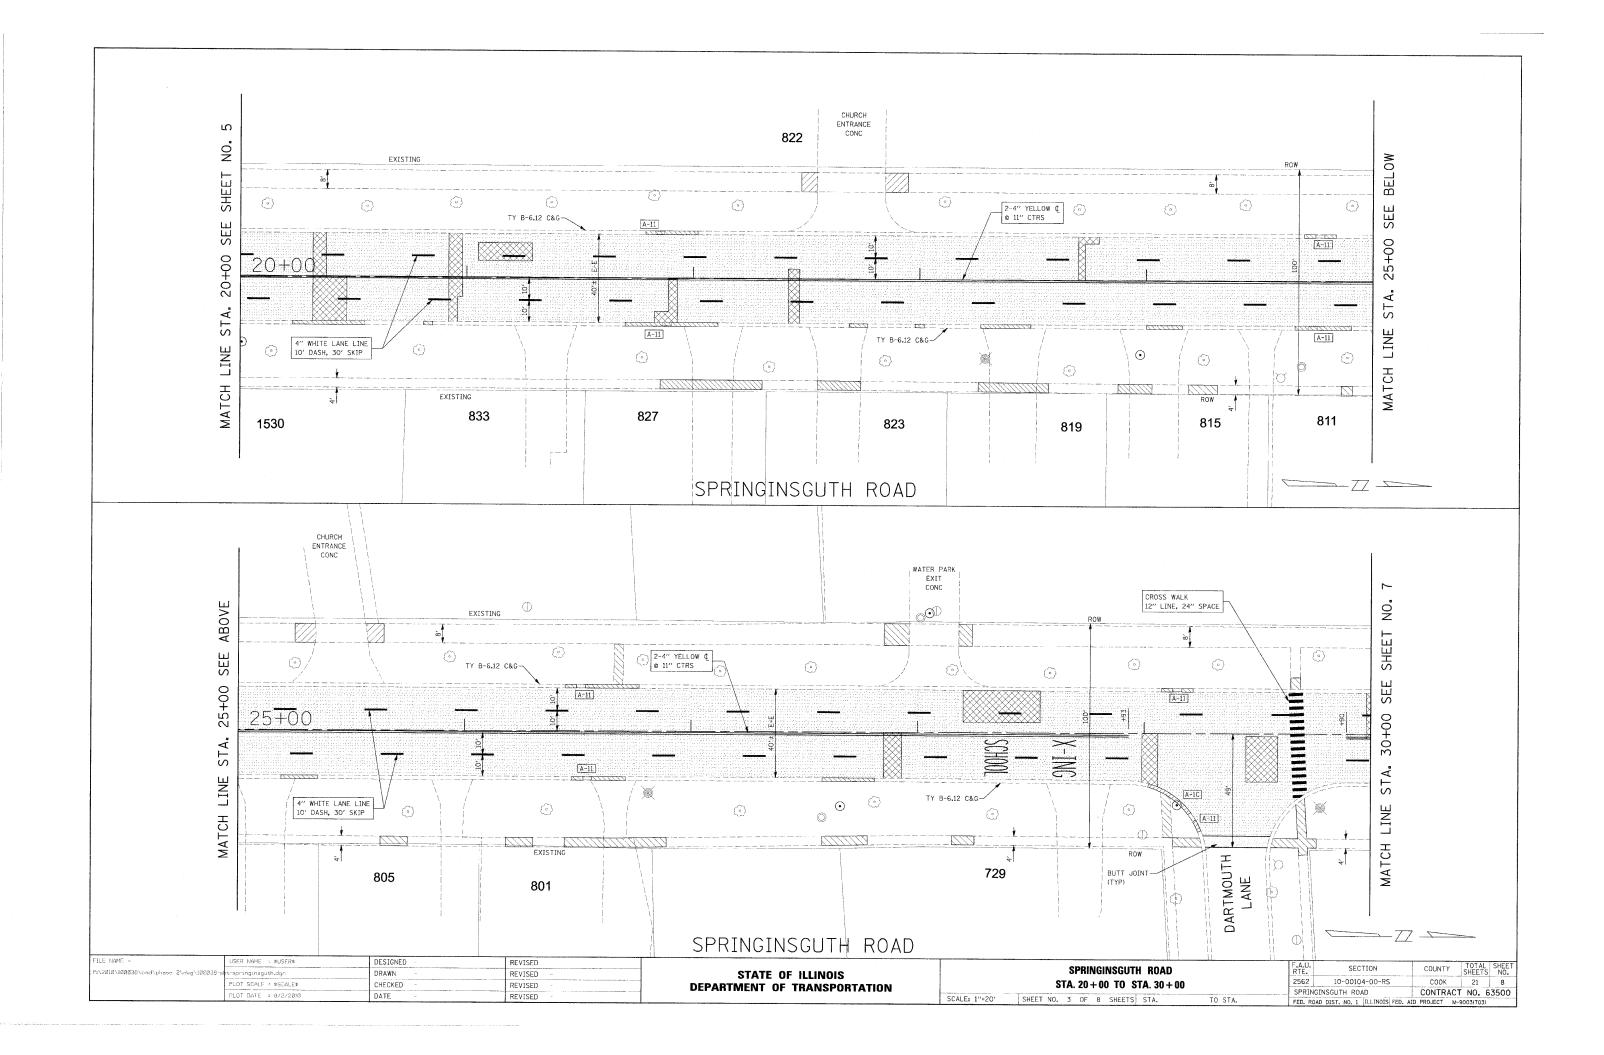
TOTALS


STATE OF ILLINOIS
DEPARTMENT OF TRANSPORTATION


,						
SPRINGINSGUTH ROAD IMPROVEMENTS			SECTION	COUNTY	TOTAL	SHEET NO.
 	SUMMARY AND SCHEDULES		10-00104-00-RS	COOK	21	5
		SPRIN	GINSGUTH ROAD	CONTRACT	NO. 63	3500
SCALE: N.T.S.	SHEET NO. 1 OF 1 SHEETS STA. TO STA.	FED. RO.	AD DIST. NO. 1 ILLINOIS FED. A	ID PROJECT M-90	003(703)	




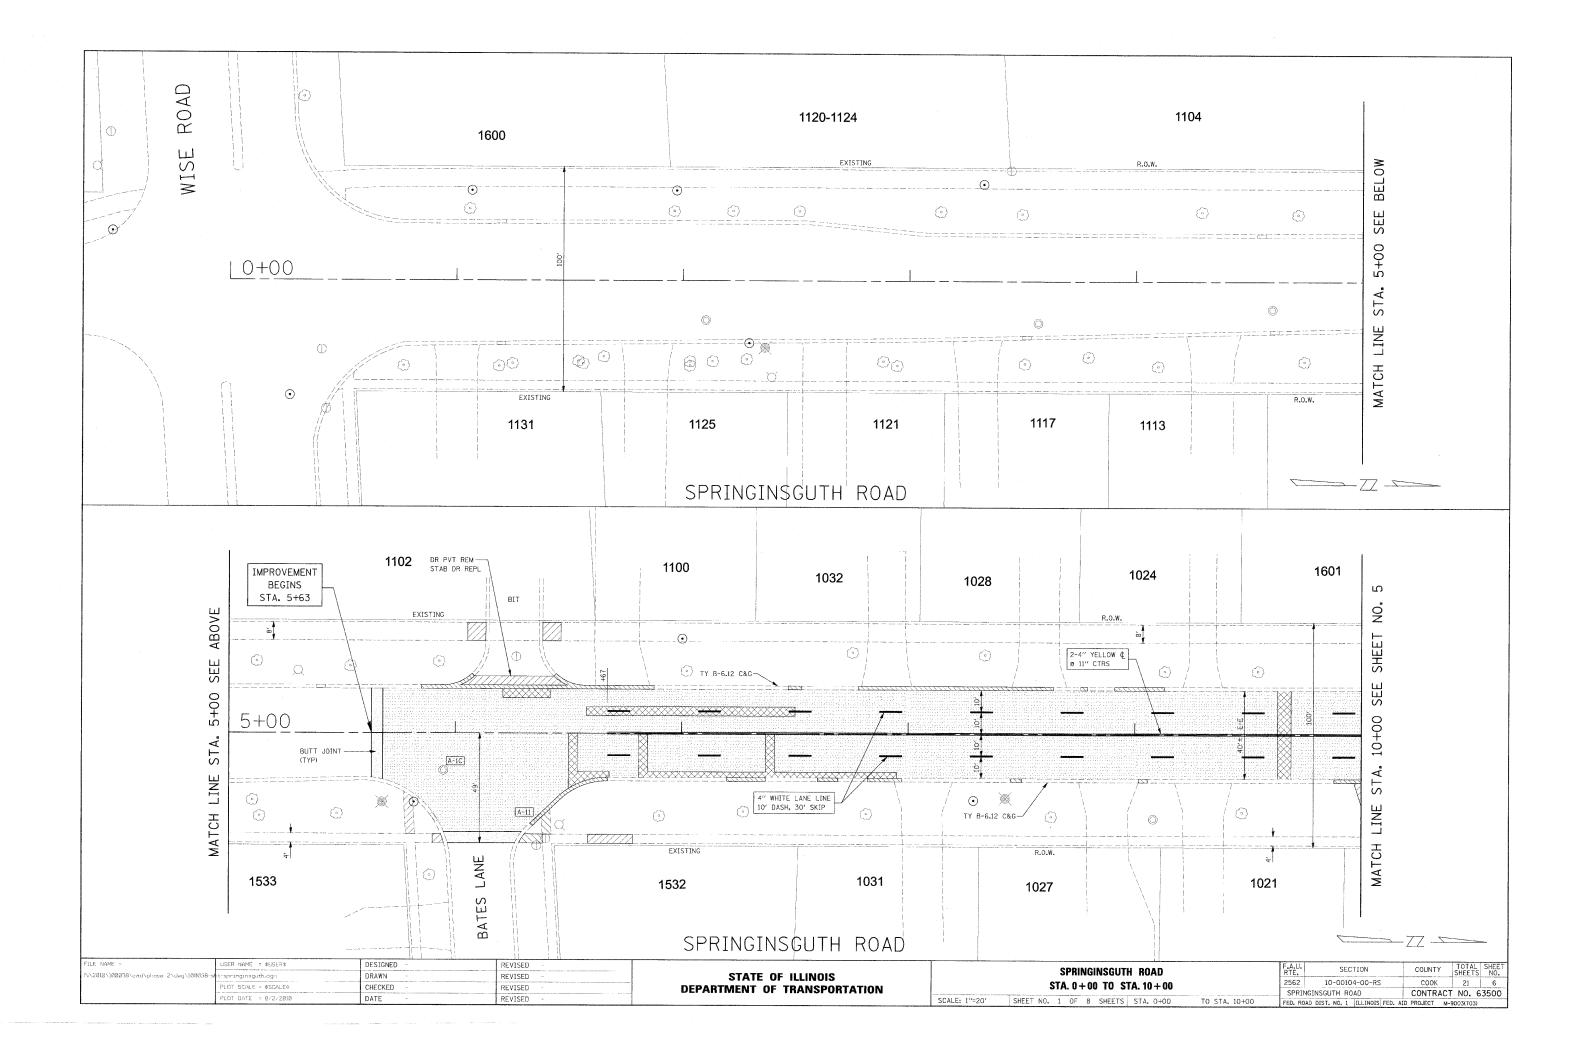


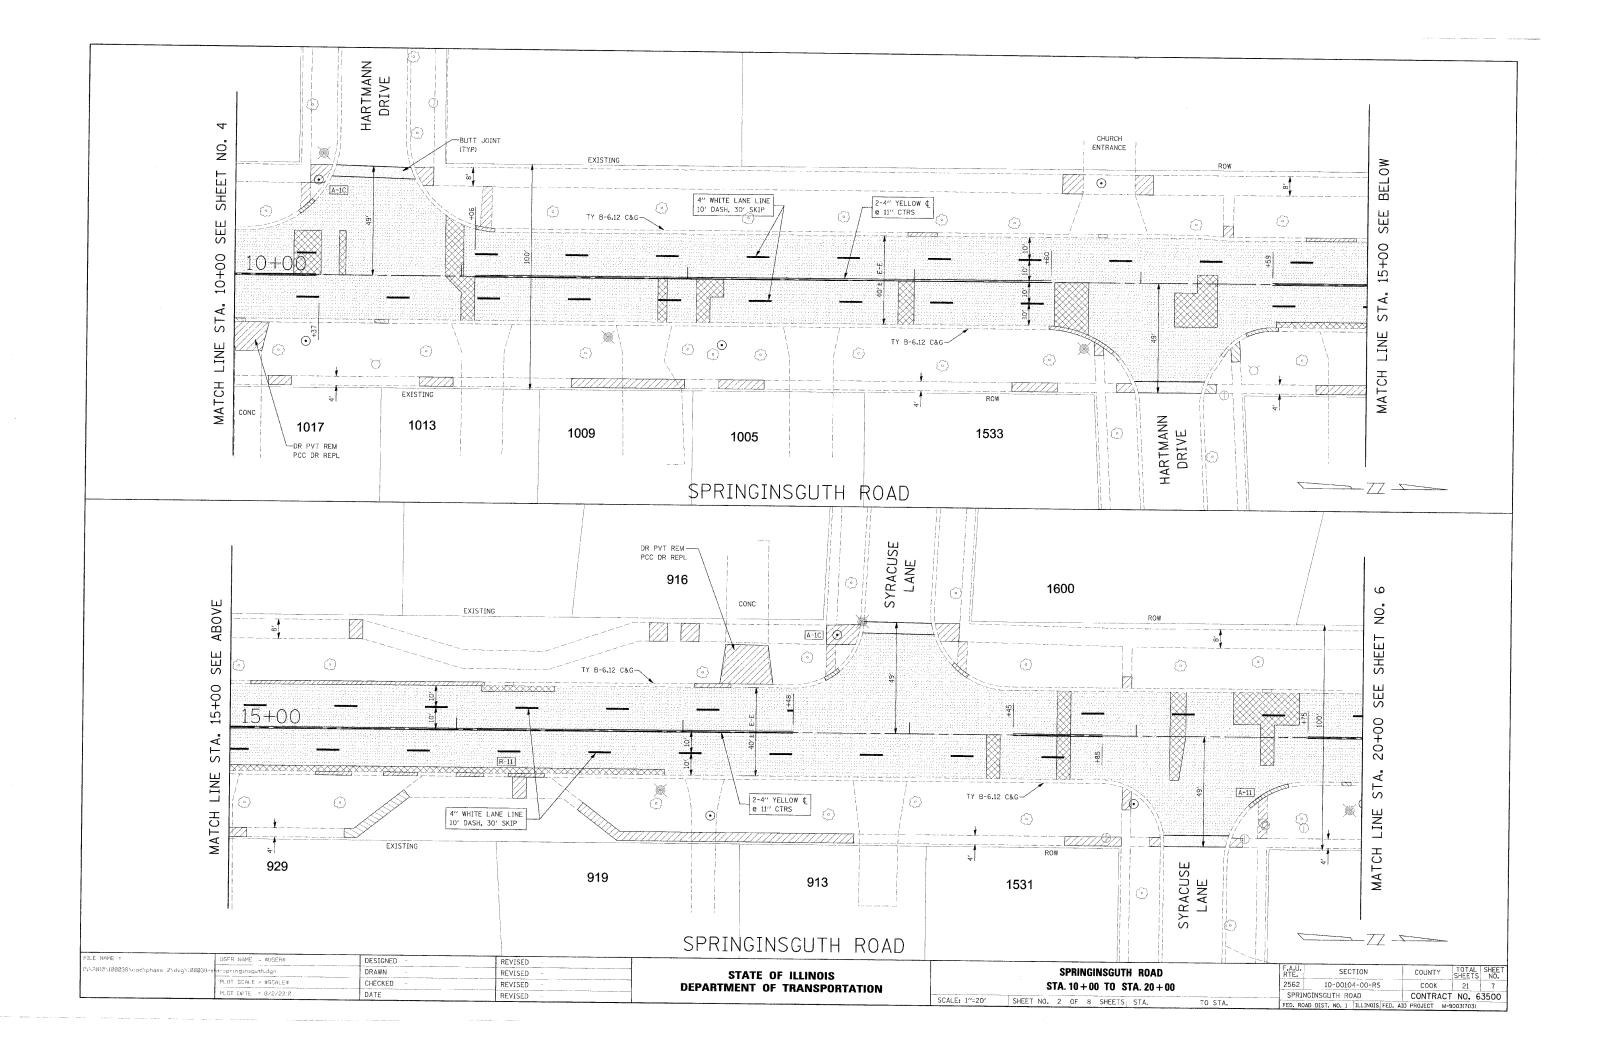


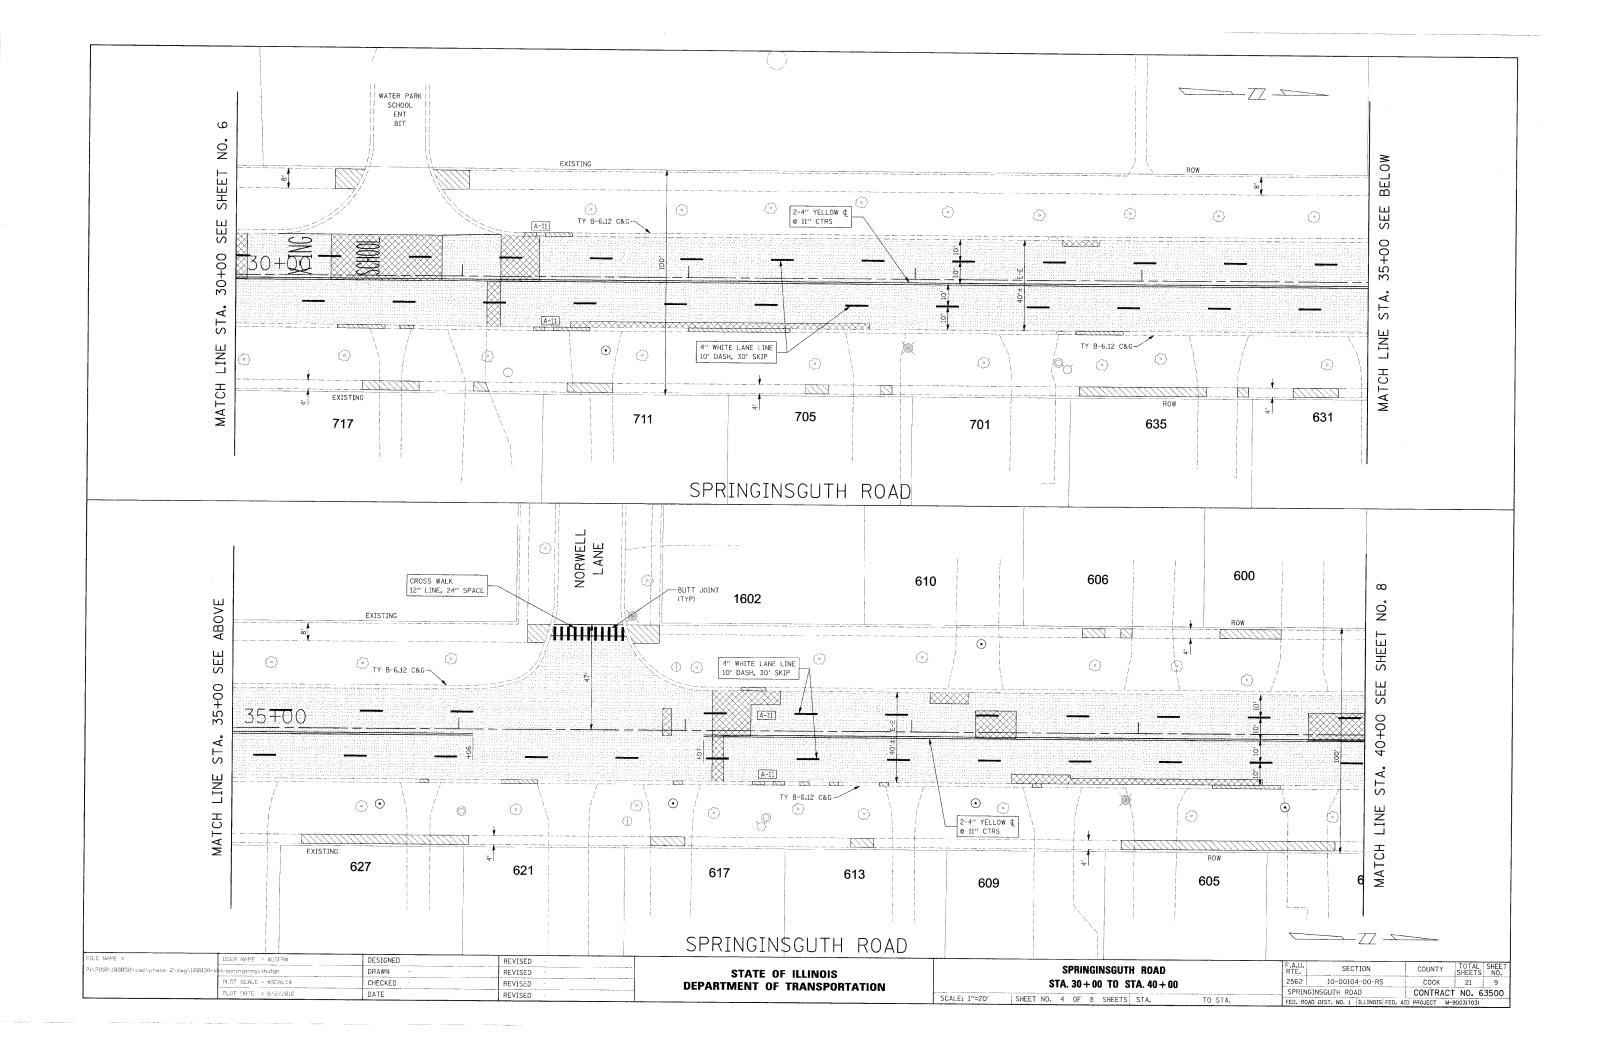


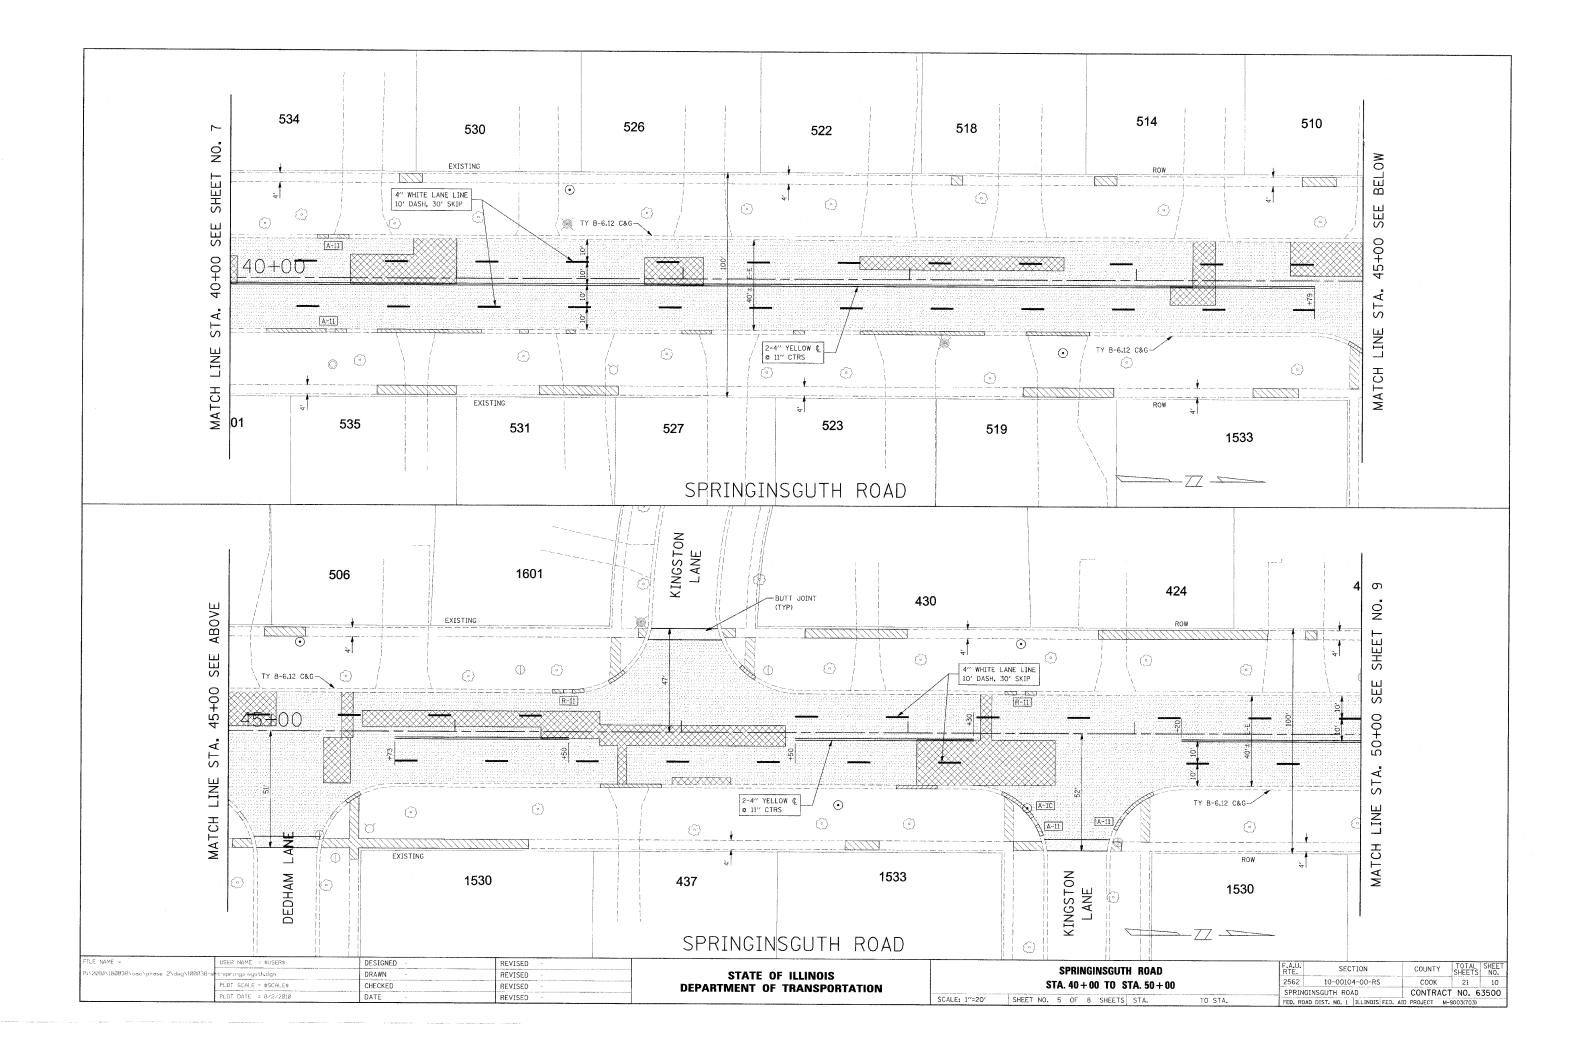


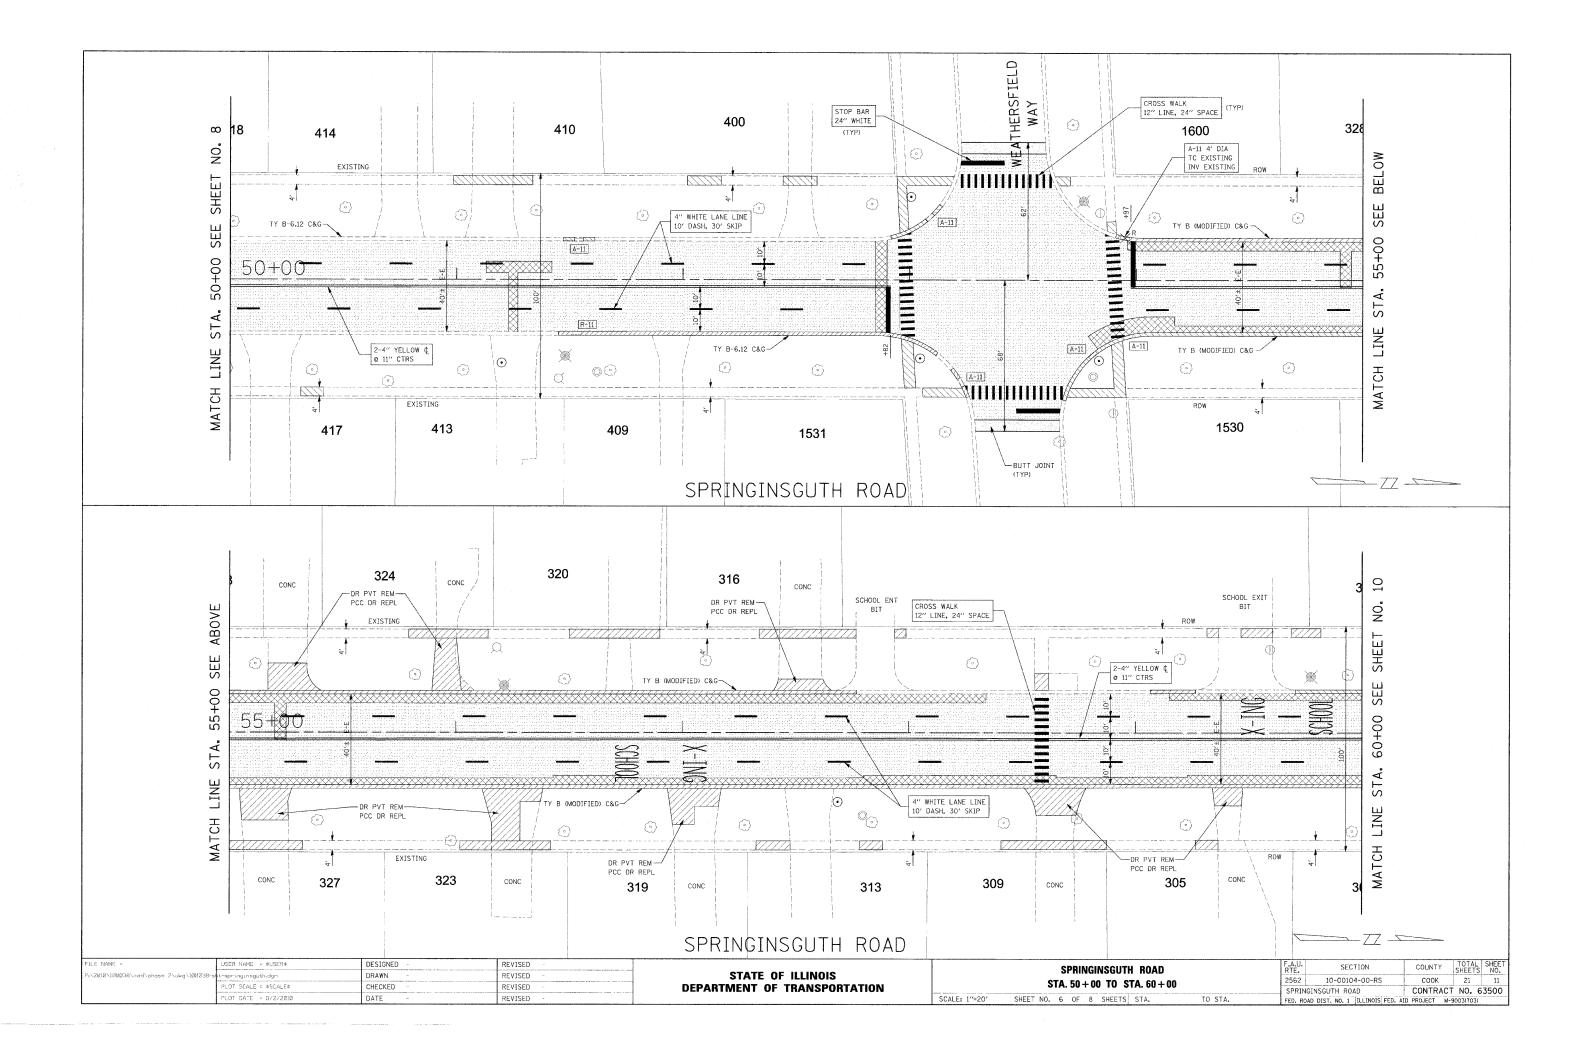

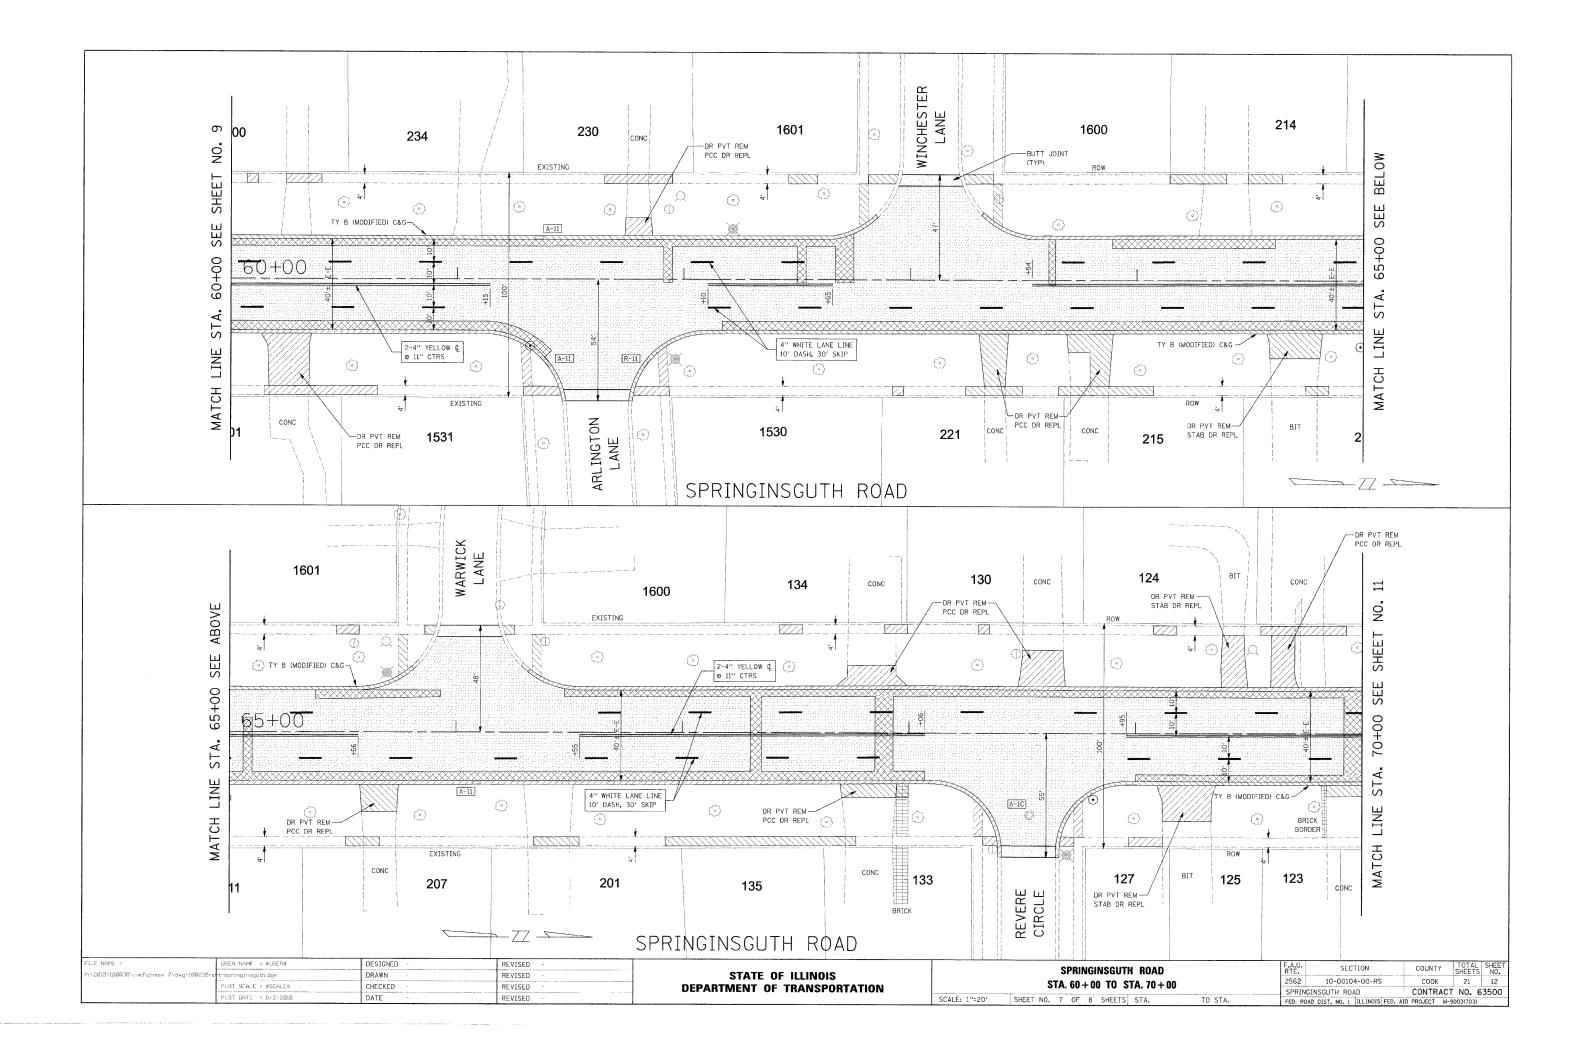

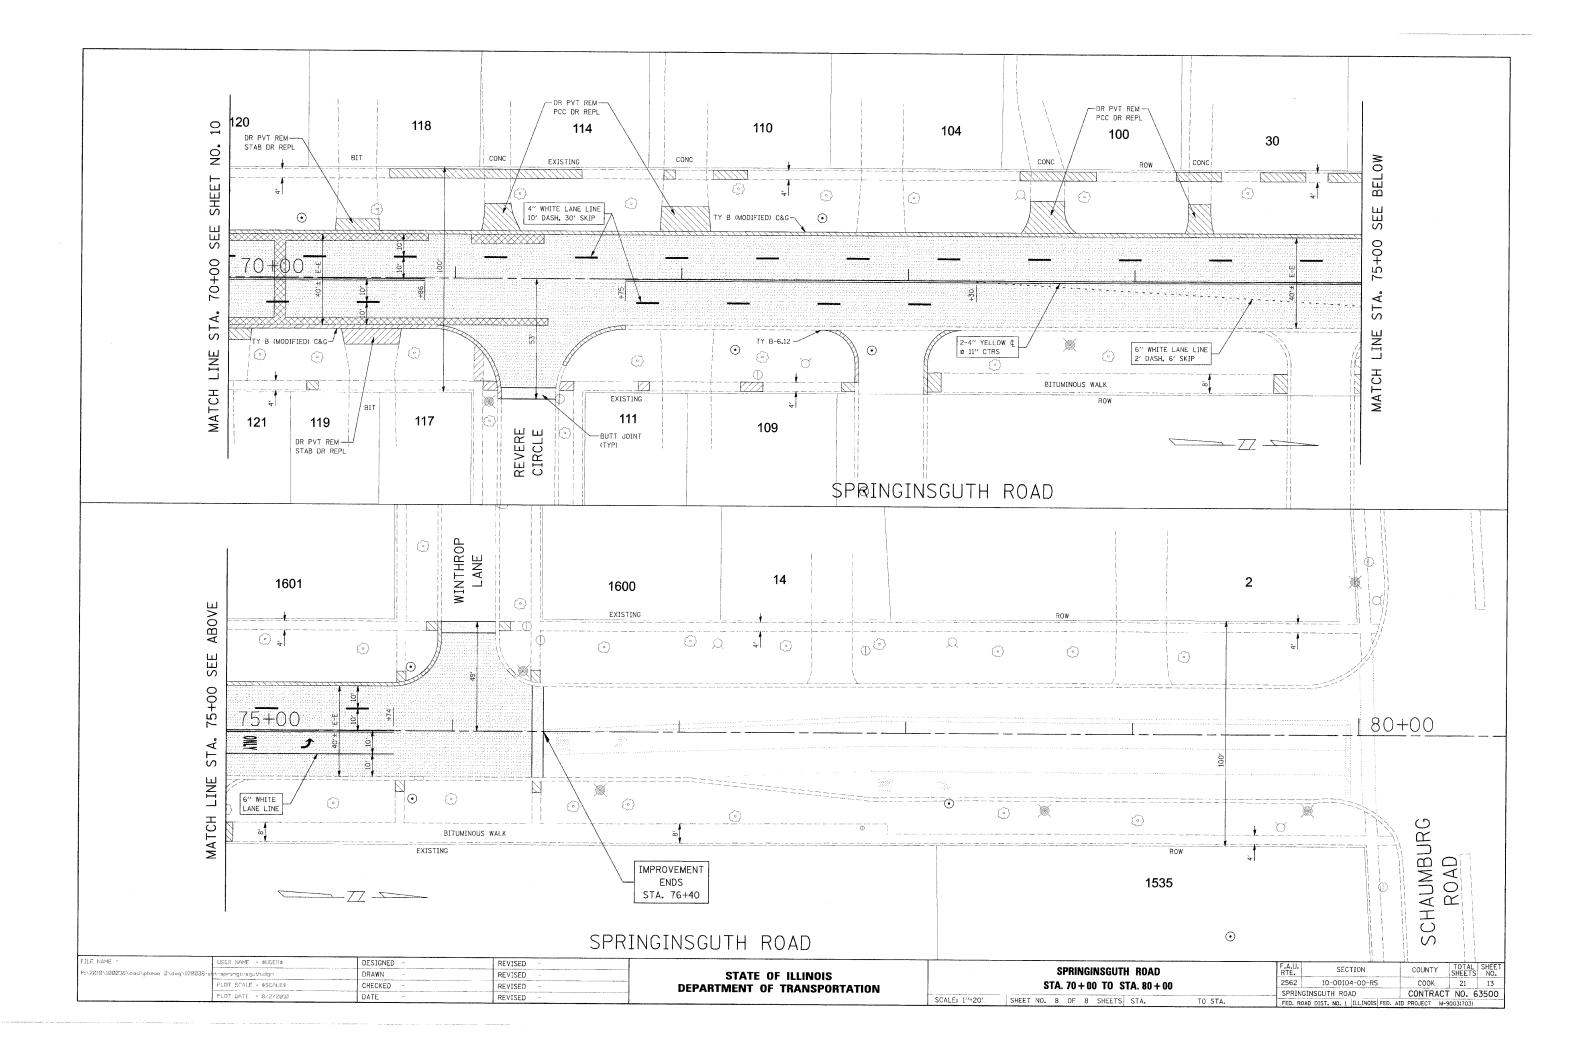


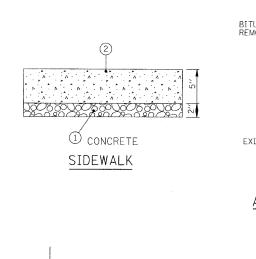

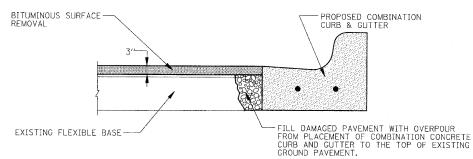


PAVEMENT RESTORATION DETAIL ADJACENT TO REMOVED AND REPLACED CURB & GUTTER

ALL WORK INCLUDED IN THE COST OF THE ASSOCIATED CURB AND GUTTER AND CURB AND GUTTER REMOVAL PAY ITEMS. (AREAS WITH NO PAVEMENT IMPROVEMENTS)

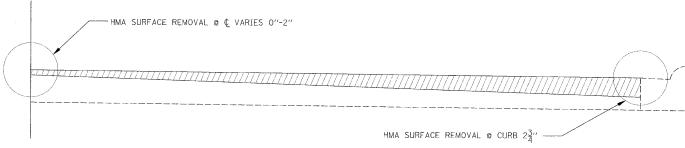

HMA SURFACE REMOVAL DETAIL

NOT TO SCALE

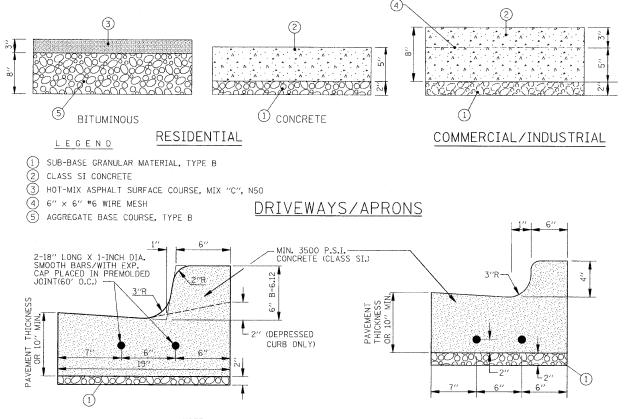


USE TWO NO. 5 RE-BARS FOR 10' ON EITHER SIDE OF ALL UTILITY TRENCHES. INSTALL 1" EXPANSION JOINT AT POINTS OF CURVATURE, AT CONSTRUCTION JOINTS AND AT A DISTANCE NOT TO EXCEED 60'. CONTRACTION JOINTS SHALL BE PLACED BETWEEN EXPANSION JOINTS AT DISTANCES NOT TO EXCEED 15'.

COMBINATION CURB & GUTTER

TYPE B-6.12

COMBINATION CURB & GUTTER TYPE B (MODIFIED)

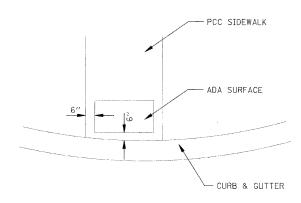

DETECTABLE WARNING DETAIL

NOT TO SCALE



FILE NAME =

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ALIGNAENT CHECKED
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CADD FILE NAME


PLAN NOTE BOOK NO.

USER NAME =	DESIGNED -	REVISED _	-
	DRAWN -	REVISED -	
PLOT SCALE =	CHECKED -	REVISED	
PLOT DATE =	DATE _	REVISED -	
			-

STATE OF ILLINOIS **DEPARTMENT OF TRANSPORTATION**

SPRINGINSGUTH ROAD IMPROVEMENTS DETAILS F.A. U. RTE. 2562 1	SECTION			
H⊕ J K.	2562	10-00104-00-RS		
			SPRINGI	NSGUTH ROAD
CALE:	SHEET NO 1 OF 1 SHEETS ST	A TO STA	EED BOAD	DIST NO 1 THE INOTE OF

COUNTY TOTAL SHEET NO.
COOK 21 14 COUNTY CONTRACT NO. 63500

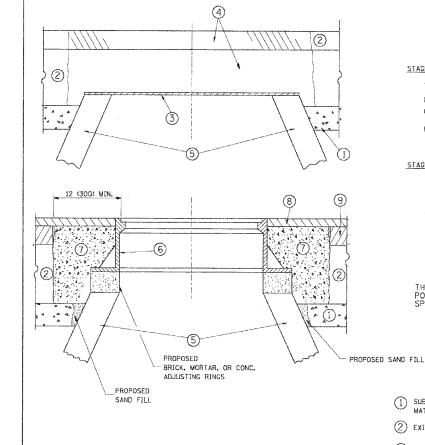

NOTES

EXISTING BROKEN FRAMES AND LIDS SHALL BE REMOVED AND DISPOSED OF BY THE CONTRACTOR AND SHALL BE REPLACED AS DIRECTED BY THE ENGINER. REPLACEMENT FRAMES AND LIDS WILL BE PAID FOR IN ACCORDANCE WITH ARTICLE 109.40 OF THE STANDARD SPECIFICATIONS UNLESS A SEPARATE PAY ITEM HAS BEEN PROVIDED.

IF THE EXISTING LIDS ARE OPEN, THE FRAME WILL BE ADJUSTED TO THE ELEVATION OF THE MILLED PAVEMENT SURFACE PRIOR TO THE MILLING OPERATION. THE FRAME WILL NOT BE REMOVED AND COVERED BY THE METAL PLATE.

CITY OF CHICAGO CASTINGS ARE THE PROPERTY OF THE CITY AND THE CONTRACTOR SHALL NOTIFY THE CITY FOR REMOVAL AND DISPOSITION OF THE CASTINGS.

THE METAL PLATE USED TO COVER THE STRUCTURE SHALL REMAIN THE PROPERTY OF THE CONTRACTOR.

WHEN STRUCTURES ARE TO BE ADJUSTED OR RECONSTRUCTED, THE LOWERING AND RAISING OF THE FRAMES AND LIDS WILL NOT BE PAID FOR SEPARATELY BUT WILL BE INCLUDED IN THE COST OF THE CORRESPONDING PAY ITEM.

CONSTRUCTION PROCEDURES

STAGE 1 (BEFORE PAVEMENT MILLING)

- A) REMOVE A MINIMUM OF 12 (300) OF THE PAVEMENT FROM AROUND THE STRUCTURE.
- B) REMOVE THE EXISTING FRAME AND LID FROM THE STRUCTURE.
- C) COVER THE STRUCTURE OPENING WITH A 36 (900) DIAMETER METAL PLATE.
- D) BACKFILL WITH CRUSHED STONE AND A MINIMUM $1V_2$ (40) THICK HMA SURFACE MIX APPROVED BY THE ENGINEER.

STAGE 2 (AFTER PAVEMENT MILLING)

- A) REMOVE THE HMA SURFACE MIX AND CRUSHED STONE.
- B) INSTALL THE FRAME AND LID; ADJUST THE FRAME TO ITS FINAL SURFACE ELEVATION.
- C) THE SURROUNDING SPACE SHALL BE FILLED WITH CLASS SI CONCRETE, OR HMA SURFACE COURSE OR HMA BINDER COURSE TO THE LEVATION OF THE SURFACE OF THE EXISTING BASE COURSE OR THE BINDER COURSE,

THE PROCEDURE EXPLAINED ABOVE SHALL CONFORM TO THE APPLICABLE PORTIONS OF SECTIONS 353, 406, 602, AND 603 OF THE STANDARD SPECIFICATIONS.

LEGEN

- 1 SUB-BASE GRANULAR MATERIAL
- 6 FRAME AND LID (SEE NOTES)
- 2 EXISTING PAVEMENT
- CLASS SI CONCRETE, HMA SURFACE COURSE OR HMA BINDER COURSE
- 3 36 (900) DIAMETER METAL PLATE
- PROPOSED CRUSHED STONE AND HMA SURFACE MIX
- 8 PROPOSED HMA SURFACE COURSE
- 5 EXISTING STRUCTURE
- 9 PROPOSED HMA BINDER COURSE

LOCATION OF STRUCTURES:

THE CONTRACTOR WILL BE REQUIRED TO KEEP A RECORD OF THE LOCATIONS OF THE BURIED STRUCTURES ACCORDING TO THE STATION AND DISTANCE LEFT OR RIGHT OF THE CENTERLINE OF PAVEMENT. LYON COMPLETION OF THE WORK, THE CONTRACTOR WILL DELIVER THE RECORD TO THE ENGINEER.


BASIS OF PAYMENT: THIS WORK WILL BE PAID FOR AT THE CONTRACT UNIT PRICE PER EACH FOR "FRAMES AND LIDS TO BE ADJUSTED, SPECIAL"

NEW FRAMES AND LIDS. WHEN SPECIFIED. WILL BE PAID FOR SEPARATELY.

DETAILS FOR FRAMES AND LIDS ADJUSTMENT WITH MILLING

ALL DIMENSIONS ARE IN INCHES (MILLIMETERS) UNLESS OTHERWISE SHOWN

l-								
	FILE NAME =	USER NAME = gaglianobt	DESIGNED - R. SHAH	REVISED - R. SHAH 03-10-95		MPTALLO PAR	F.A.U. SECTION	COUNTY TOTAL SHEET
ı	w:\distatd\22x34\bdØ8.dgn		DRAWN -	REVISED - A. ABBAS 03-21-97	STATE OF ILLINOIS	DETAILS FOR	2562 10-00104-00-RS	COOK 21 15
		PLDT SCALE = 50.0000 '/ IN.	CHECKED -	REVISED - R. WIEDEMAN 05-14-04	DEPARTMENT OF TRANSPORTATION	FRAMES AND LIDS ADJUSTMENT WITH MILLING	RDGAG A2 (RD 8)	CONTRACT NO. 63500
L		PLOT DATE = 1/4/2008	DATE - 10-25-94	REVISED - R. BORO 01-01-07		SCALE: NONE SHEET NO. 1 OF 1 SHEETS STA. TO STA.	ומייימים ניייים מיייים	AID PROJECT M-9003(703)

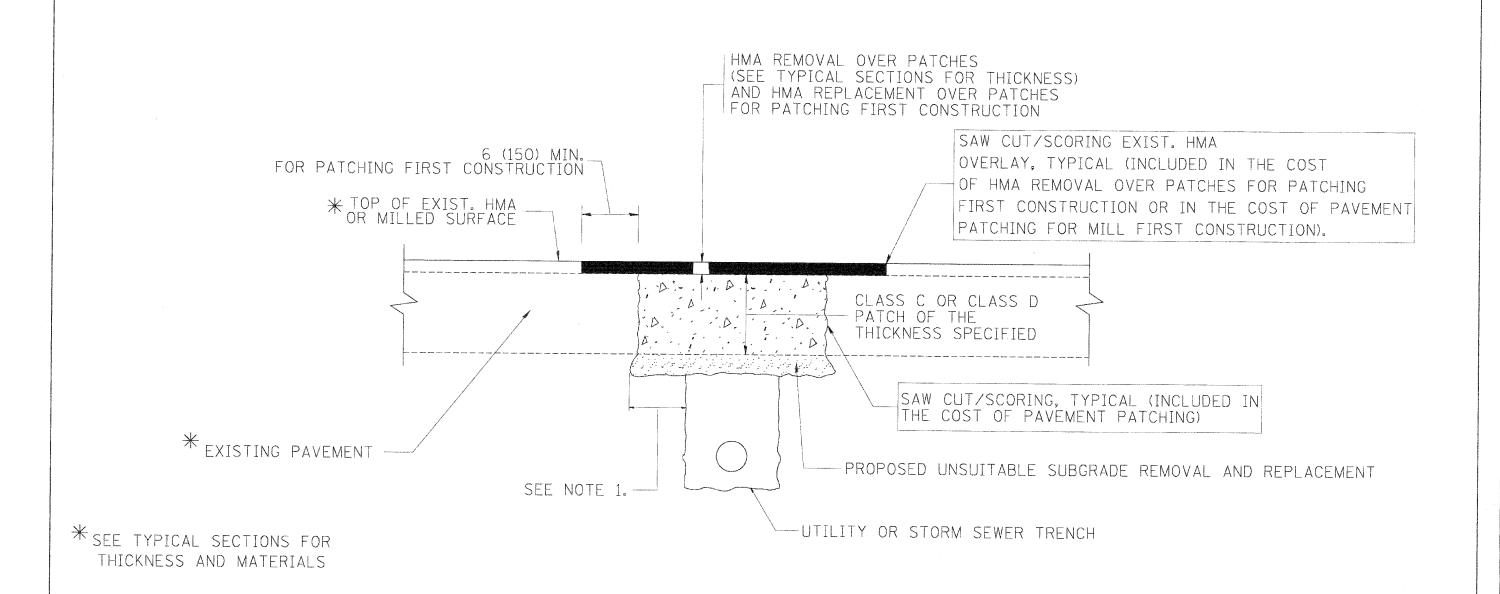

NOTES:

- 1. THE WIDTH OF THE FULL DEPTH PATCH OVER A TRENCH SHALL BE 12 (300) WIDER ON EACH SIDE OF THE TRENCH.
- 2. FOR METHOD OF MEASUREMENT AND BASIS OF PAYMENT, SEE RECURRING SPECIAL PROVISION "PATCHING WITH HOT-MIX ASPHALT OVERLAY REMOVAL".

SEQUENCE OF CONSTRUCTION (PATCHING FIRST)


- 1. REMOVE THE EXISTING HMA MATERIAL OVER THE AREA TO BE PATCHED.
- 2. REMOVE AND REPLACE WITH CLASS C OR D PATCH.
- 3. REPLACE HMA MATERIAL OVER THE AREA TO BE PATCHED.

SEQUENCE OF CONSTRUCTION (MILLING FIRST)


- 1. MILL HMA FIRST IF THERE IS AT LEAST 41/2 INCHES OR MORE OF HMA MATERIAL ON TOP OF THE EXISTING PAVEMENT OR IF THE PAVEMENT IS FULL DEPTH HMA. A MINIMUM OF 2 INCHES OF HMA MATERIAL SHALL BE IN PLACE AFTER MILLING.
- 2. REMOVE AND REPLACE WITH FULL DEPTH CLASS D PATCHES TO TOP OF MILLED SURFACE.

ALL DIMENSIONS ARE IN INCHES (M)LLIMETERS) UNLESS OTHERWISE SHOWN.

FILE NAME #	USER NAME = bauerdl	DESIGNED - R. SHAH	REVISED - A. ARRAS 04-27-98			
o:\projects\d:ststd??x34\bd22.dgn		DRAWN -	REVISED - R. BORO 01-01-07	STATE OF ILLINOIS	PAVEMENT PATCHING FOR	RTE. SECTION COUNTY SHEET NO.
	PLOT SCALE = 50.000 1/ IN.	CHECKED	REVISED - R. BORO 09-04-07	DEPARTMENT OF TRANSPORTATION	HMA SURFACED PAVEMENT	2562 10-00104-00-RS COOK 21 16
	PLOT DATE = 10/27/2008	DATE ~ 10-25-94	REVISED - K. ENG 10-27-08		SCALE: NONE SHEET NO. 1 OF 1 SHEETS STA. TO STA.	### BD400-04 (BD-22) CONTRACT NO. 63500 FED. ROAD DIST. NO. 1
						PEG. ROAD DIST. NO. 1 (ILLINOIS/PED. AIB PROJECT M-9003((03)

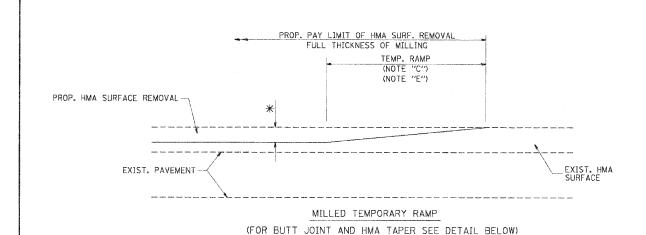


OPTION 1

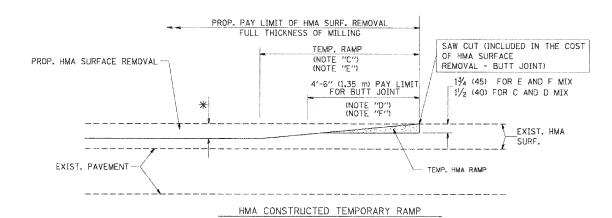



(FOR BUTT JOINT AND HMA TAPER SEE DETAIL BELOW) OPTION 2

TYPICAL TEMPORARY RAMP

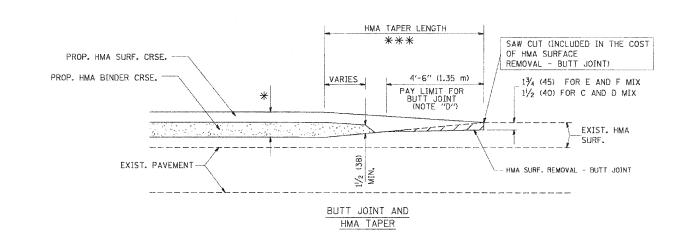

TYPICAL BUTT JOINT AND HMA TAPER FOR MILLING AND RESURFACING

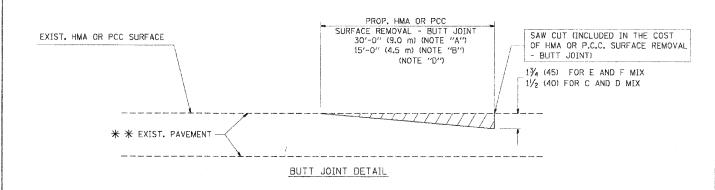

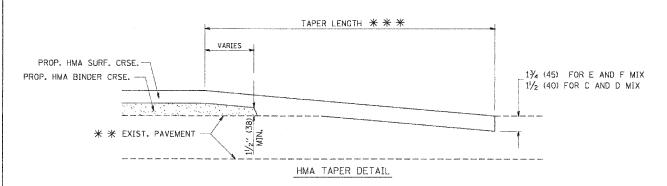

TYPICAL BUTT JOINT AND HMA TAPER FOR RESURFACING ONLY

* PC CONCRETE, HMA OR HMA RESURFACED PAVEMENT.

NOTES

- A: MAINLINE ROADWAYS AND MAJOR SIDE ROADS.
- B: MINOR SIDE ROADS.
- C: THE TEMP. RAMP SHALL BE CONSTRUCTED IMMEDIATELY UPON REMOVAL OF THE EXISTING HMA SURFACE.
- D: THE BUTT JOINT SHALL BE CONSTRUCTED IMMEDIATELY PRIOR TO PLACING THE PROPOSED HMA COURSES.
- E: TAPER THE TEMP. RAMP AT A RATE OF 3'-0" (900 mm) PER 1 INCH (25 mm) OF MILLING THICKNESS.
- F: INSTALLATION AND REMOVAL OF THE 4'-6" (1.35 m) TEMP. RAMP IS INCLUDED IN COST OF HMA SURFACE REMOVAL BUTT JOINT
- G: SEE ARTICLE 406.08 AND 406.14 OF THE STANDARD SPECIFICATIONS FOR "HMA AND/OR PCC SURFACE REMOVAL, BUTT JOINT".
- * SEE TYPICAL SECTIONS FOR MILLING THICKNESS.

BASIS OF PAYMENT:


THE BUTT JOINT WILL BE PAID FOR AT THE CONTRACT UNIT PRICE PER SOUARE YARD (SOUARE METER) FOR "HOT-MIX ASPHALT SURFACE REMOVAL - BUTT JOINT" OR FOR "PORTLAND CEMENT CONCRETE SURFACE REMOVAL- BUTT JOINT".

ALL DIMENSIONS ARE IN INCHES (MILLIMETERS) UNLESS OTHERWISE SHOWN.

FILE NAME =	USER NAME = gaglianebt	DESIGNED	-	M. DE YONG	REVISED	-	R. SHAH 10-25-94	
W:\distatd\22x34\bd32.dgn		DRAWN	-		REVISED	-	A. ABBAS 03-21-97	
	PLOT SCALE = 50.00000 '/ IN.	CHECKED	-		REVISED		M. GOMEZ 04-06-01	DEPARTI
	PLOT DATE = 1/4/2008	DATE		06-13-90	REVISED	-	R. BORO 01-01-07	

STATE	OF	ILLINOIS
DEPARTMENT	OF	TRANSPORTATION

		BU	IT JOINT /	AND		RTE.	SECTION	COUNTY	SHEETS	NO.
						2562	10-00104-00-RS	COOK	21	17
	·	HIN	IMPED DE	IPHLS			BD400-05 BD32	CONTRACT	NO. 6	3500
SCALE: NONE	SHEET NO. 1	OF 1	SHEETS	STA.	TO STA.	FED. R	OAD DIST. NO. 1 ILLINOIS FED. A	ID PROJECT M-	9003(703)	

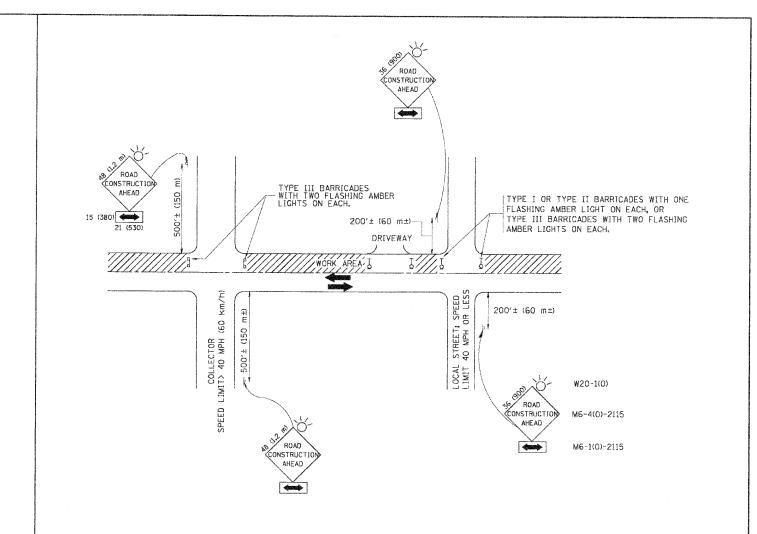

TRAFFIC CONTROL AND PROTECTION FOR SIDE ROADS, INTERSECTIONS, AND DRIVEWAYS

NOTES:

- A. FOR NO LANE RESTRICTION ON THE SIDE ROAD OR DRIVEWAYS
- 1. SIDE ROAD WITH A SPEED LIMIT OF 40 MPH (60 km/h) OR LESS AS SHOWN ON THE DRAWING AND AS DIRECTED BY THE ENGINEER:
- OF THE MAIN ROUTE.
- b) THE CLOSED PORTION OF THE MAIN ROUTE SHALL BE PROTECTED BY BLOCKING WITH TYPE 1, TYPE II OR TYPE III BARRICADES, 1/3 OF THE CROSS SECTION OF THE CLOSED PORTION.
- 2. SIDE ROAD WITH A SPEED LIMIT GREATER THAN 40 MPH (60 km/h) AS SHOWN ON THE DRAWING AND AS DIRECTED BY THE ENGINEER:
- d) ONE ROAD CONSTRUCTION AHEAD SIGN 48 \times 48 (1.2 m \times 1.2 m) WITH A FLASHER MOUNTED ON IT APPROXIMATELY 500° (150 m) IN ADVANCE OF THE MAIN ROUTE.
- b) THE CLOSED PORTION OF THE MAIN ROUTE SHALL BE PROTECTED BY BLOCKING WITH TYPE III BARRICADES, 1/2 OF THE CROSS SECTION OF THE CLOSED PORTION.
- 3. WHEN THE SIDE ROAD LIES BETWEEN THE BEGINNING OF THE MAINLINE SIGNING AND THE WORK ZONE, A SINGLE HEADED ARROW (M6-1) SHALL BE USED IN LIEU OF THE DOUBLE HEADED ARROW (M6-4).

B. FOR A LANE CLOSURE ON A SIDE ROAD OR DRIVEWAY:


USE APPLICABLE PORTIONS OF THE TYPICAL APPLICATION OF TRAFFIC CONTROL DEVICES (STD. 701501, STD. 701606 OR THE APPROPRIATE STANDARD). THE SPACING OF SIGNS AND BARRICADES SHALL BE ADJUSTED FOR FIELD CONDITIONS AS DIRECTED BY THE ENGINEER. THE DIRECTIONAL ARROW SHALL BE COVERED OR REMOVED WHEN NO LONGER CONSISTENT WITH THE SIDE ROAD LANE CLOSURE.

- C. ADVANCE WARNING SIGNS ARE TO BE OMITTED ON DRIVEWAY UNLESS OTHERWISE NOTED.
- D. THE TRAFFIC CONTROL AND PROTECTION FOR SIDE ROADS, INTERSECTIONS, AND DRIVEWAYS SHALL BE INCIDENTAL TO THE COST OF SPECIFIED TRAFFIC CONTROL STANDARDS OR ITEMS.

All dimensions are in millimeters (inches) unless otherwise shown.


FILE NAME = DESIGNED LHA REVISED J. OBERLE 10-18-95 /;\d:statd\22x34\tolE.dgn DRAWN REVISED A. HOUSEH 03-06-96 CHECKED PLOT SCALE = 50.000 '/ IN. REVISED - A. HOUSEH 10-15-96 LOT DATE = 1/4/2008 DATE 06-89 REVISED -T. RAMMACHER 01-06-0

STATE OF ILLINOIS
DEPARTMENT OF TRANSPORTATION

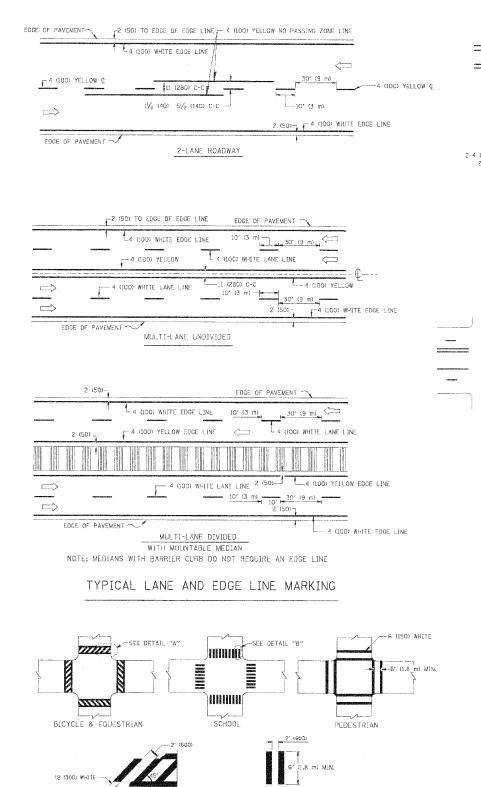


TYPICAL CROSSWALK MARKING

DETAIL "A"

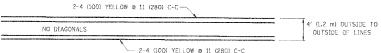


4' (1.2 m) WIDE MEDIANS ONLY

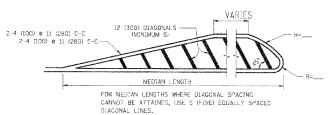

DIAGONAL LINE SPACING: 50° (15 m) C-C (LESS THAN 30MPH (50 km/h)) 75° (25 m) C-C 30MPH (50 km/h) TO 45MPH (70 km/h)) 150° (45 m) C-C (MORE THAN 45MPH (76 km/h))

MEDIANS OVER 4' (1.2 m) WIDE

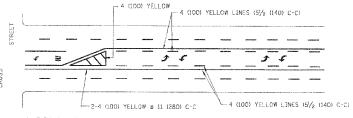


A MINIMUM OF TWO PAIRS OF TURN ARROWS SHALL BE USED, WHITE IN COLOR. ADDITIONAL PAIRS SHALL BE PLACED AT 200' (60 m) TO 300' (90 m) INTERVALS.



MEDIAN WITH TWO-WAY LEFT TURN LANE


TYPICAL PAINTED MEDIAN MARKING

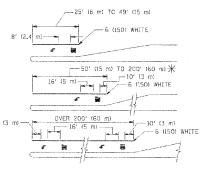

* TURN LANES IN EXCESS OF 400' (120 m) IN LENGTH MAY HAVE AN ADDITIONAL SET OF ARROW - "ONLY" INSTALLED MIDWAY BETWEEN THE OTHER TWO SETS OF ARROW - "ONLY".

TYPICAL LEFT (OR RIGHT) TURN LANE

TYPICAL TURN LANE MARKING

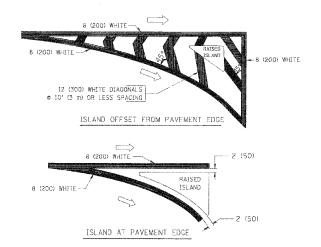

TYPICAL ISLAND MARKING

TYPE OF MARKING	WIDTH OF LINE	PATTERN	COLOR	SPACING / REMARKS
CENTERLINE ON 2 LANE PAVEMENT	4 (100)	SKIP-DASH	YELLOW	10' (3 m) LINE WITH 30' (9 m) SPACE
CENTERLINE ON MULTI-LANE UNDIVIDED PAVEMENT	2 8 4 (100)	SOLID	YELLOW	11 (280) C-C
NC PASSING ZONE LINES: FOR ONE DIRECTION FOR BOTH DIRECTIONS	4 (100) 2 @ 4 (100)	SOLID	YELLOW YELLOW	5½ (140) C-C FROM SKIP-DASH CENTERLINE 11 (280) C-C OMIT SKIP-DASH CENTERLINE BETWEEN
LANE LINES	4 (100) 5 (125) ON FREEWAYS	SKIP-DASH SKIP-DASH	WHITE WHITE	10' (3 m) LINE WITH 30' (9 m) SPACE
DOTTED LINES (EXTENSIONS OF CENTER, LANE OR TURN LANE MARKINGS)	SAME AS LINE BEING EXTENDED	SKIP-DASH	SAME AS LINE BEING EXTENDED	2' (600) LINE WITH 6' (1.8 m) SPACE
EDGE LINES	4 (100)	SOLID	YELLOW-LEFT WHITE-RIGHT	OUTLINE MOUNTABLE MEDIANS IN YELLOW; EDGE LINES ARE NOT USED NEXT TO BARRIER CURB
TURN LANE MARKINGS	6 (150) LINE; FULL SIZE LETTERS & SYMBOLS (8' (2,4m))	SOLID	WHITE.	SEE TYPICAL TURN LANE MARKING DETAIL
TWO WAY LEFT TURN MARKING	2 & 4 (100) EACH DIRECTION	SKIP-DASH AND SOLID	YELLOW	10' (3 m) LINE WITH 30' (9 m) SPACE FOR SKIP-DASH; 5/2 (140) C-C BETWEEN SOLID LINE AND SKIP-DASH LINE
	8' (2.4m) LEFT ARROW	IN PAIRS	WHITE	SEE TYPICAL TWO-WAY LEFT TURN MARKING DETAIL
CROSSWALK LINES (PEDESTRIAN) A. DIAGONALS (BIKE & EQUESTRIAN) B. LONGITUDINAL BARS (SCHOOL)	2 @ 6 (150) 12 (300) @ 45° 12 (300) @ 90°	SOLID SOLID SOLID	WHITE WHITE WHITE	NOT LESS THAN 6' (1.8 m) APART 2' (500) APART 2' (500) APART SEE TYPICAL CROSSWALK MARKING DETAILS.
STOP LINES	24 (600)	SOLID	WHTTE	PLACE 4" (1.2 m) IN ADVANCE OF AND PARALLEL TO CROSSWALK, IF PRESENT. OTHERWISE, PLACE AT DESTREED STOPPING POINT. PARALLEL TO CROSSROAD CENTERLINE, WHERE POSSIBLE
PAINTED MEDIANS	2 @ 4 (100) WITH 12 (300) DIAGONALS @ 45° NO DIAGONALS USED FOR 4' (1.2 m) WIDE MEDIANS	SOLID	YELLOW: TWO WAY TRAFFIC WHITE: ONE WAY TRAFFIC	11 (280) G-C FOR THE DOUBLE LINE SEE TYPICAL PAINTED MEDIAN MARKINS.
GORE MARKING AND CHANNELIZING LINES	8 (200) WITH 12 (300) DIAGONALS @ 45°	SOLID	WRITE	DIAGONALS: 15' (4.5 m) C-C (LESS THAN 30MPH (50 km/h)) 20' (6 m) C-C 30MPH (50 km/h) TO 45MPH (70 km/h)) 30' (9 m) C-C (OVER 45MPH (70 km/h))
RAILROAD CROSSING	24 (600) TRANSVERSE LINES; "RR" IS 6' (L8 m) LETTERS; 16 (400) LINE FOR "X"	SOLID	WHITE	SEE STATE STANDARD 780001 AREA OF: "R"=3.6 SO, FT. (0.33 m²) EACH "X"=54.0 SQ, FT. (5.0 m²)
SHOULDER DIAGONALS	12 (300) @ 45°	SOLID	WHITE - RIGHT YELLOW - LEFT	50' (15 m) C-C (LESS THAN 30MPH (50 km/h)) 75' (25 m) C-C (30 MPH (50 km/h) TO 45MPH (70 km/h)) 150' (45 m) C-C (OVER 45MPH (70 km/h))

FOR FURTHER DETAILS ON PAVEMENT MARKING REFER TO STANDARD SPECIFICATIONS FOR ROAD AND BRIDGE CONSTRUCTION AND STATE STANDARD 780001.


All dimensions are in inches (millimeters) unless otherwise shown.


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	PLOT SCALE = 50.000 '/ IN.	CHECKED -		REVISED	-	
	PLOT DATE = 9/9/2009	DATE	03-19-90	REVISED	-	

—12 (300) WHITE DETAIL "B"


STATE	OF	ILLINOIS
DEPARTMENT	OF '	TRANSPORTATION

DISTRICT ONE						F.A.U. RTE.		SE	CTION	COUNTY	TOTAL	SHEET NO.
TYPICAL PAVEMENT MARKINGS							10	-0010	4-00-RS	COOK	21	19
								TC-1	3	CONTRACT	NO. 6	3500
SCALE: NONE	SHEET NO. 1	OF 1	SHEETS	STA.	TO STA.	FED. I	ROAD DIS	ST. NO. 1	ILLINOIS FED.	AID PROJECT M-	9003(703)	

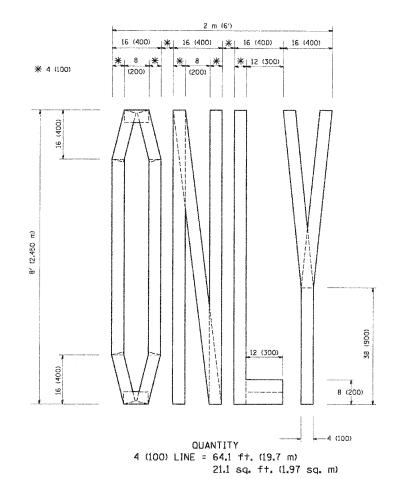

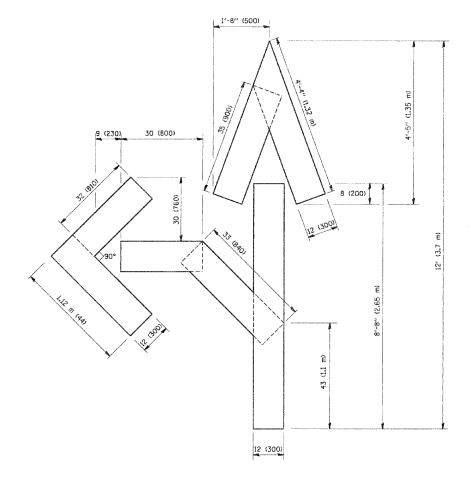


OUANTITY 4 (100) LINE = 82.5 ft. (25.3 m) 27.5 sq. ft. (2.53 sq. m)

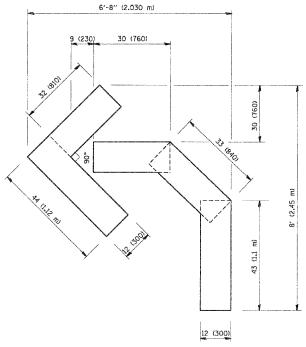


QUANTITY 4 (100) LINE = 45.5 ft. (13.9 m) 15.2 sq. ft. (1.39 sq. m)


All dimensions are in inches (millimeters) unless otherwise shown.

	FILE NAME =	USER NAME = gaglianobt	DESIGNED -	REVISED -T. RAMMACHER 06-05-96		PARTERPLY READMAND I PROPERT AND AUGUSTA	F.A.U. SECTION	COUNTY TOTAL SHEET
	W:\diststd\22x34\te16.dgn		DRAWN -	REVISED -T. RAMMACHER 11-04-97	STATE OF ILLINOIS	PAVEMENT MARKING LETTERS AND SYMBOLS	2562 10-00104-00-F	RS COOK 21 20
		PLOT SCALE = 50.00000 '/ IN.	CHECKED -	REVISED -T. RAMMACHER 03-02-98	DEPARTMENT OF TRANSPORTATION	FOR TRAFFIC STAGING	TC-16	CONTRACT NO. 63500
L		PLOT DATE = 1/4/2008	DATE - 09-18-94	REVISED -E. GOMEZ 08-28-00		SCALE: NONE SHEET NO. 1 OF 1 SHEETS STA. TO STA.	FED. ROAD DIST. NO. 1 [LLINO]	IS FED. AID PROJECT M-9003(703)
								NAMES OF THE OWNER OF THE PARTY

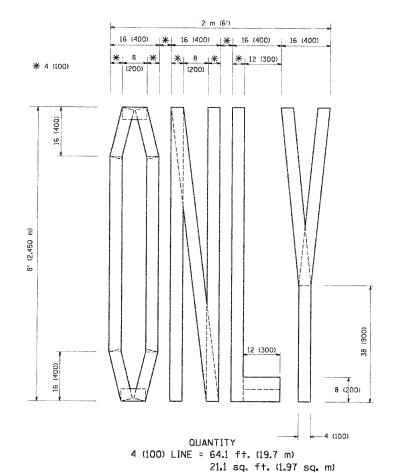

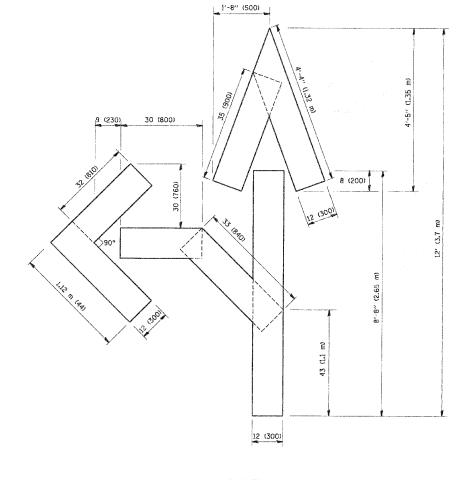

QUANTITY 4 (100) LINE = 82.5 ft. (25.3 m) 27.5 sq. ft. (2.53 sq. m)

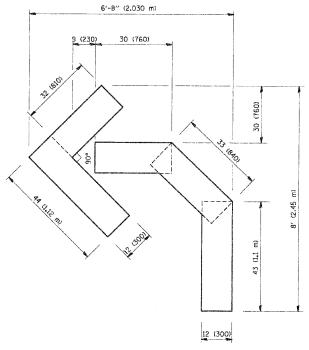

QUANTITY 4 (100) LINE = 45.5 ft. (13.9 m) 15.2 sq. ft. (1.39 sq. m)

All dimensions are in inches (millimeters) unless otherwise shown.

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FILE NAME =	USER NAME = gaglianobt	DESIGNED -	REVISED -T. RAMMACHER 06-05-96			F.A.U. SECTION	COUNTY TOTAL SHEET
W:\distatd\ZZx34\to16.dgn		DRAWN -	REVISED -T. RAMMACHER 11-04-97	STATE OF ILLINOIS	PAVEMENT MARKING LETTERS AND SYMBOLS	RTE. SECTION	COUNTY SHEETS NO.
	PLOT SCALE = 50.0000 '/ IN.	CHECKED -	REVISED -T. RAMMACHER 03-02-98	DEPARTMENT OF TRANSPORTATION	FOR TRAFFIC STAGING	2562 10-00104-00-RS	C00K 21 21
	PLOT DATE = 1/4/2008	DATE - 09-18-94	REVISED -E. GOMEZ 08-28-00	Marie Same Paramonis de la restatado de sistema de sante	SCALE: NONE SHEET NO. 1 OF 1 SHEETS STA. TO STA.	FED ROAD DIST NO 1 THENOIS FED	CONTRACT NO. 63500
						FED. ROAD DIST. NO. 1 ILLINOIS FED.	AID PROJECT M-9003(703)