




F.A. RTE.	SECTION	COUNTY	TOTAL SHEETS	SHEET NO.
	06-00543-00-BT	WINNEBAGO	71	---
FED. ROAD DIST. NO.		ILLINOIS	CONTRACT NO.	

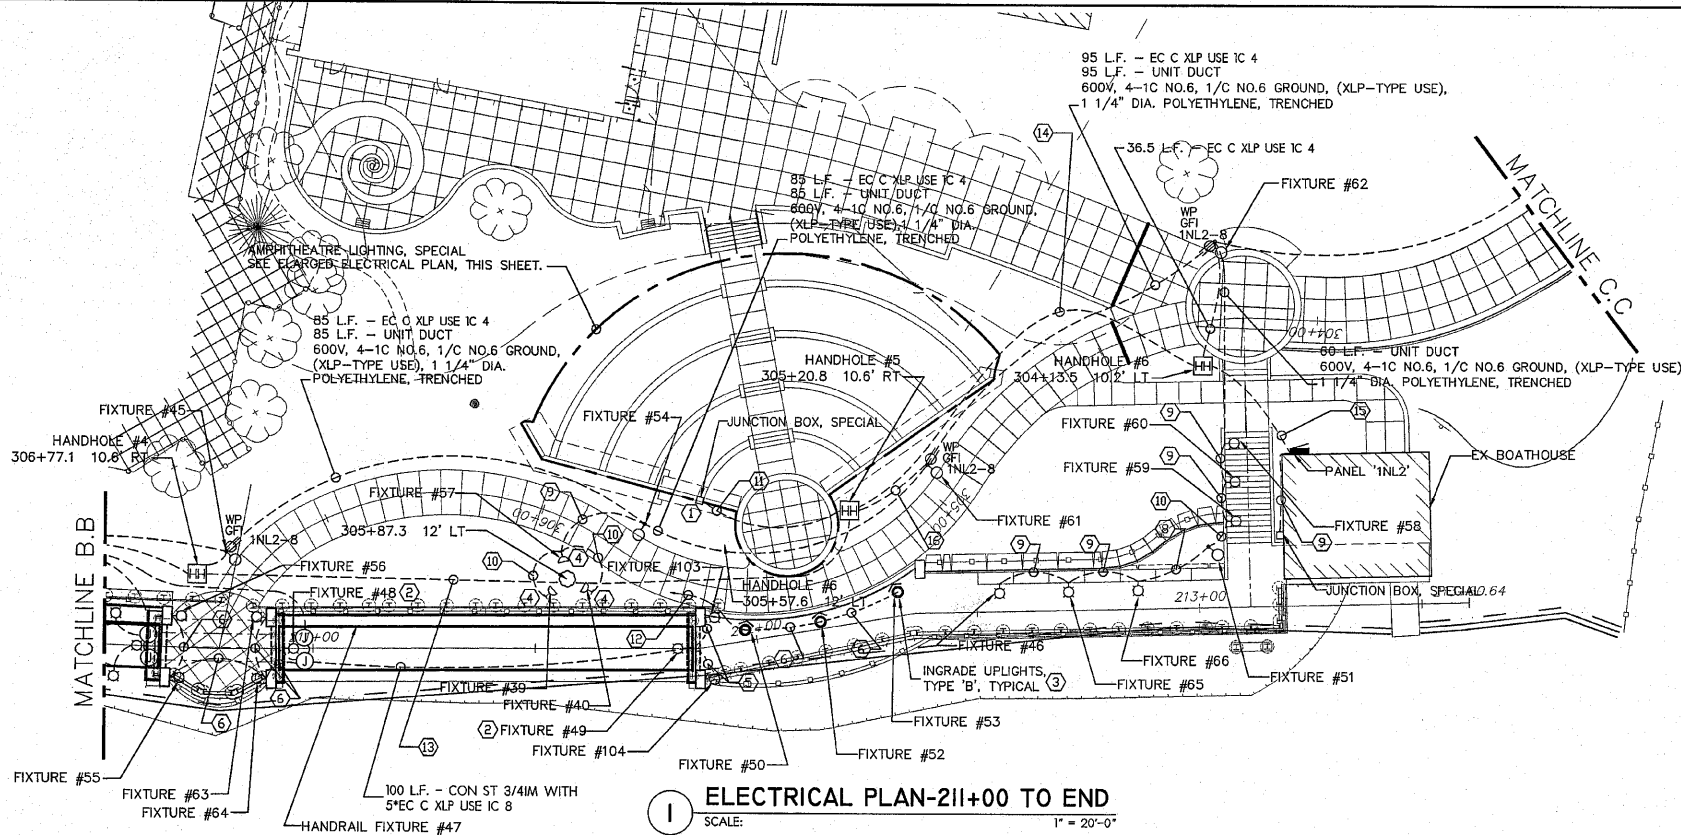


1 ELECTRICAL PLAN-211+00 TO END
SCALE: 1" = 20'-0"

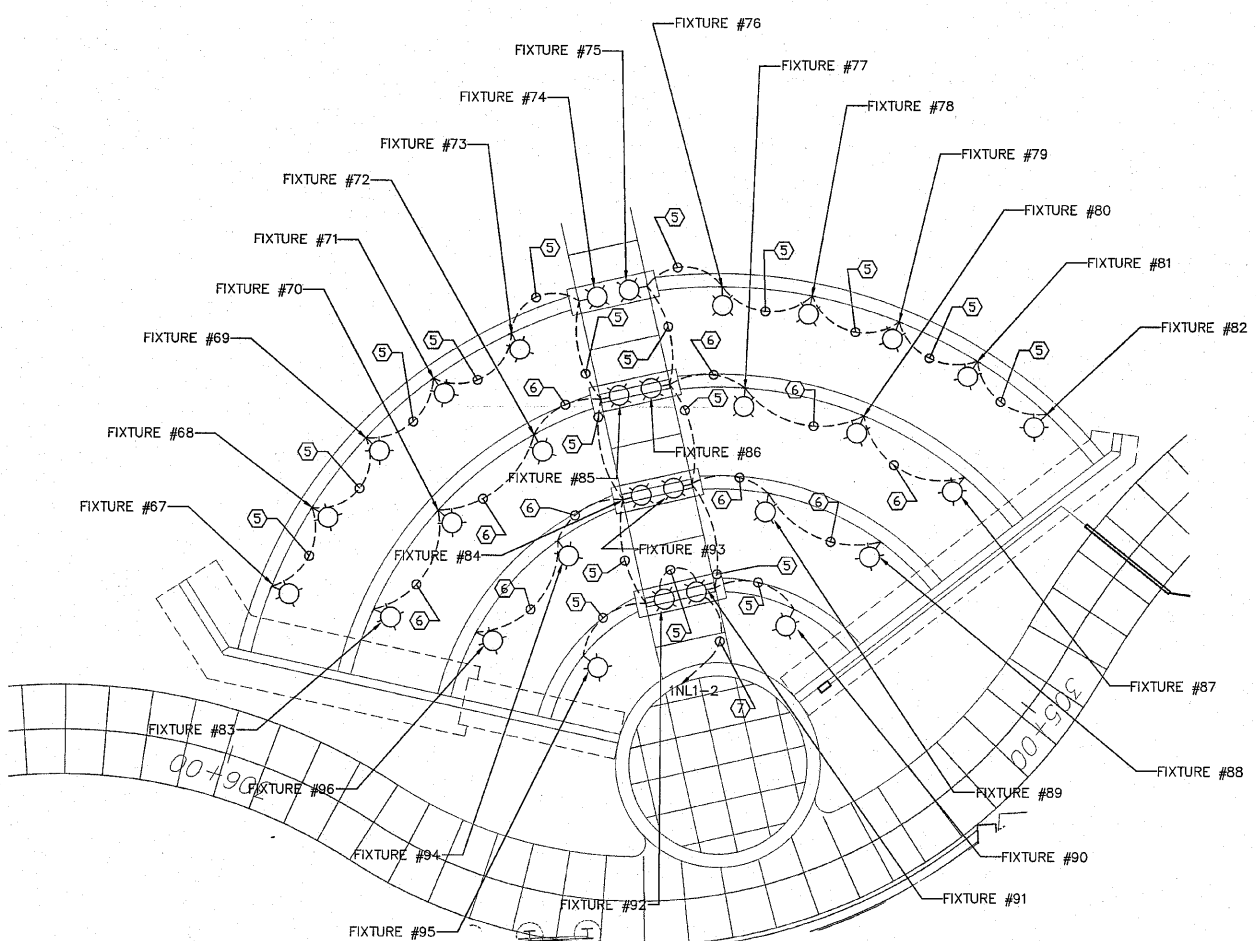

2 ENLARGED ELECTRICAL PLAN
SCALE: 1" = 10'-0"

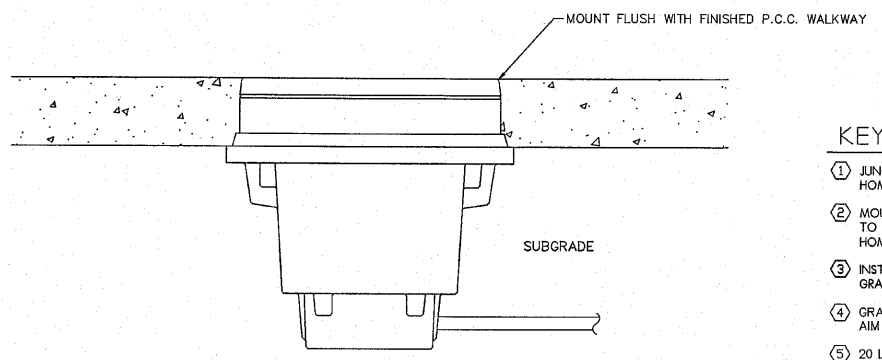


3 FIXTURE TYPE 'B' MOUNTING DETAIL
SCALE: NTS

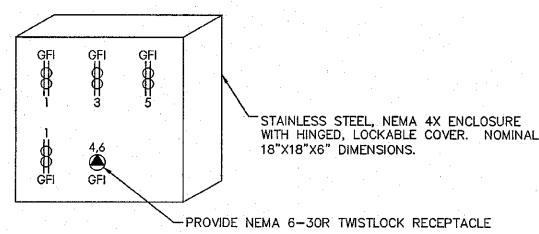

JUNCTION BOX #1, SPECIAL
SCALE: NTS

KEYED NOTES:

- 1 JUNCTION BOX #1, SPECIAL. RECESS INTO RETAINING WALL. HOMERUN TO PANEL 'INL2' WITH 1" WITH 12-#8, 1-#8 GRD.
- 2 MOUNT TYPE 'F' FLOODLIGHT BELOW BRIDGE DECK. MOUNT TO CONCRETE SUPPORT STRUCTURE 24" BELOW DECKING. HOMERUN TO PANEL 'INL1-13(15).
- 3 INSTALL IN-GRADE UPLIGHT FIXTURE FLUSH WITH FINISHED GRADE. HOMERUN TO 'INL1-6(8). SEE DETAIL THIS SHEET.
- 4 GRADE MOUNTED FLOODLIGHT - TYPE 'F' AIM FOR MAXIMUM ILLUMINATION OF SCULPTURE.
- 5 20 L.F. - CON ST 3/4" WITH 5" EC C XLP USE IC 8 (3/4" C-W/4-#8, 1-#8 GRD)
- 6 25 L.F. - CON ST 3/4" WITH 5" EC C XLP USE IC 8 (3/4" C-W/4-#8, 1-#8 GRD)
- 7 300 L.F. - CON ST 3/4" WITH 5" EC C XLP USE IC 8 (3/4" C-W/4-#8, 1-#8 GRD)
- 8 28 L.F. - UNIT DUCT 600V, 4-1C NO.6, 1/C NO.6 GROUND, (XLP-TYPE USE), 1 1/4" DIA. POLYETHYLENE, TRENCHED
- 9 25 L.F. - UNIT DUCT 600V, 4-1C NO.6, 1/C NO.6 GROUND, (XLP-TYPE USE), 1 1/4" DIA. POLYETHYLENE, TRENCHED
- 10 15 L.F. - UNIT DUCT 600V, 4-1C NO.6, 1/C NO.6 GROUND, (XLP-TYPE USE), 1 1/4" DIA. POLYETHYLENE, TRENCHED
- 11 18 L.F. - CONDUIT IN TRENCH, 2" PVC FURNISH WITH PULLCORD
- 12 435 L.F. - CON ST 3/4" WITH 5" EC C XLP USE IC 8 (3/4" C-W/4-#8, 1-#8 GRD)
- 13 153 L.F. - CONDUIT IN TRENCH, 2" FURNISH WITH PULLCORD & 2-#2, 1-#2 GRD
- 14 102 L.F. - CONDUIT IN TRENCH, 2" FURNISH WITH PULLCORD & 2-#2, 1-#2 GRD
- 15 33 L.F. - CONDUIT IN TRENCH, 2" FURNISH WITH PULLCORD & 2-#2, 1-#2 GRD
- 16 19 L.F. - EC C XLP USE IC 4

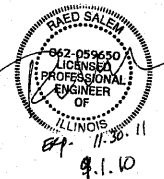

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SHEET REVIEW	
AGENCY	DATE

REVISIONS		
NO.	ITEM	DATE

SCALE:	
HOR.	VER.
1"=20'	1"=5'

DRAWN BY:	MS
CHECKED BY:	JWH
DATE:	OCTOBER 1, 2010

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ELECTRICAL PLAN - 211+00 TO END
RIVERWALK MUSEUM CAMPUS
711 NORTH MAIN STREET
ROCKFORD, IL
FILE:P:\20020 MCCLURE - ROCKFORD RIVERWALK\DWG\ELEC\08-008 PP 211+00 TO END.DWG
JOB:08-29-10-008

SHEET NO.	41
OF	138