11-5-2021 LETTING ITEM 039

COVER SHEET AND INDEX OF SHEETS

GENERAL NOTES

PROPOSED PLAN

GUARDRAIL DETAILS

SUMMARY OF QUANTITIES

SCHEDULE OF QUANTITIES

EXISTING AND REMOVAL

STAGING DETAILS S.N. 072-0164

STAGING DETAILS S.N. 072-0165

STAGING DETAILS S.N. 072-0166

STRUCTURE DETAILS S.N. 072-0164

STRUCTURE DETAILS S.N. 072-0165

STRUCTURE DETAILS S.N. 072-0166

DISTRICT CADD STANDARDS

INDEX OF SHEETS

2.

7-8.

9-10.

11-12.

13-14.

15-16.

17-18.

19-25.

26-27.

28-30.

31-32.

33-39.

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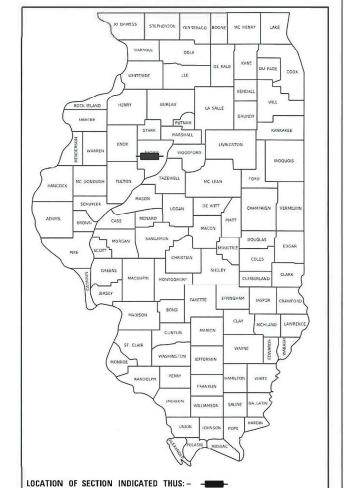
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STATE OF ILLINOIS **DEPARTMENT OF TRANSPORTATION**

1388 [(Z-1D)BR-2]BDR, BJR PEORIA 39 1 LLINOIS CONTRACT NO. 68F74

D-94-063-20



BRIDGE DECK OVERLAY & BRIDGE JOINT REPLACE/REPAIR ON IL 8 STRUCTURES: SN 072-0164 OVER NIXON RUN CREEK; SN 072-0165 OVER WARSAW CREEK AND SN 072-0166 OVER KICKAPOO CREEK TRIBUTARY



PRINTED BY THE AUTHORITY OF THE STATE OF ILLINOIS

PROPOSED HIGHWAY PLANS

FAS ROUTE 1388 (IL 8) SECTION [(Z-1D)BR-2,3;Z-1B-15D)BR]BDR PROJECT STP-Z5II(549) **BRIDGE PRESERVATION PEORIA COUNTY**

R6E

-IL 8 OVER WARSAW RUN CREEK

STA. 751 + 73.8 TO STA. 755 + 25.5

(S.N. 072-0165)

C-94-095-20

001001-02 701311-03 630001-12 701321-18 630301-09 701901-08 IL 8 OVER NIXON RUN CREEK 631031-17 704001-08 631033-08 725001-01 (S.N. 072-0164) 701006-05 780001-05 STA, 594 + 32.2 TO STA, 597 + 16.9 701201-05 782006-01 701301-04

ADT = 2550 (2019)

HIGHWAY STANDARDS

SU = 7.8%MU = 2.7%

16 22 EDWARDS 21 23 24

IL 8 OVER DEER LICK CREEK (S.N. 072-0166)

ENGINEERING SCALES. REDUCED SIZED PLANS WILL NOT CONFORM TO STANDARD SCALES. IN MAKING MEASUREMENTS ON REDUCED PLANS, THE ABOVE SCALES MAY BE USED.

JOINT UTILITY LOCATION INFORMATION FOR EXCAVATORS 1-800-892-0123 OR 811

PROJECT ENGINEER RICHARD DOTSON (309-671-3455) PROJECT MANAGER KEVIN HORST (309-671-3472)

CATALOG NO. 036074-00D CONTRACT NO. 68F74

GROSS LENGTH = 22212.6 FT. = 4.207 MILE NET LENGTH = 823.4 FT. = 0.155 MILE

STA. 814 + 57.8 TO STA. 816 + 44.8

REV. 9/16/21

AVAILABILITY OF ELECTRONIC FILES

MicroStation and GEOPAK files of this project will be made available to the Contractor after contract award. If there is a conflict between the electronic files and the printed contract plans and documents, the printed contract plans and documents shall take precedence over the electronic files. The Contractor shall accept all risk associated with using the electronic files and shall hold the Department harmless for any errors or omissions in the electronic files and the data contained therein. Errors or delays resulting from the use of the electronic files by the Contractor shall not result in an extension of time for any interim or final completion date or shall not be considered cause for additional compensation. The Contractor shall not use, share, or distribute these electronic files except for the purpose of constructing this contract. Any claims by third parties due to use or errors shall be the responsibility of the Contractor. The Contractor shall include this disclaimer with the transfer of these electronic files to any other parties and shall include appropriate language binding them to similar responsibilities.

COMMITMENTS

Commitments are not to be altered without the written approval of all parties to which the commitment was made. No commitments have been made on this project.

BRIDGE OVERLAY NOTIFICATION

After placement of the bridge deck overlay, the Resident Engineer shall notify the District Bridge Maintenance Engineer of the "as constructed" milling depth and overlay thickness for updating the Illinois Highway Information System.

BUTT JOINT CUTTING TIME RESTRICTION

Butt joints shall not be milled more than three (3) days prior to placement of the HMA surface course.

SECURING DRAINAGE STRUCTURE GRATES

Prior to routing traffic onto the shoulders as shown in the staging plans, the Constractor shall secure gratings on shoulder inlets as directed by the Engineer. This work will not be paid for separately, but shall be included in the cost of the traffic control pay item.

POLYMERIZED BITUMINOUS MATERIALS (TACK COAT) RATES

Surface Type	Residual Rate
Milled (HMA or PCC)	0.08 lb /sq ft
Existing Pavement	0.08 lb /sq ft
Fog Coat (between lifts)	0.08 lb /sq ft

PAVEMENT STATIONING NUMBERS & PLACEMENT

The Contractor shall provide labor and materials required to imprint pavement station numbers in the finished surface of the pavement and/or overlay. The numbers shall be approximately 3/4 inch (20 mm) wide, 5 inches (125 mm) high and 5/8 inch (15 mm) deep.

The pavement station numbers shall be installed as specified herein:

Interval - 200 feet (English stationing) or 100 meters (metric stationing)

Bottom of Numbers - 6 inches (150 mm) from the inside edge of the payement marking

Location:

- 2, 3, & 5 Lane Pavements right edge of pavement in direction of increasing stations
- Multi-Lane Divided Roadways outside edge of pavement in both directions
- Ramps along baseline edge of pavement

Position - stations shall be placed so they can be read from the adiacent shoulder

Format – English (Metric) pavement stations shall use this format "XXX (XX + X00)", where X represents the pavement station

This work will not be paid for separately, but will be included in the cost of the associated pavement and/or overlay pay items.

NAME PLATE RELOCATION ON METAL PLATE BRIDGE RAIL

Name plates that will be removed as a result of this work shall be relocated on the Metal Plate Bridge Rail or concrete parapet wall as directed by the Engineer. The cost of removing and replacing the name plates, including all necessary fasteners, will not be measured or paid for separately but will be considered incidental to the contract.

HOT-MIX ASPHALT MIXTURE REQUIREMENTS

Mixture Use(s):	Polymer Surface (includes Shoulders)	Polymer Binder (includes Shoulders)	Partial Depth Patch 2.5"	8" Shoulders (All Lifts)
AC/PC:	SBS OR SBR 76-28	SBS 76–22	SBS OR SBR 76-28	PG 58-28
Design Air Voids:	4.0% @ N = 50	4.0% @ N = 50	4.0% @ N = 50	4.0% @ N = 50
Mixture Composition:	IL 9.5	IL 4.75	IL 9.5	IL 9.5
(Gradation Mixture)	IL 5.5	IL 4.75	IL 5.5	IL 3.3
Friction Aggregate:	Mix E	N.A.	N.A.	Mix C
Quality Management:	QCQA	QCQA	QCQA	QCQA

Votes:

NO PASSING ZONE VERIFICATION

of centerline striping.

etc. will be allowed.

PAVING SURFACE COURSE

The resident shall contact Operations to verify the

Continuous paving operations on the main roadway

construction of the hot-mix asphalt surface. No interruptions

shall be maintained at all times during the

for side roads, entrances, turn lanes,

location of no passing zones prior to placement

- 1) Individual lift thickness of each mix type will be no less than 3 times nominal maximum aggregate size, unless otherwise approved by the Engineer.
- 2) For design purposes, mixture weight for all mixes is determined to be 112.0 lb/s.y/in., unless otherwise noted.
- 3) Sublot sizes for PFP and QCP mixes will be 1000 tons, unless otherwise agreed to by the Engineer and the paving contractor.

USER NAME = wrightmm	DESIGNED -	REVISED -								F.A.S	SECTION	COUNTY	TOTAL	L SHEET
	DRAWN -	REVISED -	STATE OF ILLINOIS			GENE	RAL N	OTES		1388	[(Z-1D)BR-2]BDR,BJR	PEORIA	39	
PLOT SCALE = 100.0089 ' / in.	CHECKED -	REVISED -	DEPARTMENT OF TRANSPORTATION							1500	[(E 10)011 E]0011/0111	CONTRAC	CT NO.	68F74
PLOT DATE = 8/30/2021	DATE -	REVISED -		SCALE:	SHEET	OF	SHEETS	STA.	TO STA.		ILLINOIS FED.	AID PROJECT		

				C	ONSTRUCTION COL	DE
				80% FED 20% STATE	80% FED 20% STATE	80% FED 20% STATE
				BR I DGE	BR I DGE	BR I DGE
CODE			TOTAL	0013	0013	0013
NO.	ITEM	UNIT	QUANTITY	S.N. 072-0164	S.N. 072-0165	S.N. 072-0166
20200500	EARTH EXCAVATION (WIDENING)	CU YD	6			6
21400100	GRADING AND SHAPING DITCHES	FOOT	150	150		
		1				
40600295	POLYMERIZED BITUMINOUS MATERIALS (TACK COAT)	POUND	1631	257	1214	160
40600982	HOT-MIX ASPHALT SURFACE REMOVAL - BUTT JOINT	SQ YD	743	358	227	158
40600990	TEMPORARY RAMP	SQ YD	118	43	38	37
40603200	POLYMERIZED HOT-MIX ASPHALT BINDER COURSE, IL-4.75,	TON	51		51	
40603200	N50	TON	21		21	
40604170	POLYMERIZED HOT-MIX ASPHALT SURFACE COURSE, IL-9.5, MIX "E", N50	TON	123	30	80	13
48101200	AGGREGATE SHOULDERS, TYPE B	TON	4	4		
48203029	HOT-MIX ASPHALT SHOULDERS, 8"	SQ YD	25			25
10203023		34 15				
50102400	CONCRETE REMOVAL	CU YD	8.8	8.8		
50300255	CONCRETE SUPERSTRUCTURE	CU YD	8.8	8.8		
30300233	CONCRETE SUPERSTRUCTURE	CO ID	0.0	0.0		
50300260	BRIDGE DECK GROOVING	SQ YD	1571	813	318	440
50300300	PROTECTIVE COAT	SQ YD	1655	857	338	460
20300300	THOTECTIVE CONT	34 10	2000			
50800205	REINFORCEMENT BARS, EPOXY COATED	POUND	1330	1330		

MODEL: Schedule of Ouantities FILE NAME: \\illino:s.gov\dot\D4Shared\PD\GEN\WINWORD\STD&PLNS\Squad

STATE OF ILLINOIS DEPARTMENT OF TRANSPORTATION

SUMMARY OF QUANTITIES

F.A.S. RTE.	SECTION	COUNTY	TOTAL SHEETS	SHEET NO.
1388	[(Z-1D)BR-2]BDR,BJR	PEORIA	39	3
		CONTRACT	NO. 6	8F 74
	ILLINOIS FED AT	ID PROJECT		

*= SPECIALTY ITEM

USER NAME = wrightmm	DESIGNED -	REVISED -
	DRAWN -	REVISED -
PLOT SCALE = 100.3227 '/ in.	CHECKED -	REVISED -
PLOT DATE = 9/2/2021	DATE -	REVISED -

	F.A.S. SECTION			COUNTY	TOTAL SHEETS	SHEET NO.
	1388	[(Z-1D)BR-2]BDR,BJ	PEORIA	39	4	
				CONTRACT	NO. 6	8F 74
		ILLINOIS	FED. AI	D PROJECT		
_						

				CONSTRUCTION CODE			
				80% FED 20% STATE	80% FED 20% STATE	80% FED 20% STATE	
				BR I DGE	BR I DGE	BR I DGE	
CODE			TOTAL	0013	0013	0013	
NO.	ITEM	UNIT	QUANTITY	S.N. 072-0164	S.N. 072-0165	S.N. 072-0166	
7010702	5 CHANGEABLE MESSAGE SIGN	CAL DA	42	14	14	14	
7030010	O SHORT TERM PAVEMENT MARKING	FOOT	415	146	139	130	
7030010	SHORT TERM PAVEMENT MARKING	F001	413	140	139	130	
7030015	O SHORT TERM PAVEMENT MARKING REMOVAL	SQ FT	138	49	46	43	
7030090	4 PAVEMENT MARKING TAPE, TYPE IV 4"	FOOT	7127	2593	2388	2146	
7030030	The state of the s	1001	1 121	2333	2300	2110	
7030092	4 PAVEMENT MARKING TAPE, TYPE IV 24"	FOOT	72	24	24	24	
7040010	O TEMPORARY CONCRETE BARRIER	FOOT	1450	537.5	487.5	425	
7040020	RELOCATE TEMPORARY CONCRETE BARRIER	FOOT	1350	462.5	475	412.5	
7060025	1 IMPACT ATTENUATORS, TEMPORARY (NON- REDIRECTIVE, NARROW), TEST LEVEL 3	EACH	6	2	2	2	
	(NAMMOW), ILSI ELVEL S						
7060035	IMPACT ATTENUATORS, RELOCATE (NON- REDIRECTIVE,	FACIL					
7060035	NARROW), TEST LEVEL 3	EACH	6	2	2	2	
7250100	O TERMINAL MARKER - DIRECT APPLIED	EACH	12	4	4	4	
7800111	O PAINT PAVEMENT MARKING - LINE 4"	FOOT	4952	1337	2209	1406	
7800111	O PATINI PAVEMENT MARKING - LINE 4	1001	4932	1337	2209	1400	
7820000	5 GUARDRAIL REFLECTORS, TYPE A	EACH	48	16	16	16	
7830020	2 PAVEMENT MARKING REMOVAL - WATER BLASTING	SQ FT	1282	404	480	398	
. 333020			1202				
X032381	8 CLEANING AND PAINTING EXPOSED REBAR	SQ FT	50	50			
*= SPECI	ALTY ITEM					I E A S	

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STATE OF ILLINOIS
DEPARTMENT OF TRANSPORTATION

SUMMARY OF QUANTITIES

A.S. TE.	SECTION	COUNTY	TOTAL SHEETS	SHEE NO.
388	[(Z-1D)BR-2]BDR,BJR	PEORIA	39	5
		CONTRACT	NO. 6	8F74
	ILLINOIS FED. A	ID PROJECT		

				CONSTRUCTION CODE			
				80% FED 80% FED 80% FED 20% STATE 20% STATE			
				BRIDGE	BRIDGE	BRIDGE	
CODE			TOTAL	0013	0013	0013	
NO.	ITEM	UNIT	QUANTITY	S.N. 072-0164	S.N. 072-0165	S.N. 072-0166	
X0556100	PARTIAL DEPTH PATCHING (SPECIAL)	SQ YD	198		134	64	
X4421000	PARTIAL DEPTH PATCHING	TON	28		19	9	
X6030205	EDAMES AND CDATES TO BE ADJUSTED (CDESIAL)	EACH	2			2	
X0030203	FRAMES AND GRATES TO BE ADJUSTED (SPECIAL)	EACH	2			2	
X7030005	TEMPORARY PAVEMENT MARKING REMOVAL	SQ FT	2519	912	844	763	
Z0001002	GUARDRAIL AGGREGATE EROSION CONTROL	TON	74	31	33	10	
			1655	057	220.4	460	
Z0012130	BRIDGE DECK SCARIFICATION 3/4"	SQ YD	1655	857	338.4	460	
Z0012162	BRIDGE DECK MICROSILICA CONCRETE OVERLAY 2 1/4"	SQ YD	1655	857	338.4	460	
Z0013798	CONSTRUCTION LAYOUT	L SUM	1	1			
20023600	FILLING EXISTING CULVERTS	EACH	1		1		

MODEL: Schedule of Quantities FILE NAME: \\illinois.gov\dot\D4Shared\PD\GEN\WINWQRD\STD&P

STATE OF ILLINOIS
DEPARTMENT OF TRANSPORTATION

SUMMARY OF QUANTITIES

CONSTRUCTION CODE

F.A.S. RTE.	SECTION	COUNTY	TOTAL SHEETS	SHEET NO.
1388	[(Z-1D)BR-2]BDR,BJR	PEORIA	39	6
		CONTRACT	NO. 6	8F74
	ILLINOIS FED. A	ID PROJECT		

				2000 Turkey					
	SHOULDER SCHEDULE								
LOCATION				48203029 HOT-MIX ASPHALT SHOULDERS, 8"	21400100 GRADING AND SHAPING DITCHES	48101200 AGGREGATE SHOULDERS, TYPE B	20200500 EARTH EXCAVATION (WIDENING)		
IL8 LT/RT				LT/RT	SQ YD	FOOT	TON	CUYD	
	S.N	1. 072-0	164						
STA	593+24.00	ТО	597+84.80	RT		150	4.2		
	S.N	N. 072-0	166						
STA	817+01.00	TO	817+42.00	RT	25.2			5.6	
S.N. 072-0164 SUBTOTALS				0	150	4	0		
S.N. 072-0166 SUBTOTALS				25	0	0	6		
			-	TOTALS	25	150	4	6	

TEMPORARY CONCRETE BARRIER SCHEDULE										
	ı	LOCATION	70400100 TEMPORARY CONCRETE BARRIER	70400200 RELOCATE TEMPORARY CONCRETE BARRIER						
	IL	8		LT/RT	FOOT	FOOT				
	S.	N. 072-016	54							
		STAGE I								
STA	593+05.94	TO	598+42.73	RT/LT	537.5					
		STAGEII								
STA	593+60.92	TO	598+23.42	RT/LT		462.5				
	S.	N. 072-016	55							
		STAGE I								
STA	751+07.72	TO	755+82.53	RT/LT	475.0					
	W	STAGE II								
STA	751+06.64	TO	755+92.96	RT/LT	12.5	475.0				
	S.	N. 072-016	56							
		STAGEI								
STA	813+33.10	TO	817+44.90	RT/LT	412.5					
		STAGEII								
STA	813+45.10	TO	817+69.40	RT/LT	12.5	412.5				
		S.N	I. 072-0164 S	UBTOTALS	537.5	462.5				
		S.N	I. 072-0165 S	UBTOTALS	487.5	475.0				
		S.N	I. 072-0166 S	UBTOTALS	425.0	412.5				
				TOTALS	1450	1350				

PAVEMENT MARKING SCHEDULE											
	78001110 PAINT PAVEMENT MARKING - LINE 4"										
	IL	8		EDGE/CL	LT/RT	FT					
STA	591+36.00	TO	600+07.00	CL		283.8					
STA	592+96.00	TO	598+53.00	EDGE	RT	557.0					
STA	593+38.00	TO	598+34.00	EDGE	LT	496.0					
		S.N. 07	72-0165								
STA	749+37.00	TO	757+62.00	CL		1,305.8					
STA	751+20.00	TO	755+68.00	EDGE	RT	448.0					
STA	751+17.00	TO	755+72.00	EDGE	LT	455.0					
		S.N. 07	2-0166								
STA	811+63.00	TO	819+40.00	CL		624.8					
STA	813+47.00	TO	817+31.00	EDGE	RT	384.0					
STA	813+59.00	TO	817+56.00	EDGE	LT	397.0					
			S.N.	072-0164 S	UBTOTALS	1,337					
			S.N.	072-0165 S	UBTOTALS	2,209					
			S.N.	072-0166 S	UBTOTALS	1,406					
					TOTALS	4,951					

1	ΓEMPORARY	/ IMPACT /	ATTENUATOR SC	HEDULE
	STATION		70600251 IMPACT ATTENUATORS, TEMPORARY (NON- REDIRECTIVE, NARROW), TEST LEVEL 3	70600352 IMPACT ATTENUATORS, RELOCATE (NON REDIRECTIVE, NARROW) TEST LEVEL 3
)	L8	LT/RT	EACH	EACH
	S.N. 072-0164	1		
	STAGE I			
STA	593+05.94	LT	1	
STA	598+42.73	LT	1	
	STAGE II			
STA	593+60.92	RT		1
STA	598+23.42	RT		1
	S.N. 0/2-016)		
	STAGE I			
STA	751+07.72	LT	1	
STA	755+82.53	LT	1	
	STAGE II			
STA	751+06.64	RT		1
STA	755+92.96	RT		1
	S.N. 072-016	ŝ		
	STAGE I			
STA	813+33.10	LT	1	
STA	817+44.90	LT	1	
	STAGE II			
STA	813+45.10	RT		1
STA	817+69.40	RT		1
	N. 072-0164 S		2	2
	l. 072-0165 S		2	2
S.N	N. 072-0166 S		2	2
		TOTALS	6	6

MISCELLANEOUS SCHEDULE												
	1	LOCATIO	60500305 FILLING INLETS	Z0023600 FILLING EXISTING CULVERTS								
	IL	8		LT/RT	EACH	EACH						
	S.	N. 072-0	165									
STA	752+63.20	TO	752+93.80	RT	1	1						
		S.N.	1	1								
				TOTALS	1	1						

70106500								
TEMPORARY BRIDGE TRAFFIC SIGNALS								
LOCATION	EACH							
S.N. 072-0164	1							
S.N. 072-0165	1							
S.N. 072-0166	1							
TOTAL	3							

STATE OF ILLINOIS DEPARTMENT OF TRANSPORTATION SCHEDULE OF QUANTITIES

SHEET 1 OF 2 SHEETS STA. TO STA.

 F.A.S. RTE.
 SECTION
 COUNTY
 TOTAL SHEETS
 SHEETS NO.

 1388
 [(Z-1D)BR-2]BDR,BJR
 PEORIA
 39
 7

 CONTRACT NO. 68F74

						RESURFACING	SCHEDULE				
LOCATION				40600295 POLYMERIZE D BITUMINOUS MATERIALS (TACK COAT)	40604170 POLYMERIZED HOT-MIX ASPHALT SURFACE COURSE, IL-9.5, MIX "E", N50	40603200 POLYMERIZED HOT-MIX ASPHALT BINDER COURSE, IL-4.75, N50	40600990 TEMPORARY RAMP	X4421000 PARTIAL DEPTH PATCHING	X0556100 PARTIAL DEPTH PATCHING (SPECIAL)	40600982 HOT-MIX ASPHALT SURFACE REMOVAL- BUTT JOINT	
IL8 LT/RT				LT/RT	POUND	TON	TON	SQ YD	TON	SQ YD	SQ YD
	S.	N. 072-0	164								
STA	594+32.20	TO	594+87.20	LT/RT	128.7	15.0		21.7			178.8
STA	596+87.20	TO	597+16.90	LT/RT	128.7	15.0		21.7			178.8
	S.	N. 072-0	165								
STA	751+73.80	ТО	753+13.50	LT/RT	588.3	39.1	24.6	18.9	7.8	56.0	113.4
STA	753+86.80	TO	755+25.70	LT/RT	625.9	41.3	26.5	18.9	10.9	77.5	113.3
	S.	N. 072-0	166								
STA	814+57.80	ТО	814+87.80	LT/RT	79.0	6.0		18.3	5.3	37.8	71.9
STA	816+14.80	ТО	816+44.80	LT/RT	81.2	7.2		18.3	3.7	26.6	86.2
	•	S.N	. 072-0164 SU	JBTOTALS	257	30	0	43	0	0	358
		S.N	. 072-0165 SU	JBTOTALS	1214	80	51	38	19	134	227
		S.N	. 072-0166 SU	JBTOTALS	160	13	0	37	9	64	158
				TOTALS	1631	123	51	118	28	198	743

	SH	ORT TER	M PAVEMEN	IT MARKIN	IG SCHEDULE	
		LOCATIO	70300100 SHORT TERM PAVEMENT MARKING	70300150 SHORT TERM PAVEMENT MARKING REMOVAL		
		IL8			FOOT	SQ FT
	S.	N. 072-0	164			
STA	591+36	TO	600+07	CL	79.2	26.4
STA	591+36	TO	600+07	RT	33.5	11.2
STA	591+36	TO	600+07	LT	33.5	11.2
	S.	N. 072-0	165			
STA	749+37	TO	757+62	CL	75	25.0
STA	749+37	TO	757+62	RT	31.7	10.6
STA	749+37	TO	757+62	LT	31.7	10.6
	S.	N. 072-02	166			
STA	811+63	TO	819+40	CL	70.6	23.5
STA	811+63	TO	819+40	RT	29.9	10.0
STA	811+63	TO	819+40	LT	29.9	10.0
		S.N.	. 072-0164 SI	JBTOTALS	146	49
		S.N.	. 072-0165 SI	JBTOTALS	138	46
		S.N.	. 072-0166 SI	JBTOTALS	130	43
				TOTALS	415	138

70107025							
CHANGEABLE MESSAGE SIGN							
LOCATION	CAL DA						
S.N. 072-0164 (2 SIGNS/ 7 DAYS EACH)	14						
S.N. 072-0165 (2 SIGNS/ 7 DAYS EACH)	14						
S.N. 072-0166 (2 SIGNS/ 7 DAYS EACH)	14						
TOTAL	42						

70106700								
TEMPORARY RUMBLE STRIPS								
LOCATION	EACH							
S.N. 072-0164	6							
S.N. 072-0165	6							
S.N. 072-0166 (EASTBOUND)	3							
TOTAL	15							

MODEL: Schedule of Quantities FILE NAME: Willinois.gov\dot\D4Shared\PD\GEN\WINWORD\STD&PLNS\S

USER NAME = wrightmm	DESIGNED -	REVISED -
	DRAWN -	REVISED -
PLOT SCALE = 100.0149 ' / in.	CHECKED -	REVISED -
PLOT DATE = 9/2/2021	DATE -	REVISED -

STATE OF ILLINOIS DEPARTMENT OF TRANSPORTATION

SCHEDULE OF QUANTITIES						SECTION
						[(Z-1D)BR-2]BDR,BJR
SHEET 2	OF 2	SHEETS	STA.	TO STA.		ILLINOIS FED. A

SECTION COUNTY TOTAL SHEET NO.

[(Z-1D)BR-2]BDR,BJR PEORIA 39 8

CONTRACT NO. 68F74

SN 072-0165


GUARDRAIL REMOVAL (STA 751+34.7 TO 753+13.9 LT) -SEE STRUCTURE SHEETS GUARDRAIL REMOVAL (STA 750+28.5 TO 752+93.3 RT) GUARDRAIL REMOVAL (STA 754+04.6 TO 756+60.5 LT) GUARDRAIL REMOVAL (STA 753+86.2 TO 755+76.8 RT) -

NOTE:

PARTIAL DEPTH PATCHING (SPECIAL) DEPTH IS 2.5".



USER NAME = wrightmm	DESIGNED -	REVISED -		EXISTING AND REMOVAL	RTE	SECTION	COUNTY	ISHEETS NO.
	DRAWN -	REVISED -	STATE OF ILLINOIS		1388	[(Z-1D)BR-2]BDR.BJR	PEORIA	39 9
PLOT SCALE = 100.0063 / in	CHECKED -	REVISED -	DEPARTMENT OF TRANSPORTATION	S.N. 072–0165		(,,,	CONTRACT	NO. 68F74
PLOT DATE = 8/30/2021	DATE -	REVISED -		SCALE: 1" = 50' SHEET 1 OF 2 SHEETS STA. 1 TO STA. 1		ILLINOIS FED. AI	D PROJECT	

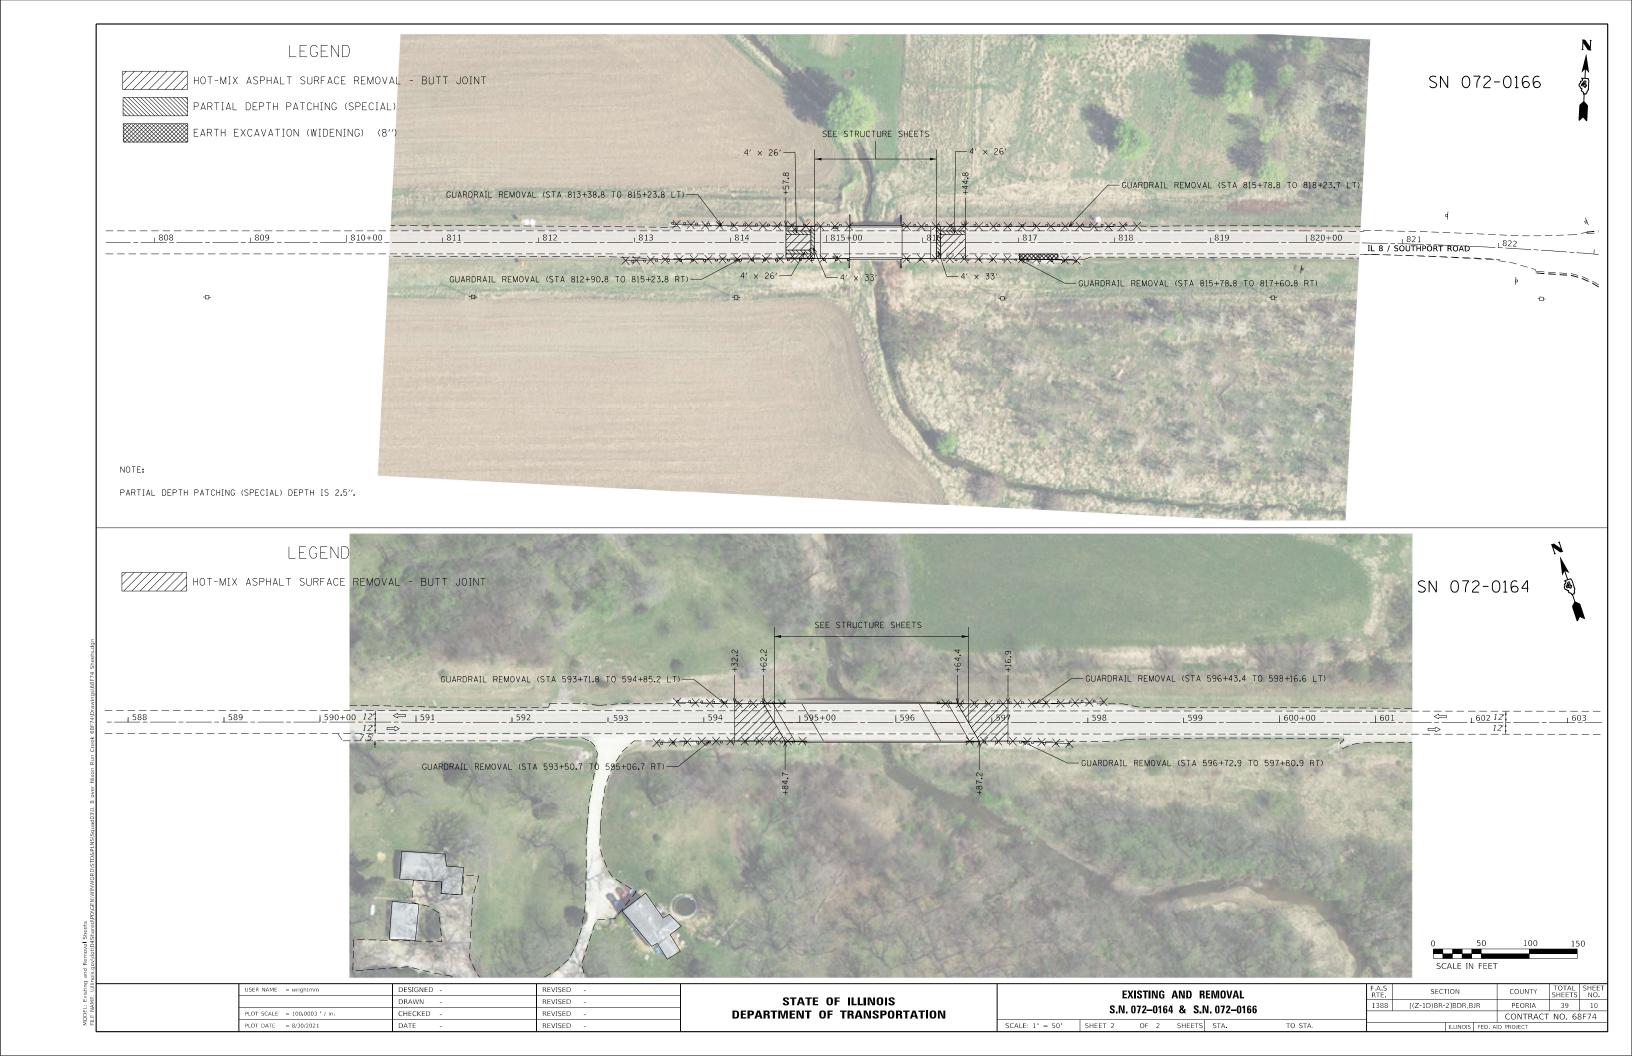



SN 072-0165

4. PARTIAL DEPTH PATCHING DEPTH IS 2.5".

6. FILLING INLETS SHALL INCLUDE REMOVING THE TOP 8" AND CAPPING WITH 8" OF CONCRETE. FILL INLET AND CULVERT WITH CONTROLLED LOW-STRENGTH


5. EXISTING INLET = 22" X 18" X 24"
EXISTING CULVERT = 12" CMP, 32' LONG

MATERIAL.


-POLYMERIZED HOT-MIX ASPHALT SURFACE COURSE, IL-9.5, MIX "E", N50 (1.5") POLYMERIZED HOT-MIX ASPHALT BINDER COURSE, IL-4.75, N50 (VARIABLE DEPTH) -POLYMERIZED HOT-MIX ASPHALT SURFACE COURSE, IL-9.5, MIX "E", N50 (1.5") POLYMERIZED HOT-MIX ASPHALT BINDER SHEETS COURSE, IL-4.75, N50 (VARIABLE DEPTH) FILLING INLETS STA. 752+72.0 15' RT FILLING EXISTING CULVERTS-PLACE 2 TONS GUARDRAIL AGGREGATE EROSION CONTROL AT ABUTMENT NOTE: 1. SEE GUARDRAIL DETAIL SHEETS FOR GUARDRAIL INFORMATION. 2. INSTALL GUARDRAIL AGGREGATE EROSION CONTROL IN LOW AREAS IN THE GUARDRAIL SHELF AS DIRECTED BY THE ENGINEER. NO FABRIC IS REQUIRED UNLESS OTHERWISE NOTED. 3. THE ENGINEER SHALL DETERMINE THE PROPOSED PROFILE ALONG THE HMA OVERLAY TO REDUCE/ELIMINATE THE BUMP AT THE EXISTING APPROACH PAVEMENT.

0	50	100	150
SCAL	E IN FEET		

USER NAME = wrightmm	DESIGNED -	REVISED -				PROPOSED PLAN		F.A.S RTF	SECTION	COUNTY	TOTAL SHEET
	DRAWN -	REVISED -	STATE OF ILLINOIS					1388	[(Z-1D)BR-21BDR.BJR	PEORIA	39 11
PLOT SCALE = 100.0056 / in	CHECKED -	REVISED -	DEPARTMENT OF TRANSPORTATION			S.N. 072-0165		-		CONTRAC	T NO. 68F74
PLOT DATE = 8/30/2021	DATE -	REVISED -		SCALE: 1" = 50'	SHEET 1	OF 2 SHEETS STA. 1	TO STA. 1		ILLINOIS FED. A	ID PROJECT	

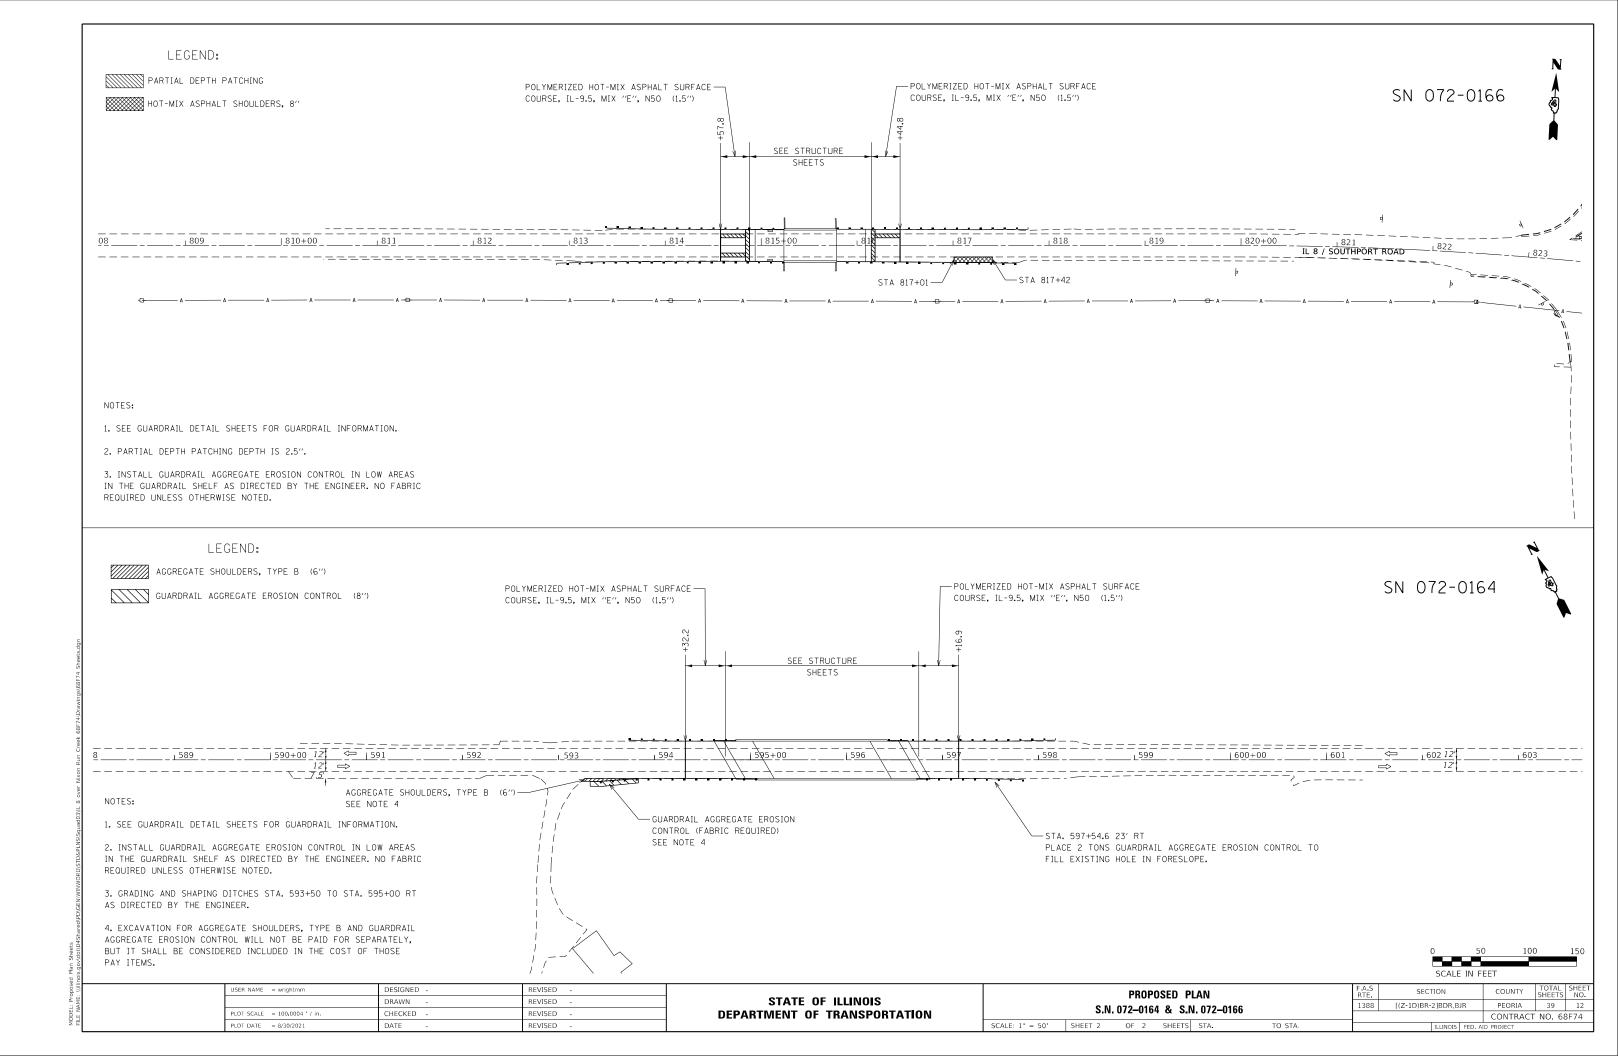


S.N. 072-0164

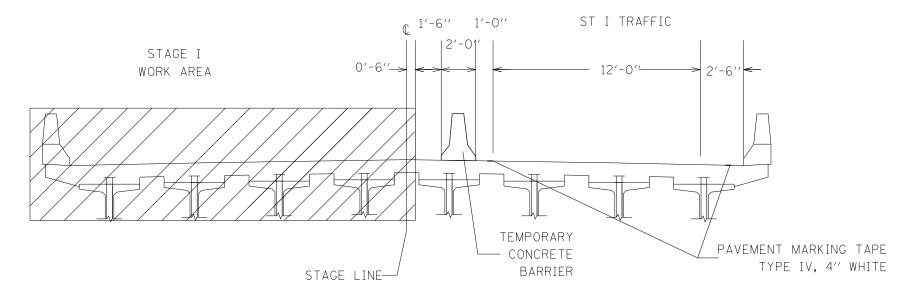

STAGING TYPICAL SECTION STAGE I


(Looking East)

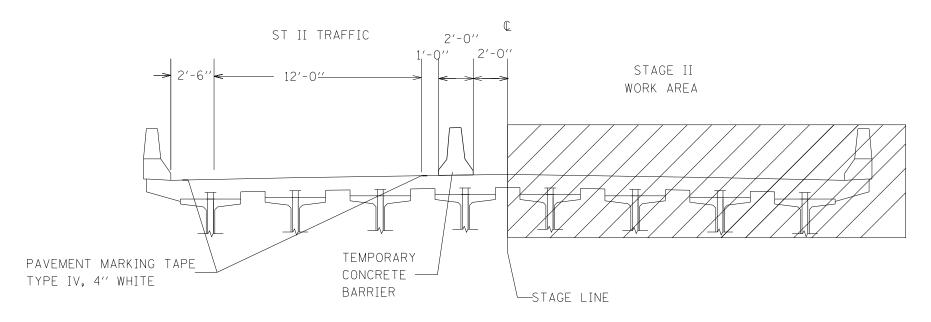


STAGING TYPICAL SECTION

STAGE II (Looking East)

USER NAME = wrightmm	DESIGNED -	REVISED -		STAGING DETAIL			F.A.S RTE	SECTION	COUNTY	TOTAL SHEET SHEETS NO.		
21.27.524.5	DRAWN -	REVISED -	STATE OF ILLINOIS S.N. 072-0164	S.N. 072-0164		[(Z-1D)BR-2]BDR,BJR	PEORIA	39 13				
PLOT SCALE = 100.0019 ' / in. PLOT DATE = 8/30/2021	CHECKED - DATE -	REVISED -	— DEPARIMENT OF TRANSPORTATION	SCALE:	SHEET	OF.	SHEETS STA.	TO STA.	+	TILLINOIS FED.	CONTRAC	T NO. 68F74

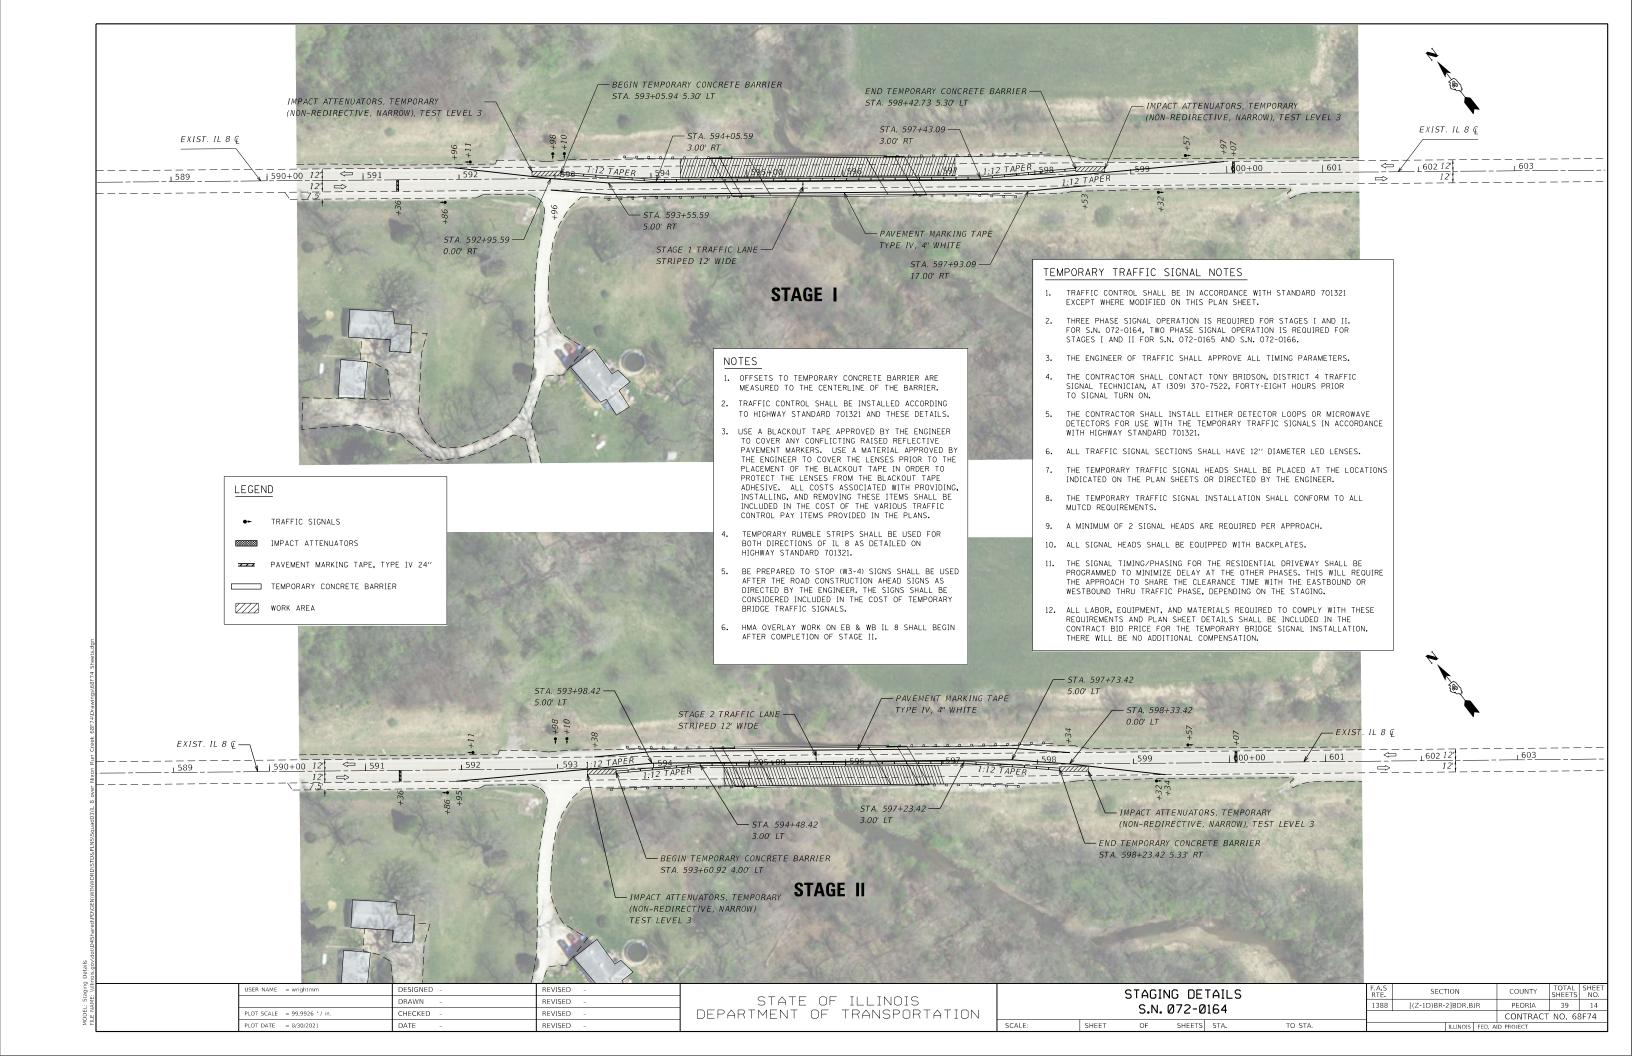


S.N. 072-0165

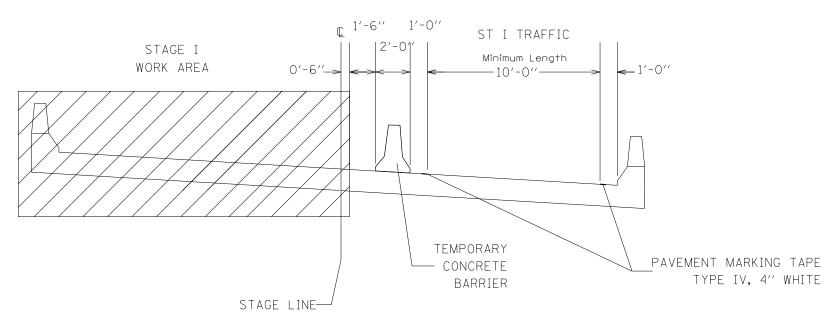

STAGING TYPICAL SECTION

STAGE I

(Looking East)

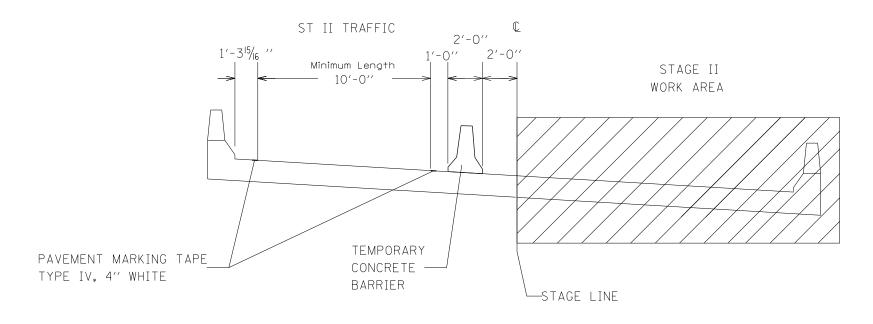


STAGING TYPICAL SECTION

STAGE II


(Looking East)

USER NAME = wrightmm	DESIGNED -	REVISED -				STAGI	ING DE	ΤΔΙΙ		F.A.S RTF	SECTION	COUNTY	TOTAL	SHEET
	DRAWN -	REVISED -	STATE OF ILLINOIS				072-0			1388	[(Z-1D)BR-2]BDR,BJR	PEORIA	39	15
PLOT SCALE = 100.0015 / in.	CHECKED -	REVISED -	DEPARTMENT OF TRANSPORTATION			2.11.	ש-27ש	160				CONTRAC	T NO. 68	8F74
PLOT DATE = 8/30/2021	DATE -	REVISED -		SCALE:	SHEET	OF	SHEETS	STA.	TO STA.		ILLINOIS FED. A	ID PROJECT		

MODEL: Typical Section
FILE NAME: \\(\text{III}\) in in its is a coval of the section

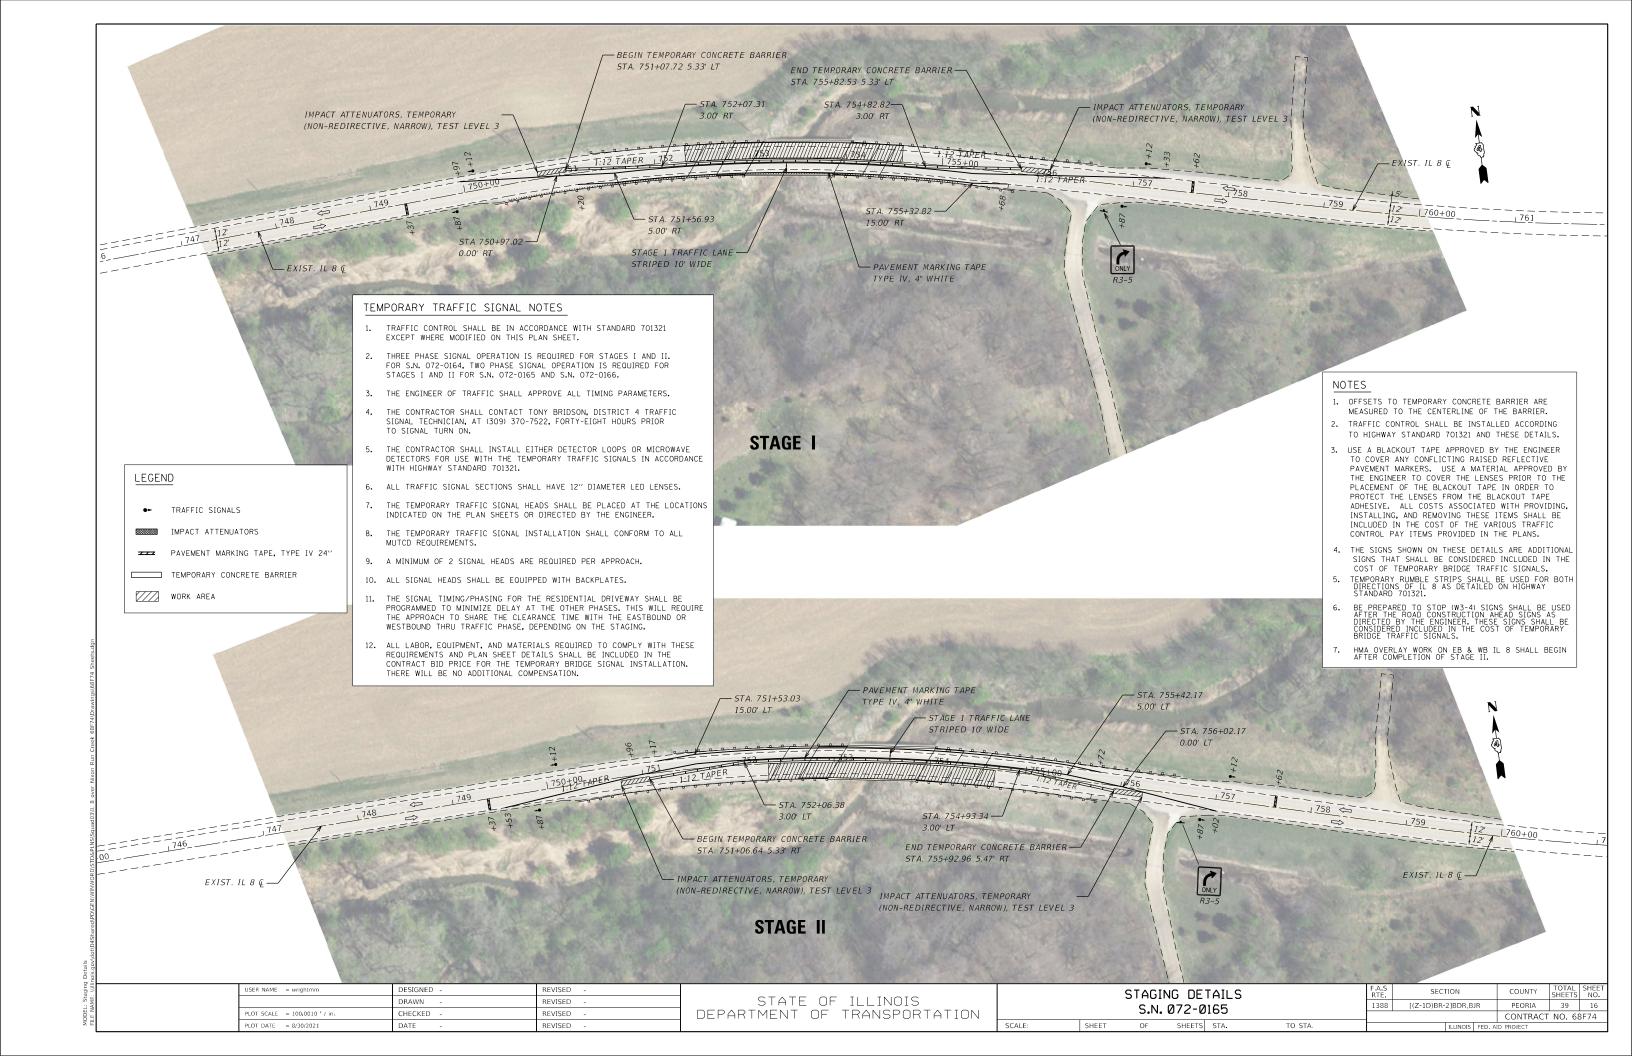


S.N. 072-0166

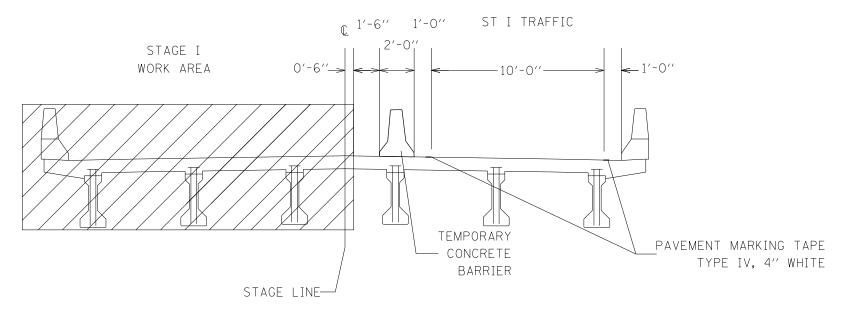

STAGING TYPICAL SECTION

STAGE I

(Looking East)

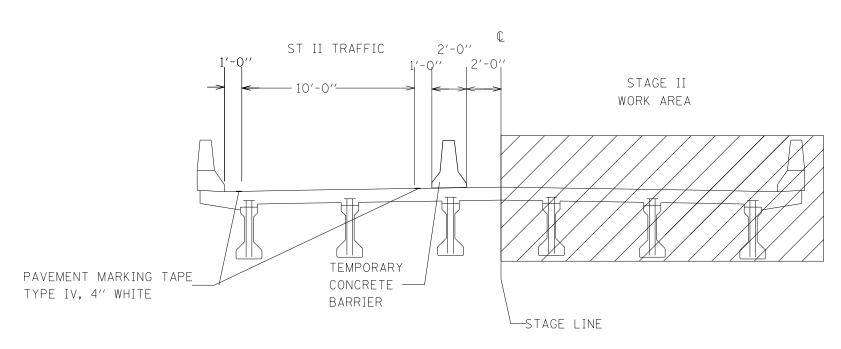



STAGING TYPICAL SECTION

STAGE II

(Looking East)

USER NAME = wrightmm	DESIGNED -	REVISED -				STAGI	ING DET	ΔΊΙ		F.A.S DTE	SECTION	COUNTY	TOTAL	SHEET
	DRAWN -	REVISED -	STATE OF ILLINOIS							1388	[(Z-1D)BR-2]BDR.BJR	PEORIA	39	17
PLOT SCALE = 100.0025 / in.	CHECKED -	REVISED -	DEPARTMENT OF TRANSPORTATION			5.N.	072-01	00				CONTRAC	T NO. 68	8F74
PLOT DATE = 8/30/2021	DATE -	REVISED -		SCALE:	SHEET	OF	SHEETS	STA.	TO STA.		ILLINOIS FED	AID PROJECT		

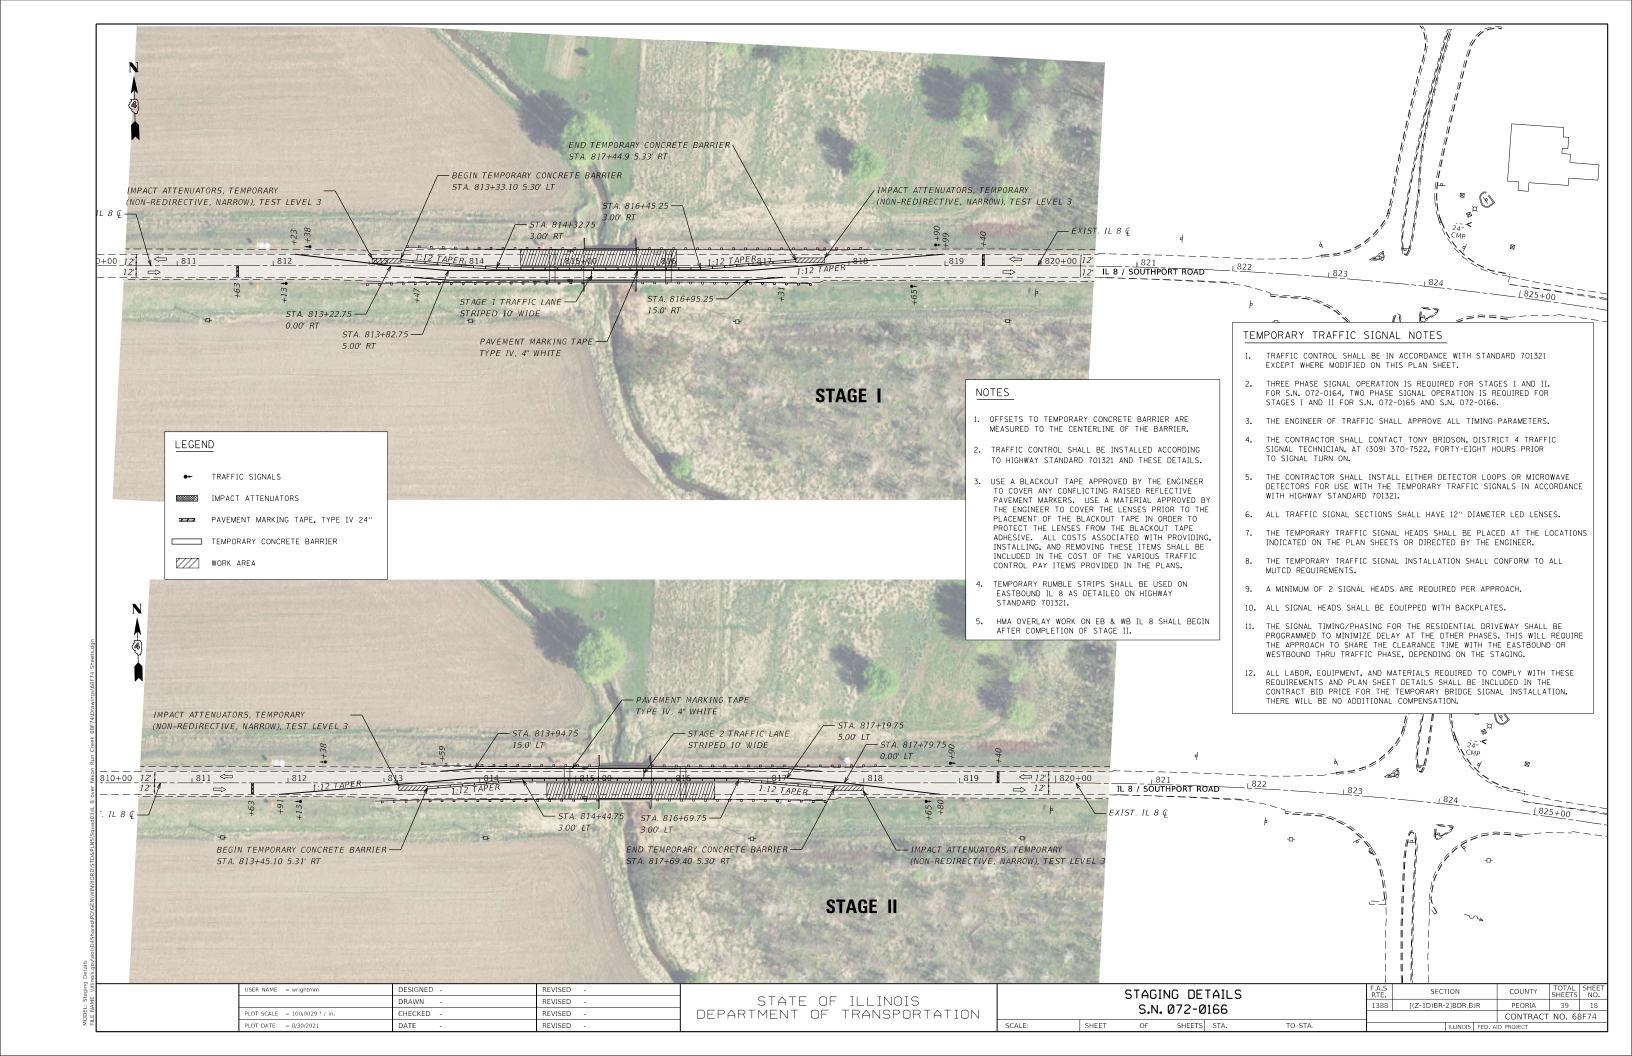

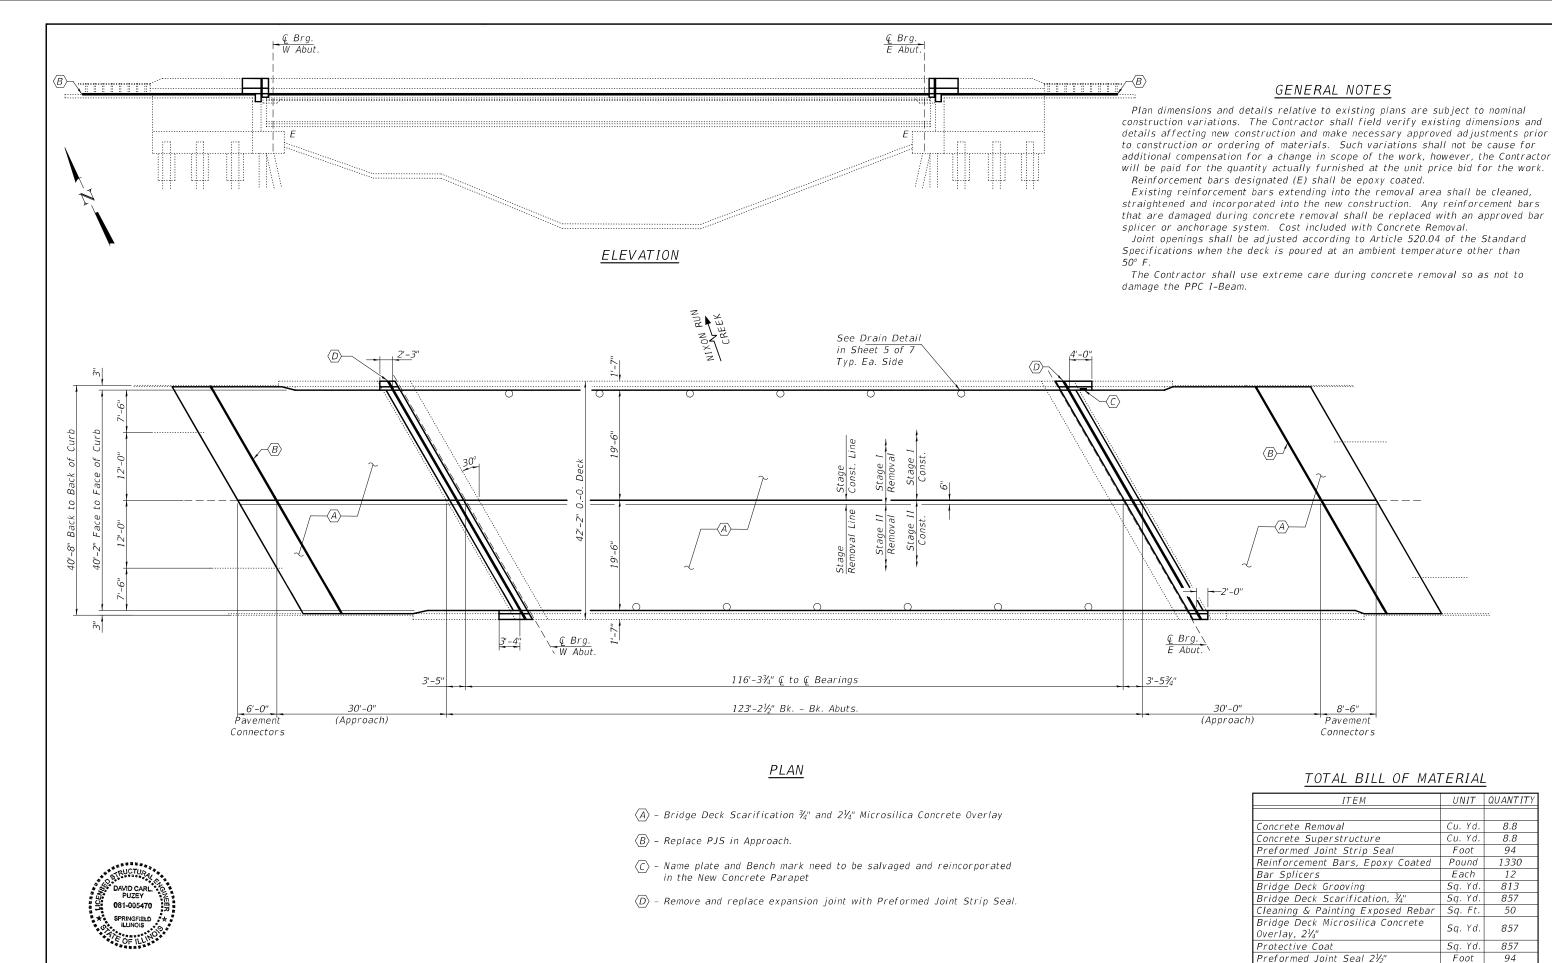


EXPIRES 11-30-2022


DESIGNED -	Victor H. Veliz	EXAMINED	Ting A. Bet	DATE -	OCTOBER 01, 2021
CHECKED -	Chi-Cheung Chau		ENGINEER OF STRUCTURAL SERVICES		
DRAWN -	Venkat Ramana Reddy V	PASSED	D. Cont Vanner.	REVISED	-
CHECKED -	VHV CCC	1	ENCINEED OF PRINCES AND STRUCTURES	REVISED	_

STATE OF ILLINOIS DEPARTMENT OF TRANSPORTATION


GENERAL PLAN AND ELEVATION IL ROUTE 8 OVER NIXON RUN CREEK SN 072 - 0164 SHEET NO. 1 OF 7 SHEETS


F.A.S. RTE	SEC.	TION		COUNTY	TOTAL SHEETS	SHEET NO.
1388	[(Z-1D)BR-2	2]BDR,BJ	R	PEORIA	39	19
				CONTRACT	NO 68F	74
		RUNNIS	EED AL	D PPO IECT		

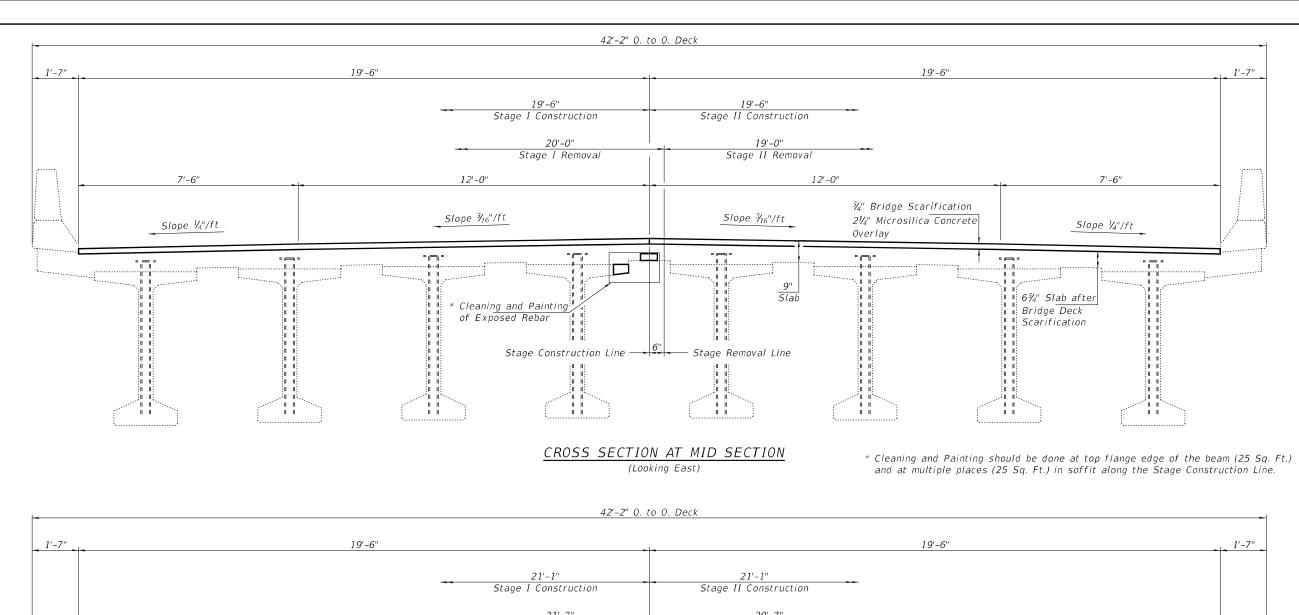


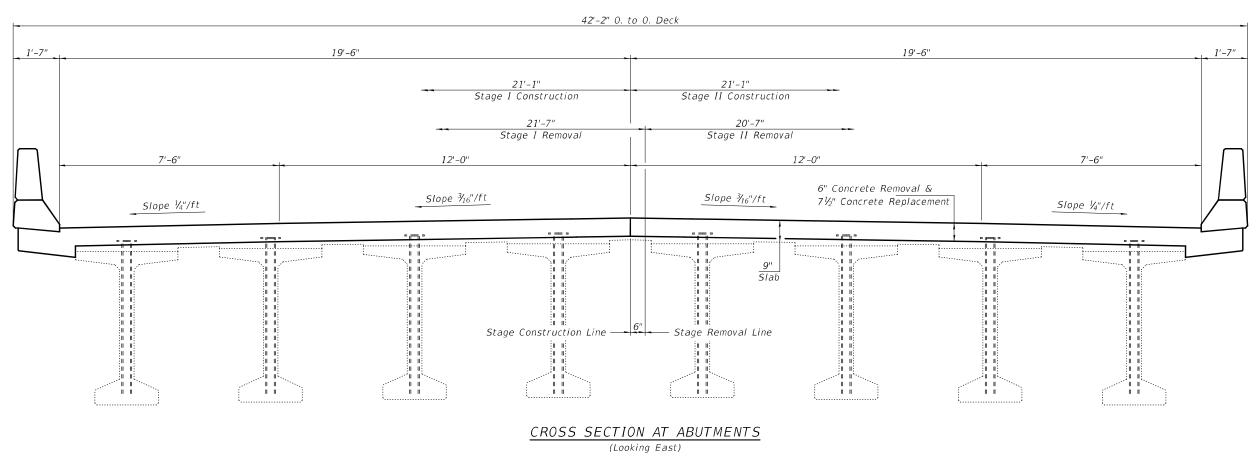



ESIGNED - VHV EXAMINED INNOT A MAILE	DATE - OCTOBER 01, 2021		CROSS SECTIONS & STAGING DETAILS	F.A.S. SECTION	COUNTY TOTAL SHEET NO.
HECKED - CCC ENGINEER OF STRUCTURAL SERVICES	<u> </u>	STATE OF ILLINOIS	SN 072-0164	1388 [(Z-1D)BR-2]BDR,BJR	PEORIA 39 20
RAWN - Venkat Ramana Reddy V PASSED I. Carl Purity	REVISED -	DEPARTMENT OF TRANSPORTATION	SN 072-0164		CONTRACT NO. 68F74
HECKED - VHV CCC ENGINEER OF BRIDGES AND STRUCTURES	REVISED -		SHEET NO. 2 OF 7 SHEETS	ILLINOIS FED. A	

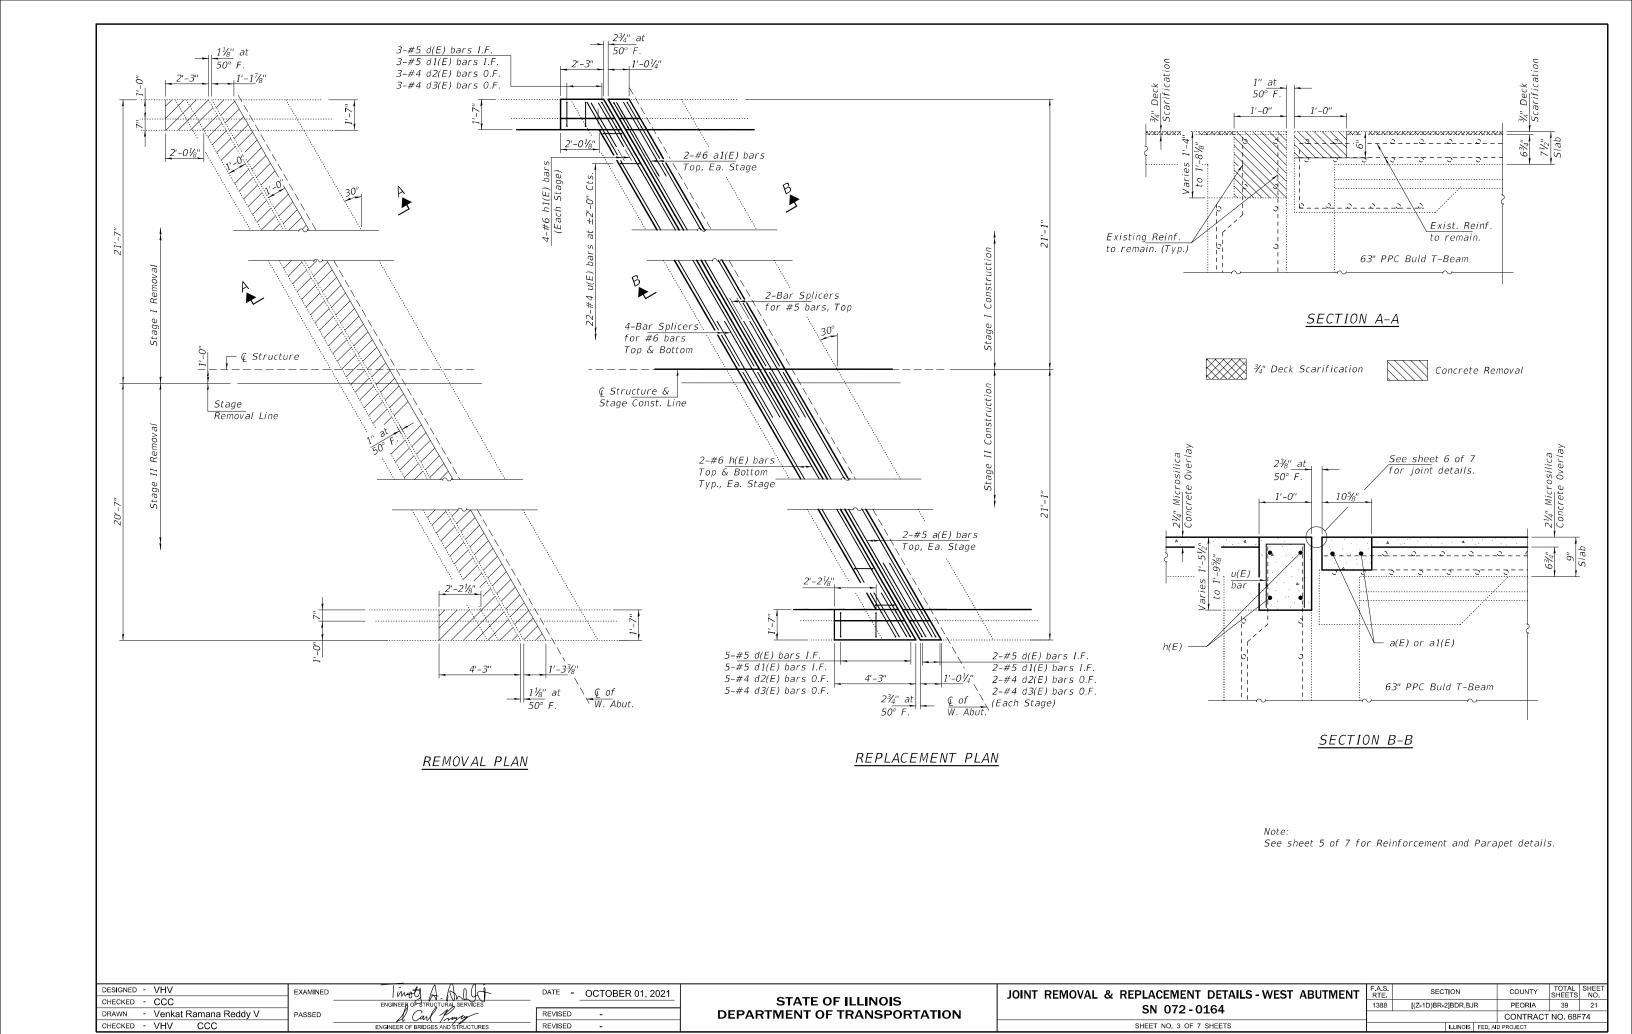

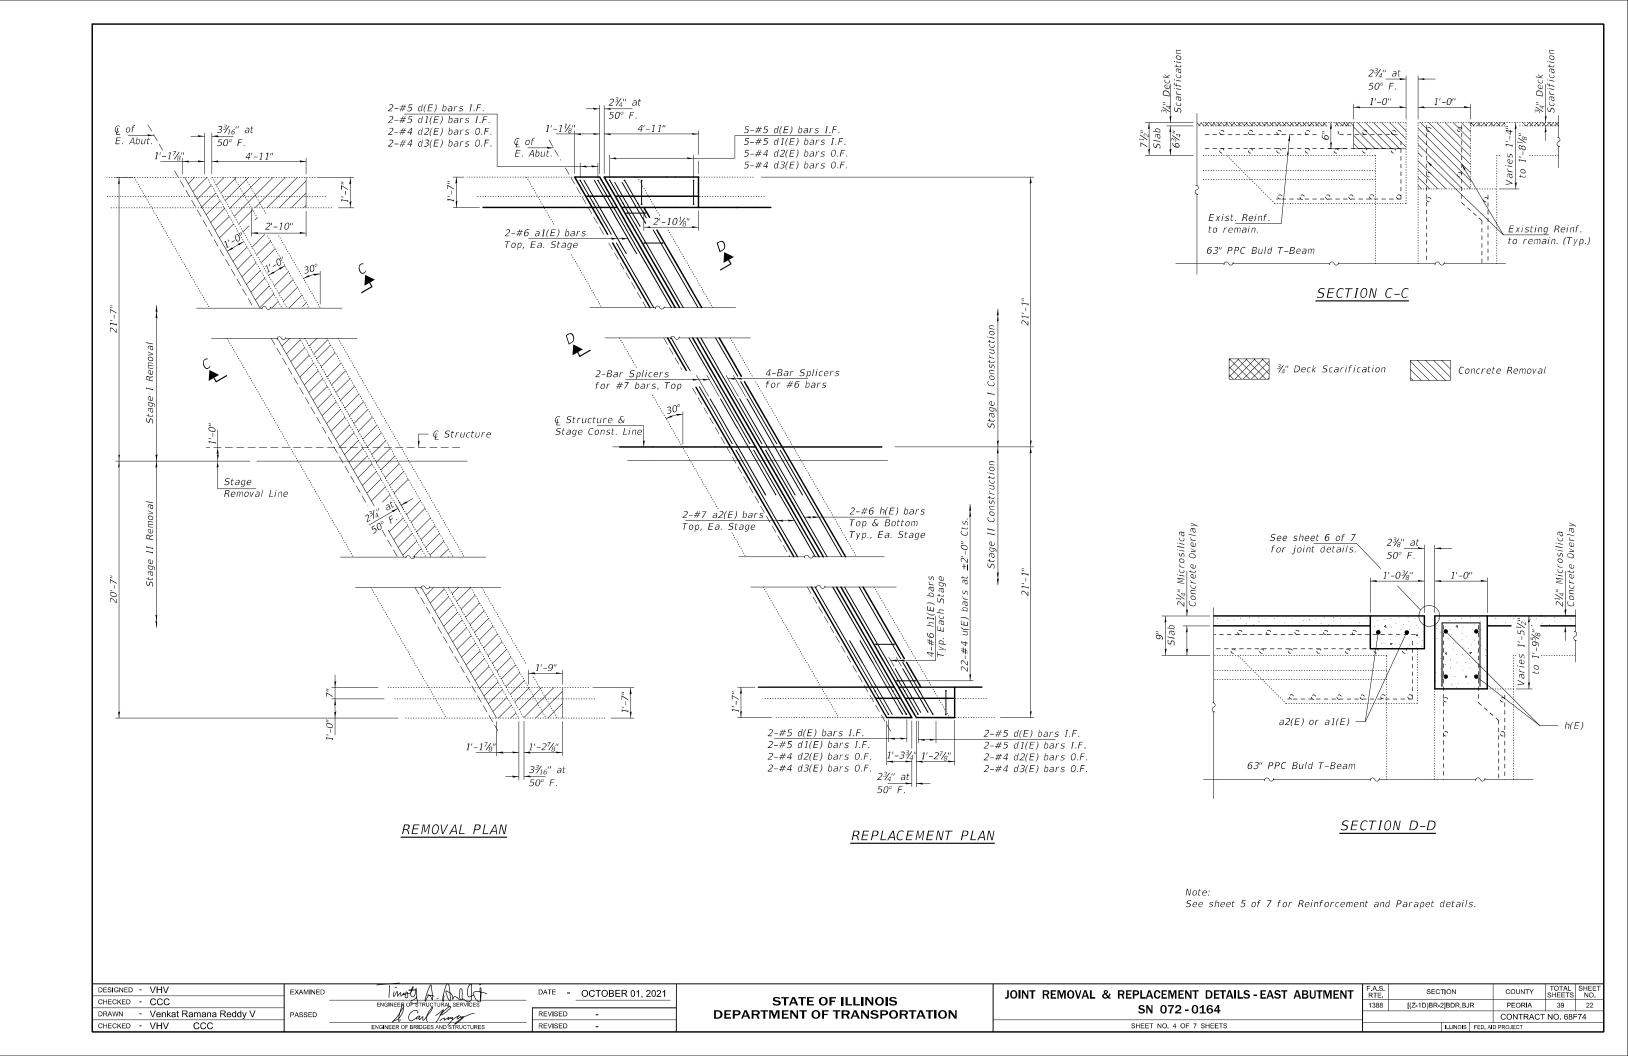

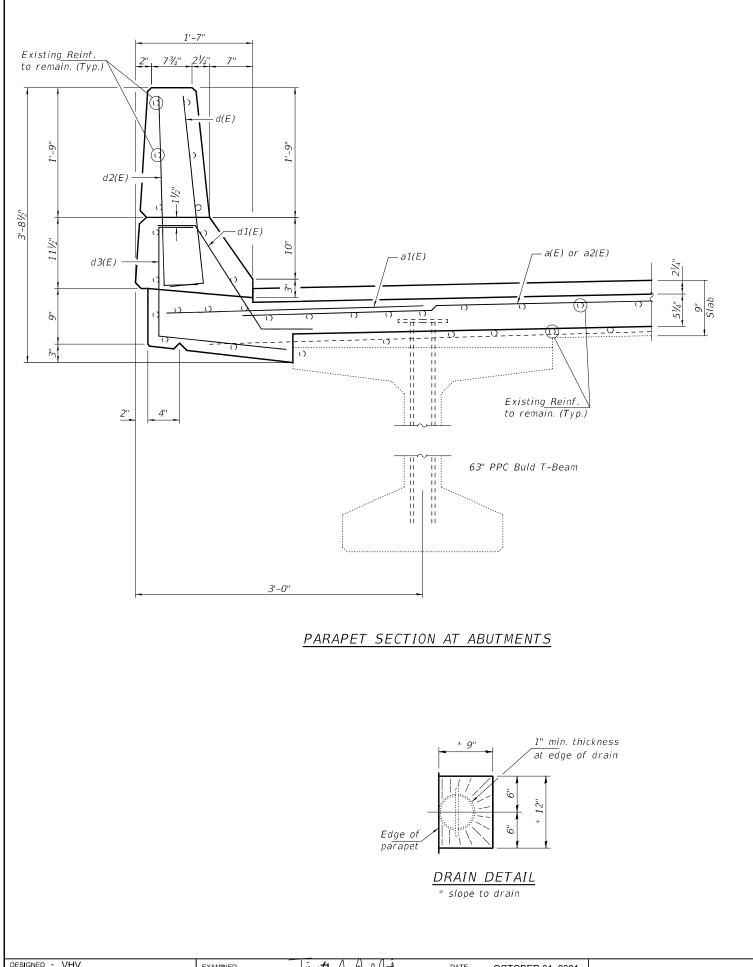


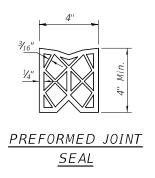

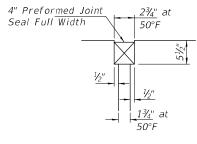


PREFORMED JOINT SEAL DETAIL

REPAIR 'B'

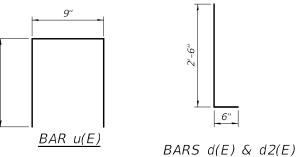

BAR d1(E)

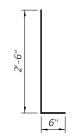

BILL OF MATERIAL (2-ABUTMENTS)

91/2" 6"	11-7" No. 11-7"
BAR d1(E)	BAR d3(E)


Bar	No.	Size	Length	Shape
a(E)	4	#5	23'-11"	
a1(E)	8	#6	4'-0''	
a2(E)	4	#7	23'-11"	
d(E)	23	#5	3'-0''	
d1(E)	23	#5	2'-7"	
d2(E)	23	#4	3'-0''	
d3(E)	23	#4	3'-6"	
h(E)	16	#6	23'-11"	
h1(E)	16	#6	4'-0''	
u(E)	44	#4	2'-11"	
Concrete	Removal		Cu. Yd.	8.8
Concrete	Superstr	ucture	Cu. Yd.	8.8
Protective	Coat		Sq. Yd.	857
Bar Splic	ers		Each	12
Reinforce Epoxy Co		s,	Pound	1330

DESIGNED - VIIV	EXAMINED	I MATI A MILLET	DATE -	OCTOBER 01, 2021
CHECKED - CCC		ENGINEER OF STRUCTURAL SERVICES		
DRAWN - Venkat Ramana Reddy V	PASSED	& Carl Prayer	REVISED	-
CHECKED - VHV CCC		ENGINEER OF BRIDGES AND STRUCTURES	REVISED	-


STATE OF ILLINOIS DEPARTMENT OF TRANSPORTATION

JOINT REMOVAL & REPLACEMENT DETAILS - WEST ABUTMENT	F./					
SN 072-0164						
3N 072-010 4						
SHEET NO. 5 OF 7 SHEETS						


F.A.S. RTE	SECTION	COUNTY	TOTAL SHEETS	SHEET NO.	
1388	[(Z-1D)BR-2]BDR,BJ	R	PEORIA	39	23
			CONTRACT	NO. 68F	74
	ILLINOIS	D PROJECT			

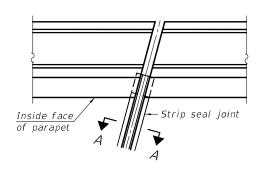

FOR SKEWS ≤ 30° PLAN AT PARAPET

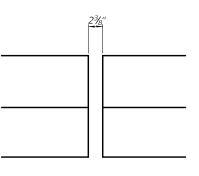

ELEVATION AT PARAPET

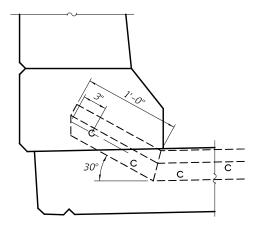

PARAPET ELEVATION AT ABUTMENTS

(Skews ≤ 30°)

Locking edge railat 50° F Top of concrete at 50° F SHOWING ROLLED RAIL JOINT

Locking edge railat 50° F Top of concrete —Strip seal * $\frac{1}{8}$ " Ø x 6" studs @ 6" cts. (alternate angled/bent studs with horizontal studs) at 50° F %" ϕ threaded rods in %6" ϕ holes at ± 4 '-0" cts.

for holding the proper joint opening based on the temperature during the deck pour. Place to miss studs. All rods shall be burned, or sawed off flush with the plates after concrete is set.

SHOWING WELDED RAIL JOINT

SECTION A-A

OCTOBER 01, 2021

* Granular or solid flux filled headed studs conforming to Article 1006.32 of the Std. Specs., automatically end welded.

REVISED

<u>ROLLED</u> WELDED RAIL (EXTRUDED) RAIL

LOCKING EDGE RAILS

** Back gouge not required if complete joint penetration is verified by mock-up.

The strip seal shall be made continuous and shall have a minimum thickness of 1/4". The configuration of the strip seal shall match the configuration of the locking edge rails. Open or "webbed" strip seal gland configurations are not permitted. The gland shall be sized for a maximum

The locking edge rails depicted are configured for typical applications and are conceptual only. The actual configuration

of the locking edge rails and matching strip seal may vary from

manufacturer to manufacturer provided they fit the application and meet the minimum anchorage shown. Flanged edge rails, however, will not be allowed. Locking edge rails may exceed the 4½" maximum depth provided the anchorage system is revised

according to the manufacturer's recommendation.

The manufacturer's recommended installation methods

All steel components shall be galvanized after fabrication according to Article 520.03 of the Standard Specifications. The Maximum space between locking edge rail segments shall be $\frac{3}{6}$ and sealed with a suitable sealant; however, any rail joint within 10' measured perpendicular to the face of the curb or parapet shall be welded as shown in the locking edge

The concrete opening below the strip seal will vary based on the locking edge rail chosen by the Contractor. Deck and parapet lengths shown elsewhere in the plans are dimensioned to the concrete opening, not the joint opening, and are based on the rolled locking edge rail. If the Contractor elects to use a different locking edge rail, dimensional adjustments may be required. One exception to this would be the strip seal joint at the end of the precast bridge approach slab. For these cases the pavement connector length shall be adjusted, not the

rated movement of 4 inches.

shall be followed.

rail splice detail.

length of the bridge approach slab.

LOCKING EDGE RAIL SPLICE

The inside of the locking edge rail groove shall be free of weld residue. Rolled rail shown, welded rail similar.

BILL OF MATERIAL

Item	Unit	Total
Preformed Joint Strip Seal	Foot	94

EJ-SS1 LT30/REPS


2-25-20

DESIGNED - VHV EXAMINED CHECKED - CCC DRAWN - Venkat Ramana Reddy V PASSED CHECKED - VHV CCC

STATE OF ILLINOIS DEPARTMENT OF TRANSPORTATION PREFORMED JOINT STRIP SEAL SN 072-0164

SECTION COUNTY [(Z-1D)BR-2]BDR,BJR PEORIA 39 24 1388 CONTRACT NO. 68F74

SHEET NO. 6 OF 7 SHEETS

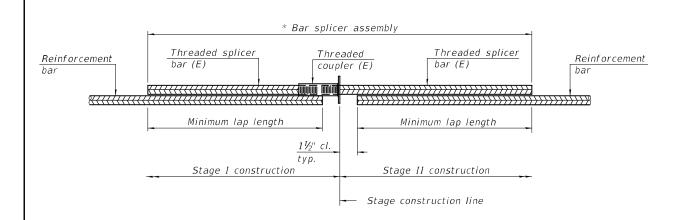


STANDARD BAR SPLICER ASSEMBLY PLAN

(All components shall be provided from one supplier)

Threaded splicer bar length = min. lap length + $1\frac{1}{2}$ " + thread length

* Epoxy not required on Bar Splicer Assembly components used in conjunction with black bars.


Location	Bar size	No. assemblies required	Minimum lap length
Deck (West Side)	#5	2	3'-6"
Deck (East Side)	#7	2	6'-3"
Abutment	#6	8	4'-0"

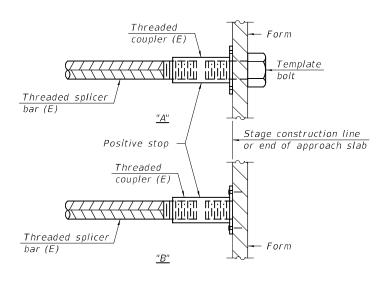

INSTALLATION AND SETTING METHODS

"A": Set bar splicer assembly by means of a template bolt "B": Set bar splicer assembly by nailing to wood forms or cementing to steel forms.

(E) : Indicates epoxy coating.

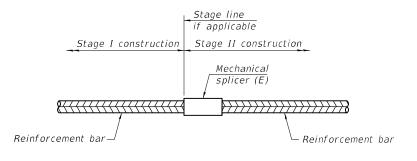

STANDARD MECHANICAL SPLICER

Location	Bar size	No. assemblies required

Notes:

Splicer bars shall be deformed with threaded ends and have a minimum $60\ ksi$ yield strength.

All reinforcement shall be lapped and tied to the splicer bars.

Bar splicer assemblies shall be epoxy coated according to the requirements


for reinforcement bars. See Section 508 of the Standard Specifications.

See approved list of bar splicer assemblies and mechanical splicers for alternatives.

BSD-1

1-1-2020

DESIGNED - VHV	EXAMINED	I mot A All It	DATE -	OCTOBER 01, 2021
CHECKED - CCC		ENGINEER OF STRUCTURAL SERVICES		
DRAWN - Venkat Ramana Reddy V	PASSED	& Carl Prayer	REVISED	-
CHECKED - VHV CCC]	ENGINEER OF BRIDGES AND STRUCTURES	REVISED	-

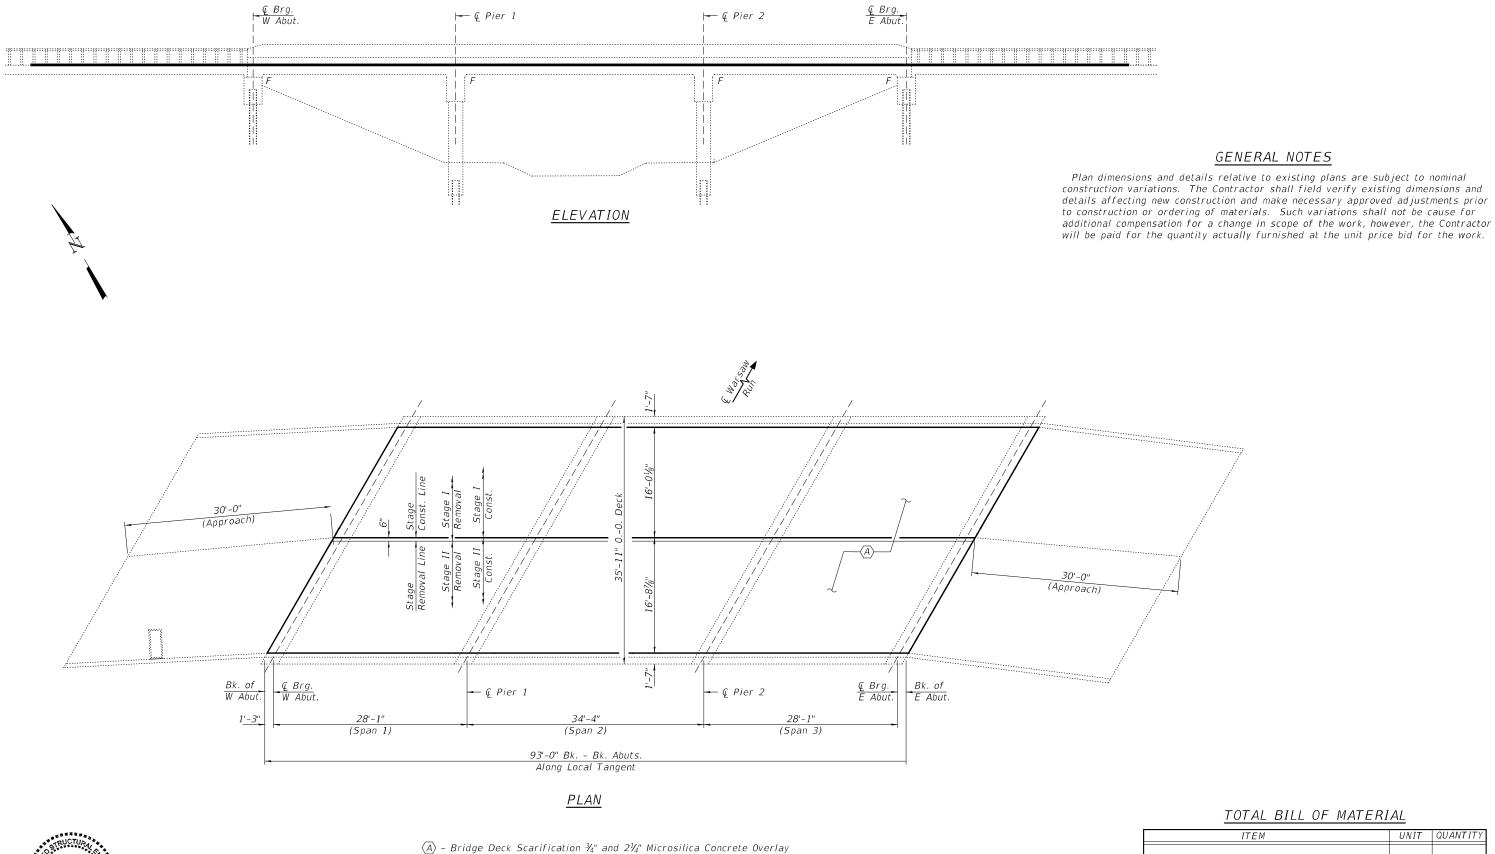


TOTAL BILL OF MATERIAL

ITEM	UNIT	QUANTITY
Bridge Deck Microsilica Concrete Overlay, 21/4"	Sq. Yd.	338.4
Bridge Deck Scarification, ¾"	Sq. Yd.	338.4
Bridge Deck Grooving	Sq. Yd.	317.8
Protective Coat	Sq. Yd.	338.4


EXPIRES 11-30-2022


081-005470

DESIGNED - Victor H. Veliz	EXAMINED	Twy A. Bet	DATE - OCTOBER 1, 2021		GENERAL PLAN AND ELEVATION	F.A.S.	SECTION	COUNTY	TOTAL SHEET
CHECKED - Chi-Cheung Chau		ENGINEER OF STRUCTURAL SERVICES		STATE OF ILLINOIS	ILL 8 OVER WARSAW RUN	1388	[(Z-1D)BR-2]BDR.BJR	PEORIA	39 26
DRAWN - Venkat Ramana Reddy V	PASSED	In Carl Projecy	REVISED -	DEPARTMENT OF TRANSPORTATION	SN 072-0165			CONTRACT	NO. 68F74
CHECKED - VHV CCC		ENGINEER OF BRIDGES AND STRUCTURES	REVISED -		SHEET NO. 1 OF 2 SHEETS		ILLINOIS FED A	AID PROJECT	

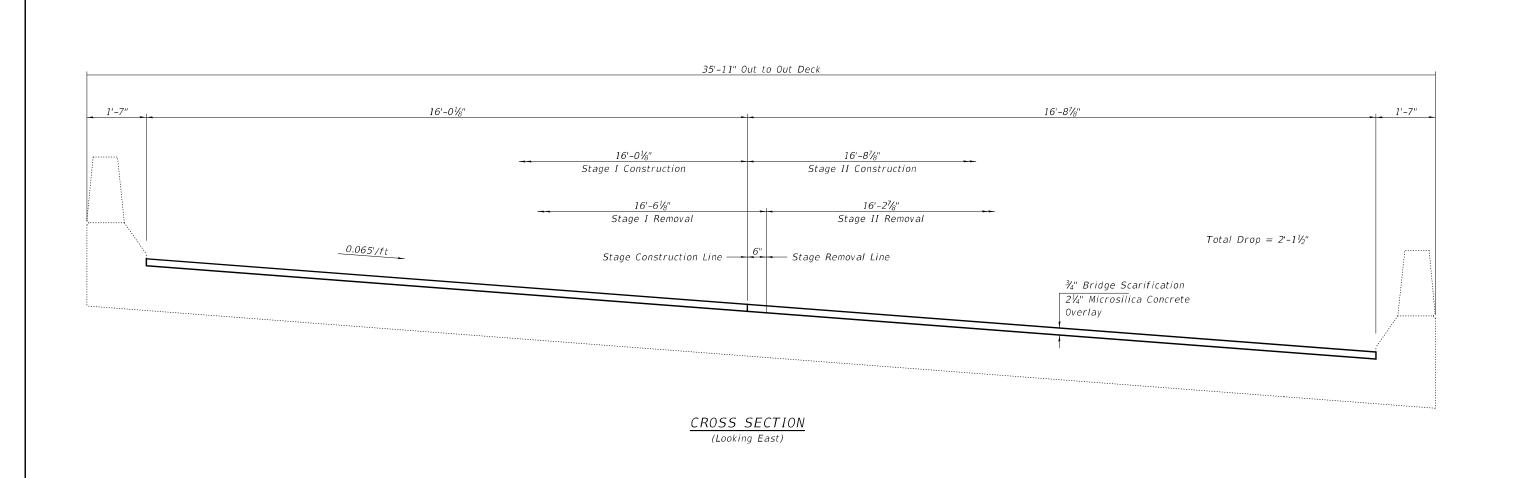


DESIGNED - VHV	EXAMINED	Timoty A. And at	DATE - OCTOBER 1, 2021	CTATE OF ILLINOIS	CROSS SECTIONS & STAGING DETAILS	F.A.S. RTE	SECTION	COUNTY	TOTAL SHEETS	SHEET NO.
CHECKED - CCC DRAWN - Venkat Ramana Reddy V	PASSED	ENGINEER OF STRUCTURAL SERVICES	REVISED -	STATE OF ILLINOIS DEPARTMENT OF TRANSPORTATION	SN 072-0165	1388	[(Z-1D)BR-2]BDR,BJR	PEORIA CONTRACT	39 T NO 681	-74
CHECKED - VHV CCC	_	ENGINEER OF BRIDGES AND STRUCTURES	REVISED -		SHEET NO. 2 OF 2 SHEETS		ILLINOIS FED. AI	D PROJECT	1 110. 00	

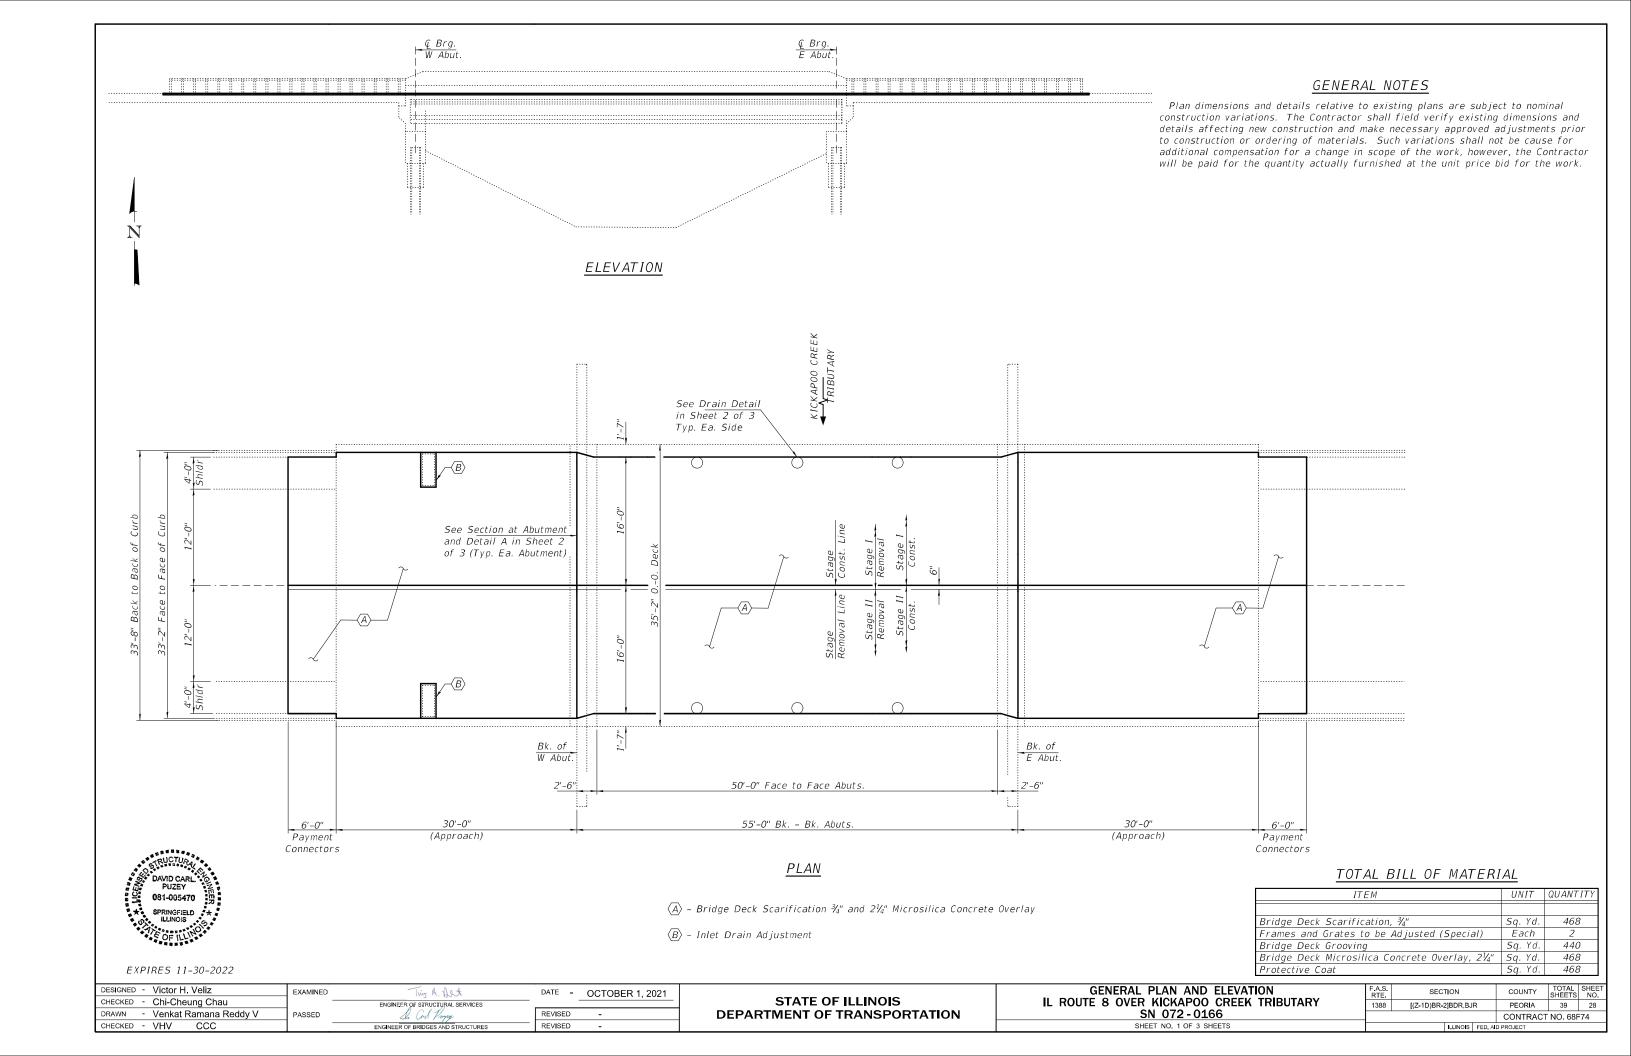

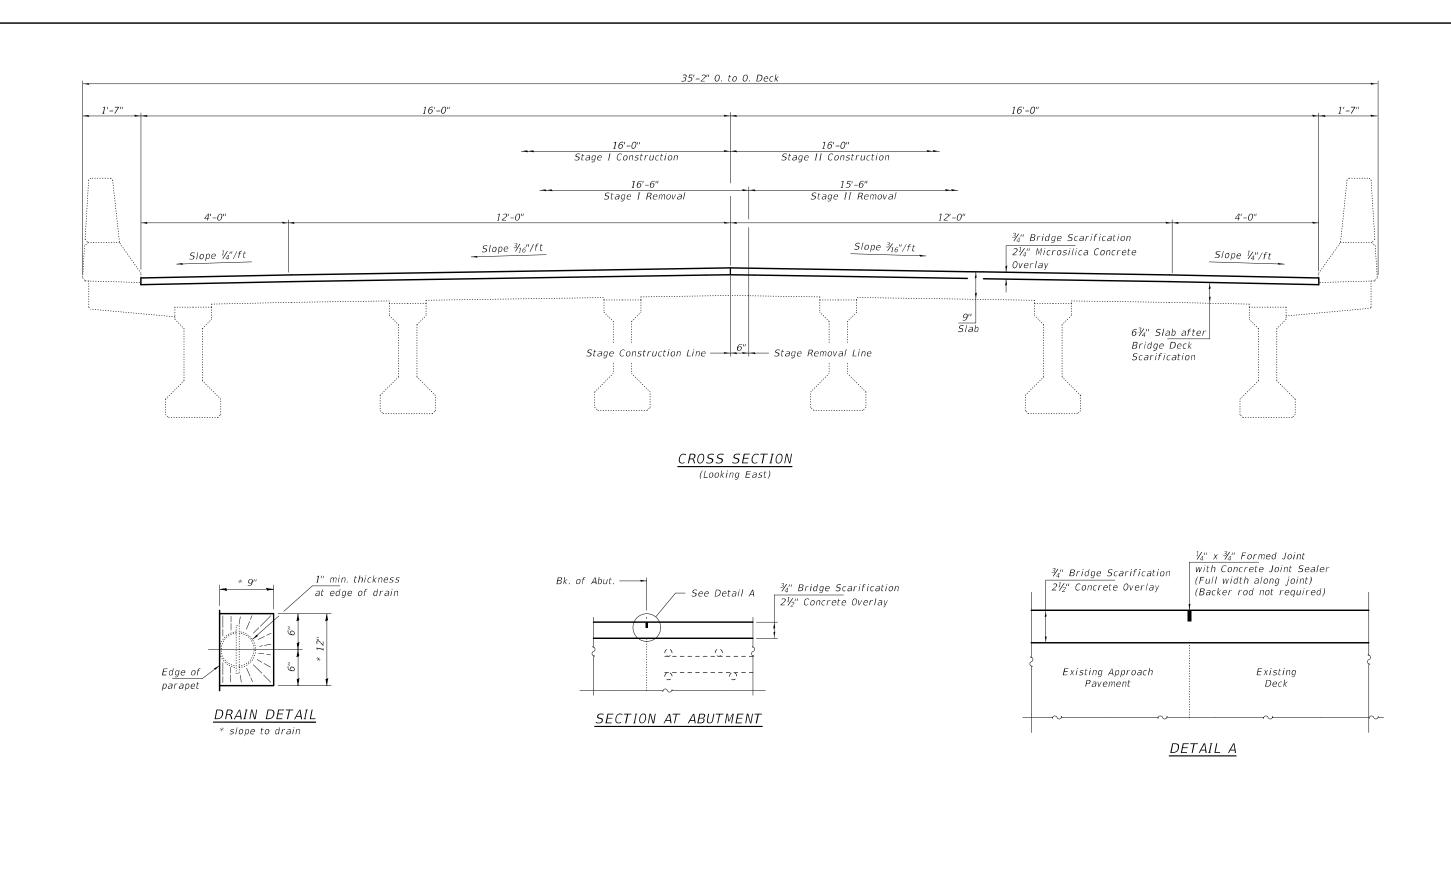

	DESIGNED - VHV	EXAMINED	Imote A Mal Co	DATE - OCTOBER 1, 2021		CROSS SECTIONS & STAGING DETAILS	F.A.S.	SECTION	COUNTY	TOTAL SHEET SHEETS NO.
	CHECKED - CCC		ENGINEER OF STRUCTURAL SERVICES		STATE OF ILLINOIS	SN 072-0166	1388	[(Z-1D)BR-2]BDR,BJR	PEORIA	39 29
L	DRAWN - Venkat Ramana Reddy V	PASSED	d. Carl Prayer	REVISED -	DEPARTMENT OF TRANSPORTATION	3N 072-0100			CONTRAC	T NO. 68F74
L	CHECKED - VHV CCC		ENGINEER OF BRIDGES AND STRUCTURES	REVISED -		SHEET NO. 2 OF 3 SHEETS		ILLINOIS FED. A	ID PROJECT	

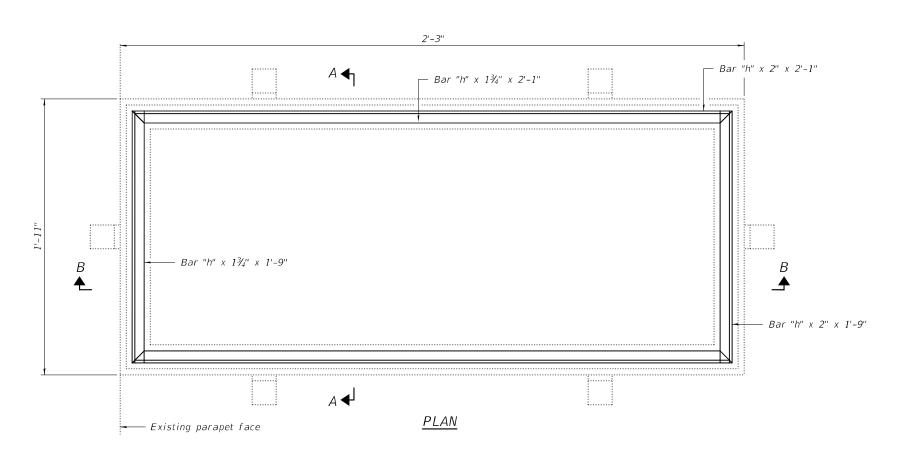

Notes:


The contractor shall ensure that no damage is done to existing grates to be reused. Shop plans for proposed adjusting scupper ring shall be submitted for approval prior to fabrication.

Cost of all labor and materials necessary to remove existing grates, clean existing


Cost of all labor and materials necessary to remove existing grates, clean existing scuppers, install adjusting scupper rings and reinstalling grates is included in the cost per unit each for Frames and Grates to be Adjusted (Special).

All structural steel shall conform to AASHTO Classification M-270 Gr. 36. The adjusting scupper ring shall be galvanized.

Bolts shall be ½"Ø, AASHTO M164 Type I, mechanically galvanized. Contractor shall be responsible for field verification of dimensions.

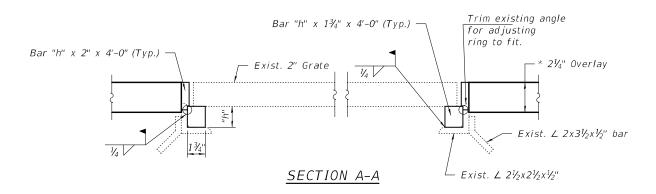


"h" : Height is the determined by the engineer in the field to allow for the variable thickness of Microsilica Concrete Overlay.

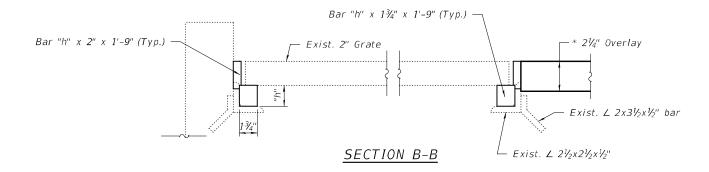



BILL OF MATERIAL

Item	Unit	Total
FRAMES AND GRATES TO BE ADJUSTED (SPECIAL)	Each	2

DESIGNED - VHV	EXAMINED	I mot A A I at	DATE - OCTOBER 1, 2021		INLET DRAIN ADJUSTMENT	F.A.S. SECTION	COUNTY SHEET NO
CHECKED - CCC		ENGINEER OF STRUCTURAL SERVICES		STATE OF ILLINOIS		1388 [(Z-1D)BR-2]BDR.BJR	PEORIA 39 30
DRAWN - Venkat Ramana Reddy V	PASSED	A. Carl Proper	REVISED -	DEPARTMENT OF TRANSPORTATION	SN 072-0166		CONTRACT NO. 68F74
CHECKED - VHV CCC	1 —	ENGINEER OF BRIDGES AND STRUCTURES	REVISED -		SHEET NO. 3 OF 3 SHEETS	ILLINOIS FED. A	

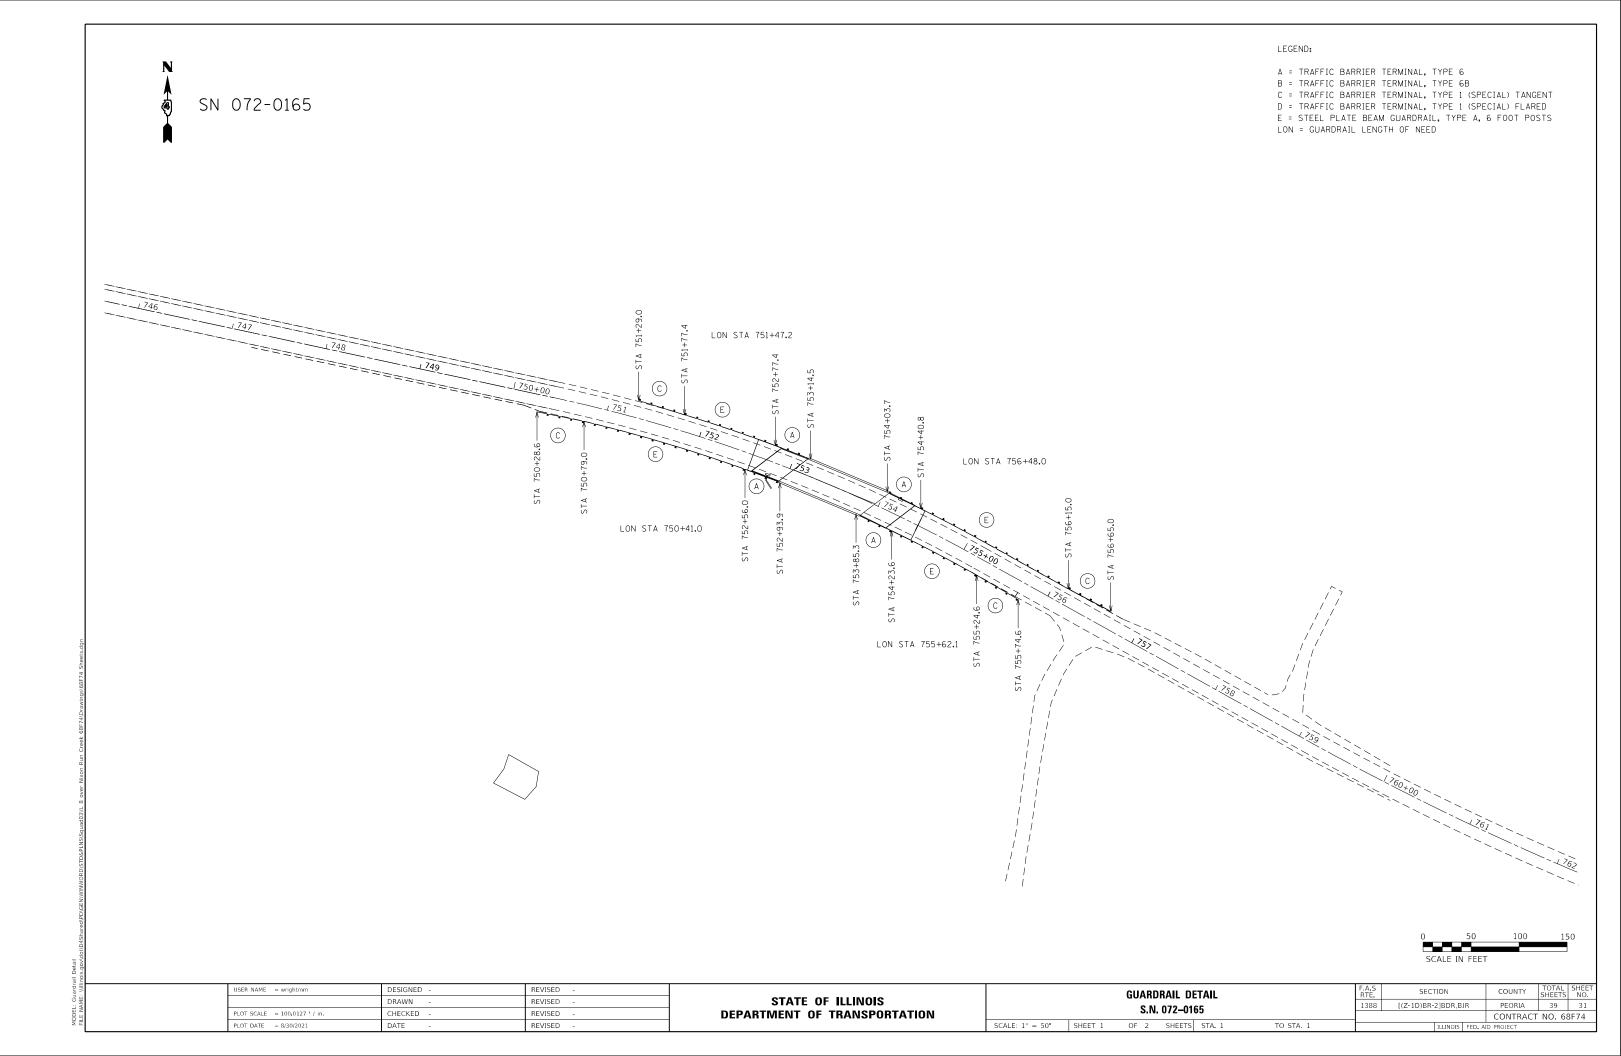

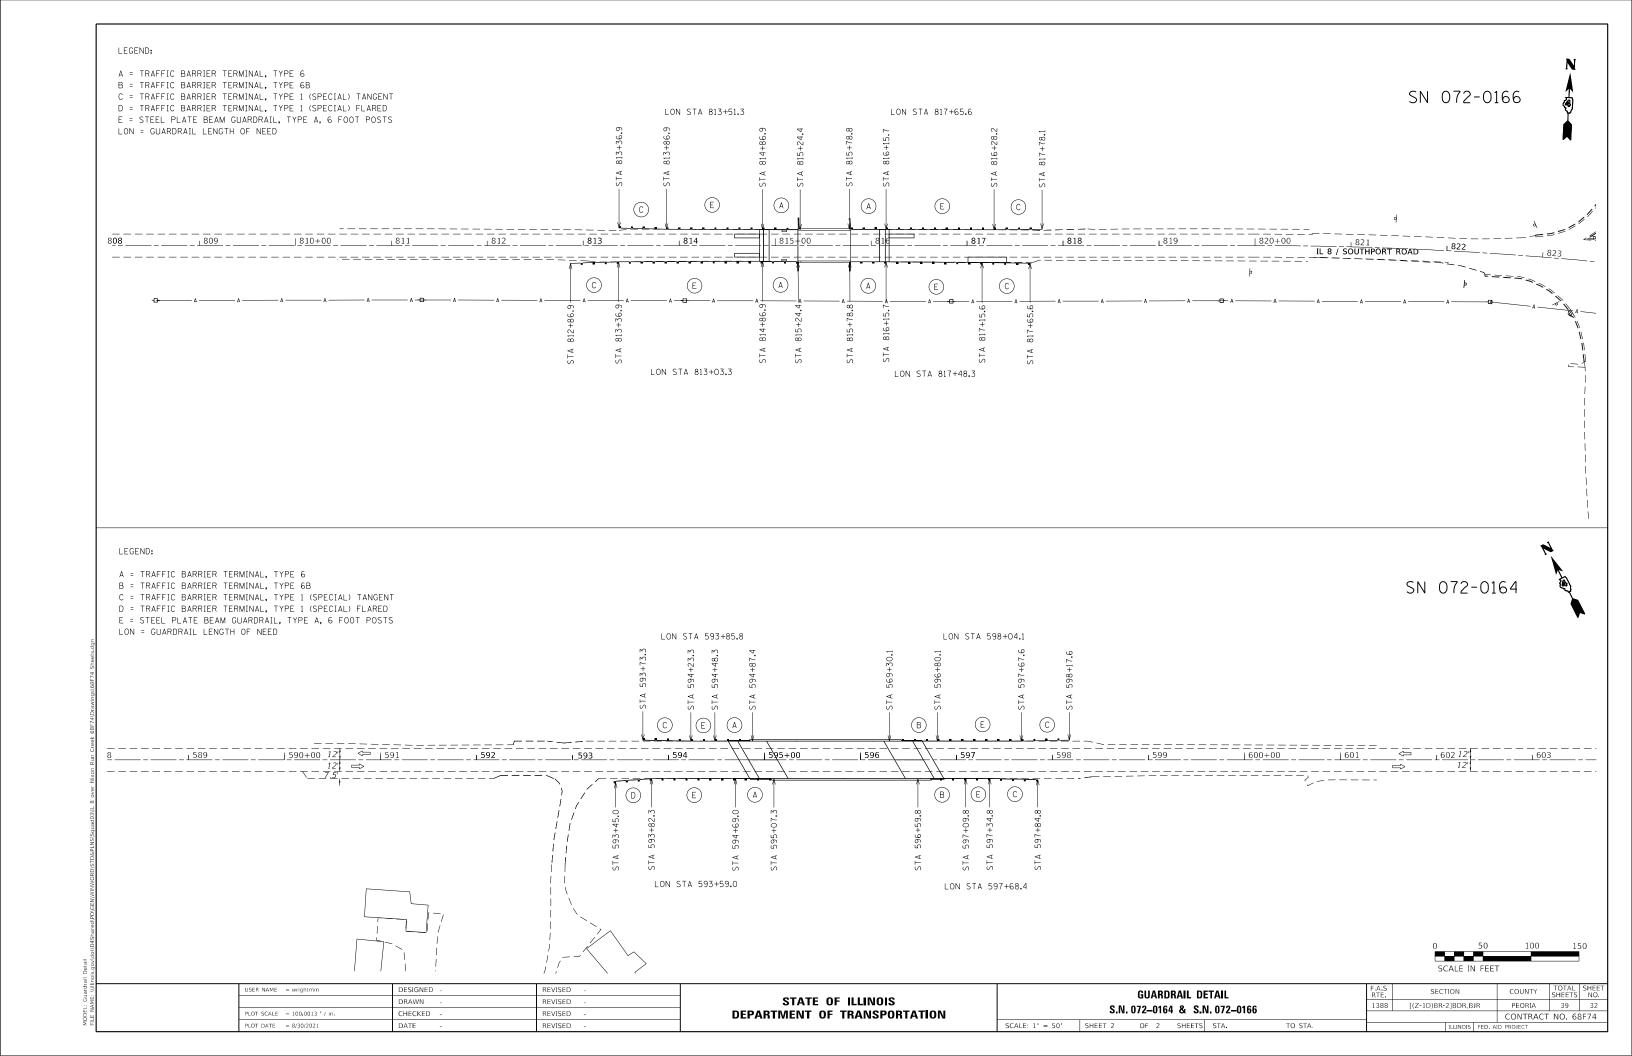

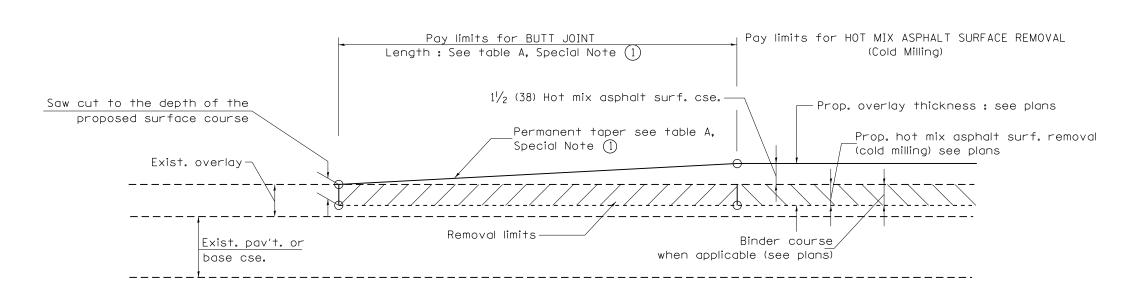


CASE 1: WITH HOT MIX ASPHALT SURFACE REMOVAL (COLD MILLING)

TABLE A TAPER RATES

		I	
SPECIAL NOTE	ELEMENT	MAINLINE INTERSTATES &	ALL
NUMBER		4-LANE EXPRESSWAYS	OTHERS
(1)	BUTT JOINT	1:480	1:240
	TAPER RATE		
(2)	TEMPORARY RAMP	1:80	1:40
	TAPER RATE		


GENERAL NOTES

- 1. The work shall be done in accordance with Article 406.08 and the Special Provision for Butt Joints.
- 2. The pavement surface to be removed may be either bituminous or P.C. concrete. The work shall be performed in accordance with Article 440.04 and the Special Provisions for Butt Joints.
- 3. The saw cut joints shall be primed just prior to the placing of bituminous material. The work will be in accordance with the applicable portions of Article 406.05.
- 4. The length of butt joint is based on the taper rate times change in cold milling depth within the butt joint pay limits, unless otherwise indicated.
- 5. Temporary ramps are paid for separately and not included in the cost of the butt joints.

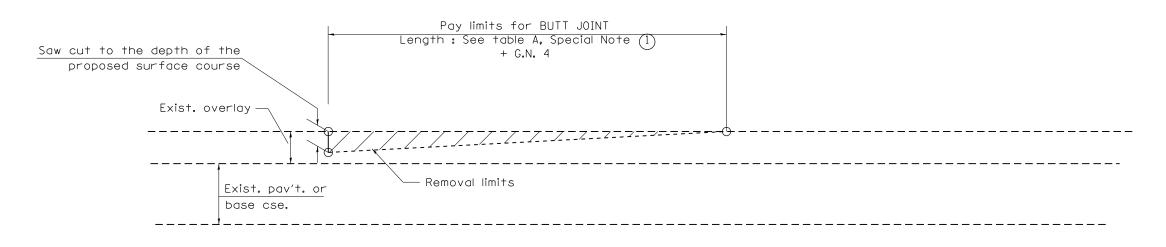


CASE 2: NO HOT MIX ASPHALT SURFACE REMOVAL (COLD MILLING)


01-01-97	RENUM. C-23.01, NEW REVISION BOX	T.P.		MAJOR MODIFICATIONS	R.D.				RTF.	SECTION	COUNTY	SHEETS	NO.
04-01-9	CORRECTION TO DEPTH	J.A.	04-12-16 N	MINOR CORRECTIONS	R.D.	STATE OF ILLINOIS	BUTT JOINTS		1388	[(Z-1D)BR-2]BDR,BJR	PEORIA	39	33
09-15-09	REVISED DESIGNER NOTE	M.M.A.	02-14-17	ADDED NOTE 5	R.D.	DEPARTMENT OF TRANSPORTATION		SHT. 1 OF 3		·	CONTRAC	T NO. 68F	F74
10-16-06	REVISED TO 2007 SPEC.	M.A.	07-16-19 V	Wording and Spelling corrections	R.D.		NOT TO SCALE	CADD STD. 406101-D4	FED. ROAD	D DIST. NO. ILLINOIS FED.			

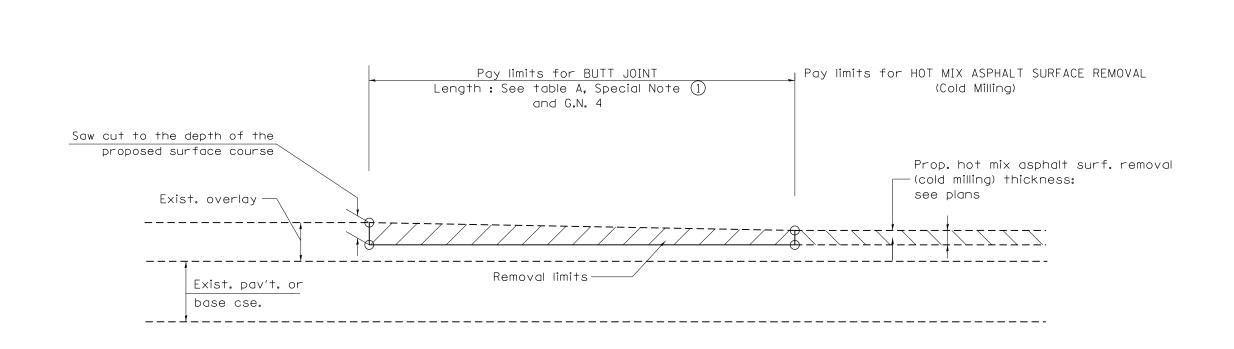

CASE 3: HOT MIX ASPHALT SURFACE REMOVAL (COLD MILLING) TIE-IN TO EXISTING BITUMINOUS TAPER

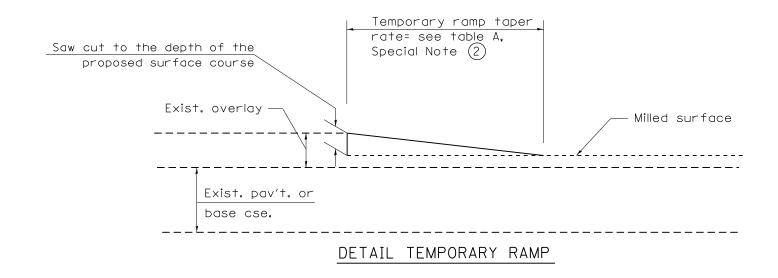


			07475 05 111111010			F.A.S. RTE.	SECTION	COUNTY	TOTAL S SHEETS	NO.
L			STATE OF ILLINOIS	BUTT JOINTS		1388	[(Z-1D)BR-2]BDR,BJR	PEORIA	39	34
L			DEPARTMENT OF TRANSPORTATION		SHT. 2 OF 3			CONTRAC	T NO. 68	F74
				NOT TO SCALE	CADD STD. 406101-D4	FED. RO	AD DIST. NO. ILLINOIS FED. A	ID PROJECT		

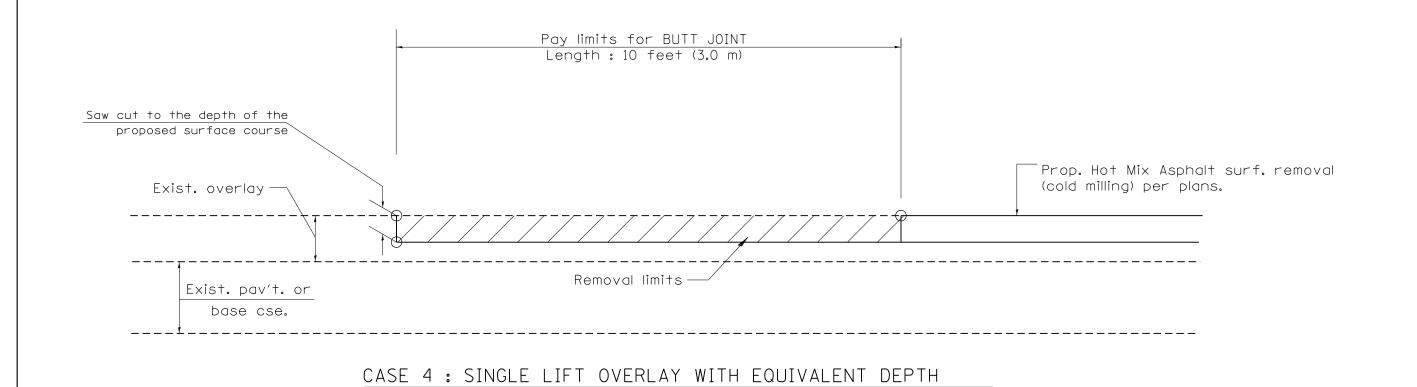

HOT MIX ASPHALT SURFACE REMOVAL (COLD MILLING)

TIE-IN TO EXISTING BITUMINOUS TAPER

			07.77			F.A.S RTE.	SECTION	COUNTY	TOTAL SHEETS	SHEET NO.
ŀ			STATE OF ILLINOIS	BUTT JOINTS		1388	[(Z-1D)BR-2]BDR,BJR	PEORIA	39	35
L			DEPARTMENT OF TRANSPORTATION		SHT. 3 OF 3			CONTRACT	T NO. 6	8F74
				NOT TO SCALE	CADD STD. 406101-D4	FED. RO	AD DIST. NO. ILLINOIS FED. A	ID PROJECT		

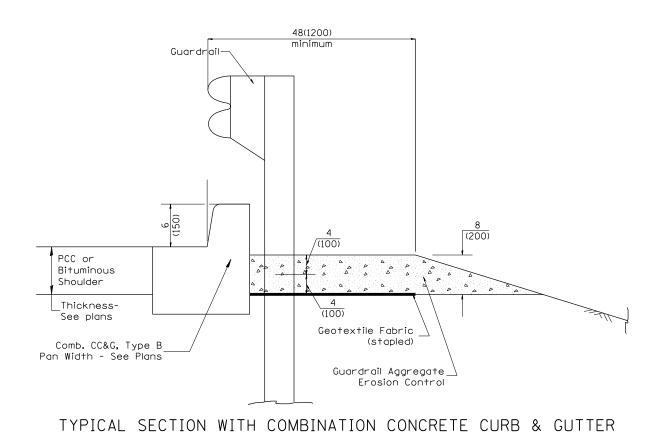


GENERAL NOTES: GUARDRAIL AGGREGATE EROSION CONTROL

- 1. This work shall consist of grading as needed, furnishing and installing geotextile fabric and staples, and furnishing, placing and shaping crushed aggregate around and behind Steel Plate Beam Guardrail posts in accordance with Plan Details.
- 2. Before placing the aggregate and the Geotextile Fabric, weeds and grass shall be removed from the area to be covered.
- 3. After the area has been prepared, and in a dry condition, the Geotextile fabric shall be placed with a 12(300) minimum overlap. A knife cut for guardrail post installation is necessary.
- 4. The aggregate shall be deposited, compacted and shaped by either mechanical or hand methods, in a manner reasonably true to line and grade.
- 5. The Contractor shall have the option of placing the guardrail before or after the Geotextile Fabric and Aggregate are in place. If the guardrail is placed after the Geotextile Fabric and Aggregate, then any voids must be filled and the aggregate returned to line and grade.


All dimensions are in inches (millimeters)


unless otherwise noted.


- 6. Materials shall meet the following requirements:
- A. The crushed aggregate shall be CA1 gradation in accordance with Article 1004.01(c) of the Standard Specifications.
- B. The Geotextile Fabric shall be nonwoven fabric in accordance with Article 1080.02 of the Standard Specifications.

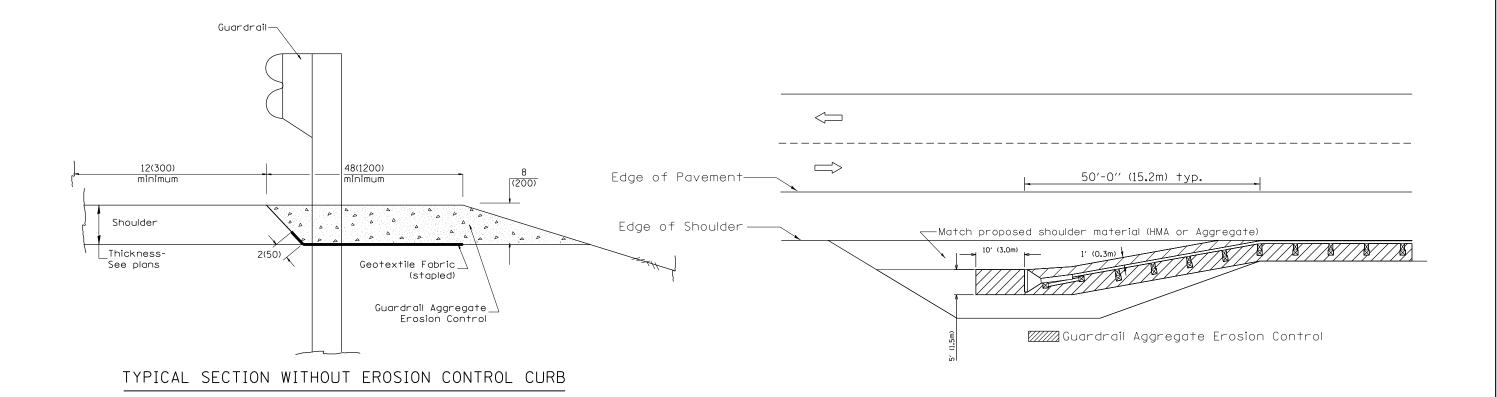

03-07-11 ADDED DETAIL SHOWING PLAN VIEW 5-30-18 CHANGE B CURB TO CC&G R.D. SECTION COUNTY STATE OF ILLINOIS **GUARDRAIL EROSION CONTROL TREATMENTS** 08-10-12 REVISED CURB "B" AND AGGREGATE R.D. 07-16-19 SPELLING CORRECTIONS R.D. PEORIA 39 36 1388 [(Z-1D)BR-2]BDR.BJR 07-15-15 ADDRESSED SHOULDER INLET CURB R.D. **DEPARTMENT OF TRANSPORTATION** SHT. 1 OF 2
CADD STD. 630101-D4
FED. ROAD DIST. NO. | ILLINOIS FED. AID PROJECT CONTRACT NO. 68F74 01-26-17 REVISED R.D. NOT TO SCALE

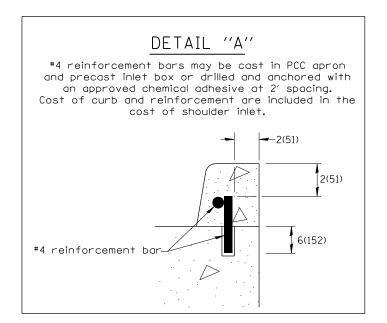


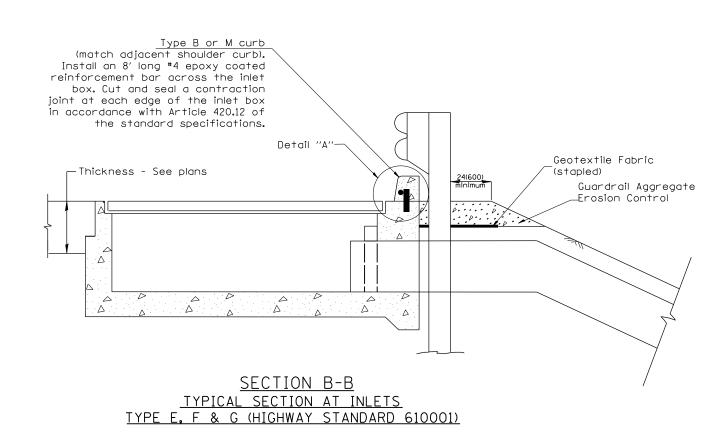

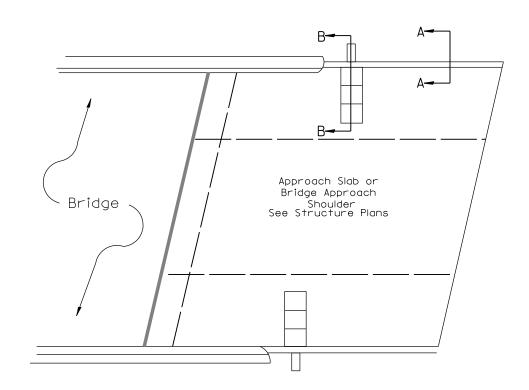

PLAN VIEW


APPROACH SLAB OR SHOULDER PLACEMENT

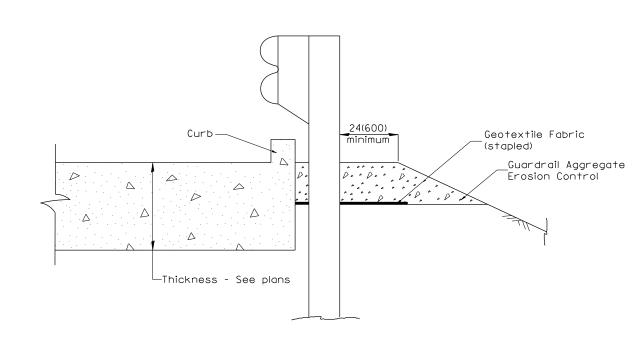

SECTION A-A

TYPICAL SECTION WITH BRIDGE APPROACH CURB

			RTE. SECTION	COUNTY SHEETS NO.
	STATE OF ILLINOIS	GUARDRAIL EROSION CONTROL TREATMENTS	1388 [(Z-1D)BR-2]BDR,E	JR PEORIA 39 37
	DEPARTMENT OF TRANSPORTATION	SHT. 2 OF 2		CONTRACT NO. 68F74
		NOT TO SCALE CADD STD. 630101-D4	FED. ROAD DIST. NO. ILLINOI	S FED. AID PROJECT

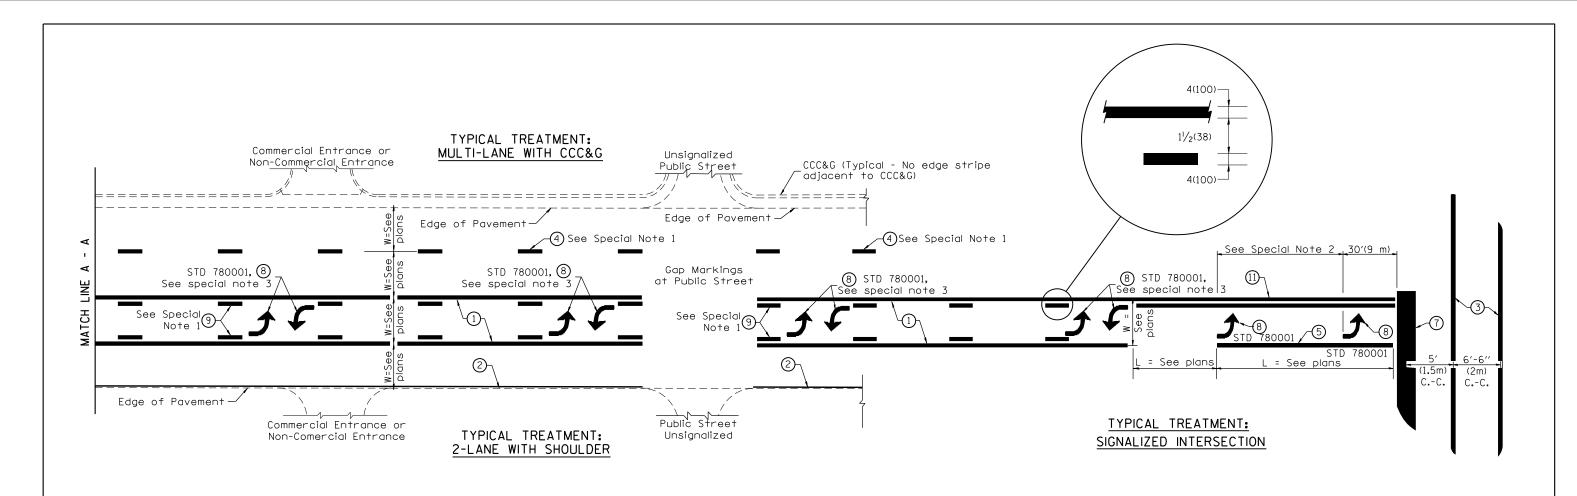

FLUSH PAVED MEDIAN: TWO-WAY LEFT TURN LANE WITH ONE-WAY LEFT TURN LANE AT SIGNALIZED INTERSECTION

TYPICAL PAVEMENT MARKING LEGEND

(Note: This is a District Standard Legend. Some elements may not apply to specific project.)

- 1) 4(100) Solid (Yellow)
- (2) 4(100) Solid (White)
- 3 2-6(150) Crosswalk @ 6'-6" (2m)min C.-C. (White)
 2-8(200) Crosswalk @ 6'-6" (2m)min C.-C. (White) (When traffic signals are present.)
- 4 6(150) Skip-Dash (White) 10' 30' 10' (See Special Note 1)
- 5) 8(200) Solid (White)
- 6) 12(300) Diagonal (White) (Item 6) is shown on Std. 780001)
- (7) 24(600) Stop Bar (White)
- (See Std. 780001 and Special Notes 2 & 3)
- 9 4(100) Skip-Dash (Yellow) 10' 30' 10' (See Special Note 1)
- (1) 12(300) Diagonal (Yellow) (See Table A) 45° (10) 4(100) Double Solid (Yellow) 11(280) C.-C. See Table A

SPECIAL NOTES

- Skip-Dash markings will be centered between both ends of city blocks and shall be placed in alignment transversely across the pavement.
- The following shall apply to arrows located in one-way left turn lanes:
 - A. A minimum of two (2) arrows is required.
 - B. The maximum spacing between arrows is 80′ (24 m).
 - C. Arrows shall be evenly spaced if three (3) or more are required.
- The following shall apply to arrow pairs located in two-way left turn lanes:
 - A. A minimum of two (2) arrow pairs is required. B. The maximum spacing between arrow pairs
- C. Arrow pairs shall be evenly spaced if three (3) or more are required.

NOT TO SCALE

D. The spacing between Bi Directional Left Turn Arrows is 33' (10 m).


GENERAL NOTES

- 1. Refer to State Standard 780001 for additional Pavement Markings including letters & arrows.
- See Plans for Pavement Markings adjacent to curbed islands and medians, and through lane reductions.
- 3. Refer to Article 780.13 for letter, number and symbol areas (sq. ft.)
- 4. Areas are grooved 1" beyond each edge for the following symbols: Through Arrow= 14.8 sq. ft.
 Large Left or Right Arrow= 21.9 sq. ft.
 2 Arrow Combination Left (or Right) and Through= 34.9 sq. ft.
 Wrong Way Arrow= 29.5 sq. ft.
 Railroad Crossing Symbol= 69.8 sq. ft.
 (For further information, refer to BDE Special Provision: Grooving for Recessed Pavement Markings)

STATE OF ILLINOIS
DEPARTMENT OF TRANSPORTATION


is 200' (61 m).


TYPICAL PAVEMENT MARKINGS

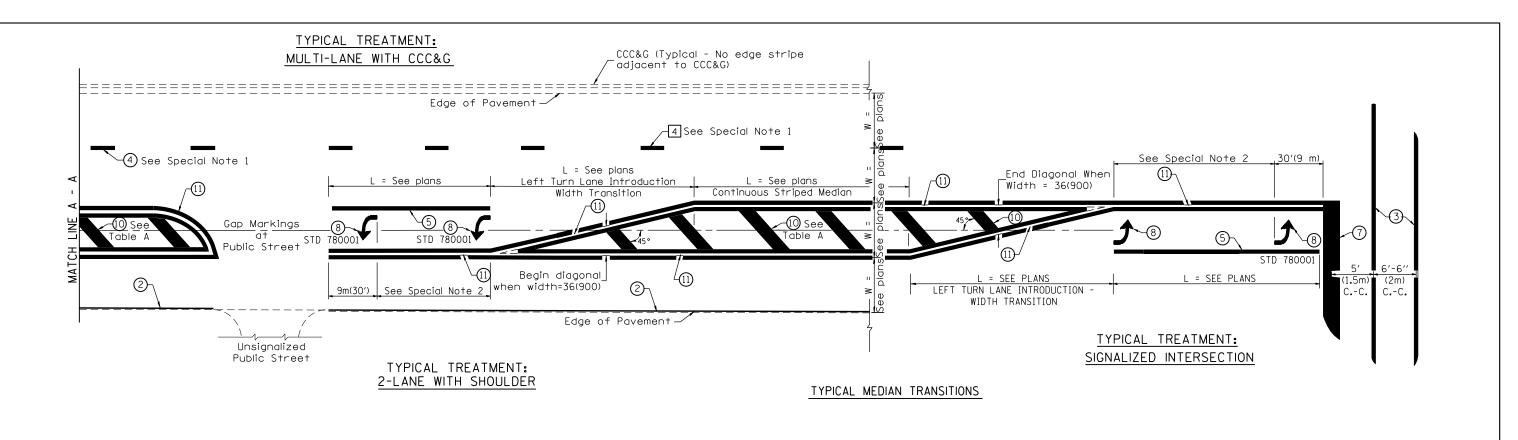

FLUSH PAVED MEDIAN: RESTRICTED LEFT TURN LANE

TABLE A RECOMMENDED SPACING BETWEEN DIAGONAL LINES

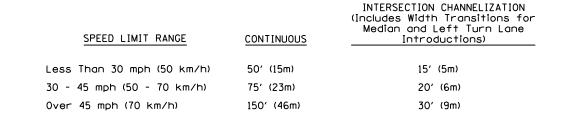

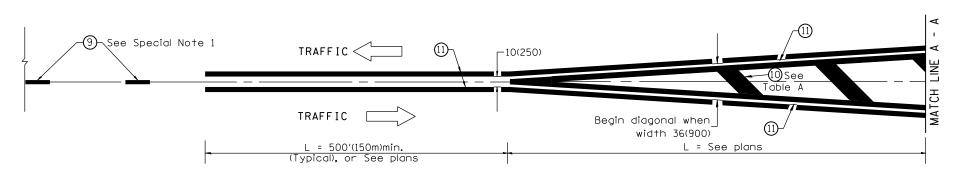

MEDIAN INTRODUCTION - WIDTH TRANSITIONS

	OTATE OF HAMINO	TYPICAL PAYEMENT MARKINGS		F.A.S. RTE.	SECTION	COUNTY	TOTAL SHEET SHEETS NO.
	STATE OF ILLINOIS DEPARTMENT OF TRANSPORTATION	TYPICAL PAVEMENT MARKINGS	SHT. 2 OF 2	1388	[(Z-1D)BR-2]BDR,BJR	PEORIA	39 39 T NO. 68F74
		NOT TO SCALE	CADD STD. 780001-D4	FED. ROAD D	DIST. NO. ILLINOIS FED. A	ID PROJECT	