11-05-2021 LETTING ITEM 076

FOR INDEX OF SHEETS AND LIST OF HIGHWAY STANDARDS, SEE SHEET NO. 2

IMPROVEMENTS LOCATED IN THE CITY OF DEKALB (NIU CAMPUS)

STATE OF ILLINOIS

DEPARTMENT OF TRANSPORTATION

PROPOSED HIGHWAY PLANS

NIU CAMPUS IMPROVEMENTS OFF OF LUCINDA AVENUE AND NORMAL ROAD

F.A.U. 5336 - LUCINDA AVENUE

CITY OF DEKALB


SECTION: 08-00003-00-PV


PROJECT: ZXAQ(441)

JOB NUMBER: C-93-021-21

DEKALB COUNTY



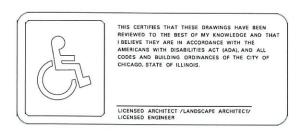


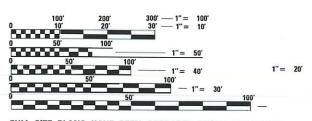

FULL SIZE PLANS HAVE BEEN PREPARED USING STANDARD ENGINEERING SCALES. REDUCED SIZED PLANS WILL NOT CONFORM TO STANDARD SCALES. IN MAKING MEASUREMENTS ON REDUCED PLANS, THE ABOVE SCALES MAY BE USED.


J.U.L.I.E.

JOINT UTILITY LOCATING INFORMATION FOR EXCAVATORS 1-800-892-0123 OR 811

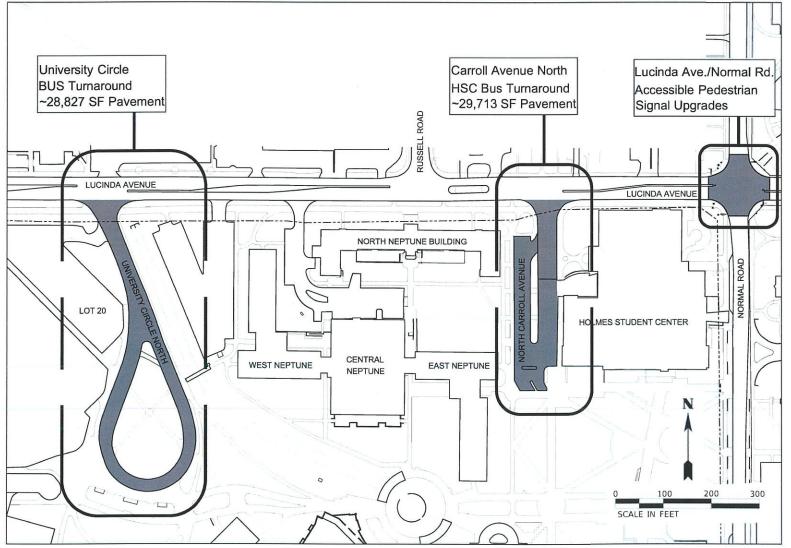

LOCATION MAP

PROJECT GROSS LENGTH: 0.686 Miles PROJECT NET LENGTH: 0.383 Miles C-93-021-21

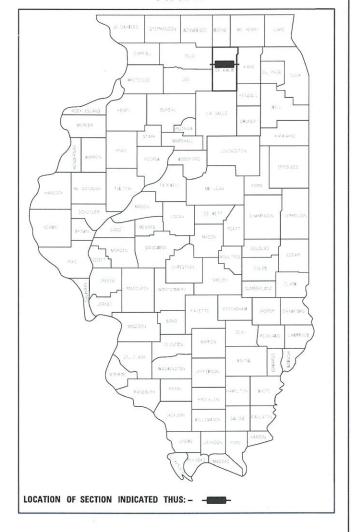

Plans Prepared By:



221 North LaSalle Street Suite 300 Chicago, IL 60601–1211 Phone: (312) 577–3300

STATE OF ILLINOIS
DEPARTMENT OF TRANSPORTATION

SUBMITTED June 4th 20 21

TED June 4th 20 21

BELINDA B. ROLLER, DIRECTOR - NORTHERN ILLINOIS UNIVERSITY

PASSED JUNE 7 20 ZI

DISTRICT 3, LOCAL ROADS AND STREET ENGINEER

Paral Harak
REGION 2 ENGINEER

PRINTED BY THE AUTHORITY OF THE STATE OF ILLINOIS

INDEX OF SHEETS

DESCRIPTION
COVER SHEET
GENERAL NOTES
SUMMARY OF QUANTITIES
EXISTING AND PROPOSED TYPICAL SECTIONS
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REMOVAL PLANS
PROPOSED IMPROVEMENTS
MILLING AND RESURFACING SEQUENCE PLAN
SOIL EROSION AND SEDIMENT CONTROL PLANS
PAVEMENT MARKING PLANS
SIDEWALK DETAIL PLANS
TRAFFIC SIGNAL INSTALLATION PLANS
TRAFFIC SIGNAL CABLE PLAN
CONSTRUCTION DETAILS

GENERAL NOTES

- ALL DIMENSIONS SHOWN ON THE PLANS ARE TO EDGE OF PAVEMENT, UNLESS OTHERWISE SPECIFIED.
- 2. ANY REFERENCE TO "STANDARD SPECIFICATIONS; THROUGHOUT THE PLANS OR SPECIAL PROVISIONS SHALL BE INTERPRETED TO THE ILLINOIS DEPARTMENT OF TRANSPORTATION "STANDARD SPECIFICATIONS FOR ROAD AND BRIDGE CONSTRUCTION" ADOPTED APRIL 1, 2016 AND THE LATEST EDITION OF THE "SUPPLEMENTAL SPECIFICATIONS AND RECURRING SPECIAL PROVISIONS", AT TIME OF BIDDING.
- 3. THERMOPLASTIC PAVEMENT MARKING LINE AND/OR LETTERS AND SYMBOLS SHALL BE DONE AT EACH LOCATION WHERE PAVEMENT MARKINGS ARE REQUIRED WITHIN 3 WORKING DAYS AFTER THE FINAL BITUMINOUS SURFACE IS IN PLACE.
- 4. THE CONTRACTOR SHALL PROTECT ALL MARKINGS FROM TRAFFIC UNTIL THE THERMOPLASTIC/PREFORMED PLASTIC HAS SET SUFFICIENTLY TO ASSUME TRAFFIC. ANY DAMAGE TO THE MARKINGS DUE TO TRAFFIC SHALL BE REPLACED IMMEDIATELY BY THE CONTRACTOR AT HIS/HER EXPENSE.
- PAVEMENT MARKING REMOVAL WILL NOT BE PAID FOR WHEN THE EXISTING MARKING IS REMOVED BY PAVEMENT REMOVAL, CURB AND GUTTER REMOVAL AND OTHER REMOVAL ITEMS.
- . UPON BID AWARD THE CONTRACTOR SHALL COMPLETE AND SUBMIT A RIGHT OF WAY CONSTRUCTION PERMIT APPLICATION FOR THE CITY OF DEKALB TO ENSURE THE CONTRACTOR IS INSURED. THE RIGHT OF WAY CONSTRUCTION PERMIT APPLICATION FOR THE CITY OF DEKALB IS INCLUDED IN THE SPECIAL PROVISION FOR RECORDS.
- DETECTABLE WARNING TILES SHALL BE POWDER COATED, 10 GAUGE GALVANIZED STEEL. COLOR SHALL BE BRICK RED - FED#22144
- 8. EXISTING RESERVED UNIVERISTY PARKING LOCATION CHANGES WILL NEED TO BE COMMUNICATED AND COORDINATED WITH THE UNIVERSITY PROJECT MANAGER.
- 9. DETECTABLE WARNING TILE MATERIAL SHALL BE 10 GAUGE GALVANIZED STEEL COLORED FED 22144 BRICK RED. EQUIPMENT AND INSTALLATION PROCEDURES USED SHALL BE ACCORDING TO THE MANUFACTURER'S SPECIFICATIONS.

IDOT HIGHWAY STANDARDS

000001-08	STANDARD SYMBOLS, ABBREVIATIONS, AND PATTERNS
280001-07	TEMPORARY EROSION CONTROL SYSTEMS
424001-11	PERPENDICULAR CURB RAMPS FOR SIDEWALKS
424006-05	DIAGNAL CURB RAMPS FOR SIDEWALKS
424011-04	CORNER PARALLEL CURB RAMPS FOR SIDEWALKS
424021-06	DEPRESSED CORNER FOR SIDEWALKS
442201-03	CLASS C & D PATCHES
701701-10	URBAN LANE CLOSURE, MULTILANE INTERSECTION
701801-06	SIDEWALK, CORNER OR CROSSWALK CLOSURE
701901-08	TRAFFIC CONTROL DEVICES
720001-01	SIGN PANEL MOUNTING DETAILS
720011-01	METAL POSTS FOR SIGNS MARKERS & DELINEATORS
728001-01	TELESCOPING STEEL SIGN SUPPORT
876001-04	PEDESTRIAN PUSH BUTTON POST
B.L.R. 28	CONCRETE CURB TYPE B AND COMBINATION CONCRETE CURB AND GUTTER

JOB NO. C-93-021-21



USER NAME = Ilugo	DESIGNED	-	ZRE	REVISED -
	DRAWN	-	ZRE	REVISED -
PLOT SCALE = 1:2	CHECKED	-	LL	REVISED -
PLOT DATE = 6/1/2021	DATE	-	APRIL 2021	REVISED -

SUMMARY OF QUANTITIES

SP	PAY ITEM NUMBER	PAY ITEM DESCRIPTION	UNIT	TOTAL QUANTITY	CONST TYPE 0005
	20200100	EARTH EXCAVATION	CU YD	47	47
	21101615	TOPSOIL FURNISH AND PLACE, 4"	SQ YD	457	457
	25000110	SEEDING, CLASS 1A	ACRE	0.1	0.1
	25000400	NITROGEN FERTILIZER NUTRIENT	POUND	8.5	8.5
	25000500	PHOSPHORUS FERTILIZER NUTRIENT	POUND	8.5	8.5
	25000600	POTASSIUM FERTILIZER NUTRIENT	POUND	8.5	8.5
•	25100635	EROSION CONTROL BLANKET	· SQ YD	457	457
	28000400	PERIMETER EROSION BARRIER	FOOT	382	382
	28000500	ÎNLÊT AND PÎPÊ PROTECTION	. ĒAĈH	18	18
	40600290	BITUMINOUS MATERIALS (TACK COAT)	POUND	2750	2750
	40602985	HOT-MIX ASPHALT BINDER COURSE, IL-9.5, N70	TON	·2	2
	40604062	HOT-MIX ASPHALT SURFACE COURSE, IL-9.5, MIX "D", N70	TON	871	871
	42400410	PORTLAND CEMENT CONCRETE SIDEWALK 8 INCH	SQ FT	4875	4875
×	42400800	DETECTABLE WARNINGS	SQ FT	388	388
	44000159	HOT-MIX ASPHALT SURFACE REMOVAL, 2 1/2"	· SQ YD	6112	6112
					930
	44000500	COMBINATION CURB AND GUTTER REMOVAL	FOOT	930	930
	44000600	SIDEWALK REMOVAL	SQ FT	4928	4928
	44201737	CLASS D PATCHES, TYPE I, 8 INCH	SQ YD	7	7
	44201741	CLASS D PATCHES, TYPE II, 8 INCH	SQ YD	· 9	9
	44201745	CLASS D PATCHES, TYPE III, 8 INCH	SQ YD	23	23
	44201747	CLASS D PATCHES, TYPE IV, 8 INCH	SQ YD	. 27	27
	60260100	INLETS TO BE ADJUSTED	EACH	17	17
	6025 5500	MANHOLES TO BE ADJUSTED	EACH	14	14
	60603800	COMBINATION CONCRETE CURB AND GUTTER, TYPE B-6.12	FOOT	229	229
 SP	LEGEND				

SP	PAY ITEM NUMBER	PAY ITEM DESCRIPTION	UNIT	TOTAL	CONST TYPE 0005
	67100100	MOBILIZATION	L SUM	1	1
	70102635	TRAFFIC CONTROL AND PROTECTION, STANDARD 701701	L SUM	1	1
	72000100	SIGN PANEL - TYPE 1	SQ FT	9	9
	72400100	REMOVE SIGN PANEL ASSEMBLY - TYPE A	EACH	1	1
	72800100	TELESCOPING STEEL SIGN SUPPORT	FOOT	13	13
\	78000100	THERMOPLASTIC PAVEMENT MARKING - LETTERS AND SYMBOLS	SQ FT	62	62
2	78000400	THERMOPLASTIC PAVEMENT MARKING - LINE 6"	FOOT	2379	2379
\	78000600	THERMOPLASTIC PAVEMENT MARKING - LINE 12"	·FOOT	1938	1938
·	78000650	THERMOPLASTIC PAVEMENT MARKING - LINE 24"	FOOT	163	163
X	85000200	MAINTENANCE OF EXISTING TRAFFIC SIGNAL INSTALLATION	EACH	1	1
\	87301215	ELECTRIC CABLE IN CONDUIT, SIGNAL NO. 14 2C	FOOT	56	56
	88102717	PEDESTRIAN SIGNAL HEAD, LED, 1-FACE, BRACKET MOUNTED WITH COUNTDOWN TIMER	EACH	8	8
\ 	88600100	DETECTOR LOOP, TYPE I	FOOT	34	34
,	89502300	REMOVE ELECTRIC CABLE FROM CONDUIT	FOOT	44	44
×	89502375	REMOVE EXISTING TRAFFIC SIGNAL EQUIPMENT	EACH	1	1
×	89502376	REBUILD EXISTING HANDHOLE	EACH	2	2
х	Z0013798	CONSTRUCTION LAYOUT	L SUM	1	1
X	X6064200	COMBINATION CONCRETE CURB AND GUTTER, TYPE B-6.12 (SPECIAL)	FOOT	701	. 701
х	X7010216	TRAFFIC CONTROL AND PROTECTION, (SPECIAL)	L SUM	1	1
×	X8760200	ACCESSIBLE PEDESTRIAN SIGNALS	EACH	8	8
X	X8950114	MODIFY EXISTING CONTROLLER AND CABINET	EACH	1	1 .
. ×	² Z0073509	PERMANENT TRAFFIC SIGNAL TIMING	EACH	1	1
Х	xx009474	JOINT REPAIR (SPECIAL)	FOOT	191	191


SP LEGEND

X INDICATES ITEM REQUIRES A SPECIAL PROVISION \(\triangle SPECIALTY ZTEMS

	USER NAME = llugo	DESIGNED	-	ZRE	REVISED	-
KNIGHT		DRAWN	-	ZRE	REVISED	-
Engineers & Architects	PLOT SCALE = 1:2	CHECKED	-	T.	REVISED	-
	PLOT DATE == 6/1/2021	DATE	-	APRIL 2021	REVISED	-

NORTHERN ILLINOIS UNIVERSITY

								COUNTY	SHEETS	NO.
SUMMARY OF QUANTITIES							08-00003-00-PV	DeKalb	31	3
								CONTRACT I	NUMBER:	87754
SCALE: NONE	SHEET	1	OF	1	SHEETS		ILLINOIS			

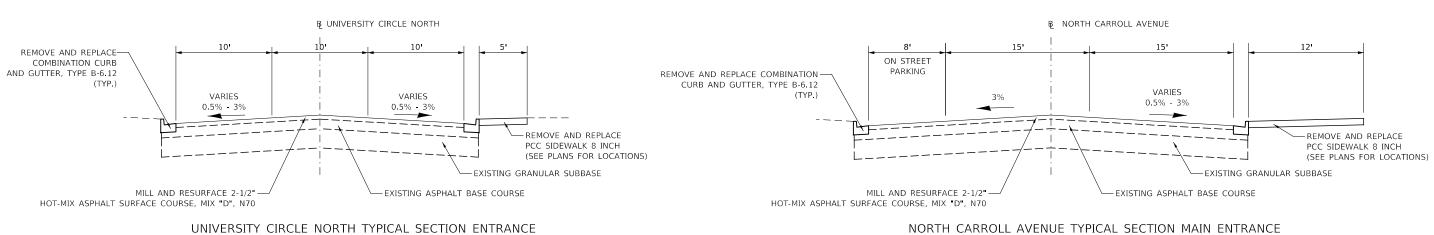


UNIVERSITY CIRCLE NORTH TYPICAL SECTION ENTRANCE

STA 103+06 TO 105+39 (LOOKING NORTH)

VARIES

₽ UNIVERSITY CIRCLE NORTH

VARIES 0.5% - 2%

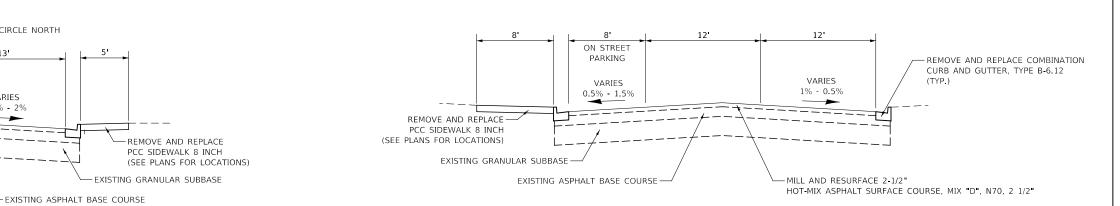

UNIVERSITY CIRCLE NORTH TYPICAL SECTION SOUTHEAST


STA 100+30 TO 103+06 (LOOKING NORTH)

NORTH CARROLL AVENUE TYPICAL SECTION TURNAROUND

STA 203+88 TO 203+66

(LOOKING NORTH)

STA 203+88 TO 203+66

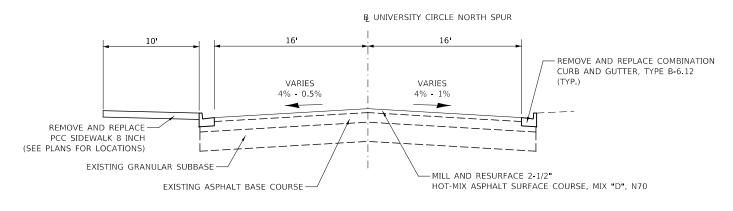

UNIVERSITY CIRCLE NORTH TYPICAL SECTION SOUTHWEST

STA 151+08 TO 153+70

	HMA MIXTURE REQUIREM	ENI IABLE	
LOCATIONS:	ENTIRE PROJECT	ENTIRE PROJECT	ENTIRE PROJECT
MIXTURE USE(S):	HMA SURFACE	CLASS D PATCH BOTTOM LIFT(S)	CLASS D PATCH TOP LIFT
BINDER GRADE (PG):	PG64-22	PG64-22	PG64-22
DESIGN AIR VOIDS:	4.0% @ N70	4.0% @ N70	4.0% @ N70
MIXTURE COMPOSITION: (MIXTURE GRADATION)	IL 9.5	IL 9.5	IL 9.5
FRICTION AGGREGATE:	MIXTURE D		
MIXTURE WEIGHT:	112.0 LB/SY/IN	112.0 LB/SY/IN	112.0 LB/SY/IN
QUALITY MANAGEMENT PROGRAM:	QCQA	QCQA	QCQA
SUBLOT SIZE:	NA	NA	NA
DENSITY TEST METHOD:	LR 1030	LR 1030	LR 1030

itects


REMOVE AND REPLACE COMBINATION

CURB AND GUTTER, TYPE B-6.12


MILL AND RESURFACE 2-1/2"— HOT-MIX ASPHALT SURFACE COURSE, MIX "D", N70


USER NAME = Ilugo	DESIGNED	-	ZRE	REVISED -
	DRAWN	-	ZRE	REVISED -
PLOT SCALE = 1:10	CHECKED	-	LL	REVISED -
PLOT DATE = 6/1/2021	DATE	-	APRIL 2021	REVISED -


EXISTING AND PROPOSED TYPICAL SECTIONS	FAU RTE	SECTION	COUNTY	TOTAL SHEETS	SHEET NO.
UNIVERSITY CIRCLE NORTH AND NORTH CARROLL AVENUE	5336	08-00003-00-PV	DeKa l b	31	4
ONIVERSITY OFFICE WORTH AND WORTH CAMBOLE AVENUE			CONTRACT N	IUMBER:	87754
SCALE: 1" = 10' SHEET 1 OF 1 SHEETS		ILLINOIS			

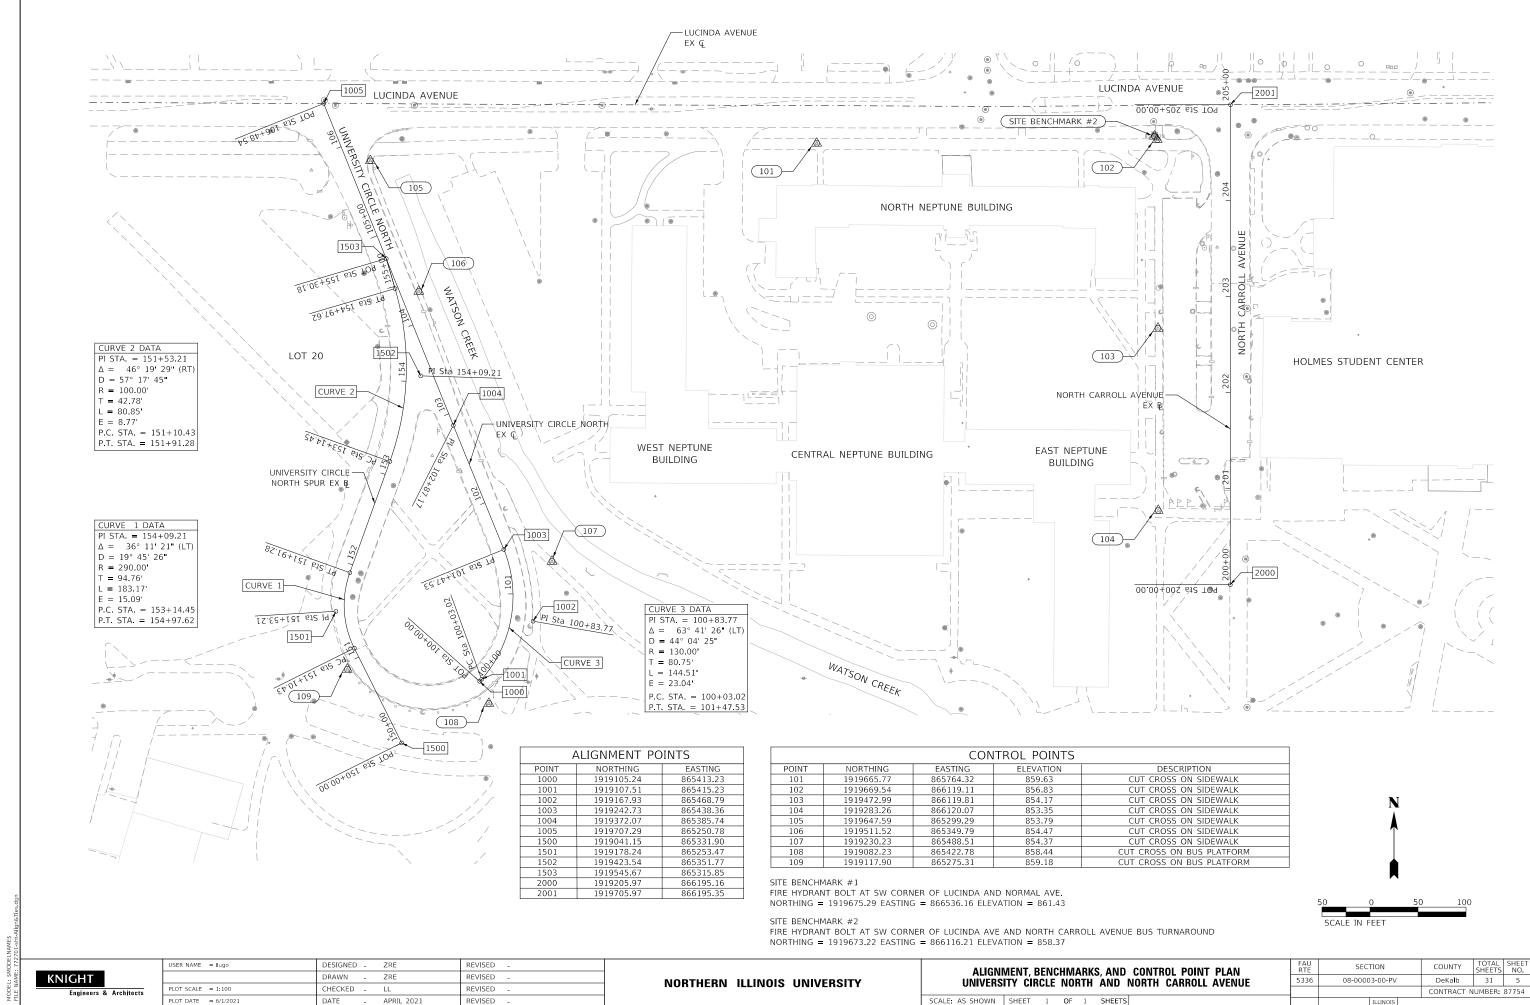



LOT DATE = 6/1/2021 DATE REVISED APRIL 2021

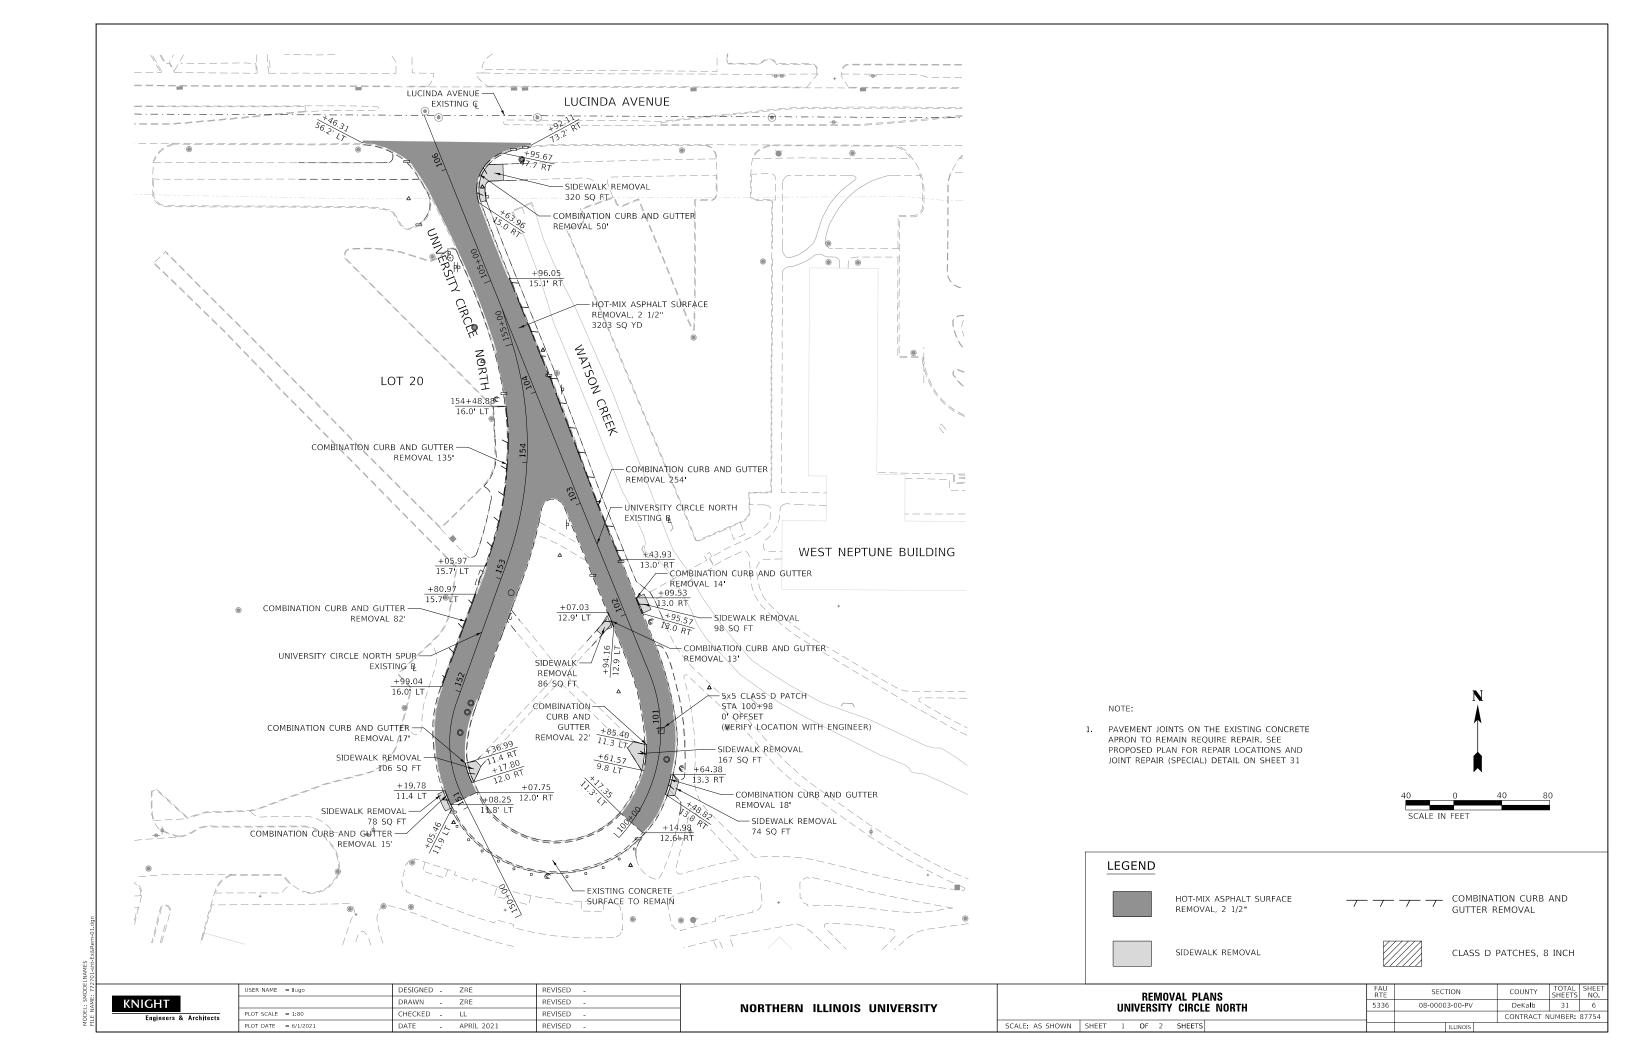


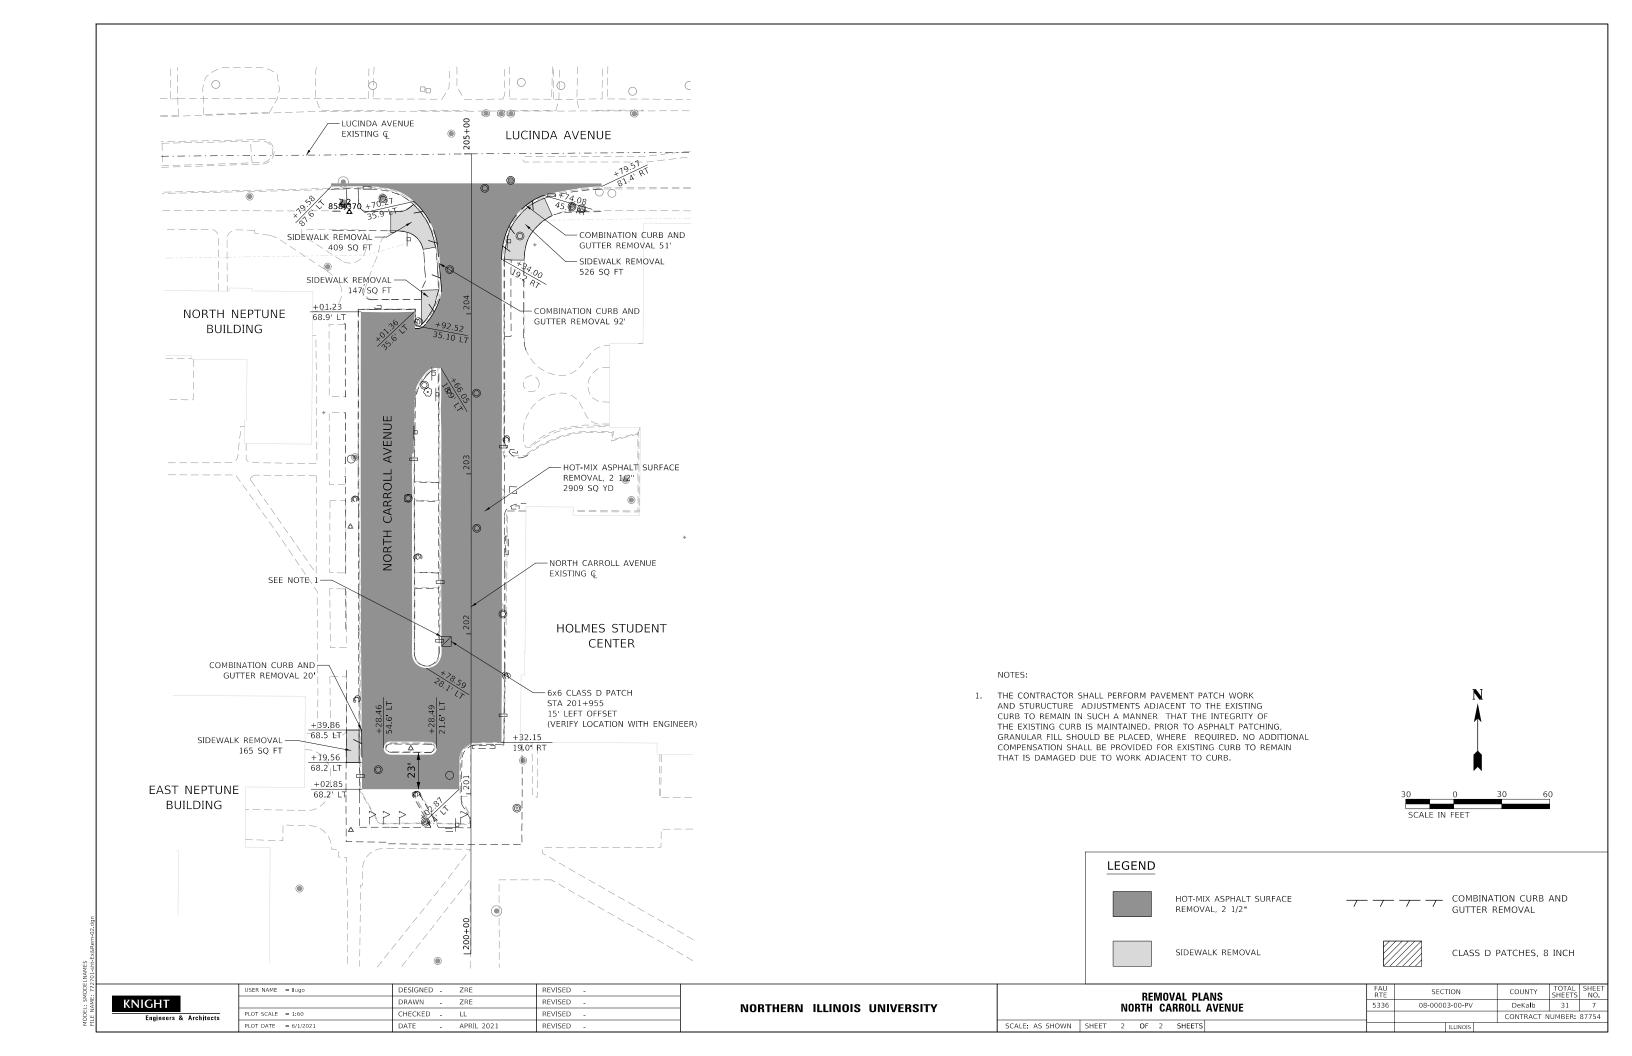

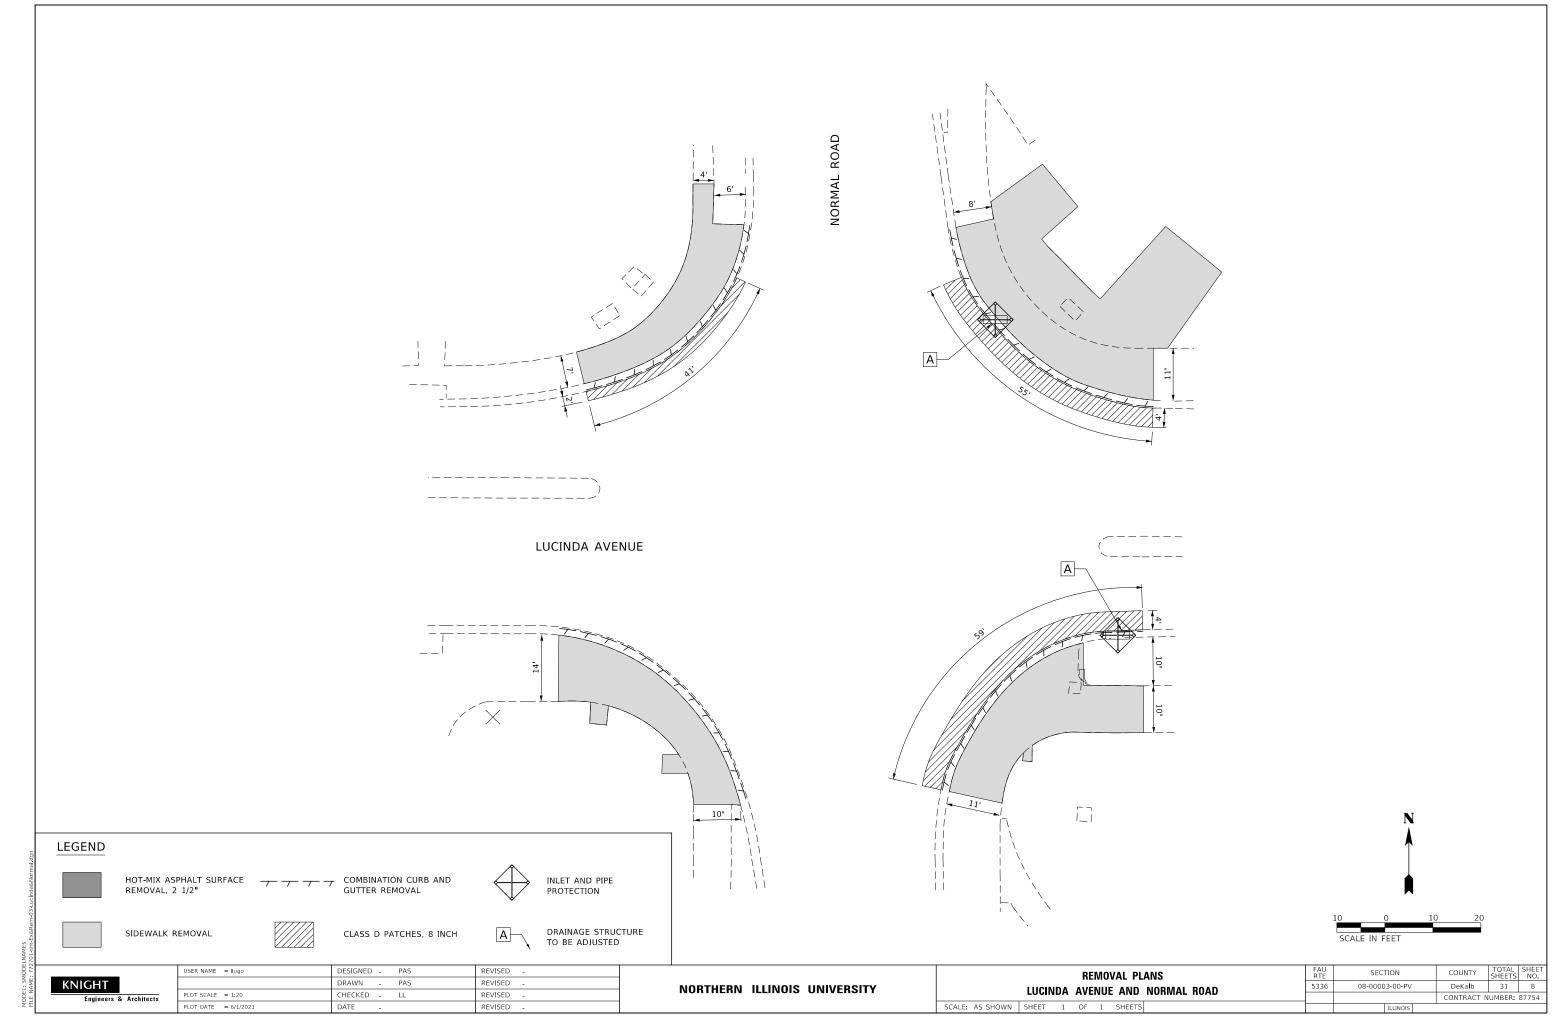

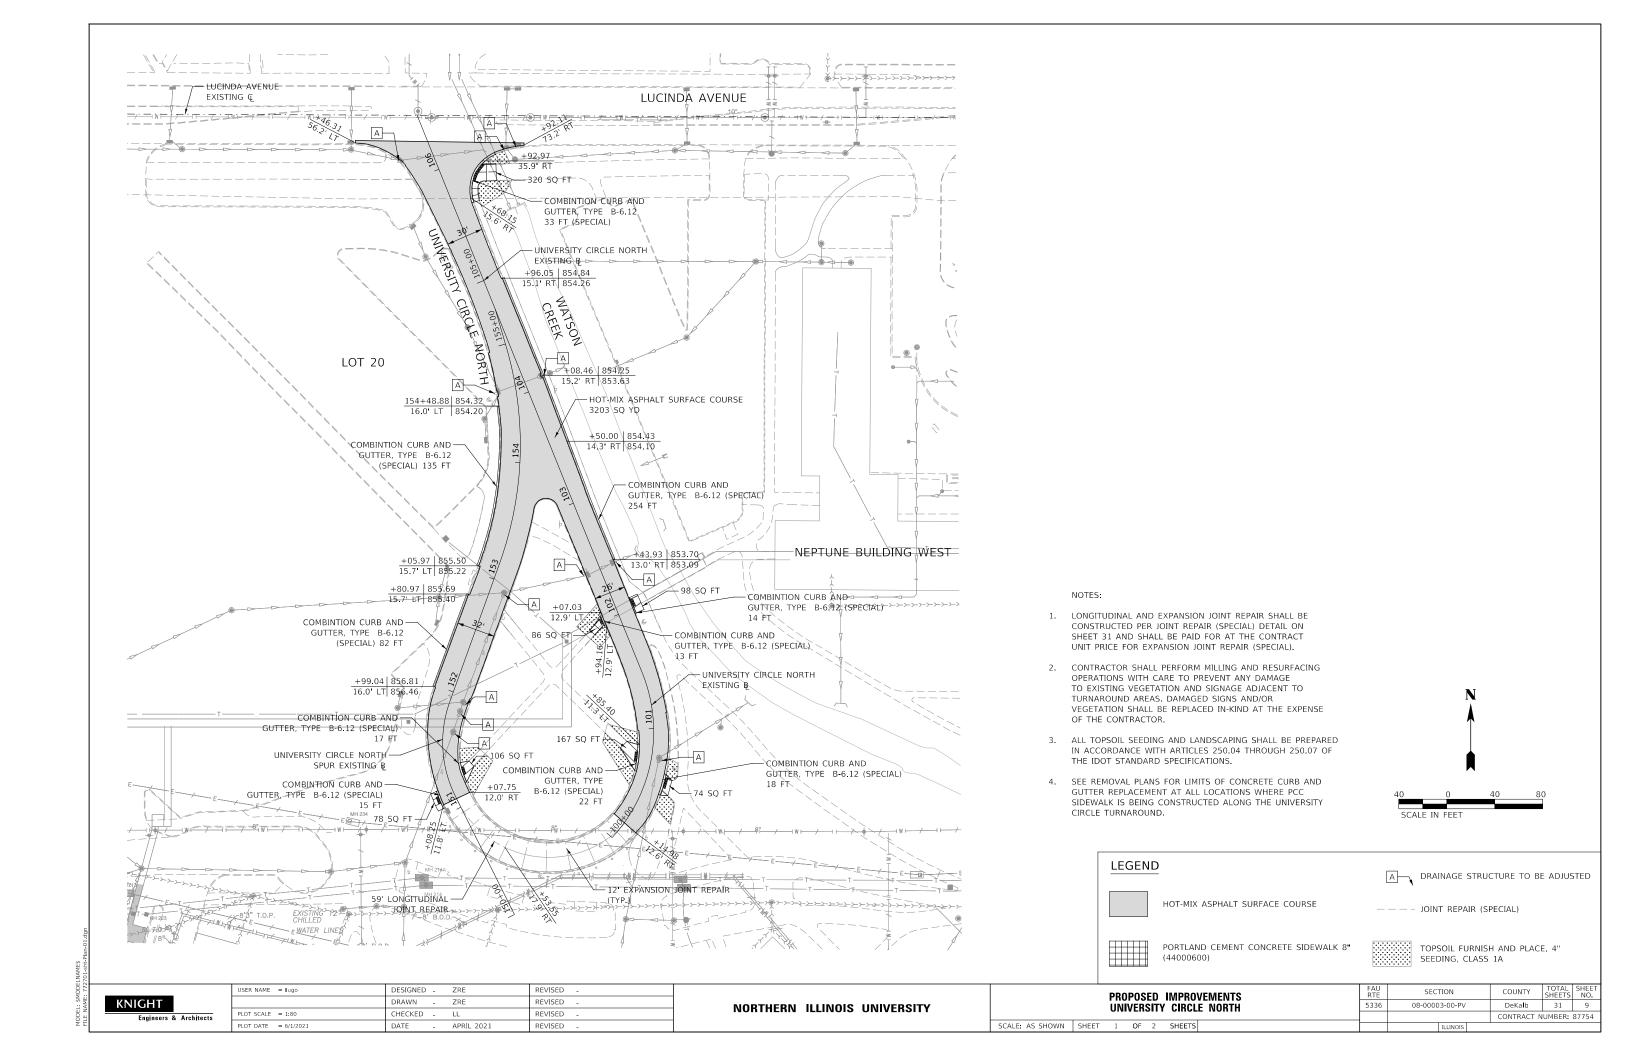


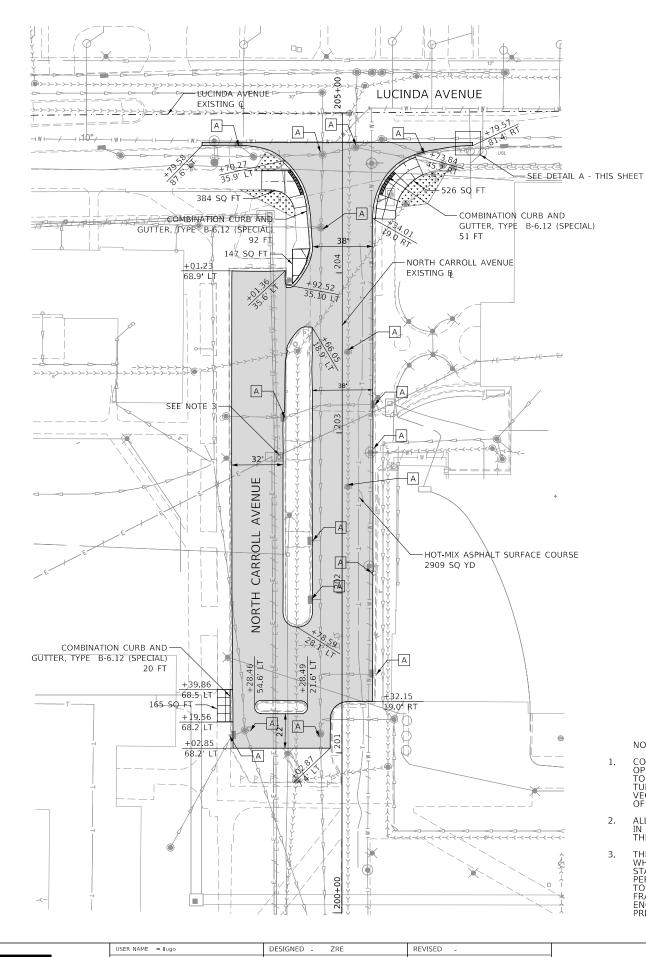

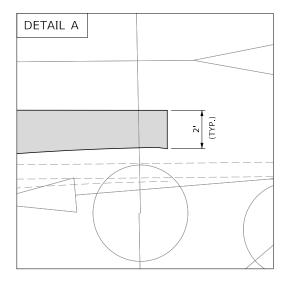



- CONTRACTOR SHALL PERFORM MILLING AND RESURFACING OPERATIONS WITH CARE TO PREVENT ANY DAMAGE TO EXISTING VEGETATION AND SIGNAGE ADJACENT TO TURNAROUND AREAS. DAMAGED SIGNS AND/OR VEGETATION SHALL BE REPLACED IN-KIND AT THE EXPENSE OF THE CONTRACTOR.
- ALL TOPSOIL SEEDING AND LANDSCAPING SHALL BE PREPARED IN ACCORDANCE WITH ARTICLES 250.04 THROUGH 250.07 OF THE IDOT STANDARD SPECIFICATIONS.
- THE CONTRACTOR SHALL TAKE ALL NECESSARY PRECAUTIONS WHEN WORKING AROUND THE UTILITY STRUCTURE LOCATED AT STA 202+84.73, OFFSET 39.36 LT. THE CONTRACTOR SHALL PERFORM MILLING AND RESURFACING AROUND THE UTILITY AS TO NOT DAMAGE THE EXISTING STRUCTURE AND CAST IN PLACE FRAME AND GRATE. THE CONTRACTOR SHALL VERIFY WITH THE ENGINEER THE LIMITS OF HIS WORK AROUND THIS STRUCTURE PRIOR TO THE MILLING OPERATION.

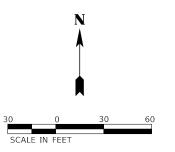

LEGEND



HOT-MIX ASPHALT SURFACE COURSE





PORTLAND CEMENT CONCRETE SIDEWALK 8" (44000600)



TOPSOIL FURNISH AND PLACE, 4" SEEDING, CLASS 1A

DRAINAGE STRUCTURE TO BE ADJUSTED

KNIGHT

DRAWN ZRE REVISED CHECKED -REVISED PLOT DATE = 6/1/2021 DATE REVISED APRIL 2021


NORTHERN ILLINOIS UNIVERSITY


PROPOSED IMPROVEMENTS NORTH CARROLL AVENUE


SECTION COUNTY DeKa**l**b 31 10


SCALE: AS SHOWN SHEET 2 OF 2 SHEETS

5336 08-00003-00-PV CONTRACT NUMBER: 87754

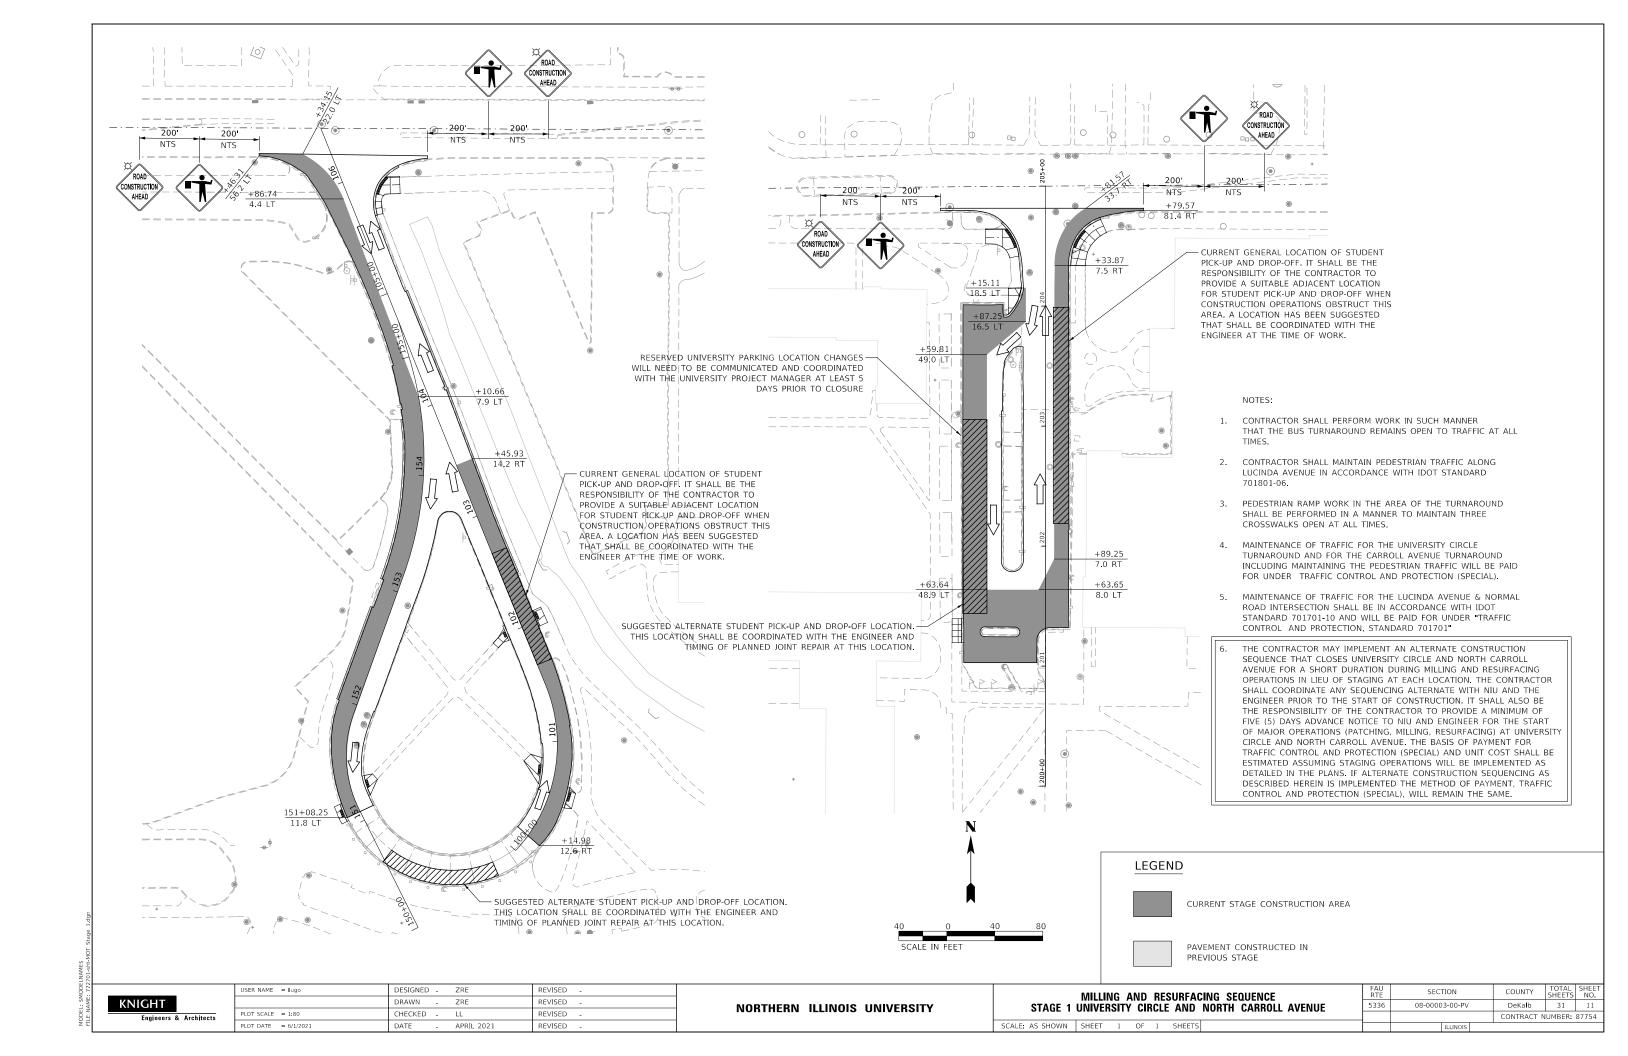


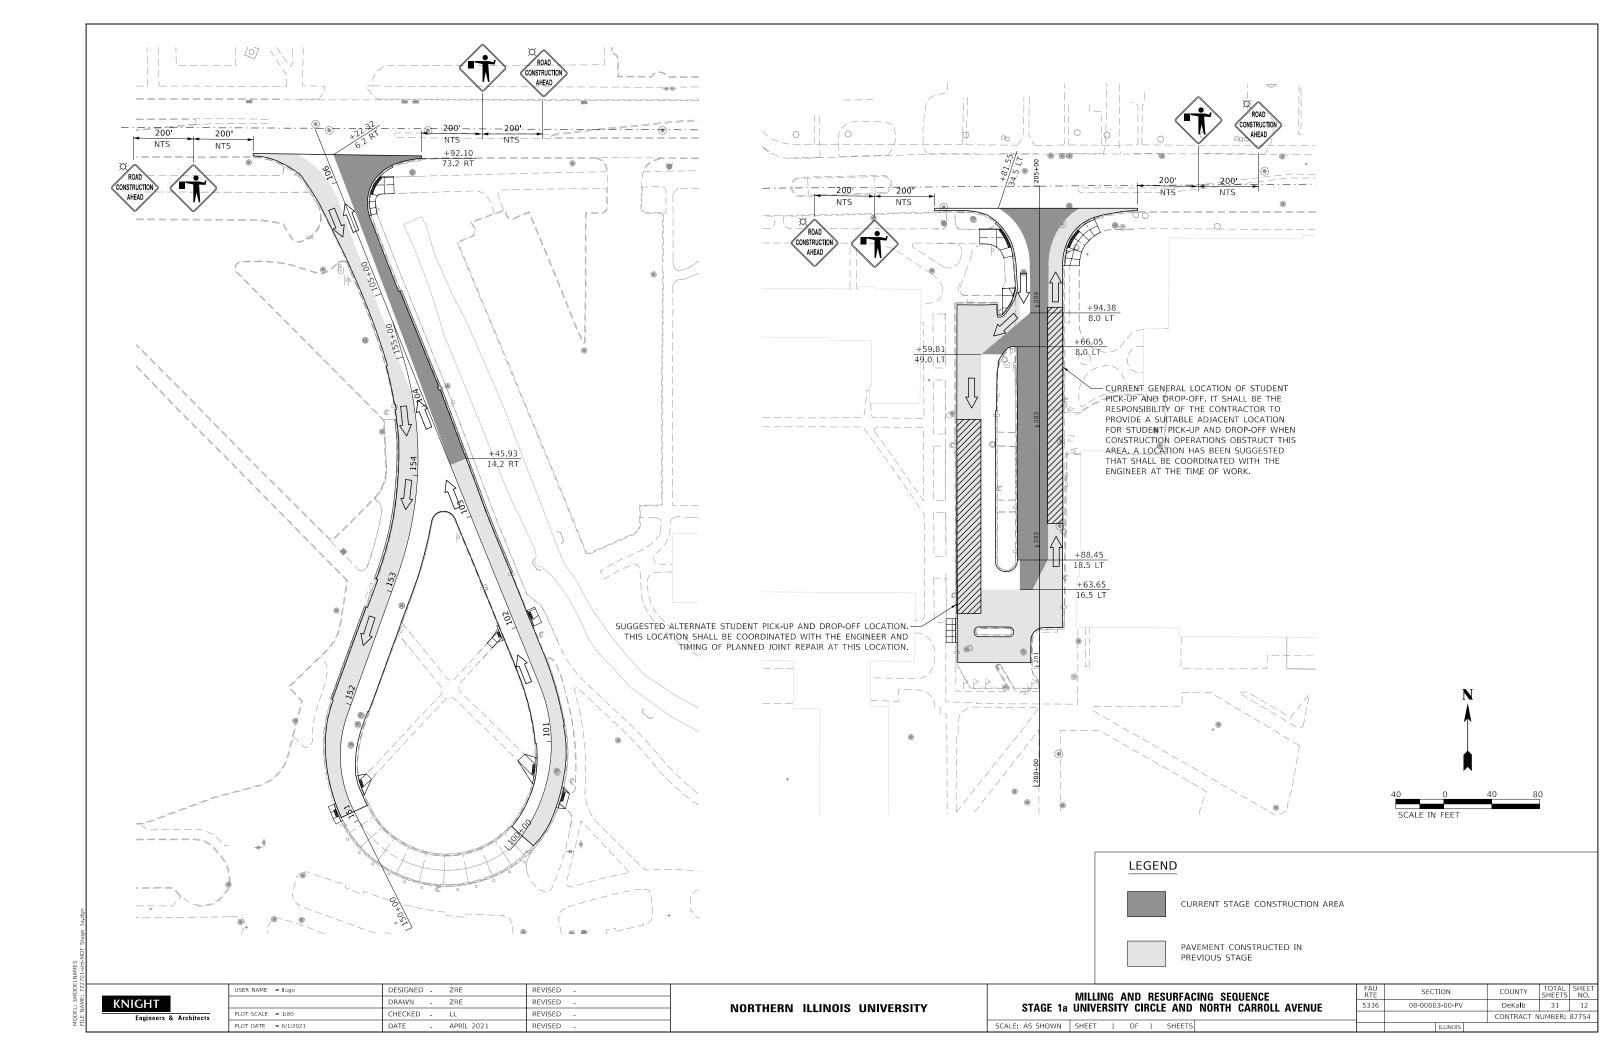


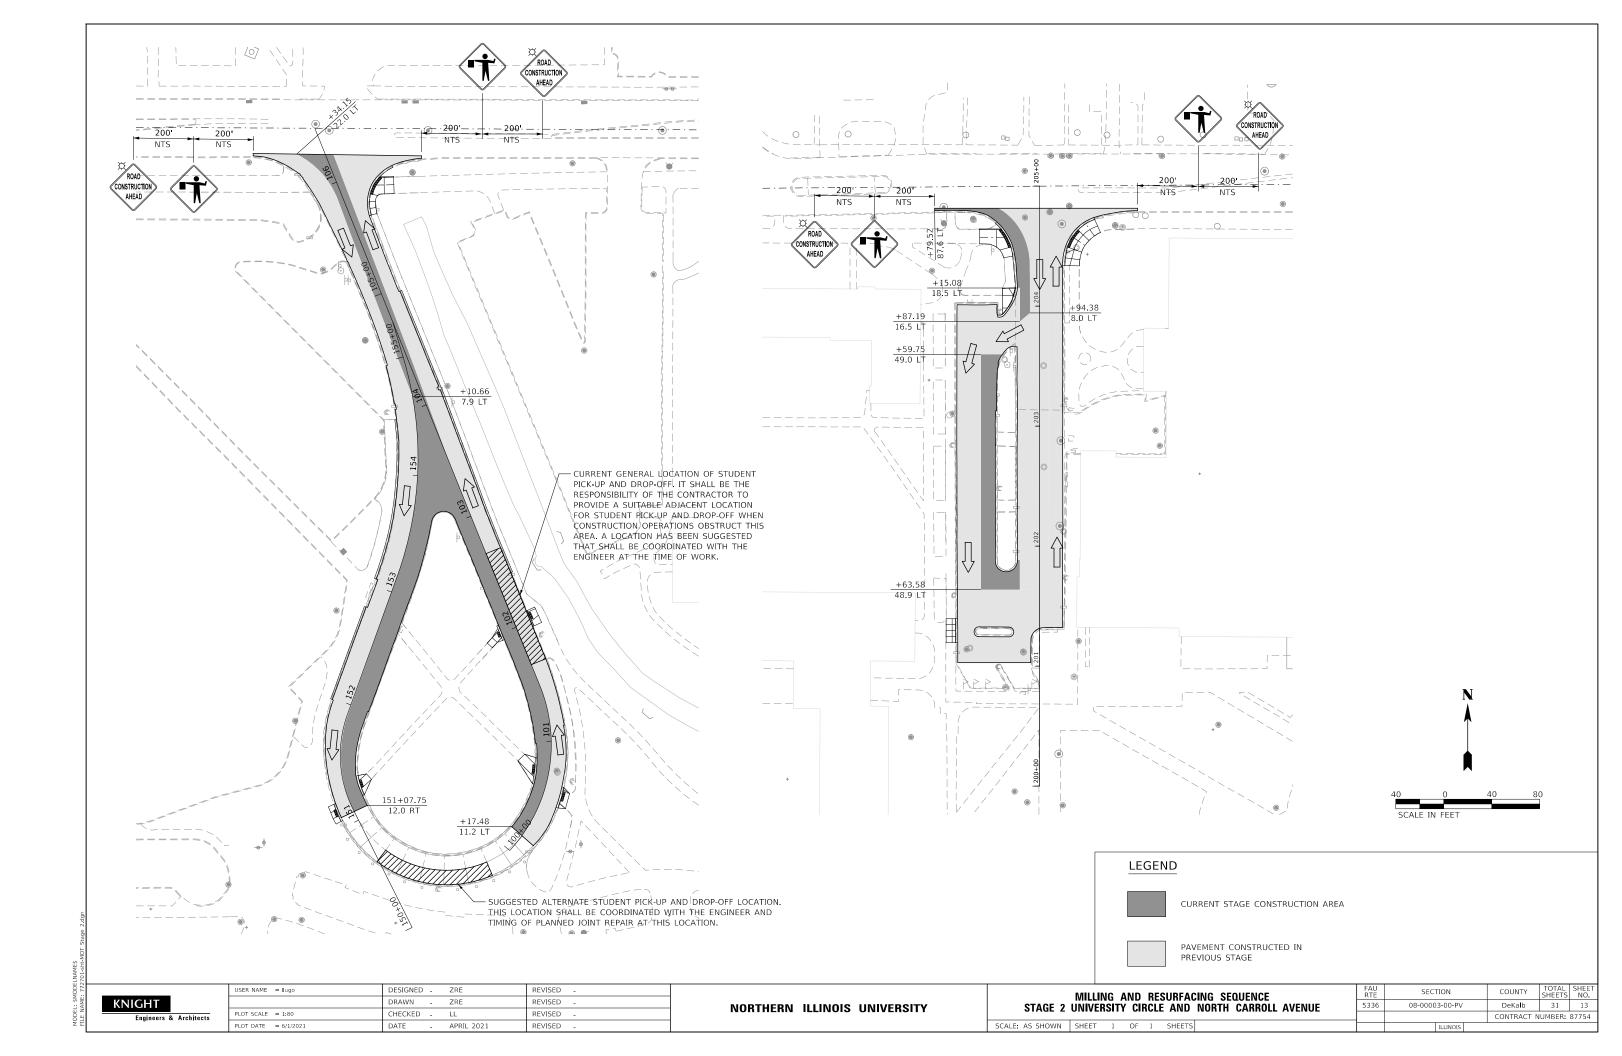

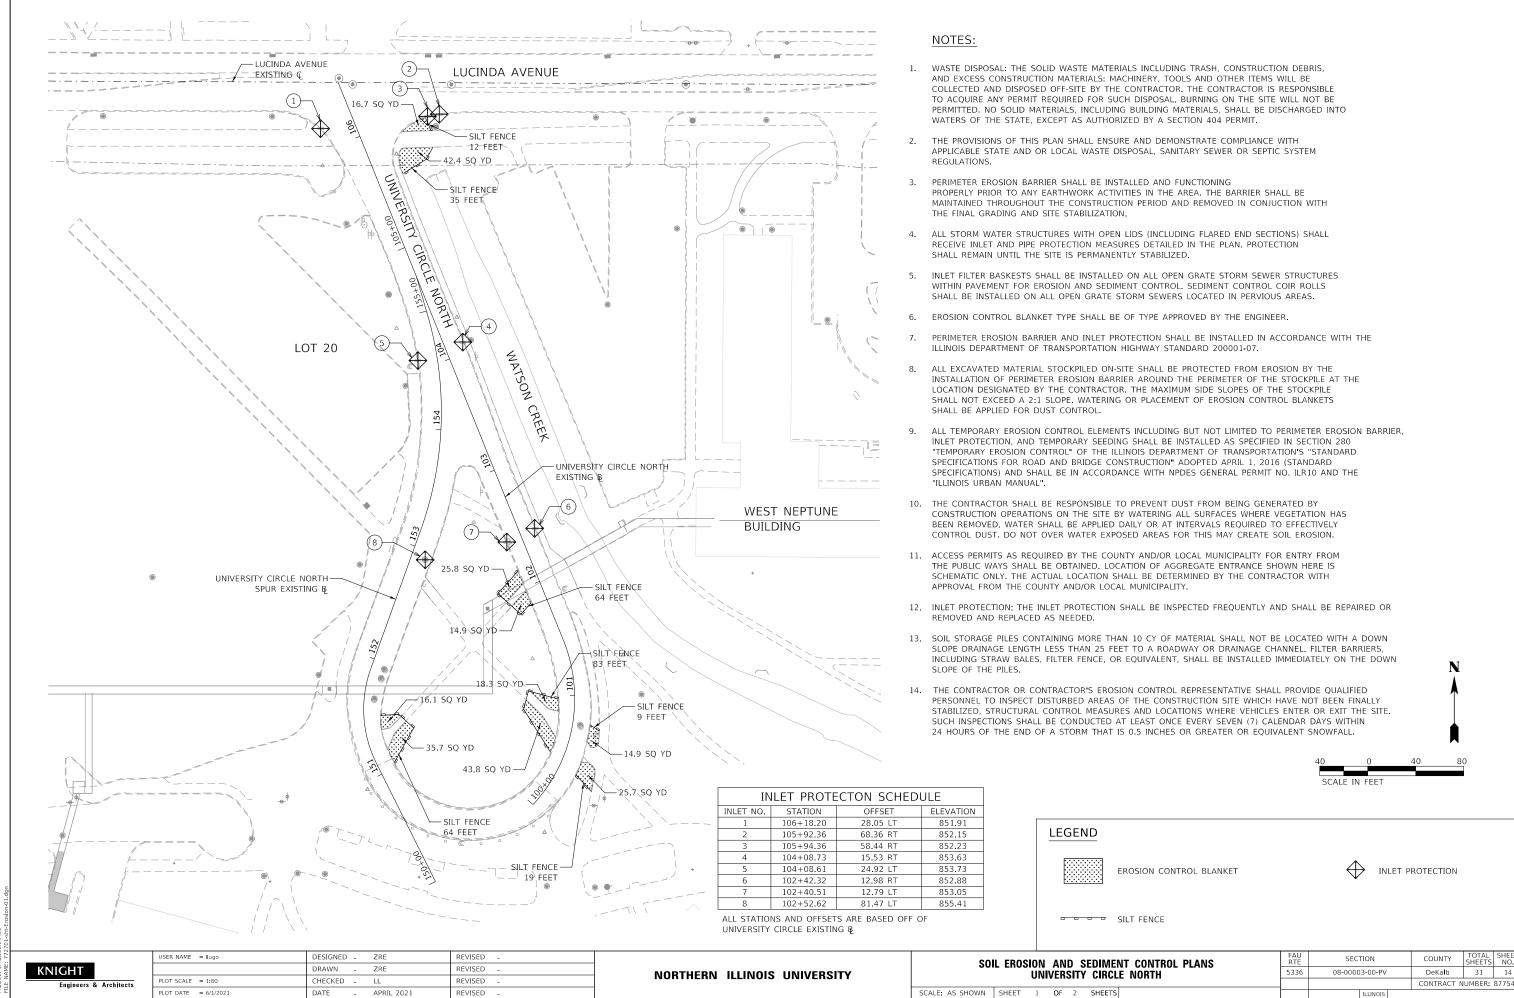

MODEL: \$MODELNAME\$

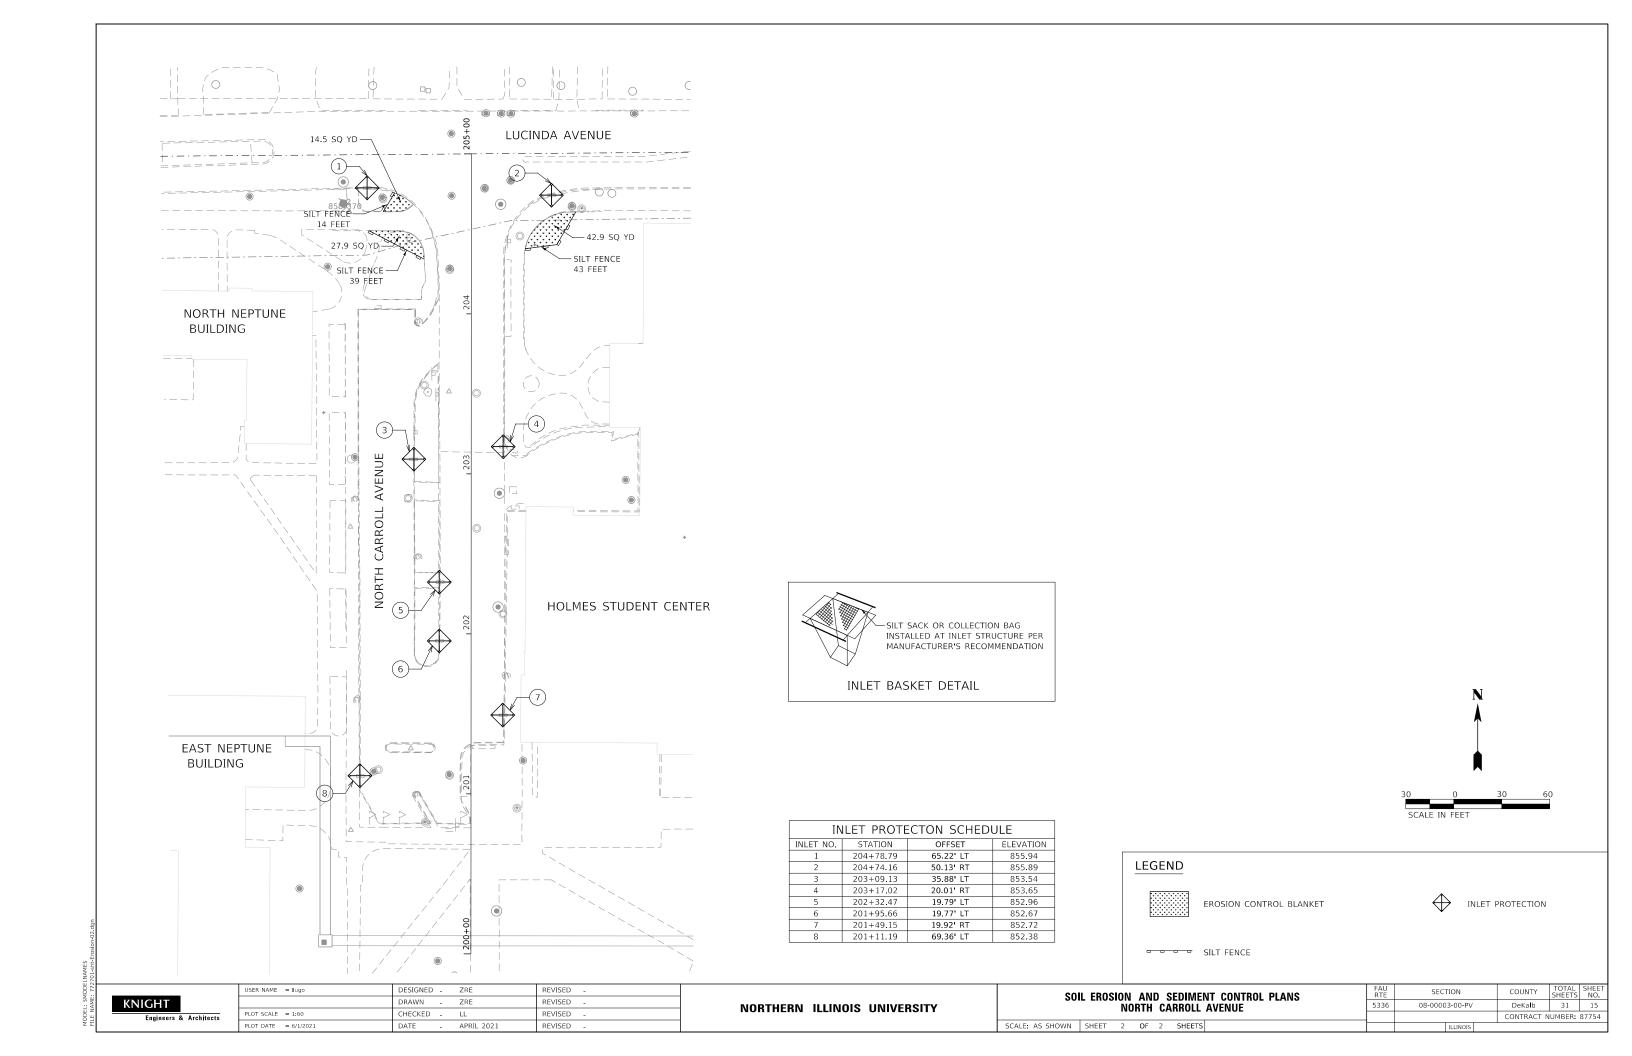


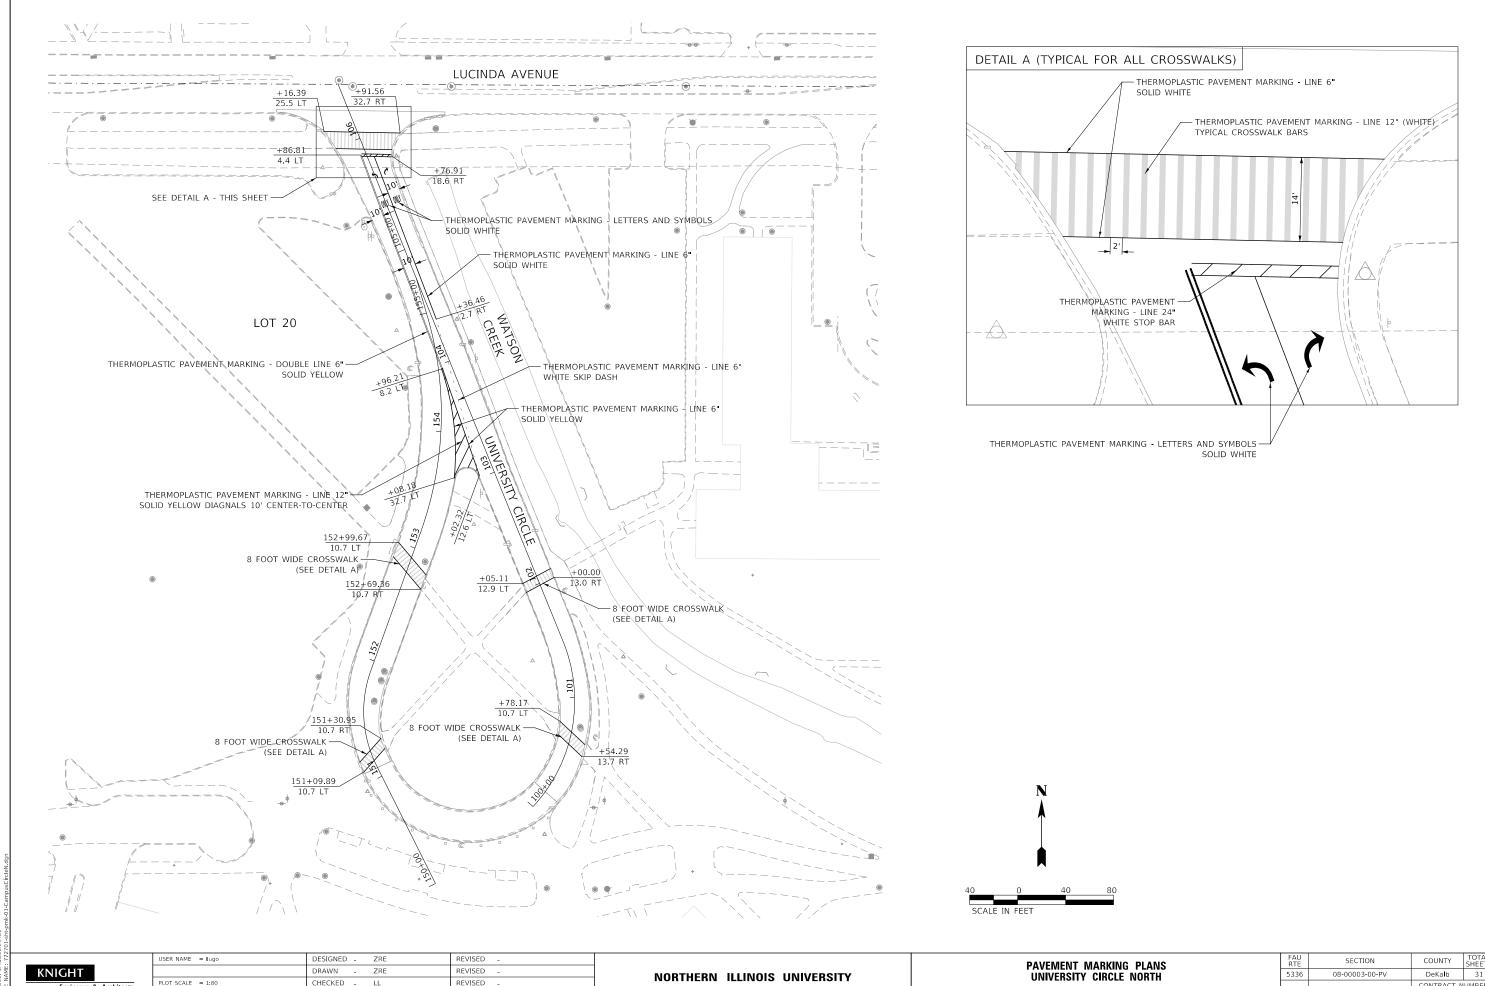


CHECKED -LL REVISED PLOT DATE = 6/1/2021 APRIL 2021 REVISED

SCALE: AS SHOWN SHEET 2

AVEMENT MARKING PLANS	FAU RTE	SECTION		COUNTY	TOTAL SHEETS	SHEET NO.
JNIVERSITY CIRCLE NORTH		08-00003-00-PV		DeKa l b	31	16
				CONTRACT N	UMBER:	87754
2 OF 2 SHEETS		ILLINOIS				

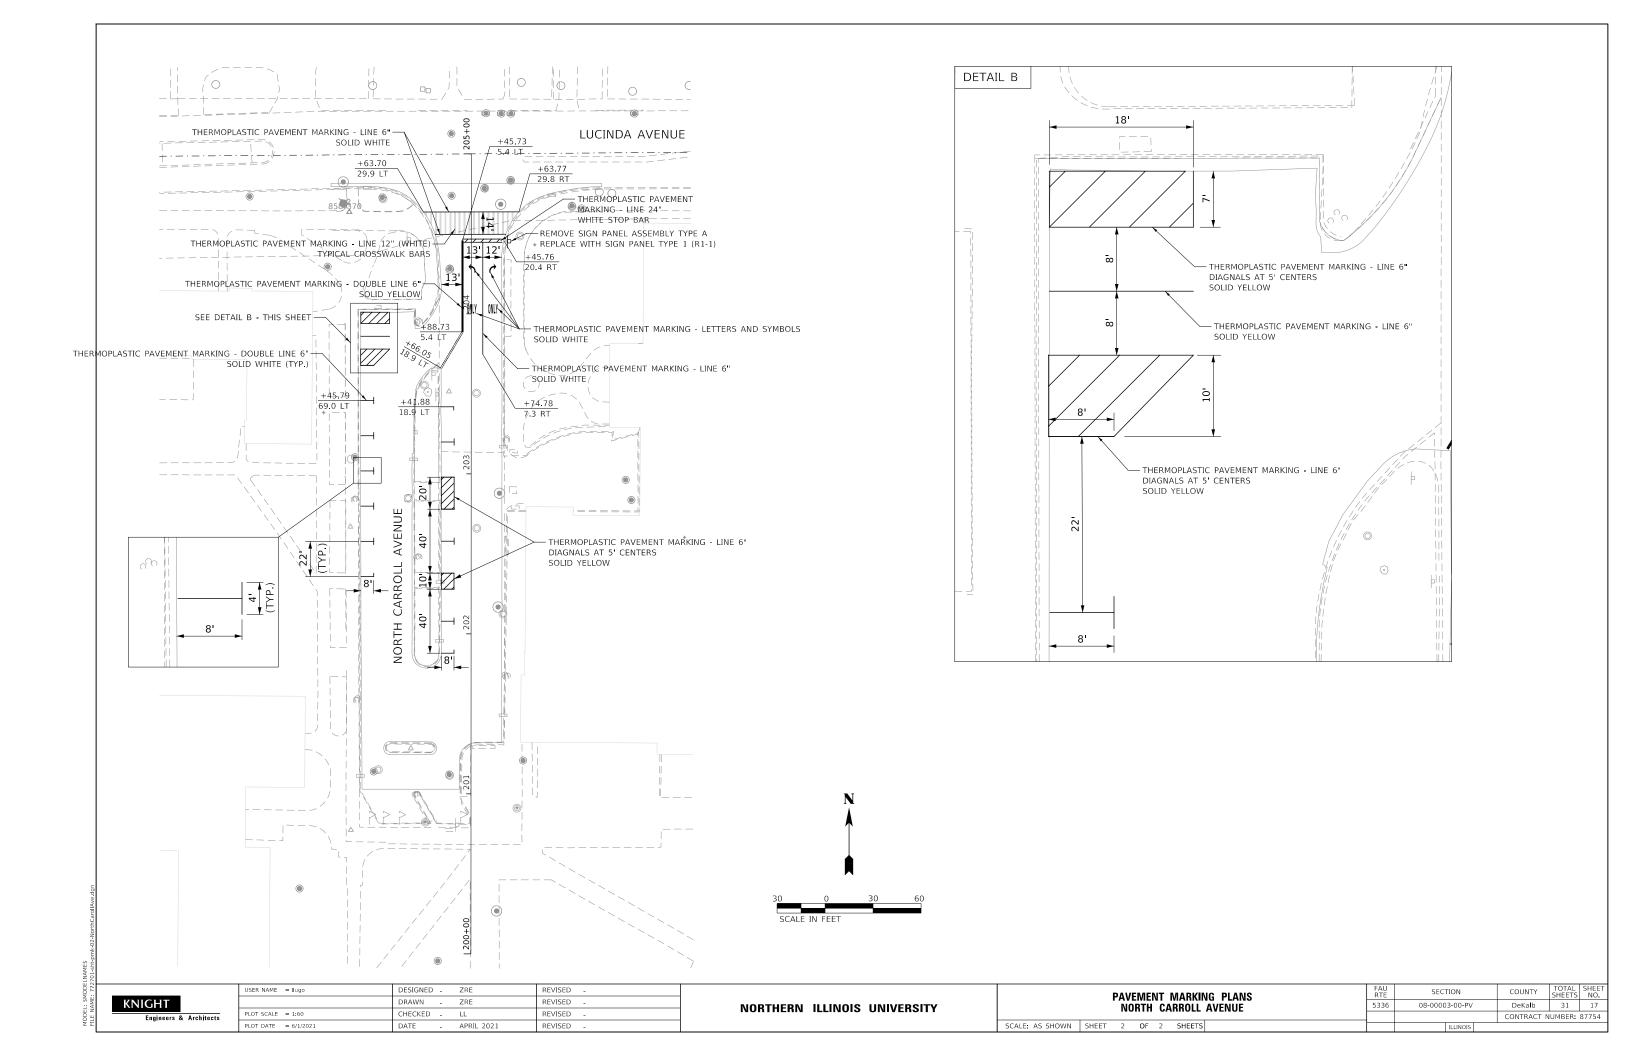

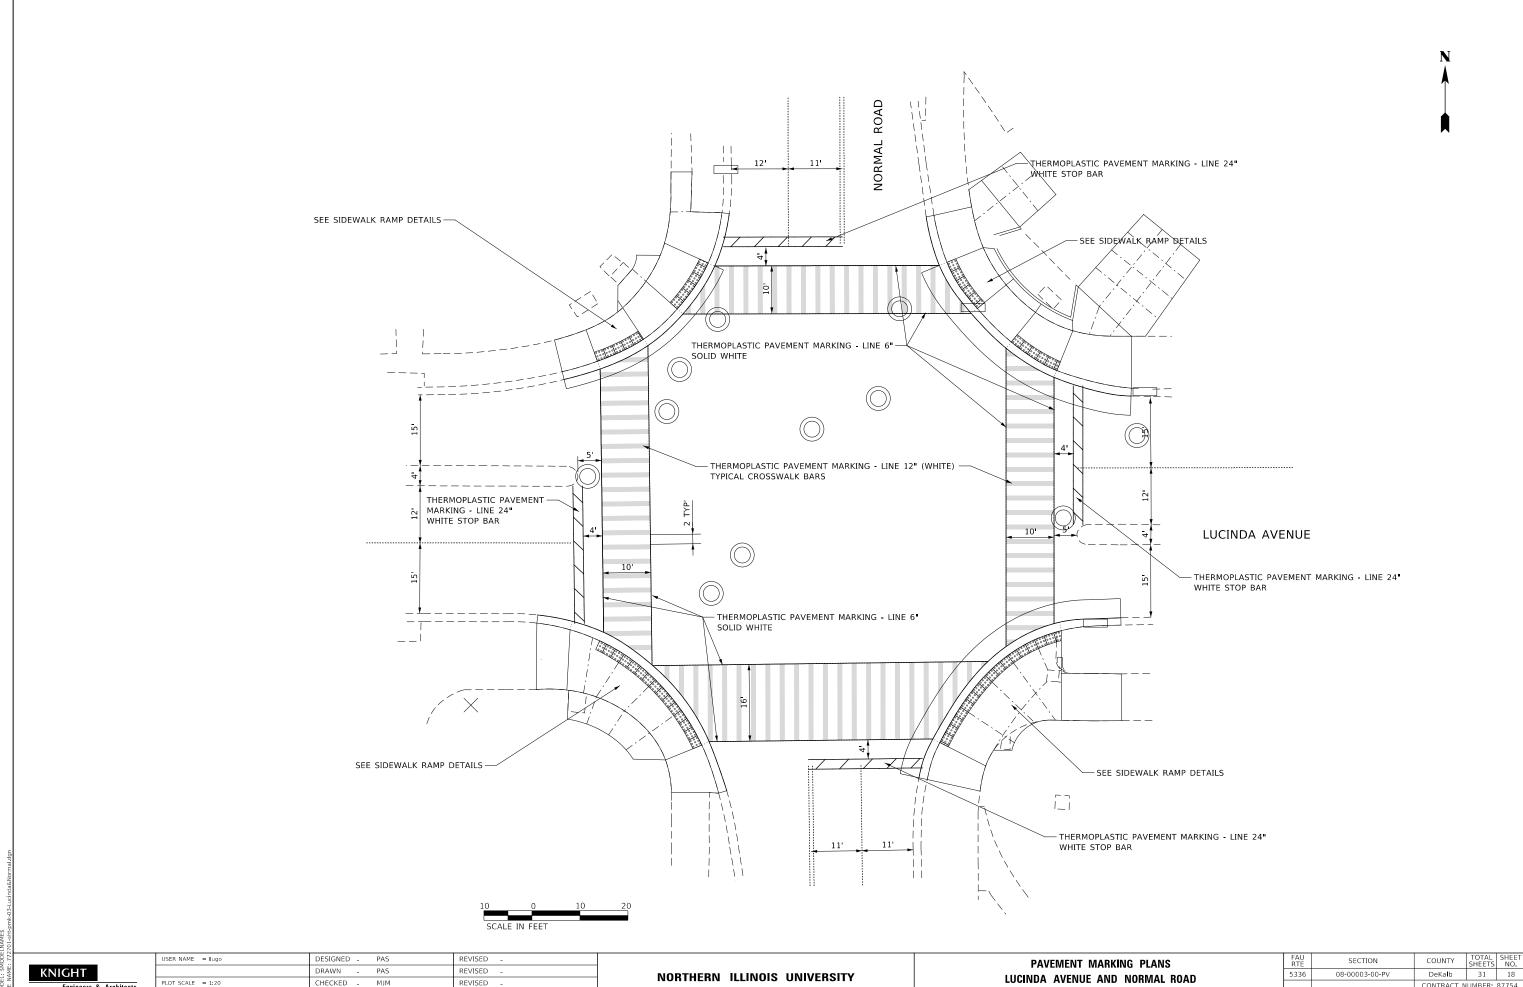

CHECKED -REVISED PLOT DATE = 6/1/2021 REVISED


NORTHERN ILLINOIS UNIVERSITY


08-00003-00-PV LUCINDA AVENUE AND NORMAL ROAD CONTRACT NUMBER: 87754 SCALE: AS SHOWN SHEET 1 OF 1 SHEETS

	STATION OFFSET		ELEVATION
Α	105+81.26	21.18' R	853.26
В	105+80.33	22.57' R	853.26
С	105+63.74	16.72' R	(854.53)
D	105+63.25	21.61' R	(854.55)
E	105+76.91	27.71' R	853.28
F	105+76.11	33.27' R	853.30
G	105+73.28	40.99' R	(853.46)
Н	105+86.25	45.71' R	(852.93)
I	105+89.00	38.37' R	853.04
J	105+90.47	34.65' R	852.98
K	105+92.09	33,88' R	852,98
L	105+91.53	32.78' R	853.00


OTHER SIDEWALK SLOPES			
FROM POINT	TO POINT	SLOPE	
I	J	1.50%	
L	K	1.63%	
Е	В	0.32%	

- 1. PRIOR TO THE REMOVAL OF SIDEWALK, THE CONTRACTOR SHALL SURVEY THE SIDEWALK ELEVATIONS AT LOCATIONS WHERE THE PROPOSED WORK WILL MEET EXISTING. THE CONTRACTOR SHALL IMMEDIATELY NOTIFY THE ENGINEER IF ANY DISCREPANCIES WITH THE ELEVATIONS SHOWN ARE ENCOUNTERED.
- 2. EXPANSION JOINT LOCATIONS ARE APPROXIMATE. THE CONTRACTOR SHALL IDENTIFY LOCATIONS IN THE FIELD AND RECEIVE APPROVAL FROM THE RESIDENT ENGINEER.

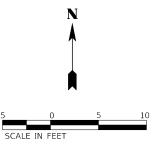

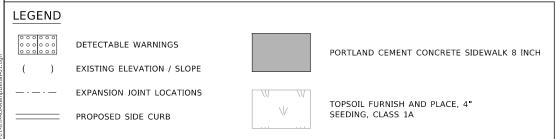

LUCINDA AVENUE

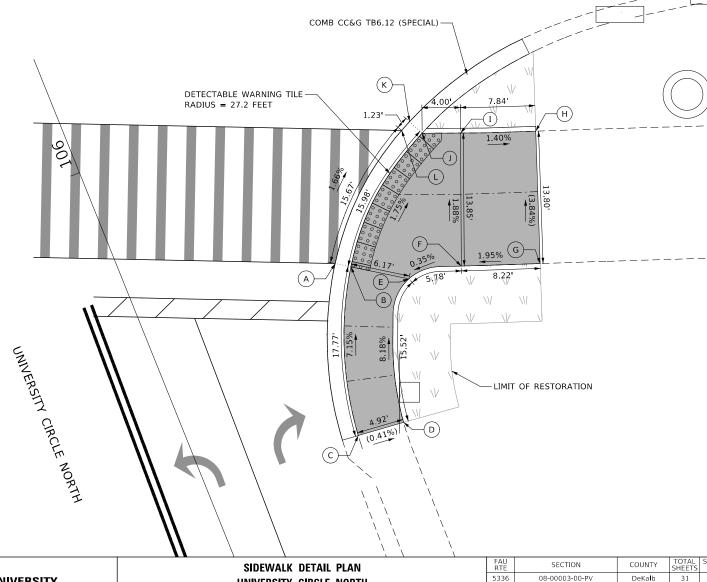

MODEL: \$MODELNAME\$

KNIGHT

NORTHERN ILLINOIS UNIVERSITY


UNIVERSITY CIRCLE NORTH

SCALE: AS SHOWN SHEET 1 OF 4 SHEETS

STALE: AS SHOWN SHEET 1 OF 4 SHEETS

	STATION	OFFSET	ELEVATION
Α	151+19.41	18.04' L	(858.82)
В	151+15.10	18.03' L	(858.72)
С	151+10.56	18.37' L	(858.83)
D	151+05.44	18.15' L	(858.89)
E	151+05.54	13.42' L	(858.84)
F	151+09.86	13.42' L	858.58
G	151+17.39	12.94' L	858.46
Н	151+19.85	12.94' L	(858.72)
I	151+09.89	11.77' L	(858.58)
J	151+17.92	11.43' L	(858.46)
K	151+30.97	11.43' R	(858.18)
L	151+23.98	11.77' R	(858.38)
М	151+17.84	13.62' R	(858.96)
N	151+24.63	13.32' R	858.44
0	151+32.45	13.18' R	858.18
Р	151+37.31	13.20' R	(858.38)
Q	151+37.28	20.41' R	(858.31)
R	151+30.30	23.36' R	(858.52)


OTHER SIDEWALK SLOPES			
FROM POINT	TO POINT	SLOPE	
В	G	4.53%	
С	F	4.99%	
Q	Р	-0.97%	
R	M	-2.92%	

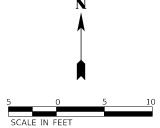

KNIGHT

NOTES

1. PRIOR TO THE REMOVAL OF SIDEWALK, THE CONTRACTOR WHERE THE PROPOSED WORK WILL MEET EXISTING. THE CONTRACTOR SHALL IMMEDIATELY NOTIFY THE ENGINEER IF ANY DISCREPANCIES WITH THE ELEVATIONS

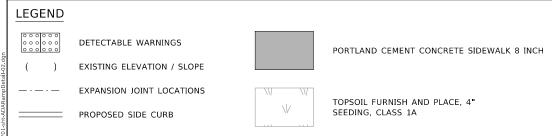

SHALL SURVEY THE SIDEWALK ELEVATIONS AT LOCATIONS SHOWN ARE ENCOUNTERED. 2. EXPANSION JOINT LOCATIONS ARE APPROXIMATE. THE CONTRACTOR SHALL IDENTIFY LOCATIONS IN THE FIELD AND RECEIVE APPROVAL FROM THE RESIDENT ENGINEER. USER NAME = Ilugo DESIGNED - JM REVISED SIDEWALK DETAIL PLAN DRAWN -REVISED NORTHERN ILLINOIS UNIVERSITY UNIVERSITY CIRCLE NORTH CHECKED - LL REVISED PLOT DATE = 6/1/2021 SCALE: AS SHOWN SHEET 2 OF 4 SHEETS REVISED

COMB CC&G TB6.12 (SPECIAL) —

- COMB CC&G TB6.12 (SPECIAL)

FAU RTE 5336

SECTION

08-00003-00-PV


COUNTY

DeKa**l**b 31 20

CONTRACT NUMBER: 87754

	STATION	OFFSET	ELEVATION
Α	100+50.35	21.50' R	(856.12)
В	100+61.60	20.85' R	(855.86)
С	100+48.88	15.59' R	(856.35)
D	100+52.21	15.49' R	855.92
Е	100+62.84	15.04' R	855.69
F	100+64.86	14.91' R	(855.83)
G	100+54.79	13.63' R	(855.92)
Н	100+63.03	13.30' R	(855.69)
I	100+85.25 12.96' L		(855.59)
J	100+78.82 12.35' L		855.33
K	100+67.55	11.56' L	855.68
L	100+61.08	11.27' L	(856.29)
М	100+77.46	10.69' L	(855.33)
N	100+66.70	9.96' L	(855.68)
0	100+79.97 26.90' L		(856.17)
Р	100+87.62	21.86' L	(855.72)

OTHER SIDEWALK SLOPES			
FROM POINT	TO POINT	SLOPE	
Α	С	(-3.74%)	
В	F	(0.43%)	
F	E	6.22%	
P	I	(1.42%)	
0	L	(-0.54%)	

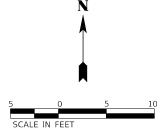


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LEGEND | OCCUPATION | DETECTABLE WARNINGS | PORTLAND CEMENT CONCRETE SIDEWALK 8 INCH | OCCUPATION | OCCUPAT

KNIGHT		
Engineers	&	Architects


	USER NAME = Ilugo	DESIGNED - JM	REVISED -	ĺ
s		DRAWN - JM	REVISED -	
	PLOT SCALE = 1:10	CHECKED - LL	REVISED -	
	PLOT DATE = 6/1/2021	DATE -	REVISED -	

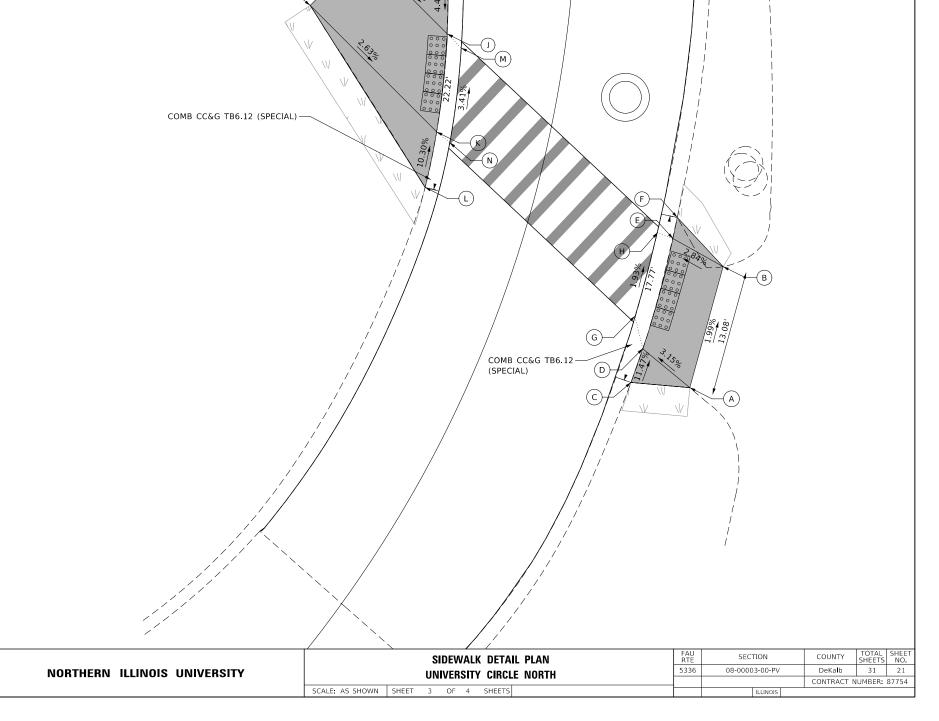

101

	STATION OFFSET 101+96.95 27.20' L		ELEVATION
А			(854.90)
В	101+91.69	24.68' L	(854.72)
С	101+94.29	19.27' L	854.60
D	101+99.54	21.79' L	854.78
E	101+94.16	14.50' L	(853.97)
F	101+96.92	13.38' L	853.65
G	101+97.06	12.94' L	(853.65)
Н	102+03.78	12.96' L	(853.61)
I	102+03.58	13.38' L	853.61
J	102+04.89	14.49' L	(853.85)
K	102+08.05	13.04' R	(853.63)
L	102+00.00	13.02' R	(853.70)
М	101+95.57	14.26' R	(853.94)
N	102+00.10	14.09' R	853.70
0	102+08.16	13.78' R	853.63
Р	102+09.82	20.72' R	(853.82)
Q	102+08.37	102+08.37 20.78' R	
R	102+02.37	21.00' R	(853.78)
S	101+95.83	21.25' R	(853.85)
Т	102+09.56	13.72' R	(853.88)


OTHER SIDEWALK SLOPES				
FROM POINT	TO POINT	SLOPE		
D	J	12.70%		
С	E	13.20%		
Р	Т	(-0.86%)		
T	0	2.14%		
Р	Q	1.37%		

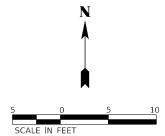


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	LEGEND				
۔	000000	DETECTABLE WARNINGS		PORTLAND CEMENT CONCRETE SIDEWALK 8 INCH	
ail-04.dgn	()	EXISTING ELEVATION / SLOPE			
ampDet		EXPANSION JOINT LOCATIONS	\\\	TORCOL FURNICH AND DIACE. All	
E\$ ht-ADARa		PROPOSED SIDE CURB	V	TOPSOIL FURNISH AND PLACE, 4" SEEDING, CLASS 1A	
NAMES 701-sht					

LE WARNINGS ELEVATION / SLOPE			PORTLAND CEMENT CONCR	EETE SIDEWALK 8 INCH		
N JOIN ⁻	T LOCATIONS	W	N .	TOPSOIL FURNISH AND PLA SEEDING, CLASS 1A	CE, 4"	
	USER NAME = Ilugo		DESIG	NED - JM	REVISED -	
			DRAW	/N - JM	REVISED -	
cts	PLOT SCALE = 1:10		CHECKED - LL		REVISED -	
	PLOT DATE = 6/1/2021		DATE -		REVISED -	1



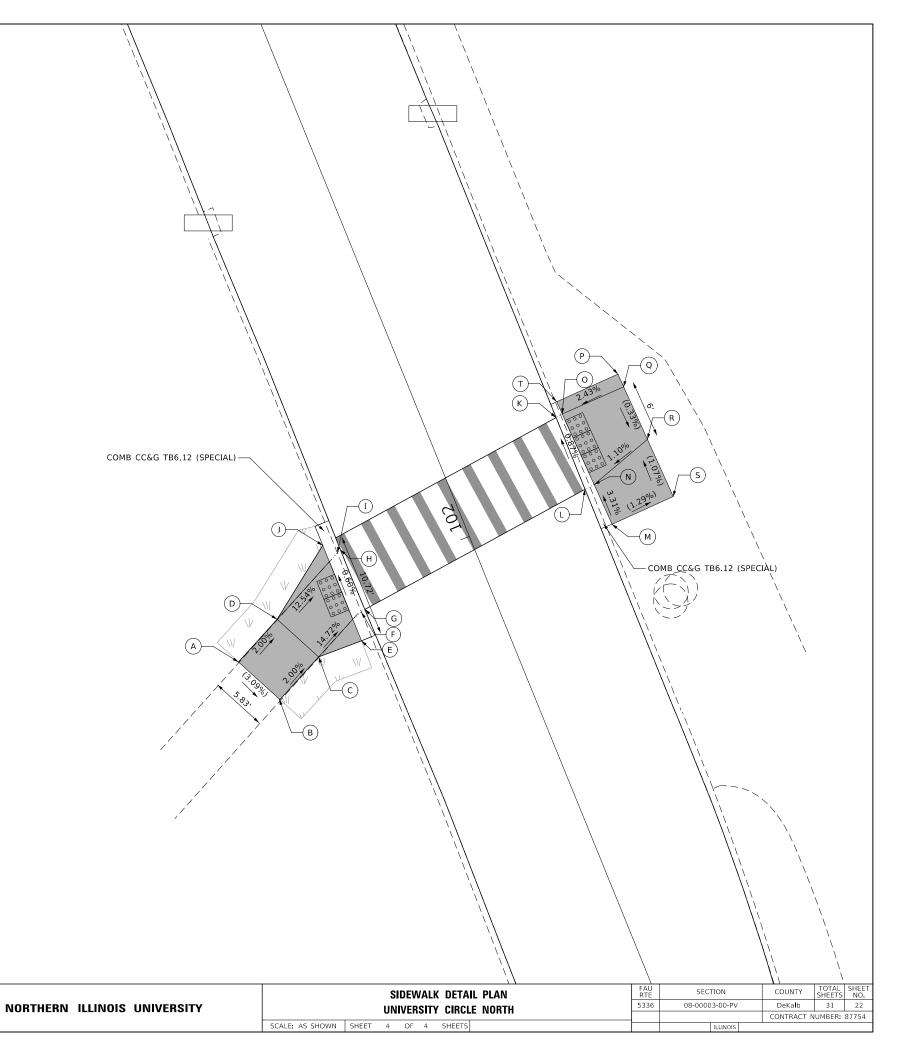


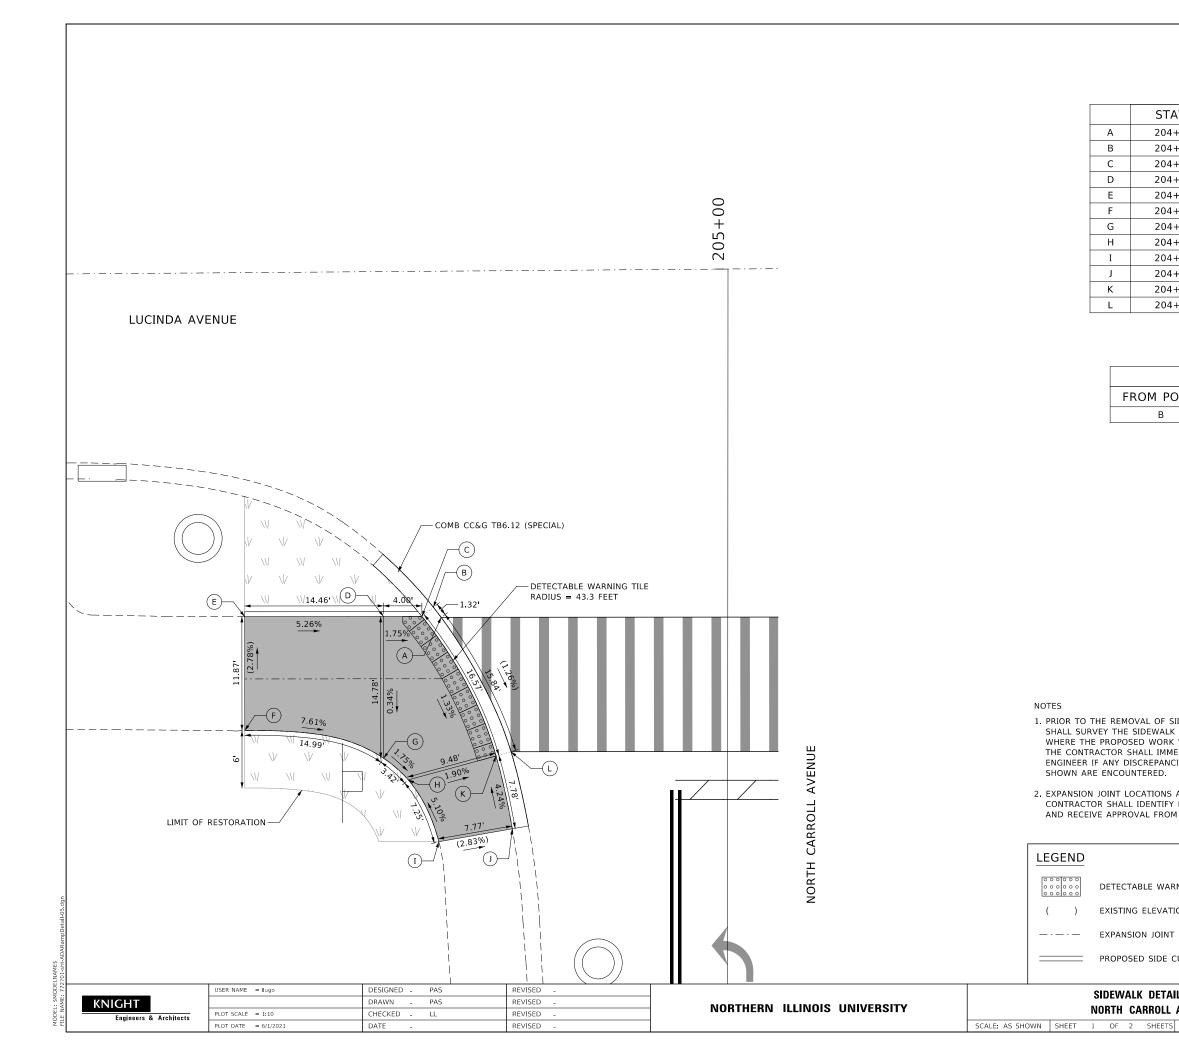	STATION	OFFSET	ELEVATION
Α	204+63.70	29.86' L	(855.23)
В	204+64.75	30.66' L	(855.25)
С	204+63.79	31.87' L	855.25
D	204+63.79	35.87' L	855.32
E	204+63.77	50.33' L	(856.08)
F	204+51.90	50.31' L	(856.41)
G	204+49.01	35.85' L	855.27
Н	204+46.76	33.28' L	855.21
I	204+40.33	30.09' L	855.58
J	204+41.67	22.44' L	855.36
K	204+49.26	24.14' L	855.03
L	204+49.71	22.58' L	(855.03)

OTHER SIDEWALK SLOPES					
FROM POINT TO POINT SLOPE					
В	А	(1.52%)			


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NORTH CARROLL AVENUE

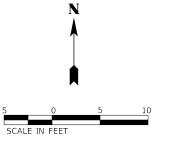

DeKa**l**b 31 23

CONTRACT NUMBER: 87754

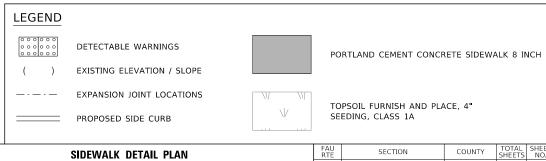


5336


08-00003-00-PV

	STATION	OFFSET	ELEVATION
Α	204+49.76	21.57' R	(854.92)
В	204+49.24	23.06' R	854.92
С	204+44.36	21.95' R	855.25
D	204+40.27	21.30' R	855.45
E	204+33.91	20.83' R	(855.21)
F	204+47.23	28.73' R	855.33
G	204+39.60	26.59' R	855.55
Н	204+33.71	24.94' R	(855.44)
I	204+45.07	34.84' R	855.45
J	204+38.72	33.48' R	855.68
K	204+33.61	32.99' R	(855.77)
L	204+61.39	50.60' R	(856.39)
М	204+54.66	41.13' R	855.67
N	204+66.79	48.20' R	(856.30)
0	204+59.36	36.22' R	855.56
Р	204+72.29	45.76' R	(856.30)
Q	204+68.07	37.21' R	(855.87)
R	204+63.51	31.90' R	855.18
S	204+64.72	30.63' R	(855.18)
Т	204+63.77	29.75' R	(855.16)

OTHER CIRCUMALIK CLOREC						
OTHE	OTHER SIDEWALK SLOPES					
FROM POINT TO POINT SLOPE						
S	(1.54%)					
Q	0	3.54%				
С	6.60%					
F	1.09%					
D	С	4.83%				


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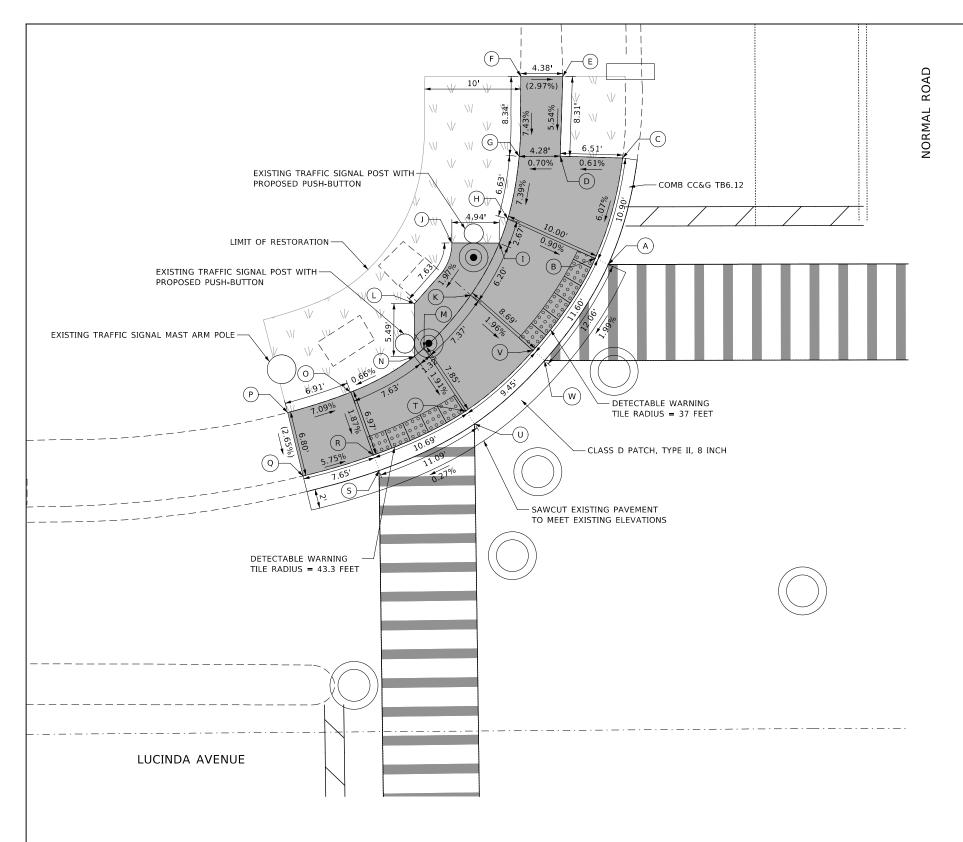


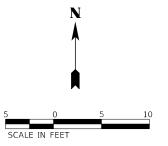

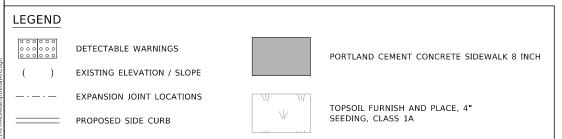KNIGHT		
Engineers	&	Architects

	USER NAME = Ilugo	DESIGNED - PAS	REVISED -
		DRAWN - PAS	REVISED -
ets	PLOT SCALE = 1:10	CHECKED - LL	REVISED -
	PLOT DATE = 6/1/2021	DATE -	REVISED -



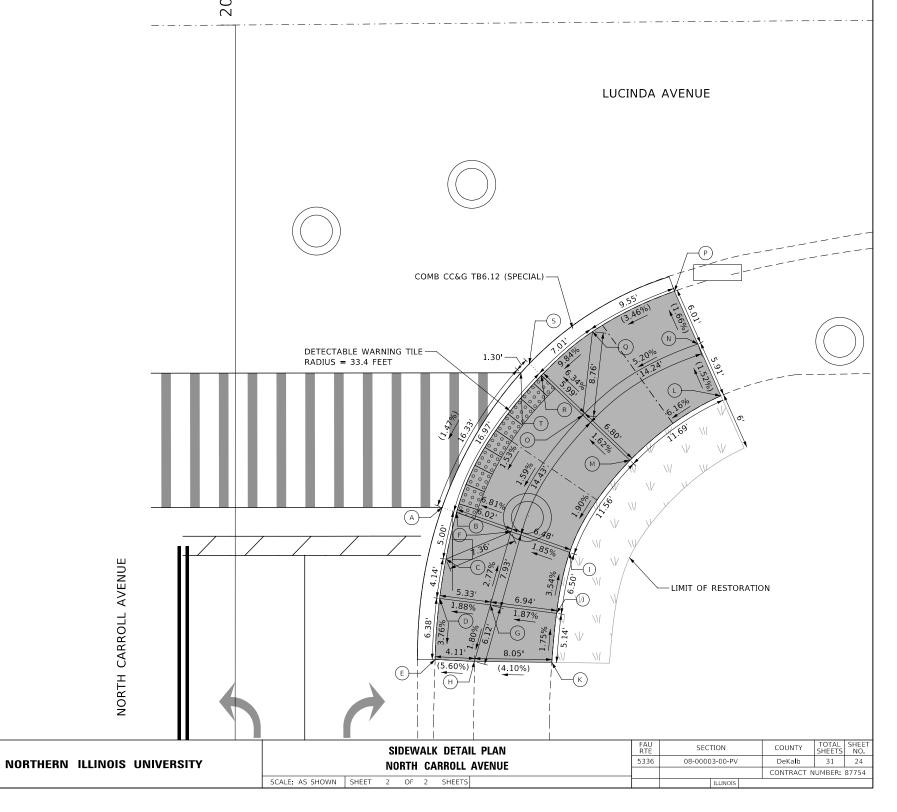


	NORTHING	EASTING	ELEVATION
Α	1919757.29	866572.35	(859.68)
В	1919757.91	866570.99	859.67
С	1919768.38	866573.85	(860.34)
D	1919768.57	866567.35	860.30
E	1919776.88	866567.62	(860.76)
F	1919776.88	866563.24	(860.89)
G	1919768.55	866563.07	860.27
Н	1919762.03	866561.88	859.78
I	1919759.52	866561.00	859.73
J	1919759.54	866556.06	859.71
K	1919754.09	866558.02	859.61
L	1919753.21	866552.18	859.56
М	1919748.57	866553.17	859.47
N	1919747.72	866552.15	859.46
0	1919743.99	866545.53	859.41
Р	1919741.86	866538.96	(859.90)
Q	1919735.26	866540.57	(859.72)
R	1919737.44	866547.90	859.28
S	1919735.82	866548.48	(859.29)
Т	1919742.03	866557.52	859.32
U	1919740.68	866558.41	859.32
V	1919748.33	866564.53	859.44
W	1919747.28	866565.72	859,44

ОТНЕ	OTHER SIDEWALK SLOPES					
FROM POINT	FROM POINT TO POINT					
В	В V					
Н	I	1.87%				
I	J	0.40%				
I	K	1.94%				
K	М	1.90%				
М	N	0.76%				
L	N	1.82%				
Т	R	0.37%				

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LEGEND			
000000	DETECTABLE WARNINGS		PORTLAND CEMENT CONCRETE SIDEWALK 8 INCH
()	EXISTING ELEVATION / SLOPE		
	EXPANSION JOINT LOCATIONS	W	TORGON FURNISH AND BLACE AN
	PROPOSED SIDE CURB	W	TOPSOIL FURNISH AND PLACE, 4" SEEDING, CLASS 1A

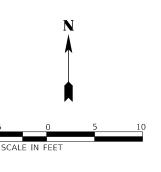

KNIGHT		
Engineers	&	Archited

	USER NAME = Ilugo	DESIGNED - PAS	REVISED -
leers & Architects		DRAWN - PAS	REVISED -
	PLOT SCALE = 1:10	CHECKED - MJM	REVISED -
	PLOT DATE = 6/1/2021	DATE -	REVISED -


NORTHERN ILLINOIS UNIVERSITY

	SIDEWALK			DETA	AIL PLAN		
LUCINDA		AVE	NUE	AND	NORMAL	ROAD	
SCALE: AS SHOWN	SHEET	1	OF	4	SHEETS		

FAU RTE	SECTION	COUNTY	TOTAL SHEETS	SHEET NO.
5336	08-00003-00-PV	DeKa l b	31	25
		CONTRACT N	UMBER:	87754
		•		

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NORTHERN ILLINOIS UNIVERSITY

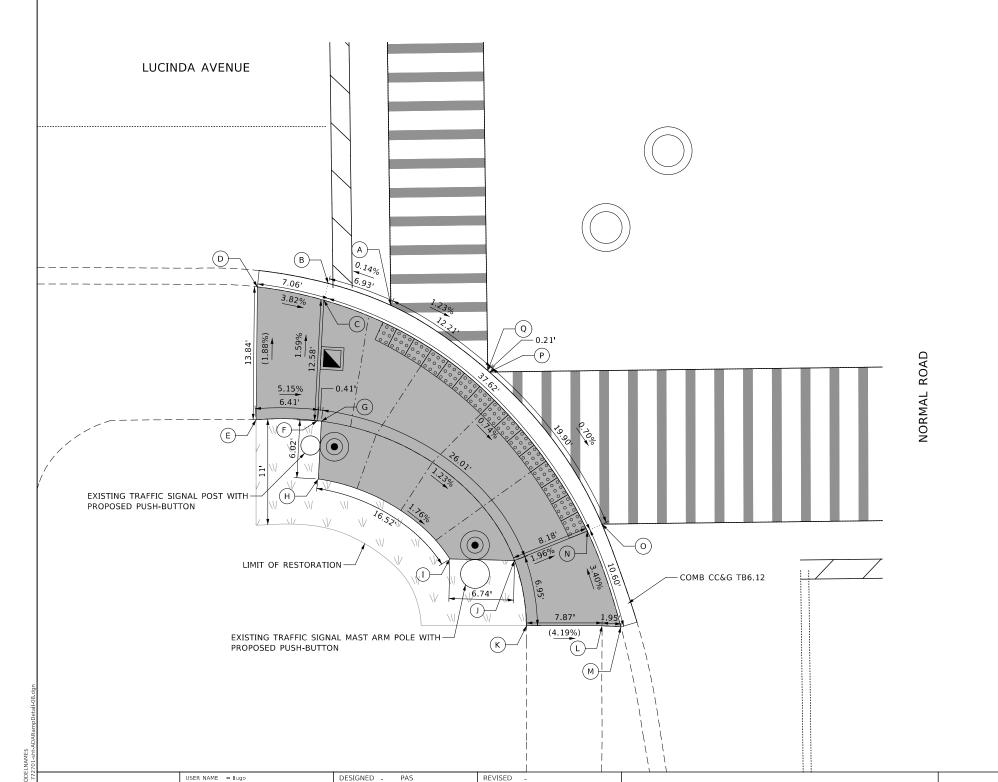

REVISED

REVISED

REVISED

DRAWN

PLOT DATE = 6/1/2021


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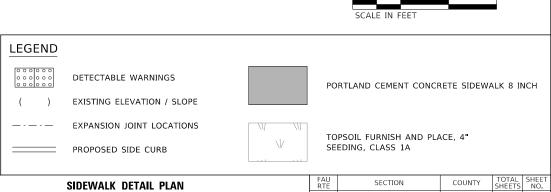
PAS

KNIGHT

	NORTHING	EASTING	ELEVATION
Α	1919680.95	866549.20	(859.27)
В	1919683.24	866542.67	(859.26)
С	1919681.49	866542,21	859.26
D	1919682.87	866535.29	(859.53)
E	1919669.04	866535.15	(859.79)
F	1919668.93	866541.54	859.46
G	1919669.04	866541.96	859.46
Н	1919662.87	866541.63	859.55
I	1919654.53	866555.34	859.26
J	1919654.37	866562.08	859.14
K	1919647.57	866563.34	(859.52)
L	1919647.57	866571.21	(859.19)
М	1919647.45	866573.15	(859.34)
N	1919657.44	866569.66	858.98
0	1919658.16	866571.18	(858.98)
Р	1919674.01	866559.45	(859.12)
Q	1919674.15	866559,29	(859.12)

OTHER SIDEWALK SLOPES				
FROM POINT TO POINT SLOPE				
G	F	1.50%		
Н	I	1.78%		
J	I	5.47%		
L	K	(7.69%)		



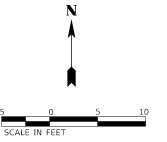

LUCINDA AVENUE AND NORMAL ROAD

SCALE: AS SHOWN SHEET 2 OF 4 SHEETS

5336

08-00003-00-PV


DeKalb 31 26

CONTRACT NUMBER: 87754

	NORTHING	EASTING	ELEVATION
Α	1919757.39	866619.15	(859.77)
В	1919758.04	866620.73	859.77
С	1919767.82	866618.01	(860.41)
D	1919769.59	866625.87	(860.48)
Е	1919773.17	866625.30	(860.60)
F	1919775.10	866627.94	(860.75)
G	1919780.98	866636.04	(861.06)
Н	1919772.14	866643.43	(860.88)
I	1919765.40	866635.87	860.42
J	1919761,11	866628.30	859.86
K	1919760.91	866630.58	859.87
L	1919754.61	866634.60	859.73
М	1919753.34	866633.08	859.70
N	1919748.43	866627.04	859.55
0	1919747.41	866625.78	859.55
Р	1919740.15	866633.05	859.74
Q	1919741.45	866634.12	859.74
R	1919747.62	866639.17	859.89
S	1919749.34	866640.36	859.93
Т	1919745.93	866646.91	860.07
U	1919743.79	866646.97	860.05
V	1919735.50	866643.62	859.96
W	1919734.08	866643.05	859.96
Х	1919731.83	866659,12	(860.75)
Y	1919742.65	866659.12	(860.91)
Z	1919742.65	866662.10	(860.97)
AA	1919758,53	866673.40	(861.50)
AB	1919768.02	866661.72	(861.38)
AC	1919752.92	866648.06	(860.42)

OTHE	OTHER SIDEWALK SLOPES			
FROM POINT	TO POINT	SLOPE		
К	J	0.44%		
К	L	1.87%		
L	М	1.52%		
S	┙	2.55%		
S	R	1.91%		
Т	S	1.89%		
Т	U	0.93%		
Е	D	(3.31%)		

OTHER SIDEWALK LENGTHS		
FROM POINT	TO POINT	LENGTH
J	K	2.29'
L	М	1.98'
R	S	2.09'
Т	U	2.14'

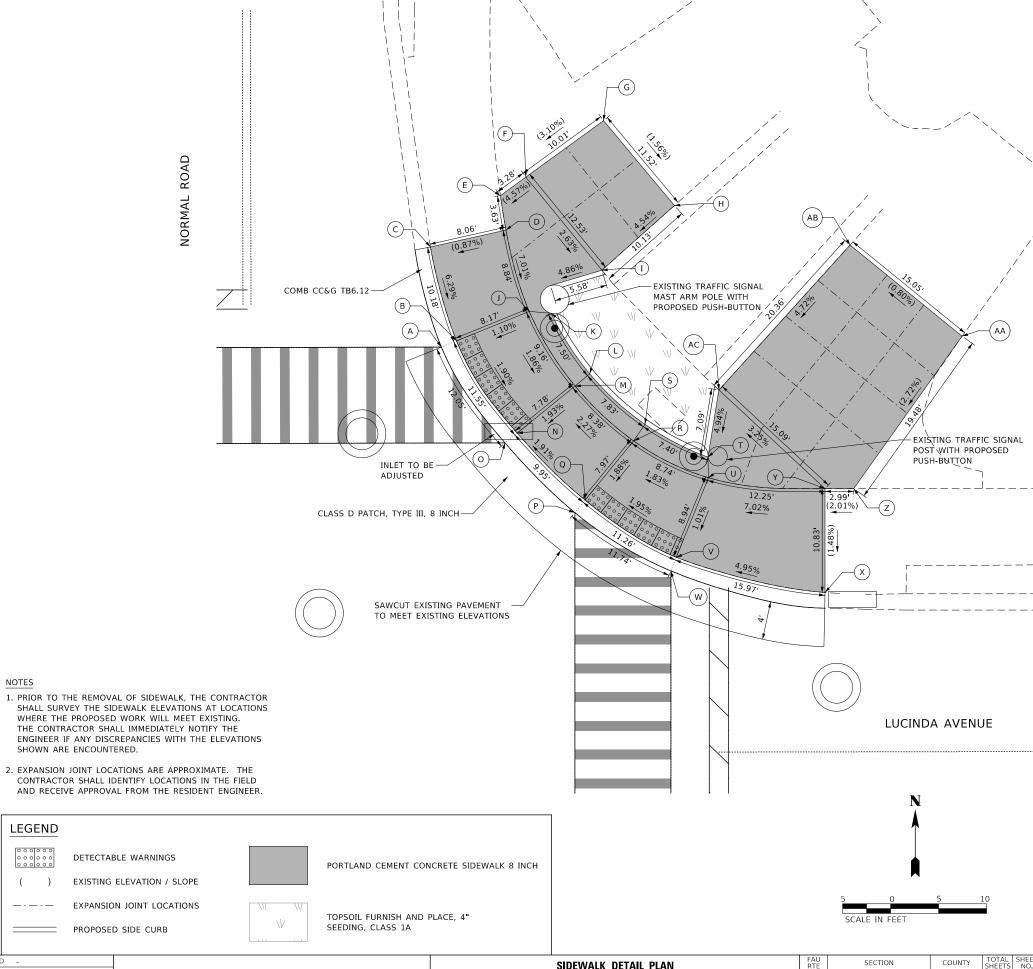

KNIGHT

USER NAME = Ilugo DESIGNED - PAS REVISED DRAWN PAS REVISED CHECKED -REVISED PLOT DATE = 6/1/2021

NOTES


LEGEND


NORTHERN ILLINOIS UNIVERSITY

SIDEWALK DETAIL PLAN 5336 08-00003-00-PV DeKa**l**b 31 27 LUCINDA AVENUE AND NORMAL ROAD CONTRACT NUMBER: 87754 SCALE: AS SHOWN SHEET 3 OF 4 SHEETS

	NORTHING	EASTING	ELEVATION
Α	1919658.74	866617.80	859.38
В	1919658.00	866619.24	859.38
С	1919650.27	866616.62	(859.50)
D	1919647.88	866627.62	(859.73)
Е	1919653.11	866628.80	859.58
F	1919656.38	866630.45	859.65
G	1919656.38	866634.27	859.72
Н	1919662.62	866644.55	859.95
I	1919662.55	866657.16	(860.97)
J	1919672.30	866657.07	(860.88)
K	1919672.43	866644.55	860.02
L	1919681.29	866644.55	860.08
М	1919683.06	866644.18	860.08
N	1919682.78	866643.05	860.06
0	1919677.99	866633.05	859.85
Р	1919674.88	866629.28	859.76


OTHER SIDEWALK SLOPES				
FROM POINT	TO POINT	SLOPE		
F	E	1.90%		
G	F	1.83%		
M	N	1.71%		

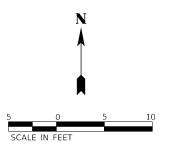

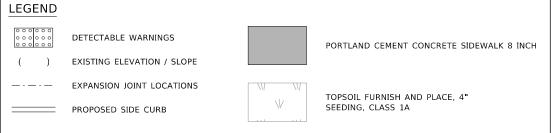

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LUCINDA AVENUE

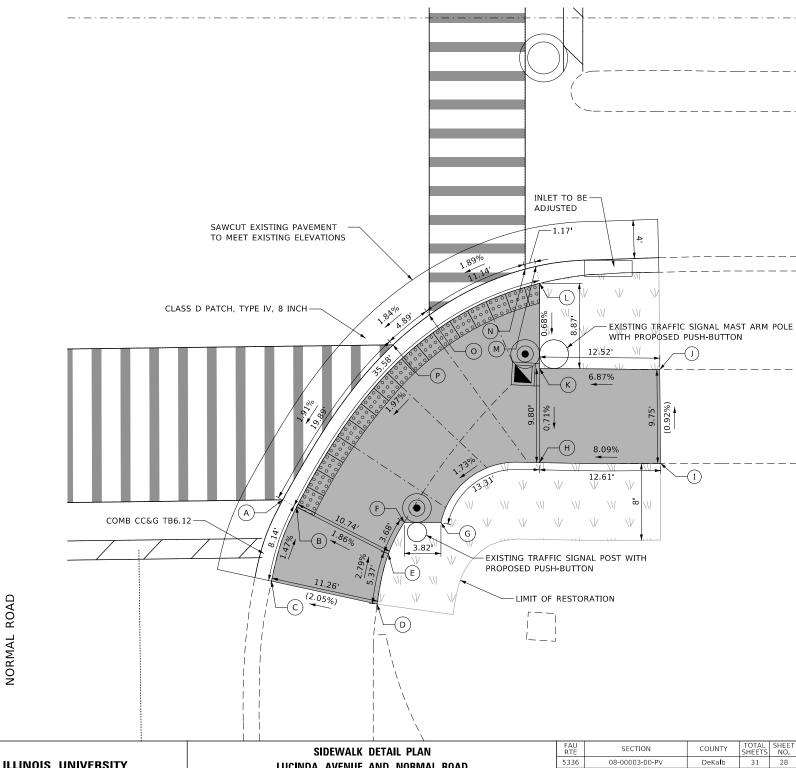

MODEL: \$MODELNAME\$

 KNIGHT
 USER NAME
 = Iliugo
 DESIGNED
 PAS
 REVISED

 Bragineers & Architects
 DRAWN
 PAS
 REVISED

 PLOT SCALE
 = 1:10
 CHECKED
 MJM
 REVISED

 PLOT DATE
 = 6/1/2021
 DATE
 REVISED

NORTHERN ILLINOIS UNIVERSITY

LUCINDA AVENUE AND NORMAL ROAD

SCALE: AS SHOWN SHEET 4 OF 4 SHEETS

STATE SHEETS NO.

SHEET NO.

SHEETS NO.

SHEET NO.

SHEET NO.

SHEET NO.


SHEET NO.

SHEET NO.


SHEETS NO.

SHEET NO.

SHEET

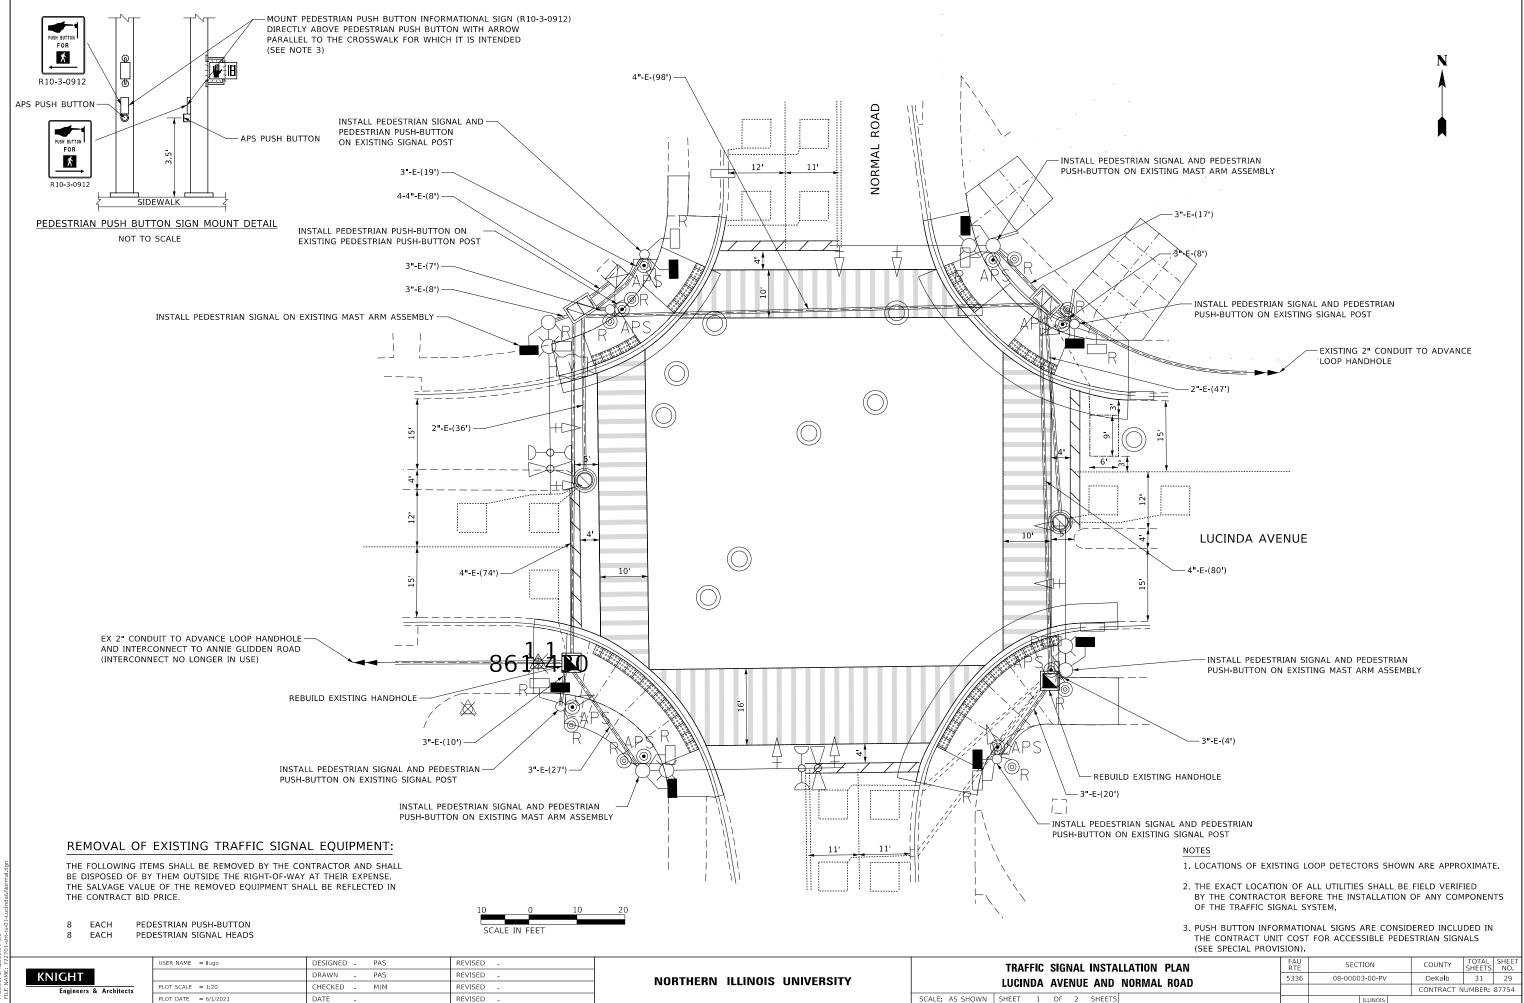

PLOT DATE = 6/1/2021 REVISED

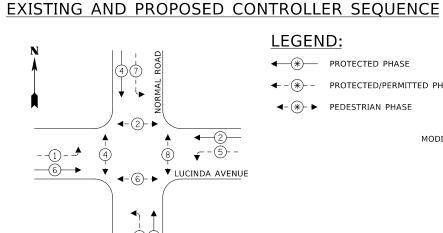

EXISTING AND PROPOSED

EMERGENCY VEHICLE

PREEMPTION SEQUENCE

LEGEND:

←(*)— PROTECTED PHASE

← - (*)- - PROTECTED/PERMITTED PHASE

◆- *- PEDESTRIAN PHASE

EXISTING INTERCONNECT TO ANNIE GLIDDEN ROAD (NO LONGER IN USE)

> TRAFFIC SIGNALS SCHEDULE OF QUANTITIES LUCINDA AVENUE AND NORMAL ROAD

MODIFY EXISTING CONTROLLER AND CABINET -

SEE NOTE 1

REMOVE EXISTING CABLE FROM CONDUIT

LUCINDA AVENUE

- VIDEO DETECTION SYSTEM D---(I

(ABANDONED, NO LONGER IN USE)

SEE NOTE 1-

ROAD

NORMAL

-SEE NOTE 1

LUCINDA AVENUE

SEE NOTE 1

LUCINDA AVENUE

4—(2)—

TRAFFIC SIGNAL **ELECTRICAL SERVICE REQUIREMENTS**

		NO. OF	LED	7.	IOTAL
TYPE		LAMPS	WATTAGE	OPERATION	WATTAGE
SIGNAL (F	RED)	12	11	50	66.0
(YELL	OW)	12	20	5	12.0
(GRE	EN)	12	12	45	64.8
PERMISSIVE ARE	ROW	16	10	10	16.0
PED. SIGNAL		8	20	100	160.0
CONTROLLER		1	100	100	100.0
UPS		-	25	100	-
VIDEO SYSTEM		1	150	100	150.0
BLANK-OUT SIG	N	-	25	5	-
FLASHER		-	-	50	-
STREET NAME S	SIGN	-	120	50	-
				TOTAL =	552.8

ENERGY COSTS TO:

CITY OF DEKALB 1216 MARKET STREET

ENERGY SUPPLY: CONTACT: NORA FERNANDEZ

COMPANY: COMMONWEALTH EDISON

ACCOUNT NUMBER:

KNIGHT

USER NAME = Ilugo	DESIGNED - PAS	REVISED -
	DRAWN - PAS	REVISED -
 PLOT SCALE = 1:40	CHECKED - MJM	REVISED -
PLOT DATE = 6/1/2021	DATE -	REVISED -

DETECTOR LOOP, TYPE I

PERMANENT TRAFFIC SIGNALTIMING

ACCESSIBLE PEDESTRIAN SIGNALS

ELECTRIC CABLE IN CONDUIT, SIGNAL NO. 14 2C

PEDESTRIAN SIGNAL HEAD, LED. 1-FACE, BRACKET MOLI

NORTHERN ILLINOIS UNIVERSITY

EACH

TRAFFIC SIGNAL CABLE PLAN, PHASE DESIGNATION DIAGRAM, AND EMERGENCY VEHICLE PREEMPTION SEQUENCE LUCINDA AVENUE AND NORMAL ROAD

SECTION COUNTY 5336 08-00003-00-PV DeKalb 31 30 CONTRACT NUMBER: 87754 SCALE: AS SHOWN SHEET 2 OF 2 SHEETS


NORMAL ROAD


1. LUMINAIRES ARE POWERED BY THE EXISTING STREET LIGHTING CONTROLLER AND NOT CONNECTED TO THE SIGNAL CONTROLLER CABINET.

CABLE PLAN (NOT TO SCALE)

DEKALB, ILLINOIS 60115

PHONE: (815) 490-2335

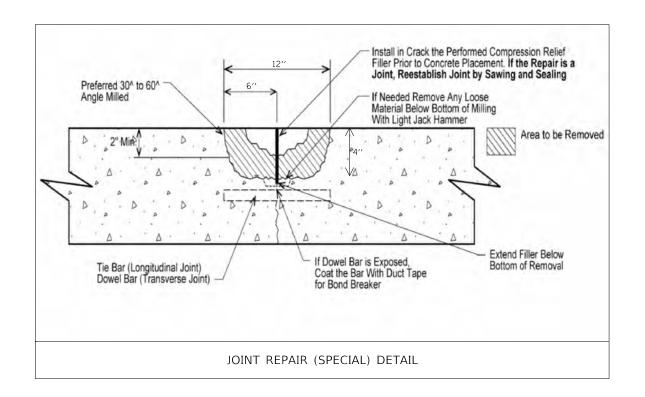

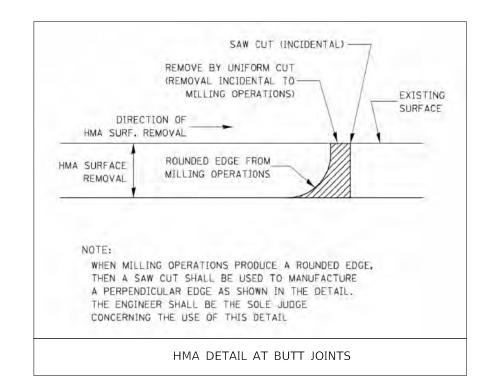

NAME: 772701-5h
NAME: 772701-5h
KNIGHT

USER NAME = Ilugo	DESIGNED -	ZRE	REVISED -
	DRAWN -	ZRE	REVISED -
PLOT SCALE = 1:2	CHECKED -	LL	REVISED -
PLOT DATE = 6/1/2021	DATE -	APRIL 2021	REVISED -

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