


TEMPORARY EROSION CONTROL NOTES

- 1. THE CONTRACTOR SHALL INSTALL PERIMETER EROSION BARRIER PRIOR TO STRIPPING OF VEGETATION.
- 2. TEMPORARY DITCH CHECKS SHALL BE INSTALLED IMMEDIATELY AFTER GRADING IS COMPLETED. DITCH CHECKS ARE BASED ON ONE (1) INSTALLATION AND THREE (3) REPLACEMENTS OVER THE DURATION OF THE CONTRACT. THESE ITEMS WILL BE PAID FOR AS EACH, REGARDLESS OF THE TYPE OF CONFIGURATION USED.
- 3. RUNOFF FROM EXCAVATION AREAS SHALL LEAVE THE SITE THROUGH SEDIMENT CONTROL DEVICES. THE CONTRACTOR SHALL ADJUST HIS OPERATION AND IMPLEMENT EROSION CONTROL MEASURES ACCORDINGLY.
- 4. THE CONTRACTOR SHALL SURROUND ANY NECESSARY EARTH STOCKPILES WITH PERIMETER EROSION BARRIER.
- 5. THE CONTRACTOR SHALL MAINTAIN ALL EROSION CONTROL DEVICES AT ALL TIMES. EROSION CONTROL DEVICES SHALL BE INSPECTED EVERY SEVEN CALENDAR DAYS OR WITHIN 24 HOURS AFTER A 13 MM (0.5 INCH) RAINFALL OR SNOWFALL.
- 6. THE CONTRACTOR SHALL SEED ALL DISTURBED AREAS AS SOON AS PRACTICAL AFTER CONSTRUCTION ACTIVITIES IN THAT AREA HAVE BEEN CONCLUDED. AREAS THAT HAVE STEEP SLOPES OR WILL NOT RECIEVE PERMANENT LANDSCAPING SHALL BE TEMPORARILY SEEDED. ALL FLATTER AREAS OR AREAS WHERE NO FURTHER WORK IS TO OCCUR FOR ONE MONTH OR MORE SHALL BE SEEDED AND PERIMETER EROSION CONTROL BLANKET WITHIN SEVEN (7) CALENDAR DAYS.

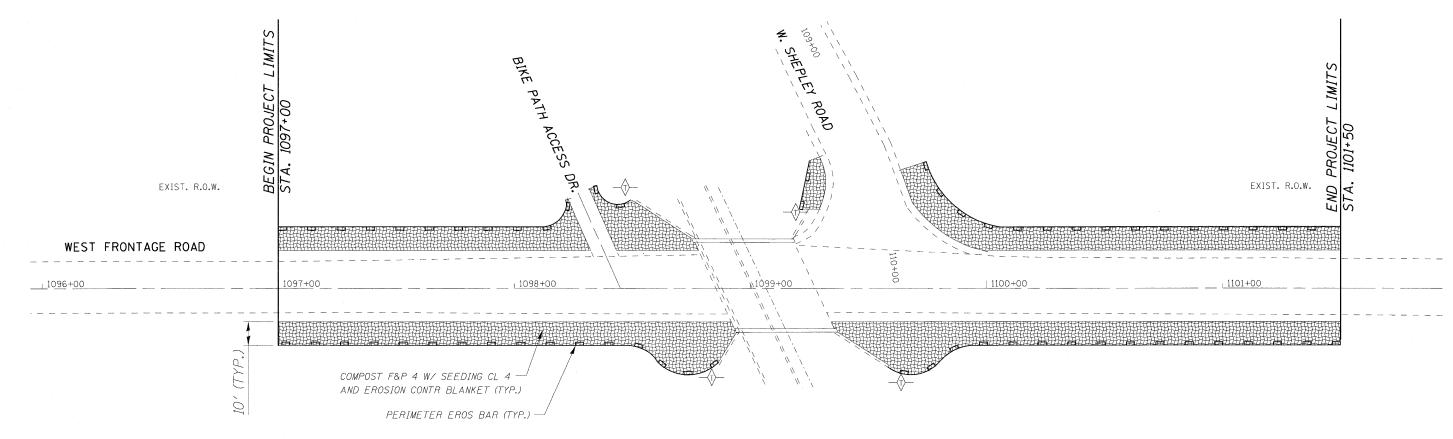

TEMPORARY EROSION CONTROL SEQUENCE OF CONSTRUCTION

- 1. ESTABLISH TEMPORARY EROSION CONTROL AND ERECT PERIMETER EROSION CONTROL BARRIER AS SHOWN ON THE THE PLANS PROIR TO EARTHWORK.
- 2. IMPLEMENT SEDIMENT AND EROSION CONTROL DEVICES FOR STOCKPILE AREAS AS REQUIRED.
- 3. CONSTRUCT CONSTRUCTION STAGING OF PROPOSED DRAINAGE FACILITIES AND INSTALL TEMPORARY DITCH CHECKS IMMEDIATELY AFTER DITCH GRADING IS COMPLETED.
- 4. INSTALL PERMANENT LANDSCAPING IN CONJUNCTION WITH CONSTRUCTION STAGING.
- 5. CLEAN DRAINAGE FACILITIES AND REMOVE TEMPORARY EROSION DEVICES WITHIN 30 DAYS AFTER FINAL SITE STABILIZATION IS ACHIEVED.

LEGEND

COMPOST FURNISH AND PLACE, 4"
W/ SEEDING, CL 4 AND EROSION
CONTROL BLANKET

- TEMPORARY DITCH CHECK (STD 280001-04)

0' 10' 20' 40' SCALE: 1''= 20'

	USER NAME = \$USER\$	DESIGNED - MJY			EROSION CONTROL PLAN		F.A.I.	SECTION	COUNTY TOTAL	
		DRAWN - ST	REVISED -	STATE OF ILLINOIS	I-55 WEST FRONTAGE ROAD OVER (I & M) CANAL			55	86 B-3-R	WILL 38
CONSULTING ENGINEERS 1560 WALL ST, SUITE 222	PLOT SCALE = \$SCALE\$	CHECKED - MJY	REVISED -	DEPARTMENT OF TRANSPORTATION					D-91-097-09	CONTRACT NO. 60
NAPERVILLE, ILLINOIS 60563 PH: (630) 577-9100	PLOT DATE = \$DATE\$	DATE - 07/08/2009	REVISED -		SCALE: 1" = 20'	SHEET NO. 10 OF 38 SHEETS	STA. 1097+00 TO STA. 1101+50	FED. ROAD DIST. NO. ILLINOIS FED. AID PROJECT		ID PROJECT