
STATE OF ILLINOIS

DEPARTMENT OF TRANSPORTATION

DIVISION OF HIGHWAYS

PROPOSED HIGHWAY PLANS

FAP ROUTE 510 (IL 96) SECTION 120 (I-6) PROJECT: ACF - 0510(035) **HANCOCK COUNTY** C-96-124-10

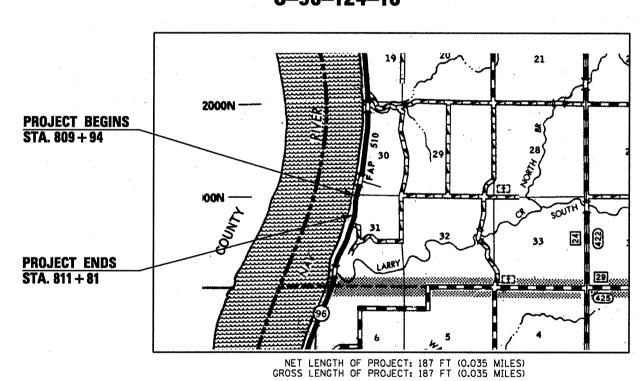



F.A.P. SECTION 510 120 (I-6) COUNTY HANCOCK 13 1



STATE OF ILLINOIS **DEPARTMENT OF TRANSPORTATION**

PRINTED BY THE AUTHORITY OF THE STATE OF ILLINOIS

TRAFFIC DATA

ADT (2002) 1,650 (6% MU + SU)


INDEX OF SHEETS

GENERAL NOTES, COMMITMENTS & MIX DESIGN SUMMARY OF QUANTITIES TYPICAL SECTION SCHEDULE OF QUANTITIES ROADWAY PLAN TRAFFIC CONTROL DETAIL

PIN PILE DETAILS 11-13 SOIL BORINGS HIGHWAY STANDARDS

IDOT HIGHWAY STANDARDS

000001-05	635006-03	701311-0
001001-02	635011-02	701321-1
001006	701001-02	701901-0
280001-04	701006-03	704001-0
482011-03	701011-02	780001-0
630001-08	701201-03	781001-0
635001-01	701301-03	

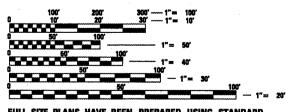

ENGINEERING SCALES. REDUCED SIZED PLANS WILL NOT CONFORM TO STANDARD SCALES, IN MAKING MEASUREMENTS ON REDUCED PLANS, THE ABOVE SCALES MAY BE USED.

J.U.L.I.E.

JOINT UTILITY LOCATION INFORMATION FOR EXCAVATION 1-800-892-0123

CONTRACT NO. 72852

FAP ROUTE 510 (IL 96) SECTION 120 (I-6)



PLANS PREPARED BY

141 MARKET PLACE SUITE 208 - FAIRVIEW HEIGHTS, ILLINOIS 62208 5200 OAKLAND AVENUE . ST. LOUIS, MISSOURI 63110 www.hornershifrin.com

HANCOCK COUNTY

GENERAL NOTES

 THE CONTRACTOR SHALL BE RESPONSIBLE FOR PROTECTING UTILITY PROPERTY FROM CONSTRUCTION OPERATIONS AS OUTLINED IN ARTICLE 107.31 OF STANDARD SPECIFICATION. THE J.U.L.I.E. NUMBER IS 1-800-892-0123.

THE LOCATION OF ALL UTILITIES ARE BASED ON INFORMATION PROVIDED BY OTHERS AND ARE INTENDED TO BE APPROXIMATE. IT SHALL BE THE CONTRACTOR'S RESPONSIBILITY TO COORDINATE HIS CONSTRUCTION ACTIVITIES WITH THE VARIOUS UTILITY OWNERS. ALL POTENTIAL CONFLICTS SHALL BE INVESTIGATED AND REMEDIAL ACTION TAKEN PRIOR TO INTERRUPTION OF THE CONTRACTOR'S PROGRESS.

ALL UTILITY FACILITIES THAT REQUIRE RELOCATION WITHIN STATE R.O.W. SHALL BE COMPLETED BY THE UTILITY COMPANY UNLESS OTHERWISE SHOWN ON THE PLANS.

- 2. IN ADDITION TO FIELD SURVEYS AND AERIAL SURVEYS, PLAN DIMENSIONS AND DETAILS RELATIVE TO EXISTING FACILITIES HAVE BEEN TAKEN FROM EXISTING PLANS AND ARE SUBJECT TO CONSTRUCTION VARIATIONS. IT SHALL BE THE CONTRACTOR'S RESPONSIBILITY TO VERIFY SUCH DIMENSIONS AND DETAILS IN THE FIELD. SUCH VARIATIONS SHALL NOT BE CAUSE FOR ADDITIONAL COMPENSATION DUE TO CHANGE IN THE SCOPE OF WORK, HOWEVER, THE CONTRACTOR WILL BE PAID FOR THE QUANTITY ACTUALLY FURNISHED AT THE UNIT PRICE BID FOR
- 3. ALL STATIONS AND OFFSET REFERENCES ARE TO THE ROADWAY CENTERLINE (IL 96) UNLESS OTHERWISE NOTED. THE STATE PLANE COORDINATE SYSTEM HAS BEEN USED FOR THE HORIZONTAL CONTROL.
- ALL ELEVATIONS SHOWN ON THE PLANS ARE BASED ON U.S.G.S. MEAN SEA LEVEL DATUM.
- 5. ANY REFERENCE WITHIN THESE PLANS TO A STANDARD SHALL BE INTERPRETED TO MEAN THE EDITION INDICATED BY THE SUB-NUMBER LISTED ON THE PREVIOUS SHEET OR THE COPY INCLUDED IN THESE PLANS.
- THE ENGINEER SHALL BE THE SOLE JUDGE CONCERNING CURING TIME FOR THE VARIOUS BITUMINOUS LIFTS.
- 7. ANY EARTH DISTURBED SHALL BE SEEDED, FERTILIZED, AND MULCHED TO THE SATISFACTION OF THE ENGINEER. NO ADDITIONAL COMPENSATION WILL BE ALLOWED FOR COMPLYING WITH THIS REQUIREMENT.

8. FACTORS USED FOR ESTIMATING PLAN QUANTITIES ARE AS FOLLOWS AND SHALL NOT BE USED FOR THE BASIS OF FINAL QUANTITIES:

HMA CONCRETE SURFACE COURSE
ALL AGGREGATE
BITUMINOUS MATERIALS:
PRIME COAT FOR BITUMINOUS CONCRETE:
- ON PAVEMENT
- ON AGGREGATE
0.056 TON/SQ YD/IN
2.05 TON

0.056 TON/SQ YD/IN

TON/SQ YD

0.002

THE QUANTITY OF SHORT TERM PAVEMENT MARKING SHOWN IN THE PLANS IS BASED ON ONE APPLICATION EACH FOR THE BINDER COURSE AND SURFACE COURSE.

HMA CONCRETE BASE COURSE

- AGGREGATE (PRIME COAT)

- 10. THE DISTRICT BUREAU OF OPERATIONS SHALL BE NOTIFIED AT LEAST 14 DAYS PRIOR TO PLACEMENT OF FINAL PAVEMENT MARKINGS PH: (217) 782-7314.
- 11. WHERE PROPOSED CONSTRUCTION ABUTS EXISTING APPURTENANCES, A SAW CUT SHALL BE MADE TO ACHIEVE A NEAT BUTT JOINT. ALL SAWED JOINTS FOR REMOVALS AND BUTT JOINTS SHALL BE CONSIDERED INCLUDED IN ITEM BEING REMOVED OR CONSTRUCTED.
- 12. A GEOTECHNICAL REPORT HAS BEEN PREPARED FOR THIS PROJECT AND IS AVAILABLE FOR REVIEW PRIOR TO BID AT THE DISTRICT OFFICE. CONTACT THE DISTRICT GEOTECHNICAL ENGINEER AT (217) 782-6709.

DISTRICT SIX	× 11.
EXAMPLED August 10	20 09
OPERATIONS ENGINEER	
EXAMINED A 12	20 09
PROGRAM IMPLEMENTATION ENGINE	EER
EXAMINED August 10	20 <u>09</u>
PROGRAM DEVELOPMENT ENGINEER	

F.A.P. RTE.	SECTION		COUNTY	TOTAL	SHEET NO.
510	120 (1-	6)	HANCOCK	13	2
STA.		то	STA.		:
FED. ROAD	DIST. NO.	ILLINOIS	FED. AID	PROJECT	
		٠	STATE CON	TRACT NO	. 7285

COMMITMENTS

NONE

MIX DESIGN

LOCATION(S):	
MIXTURE USE(S):	HMA SURFACE
AC / PG:	PG 64-22
DESIGN AIR VOIDS:	4.0% @ N DESIGN = 50
MIXTURE COMPOSITION:	IL 9.5 OR 12.5
(GRADATION MIXTURE)	·
FRICTION AGGREGATE:	MIX C

LOCATION(S):	
MIXTURE USE(S):	LEVEL BINDER (MACHINE METHOD)
AC / PG:	PG 64-22
DESIGN AIR VOIDS:	4.0% @ N DESIGN = 50
MIXTURE COMPOSITION:	IL 9.5
(GRADATION MIXTURE)	
FRICTION AGGREGATE:	N/A ·

LOCATION(S):	
MIXTURE USE(S):	HMA BASE COURSE
AC / PG:	PG 64-22
DESIGN AIR VOIDS:	4.0% @ N DESIGN = 50
MIXTURE COMPOSITION:	IL 19.0
(GRADATION MIXTURE)	
FRICTION AGGREGATE:	N/A

REVISIONS
NAME
DATE

GENERAL NOTES, COMMITMENTS & MIX DESIGN

F.A.P. 510 (IL 96)
HANCOCK COUNTY

SCALE: VERT. NONE
DATE 03/18/2004

DATE 03/18/2004

CHECKED BY SRD

CODE NUMBER	PAY ITEM	UNIT	RURAL HANCOCK CO. 80% FED 20% STATE Y009 26.0	
20200100	EARTH EXCAVATION	CU YD		
28000400	PERIMETER EROSION BARRIER	FOOT	200	
31100100	SUB-BASE GRANULAR MATERIAL, TYPE A	TON	110	
35501332	HOT-MIX ASPHALT BASE COURSE, 12"	SQ YD	212	
40600200	BITUMINOUS MATERIALS (PRIME COAT)	TON	0.5	
40600300	AGGREGATE (PRIME COAT)	TON	3.0	
40600625	LEVELING BINDER (MACHINE METHOD), N50	TON	25	
40600990	TEMPORARY RAMP	SQ YD	40	
40603310	HOT-MIX ASPHALT SURFACE COURSE, MIX "C", N50	TON	48	
44000198	HOT-MIX ASPHALT SURFACE REMOVAL, VARIABLE DEPTH	SQ YD	364	
44000100	PAVEMENT REMOVAL	SQ YD	101	
44000400	GUTTER REMOVAL	FOOT	125	
44004250	PAVED SHOULDER REMOVAL	SQ YD	84	
48101200	AGGREGATE SHOULDERS, TYPE B	TON	165	
63000002	STEEL PLATE BEAM GUARD RAIL, TYPE A, 6.75 FOOT POSTS	FOOT	212.5	
63200310	GUARDRAIL REMOVAL	FOOT	212.5	
67000500	ENGINEERS FIELD OFFICE, TYPE B	CAL MO	5	
67100100	MOBILIZATION	L SUM	1	
70101205	TRAFFIC CONTROL AND PROTECTION, STANDARD 701321 (SPECIAL)	EACH	1	
70100450	TRAFFIC CONTROL AND PROTECTION, STANDARD 701201	L SUM	1	
70103815	TRAFFIC CONTROL SURVEILLANCE	CAL DA	5	
70106500	TEMPORARY BRIDGE TRAFFIC SIGNALS	EACH	1	
70300100	SHORT-TERM PAVEMENT MARKING	FOOT	367	
70300230	TEMPORARY PAVEMENT MARKING - LINE 5"	FOOT	2932	
70301000	WORK ZONE PAVEMENT MARKING REMOVAL	SO FT	308	
70400100	TEMPORARY CONCRETE BARRIER	FOOT	350	
78001120	PAINT PAVEMENT MARKING - LINE 5"	FOOT	2932	
78200410	GUARDRAIL MARKERS, TYPE A	EACH	2	
78300100	PAVEMENT MARKING REMOVAL	SQ FT	746	
78300200	RAISED REFLECTIVE PAVEMENT MARKER REMOVAL	EACH	3	
X7200201	WIDTH RESTRICTION SIGNING	L SUM	1	
Z0030260	IMPACT ATTENUATORS, TEMPORARY (FULLY REDIRECTIVE, NARROW), TEST LEVEL 3	EACH	2	
X0326695	FURNISHING AND INSTALLING GROUTED PIN PILES	L SUM	1	

F.A.P. RTE.	SECTION	V (COUNT	Y	TOT/ SHEE	AL TS	SHEET NO.
510	120 (1-	6) 1	IANCO	K	13	П	3
STA.		TO	STA.		********		
FED. ROAD	DIST. NO.	ILLINOIS	FED.	AID	PROJE	CT	
·			STATE	CON	TRACT	NO.	72852

REVISIONS
NAME DATE

SUMMARY OF QUANTITIES

FAP ROUTE 510 (IL 96)


SECTION 120 (I-6)

HANCOCK COUNTY

* SPECIALTY ITEMS

SCALE: VERT, NONE DRAWN BY SSM
DATE 03/18/2004 CHECKED BY SRD

STATE CONTRACT NO. 7285

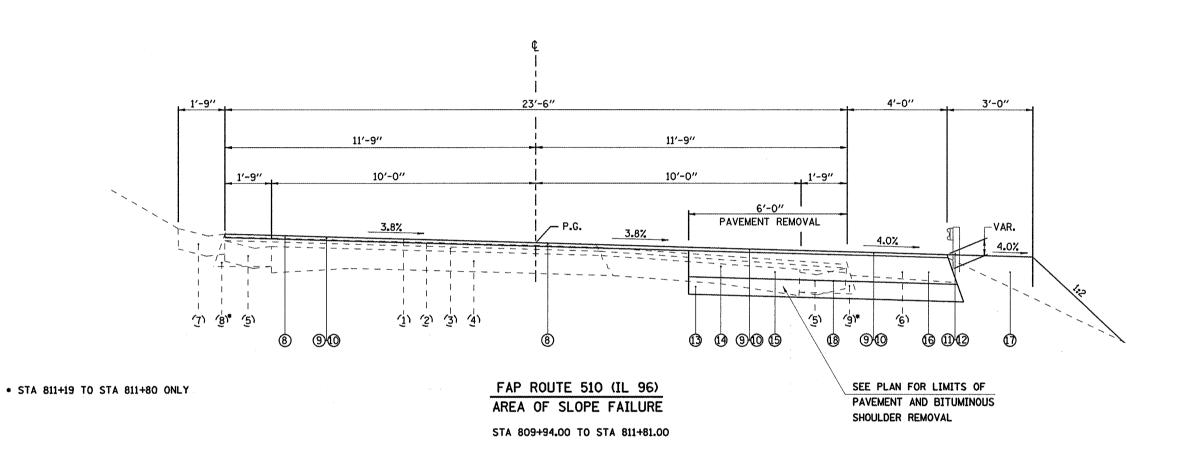

EXISTING MATERIAL LEGEND

- (1) EXISTING BITUMINOUS CONCRETE SURFACE COURSE
- (2) EXISTING BITUMINOUS CONCRETE BINDER COURSE, 134"
- (3) EXISTING LEVELING BINDER
- (4) EXISTING PAVEMENT
- (5) EXISTING GUTTER
- (6) EXISTING BITUMINOUS SHOULDER, 6"
- (1) EXISTING CONCRETE GUTTER TYPE B
- (8) EXISTING PCC BASE COURSE WIDENING, 9"

PROPOSED MATERIAL LEGEND

- (8) PROPOSED HMA SURFACE REMOVAL, VAR. DEPTH (21/4" TYP.)
- 9 PROPOSED LEVELING BINDER (MACHINE METHOD), N50, 3/4"
- 10 PROPOSED HMA SURFACE COURSE, MIX "C", N50, 11/2"
- 11) PROPOSED GUARDRAIL REMOVAL
- 12) PROPOSED STEEL PLATE BEAM GUARD RAIL, TYPE A
- 3 PROPOSED SUB-BASE GRANULAR MATERIAL, TYPE A, 8"
- PROPOSED HMA BASE COURSE, 12"
- (15) PROPOSED PAVEMENT REMOVAL
- 16 PROPOSED PAVED SHOULDER REMOVAL
- 17 PROPOSED AGGREGATE SHOULDERS, TYPE B
- (B) PROPOSED GUTTER REMOVAL (STA 809+94 TO STA 811+19)

REVISIONS
NAME DATE

ILLINOIS DEPARTMENT OF TRANSPORTATION

TYPICAL SECTION
FAP 510 (IL 96)
SECTION 120 (I-6)
HANCOCK COUNTY

SCALE: VERT. NONE

DRAWN BY SSM CHECKED BY SRD

			BITUI	MINOUS MATERI	ALS				
STATION TO STATION	LENGTH	WIDTH	HMA BASE COURSE, 12 IN.	LEVELING BINDER. (MACHINE METHOD). N50		BITUMINOUS MATERIALS (PRIME COAT)	AGGREGATE (PRIME COAT)	SUB-BASE GRANULAR MATERIAL, TY A	TEMPORARY RAMP
	FOOT	FOOT -	SQ. YD.	TON	TON	TON	TON	TON	SQ. YD.
809+94.00 TO 811+81.00	187	10	212	25	48	0.5	3. 0	110	
809+94.00									20
811+81.00									20
		TOTAL =	212	25	48	0.5	3.0	110	40

PAVEMENT MARKING									
STATION TO STATION	DESCRIPTION	LOCATION	PAINT PAVEMENT MARKING- LINE 5"	TEMPORARY PAVEMENT MARKING- LINE 5"	SHORT-TERM PAVEMENT MARKING (2 APPS)	WORK ZONE PAVEMENT MARKING REMOVAL	RAISED REFLECTIVE PAVEMENT MARKER REMOVAL	PAVEMENT MARKING REMOVAL	
			FOOT	F00T	FOOT	SQ FT	EACH	SQ FT	
807+17.50 TO 814+50.00	DOUBLE SOLID	CL	1466	1466					
807+17.50 TO 814+50.00	EDGE	LT, RT	1466	1466					
807+17.50 TO 814+50.00	DASHED	CL			147	25			
807+17.50 TO 814+50.00	DOUBLE SOLID	CL						611	
807+17.50 TO 809+17.50	EDGE	RT						84	
812+67.00 TO 813+90.00	EDGE	RT						51	
807+27.00 TO 809+94.00	EDGE	RT				111			
811+81.00 TO 813+90.00	EDGE	RT				87			
807+17.50; 814+50.00	STOP BAR					48			
809+94.00 TO 811+81.00		CL					3		
		TOTAL =	2932	2932	147	271	3	746	

EROSION CONTROL							
		PERIMETER					
LOCATION	OFFSET	EROSION					
LOCATION	OFFSEI	BARRIER					
		FOOT					
809+90.00 TO 811+90.00	RT	200					

	TOTAL =	200					

HMA SURFACE REMOVAL, VD						
STATION TO STATION	AREA					
	1	SQ. YD.				
809+94.00 TO 811+81.00	17.5	364				
	TOTAL =	364				

AGGREGATE SHOULDER			
STATION	STATION	LENGTH	AGG SHLDRS
			TON
809+94.00	811+81.00	187	165
		TOTAL =	165


REMOVAL ITEMS					
STATION	STATION	LENGTH	PAVEMENT REMOVAL	GUTTER REMOVAL	PAVED SHOULDER REMOVAL
			SQ YD	FOOT	SQ YD
809+94.00	811+81.00	187	101		84
809+94.00	811+19.00	125		125	
		TOTAL =	101	125	84


GUARDRAIL				
LOCATION	SIDE GUARDRAIL SPBGR, TYP FOOT FOOT	SPRGR TYPE		GUARDRAIL MARKERS, TYPE A
		FOOT	FOOT	EACH
809+77.50 TO 811+90.00	RT	212. 5	212.5	2
	TOTAL =	212, 5	212, 5	

TEMPORARY CONCRETE BARRIER			
		TEMPORARY	
LOCATION	SIDE	CONCRETE	
LOCATION		BARRIER	
		FOOT	
809+17.50 TO 809+67.50	RT	50	
809+67.50 TO 812+17.50	RT	250	
812+17.50 TO 812+67.50	RT	50	
	TOTAL =	350	

REVISION		ILLINOIS DEPARTMENT OF	TOANSDODTATIO	1M
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		SCHEDULE OF C		
		SECTION 120 HANCOCK CO		
		SCALE: VERT. NONE	DRAWN BY	SSM
		DATE 03/18/2004	CHECKED BY S	SRD

FED. ROAD DIST. NO. | ILLINOIS | FED. AID PROJECT | STATE CONTRACT NO. 72852

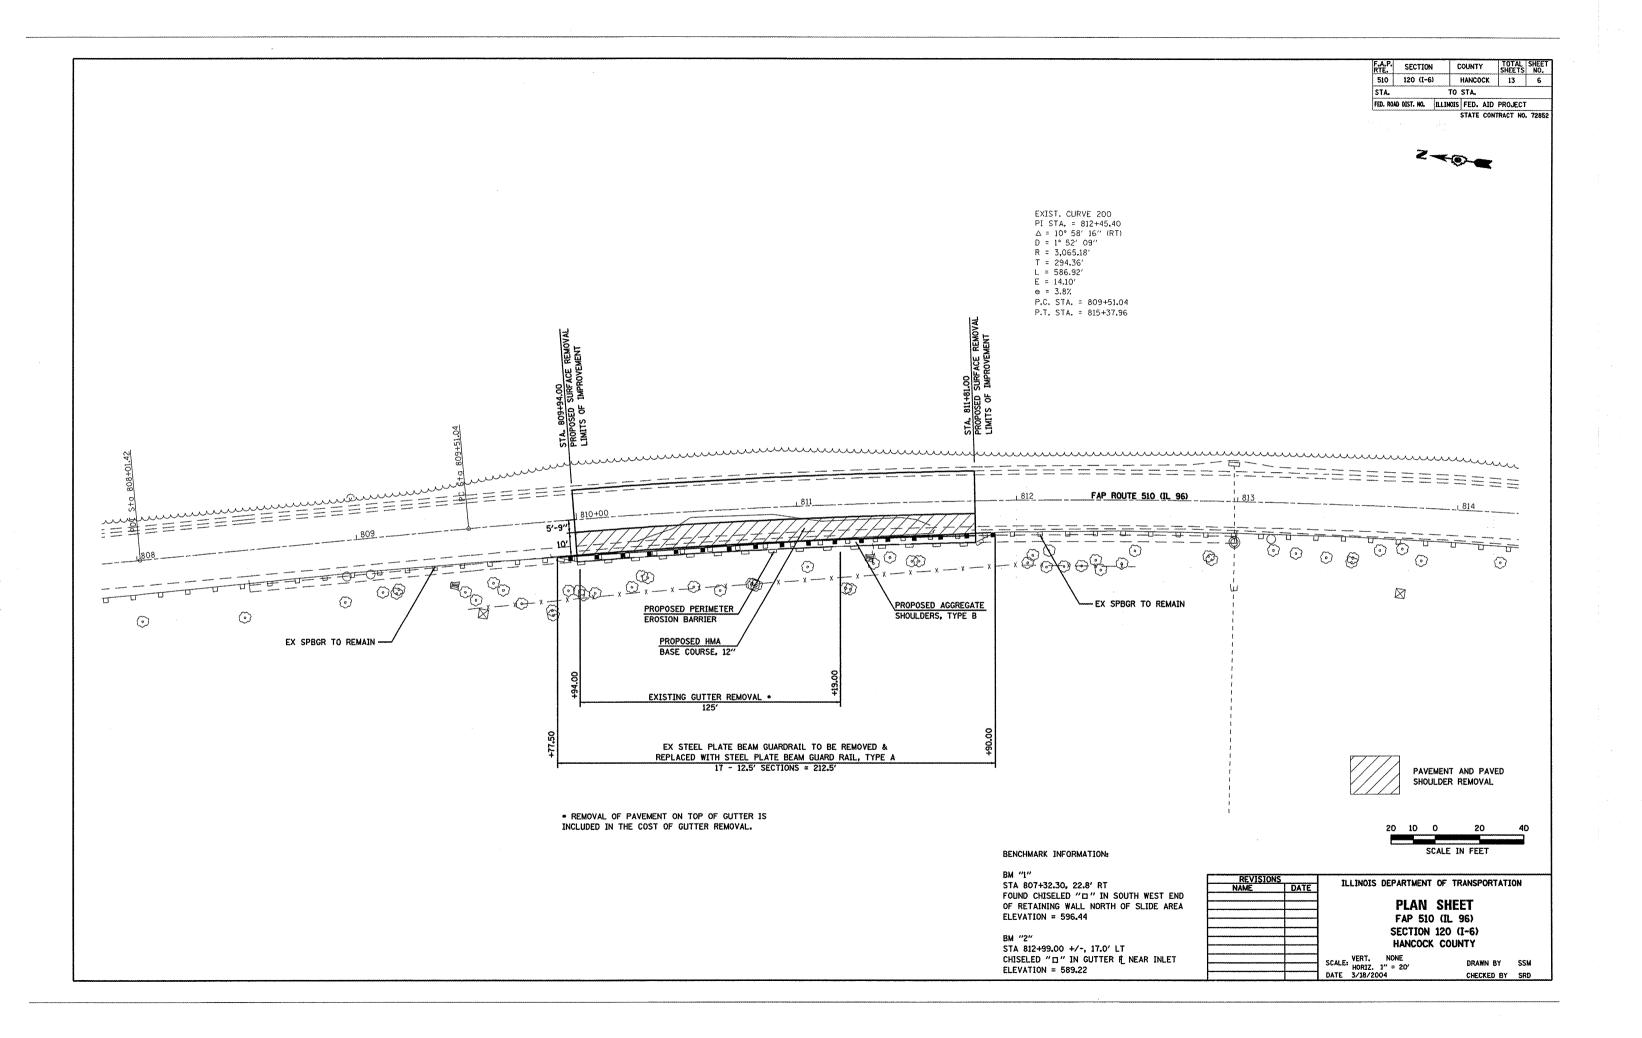

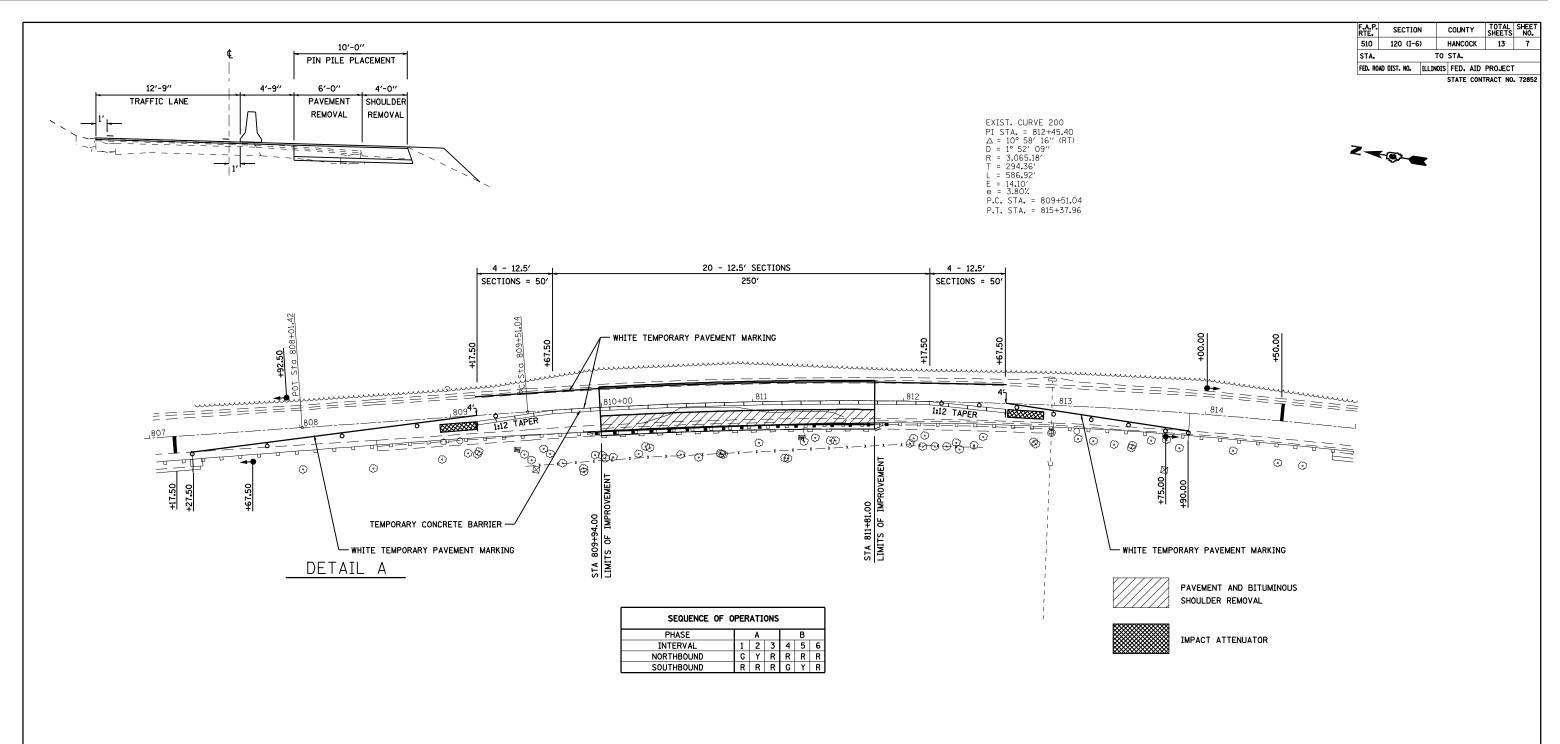

SEQUENCE OF CONSTRUCTION

- 1) INSTALL TRAFFIC CONTROL PROTECTION STANDARD 701321 $\,$
- 2) REMOVE PAVEMENT, SHOULDER, GUTTER, AND GUARD RAIL WITHIN PIN PILE PLACEMENT AREA
- 3) INSTALL PIN PILES
- 4) PATCH PAVEMENT AND RE-ERECT GUARD RAIL
- 5) REMOVE TRAFFIC CONTROL AND PROTECTION STANDARD 701321
- 6) PERFORM BITUMINOUS SURFACE REMOVAL, RESURFACING, AND FINAL PAVEMENT MARKINGS

NOTES:

ADVANCE WARNING SIGNS, TEMPORARY RUMBLE STRIPS, VERTICAL PANELS, PAVEMENT MARKERS, AND BARRIER WALL REFLECTORS SHALL BE LOCATED IN ACCORDANCE WITH TRAFFIC CONTROL AND PROTECTION STANDARD 701321.

SEE HIGHWAY STANDARD 701321 FOR MORE INFORMATION

IMPACT ATTENUATORS SHALL CONFORM TO: BDE MEMO 34-04 "IMPACT ATTENUATORS, (CRASH CUSHIONS)"

30	0	30	60
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ILLINOIS DEPARTMENT OF TRANSPORTATION


TRAFFIC CONTROL DETAIL
FAP 510 (IL 96)
SECTION 120 (I-6)
HANCOCK COUNTY

SCALE: VERT. NONE HORIZ. 1"=30" DATE: 03/18/2004


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F.A.P. RTE.	SECTION	(COUNT	Y	TOTAL SHEETS	SHEET NO.
510	120 (I-6)		HANCO	СК	13	8
STA.	STA. TO STA.					
FED. RO	FED. ROAD DIST. NO. ILLINOIS FED. AID PROJECT					
	STATE CONTRACT NO. 72852					



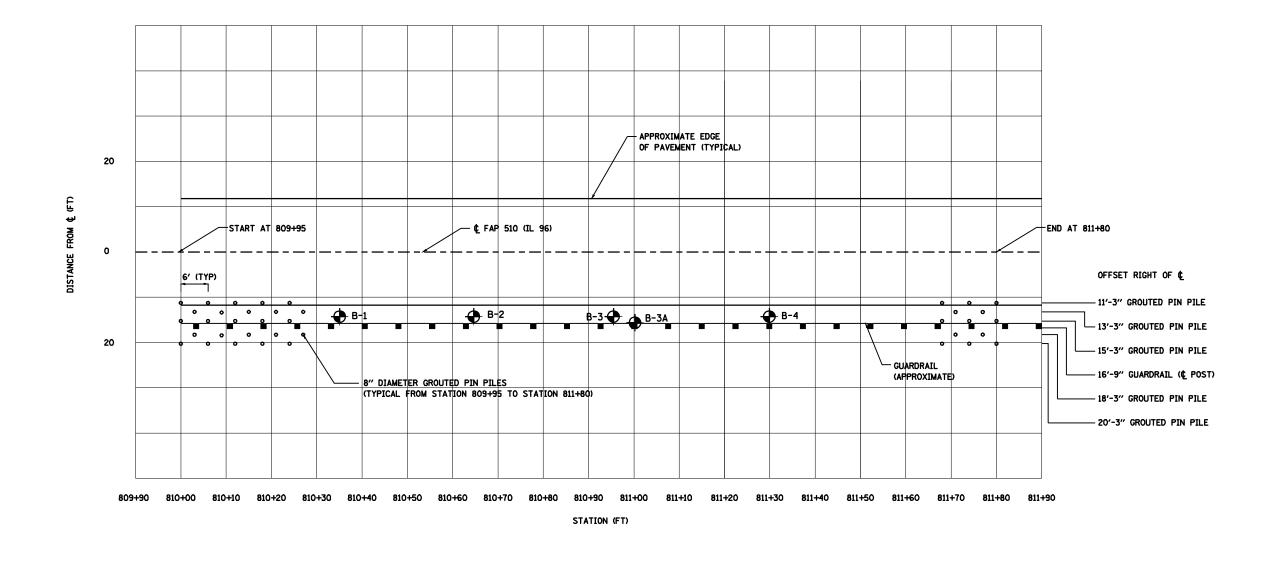

PLAN VIEW

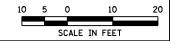

NOTES: FIELD ADJUSTMENTS SHALL BE MADE AS NEEDED TO MAINTAIN
AN 18 INCH SPACING BETWEEN & OF GUARDRAIL AND & OF ADJACENT
GROUTED PIN PILE ROWS.

OTHER GROUTED PIN PILE DIAMETERS AND SPACINGS ARE ACCEPTABLE, AS PROVIDED IN THE SPECIAL PROVISIONS.



ILLINOIS DEPARTMENT OF TRANSPORTATION

GROUTED PIN PILE DETAIL FAP 510 (IL 96) SECTION 120 (I-6)


HANCOCK COUNTY

SCALE: VERT. NONE HORIZ. 1" = 10' DATE 4/21/2005


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BASED ON GEOTECHNICAL REPORT DATED MAY 2004 (PREPARED BY SCI ENGINEERING FOR IDOT) AND PLAN PROVIDED BY IDOT DATED OCTOBER 1, 2003





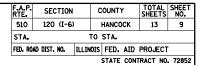

STATION	OUTER ROW (RIVER SIDE)	INNER ROW (CL SIDE)
809+95 - 810+25	589	590
810+25 - 810+65	588	589
810+65 - 810+80	587	588

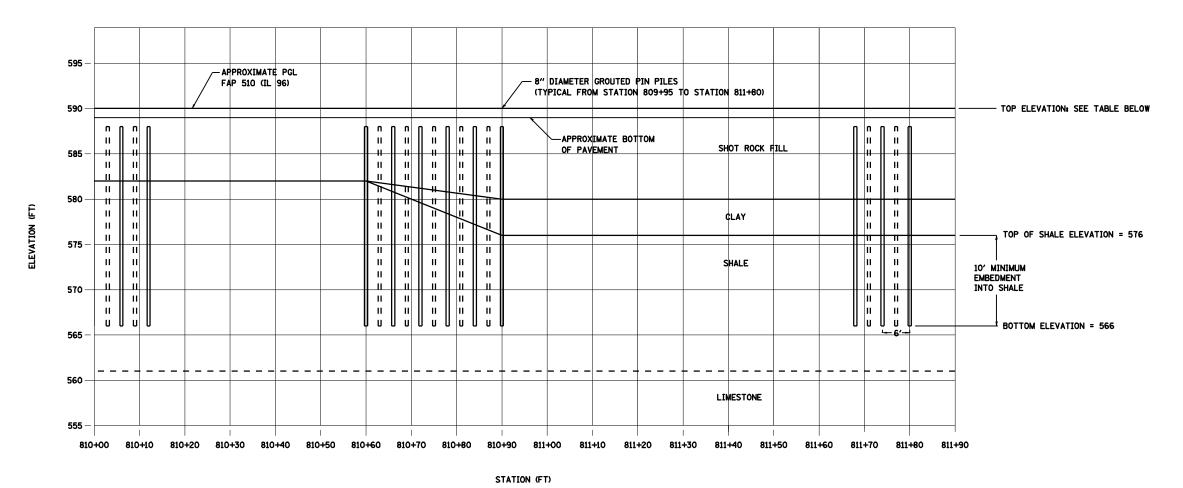NOTE: TOP ELEVATIONS TO BE ADJUSTED IN ACCORDANCE WITH THE PROPOSED AGGREGATE SUBBASE ELEVATION.

THE TOP OF THE PIN PILES SHALL BE A MINIMUM OF 12 INCHES BELOW THE BOTTOM OF THE PROPOSED PAVEMENT.

ELEVA	TION	VIEW

SCALE: HOR. 1" = 10' VERT. 1" = 5'

SUBSUI	RFACE MATERIAL CONSTRUCTION CONSIDERATIONS
ROCK FILL	GRADATION RANGE: ±0.1" TO ±36"; UNEVENLY DISTRIBUTED; ±3 FT NOMINAL MAXIMUM DIMENSION. ROCK FILL COMPOSED OF PRIMARILY LIMESTONE, SOME BROKEN CONCRETE MAY BE ENCOUNTERED.
CLAY	FAILURE PLANE. LOW STRENGTH / HIGH MOISTURE.
SHALE	WEATHERED; 19% <rqd<92%; 4<n<100+.="" are="" augured="" be="" boulders="" drilling="" during="" encountered.<="" equipment="" investigation.="" likely="" standard="" td="" to="" using=""></rqd<92%;>
GROUNDWATER	RAPID SEEPAGE INTO EXCAVATION SHOULD BE EXPECTED.

10 5 0 10 20 SCALE IN FEET

NOTES: FIELD ADJUSTMENTS SHALL BE MADE AS NEEDED TO MAINTAIN A MINIMUM OF 12 INCHES BETWEEN GUARDRAIL POSTS AND EDGE OF GROUTED PIN PILES.

ELEVATIONS SHOWN DEPICT GENERALIZED SOIL CONDITIONS. ACTUAL CONDITIONS MAY VARY CONSIDERABLY.

OTHER GROUTED PIN PILE DIAMETERS AND SPACINGS ARE ACCEPTABLE, AS PROVIDED IN THE SPECIAL PROVISIONS.

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ILLINOIS DEPARTMENT OF TRANSPORTATION


GROUTED PIN PILE DETAIL
FAP 510 (IL 96)
SECTION 120 (I-6)


HANCOCK COUNTY


SCALE: VERT. 1" = 5' HORIZ. 1" = 10' DATE 4/21/2005

DRAWN BY SSM CHECKED BY AGM

BASED ON GEOTECHNICAL REPORT DATED MAY 2004 (PREPARED BY SCI ENGINEERING FOR IDOT) AND PLAN PROVIDED BY IDOT DATED OCTOBER 1, 2003

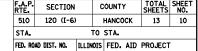

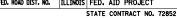

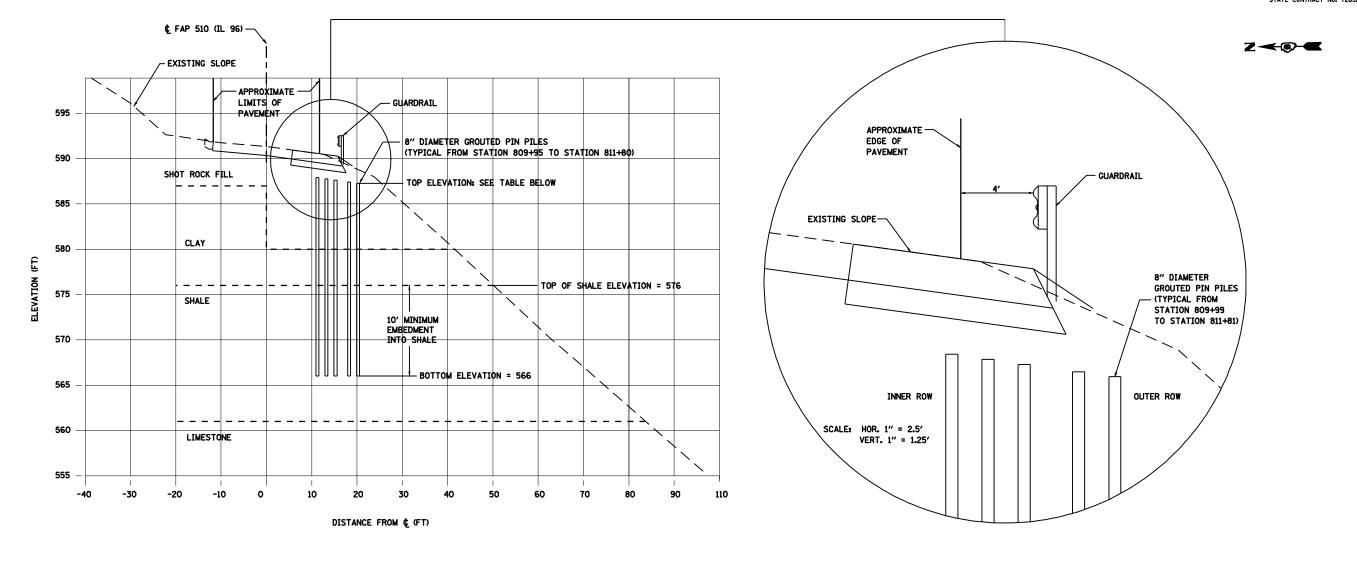

CROSS SECTION VIEW

SCALE: HOR. 1" = 10' VERT. 1" = 5'

STATION	OUTER ROW (RIVER SIDE)	INNER ROW (CL SIDE)
809+95 - 810+25	589	590
810+25 - 810+65	588	589
810+65 - 810+80	587	588

NOTE: TOP ELEVATIONS TO BE ADJUSTED IN ACCORDANCE WITH THE PROPOSED AGGREGATE SUBBASE ELEVATION.

THE TOP OF THE PIN PILES SHALL BE A MINIMUM OF 12 INCHES BELOW THE BOTTOM OF THE PROPOSED PAVEMENT.

SUBSUF	RFACE MATERIAL CONSTRUCTION CONSIDERATIONS
ROCK FILL	GRADATION RANGE: ±0.1" TO ±36"; UNEVENLY DISTRIBUTED; ±3 FT NOMINAL MAXIMUM DIMENSION. ROCK FILL COMPOSED OF PRIMARILY LIMESTONE, SOME BROKEN CONCRETE MAY BE ENCOUNTERED.
CLAY	FAILURE PLANE. LOW STRENGTH / HIGH MOISTURE.
SHALE	WEATHERED; 19% <rqd<92%; 4<n<100+.="" are="" augured="" be="" boulders="" drilling="" during="" encountered.<="" equipment="" investigation.="" likely="" standard="" td="" to="" using=""></rqd<92%;>
GROUNDWATER	RAPID SEEPAGE INTO EXCAVATION SHOULD BE EXPECTED.

10 5 0 10 20 SCALE IN FEET

NOTES: FIELD ADJUSTMENTS SHALL BE MADE AS NEEDED TO MAINTAIN AN 18 INCH SPACING BETWEEN & OF GUARDRAIL AND & OF ADJACENT GROUTED PIN PILE ROWS.

CROSS SECTION SHOWN DEPICTS GENERALIZED SOIL CONDITIONS. ACTUAL CONDITIONS MAY VARY CONSIDERABLY.

OTHER GROUTED PIN PILE DIAMETERS AND SPACINGS ARE ACCEPTABLE, AS PROVIDED IN THE SPECIAL PROVISIONS.

ILLINOIS DEPARTMENT OF TRANSPORTATION

GROUTED PIN PILE DETAIL FAP 510 (IL 96) SECTION 120 (I-6) HANCOCK COUNTY

SCALE: VERT. 1" = 5' HORIZ. 1" = 10' DATE 4/21/2005

DRAWN BY SSM CHECKED BY AGM

BASED ON GEOTECHNICAL REPORT DATED MAY 2004 (PREPARED BY SCI ENGINEERING FOR IDOT) AND PLAN PROVIDED BY IDOT DATED OCTOBER 1, 2003

Plot Plot

T.A.P.	SECTION		COUNTY	,	TOTAL SHEET	SHEET S NO.					
510	120 (I-6)	HANCOC	K	13	11					
STA. TO STA.											
FED. RO	AD DIST. NO.	ILLINOI	S FED.	AID	PROJEC	т					
			STATE	CONT	RACT N	10. 72852					

ROUTE FAP 510 (IL 96) DESCRIPTIO	IN		IL	96 Pr	oposed Slope Repair	LOGG	GED BY M. Ta
SECTION 120 (I-3) L							
COUNTY Hancock DRILLIN	G MET	HOD			HSA	HAMMER TYPE	140# Au
STRUCT. NO. Station BORING NO. 1 Station 810+35 Offset 14.00ft Right Ground Surface Elev. 591.5 ft	D E P T H	8 L O W	U C S Qu (tsf)	M O S T (%)	Surface Water Elev. Stream Bed Elev. Groundwater Elev.: First Encounter No Upon Completion After Hrs.	N/A ft Encounter ft	
Grey Most Rock Fill w/ Limestone Cobbles and Boulders		4 6 2		10			
Grey Poorly Indurated LIMESTONE Auger Refusal at 7.5 Borehole continued with rock		2 3 41					
coring.	-10						
	-15						
	-20						

Illinois Depa of Transport	ation	ROCK	CORE	LC)G			Date	6/7
ROUTE FAP 510 (IL 96) DESCRIP	TIONILS	6 Proposed Sk	pe Repair		_ L	OGGE	DBY	M. Ta	apı
SECTION120 (I-6)	LOCATION W 1/2.	SEC. 31, TWP.	6 N, RNG. 8 W.	1 PM					
COUNTY		1.875 576.50		D E P T	C O R E	R C O V E R	R . Q . D .	T I M E	
Station 810+35 Offset 14.00ft Right Ground Surface Elev. 591.5	•	331.30		H (ft)	(#)	Y (%)	(%)	(min/ft)	
Light Grey Well Indurated Crystalline I Likely Not In Place Tan and Tannish Grey V. Weathered			584.0 / 503.4		1	10	10		The same of the sa
					2	25	0		
				-15	3	73	58		
				-20	4	81	71		
Dark Grey Well Indurated Clayey SHAI			566.90 564.80	-25					
Dark Grey V. Well Indurated Clayey Sh	ALE			-	5	98	96		

of Transpo	ortation ROCK CO					ate	1/7/99
ROUTE FAP 510 (IL 96) DESC	RIPTION IL 96 Proposed Slope Repa	iir	L	OGGE) BY	M. Ta	ppan
SECTION120 (I-6)	LOCATION W 1/2, SEC. 31, TWP. 6 N, RNG	.8W,4PM					
COUNTY Hancock Co	ORING METHOD Christensen NXB w/ Water			R	R	CORE	S
STRUCT, NO.	CORING BARREL TYPE & SIZENX	В р	С	C		Ţ	R
Station	Core Diameter 1.0/5 in	E	0	V		M	N
BORING NO. 1 Station 810+35 Offset 14.00ft Right	Top of Rock Elev. 576.50 ft Begin Core Elev. 584.00 ft	P	R	E R	_ D	E	G T
Station 810+35 Offset 14.00ft Right	Begin Core Elev. 584.00 ft	н		Υ			Н
Ground Surface Elev. 591.5		(ft)	(#)	(%)	(%)	(min/ft)	(tsf)
Dark Grey V. Well Indurated Claye	ey SHALE (continued)						
		_					
		_					
		30 561.00					
/. Light Brownish Grey Moderately	Indurated Argillicecus LIMESTONE	301.00					
Boring Complete		560.00					
Note - No Water Return During Ro	ick Core Run	_					
Station, Elevation updated 08/20/0	4 MRM				-		
		-35					
		_					
		_					
		-40					
		-					
		-47					
		-45					
		_					

	REVISIONS		TI I TNOTS	DEPARTMENT OF TRANSPORTATION
	NAME	DATE	ILLINOIS	DEPARTMENT OF TRANSPORTATION
F				
H				SOIL BORINGS
				· · · · · · · · · · · · · · · · · · ·
				SHEET 1 OF 3
F				
H			oo VERT.	
H			SCALE: HORIZ.	DRAWN BY IDOT
			DATE	CHECKED BY

F.A.P. RTE.	SECTION		СО	UNT	′	TOTAL SHEETS	SHEET NO.				
510	120 (I-6)	HAI	NCOC	K	13	12				
STA. TO STA.											
FED. RO	AD DIST. NO.	ILLINO	IS F	ED.	AID	PROJEC	Г				
			S.	TATE	CONT	RACT NO	. 72852				

POLITE FAR 510 /II 98\ DESC	PIPTIN				DR De	oposed Slope Repair	1000		, ,	1 T	
							LOGGE	ום ענ		и. гар	pan
SECTION 120 (I-6)					. SEC.				- To ottomatoria		
COUNTY Hancock D		ME	THOD	_		HSA HAMMER	TYPE		140	# Auto	
STRUCT, NO. Station BORING NO. 2 Station 810+65		D E P T H	B C W S	C S Qu	M O I S T	Surface Water Elev.	_ ft _ ft	D E P T H	B L O W S	C S Qu	M O I S T
Offset 14.00ft Right Ground Surface Elev. 590.8	ft	(ft)	/6"	(tsf)	(%)	Upon Completion 556.2 After Hrs. Plugged	_ ft ft	(ft)	/6"	(tsf)	{%
Grey Maist Rock Fill with Limestone Cobbles and Boulders						SHALE (continued) Greyish Brown Weathered Poorly		_	17	S-14	
		\dashv				Indurated Clayey SHALE		-	3		
						Brown and Grey Weathered Poorly Indurated Clayey SHALE		=	13	3.5 B	17
		.5	2		7	Grey Moist Well Indurated	556.30	-25	20		9
			3			CLÁYEY SHALE Poker Chipped Sample			/5" /		
		7	1 2 5		10	Poker Chipped Sample			100 /5" /		6
			100				561.30	-	100		
		-10	B.S.			Boring Completed		-30	<i>j4</i> "		
						Station, Elevation Updated 08/20/04 MRM					
	-	-	1 3	0.5 B	20						
Dark Grey Mcttled CLAY	577.30		0					-35			
	575.80	-15	1	0.3	30			-35			
SHALE Grey and Tan V. Weathered Poorly Indurated Clayey SHALE			3	В							
	-	1	3 5 10	1.1 S-5	15		-	=			
	-	1		3-0			-				
		-	3	4.2	15			-			

of Transportat					DIL BORIN			Date6/8
ROUTE FAP 510 (IL 96) DESCRIPTION	N		IL	96 Pr	oposed Slope Repair		LOGGED BY	M. Tapp
SECTION 120 (I-6) LO	CATI	ON	W 1/2	SEC.	31, TWP. 6 N, RNG. 8	W, 4 PM		
COUNTY Hancock DRILLING	3 ME	THOD			HSA	_ HAMMER	TYPE	140# Auto
STRUCT. NO. Station BORING NO. 3	D E P T	B L O W	Ç S	M O - s	Surface Water Elev. Stream Bed Elev. Groundwater Elev.:	N/A N/A		
Station 810+95 Offset 13.00ft Right Ground Surface Elev. 590.6 ft	H (ft)	/6"	Qu (tsf)	T (%)	First Encounter N Upon Completion After Hrs.	Dry	ft	
Grey Moist Rock FIII w/ Large Limestone Cobbles and Boulders	_							
	_							
	_							
		2						
	-5	5						
	\exists							
	-	7						
		8						
		6						
Boulders and Cobbles Pushed Augers 580:10 Abandoned Hole - Moved to	10	5						
Boring 3a	Ξ							
	-							
	-15							
	-15							
	=							
	긔							
	_							

Illinois Depart	me	nt		SC	OIL BORING LOG		rage	1	ďΤ
Division of Highways Idet District 6				-			Date	6/	8/99
ROUTE FAP 510 (IL 98) DESCRIPTION	N			96 Pr	oposed Slope Repair LO	GGED B	Y	W. Tap	pan
SECTION120 (I-6)	OCATI	ION _	W 1/2	SEC.	31, TWP. 6 N. RNG. 8 W, 4 PM				
COUNTY Hancock DRILLIN	IG ME	THOD			HSA HAMMER TY	PE	140	# Auto	
STRUCT. NO.	D	B	U	M	Surface Water Elev. N/A ft Stream Bed Elev. N/A ft	D		U	I C
Station	P	ō	s	Ī	Stream Bed Elev. N/A To	P	0	S	i
BORING NO. 3A Station 811+00 Offset 15.00f Right	T	W		S	Groundwater Elev.:	т			٤
Station 811+00	Н	S	Qu	T	First Encounter 580.9 ft Upon Completion 564.4 ft	н	S	Qu	1
Offset 15.00ft Right					Upon Completion 564.4 ft		100		
Ground Surface Elev It	(ft)	16	(tsf)	(%)	After Hrs Plugged_ft	(ft)		(tsf)	(%
Grey Maist Rock Fill w/ Limestone					SHALE (continued)		13	S-11	
Cobbles and Boulders									
	_								
	_		1		Barrer and Constitutions		3		
	_				Brown and Grey Weathered Poorly Indurated Clayey SHALE	_	10	5.0 P	18
					1 sony indefated clayer of MEE		14	P	-
					1	_	1		
		1			1	_	20		
	-5	<u> </u>	-		Grey Dry Moderately Indurated		400		7
	5	3			Clayey SHALE	-26	/3"		T,
	_	<u> </u>				_	1	1	
	_						1		
	_	2				_	1		
	-	3	1				1		
		2]		
						1.40			
	-	1			Grey Moderately Indurated 56	0.90	100		
Free Water	-10	2			Argilliceous LIMESTONE / Boring Completed	-30	/3"	1	
		2			Borning Completed	_	1		
	_				Station, Elevation updated	_	1		
					08/20/04 MRM				
		1 2		-	H		-		
Brown and Grey Moist CLAY	0	3				_	1		
Colluvium	_	٥	-			_	-		
	_					-			
	-	0							
	-15		0.4	22					
	-15	2	В			533			
574.4	, –	-	-			_			
SHALE 574.4	-								
		1							
Grey and Tan Moist V. Weathered		2	1.5	16		-			
Poorly Indurated Clayey SHALE		5	S-12			-			
	_								
		3							
	-20		3.3	1.4		-40		1	

The Unconfined Compressive Strength (UCS) Failure Mode is indicated by (B-Bulgo, S-Shoar, P-Penetrometer)
The SPT (N value) is the sum of the last two blow values in each sampling zone (AASHTO T206)

BBS, from 13

NT OF TRANSPORTATION	TILINOIS DEPARTME		REVISIONS
IN OF THAINSFORTATION	ILLINOIS DEI ANTMI	DATE	NAME
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DODINGO	0011		
BORINGS	SUIL SUIL		
T 2 OF 3	SHEE		
	1		
	1		
DRAWN BY IDOT	SCALE: VERT.		•
DRAWN BY 1001	HORIZ.		

F.A.P. RTE.	SECTION	С	OUNT	′	TOTAL SHEETS	SHEET NO.	
510	120 (I-6)	н	ANCOC	K	13	13
STA.		7	го	STA.		•	
FED. RO	AD DIST. NO.	ILLIN	OIS	FED.	AID	PROJECT	
				STATE	CONT	RACT NO	72852

ROUTE FAP 510 (IL 96) DES	CRIPTION _		IL	96 Pr	oposed Slope Repair	LOGG	ED BY _	М. Тар	pan
ECTION 120 (I-6)	FOCY.	LION _	W 1/2	SEC.	31, TWP, 8 N. RNG, 8 V	N, 4 PM			
COUNTY Hancock DRILLING METHOD			HSA		HAMMER TYPE	140# Auto			
STRUCT. NO	P T H	w s	U C S Qu (tsf)	M O I S T (%)	Surface Water Elev. Stream Bed Elev. Groundwater Elev.: First Encounter Upon Completion After Hrs. Grey and Brown Weat Poorly Indurated Clay Borehole continued w	N/A ft 578.5 ft Cored ft Plugged ft hered V. ay SHALE	D B E L P O T W H S 10	C S Qu " (taf)	M O I S T T (%)
rown and Dark Grey Molst CLA folluvium Srey and Tan V. Weathered V. oorly indurated Clayey SHALE	580.00 · Y	1 2 2	0.6 B	16			-30		

Division of Highways Idox Civinius s						6/9/99				
ROUTE FAP 510 (IL 96) DESCRIPTION IL 96 Proposed Slope Rep	IL 96 Proposed Slope Repair					LOGGED BY M. Tappan				
SECTION 120 (I-6) LOCATION W 1/2, SEC. 31, TWP. 6 N, RN	G. 8 W, 4 F	PM								
COUNTY Hancock CORING METHOD Christensen NXB w/ Water			R	R	CORE	S T				
STRUCT. NO. CORING BARREL TYPE & SIZE NO.		D C E O P R T E H	C O V E R Y (%)	Q . D .	T I M E (min/ft)	E N G T H (tsf)				
Grey and Brown Weathered V. Poorly Indurated Clayey SHALE	570.00	_ 1	48	19						
	-									
	-	\dashv								
	565.80									
Dark Grey Poorly Indurated Clayey SHALE	564.80	-25 2	92	92						
Dark Grey Well indurated Clayey SHALE				-						
		_								
Light Brownish Grey Moderately Indurated Poorly Cemented Argilliceous	561.00 560.40									
LIMESTONE Boring Completed		-30								
Refer Elevation to BM TJM100, Chisled Square on SW Comer of Existing Wall 'L' at STA 807+32, 14' Rt. BM TJM100–596 44'	-									
Refer Stations to PK Nails set by D6 Survey Crew, STA Increase to South										
Stations, Elevations Updated 08/20/04 MRM	-									
	_	_								
	_	-35								
		-								
	_	_								
	-									
	-	-35								
	-	-								
		40								

REVISIONS
NAME
DATE

SOIL BORINGS
SHEET 3 OF 3

SCALE; VERT.
HORIZ.
DATE

DATE

REVISIONS

ILLINOIS DEPARTMENT OF TRANSPORTATION

BORINGS
SHEET 3 OF 3