#### **GENERAL NOTES**

1. BEFORE STARTING ANY EXCAVATION, THE CONTRACTOR SHALL CALL "JULIE" (811) AT 800-892-0123 FOR FIELD LOCATIONS OF BURIED ELECTRIC, TELEPHONE AND GAS FACILITIES. (48 HOURS NOTIFICATION IS REQUIRED). CONTACT OWNER'S PROJECT MANAGER TO LOCATE PRIVATE UTILITIES WITHIN THE PROJECT AREA, A MINIMUM OF FIVE DAYS IN ADVANCE OF CONSTRUCTION ACTIVITIES.

- 2. NO WORK SHALL COMMENCE UNTIL TRAFFIC CONTROL REQUIREMENTS ARE MET.
- 3. ALL UTILITIES, SCHOOL DISTRICTS, LOCAL POLICE, AND FIRE DEPARTMENTS SHALL BE NOTIFIED BY THE CONTRACTOR PRIOR TO THE START OF CONSTRUCTION.

4. UNLESS AUTHORIZED BY THE ENGINEER, ALL EXISTING ACCESS POINTS SHALL BE MAINTAINED AT ALL TIMES BY THE CONTRACTOR.

5. DURING THE CONSTRUCTION, THE CONTRACTOR WILL BE REQUIRED, AT HIS EXPENSE, TO HAVE AVAILABLE A WATER TRUCK OR SIMILAR EQUIPMENT TO CONTROL DUST. IF NECESSARY, THE CONTRACTOR SHALL BE REQUIRED TO CONTROL DUST DURING NON-WORKING HOURS. PAYMENT FOR THIS WORK SHALL BE INCLUDED IN THE COST OF EARTH EXCAVATION.

6. ALL SOIL EROSION AND SEDIMENT CONTROL DEVICES SHALL BE INSTALLED PRIOR TO UPLAND DISTURBANCE.

7. THE CONTRACTOR WILL PERFORM ALL CONSTRUCTION LAYOUT AND AS-BUILT SURVEY.

#### TREE REMOVAL & CLEARING

DUE TO THE POTENTIAL PRESENCE OF THE INDIANA BAT AND THE NORTHERN LONG—EARED BAT WITHIN THE PROJECT AREA, TREES SHALL NOT BE CLEARED FROM APRIL 1 THROUGH SEPTEMBER 30.

TREES NOT MARKED FOR REMOVAL SHALL BE CONSIDERED AS DESIGNATED TO BE SAVED AND SHALL BE PROTECTED.

ALL LIMBS, BRANCHES, AND OTHER DEBRIS RESULTING FROM THIS WORK SHALL BE DISPOSED OF BY THE CONTRACTOR AT THERE OWN EXPENSE OFFSITE.

THE EXACT CLEARING AND GRUBBING LOCATIONS ARE NOT PROVIDED ON THE PLANS. GENERAL LOCATION ARE NOTED. CLEARING AND GRUBBING SHALL NOT BE PAID FOR SEPARATELY.

### **TOPSOIL**

IN GENERAL, TOPSOIL SHALL BE PLACED TO A DEPTH OF 4 INCHES. EXISTING TOPSOIL SHALL BE STOCKPILED AND RE-USED ONSITE.

THE CROSS SECTIONS INDICATE THE FINISHED GRADE OF TOPSOIL.

TOPSOIL SHALL NOT BE STOCKPILED WITHIN THE LIMITS OF THE REGULATORY 100—YEAR FLOODPLAIN. NOTE: AS A MAJORITY OF THE PROJECT AREA IS LOCATED WITHIN THE FLOODPLAIN, NO TOPSOIL OR EXCAVATION STOCKPILES SHALL REMAIN ONSITE FOR LONGER THAN 24—HOURS. CONTRACTOR SHALL BE RESPONSIBLE FOR DETERMINING STOCKPILE LOCATIONS OFFSITE, IF NECESSARY.

#### STORM SEWERS, STRUCTURES, & UTILITIES

THE CONTRACTOR SHALL BE RESPONSIBLE FOR CONTACTING LOCAL AGENCIES MAINTAINING SANITARY SEWERS, WATERMAINS, AND STREET LIGHTS TO VERIFY THE MATERIALS AND METHODS ALLOWED FOR THE ADJUSTMENT OR PROTECTION OF THE UTILITY INVOLVED.

THE LOCATION AND ELEVATION OF EXISTING UTILITIES ARE APPROXIMATE. THE EXACT LOCATIONS AND ELEVATIONS ARE TO BE VERIFIED BY THE CONTRACTOR THROUGH THE OWNER OF THE UTILITY.

ALL FIELD TILES ENCOUNTERED SHALL BE CAREFULLY PRESERVED AND CONNECTED TO PROPOSED DRAINAGE STRUCTURES, SEWERS OR DITCHES AS DIRECTED BY THE ENGINEER; THIS WORK WILL BE PAID AT THE APPLICABLE CONTRACT UNIT PRICE OR IN ACCORDANCE WITH ARTICLE 109.04.

SHOULD THE CONTRACTOR ENCOUNTER ANY DRAIN TILES, THE CONTRACTOR SHALL CONTACT THE OWNER OR ENGINEER IMMEDIATELY. ANY DAMAGES TO TILES SHALL BE REPAIRED BY THE CONTRACTOR AT NO ADDITIONAL COST TO THE OWNER.

KNOWN UTILITIES INCLUDE THE FOLLOWING:

CITY OF SYCAMORE — SANITARY SEWER, WATER MAIN, STORM SEWER

COMCAST — AERIAL CABLES

COMED — AERIAL CABLES

NICOR — GAS MAIN

# HOT-MIX ASPHALT

HOT-MIX ASPHALT SURFACE COURSE SHALL NOT BE PLACED UNTIL ALL EARTH EXCAVATION AND AGGREGATE BASE COURSE HAVE BEEN COMPLETED TO THE SATISFACTION OF THE ENGINEER.

# PAVEMENT STRIPING

ALL PROPOSED SEGMENTS OF THE TRAIL, EXCEPT WHERE NOTED ON THE PLANS, SHALL BE PAINTED WITH A SINGLE SOLID YELLOW PAVEMENT PAINT MARKING, 4" AT THE CENTERLINE OF THE PATH.

# TRENCH BACKFILL

WHERE TRENCH BACKFILL IS REQUIRED, THE MATERIAL USED SHALL BE COMPACTED AS SPECIFIED IN ARTICLE 550.07 OF THE STANDARD SPECIFICATIONS USING METHOD ONE. THE COST OF TRENCH BACKFILL SHALL BE INCLUDED IN THE COST OF STORM SEWERS (OF THE TYPE AND DIAMETER SPECIFIED).

# PATH EXCAVATION

THE CONTRACTOR WILL HAVE THE OPTION OF REMOVING THE EXISTING BITUMINOUS MATERIAL BY GRINDING OR EXCAVATING THE MATERIAL. IF THE BITUMINOUS MATERIAL IS REMOVED BY EXCAVATION, IT MAY NOT BE USED IN EMBANKMENT AREAS UNLESS SPECIFICALLY AUTHORIZED BY THE ENGINEER. BITUMINOUS MATERIAL REMOVED BY GRINDING MAY BE USED AS EMBANKMENT MATERIAL OR AS AGGREGATE BASE COURSE IF IT MEETS THE STANDARDS WITHIN THE SPECIAL PROVISIONS. NO BITUMINOUS MATERIAL SHALL BE REMOVED IN AREAS TO BE USED FOR TEMPORARY ACCESS.

THE CONTRACTOR SHALL NOT CROSS COMPLETED BASE COURSE OR EXISTING PAVEMENT, NOT SCHEDULED TO BE REMOVED, WITH ANY TRACKED EQUIPMENT.

ALL EMBANKMENTS AND SUB-GRADE SHALL BE COMPACTED TO THE SATISFACTION OF THE ENGINEER PRIOR TO PLACING AGGREGATE SUBGRADE OR SUBBASE GRANULAR MATERIAL.

THERE MAY BE AREAS INVOLVING DRAINAGE DITCHES, CULVERT ENTRANCES AND EXITS, AND DEPRESSIONAL PONDED AREAS THAT MAY HAVE DEPOSITS OF UNSUITABLE OR UNSTABLE MATERIAL. THESE AREAS MUST BE PUMPED DRY OF ANY WATER AND ALL UNSUITABLE/UNSTABLE MATERIAL REMOVED BEFORE ANY EMBANKMENT MATERIAL IS PLACED.

	<u>EXISTING</u>	<u>PROPOSED</u>
CURB & GUTTER		
EDGE OF PAVEMENT -		
	<b>→</b>	<b>→</b>
	× ×	·
PERIMETER EROSION BARRIER		xxxx
TEMPORARY FENCE		<del>-                                    </del>
OVERHEAD WIRE -	——————————————————————————————————————	
10-YR FLOODPLAIN -	10YR	
100-YR FLOODPLAIN -	100YR	
FLOODWAY -	FW	
CONTOUR -	<del></del> 700 <del></del>	700
MANHOLE		
CATCH BASIN	$\bigcirc$	•
INLET		-
STEEL END SECTION	$\triangleright$	•
CONC END SECTION		
HYDRANT	Q	
HANDHOLE		
UTILITY PEDESTAL	PED	
UTILITY POLE		
UTILITY POLE W/STREET LIGHT	$\varphi \longrightarrow \hspace{-1em} \swarrow$	
STREET LIGHT		
STREET LIGHT CONTROLLER		
SIGN	П	
TREE REMOVAL		
TREE(DECICOUS)		
STONE RIPRAP		
STABILIZED CONSTRUCTION ENTR	ANCE	
WETLAND	\(\psi\) \(\	
ASPHALT TRAIL		
PAVEMENT REMOVAL		
PERMANENT EASEMENT		777777777777777777
TEMPORARY EASEMENT		
EXISTING PROPERTY LINE		
CONSTRUCTION LIMITS		

### <u>INDEX OF SHEETS</u>

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3	SUMMARY OF QUANTITIES
4	EXISTING TYPICAL SECTIONS
5	PROPOSED TYPICAL SECTIONS
6A-6B	SCHEDULE OF QUANTITIES
7–8	ALIGNMENT & TIES
9-11	EXISTING CONDITIONS & DEMOLITION PLAN
12-17	PLAN & PROFILES
18-20	LANDSCAPE PLAN & EROSION CONTROL PLAN
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24	GENERAL DATA
25–26	APPROACH SLAB PLANS
27	DRILLED SHAFT PIER PLAN & DETAILS
28	HP PILE DETAILS
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32-34	PAVEMENT MARKING AND SIGNANGE PLAN
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## IDOT HIGHWAY STANDARDS

1001 11101111	
000001-08 280001-07	STANDARD SYMBOLS, ABBREVIATIONS AND PATTERNS TEMPORARY EROSION CONTROL SYSTEMS
542301-03	PRECAST REINFORCED CONCRETE FLARED END SECTION
602401-07	PRECAST MANHOLE, TYPE A, 4' (1.22 m) DIAMETER
602701-02	MANHOLE STEPS
604001-05	FRAME AND LIDS TYPE 1
604036-03	GRATE TYPE 8
664001-02	CHAIN LINK FENCE
701001-02	OFF-ROAD OPERATIONS: 2L, 2W, MORE THAN 15 FT. AWAY
	OFF-ROAD OPERATIONS: 2L, 2W, 15' TO 24" FROM PAVEMENT EDGE
701301-04	LANE CLOSURE, 2L, 2W, SHORT TIME OPERATIONS
701501-06	LANE CLOSURE, 2L, 2W, UNDIVIDED
701801-06	SIDEWALK, CORNER OR CROSSWALK CLOSURE
701901-00	·
720001-01	
720006-04	SIGN PANEL ERECTION DETAILS
720011-01	METAL POSTS FOR SIGNS, MARKERS & DELINEATORS
729001-01	APPLICATIONS OF TYPES A & B METAL POSTS (FOR SIGNS & MARKERS)
	·

HMA MIXTURE REQUIREMENT	TABLE	
LOCATIONS:	ENTIRE PROJECT	STA 220+70 - STA 220+87
MIXTURE USE(S):	HMA	HMA BINDER FOR
	SURFACE	PAVEMENT PATCH
BINDER GRADE (PG):	PG 64-22	PG 64-22
DESIGN AIR VOIDS:	4.0% @ N50	4.0% @ N50
MIXTURE COMPOSITION:	IL 9.5	IL 9.5
(MIXTURE GRADATION)		
FRICTION AGGREGATE:	MIXTURE C	
MIXTURE WEIGHT:	112.0 LB/SY/IN	112.0 LB/SY/IN
QUALITY MANAGEMENT PROGRAM:	QCQA	QCQA
SUBLOT SIZE:	N/A	N/A
DENSITY TEST METHOD:	CORES/NUCLEAR	CORES/NUCLEAR
MATERIAL TRANSFER DEVICE (REQUIRED):	NO	NO

## SITE BENCHMARKS:

BM #1 SET "PK" NAIL IN EXISTING PAVEMENT S.W. CORNER PLEASANT ST. AND EAST PAGE ST. STA. 224+25.59, 4.00'RT.

ELEV: <u>833.32</u> (NAVD 88)

BM #2 SET "PK" NAIL IN EXISTING PAVEMENT STA. 220+78.07, 28.47'RT. ELEV: 836.04 (NAVD 88)

BM #3 SET "PK" NAIL IN EXISTNG PAVEMENT STA. 212+57.09, 24.73'LT. ELEV: 830.74 (NAVD 88)

BM #4 SET "PK" NAIL IN EXISTING PAVEMENT STA. 209+37.65, 19.52'RT. ELEV: 827.54 (NAVD 88)

BM #5 SET "PK" NAIL IN EXISTING PAVEMENT STA. 207+94.86, 36.39'RT. ELEV: 829.08 (NAVD 88)

BM #6 SET "PK" NAIL IN EXISTING PAVEMENT STA. 204+33.84, 74.18'RT. ELEV: 828.66 (NAVD 88)

## FLOOD ELEVATIONS:

SCALE: N.T.S.


FLOOD ELEVATIONS WERE DETERMINED UTILIZING FEMA FLOOD PANEL 17037C0256E AND THE DEKALB COUNTY COUNTYWIDE FLOOD INSURANCE STUDY, BOTH EFFECTIVE JANUARY 2, 2009.


100-YEAR FLOOD ELEVATION: 830.60-835.00 (NAVD88) 10-YEAR FLOOD ELEVATION: 828.60-830.60 (NAVD88)

GENERAL NOTES, INDEX OF SHEETS, LEGEND AND HIGHWAY STANDARDS			F.A.U. RTE.	SEC.	TION	COUNTY	TOTAL SHEETS	SHEET NO.	
			_	21-P400	6-03-BT	DEKALB	44	2	
		CONTRACT NO. 87			7843				
•	SHEET NO. 1 OF 1 SHEETS	STA.	TO STA.	FFD. RO	AD DIST. NO.	ILLINOIS	FFD. AID PROJEC	CT TYVE(41	7)

	USER NAME = sgieraltowski	DESIGNED — AK	REVISED — 06/30/2025
ENGINEERING		DRAWN — RT	REVISED — 10/03/2025
ENGINEERING RESOURCE ASSOCIATES	PLOT SCALE = \$SCALE\$	CHECKED — JM	REVISED — ADDENDUM 1 10/21/2
THEOGRAPH THEOGRAPH TEST	PLOT DATE = $3/4/2025$	DATE — October 2023	REVISED —

STATE OF ILLINOIS DEPARTMENT OF TRANSPORTATION

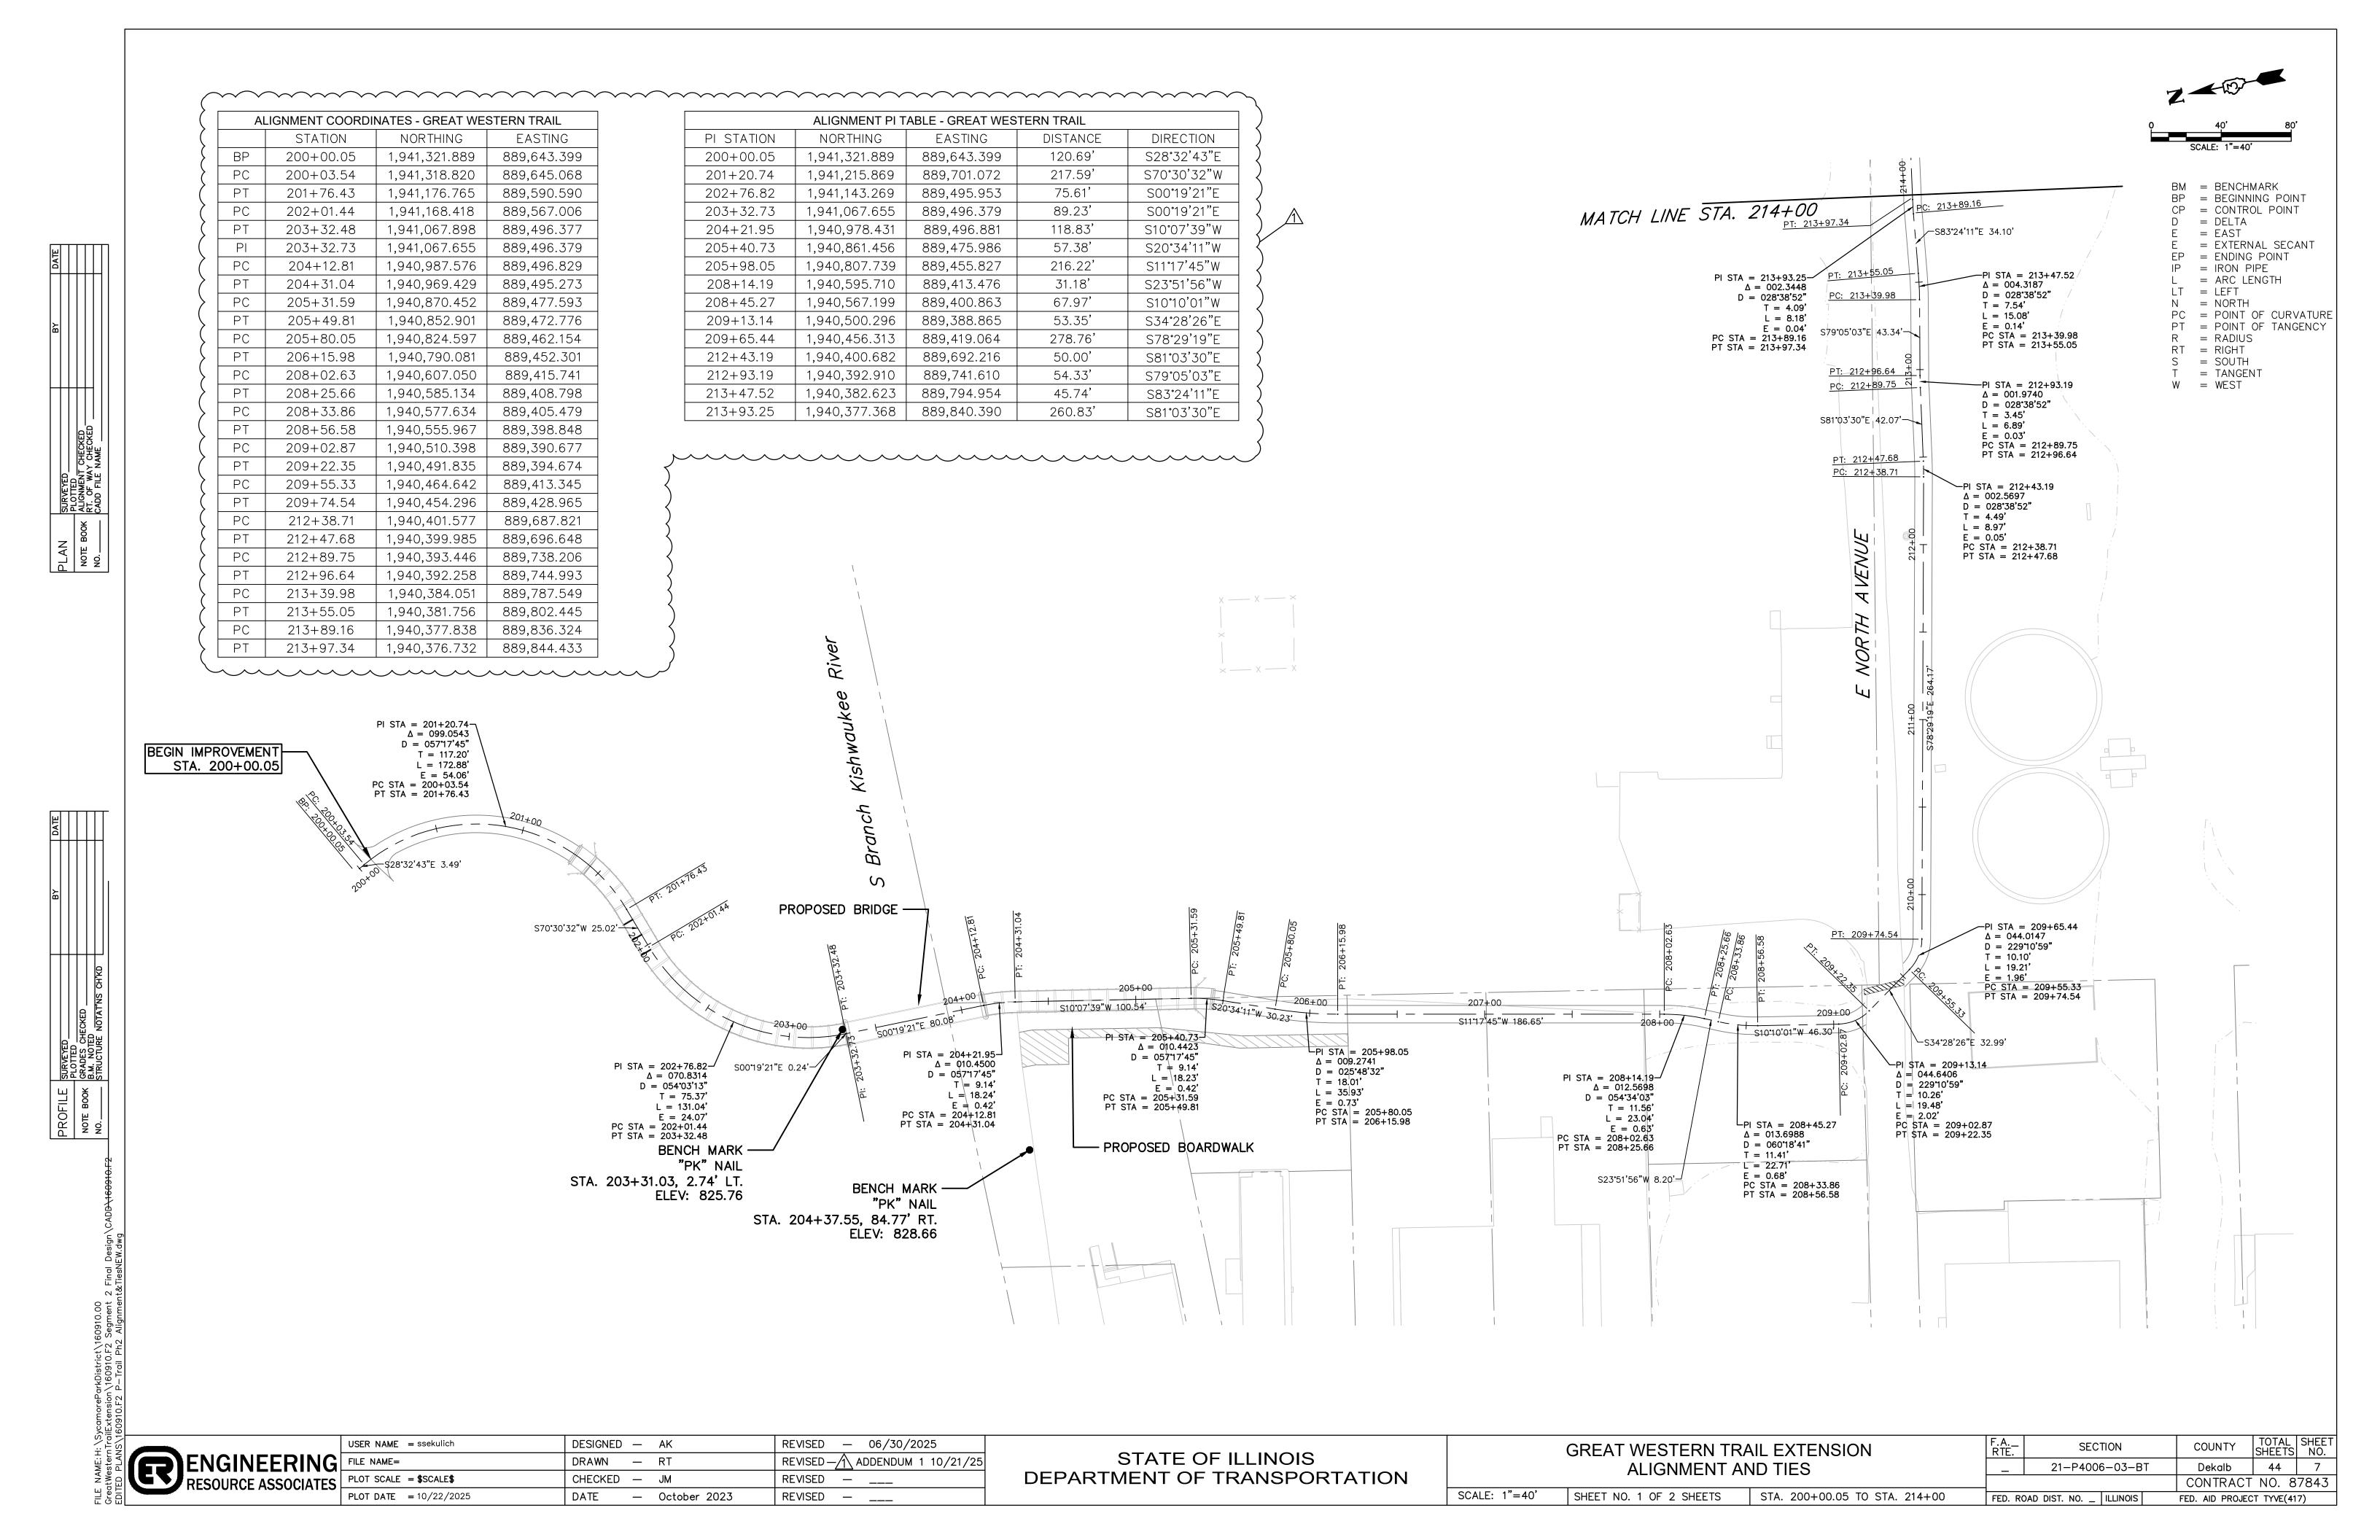

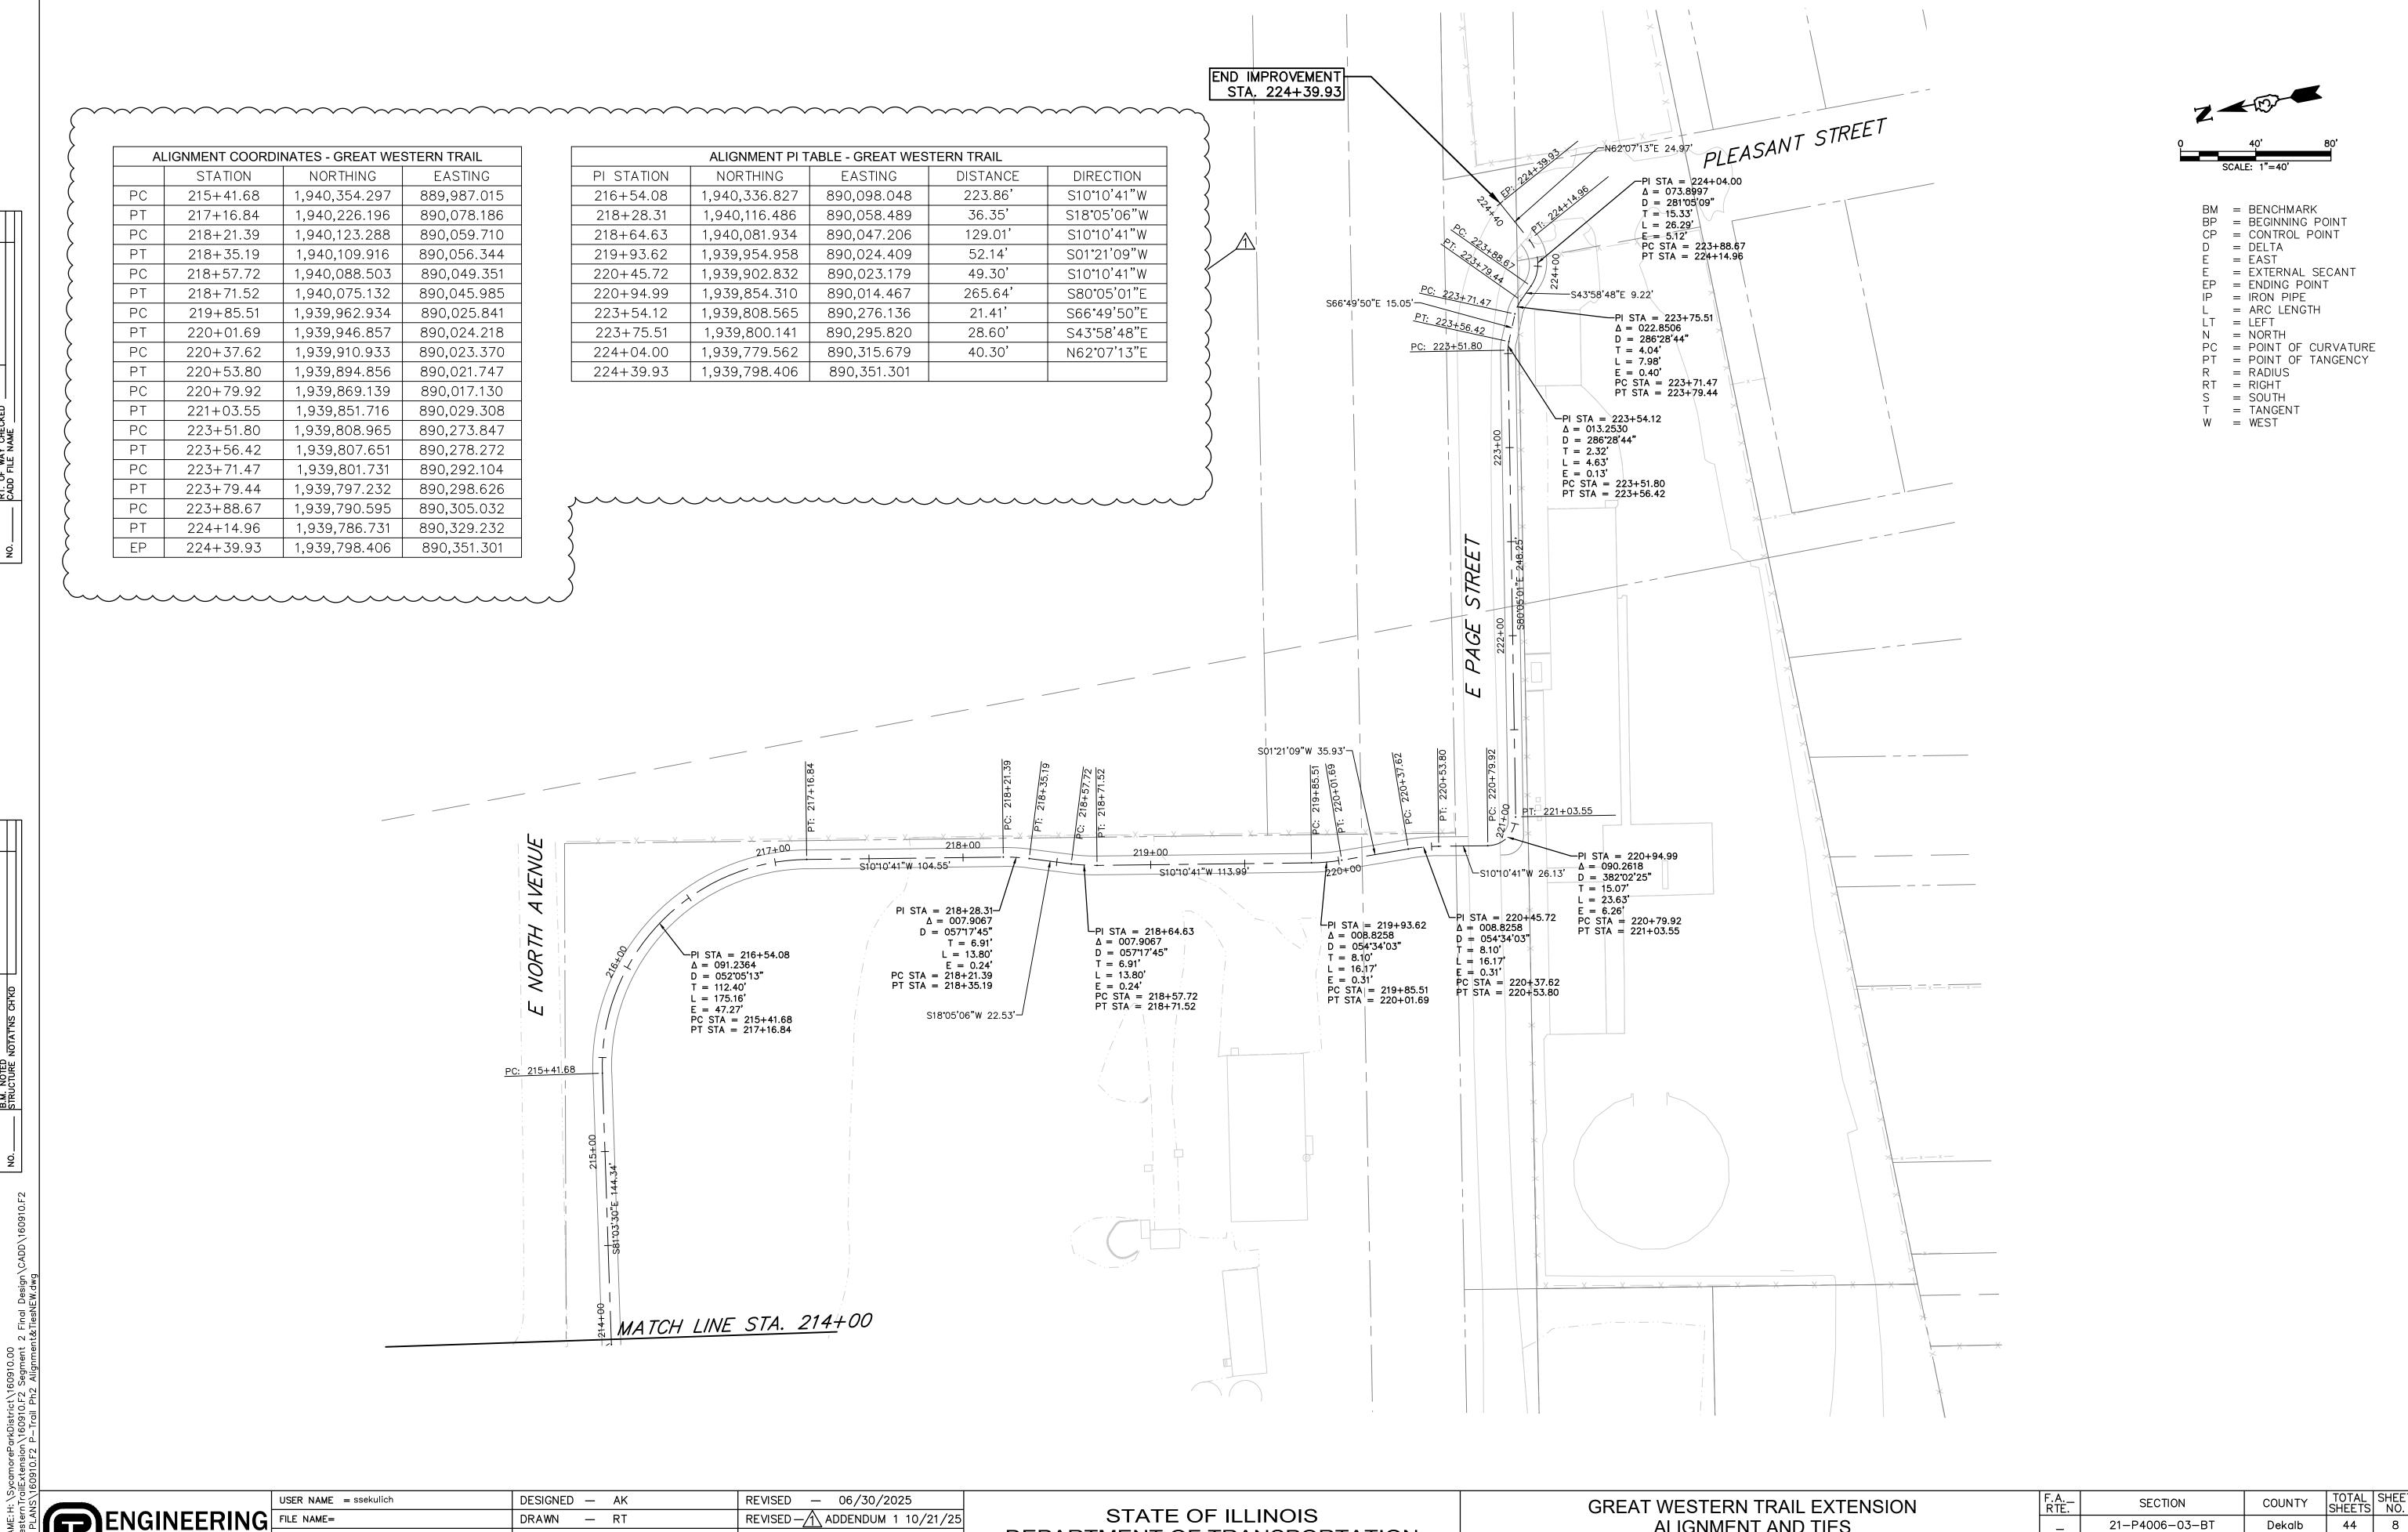

PLOT SCALE = \$SCALE\$ CHECKED — JM REVISED PLOT DATE = 10/22/2025 October 2023 REVISED — \_\_\_

DEPARTMENT OF TRANSPORTATION

**ALIGNMENT AND TIES** STA. 214+00 TO STA. 224+39.93 SHEET NO. 2 OF 2 SHEETS

SCALE: 1"=40'

CONTRACT NO. 87843 FED. ROAD DIST. NO. \_ | ILLINOIS | FED. AID PROJECT TYVE(417)