				CONSTRUCTION CODE			
			Ī	TAZEWELL COUNTY	TAZEWELL COUNTY		
					1000/ CTATE		
				90% FEDERAL 10% STATE	100% STATE		
CODE			TOTAL	BR I DGE	DECORATIVE LIGHTING		
CODE	ITEM	UNIT	TOTAL	0013	0021		
NO.	- · · - · ·		QUANTITY	S.N.090-0001	0021		
				5.14.090-0001			
52100560	ANCHOR BOLTS, 2"	EACH	8	8			
32100300	ANCHOR BOLTS, 2	EACH					
58700300	CONCRETE SEALER	SQ FT	5841	5841			
59000200	EPOXY CRACK INJECTION	FOOT	29	29			
66900200	NON-SPECIAL WASTE DISPOSAL	CU YD	1328	1328			
66900530	SOIL DISPOSAL ANALYSIS	EACH	3	3			
66900540	VOCS SOIL ANALYSIS	EACH	3	3			
66900545	SVOCS SOIL ANALYSIS	EACH	3	3			
				<u>-</u>			
66900550	PCBS SOIL ANALYSIS	EACH	3	3			
66900620	RCRA METALS AND PH SOIL ANALYSIS	EACH	3	3			
66900645	PESTICIDE SOIL ANALYSIS	EACH	3	3			
66901001	REGULATED SUBSTANCES PRE-CONSTRUCTION PLAN	LSUM	1	1			
66901002	ON-SITE MONITORING OF REGULATED SUBSTANCES	CAL DA	8	8			
66001005	DECLI ATED CURST ANGES SINAL CONSTRUCTION DECOR	,					
	REGULATED SUBSTANCES FINAL CONSTRUCTION REPORT			, /1\			
66901004	HERBICIDES SOIL ANALYSIS	EACH	3	° 7—			
67000400	ENGINEER'S FIELD OFFICE, TYPE A	CAL MO		16			

* SPECIALTY ITEM

MODJESKI and MASTERS
Experiences great bridges.

USER NAME = aecook DESIGNED - CSG REVISED -DRAWN - AEC REVISED -PLOT SCALE = 2.0000 ' / in. CHECKED - RLM REVISED -PLOT DATE = 8/15/2019 DATE - 8/9/2019 REVISED -

STATE OF ILLINOIS DEPARTMENT OF TRANSPORTATION

SUMMARY OF QUANTITIES SCALE: N.T.S. | SHEET 3 OF 12 SHEETS STA.

CONSTRUCTION CODE

*PEORIA/TAZEWELL

COUNTY TOTAL SHEET NO.

* 329 6 F.A.I. RTE. SECTION 90(10D-1)BRR CONTRACT NO. 68C89 TO STA.



6107	2019	8/8/2019	
DAB 1/16/2019	RLA 1/16/2019	KNB 8/8/	
NE C	Z	WED	

PAVEME	ENT MARKING REMO	VAL SCHEDULE	- EXIST	ING I-74			
			XOC	327980			
LOCATI	PAVEMENT MARKING REMOVAL - WATER BLASTING						
		3	SC	Q FT			
BEGIN STATION	END STATION	LETTERS AND SYMBOLS	4"	6"	8"	12"	
÷			j.				
PEORIA CO	DUNTY						
BEGIN I-74 PEORIA	MATCHLINE A		Į.				
MATCHLINE A	MATCHLINE B			28			
MATCHLINE B	MATCHLINE C		ĺ	627	291	85	
MATCHLINE C	MATCHLINE D		391	547	1488	136	
MATCHLINE D	MATCHLINE E			374			
MATCHLINE E	MATCHLINE F			342	156		
MATCHLINE F	133+00.00		j	5	677		
IL RTE 40 / A	DAMS ST						
IL RTE 40 / W JOHN H	. GWYNN JR AVE		į				
IL RTE 40 / ROMEO E	B GARRETT AVE						
IL RTE 40 / PE	RRY AVE						
IL RTE 40 / FA	YETTE ST						
IL RTE 40 / SPA	LDING AVE			42	144		
JEFFERSON AVE	/ FAYETTE ST				232		
IL RTE 40 / GLE	N OAK AVE		Ť		172		
TAZEWELL (COUNTY		İ				
BEGIN I-74 TAZEWELL	MATCHLINE G		j	29	478	121	
MATCHLINE G	MATCHLINE H		Ť	163	245		
MATCHLINE H	33+00.00			298	25		
33+00.00	46+50.00		169	423	346	214	
46+50.00	61+00.00		389	68	866	489	
61+00.00	67+00.00		285	32	912	235	
BEGIN WASHINGTON ST	21+00.00		9	5			
67+00.00	MATCHLINE J		617	69	58	107	
MATCHLINE J	END IL RTE 40	332	550	92	413	169	
135+60.00	144+00.00		696	130	482	164	
FROM TEMP PVMT MA	RKING SCHEDI II E		11.931		2.065	1.310	
TROW TENT FUNT WA	TATING GOLIEDULE		11,531	İ	2,003	1,310	
SUBTO	TAL	332	3,106	3,274	6,985	1,720	
TOTA	I		2	0.723			
IOIA	i E		3	0,123			

	l l	EMPORARY PAVEM			63	
		70300210	70300220	70300250	70300260	70300280
		TEMPORARY	TEMPORARY	TEMPORARY	TEMPORARY	TEMPORARY
LOCAT	IION	PAVEMENT	PAVEMENT	PAVEMENT	PAVEMENT	PAVEMENT
		MARKING LETTERS	MARKING - LINE 4"		MARKING - LINE 12"	
		AND SYMBOLS				
BEGIN STATION	END STATION	SQ FT	FOOT	FOOT	FOOT	FOOT
PEORIA C	COUNTY				18:	
BEGIN I-74 PEORIA	MATCHLINE A					
MATCHLINE A	MATCHLINE B		1,381			
MATCHLINE B	MATCHLINE C	144	4,803	1,649	171	
MATCHLINE C	MATCHLINE D		8,550	459	172	
MATCHLINE D	MATCHLINE E		3,049			
MATCHLINE E	MATCHLINE F		3,726		8	
MATCHLINE F	133+00.00		1,212			
IL RTE 40 / A	ADAMS ST	288				
IL RTE 40 / W JOHN H	H. GWYNN JR AVE	288				
IL RTE 40 / ROMEO	B GARRETT AVE	144				
IL RTE 40 / P		144				
IL RTE 40 / FA		144				
IL RTE 40 / SP/		144	239	72		
JEFFERSON AVE	/ FAYETTE ST		583		X	
IL RTE 40 / GLE		432	356			
IL RTE 40 C	OVER I-74					
TAZEWELL	COUNTY				90	
BEGIN I-74 TAZEWELL	MATCHLINE G		1,020	956	348	
MATCHLINE G	MATCHLINE H		2,245	19		
MATCHLINE H	33+00.00		3,102	18		
33+00.00	46+50.00		5,009		619	
46+50.00	61+00.00		3,639			
61+00.00	67+00.00		1,710			
BEGIN WASHINGTON ST	21+00.00		88			
67+00.00	MATCHLINE K		2,334		20	
MATCHLINE K	END IL RTE 40	696	2,655	454	99	36
TOTA	Λ Ι	2.424	45.701	3.627	1.429	36

				D5440444 444D 5	DISPOSAL OF BESULLAT	TED CLIDSTANGES					
	REMOVAL AND DISPOSAL OF REGULATED SUBSTANCES										Change error
	66900200	66901001	66901002	66901003	66900620	66900540	66900545	66900550	66900645	66900530	66901004
LOCATION	NON-SPECIAL WASTE DISPOSAL	REGULATED SUBSTANCES PRE-CONSTRUCTION PLAN	ON-SITE MONITORING OF REGULATED SUBSTANCES	REGULATED SUBSTANCES FINAL CONSTRUCTION REPORT	RCRA METALS & pH SOIL ANALYSIS	VOCS SOIL ANALYSIS	SVOCS SOIL ANALYSIS	PCBS SOIL ANALYSIS	PESTICIDE SOILS ANALYSIS	SOIL DISPOSAL ANALYSIS	HERBICIDES SOIL ANALYSIS
	CU YD	LUMP	CAL DA	LUMP	EACH	EACH	EACH	EACH	EACH	EACH	EACH
MBB PIERS 5 & 6	1,328	1	8	1	3	3	3	3	3	3	3 ,
TOTAL:	1,328	1	8	1	3	3	3	3	3	3	3
		•								N.	i

LANDSCAPING AND EROSION CONTROL								
5.	25000200	25000400	25000500	25000600	25100115	28000250	28000400	
5	CEEDING	NITROGEN	PHOSPHORUS	POTASSIUM	AALILGII	TEMPORARY	PERIMETER	
LOCATION	SEEDING,	FERTILIZER	FERTILIZER	FERTILIZER	MULCH,	EROSION	EROSION	
	CLASS 2	NUTRIENT	NUTRIENT	NUTRIENT	METHOD 2	CONTROL SEEDING	BARRIER	
78	ACRE	POUND	POUND	POUND	ACRE	POUND	FOOT	
CHANNEL EXCAVATION	0.6	54	54	54	0.6	60	460	
WASTE SITE ON I-474	WASTE SITE ON I-474		54	54	0.6	00	400	
TOTAL:	0.6	54	54	54	0.6	60	460	

	20300100
LOCATION	CHANNEL
LOCATION	EXCAVATION
	CU YD
	dij
TAZEWELL COUNTY	
SOUTH ABUTMENT	90
PIER 5	749
PIER 6	579
TOTAL	1,418

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3	© Copyright Hanson Professional Services Inc. 2019
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1	Hanson Professional Services Inc.

-	PLOT DATE = 8/15/2019	DATE	6	8/8/19	REVISED	£]
	PLOT SCALE = 2.00 ' / in.	CHECKED	201	KNB	REVISED	5
	4	DRAWN	-	RLA	REVISED	1
	USER NAME = Ander00846	DESIGNED		BAB	REVISED	. ⇒ ji

STAT	E OF	ILLINOIS
DEPARTMENT	OF	TRANSPORTATION

SCALE:

ŀ	-74 MURR	RAY BAKE	R BRIDG	E	F.A.I. RTE.	SECTION		COL
	SCHEDUL	F OF OU	ANTITIES		74	90(10D-1)BRR		TAZE
	JUILDUL	L 01 407	NITTIES		13,50			CONT
SHEET	OF	SHEETS	STA	TO STA		THINOIS	T cen /	ND BBOIE

LIGHTING LEGEND:

 \bowtie R EXISTING NAVIGATION OBSTRUCTION LIGHTING CONTROLLER TO BE REMOVED.

EXISTING JUNCTION BOX TO BE REMOVED.

EXISTING CABLE AND CONDUIT TO BE REMOVED.

PROPOSED ELECTRIC CABLE IN EXISTING EMBEDDED CONDUIT.

EXISTING CABLE IN EXISTING CONDUIT TO BE REMOVED.

SIZE AS NOTED ON PLAN.

Ø R EXISTING NAVIGATIONAL LIGHT TO BE REMOVED.

O—O R EXISTING LUMINAIRE AND MAST ARM TO BE REMOVED.

R EXISTING PARAPET MOUNTED LIGHT POLE TO BE REMOVED, NO SALVAGE.

PROPOSED NAVIGATION OBSTRUCTION LIGHTING CONTROLLER.

PROPOSED JUNCTION BOX, SIZE AS NOTED ON PLAN.

PROPOSED CABLE AND CONDUIT, SIZE AS NOTED ON PLAN.

PROPOSED RED NAVIGATIONAL LIGHT, LED, 180°.

PROPOSED GREEN NAVIGATIONAL LIGHT, LED, 360°

PROPOSED LUMINAIRE, LED, ROADWAY, OUTPUT DESIGNATION E, 240V, 4' MAST ARM AND 22' M H

PROPOSED LIGHT POLE, GALVANIZED STEEL, 35' M.H., 8' MAST ARM, LUMINAIRE, LED, ROADWAY, OUTPUT DESIGNATION F, 240V. ON NEW PARAPET WALL FOUNDATION. SEE STRUCTURAL PLANS FOR FOUNDATION DETAIL.

CABLE/CONDUIT SCHEDULE:

ELECTRIC CABLE IN CONDUIT, 600V (XLP-TYPE USE) 2-1C NO.8, 1/C NO.8 GROUND IN 2" DIA., PVC CONDUIT EMBEDDED IN STRUCTURE.

ELECTRIC CABLE IN CONDUIT, 600V (XLP-TYPE USE) 2-1C NO.8, 1/C NO.8 GROUND IN 3/4" DIA., STAINLESS STEEL CONDUIT ATTACHED TO STRUCTURE

2" DIA., PVC CONDUIT EMBEDDED IN STRUCTURE.

HIGHWAY STANDARDS

000001-07 STANDARD SYMBOLS, ABBREVIATIONS, AND PATTERNS DECIMAL OF AN INCH AND OF A FOOT

701001-02 OFF-ROAD OPERATIONS, 2L, 2W, MORE THAN 15' AWAY 701006-05 OFF-ROAD OPERATIONS, 2L, 2W, 15' TO 24" FROM PAVEMENT EDGE

701101-05 OFF-ROAD OPERATIONS, MULTILANE, 15' TO 24" FROM PAVEMENT EDGE

701106-02 OFF-ROAD OPERATIONS, MULTILANE, MORE THAN 15' AWAY

DESIGNED - MKR

CHECKED - MKR

DRAWN

CHECKED -

REVISED -

REVISED -

REVISED -

REVISED

701456-05 PARTIAL EXIT RAMP CLOSURE FREEWAY / EXPRESSWAY

701901-08 TRAFFIC CONTROL DEVICES

812001 RACEWAY EMBEDDED IN STRUCTURE

821101-02 LUMINAIRE WIRING IN POLE

** 826001-02 NAVIGATION OBSTRUCTION LIGHTING CONTROLLER, 240V

830001-03 LIGHT POLE, STEEL MAST ARM

830021-03 LIGHT POLE STEEL TENON TOP

836001-04 LIGHT POLE FOUNDATION 838001-01 BREAKAWAY DEVICES

BOTH SPARE 20A CIRCUIT BREAKERS LABELED AS "REQUIRED BUT NOT SHOWN" SHALL BE USED FOR **FUTURE ROADWAY LIGHTING CIRCUITS** CONTROLLER SHALL BE EQUIPPED WITH AN ADDITIONAL 20AMP SINGLE POLE CIRCUIT BREAKER TO POWER PROPOSED RWIS CONTROL CABINET.

USER NAME =

PLOT DATE =

BILL OF MATERIALS:

PAY ITEM	UNIT	QUANTITY
ELECTRIC SERVICE INSTALLATION	EACH	1
CONDUIT EMBEDDED IN STRUCTURE, 2" DIA., PVC	FOOT	8,650
JUNCTION BOX, STAINLESS STEEL, ATTACHED TO STRUCTURE, 10" X 6" X 4"	EACH	28
JUNCTION BOX, STAINLESS STEEL, ATTACHED TO STRUCTURE, 14" X 8" X 6"	EACH	42
JUNCTION BOX, STAINLESS STEEL, ATTACHED TO STRUCTURE, 18" X 12" X 8"	EACH	2
ELECTRIC CABLE IN CONDUIT, 600V (XLP-TYPE USE) 3-1/C NO. 8	FOOT	10,000
LUMINAIRE, LED, ROADWAY, OUTPUT DESIGNATION E	EACH	28
LUMINAIRE, LED, ROADWAY, OUTPUT DESIGNATION F	EACH	5
WATERWAY OBSTRUCTION WARNING LUMINAIRE, LED, 180 DEGREE RED, PARAPET MOUNTED	EACH	6
WATERWAY OBSTRUCTION WARNING LUMINAIRE, LED, 360 DEGREE GREEN, PARAPET MOUNTED	EACH	2
NAVIGATION OBSTRUCTION LIGHTING CONTROLLER	EACH	1
LIGHT POLE, GALVANIZED STEEL, 35 FT. M.H., 8 FT. MAST ARM	EACH	5
REMOVAL OF LIGHTING UNIT, NO SALVAGE	EACH	5
REMOVAL OF LIGHTING CONTROLLER	EACH	1
REMOVAL OF ELECTRIC SERVICE INSTALLATION	EACH	1
REMOVE ELECTRIC CABLE FROM CONDUIT	FOOT	1,674
REMOVAL OF LIGHTING LUMINAIRE, NO SALVAGE	EACH	22
MAST ARM, STREET LIGHTING, 4'	EACH	28
CONDUIT ATTACHED TO STRUCTURE, 3/4" DIA. STAINLESS STEEL	FOOT	728
CONDUIT ATTACHED TO STRUCTURE, 2" DIA., STAINLESS STEEL	FOOT	30
REMOVE EXISTING JUNCTION BOX	EACH	35
LUMINAIRE MOUNTING BRACKET - SPECIAL	EACH	28
REMOVAL OF EXISTING NAVIGATION LIGHTING	EACH	8
MAINTENANCE OF NAVIGATION LIGHTING SYSTEM	CAL MO	12
LIGHT POLE FOUNDATION, INTEGRAL WITH BARRIER WALL	EACH	5
REMOVE EXISTING CONDUIT ATTACHED TO STRUCTURE	FOOT	880

INDEX OF SHEETS

CABLE/CONDUIT SCHEDULE, GENERAL NOTES, HIGHWAY STANDARDS, INDEX OF SHEETS, LIGHTING LEGEND, AND BILL OF MATERIALS.

STATE OF ILLINOIS

DEPARTMENT OF TRANSPORTATION

- L-2 NAVIGATION LIGHTING REMOVAL PLAN.
- NAVIGATION LIGHTING REMOVAL PLAN.
- L-4 LIGHTING REMOVAL PLAN.
- L-5 LIGHTING REMOVAL PLAN.
- PROPOSED NAVIGATION LIGHTING PLAN.
- PROPOSED NAVIGATION LIGHTING PLAN.
- PROPOSED LIGHTING PLAN.
- PROPOSED LIGHTING PLAN
- L-10 PROPOSED LIGHTING PLAN.
- L-11 PROPOSED LIGHTING PLAN
- L-12 LIGHTING DETAILS.
- L-13 LIGHTING DETAILS.
- L-14 LIGHTING DETAILS.
- L-15 WIRING DIAGRAM.
- L-16 LUMINAIRE PERFORMANCE TABLES
- L-17 ELECTRICAL SERVICE DETAILS.

GENERAL NOTES:

THE CONTRACTOR SHALL STAGE THE REMOVAL OF EXISTING LIGHT POLES AND INSTALLATION OF NEW POLES SO THAT THE ROADWAY IS ADEQUATELY LIT

THE CONTRACTOR SHALL STAGE THE REMOVAL OF THE EXISTING NAVIGATION LIGHTING AND THE INSTALLATION OF NEW NAVIGATION LIGHTING SO AS TO MAINTAIN CONTINUOUS OPERATION OF THE NAVIGATION LIGHTING SYSTEM

- THE LOCATION OF ALL UTILITIES AND PRIVATELY OWNED FACILITIES SHALL BE FIELD VERIFIED BY THE CONTRACTOR PRIOR TO THE INSTALLATION OF ANY COMPONENTS.
- THE CONTRACTOR SHALL VERIFY FIELD CONDITIONS PRIOR TO BIDDING. THERE WILL BE NO ADDITIONAL COMPENSATION PAID FOR CLAIMS THAT ARISE FROM A FAILURE TO FULLY INVESTIGATE EXISTING FIELD CONDITIONS.
- IT IS THE CONTRACTOR'S RESPONSIBLITY TO ADEQUATELY IDENTIFY AND LOCATE ALL EXISTING UNDERGROUND FACILITIES WITHIN THE LIMITS OF THE PROJECT. THE CONTRACTOR SHALL BE LIABLE FOR ANY DAMAGE TO IDOT FACILITIES RESULTING FROM INACCURATE LOCATING.
- ELECTRICAL WORK SHALL CONFORM WITH NATIONAL, STATE, AND LOCAL CODES.
- THE CONTRACTOR SHALL PROVIDE ELECTRICAL CABLE SLACK IN ACCORDANCE WITH
- ELECTRICAL CABLE WILL BE MEASURED FOR PAYMENT IN ACCORDANCE WITH ARTICLE 817.04.
- ALL SURPLUS MATERIALS SHALL BE DISPOSED OF IN ACCORDANCE WITH ARTICLE 202.03 OF THE STANDARD SPECIFICATIONS
- THE COST OF REMOVING THE EXISTING WIRING WILL NOT BE PAID SEPARATELY, BUT SHALL BE INCLUDED IN THE COST OF THE LIGHTING REMOVAL ITEMS.
- 11. THE CONTRACTOR SHALL DISPOSE OF THE EXISTING LIGHTING EQUIPMENT (LIGHT POLES, LUMINAIRE ARMS, LUMINAIRES, WIRING, CONDUIT, LIGHTING CONTROLLER, ETC). OFF THE JOB SITE. THE SALVAGE COST OF THESE ITEMS SHALL BE INCLUDED IN THE BID PRICES FOR THE LIGHTING REMOVAL PAY ITEMS
- 12. THE CONTRACTOR SHALL FURNISH AND INSTALL FLEXIBLE LIQUID TIGHT CONDUIT AS REQUIRED FOR THE PROPOSED LIGHTING INSTALLATION. THE COST OF THE FLEXIBLE LIQUID TIGHT CONDUIT SHALL BE INCLUDED IN THE COST OF THE PROPOSED CONDUIT.
- THE CONTRACTOR SHALL FURNISH AND INSTALL ALL ITEMS REQUIRED TO ATTACH THE CONDUITS AND JUNCTION BOXES TO THE STRUCTURE, INCLUDING, BUT NOT LIMITED TO UNI-STRUT, BRACKETS, FLEXIBLE LIQUID TIGHT CONDUIT, LB CONDUIT, FITTINGS, HARDWARE, AND OTHER MISCELLANEOUS ITEMS. THESE ITEMS SHALL BE STAINLESS STEEL OR HOT-DIPPED GALVANIZED STEEL AND WILL NOT BE PAID FOR SEPARATELY, BUT SHALL BE INCLUDED IN THE BID PRICE FOR THE CONDUIT ATTACHED TO STRUCTURE AND JUNCTION BOX PAY ITEMS.
- CONDUIT ATTACHMENT BRACKETS SHALL BE INSTALLED AT 8 FT. SPACINGS (MAXIMUM) ON STRUCTURES.
- THE CONTRACTOR SHALL FURNISH AND INSTALL EXPANSION/DEFLECTION COUPLINGS (OR OTHER EQUIPMENT AND METHODS AS APPROVED BY THE ENGINEER) FOR ALL BRIDGE JOINTS AS SHOWN ON THE PLAN SHEETS AND DIRECTED BY THE ENGINEER. THE COST OF THIS WORK SHALL BE INCLUDED IN THE COST OF THE PROPOSED CONDUIT.
- ALL FLEXIBLE LIQUID TIGHT CONDUIT SHALL BE NON-METALLIC AND SHALL INCLUDE CONNECTORS WITH INTEGRAL STAINLESS STEEL KELLUM GRIPS AT THE ENDS FOR INCREASED STRENGTH AND DURABILITY
- 17. ALL CONDUIT ATTACHMENT BRACKETS AND HARDWARE SHALL BE STAINLESS STEEL.
- THE CONTRACTOR SHALL INSTALL THREAD LOCKER ON ALL ATTACHED GALVANIZED CONDUIT THREADED CONNECTIONS TO PREVENT LOOSENING THROUGH VIBRATION.

L-1

*PEORIA/TAZEWEL

SECTION COUNTY CABLE/CONDUIT SCHEDULE, GENERAL NOTES, HIGHWAY STANDARDS, INDEX OF SHEETS, REPORT OF 90(10D-1)BRR 329 LIGHTING LEGEND, AND BILL OF MATERIALS. CONTRACT NO. 68C89 SHEETS

8/16/2019 4:20:00 PM

/1\ REV. 11/1/19

INDEX OF SHEETS

SHEET NUMBER	SHEET TITLE
100	DECORATIVE LIGHTING SHEET INDEX AND GENERAL NOTES
101	SCHEDULE OF QUANTITIES - CONDUIT AND CONDUCTORS
102	SCHEDULE OF QUANTITIES - CONDUIT AND CONDUCTORS
103	SCHEDULE OF QUANTITIES - CONDUIT AND CONDUCTORS
104	SCHEDULE OF QUANTITIES - ELECTRICAL ITEMS
105	LIGHTING CRITERIA AND CONSTRUCTION NOTES
106	EXISTING LIGHTING SYSTEM REMOVALS
107	REMOVAL DETAILS
108	KEY PLAN
109	ELEVATION VIEW - POSITION 06 - 10
110	ELEVATION VIEW - POSITION 11 - 17
111	ELEVATION VIEW - POSITION 18 - 24
112	ELEVATION VIEW - POSITION 25 - 31
113	ELEVATION VIEW - POSITION 32 - 38
114	ELEVATION VIEW - POSITION 39 - 45
115	ELEVATION VIEW - POSITION 46 - 52
116	ELEVATION VIEW - POSITION 53 - 59
117	ELEVATION VIEW - POSITION 60 - 66
118	ELEVATION VIEW - POSITION 67 - 73
119	ELEVATION VIEW - POSITION 74 - 78
120	PLAN - POSITION 06 - 10
121	PLAN - POSITION 11 - 17
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123	PLAN - POSITION 25 - 31
124	PLAN - POSITION 32 - 38
125	PLAN - POSITION 39 - 45
126	PLAN - POSITION 46 - 52
127	PLAN - POSITION 53 - 59
128	PLAN - POSITION 60 - 66
129	PLAN - POSITION 67 - 73
130	PLAN - POSITION 74 - 78
131	SCHEDULES - WIRE AND CABLE
132	SCHEDULES - WIRE, CABLE AND CONDUIT
133	SCHEDULES - WIRE, CABLE AND CONDUIT
134	SCHEDULES - WIRE, CABLE AND CONDUIT
135	SCHEDULES - WIRE, CABLE AND CONDUIT
136	SCHEDULES - WIRE, CABLE AND CONDUIT
137	SCHEDULES - WIRE, CABLE AND CONDUIT
138	SCHEDULES - WIRE, CABLE AND CONDUIT
139	SCHEDULES - WIRE, CABLE AND CONDUIT
140	SCHEMATIC DIAGRAM - POSITION 06 -17 (WEST)
141	SCHEMATIC DIAGRAM - POSITION 18 - 31 (WEST)
142	SCHEMATIC DIAGRAM - POSITION 32 - 45 (WEST)
143	SCHEMATIC DIAGRAM - POSITION 46 - 59 (WEST)
144	SCHEMATIC DIAGRAM - POSITION 60 - 73 (WEST)
145	SCHEMATIC DIAGRAM - POSITION 74 - 78 (WEST)
146	SCHEMATIC DIAGRAM - POSITION 06 -17 (EAST)
147	SCHEMATIC DIAGRAM - POSITION 18 - 31 (EAST)
148	SCHEMATIC DIAGRAM - POSITION 32 - 45 (EAST)
149	SCHEMATIC DIAGRAM - POSITION 46 - 59 (EAST)
150	SCHEMATIC DIAGRAM - POSITION 60 - 73 (EAST)
151	SCHEMATIC DIAGRAM - POSITION 74 - 78 (EAST)
152A	CONTROL CABINET DOWNER DETAILS
152B	CONTROL CABINET POWER DETAILS
152C 153	LUMINAIRE WIRING DETAILS
	LUMINAIRE MOUNTING DETAILS
	LUMINAIRE MOUNTING DETAILS
154	LUMINAIDE MOUNTING DETAILS, DIEDS
154 155	LUMINAIRE MOUNTING DETAILS - PIERS
154	LUMINAIRE MOUNTING DETAILS - PIERS CONDUIT MOUNTING DETAILS NORTH CONTROL CABINET SITE PLAN


GENERAL NOTES

- 1. PROVIDE ALL LABOR, MATERIALS, AND EQUIPMENT TO FURNISH AND INSTALL THE ELECTRICAL WORK AS SHOWN ON THE PLANS, AS DETAILED IN THE SPECIFICATIONS, AS REQUIRED BY THE NATIONAL ELECTRICAL CODE (NEC), AND AS REQUIRED FOR SPECIFIED OPERATION. CONTRACTOR SHALL EMPLOY ONLY EXPERIENCED ELECTRICIANS. A DULY LICENSED ELECTRICIAN SHALL SUPERVISE ALL WORK. CONTRACTOR SHALL ENSURE THAT ALL EMPLOYEES ARE FAMILIAR WITH THE TYPE OF WORK ENCOUNTERED ON THE PROJECT. ALL MATERIALS AND EQUIPMENT PROVIDED, WHERE APPLICABLE, SHALL HAVE A UL OR FM "LISTING MARK" AFFIXED TO THEM OR THEIR PACKING CONTAINERS AND THEY SHALL MEET ALL UL OR FM AND NEC STANDARDS FOR THEIR INDICATED USE.
- 2 WHEREVER THE TERM "STANDARD SPECIFICATIONS" IS USED. IT SHALL MEAN "STANDARD SPECIFICATIONS FOR ROAD AND BRIDGE CONSTRUCTION 2016 EDITION BY THE ILLINOIS DEPARTMENT OF TRANSPORTATION."
- 3. CONTRACTOR SHALL VERIFY THE LOCATION OF ALL EXISTING UTILITIES BEFORE BEGINNING CONSTRUCTION AND SHALL PROTECT ALL EXISTING UNDERGROUND FACILITIES FROM DAMAGE AND DISRUPTION. CONTRACTOR SHALL PHYSICALLY LOCATE ALL UTILITIES IN THE AFFECTED AREA, REGARDLESS OF THE OWNERSHIP OF THE UTILITY. JULIE LOCATING ALONE IS NOT SUFFICIENT. METHODS THE CONTRACTOR SHALL USE INCLUDE HAND DIGGING, VACUUM POTHOLING, PROBING, ELECTRONIC LOCATING USING CONTRACTOR'S OWN EQUIPMENT, VISUAL SURVEY OF NEARBY FACILITIES (MANHOLES, INLETS, STREET BOXES, HYDRANTS AND THE LIKE), CITY SEWER MAPS, IN SHORT: ANY METHOD DEEMED BY THE CONTRACTOR TO BE SUFFICIENT TO PREVENT ANY DAMAGE OR DISRUPTION TO EXISTING UTILITIES. FIELD LOCATING OF UTILITIES SHALL BE INCLUDED WITH THE ASSOCIATED PAY ITEM. CONTRACTOR SHALL REPAIR AND RESTORE ANY UNDERGROUND UTILITIES DAMAGED OR DISRUPTED DURING CONSTRUCTION OPERATIONS TO THE SATISFACTION OF THE UTILITY OWNER AT CONTRACTOR'S OWN EXPENSE
- 4. PLANS AND SPECIAL PROVISIONS DETAIL ONE METHOD OF WIRING FOR THE DMX CONTROL SYSTEM THAT IS BASED ON THE DMX-512 OPEN PROTOCOL WIRING METHODS. SOME EQUIPMENT REFERENCED ON THE PLANS AND IN THE SPECIAL PROVISIONS INCLUDES EQUIPMENT AVAILABLE FROM A SINGLE MANUFACTURER. OTHER EQUIPMENT AND WIRING METHODS BY OTHER MANUFACTURERS FOR APPLYING A DMX-512 COMPLIANT SYSTEM IS ACCEPTABLE. THE MANUFACTURER OF THE LIGHTING EQUIPMENT AND ASSOCIATED POWER AND CONTROL SYSTEM SHALL BE RESPONSIBLE TO PROVIDE ALL DETAILS OF INSTALLATION FOR THE SYSTEM PROVIDED. MANUFACTURER SHALL UTILIZE WIRING METHODS AND EQUIPMENT THAT PROVIDE RELIABLE, ROBUST, AND REPEATABLE OPERATION WHEN INSTALLED FOR THIS SPECIFIC APPLICATION. SUBMIT SHOP DRAWINGS THAT INCLUDE SPECIFIC DETAILS OF THE CIRCUITRY REQUIRED FOR THE MANUFACTURER'S SPECIFIC EQUIPMENT FOR THIS SPECIFIC APPLICATION AND CONSIDERATION SHALL BE GIVEN TO CIRCUIT WIRING LENGTHS, DMX WIRING RESTRICTIONS. VOLTAGE DROP. CIRCUIT LOADING. SURGE PROTECTION OF LUMINAIRES (POWER AND SIGNAL CONNECTIONS), AND SURGE PROTECTION FOR THE LIGHTING CONTROLLER MOUNTED EQUIPMENT (FIELD AND POWER WIRING).
- 5. CONTRACTOR SHALL EVALUATE REMOVED MATERIALS AND EQUIPMENT BEFORE DISPOSAL. HANDLING AND DISPOSAL OF HAZARDOUS MATERIALS SHALL BE ACCOMPLISHED AS REQUIRED FOR THE MATERIALS AND EQUIPMENT REMOVED RECYCLE THE LED AND DRIVER ELECTRONICS COMPONENTS WITH A LICENSED RECYCLER. DISPOSE OTHER REMOVED MATERIAL AS REQUIRED BY THE GOVERNING LAWS. SPECIAL HANDLING AND DISPOSAL SHALL NOT BE MEASURED SEPARATELY AND IS INCLUDED IN THE ASSOCIATED PAY ITEM.
- 6. THE DETAILS SHOWN IN THE PLANS FOR THE FABRICATION OF THE LUMINAIRE SUPPORTS INDICATE MATERIALS OF CONSTRUCTION AND GENERAL FABRICATION REQUIREMENTS. DIMENSIONS SHOWN ARE PROVIDED FOR GENERAL GUIDANCE. EVERY MOUNTING LOCATION IS UNIQUE, AND THE SUPPORT STRUCTURE PROVIDED FOR EACH LOCATION SHALL BE FABRICATED FOR THAT SPECIFIC UNIQUE SITUATION. PROVIDE THE LUMINAIRE SUPPORT STRUCTURE REQUIRED FOR EACH SITUATION AT THE BID PRICE AND NO ADDITIONAL PAYMENT WILL BE MADE. SUBMIT SHOP DRAWINGS TO THE ENGINEER FOR REVIEW FOR THE PROPOSED LUMINAIRE SUPPORTS BEFORE FABRICATION BEGINS.

- 7. THE DECORATIVE LIGHTING SYSTEM DESCRIBED IN THE PLANS AND SPECIAL PROVISIONS IS BASED ON THE EQUIPMENT OF A SPECIFIC MANUFACTURER. OTHER MANUFACTURER'S EQUIPMENT IS ACCEPTABLE, HOWEVER IT MUST MEET THE DESIGN INTENT DESCRIBED IN THESE DOCUMENTS, WHETHER SPECIFICALLY STATED OR IMPLIED BY THE DESIGN DETAILS. AN OPEN PLATFORM CONTROL SYSTEM HAS BEEN DESCRIBED THAT UTILIZES USITT DMX 512 PROTOCOL WITH RDM (REMOTE DEVICE MANAGEMENT, ANSI E1.20) ENHANCEMENT TO ALLOW BI-DIRECTIONAL COMMUNICATION BETWEEN THE LIGHTING SYSTEM CONTROLLER AND EACH LUMINAIRE. PROPOSED SYSTEMS BY OTHER MANUFACTURERS SHALL UTILIZE THE SAME DMX/RDM PROTOCOL THE MANUFACTURER SHALL PROVIDE A SYSTEM OF THEIR OWN DESIGN THAT MEETS THE DESIGN INTENT OF THESE DOCUMENTS AND CONFORMS TO THE METHODS OF THE MANUFACTURER TO PROVIDE A ROBUST AND RELIABLE CONTROL SYSTEM THAT IS SPECIFICALLY DESIGNED FOR THIS APPLICATION. THE MANUFACTURER'S PROPOSED SYSTEM SHALL TAKE INTO CONSIDERATION THE RESTRICTIONS IMPOSED FOR LOCATING AND MOUNTING EQUIPMENT TO THE BRIDGE STRUCTURE. BRIDGE MOUNTED EQUIPMENT SHALL BE LIMITED TO CONDUIT, JUNCTION BOXES, SIGNAL SPLITTERS, BOOSTERS, AND LUMINAIRES. PROPOSALS FOR MOUNTING ADDITIONAL EQUIPMENT SHALL BE REVIEWED AND ACCEPTED BY THE ENGINEER AND OWNER BEFORE PROCEEDING WITH THESE MODIFICATIONS. THE MANUFACTURER SHALL SUBMIT TO THE ENGINEER FOR REVIEW SHOP DRAWINGS FOR THE COMPLETE CONTROL SYSTEM. SUBMITTAL SHALL INCLUDE LIGHTING CONTROLLER PANEL DRAWINGS (INTERIOR, EXTERIOR LAYOUT DRAWINGS, PANEL WIRING DRAWINGS, CONTROL AND POWER ONE-LINES, FIELD WIRING DRAWINGS AND SPEC SHEETS FOR ALL CONTROL EQUIPMENT) SUBMIT TO THE ENGINEER FOR REVIEW SHOP DRAWINGS AND PRODUCT DATA FOR THE DECORATIVE LIGHTING SYSTEM 45 DAYS AFTER
- 8. THE EQUIPMENT MOUNTED ON THE BRIDGE WILL BE EXPOSED TO HARSH OUTDOOR CONDITIONS SUCH AS EXTREME HIGH AND LOW TEMPERATURES, SUN EXPOSURE. HUMIDITY. RAIN. SNOW. ICE THAT IS TYPICAL FOR THIS GEOGRAPHIC AREA. PROXIMITY TO THE ROADWAY WILL ALSO EXPOSE THE INSTALLATION TO ROAD DE-ICING SALT SPRAY. THE BRIDGE STRUCTURE EXPERIENCES VIBRATION FROM VARIOUS SOURCES WITH VARIOUS FREQUENCIES AND INTENSITIES. STEEL COMPONENTS AND FABRICATED ASSEMBLIES SHALL BE HOT-DIPPED GALVANIZED AFTER FABRICATION AND CUTTING TO SIZE (I.E. CHANNEL STRUT USED FOR CONDUIT AND JUNCTION BOX SUPPORTS) SEAL ALL FIELD CUT THREADS AND SUPPORTS (I.E. CHANNEL STRUT USED FOR CONDUIT AND JUNCTION BOX SUPPORTS) WITH APPROPRIATE COLD GALVANIZING TREATMENT. FASTENERS AND WASHERS SHALL BE HOT-DIPPED GALVANIZED. THE CONTRACTOR SHALL TAKE EXTREME CARE WITH THIS INSTALLATION TO MAKE JOINTS TIGHT. FASTENERS SECURE TO MANUFACTURER'S SPECIFICATION, USE THREAD SEAL AND LOCK COMPOUND ON FASTENERS AND JOINT SEALANT ON THREADED JOINTS TO SEAL AND LOCK THE JOINT FROM LOOSENING FROM VIBRATION.

CONTRACT EXECUTION.....

FINAL CONNECTION TO EACH LUMINAIRE (FIXTURE WHIP) SHALL BE FLEXIBLE CABLE THAT CONTAINS A 2-PAIR, TWISTED SHIELDED DMX-512 COMPLIANT CABLE (120 OHM) AND POWER CONDUCTORS. THIS CONNECTION SHALL BE ACCOMPLISHED WITH EITHER A SINGLE CABLE (CONTROL AND POWER) OR TWO SEPARATE CABLES (ONE CONTROL, ONE POWER) UTILIZING NON-COMPLIANT CABLE FOR DMX/RDM SIGNALS IS NOT ALLOWED. FIXTURE WHIPS SHALL BE CONSTRUCTED TO ALLOW LENGTHS OF CABLE NEEDED TO REACH THE LUMINAIRE JUNCTION BOXES FROM EVERY LUMINAIRE AS SHOWN ON THE PLAN DETAIL SHEETS AND AS REQUIRED FOR THE ACTUAL INSTALLATION, DMX DIGITAL COMMUNICATIONS CABLING SHALL BE CONSTRUCTED FROM DMX-512 COMPLIANT CABLING AND SHALL CONFORM TO ALL MATERIAL AND INSTALLATION STANDARDS AND BEST INDUSTRY PRACTICES FOR INSTALLATION AND OPERATION IN EXTREME OUTDOOR ENVIRONMENTS. ALL LUMINAIRE FIXTURE WHIPS AND ASSOCIATED POWER CABLING SHALL BE EQUIPPED WITH STRAIN RELIEF AT EACH FIXED END AS WELL AS INTERMEDIATE CABLE SUPPORTS TO PREVENT CABLE MOVEMENT AND, ______ LOOSENING FROM WIND AND VIBRATION

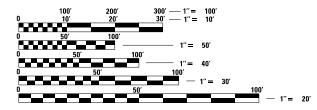

FULL SIZE PLANS HAVE BEEN PREPARED USING STANDARD ENGINEERING SCALES, REDUCED SIZED PLANS WILL NOT CONFORM TO STANDARD SCALES. IN MAKING MEASUREMENTS ON REDUCED PLANS, THE ABOVE SCALES MAY BE USED.

JOINT UTILITY LOCATING INFORMATION FOR EXCAVATORS 1-800-892-0123 OR 811



100 WALNUT ST., SUITE 200 PEORIA, ILLINOIS 61602 (309) 689-9888 / info@f-w.com

PROJECT # 0181069.00



This seal applies to Decorative Lighting Sheets #100 to #158.

				_		
	TOTAL BILL OF MATERIALS					
PAY CODE	DESCRIPTION	UNIT	TOTAL QUANTITY			
81100200	CONDUIT ATTACHED TO STRUCTURE, 3/4" DIA., GALVANIZED STEEL	FOOT	7,944	1		
81100600	CONDUIT ATTACHED TO STRUCTURE, 2" DIA., GALVANIZED STEEL	FOOT	12,330	1		
81300710	JUNCTION BOX, STAINLESS STEEL, ATTACHED TO STRUCTURE, 16" X 12" X 6"	EACH	56	1		
81702101	ELECTRIC CABLE IN CONDUIT, 600V (XLP-TYPE USE) 1/C NO. 14	FOOT	14,400	1		
81702120	ELECTRIC CABLE IN CONDUIT, 600V (XLP-TYPE USE) 1/C NO. 8	FOOT	34,320	1		
84500110	REMOVAL OF LIGHTING CONTROLLER	EACH	1	1		
X0325541	REMOVE EXISTING LIGHTING SYSTEM	LSUM	1	1		
X1400375	DMX CONTROL CABLE IN CONDUIT	FOOT	32,944]		
X1400376	CONTROL CABINET, BASE MOUNT (SPECIAL)	EACH	2	1		
X1400377	CBX SPLITTER BOX	EACH	38	1		
X8040102	ELECTRIC SERVICE INSTALLATION, SPECIAL	EACH	2	1		
X8130110	JUNCTION BOX (SPECIAL)	EACH	177]		
X8212031	LUMINAIRE, TYPE A (SPECIAL)	EACH	144	l		
X8212032	LUMINAIRE, TYPE B (SPECIAL)	EACH	286			
X8212033	LUMINAIRE, TYPE C (SPECIAL)	EACH	72			
X8710035	FIBER OPTIC CABLE 96 FIBERS, SINGLE MODE	FOOT	2,572]		

<u> F.A.I. 74 - SECTION 90(10D-1)BRR</u> PEORIA / TAZEWELL COUNTY STATION 151+85 STRUCTURE NO. 090-0001

Farnsworth

USER NAME = rtarntino	DESIGNED - DAR	REVISED 10/18/19
	CHECKED - JDA	REVISED
PLOT SCALE = 24:0 ':" / ft.	DRAWN - RJT	REVISED
PLOT DATE = 09/06/19	CHECKED - JJO	REVISED

STATE OF ILLINOIS **DEPARTMENT OF TRANSPORTATION** **DECORATIVE LIGHTING SHEET INDEX AND GENERAL NOTES** MURRAY BAKER BRIDGE OVER ILLINOIS RIVER SHEET 1 OF 1 SHEETS


F.A. I. RTE.	SECTION		COUNTY	TOTAL SHEETS	SHEET NO.	
74	74 90(10D-1)BRR		**	329	100	
				CONTRACT	NO. 6	8C89
		ILLINOIS	FED. A	D PROJECT		

** PEORIAN TAZEWELL /I\ REV. 11/1/19


// REV. 11/1/19



NORTH CONTROLLER

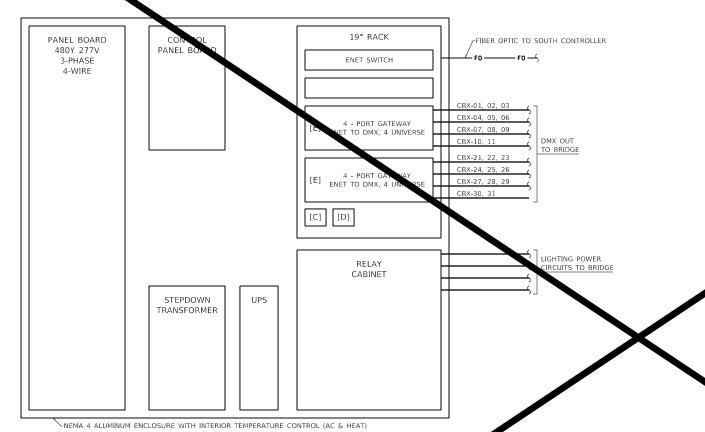

SOUTH CONTROLLER

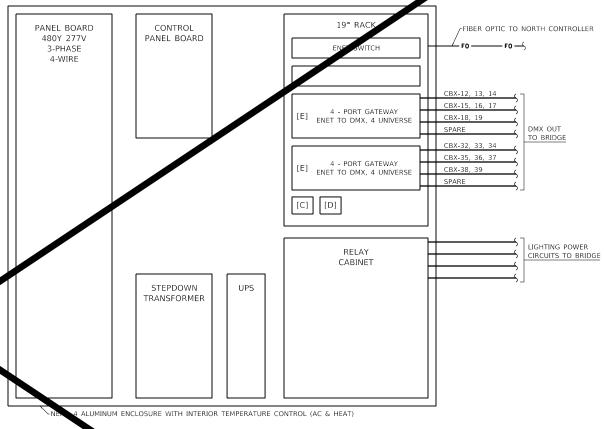

	<u>PARTS LIST</u>	
ITEM	DESCRIPTION	DESIGNATION
Α	UNISON MOSAIC W/1 MODULE RACKMOUNT	
В	48V POWER SUPPLY KIT	
С	UNISON MOSAIC SHOW CONTROLLER	
D	UNISON MOSAIC REMOTE I/O DEVICE	
Е	RSN-DMX-T-RACK MK2 GW 4P	
F	ERP48-FT ENCLOSURE 48 1P RELAYS	

F.A.I. 74 - SECTION 90(10D-1)BRR


PEORIA / TAZEWELL COUNTY

STATION 151+85

<u>STRUCTURE NO. 092-0001</u>

FOUP
WALNUT ST., SUITE 200
FEORM, ILLINOIS SION
(309) 683-9888 / Info@/-w.com

USER NAME = rtarntlino	DESIGNED -	DAR	REVISED
	CHECKED -	JDA	REVISED
PLOT SCALE = 24:0 ':" / ft.	DRAWN -	RJT	REVISED
PLOT DATE = 00/00/00	CHECKED -	JJO	REVISED

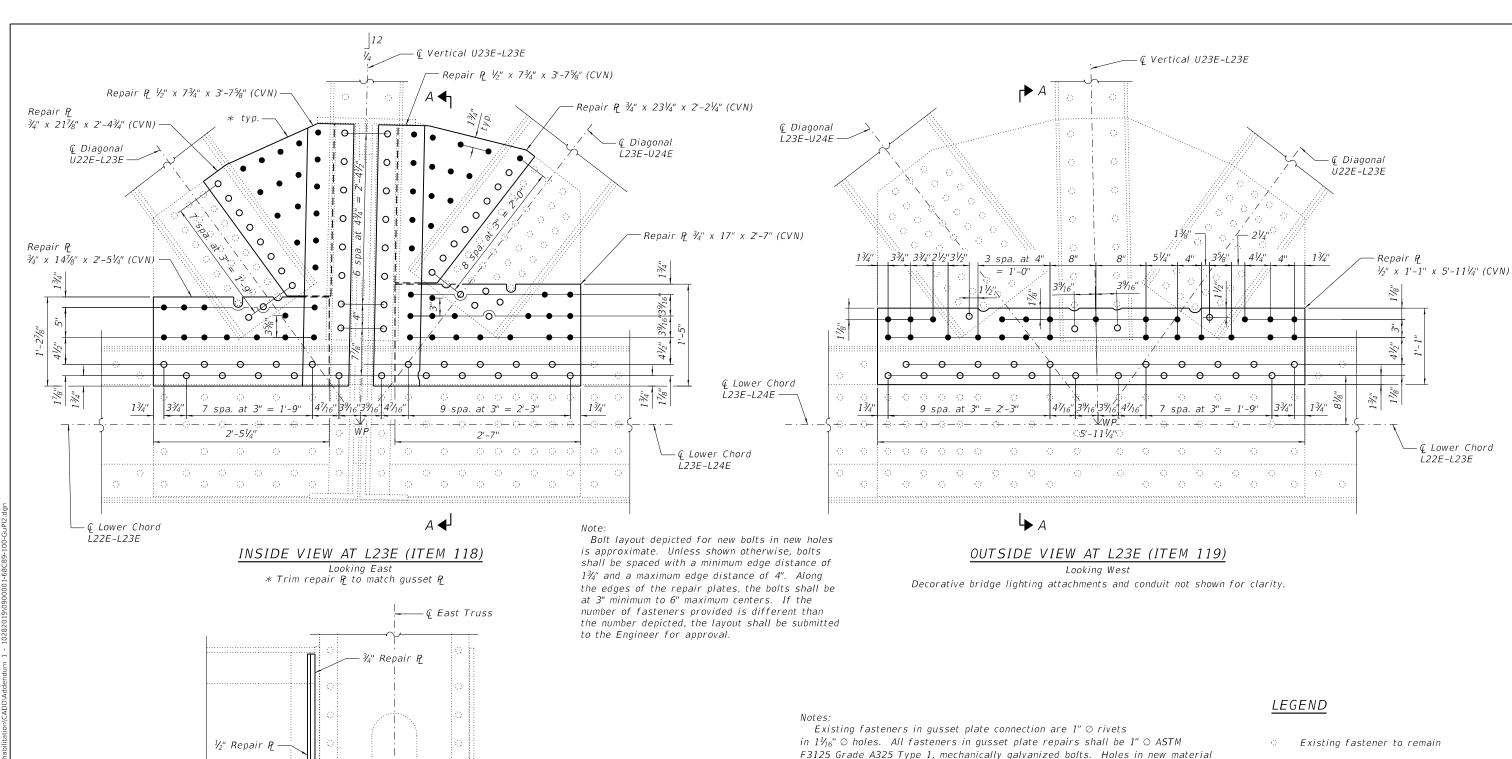

F3125 Grade A325 Type 1, mechanically galvanized bolts. Holes in new material and new holes in existing material shall be $1\frac{1}{16}$ " \emptyset .

Existing utility conduits attached to the lower chord and located near the gusset plate repair shall be temporarily detached, temporarily supported, modified as needed to fit the repaired condition, and reattached after the gusset plate repair has been completed. Modifications shall be approved by the Engineer. Utilities are to remain in service during gusset plate repair. Cost to detach, support, modify, and reattach existing conduit necessary to complete the work as shown in the plans shall be included in Structural

Existing steel that will be in contact with new steel will be cleaned and painted in accordance with the special provision for Cleaning and Painting Contact Surface Areas of Existing Steel Structures for primary connections. The primer shall be fully cured in accordance with the manufacturer's instructions prior to connecting new steel to existing steel.

Load carrying components designated "CVN" denotes Charpy-V-Notch impact energy requirements, Zone 2.

Coordinate removal and replacement of decorative bridge lighting with gusset plate repairs. See Lighting Plans.

- New bolt in new hole (shop or field drilled)
- Replace existing fastener with new bolt in existing hole (holes in new material may be field drilled using existing member as a template)

BILL OF MATERIAL

Item	Unit	Total	^
Structural Steel Repair	Pound	960	1
	,		



	USER NAME =	DESIGNED - RLM	REVISED - /1 10/25/19 RLM
		CHECKED - JAD	REVISED -
;	PLOT SCALE =	DRAWN - AEC	REVISED -
	PLOT DATE = 10/28/2019	CHECKED - RLM	REVISED -

SECTION A-A

Repair R

.½" Repair ₽

Existing

Utility

Conduit

STATE OF ILLINOIS **DEPARTMENT OF TRANSPORTATION**

GUSSET PLATE REPAIRS - 2 MURRAY BAKER BRIDGE OVER ILLINOIS RIVER SHEET S100 OF S145 SHEETS

	F.A.I. RTE.				COUNTY	TOTAL SHEETS	SHEE NO.
	74 90(10D-1)BRR			*	329	282	
				CONTRA	CT NO. 6	8C89	
		IL	L I NOIS	FED. All	D PROJECT		