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STATE OF ILLINOIS DEPARTMENT OF TRANSPORTATION

1735 2023 DB YARK PARKING COOK 11 1 ILLINOIS CONTRACT NO. 62W03

FOR INDEX OF SHEETS, SEE SHEET NO. 2

PROJECT LOCATED IN: **ELK GROVE VILLAGE**

PROPOSED HIGHWAY PLANS

DISTRICT BRIDGE MAINTENANCE YARD (1101 BIESTERFIELD RD, ELK GROVE VILLAGE) **SECTION 2023 DB YARD PARKING**

PARKING LOT IMPROVEMENT **COOK COUNTY**

C-91-089-24



LOCATION MAP NOT TO SCALE

THOMAS V. NGO, P.E. * 062-058379


MILLENNIA PROFESSIONAL SERVICES

SIGNATURE AND SEAL APPLIES TO DRWG NO LTD II



D-91-080-24



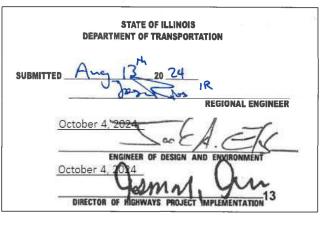



PRINTED BY THE AUTHORITY OF THE STATE OF ILLINOIS



FULL SIZE PLANS HAVE BEEN PREPARED USING STANDARD ENGINEERING SCALES. REDUCED SIZED PLANS WILL NOT CONFORM TO STANDARD SCALES. IN MAKING MEASUREMENTS ON REDUCED PLANS, THE ABOVE SCALES MAY BE USED.

J.U.L.I.E. JOINT UTILITY LOCATION INFORMATION FOR EXCAVATION 1-800-892-0123

PROJECT ENGINEER: VESELIN VELICHKOV, P.E. (847) 705-4432 PROJECT MANAGER: FAWAD AQUEEL, P.E.

CONTRACT NO. 62W03

INDEX OF SHEETS

- 1 COVER SHEET
- 2 INDEX OF SHEETS, STATE STANDARDS, & GENERAL NOTES
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- 5-6 TYPICAL SECTIONS
- 7 EXISTING SITE AND REMOVAL PLAN
- 8 PROPOSED SITE AND PAVEMENT MARKING PLAN
- 9 GRADING PLAN AND LANDSCAPING PLAN
- 10 TRAFFIC CONTROL AND PROTECTION FOR SIDE ROADS, INTERSECTIONS, AND DRIVEWAYS (TC-10)
- 11 DISTRICT ONE TYPICAL PAVEMENT MARKINGS (TC-13)

LIST OF HIGHWAY STANDARDS

000001-08 STANDARD SYMBOLS, ABBREVIATIONS, AND PATTERNS

701006-05 OFF-RD OPERATIONS, 2L, 2W, 15' (4.5m) TO 24" (600mm) FROM PAVEMENT EDGE

701011-04 OFF-RD MOVING OPERATIONS, 2L, 2W, DAY ONLY 701301-04 LANE CLOSURE, 2L, 2W, SHORT TIME OPERATIONS

701901-09 TRAFFIC CONTROL DEVICES

GENERAL NOTES

- BEFORE STARTING ANY EXCAVATION, THE CONTRACTOR SHALL CALL "J.U.L.I.E." AT 800-892-0123 FOR FIELD LOCATIONS OF BURIED ELECTRIC, TELEPHONE AND GAS UTILITIES. 48 HOUR NOTIFICATION IS REQUIRED.
- THE CONTRACTOR SHALL COORDINATE ACTIVITIES WITH THE DISTRICT BRIDGE TEAM OPERATION SUPERVISOR JOHN R. BILSKI AT (847) 956-1444.
- 3. THE CONTRACTOR WILL NOT BE ALLOWED TO SET UP A YARD OR FIELD OFFICE ON STATE PROPERTY WITHOUT WRITTEN PERMISSION FROM THE DEPARTMENT.
- IT SHALL BE THE CONTRACTOR'S RESPONSIBILITY TO VERIFY ALL DIMENSIONS AND CONDITIONS EXISTING IN THE FIELD PRIOR TO CONSTRUCTION AND ORDERING OF MATERIALS.
- 5. THE CONTRACTOR SHALL BE REQUIRED TO PROVIDE ACCESS TO ABUTTING PROPERTY AT ALL TIMES DURING THE CONSTRUCTION OF THIS PROJECT.
- 6. DO NOT SCALE PLANS FOR CONSTRUCTION DIMENTIONS.
- 7. EXISTING BROKEN FRAMES AND LIDS SHALL BE REMOVED AND DISPOSED OF BY THE CONTRACTOR AND SHALL BE REPLACED AS DIRECTED BY THE ENGINEER. REPLACEMENT FRAMES AND LIDS WILL BE PAID FOR ACCORDING TO ARTICLE 109.04 OF THE STANDARD SPECIFICATIONS UNLESS A SEPARATE PAY ITEM HAS BEEN PROVIDED.
- 8. CONTRACTOR IS TO PERFORM THEIR OPERATIONS DURING THE DISTRICT BRIDE MAINTENANCE YARD OPERATING HOURS, UNLESS APPROVED BY THE TEAM SECTION TECHNICIAN.
- 9. BEFORE COMMENCING ANY WORK, THE CONTRACTOR MUST CONTACT IDOT DISTRICT 1
 ELECTRICAL MAINTENANCE CONTRACTOR (EMC) MEADE ELECTRIC TED TROYNER,
 1-708-588-2544 FOR IDOT OWNED UNDERGROUND LIGHTING FACILITIES (CABLES, CONDUITS ETC.) IDENTIFICATION.

COMMITMENTS

NO COMMITMENTS FOR THIS PROJECT

MILLENNIA
PROFESBIONAL SERVICES
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USER NAME = jpham	DESIGNED - TN	REVISED -
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INDEX C	F SHEETS DISTRIC	•			,	GENERAL NOTES E yard
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				CONSTRUCT	ION CODE
				URBAN	
CODE	ITEM	UNIT	TOTAL QUANTITY	100% STATE	
NO.	·		QUANTITY	0044	
20101400	NITROGEN FERTILIZER NUTRIENT	POUND	4	4	
20101600	POTASSIUM FERTILIZER NUTRIENT	POUND	4	4	
20200100	EARTH EXCAVATION	CU YD	2413	2413	
21101615	TOPSOIL FURNISH AND PLACE, 4"	SQ YD	259	259	
25200110	SODDING, SALT TOLERANT	SQYD	259	259	
			200	239	
28000510	INLET FILTERS	EACH	7	7	
		2015			
31101400	SUBBASE GRANULAR MATERIAL, TYPE B 6"	SQ YD	14477	14477	
40600275	BITUMINOUS MATERIALS (PRIME COAT)	POUND	32452	32452	
				V=.V=	
40600290	BITUMINOUS MATERIALS (TACK COAT)	POUND	5139	5139	
40603085	HOT-MIX ASPHALT BINDER COURSE, IL-19.0, N70	TON	0500	0500	
40003063	HOT-WIX ASPRALI BINDER COORSE, IL-19:0, IN/0	TON	2506	2506	
40604062	HOT-MIX ASPHALT SURFACE COURSE, IL-9.5, MIX "D", N70	TON	1496	1496	
42000300	PORTLAND CEMENT CONCRETE PAVEMENT 8"	SQ YD	506	506	
42001300	PROTECTIVE COAT	SQYD	517	517	
		92.5	017	317	
42400200	PORTLAND CEMENT CONCRETE SIDEWALK 5 INCH	SQ FT	100	100	
44000400	DAVEMENT DEMOVAL	90.40			
44000100	PAVEMENT REMOVAL	SQ YD	14984	14984	
44000155	HOT-MIX ASPHALT SURFACE REMOVAL, 1 1/2"	SQYD	1579	1579	
				,,,,,	
44000158	HOT-MIX ASPHALT SURFACE REMOVAL, 2 1/4"	SQ YD	1755	1755	
44000600	SIDEWALK REMOVAL	SQ FT	100	100	
++000000		00211	100	100	
60250200	CATCH BASINS TO BE ADJUSTED	EACH	1	1	
60252800	CATCH BASINS TO BE RECONSTRUCTED	EACH	1	1	
60300305	FRAMES AND LIDS TO BE ADJUSTED	EACH	7	7	
			·	,	
66900200	NON-SPECIAL WASTE DISPOSAL	CU YD	1206	1206	
66900530	SOIL DISPOSAL ANALYSIS	EACH	4		
00900330	SOIL DISFOONL AIVALTSIS	LAGIT	4	4	
66901001	REGULATED SUBSTANCES PRE-CONSTRUCTION PLAN	L SUM	1	1	
66901003	REGULATED SUBSTANCES FINAL CONSTRUCTION REPORT	L SUM	1 500	1 500	
66901005 66901006	ENGINEERED BARRIER REGULATED SUBSTANCES MONITORING	SQ YD CAL DA	590 8	590 8	
30001000	1. ESSENCES SOSSILITATION OF THE PROPERTY OF T	JAL DA	<u> </u>	•	
67100100	MOBILIZATION	LSUM	1	1	
78000200	THERMOPLASTIC PAVEMENT MARKING - LINE 4"	FOOT	2218	2218	
X4400501	COMBINATION CURB AND GUTTER REMOVAL AND REPLACEMENT LESS THAN OR EQUAL TO 10 FEET	FOOT	50	50	
				1 50	

* SPECIALTY ITEM

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STATE OF ILLINOIS
DEPARTMENT OF TRANSPORTATION

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	ield Maint Yard-Bridge\00-CADD10.12 ORD\CADD Data\Sheets\04-D162	
	33 Biesterfield Maint Yard-Bridge∖00⊣	
	VarVar PHII\WO46 62W03 Biesterfik	
ZWUS-SUU-VUZ	NAME: P:\2019\ME19003_VarVar_PHII\\	
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JSER NAME = jpham

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			CONSTRUCTION CODE			
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CODE NO.	ITEM	UNIT	TOTAL QUANT I TY	100% STATE		
	COMPINATION CURP AND CUTTER REMOVAL AND REPLACEMENT OPERATER THAN 40 FEET	FOOT		0044		
X4400503	COMBINATION CURB AND GUTTER REMOVAL AND REPLACEMENT GREATER THAN 10 FEET	FOOT	50	50		
X5537800	STORM SEWERS TO BE CLEANED 12"	FOOT	100	100		
X6030205	FRAMES AND GRATES TO BE ADJUSTED (SPECIAL)	EACH	4	4		
A0030203	FRAMES AND GRATES TO BE ADJUSTED (SPECIAL)	EACH	1	1		
X6700407	ENGINEER'S FIELD OFFICE, TYPE A (D1)	CAL MO	6	6		
Z0013798	CONSTRUCTION LAYOUT	L SUM	1	1		
20010730		LOOM	<u>'</u>	1		
Z0018500	DRAINAGE STRUCTURES TO BE CLEANED	EACH	7	7		

STATE OF ILLINOIS
DEPARTMENT OF TRANSPORTATION

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F.A.U SECTION COUNTY TOTAL SHEETS NO.

1735 2023 DB YARD PARKING COOK 11 4

CONTRACT NO. 62W03


SUMMARY OF QUANTITIES

DISTRICT BRIDGE MAINTENANCE YARD

TO STA. 0+00.00

SCALE: 1"=1'-0" SHEET 2 OF 2 SHEETS STA. 0+00.00


MAINTENANCE YARD ALIGNMENT

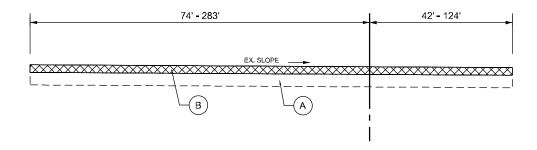

EXISTING TYPICAL SECTION MAINTENANCE YARD

STA. 0+61 TO STA. 2+00

MAINTENANCE YARD ALIGNMENT

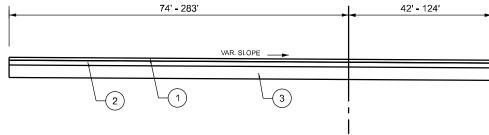


PROPOSED TYPICAL SECTION MAINTENANCE YARD

STA. 0+61 TO STA. 2+00

PROPOSED LEGEND

- 1) PROPOSED HMA SURFACE COURSE, MIX "D", IL-9.5, N70, 1 1/2""
- (2) PROPOSED HMA BINDER COURSE, IL-19.0, N70, 3"
- (3) PROPOSED SUBBASE GRANULAR MATERIAL, TYPE B 6"


MAINTENANCE YARD ALIGNMENT

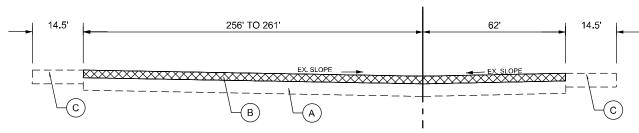

EXISTING TYPICAL SECTION MAINTENANCE YARD

STA. 2+00 TO STA. 3+60

MAINTENANCE YARD ALIGNMENT

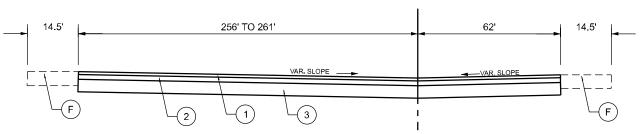

PROPOSED TYPICAL SECTION MAINTENANCE YARD

STA. 2+00 TO STA. 3+60


EXISTING LEGEND

- (A) EXISTING SUB-BASE
- B) PAVEMENT REMOVAL, 4 1/2"
- (C) EXISTING CONCRETE PAVEMENT

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	TY	PIC/	AL SECT	IONS			F.A.U RTE		SEC	TION		COUNTY
DISTR	ICT RR	ING	E MAIN1	FNANC	F YARD		1735	202	3 DB YAF	RD PARKI	NG	соок
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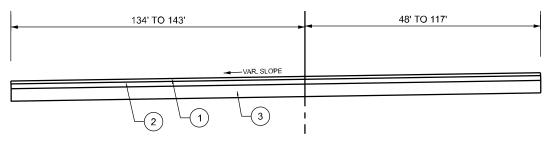
MAINTENANCE YARD ALIGNMENT



EXISTING TYPICAL SECTION MAINTENANCE YARD

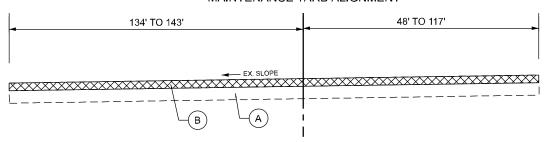STA. 3+60 TO STA. 5+00

MAINTENANCE YARD ALIGNMENT



PROPOSED TYPICAL SECTION MAINTENANCE YARD

STA. 3+60 TO STA. 5+00

EXISTING LEGEND

- (A) EXISTING SUB-BASE
- B PAVEMENT REMOVAL, 4 1/2"
- © EXISTING CONCRETE PAVEMENT

PROPOSED LEGEND

- (1) PROPOSED HMA SURFACE COURSE, MIX "D", IL-9.5, N70, 1 1/2""
- 2 PROPOSED HMA BINDER COURSE, IL-19.0, N70, 3"
- ig(3ig) PROPOSED SUBBASE GRANULAR MATERIAL, TYPE B 6"

HOT MIX ASPHALT MIXTURE REQUIREMENTS										
MIXTURE TYPE	AIR VOID @ N _{DES.}	амр түре								
PAVEMENT RECONSTRUCTION										
HOT-MIX ASPHALT SURFACE COURSE, MIX "D", IL-9.5, N70, 1 1/2"	4% @ 70 GYR	QC/QA								
HOT-MIX ASPHALT BINDER COURSE, IL-19.0, N70, 3"	4% @ 70 GYR	QC/QA								
QUALITY CONTROL FOR PERFORMANCE (QCP); PAY FOR PERFORMANCE (PFP) QMP DESIGNATION: QUALITY CONTROL / QUALITY ASSURANCE (QC/QA);										

MIXTURE NOTES:


- 1. THE UNIT WEIGHT USED TO CALCULATE ALL HOT-MIX ASPHALT SURFACE MIXTURES IS 112 LBS/SQ YD/IN
- 2. THE "AC TYPE" FOR POLYMERIZED HMA MIXES SHALL BE "SBS/SBR PG 76-22" AND FOR NON-POLYMERIZED HMA THE "AC TYPE" SHALL BE "PG 64-22" UNLESS MODIFIED BY RECLAIMED MATERIALS SPECIFICATIONS.





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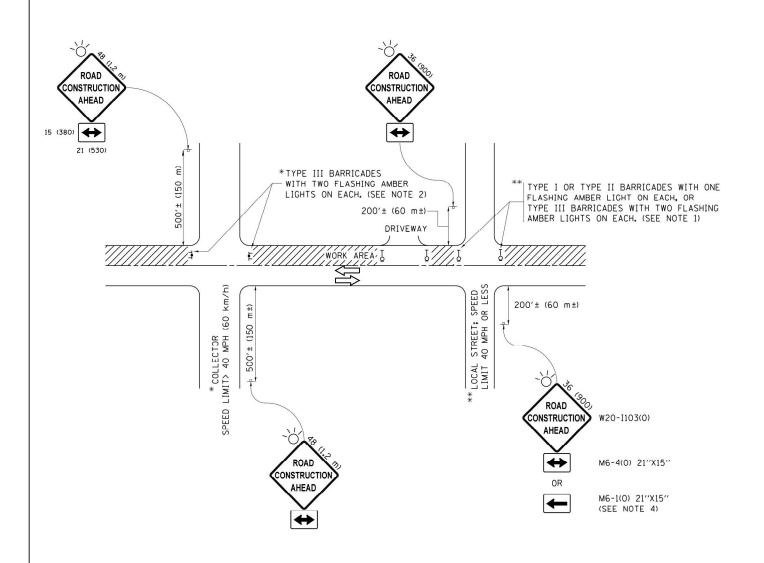
STATE OF ILLINOIS
DEPARTMENT OF TRANSPORTATION

TYPICAL SECTIONS - PROPOSED	F.A.U RTE	SECTION	COUNTY	TOTAL SHEETS	SHEET NO.
DISTRICT BRIDGE MAINTENANCE YARD	1735	2023 DB YARD PARKING	соок	11	6
DIGINIOI DINDOL MAINTENANOL TAND			CONTRAC	T NO. 62\	V03
SHEET 2 OF 2 SHEETS STA. TO STA.	ILLINOIS FED. AID PROJECT				



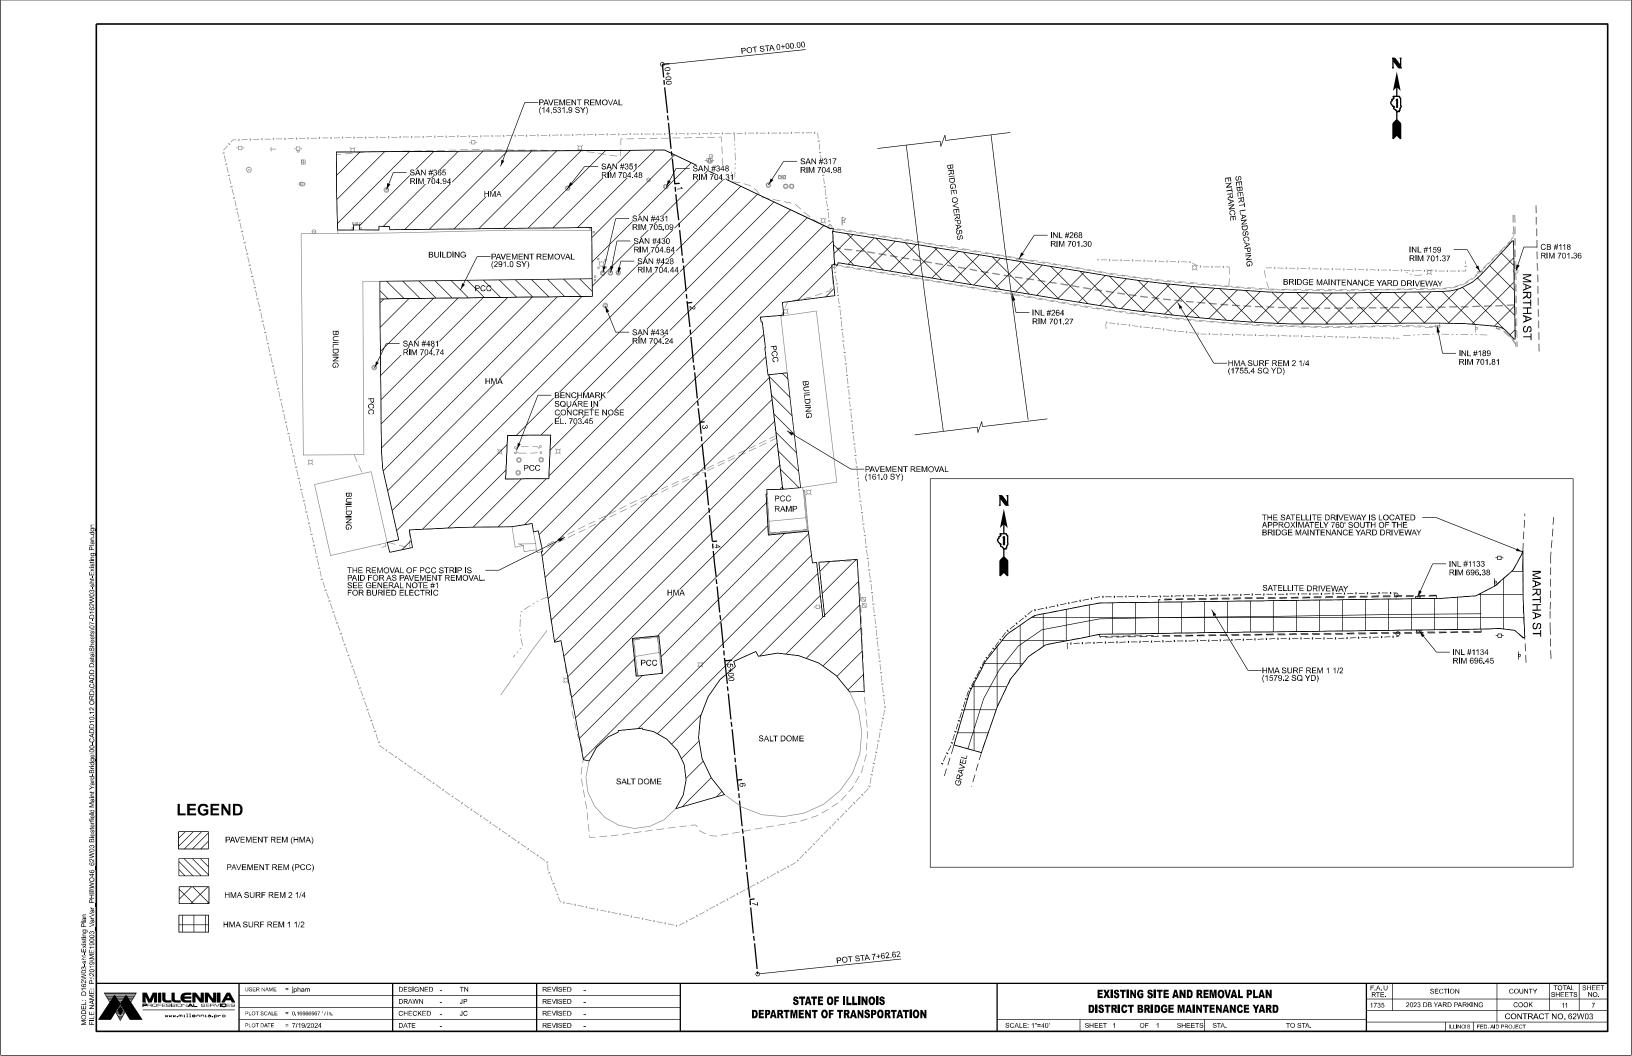

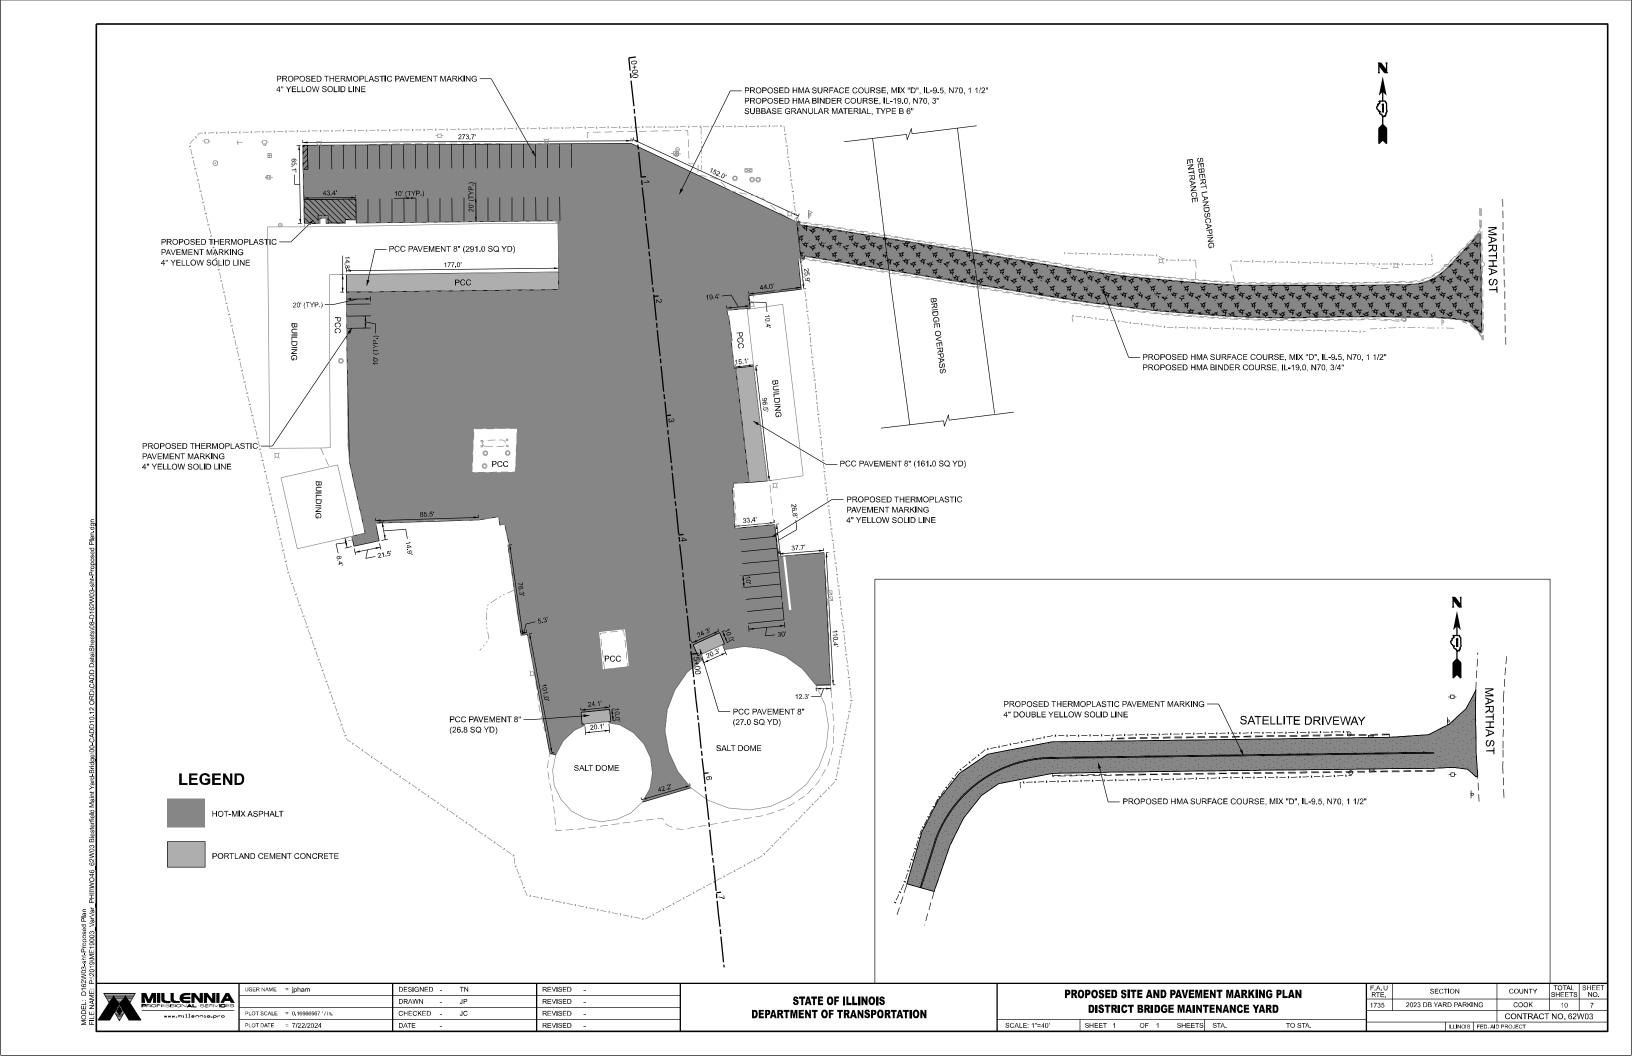

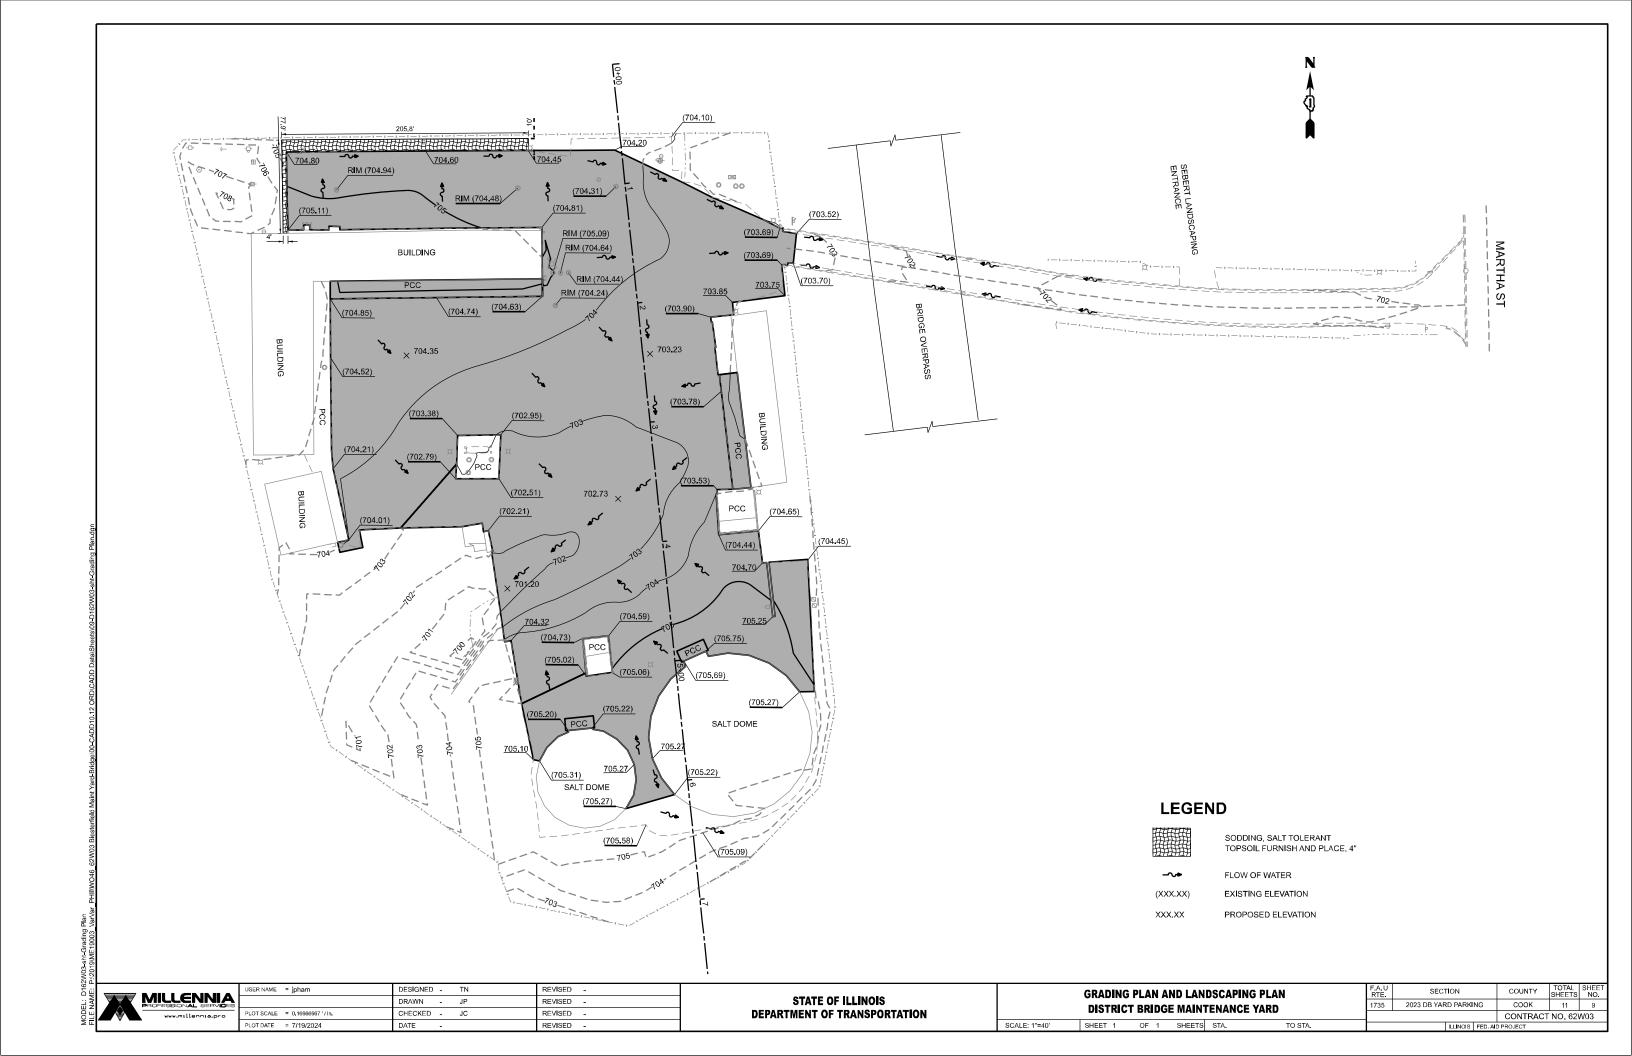

NOTES:

- SIDE ROAD WITH A SPEED LIMIT OF 40 MPH (60 km/h) OR LESS AS SHOWN ON THE DRAWING AND AS DIRECTED BY THE ENGINEER:
 - a) ONE "ROAD CONSTRUCTION AHEAD" SIGN 36 x 36 (900x900) WITH A FLASHER MOUNTED ON IT APPROXIMATELY 200" (60 m) IN ADVANCE OF THE MAIN ROUTE.
 - b) THE CLOSED PORTION OF THE MAIN ROUTE SHALL BE PROTECTED BY BLOCKING WITH TYPE I, TYPE II OR TYPE III BARRICADES, 1/3 OF THE CROSS SECTION OF THE CLOSED PORTION.
- 2. SIDE ROAD WITH A SPEED LIMIT GREATER THAN 40 MPH (60 km/h) AS SHOWN ON THE DRAWING AND AS DIRECTED BY THE ENGINEER:
 - o) ONE "ROAD CONSTRUCTION AHEAD" SIGN 48 \times 48 (1.2 m \times 1.2 m) WITH A FLASHER MOUNTED ON IT APPROXIMATELY 500" (150 m) IN ADVANCE OF THE MAIN ROUTE.
 - b) THE CLOSED PORTION OF THE MAIN ROUTE SHALL BE PROTECTED BY BLOCKING WITH TYPE III BARRICADES, 1/2 OF THE CROSS SECTION OF THE CLOSED PORTION.
- 3. CONES MAY BE SUBSTITUTED FOR BARRICADES OR DRUMS AT HALF THE SPACING DURING DAY OPERATIONS. CONES SHALL BE A MINIMUM OF 28 (710)
 IN HEIGHT
- 4. WHEN THE SIDE ROAD LIES BETWEEN THE BEGINNING OF THE MAINLINE SIGNING AND THE WORK ZONE, A SINGLE HEADED ARROW (M6-1) SHALL BE USED IN LIEU OF THE DOUBLE HEADED ARROW (M6-4).

SCALE: NONE


- 5. WHEN WORK IS BEING PERFORMED ON A SIDE ROAD OR DRIVEWAY, FOLLOW THE APPLICABLE STANDARD(S). THE DIRECTIONAL ARROW (MG-1 OR MG-4) SHALL BE COVERED OR REMOVED WHEN NO LONGER CONSISTENT WITH THE TRAFFIC CONTROL SET-UP.
- 6. ADVANCE WARNING SIGNS ARE TO BE OMITTED ON DRIVEWAYS UNLESS OTHERWISE SPECIFIED IN THE PLANS OR BY THE ENGINEER.
- 7. THE TRAFFIC CONTROL AND PROTECTION FOR SIDE ROADS, INTERSECTIONS, AND DRIVEWAYS SHALL BE INCLUDED IN THE COST OF SPECIFIED TRAFFIC CONTROL STANDARDS OR ITEMS.


All dimensions are in inches (millimeters) unless otherwise shown.

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Default	PLOT DATE = 9/15/2016	DATE - 06-89	REVISED	-	A. SCHUETZE 09-15-16

STATI	E OF	ILLINOIS
DEPARTMENT	OF	TRANSPORTATION

TRAFFIC CONTROL AND PROTECTION FOR SIDE ROADS, INTERSECTIONS, AND DRIVEWAYS					F.A.U. RTE.	SECTION		
					1735	2023 DB YARD PARKIN		
SIDE NUADS, INTENSECTIONS, AND DRIVEVVATS						TC-10		
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TYPICAL CROSSWALK MARKING

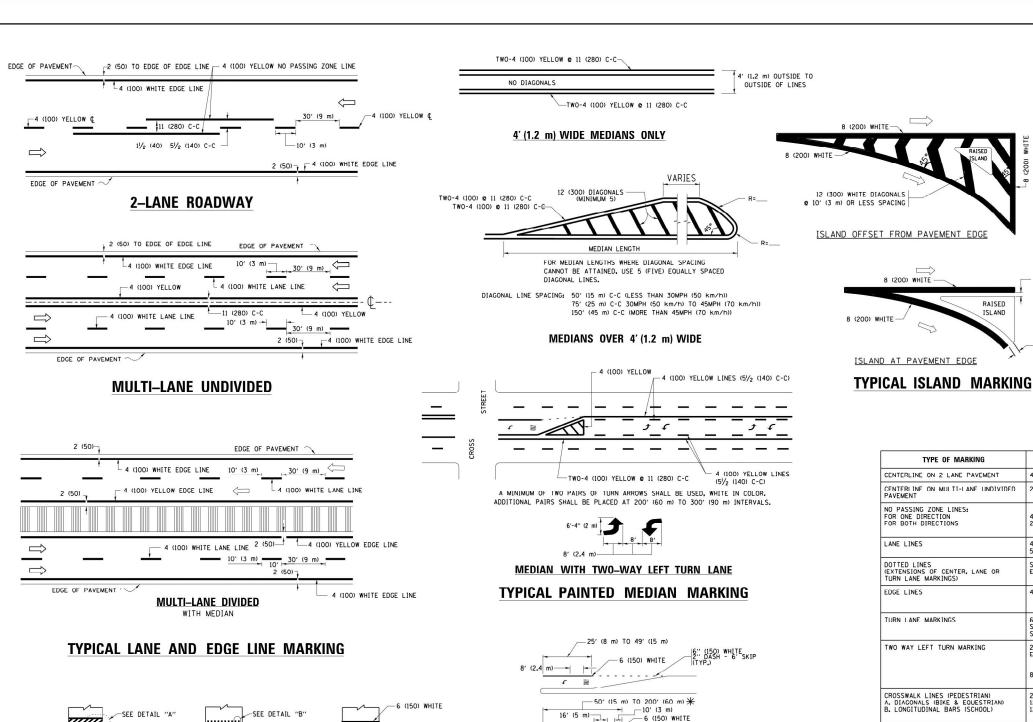MARKINGS SHALL BE INSTALLED PARALLEL TO THE CENTERLINE OF

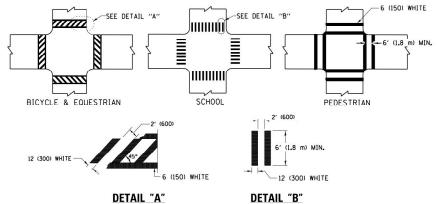
16' (5 m) 10' (3 m) 6 (150) WHITE OVER 200' (60 m) 6 (150) WHITE

FULL SIZE LETTERS 8' (2.4 m) AND ARROWS SHALL BE USED. AREA = 15.6 SO. FT. (1.5 m2) ONLY AREA = 20.8 SO. FT. (1.9 m2)

* IURN LANES IN EXCESS OF 400' (120 m) IN LENGTH MAY HAVE AN ADDITIONAL SET OF ARROW - "ONLY" INSTALLED MIDWAY BETWEEN THE OTHER TWO SETS OF

TYPICAL LEFT (OR RIGHT) TURN LANE

TYPICAL TURN LANE MARKING

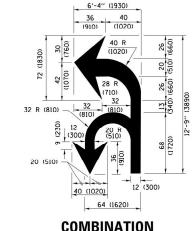


COMBINATION LEFT AND U-TURN

_ 2 (50)

RAISED

8 (200) WHITE -

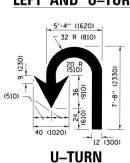

LANE REDUCTION TRANSITION

D(FT)

500

580

665

750

SPEED LIMIT

45

50

55

* LANE REDUCTION ARROWS REQUIRED AT SPEEDS OF 45 MPH OR GREATER OR WHEN SPECIFIED IN PLANS.

TYPE OF MARKING	WIDTH OF LINE	PATTERN	COLOR	SPACING /REMARKS
CENTERLINE ON 2 LANE PAVEMENT	4 (100)	SKIP-DASH	YELLOW	10' (3 m) LINE WITH 30' (9 m) SPACE
CENTERLINE ON MULTI-LANE LINDIVIDED PAVEMENT	2 8 4 (100)	SOI ID	YFI I OW	11 (280) C-C
NO PASSING ZONE LINES: FOR ONE DIRECTION FOR BOTH DIRECTIONS	4 (100) 2 0 4 (100)	SOLID SOLID	YELLOW YELLOW	5½ (140) C-C FROM SKIP-DASH CENTERLINE 11 (280) C-C OMIT SKIP-DASH CENTERLINE BETWEEN
LANE LINES	4 (100) 5 (125) ON FREEWAYS	SKIP-DASH SKIP-DASH	WHITE WHITE	10' (3 m) LINE WITH 30' (9 m) SPACE
DOTTED LINES (EXTENSIONS OF CENTER, LANE OR TURN LANE MARKINGS)	SAME AS LINE BEING EXTENDED	SKIP-DASH	SAME AS LINE BEING EXTENDED	2' (600) LINE WITH 6' (1.8 m) SPACE
EDGE LINES	4 (100)	SOLID	YELLOW-LEFT WHITE-RIGHT	OUTLINE MEDIANS IN YELLOW
TURN LANE MARKINGS	6 (150) LINE; FULL SIZE LETTERS & SYMBOLS (8' (2.4m))	SOL ID	WHITE	SEE TYPICAL TURN LANE MARKING DETAIL
TWO WAY LEFT TURN MARKING	2 @ 4 (100) EACH DIRECTION 8' (2.4m) LEFT ARROW	SKIP-DASH AND SOLID IN PAIRS	YELLOW	10' (3 m) LINE WITH 30' (9 m) SPACE FOR SKIP-DASH; 5½ (140) C-C BETWEEN SOLID LINE AND SKIP-DASH LINE SEE TYPICAL TWO-WAY LEFT TURN MARKING DETAIL
CROSSWALK LINES (PEDESTRIAN) A. DIACONALS (BIKE & EOUESTRIAN) B. LONGITUDINAL BARS (SCHOOL)	2 @ 6 (150) 12 (300) @ 45° 12 (300) @ 90°	SOLID SOLID SOLID	WHITE WHITE WHITE	NOT LESS THAN 6' (1.8 m) APART 2' (500) APART 2' (500) APART 5EE TYPICAL CROSSWALK MARKING DETAILS.
STOP LINES	24 (600)	SOLID	WHITE	PLACE 4' (1,2 m) IN ADVANCE OF AND PARALLEL TO CROSSWALK. IF PRESENT. OTHERWISE, PLACE AT DESIRED STOPPING POINT. PARALLEL TO CROSSROAD CENTERLINE, WHERE POSSIBLE.
PAINTED MEDIANS	2 @ 4 (100) WITH 12 (300) DIAGONALS @ 45° NO DIAGONALS USED FOR 4' (1.2 m) WIDE MEDIANS	SOLID	YELLOW: TWO WAY TRAFFIC WHITE: ONE WAY TRAFFIC	11 (280) C-C FOR THE DOUBLE LINE SEE TYPICAL PAINTED MEDIAN MARKING.
GORE MARKING AND CHANNELIZING LINES	8 (200) WITH 12 (300) DIAGONALS & 45°	SOLID	WHITE	DIACONALS: 15' (4,5 m) C-C (LESS THAN 30MPH (50 km/h)) 20' (6 m) C-C 30MPH (50 km/h) TO 45MPH (70 km/h)) 30' (9 m) C-C (OVER 45MPH (70 km/h))
RAILROAD CROSSING	24 (600) TRANSVERSE LINES; "RR" IS 6' (1.8 m) LETTERS; 16 (400) LINE FOR "X"	SOLID	WHITE	SEE STATE STANDARD 780001 AREA OF: "R"*3.6 SO, FT. (0.33 m²) EACH "X"-54.0 SO, FT. (5.0 m²)
SHOULDER DIAGONALS (REQUIRED FOR SHOULDERS ≥ 8°)	12 (300) @ 45°	SOLID	WHITE - RIGHT YELLOW - LEFT	50' (15 m) C-C (LESS THAN 30MPH (50 km/h)) 75' (25 m) C-C (30 MPH (50 km/h) TO 45MPH (70 km/h) 150' (45 m) C-C (0VER 45MPH (70 km/h))
U TURN ARROW	SEE DETAIL	SOLID	WHITE	16.3 SF
2 ARROW COMBINATION LEFT AND U TURN	SEE DETAIL	SOLID	WHITE	30.4 SF

FOR FURTHER DETAILS ON PAVEMENT MARKING REFER TO STANDARD SPECIFICATIONS FOR ROAD AND BRIDGE CONSTRUCTION AND STATE STANDARD 780001.

All dimensions are in inches (millimeters) unless otherwise shown.

FILE NAME = DESIGNED -EVERS REVISED C. JUCIUS 09-09-09 JSER NAME = footem w:\\ILØ84EBIDINTEG.1111 ents\IDOT Offices\District I\Projects\ taRAWN\CADData\CADsheets\tc13.dor REVISED C. JUCIUS 07-01-13 CHECKED REVISED C. JUCIUS 12-21-15 DATE REVISED C. JUCIUS 04-12-16 03-19-90

STATE OF ILLINOIS **DEPARTMENT OF TRANSPORTATION**

DISTRICT ONE		F.A.U RTE.	SECTION	COUNTY	TOTAL SHEETS	SHEET NO.				
TYPICAL PAVEMENT MARKINGS				1735	2023 DB YARD PARKING	соок	11	11		
				WANKINGS			TC-13	CONTRACT	NO. 62	2W03
CUEET 1	1 0	E 1	CHEETC	CTA	TO STA		THE THOUGHT FER	IO DDO IDOT		