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STATE OF ILLINOIS **DEPARTMENT OF TRANSPORTATION**

SECTION 255 67-(1,2,3)-PP, 82-(6,7,8)-PP

D-98-101-24



STATE OF ILLINOIS **DEPARTMENT OF TRANSPORTATION**

REGIONAL ENGINEER

PRINTED BY THE AUTHORITY OF THE STATE OF ILLINOIS

FOR INDEX OF SHEETS, SEE SHEET NO. 2

TRAFFIC DATA

MISSISSIPPI RIVER TO EXIT 6

2023 ADT = 51,700 (ACTUAL) 2024 ADT = 52,400 (ESTIMATED) 2044 ADT = 60,300 (ESTIMATED) SU = 2.0% MU = 8.2%

EXIT 6 TO SOUTH MAIN STREET


2023 ADT = 41,000 (ACTUAL) 2024 ADT = 41,600 (ESTIMATED) 2044 ADT = 47,800 (ESTIMATED) SU = 2.3% MU = 10.6%

SOUTH MAIN STREET TO IL 3 INTERCHANGE

2023 ADT = 35,700 (ACTUAL) 2024 ADT = 36,200 (ESTIMATED) 2044 ADT = 41,600 (ESTIMATED) SU = 2.9% MU = 14.7%

IL 3 INTERCHANGE TO IL 157

2023 ADT = 31,400 (ACTUAL) 2024 ADT = 31,800 (ESTIMATED) 2044 ADT = 36,600 (ESTIMATED) SU = 3.2% MU = 14.0%

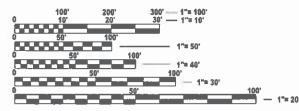

ENGINEERING SCALES. REDUCED SIZED PLANS WILL NOT CONFORM TO STANDARD SCALES. IN MAKING MEASUREMENTS ON REDUCED PLANS, THE ABOVE SCALES MAY BE USED.


JOINT UTILITY LOCATION INFORMATION FOR EXCAVATION 1-800-892-0123 OR 811

PROJECT ENGINEER: BILLIE OWEN PROJECT MANAGER: MIKE BERG

PROPOSED HIGHWAY PLANS

FAI ROUTE 255 (I-255) SECTION 67-(1,2,3)-PP, 82-(6,7,8)-PP PATCHING - CM MONROE, ST. CLAIR COUNTIES

C-98-188-24

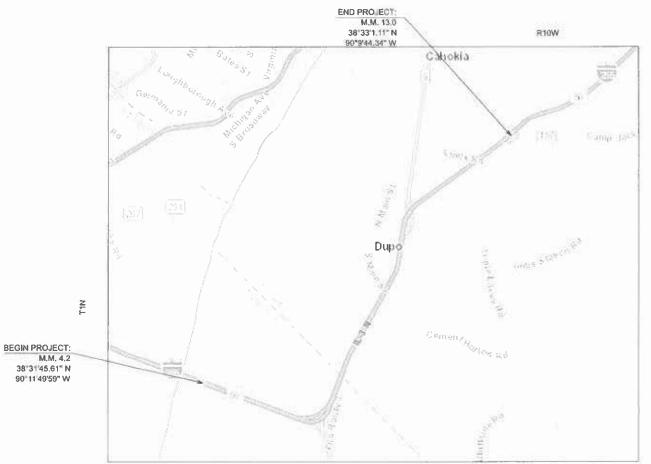

GROSS LENGTH = 39,780 FT. = 7.53 MILES NET LENGTH = 39,780 FT. = 7.53 MILE

CONTRACT NO. 76U22



INDEX OF SHEETS

- 1. COVER SHEET
- 2. INDEX OF SHEETS, STANDARDS, GENERAL NOTES, COMMITMENTS
- 3. SUMMARY OF QUANTITIES
- 4. TYPICAL SECTIONS
- 5. CHANGEABLE MESSAGE SIGN DETAIL
- 6-7. CLASS A PATCHING (SPECIAL) DETAIL

STANDARDS

000001-08 STANDARD SYMBOLS, ABBREVIATIONS AND PATTERNS

001006 DECIMAL OF AN INCH AND OF A FOOT

420001-10 PAVEMENT JOINTS

701101-05 OFF-RD OPERATIONS, MULTILANE, 15' TO 24" FORM PAVEMENT EDGE

701106-02 OFF-RD OPERATIONS, MULTILANE, MORE THAN 15' AWAY

701400-12 APPROACH TO LANE CLOSURE FREEWAY EXPRESSWAY

701401-13 LANE CLOSURE FREEWAY EXPRESSWAY

701411-09 LANE CLOSURE MULTILANE ENTRANCE OR EXIT RAMP 45 MPH OR MORE

701426-09 LANE CLOSURE MULTILANE INTERMITTENT OR MOVING OPERATIONS 45 MPH OR MORE

701428-01 TRAFFIC CONTROL SETUP REMOVAL FREEWAY EXPRESSWAY

701446-11 TWO LANE CLOSURE FREEWAY EXPRESSWAY

701901-09 TRAFFIC CONTROL DEVICES

780001-05 TYPICAL PAVEMENT MARKINGS

781001-04 TYPICAL APPLICATIONS RAISED REFLECTIVE PAVEMENT MARKERS

GENERAL NOTES

1. UTILITIES KNOWN TO HAVE FACILITIES WITHIN THE PROJECT AREA ARE AS FOLLOWS:

AMEREN ILLINOIS
BUCKEYE PIPE LINE COMPANY
VILLAGE OF CAHOKIA
CHARTER COMMUNICATIONS, INC.
CLEARWAVE FIBER LLC
CITY OF COLUMBIA
VILLAGE OF DUPO
EVERSTREAM GLC HOLDING COMPANY LLC
HARRISONVILLE TELEPHONE COMPANY
VERIZON BUSINESS
METRO EAST SANITARY DISTRICT
PRAIRIE DU PONT PUBLIC WATER DISTRICT
SUGAR LOAF TOWNSHIP SEWER SYSTEM

- 2. NO SURVEY WAS PERFORMED FOR THIS PROJECT AND THE PLANS WERE CREATED USING MICROFILM AND FIELD MEASUREMENTS.
- 3. THE RESIDENT ENGINEER SHALL VERIFY THE EXISTINCE OF HIGHWAY LIGHTING, INTELLIGENT TRANSPORTATION SYSTEMS (I.T.S.) UTILITIES, AND/OR ELECTRICAL CABLES ASSOCIATED WITH TRAFFIC SIGNALS WITHIN THE PROJECT LIMITS. IF ANY OF THESE EXIST WITHIN THE PROJECT LIMITS, AND IF THESE ITEMS REQUIRE LOCATING, THE CONTRACTOR SHALL BE DIRECTED TO DO SO ACCORDING TO SECTION 803 OF THE STANDARD SPECIFICATIONS. THIS WORK SHALL BE PAID FOR ACCORDING TO ARTICLE 109.04 OF THE STANDARD SPECIFICATIONS.

- 4. SIX CHANGEABLE MESSAGE SIGNS SHALL BE REQUIRED FOR THIS PROJECT. THEY SHALL BE PLACED TWO WEEKS PRIOR TO ANY LANE CLOSURE AND SHALL REMAIN UP FOR THE DURATION OF THE PROJECT. THE CHANGEABLE MESSAGE SIGNS SHALL BE PLACED AS SHOWN ON THE LOCATION MAP SHEET OR AT THE DISCRETION OF THE ENGINEER.
- 5. THE DEPARTMENT STRONGLY ENCOURAGES THE PRIME CONTRACTOR AND THEIR APPROVED SUB-CONTRACTORS TO HIRE MINORITY, WOMEN AND DISADVANTAGED INDIVIDUALS FROM ITS FEDERALLY FUNDED HIGHWAY CONSTRUCTION CAREERS TRAINING PROGRAM (HCCTP) TO HELP MEET WORKFORCE AND TRAINEE GOALS. THIS PROGRAM IS TRAINING MINORITIES, WOMEN AND DISADVANTAGED INDIVIDUALS IN HIGHWAY CONSTRUCTION-RELATED SKILLS, E.G., MATH FOR THE TRADES, JOB READINESS, TECHNICAL SKILLS COURSEWORK (CARPENTRY, CONCRETE FLATWORK, BLUEPRINT READING, SITE PLANS, SITE WORK, TOOLS USE, ETC.) AND OSHA 10 HOUR CERTIFICATION, TO PREPARE THEM FOR A CAREER IN THE HIGHWAY CONSTRUCTION TRADES. GRADUATES ARE WELL-TRAINED AND READY TO BECOME PRODUCTIVE ENTRY-LEVEL CONSTRUCTION WORKERS. CONTACT THE DISTRICT 8 EEO OFFICE AT 618-346-3360 AND/OR THE HCCTP COORDINATOR AT 618-874-6528 TO LEARN MORE ABOUT THE PROGRAM AND FOR ASSISTANCE IN MEETING WORKFORCE AND TRAINEE GOALS.
- 6. NO PATCHING REPAIR SCHEDULE WAS DEVELOPED FOR THIS CONTRACT. FINAL REPAIR LOCATIONS, SIZES, AND THEIR PRIORITY FOR REPAIR ARE TO BE DETERMINED BY THE RESIDENT ENGINEER. ALL AREAS TO BE REPAIRED SHALL BE FULL LANE WIDTH. CARE SHOULD BE TAKEN TO DETERMINE LOCATIONS MOST IN NEED OF REPAIR THROUGHOUT THE PROJECT LIMIT PRIOR TO THE COMMENCEMENT OF CONSTRUCTION OPERATIONS AS IT WILL NOT BE POSSIBLE TO REPAIR ALL QUESTIONABLE AREAS DUE TO THE LIMITED QUANTITIES INCLUDED IN THE PLANS.

COMMITMENTS

NONE

USER NAME = Robert.Hughes	DESIGNED -	REVISED -
	DRAWN _	REVISED _
	CHECKED -	REVISED -
PLOT DATE = 8/5/2024	DATE -	REVISED -

STATE OF ILLINOIS
DEPARTMENT OF TRANSPORTATION

SCALE:

INDEX OF S	HEETS, ST	ANDARD	S, GENE	RAL N	OTES, COMMITMENTS	F.A.I RTE.	SECTION	COUNTY	TOTAL SHEETS	SHEET NO.
			•		•	255	67-(1,2,3)-PP, 82-(6,7,8)-PP	*	7	2
								CONTRACT	NO. 76	U22
ALE:	SHEET 1	OF 1	SHEETS	STA.	TO _STA.		LILINOLS FEED A	IDECT.		

REV - MS

DEL: General Notes [Sheet]

ſ					100% STATE ROADWAY	100% STAT	
	CODE NO.	ITEM	UNIT	TOTAL QUANTITY	0006 URBAN	0006 URBAN	
			ľ				
	44213000	PATCHING REINFORCEMENT	SQ YD	2300	1380	920	
	44213200	SAW CUTS	FOOT	9000	5400	3600	
				0000	0,00		
	44213204	TIE BARS 3/4"	EACH	114	68	46	
	67100100	MOBILIZATION	L SUM	1	0.6	0.4	
	70100420	TRAFFIC CONTROL AND PROTECTION, STANDARD 701411	EACH	10	6	4	
	70100800	TRAFFIC CONTROL AND PROTECTION, STANDARD 701401	L SUM	1	0.6	0.4	
	70100815	TRAFFIC CONTROL AND PROTECTION, STANDARD 701446	L SUM	1	0.6	0.4	
	70107025	CHANGEABLE MESSAGE SIGN	CAL DA	354	236	118	
	70200100	NIGHTTIME WORK ZONE LIGHTING	L SUM	1	0.6	0.4	
	70300100	SHORT TERM PAVEMENT MARKING	FOOT	75	45	30	
İ							
	70300150	SHORT TERM PAVEMENT MARKING REMOVAL	SQ FT	1150	690	460	
	78001130	PAINT PAVEMENT MARKING - LINE 6"	FOOT	2250	1350	900	
	78100100	RAISED REFLECTIVE PAVEMENT MARKER	EACH	50	30	20	
Ī				9			
-	X4420543	CLASS A PATCHES, TYPE I, 9 INCH (SPECIAL)	SQ YD	200	120	80	

Ø 0042

CONSTRUCTION CODE

ST. CLAIR MONROE

					00110111001	
					ST. CLAIR	MONROE
					100% STATE	100% STATE
			T	T T	ROADWAY	ROADWAY
	CODE			TOTAL	0006	0006
	NO.	ITEM	LINUT		URBAN	URBAN
	NO.	I I EW	UNIT	QUANTITY	URBAN	URBAN
	X4420545	CLASS A PATCHES, TYPE II, 9 INCH (SPECIAL)	SQ YD	800	480	320
	X4420547	CLASS A PATCHES, TYPE III, 9 INCH (SPECIAL)	SQ YD	300	180	120
	X4420549	CLASS A PATCHES, TYPE IV, 9 INCH (SPECIAL)	SQ YD	1000	600	400
ø	Z0076604	TRAINEES TRAINING PROGRAM GRADUATE	HOUR	500	500	
y	20070004	THAINELS TRAINING FROGRAM GRADUATE	HOOK	300	300	
			-			


* 5	SPECIA	LTY I	ΓΕΜ
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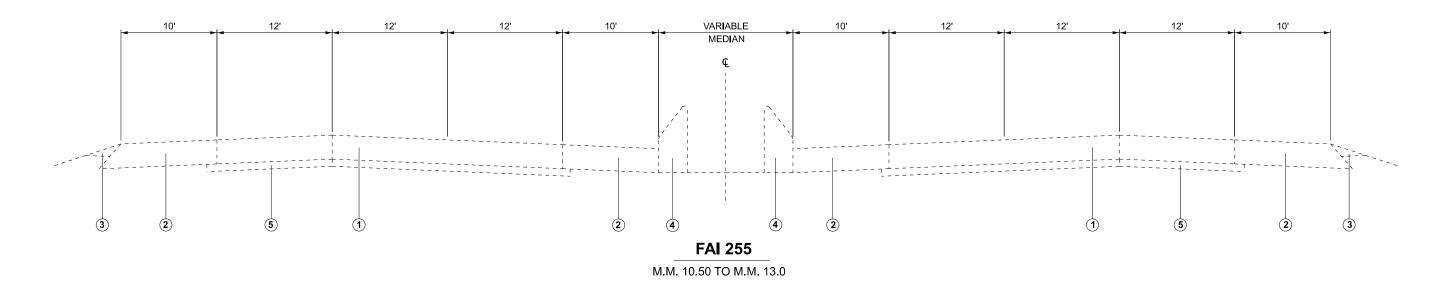
	USER NAME = Robert.Hughes	DESIGNED -	REVISED -
		DRAWN -	REVISED -
- 1		CHECKED -	REVISED -
	PLOT DATE = 7/30/2024	DATE -	REVISED -

SCALE:

	SUMMARY OF QUANTITIES											SECTIO	N		COUNTY	TOTAL SHEETS	SHEET NO.
									255	67-(1,2,3)-PP, 82-(6,7,8)-PP		100	7	3			
													CONTRACT	NO. 76	J22		
	SHEET	1		OF	1	S	SHEETS	STA.	TO STA.		ILLINOIS FED. AIL			PROJECT			


CONSTRUCTION CODE



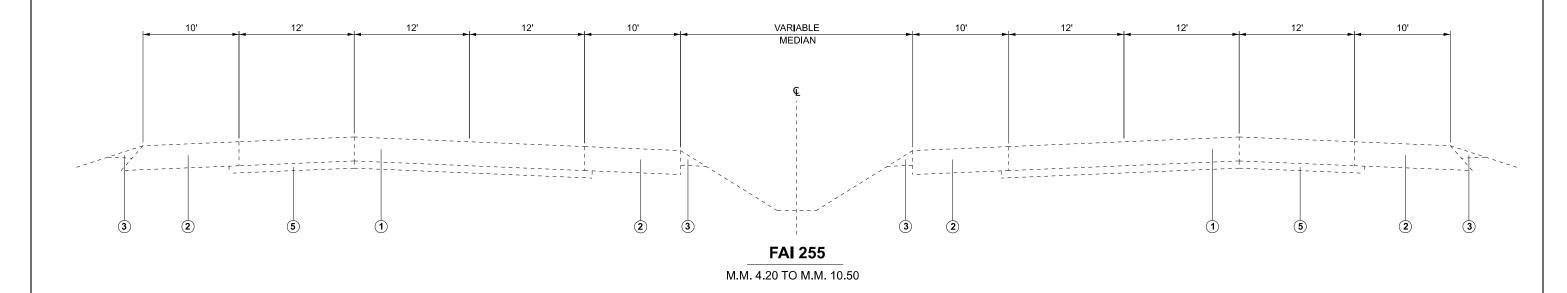

- ①EXISTING C.R.P.C.C. PAVEMENT 9"
- ②EXISTING BITUMINOUS SHOULDERS 9"
- ③EXISTING AGGREGATE SHOULDERS, TYPE B
- **4** EXISTING CONCRETE BARRIER
- **⑤EXISTING STABILIZED SUB-BASE, 4"**

USER NAME = Robert.Hughes	DESIGNED -	REVISED -			TYPICAL SECTIONS		F.A.I	SECTION	COUNTY	TOTAL SHEET
	DRAWN -	REVISED -	STATE OF ILLINOIS		I II JOAL GLOTJONG		255	67-(1,2,3)-PP, 82-(6,7,8)-PP	*	7 4
	CHECKED -	REVISED -	DEPARTMENT OF TRANSPORTATION					(11)	CONTRAC	T NO. 76U22
PLOT DATE = 7/11/2024	DATE -	REVISED -		SCALE: NTS	SHEET 1 OF 1 SHEETS STA.	TO STA.		ILLINOIS FED, AII	D PROJECT	

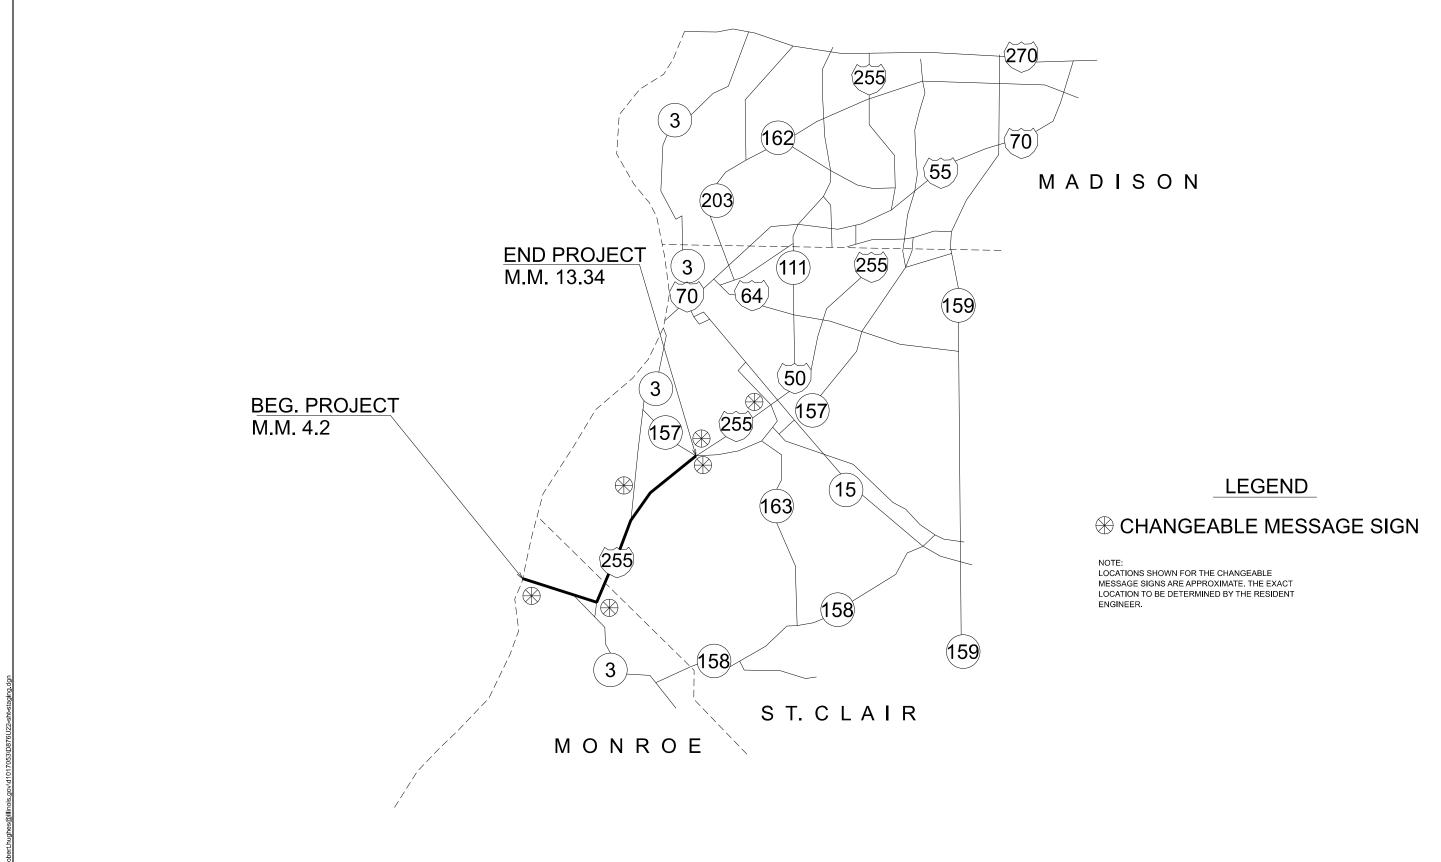

MODEL: CMB MAP [Sheet]
FILE NAMF: c:\pw work\pwidot\rol

STATE OF ILLINOIS
DEPARTMENT OF TRANSPORTATION

 CHANGEABLE MESSAGE SIGN DETAIL
 F.A.I RTE. 255
 SE 67-(1,2,3)-P


 SHEET 1 OF 1 SHEETS STA. TO STA.
 TO STA.

 F.A.I RTE.
 SECTION
 COUNTY
 TOTAL SHEETS
 NO.

 255
 67-(1,2,3)-PP, 82-(6,7,8)-PP
 *
 7
 5

 CONTRACT NO. 76U22

*MONROE, ST. CLAIR

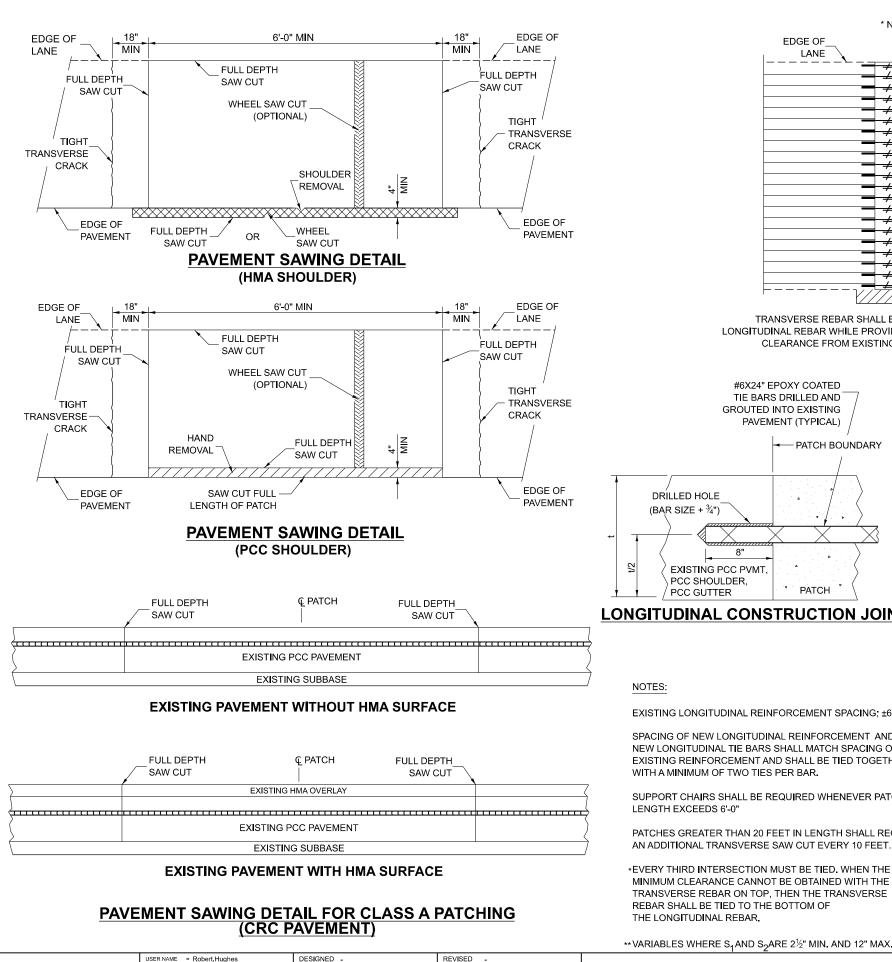

DRAWN


DATE

PLOT DATE = 7/30/2024

CHECKED

REVISED -

REVISED

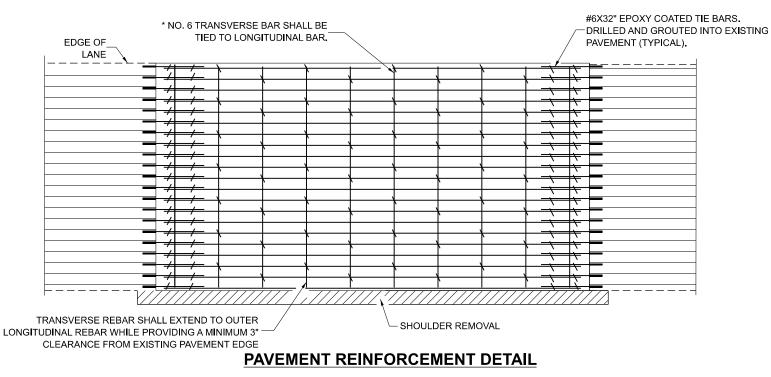

FULL DEPTH.

FULL DEPTH _

SAW CUT

2" MIN. CL

EXISTING

PAVEMENT


EXISTING

PAVEMENT

SAW CUT

2" MIN CL

(TYP)

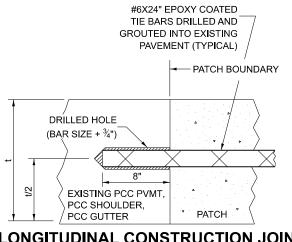

LONGITUDINAL CONSTRUCTION JOINT

NOTES:

EXISTING LONGITUDINAL REINFORCEMENT SPACING; ±6½".

SPACING OF NEW LONGITUDINAL REINFORCEMENT AND NEW LONGITUDINAL TIE BARS SHALL MATCH SPACING OF EXISTING REINFORCEMENT AND SHALL BE TIED TOGETHER WITH A MINIMUM OF TWO TIES PER BAR.

SUPPORT CHAIRS SHALL BE REQUIRED WHENEVER PATCH LENGTH EXCEEDS 6'-0"

PATCHES GREATER THAN 20 FEET IN LENGTH SHALL REQUIRE AN ADDITIONAL TRANSVERSE SAW CUT EVERY 10 FEET.

*EVERY THIRD INTERSECTION MUST BE TIED. WHEN THE MINIMUM CLEARANCE CANNOT BE OBTAINED WITH THE TRANSVERSE REBAR ON TOP, THEN THE TRANSVERSE REBAR SHALL BE TIED TO THE BOTTOM OF THE LONGITUDINAL REBAR.

PATCHING DETAIL FOR CLASS A PATCHING (CRC PAVEMENT)

EXISTING STABILIZED SUB-BASE

WITH HMA OVERLAY

6'-0" MIN

#6 REINFORCEMENT BARS AT 12" CTS

EXISTING STABILIZED SUB-BASE

3% MIN CL

SUPPORT CHAIR

-SUPPORT CHAIR

FULL DEPTH

EXISTING

PAVEMENT

EXISTING

PAVEMENT

SAW CUT

-#6X32" EPOXY COATED

PAVEMENT (TYPICAL)

 S_2

TIE BARS DRILLED AND

GROUTED INTO EXISTING

EXISTING HMA OVERLAY

FULL DEPTH

SAW CUT

(TYP.)

#6X32" EPOXY COATED

TIE BARS DRILLED AND GROUTED INTO EXISTING

PAVEMENT (TYPICAL)

REINFORCEMENT

PATCH

WITHOUT HMA OVERLAY

PATCH

REINFORCEMENT

#6 REINFORCEMENT BARS AT 12" CTS

22" MIN LAP

(TYP)

22" MIN LAP


。(TYP)

STATE OF ILLINOIS **DEPARTMENT OF TRANSPORTATION**


CLASS A PATCHES (SPECIAL) DETAIL 255 67-(1,2,3)-PP, 82-(6,7,8)-PP 7 CONTRACT NO. 76U22 SHEET 1 OF 2 SHEETS STA. TO STA.

*MONROE, ST. CLAI

TRANSVERSE EXPANSION JOINTS

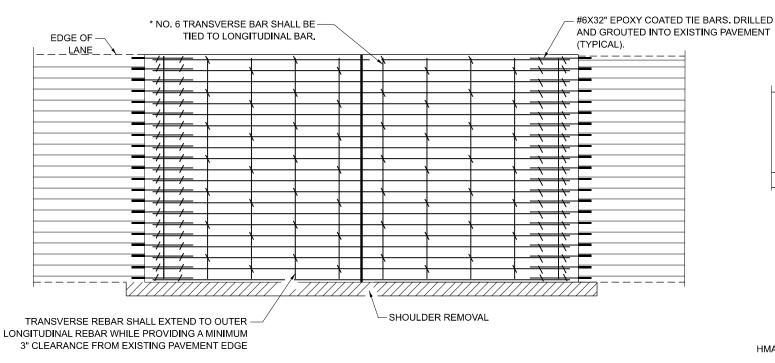

PAVEMENT REINFORCEMENT DETAIL

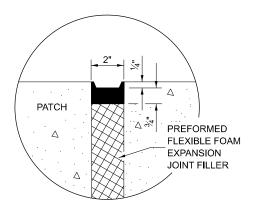


12'-0" MIN 6'-0" MIN 6'-0" MIN SEE SEALING DETAILS -© PATCH S₂ PATCH REINFORCEMENT FULL DEPTH -2" MIN CL FULL DEPTH SAW CUT SAW CUT SUPPORT 8" 2" MIN CL 22" MIN LAP CHAIR (TYP.) **EXISTING** (TYP) **EXISTING** PAVEMENT **PAVEMENT** EXISTING STABILIZED SUB-BASE -#6X32" EPOXY COATED TIE BARS DRILLED AND **WITHOUT HMA OVERLAY**

12'-0" MIN 6'-0" M**I**N 6'-0" MIN SEE SEALING DETAILS Ç PATCH S2 EXISTING - EXISTING PATCH HMA SURFACE HMA SURFACE REINFORCEMENT -2" MIN CL FULL DEPTH -(TYP) FULL DEPTH SAW CUT SAW CUT SUPPORT 8" 22" MIN LAP 2" MIN CL CHAIR (TYP.) **EXISTING EXISTING** (TYP) (TYP) PAVEMENT , PAVEMENT EXISTING STABILIZED SUB-BASE #6X32" EPOXY COATED

CLASS A PATCH WITH EXPANSION JOINT

WITH HMA OVERLAY

SEALING DETAIL

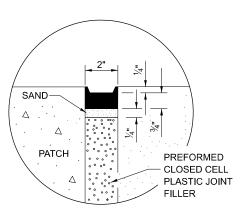

SEALING DETAIL

SCALE:

NOTES:

GROUTED INTO EXISTING PAVEMENT (TYPICAL)

TIE BARS DRILLED AND

PAVEMENT (TYPICAL)

GROUTED INTO EXISTING

EXISTING LONGITUDINAL REINFORCEMENT SPACING; ±6½".

SPACING OF NEW LONGITUDINAL REINFORCEMENT AND NEW LONGITUDINAL TIE BARS SHALL MATCH SPACING OF EXISTING REINFORCEMENT AND SHALL BE TIED TOGETHER WITH A MINIMUM OF TWO TIES PER BAR.

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** VARIABLES WHERE S₁ AND S₂ ARE 2½" MIN. AND 12" MAX.

USER NAME = Robert.Hughes	DESIGNED -	REVISED -
	DRAWN -	REVISED -
	CHECKED -	REVISED -
PLOT DATE = 8/5/2024	DATE -	REVISED -

STATE OF ILLINOIS
DEPARTMENT OF TRANSPORTATION

CLASS	A PATCH	ES (SPE	CIAL) DE	TAIL	F.A.I RTE.	SECTION
		•	,		255	67-(1,2,3)-PP, 82-(6,7,8
SHEET 2	OF 2	SHEETS	STA.	TO STA.		ILLINOIS

7 7