

FOR INDEX OF SHEETS, SEE SHEET NO. 2

1. IL. RTE. 53 (N.B.) OVER U.S. RTE. 14 & C.N.W. R.R. SN-016-0374
INCLUDES ONE 7 SPAN CONTINUOUS R.C. SLAB STRUCTURE WITH STEEL GIRDERS ON CONCRETE PIERS AND ABUTMENTS AT STA. 269+54.56 SPANS AT 64'-5 1/2", 82'-6", 65'-2 1/2", 79'-8", 82'-10", AND 61'-5"
2. IL. RTE. 53 (S.B.) OVER U.S. RTE. 14 & C.N.W. R.R. SN-016-1119
INCLUDES ONE 7 SPAN CONTINUOUS R.C. SLAB STRUCTURE WITH STEEL GIRDERS ON CONCRETE PIERS AND ABUTMENTS AT STA. 269+54.56 SPANS AT 64'-5 1/2", 82'-6", 65'-2 1/2", 79'-8", 82'-10", AND 61'-5"
3. IL. RTE. 53 (N.B.) OVER PALATINE RD. SN-016-0373
INCLUDES ONE 4 SPAN CONTINUOUS R.C. SLAB STRUCTURE WITH STEEL GIRDERS ON CONCRETE PIERS AND ABUTMENTS AT STA. 329+18.98 2 SPANS AT 60'-9" AND 2 AT 39'-3"
4. IL. RTE. 53 (S.B.) OVER PALATINE RD. SN-016-0970
INCLUDES ONE 4 SPAN CONTINUOUS R.C. SLAB STRUCTURE WITH STEEL GIRDERS ON CONCRETE PIERS AND ABUTMENTS AT STA. 329+18.98 2 SPANS AT 60'-9" AND 2 AT 39'-3"
5. IL. RTE. 53 OVER ANDERSON DRIVE SN-016-0372
INCLUDES ONE 52'-2" SPAN CONTINUOUS R.C. SLAB STRUCTURE WITH PRESTRESSED CONCRETE BEAMS ON CONCRETE ABUTMENTS AT STA. 351+81.46

STATE OF ILLINOIS
DEPARTMENT OF TRANSPORTATION

DIVISION OF HIGHWAYS
PLANS FOR PROPOSED
FEDERAL AID HIGHWAY

SCALES
PLAN
PROFILE HORIZ.
PROFILE VERT.
CROSS SECTIONS

F.A.P. 342 (IL. RTE. 53)
SECTION 531(2.1,3,3.1)RS-1(89) & 1990-116BR
U.S. RTE. 14 TO U.S. RTE. 12
RESURFACING AND BRIDGE DECK REHABILITATION
COOK COUNTY
C-91-475-89

FAP RTE	SECTION	COUNTY	TOTAL SHEETS	SHEET NO.
342	*	COOK	211	1

D-91-475-89





DESIGN DESIGNATION
9630(10) TRUNK 5.5(B-20)

STATE OF ILLINOIS
DEPARTMENT OF TRANSPORTATION
DIVISION OF HIGHWAYS

SUBMITTED: *[Signature]* 19 91
EXAMINED: *[Signature]* 19 91
PASSED: *[Signature]* 19 91
APPROVED: *[Signature]* 19 91

PRINTED BY AUTHORITY OF THE
STATE OF ILLINOIS

FOR J.U.L.I.E. INFORMATION CALL 1-800-892-0123

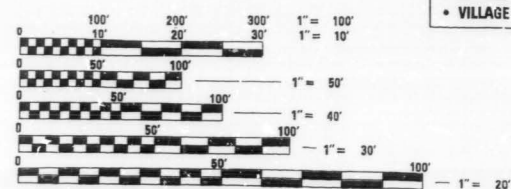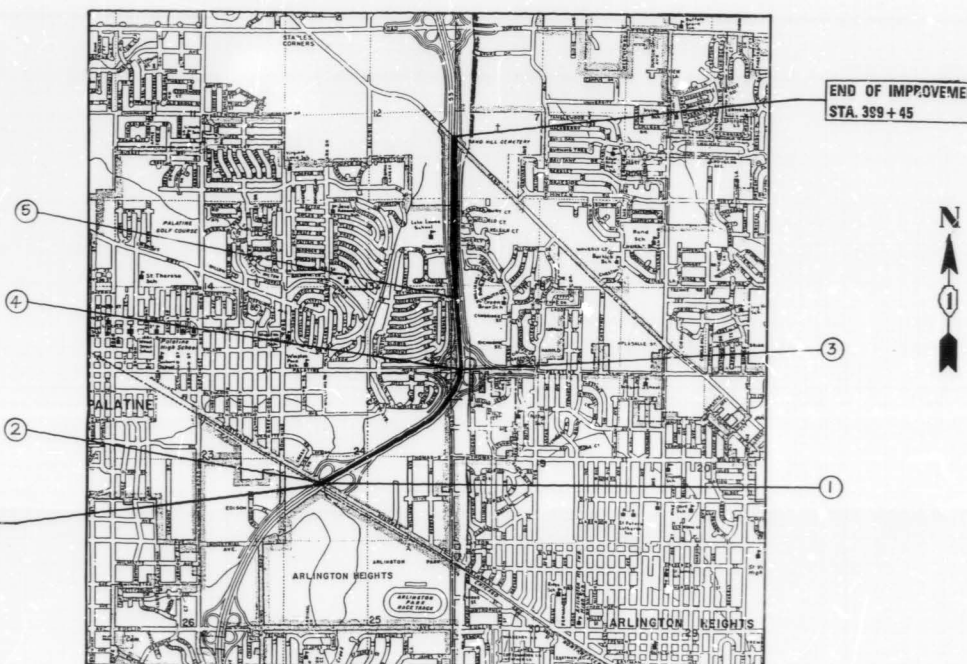


FULL SIZE PLANS HAVE BEEN PREPARED USING STANDARD ENGINEERING SCALES, REDUCED SIZED PLANS WILL NOT CONFORM TO STANDARD SCALES, IN MAKING MEASUREMENTS ON REDUCED PLANS, THE ABOVE SCALES MAY BE USED.

CONTRACT NO. 80604

NET LENGTH OF IMPROVEMENT = 13,243 LIN. FT. = 2.508 MI.
GROSS LENGTH OF IMPROVEMENT = 13,243 LIN. FT. = 2.508 MI.

PLAN PREPARATION ENGINEER
L. SORENSON/M. DE YONG, (708) 705-4432

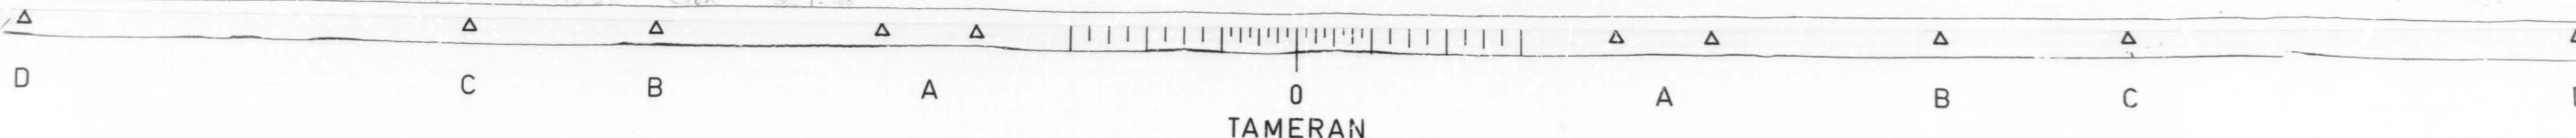

F.A.P. NO.	SECTION	COUNTY	TOTAL SHEETS	SHEET NO.
342	*	COOK	211	2
STA.	TO ST.			
FED. ROAD DIST. NO. 1	ILLINOIS	FED. AID PROJECT		

*531(2,1,3,3.1)RS-1(89)E/990-116BR

INDEX OF SHEETS

LIST OF STATE STANDARDS

SHEET NO.	DESCRIPTION
1	TITLE SHEET
2	INDEX OF SHEETS, STATE STANDARDS AND PLAN NOTES
3-7	SUMMARY OF QUANTITIES
8-11	TYPICAL CROSS SECTIONS
12-21	PLAN - MAINLINE
22-33	PLAN - RAMPS
34-37	BARRIER WALL DETAILS
38-42	BARRIER WALL PROFILE
43-52	DRAINAGE AND UTILITIES - MAINLINE
53-58	DRAINAGE AND UTILITIES - RAMPS
59-60	CATCH BASIN 4x3 AND 4x8
61-64	TYPICAL CROSS SECTIONS - STAGING
65-73	SUGGESTED STAGES OF CONSTRUCTION
74	TEMPORARY INFORMATION SIGNING - FOR STAGING
75	TEMPORARY CONCRETE BARRIER WITH IMPACT ATTENUATOR
76-78	LANE CLOSURES - FREEWAY STANDARDS
79	RAMP CLOSURES - DETAIL
80	TEMPORARY PAVEMENT MARKING - LETTERS AND SYMBOLS
81	TRAFFIC CONTROL - SIDEROADS, INTERSECTIONS, AND DRIVEWAYS
82-85	TEMPORARY INFORMATION SIGNING - SIGN TRUSS REMOVAL
100-120	SIGN TRUSS PLAN AND DETAILS
121-123	ELECTRICAL PLAN AND DETAILS
124-145	SURVEILLANCE
146	LUG SYSTEM DETAIL
147-150	APPROACH SLAB DETAILS
151	BRIDGE APPROACH SHOULDER PAVEMENT
152-159	BRIDGE PLANS - U.S. ROUTE 14 & CNW RR (NB)
160-167	BRIDGE PLANS - U.S. ROUTE 14 & CNW RR (SB)
168-173	BRIDGE PLANS - PALATINE ROAD (NB)
174-179	BRIDGE PLANS - PALATINE ROAD (SB)
180-187	BRIDGE PLANS - ANDERSON DRIVE
188	NEOPRENE JOINT DETAIL
189	RETROFIT CONCRETE PARAPET DETAIL
190	BAR SPLICER DETAIL
191-192	CROSS SECTIONS - DITCH REGRADING
193-205	CROSS SECTIONS - CENTERLINE MEDIAN
206-211	DISTRICT DETAILS

STANDARD #	DESCRIPTION
2149-11	DELINEATORS
2213-4	FRAME AND LIDS, TYPE 1
2225-3	REINFORCEMENT FOR CONTINUOUSLY REINFORCED P.C.C. PAVEMENT
2228-4	METAL END SECTION FOR PIPE CULVERTS
2230-16	STEEL PLATE BEAM GUARDRAIL
2233-12	36' CONTINUOUSLY REINFORCED P.C.C. PAVEMENT
2237-11	B.A.M. SHOULDER DETAILS - ADJACENT TO RIGID PAVEMENT
2298-8	TYPICAL APPLICATION OF TRAFFIC CONTROL DEVICES
2299-11	DESIGN OF TRAFFIC CONTROL DEVICES
2300-3	FLAGMAN TRAFFIC CONTROL SIGN
2307-6	TYPICAL APPLICATION OF TRAFFIC CONTROL DEVICES SHORT-TIME OPERATION, DAY OR NIGHT
2308-5	TYPICAL APPLICATION OF TRAFFIC CONTROL DEVICES RURAL, DAY OR NIGHT, MOVING OPERATIONS
2314-5	TYPICAL APPLICATION OF TRAFFIC CONTROL DEVICES MULTILANE DIV. AND UNDIV., RURAL, DAY OR NIGHT
2316-12	TYPICAL APPLICATION OF TRAFFIC CONTROL DEVICES MULTILANE DIV. AND UNDIV., RURAL, OVER ONE DAY
2323-11	PAVEMENT JOINTS
2324-7	BRIDGE APPROACH SHOULDER PAVEMENT
2326-3	TRAFFIC BARRIER TERMINAL, TYPE 10
2327-11	SUB-SURFACE DRAINS
2333-3	CONCRETE BARRIER
2336-4	TRAFFIC BARRIER TERMINAL, TYPE 1 AND 1A
2337-2	TRAFFIC BARRIER TERMINAL, TYPE 2
2338-2	TRAFFIC BARRIER TERMINAL, TYPE 3 & 3A
2340-4	TRAFFIC BARRIER TERMINAL, TYPE 5 & 5A
2341-3	TRAFFIC BARRIER TERMINAL, TYPE 6
2360-4	BRIDGE APPROACH PAVEMENT (50 FT.)
2362-3	CONCRETE HEADWALL FOR PIPE DRAINS
2381	TEMPORARY EROSION CONTROL SYSTEMS
2383-1	TEMPORARY CONCRETE BARRIER
2385	FRAME AND GRATE, TYPE 20
2386	FRAME AND GRATE, TYPE 21
2409-1	TYPICAL APPLICATION OF TRAFFIC CONTROL DEVICES TWO LANE, TWO-WAY, RURAL, ONE-LANE CLOSURE ON BRIDGE DECK, DAY OR NIGHT OPERATIONS
2425-1	CLASS A PATCHES
2427-1	CLASS C AND D PATCHES
U-2	TYPICAL APPLICATION OF TRAFFIC CONTROL DEVICES
U-4	TYPICAL APPLICATION OF TRAFFIC CONTROL DEVICES
2419	" " " " " " " "
△2429	P.C.C. SHOULDER DETAILS

PLAN NOTES

BEFORE STARTING ANY EXCAVATION, THE CONTRACTOR SHALL CALL "JULIE" AT 800-892-0123 OR "DIGGER" (CHICAGO UTILITY ALERT NETWORK), (312)774-7000 FOR FIELD LOCATIONS OF BURIED ELECTRIC, TELEPHONE AND GAS FACILITIES. (48 HOURS NOTIFICATION IS REQUIRED).

THE CONTRACTOR SHALL COORDINATE CONSTRUCTION ACTIVITIES WITH UTILITY COMPANIES AND THE CITY OF CHICAGO.

THE CONTRACTOR WILL NOT BE ALLOWED TO SET UP A YARD OR FIELD OFFICE ON STATE PROPERTY WITHOUT WRITTEN PERMISSION FROM THE DEPARTMENT.

THE REMOVAL OF GUARDRAIL TERMINAL SECTIONS SHALL BE INCLUDED IN THE UNIT PRICE PER LINEAL FOOT FOR STEEL PLATE BEAM GUARD RAIL REMOVAL.

BARRICADES: THE CONTRACTOR SHALL PROVIDE AND INSTALL TWO (2) WEIGHTED SAND BAGS ON EACH TYPE I OR TYPE II BARRICADE USED. (ONE (1) WEIGHTED SAND BAG ACROSS EACH BOTTOM RAIL).

WHEN ARTIFICIAL LIGHTING IS UTILIZED IN NIGHT OPERATIONS THE CONTRACTOR SHALL EXERCISE THE UTMOST PRECAUTIONS IN PREVENTING ADVERSE VISIBILITY TO THE MOTORING PUBLIC AND ADJOINING RESIDENTIAL AREAS.

REVISIONS	
NAME	DATE

ILLINOIS DEPARTMENT OF TRANSPORTATION
 INDEX OF SHEETS,
 STATE STANDARDS
 AND
 PLAN NOTES

SCALE: VERT. _____
 HORIZ. _____


DRAWN BY _____
 CHECKED BY _____

△ Rev 2-06-91




EXISTING BRIDGE DESCRIPTION


THE BRIDGE CONSISTS OF A 7 SPAN CONTINUOUS WIDE FLANGE BEAM STRUCTURE WITH SPANS AT 64'-5 1/2", 82'-6", 65'-2 1/2", 79'-8", 82'-10", AND 61'-5", ON OPEN R.C. ABUTMENTS AND R.C. PIERS. THE 7" THICK CONCRETE DECK HAS A 2" THICK BITUMINOUS CONC. OVERLAY.

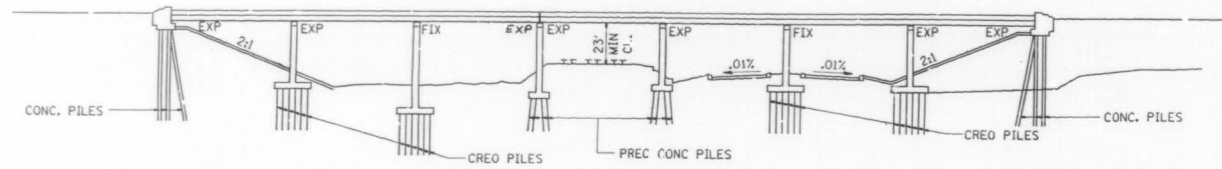

ELEVATION

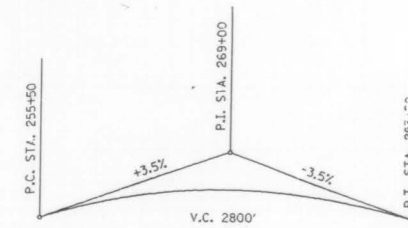

VERTICAL CURVE DATE IL RTE 53

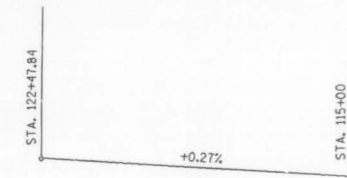


PROFILE NORTHWEST HIGHWAY

NO.	SECTION	DATE	BY	NO.
342	*	COOK	Z11	152
STA.	TO STA.			
P.L. STA. 269+00		P.L. STA. 283+50		

* 5... (2, 1, 3, 3, 1) RS-1 (89) (1990-116 BR SHEET 1 OF 8


INDEX OF SHEETS

- 1) PLAN AND ELEVATION
- 2) GENERAL NOTES AND SUMMARY OF QUANTITIES
- 3) DECK DETAILS
- 4) DELAYTECT
- 5) BOTTOM DECK SURVEY
- (6-7) JOINT RECONSTRUCTION DETAILS
- 8) STAGING CROSS SECTION

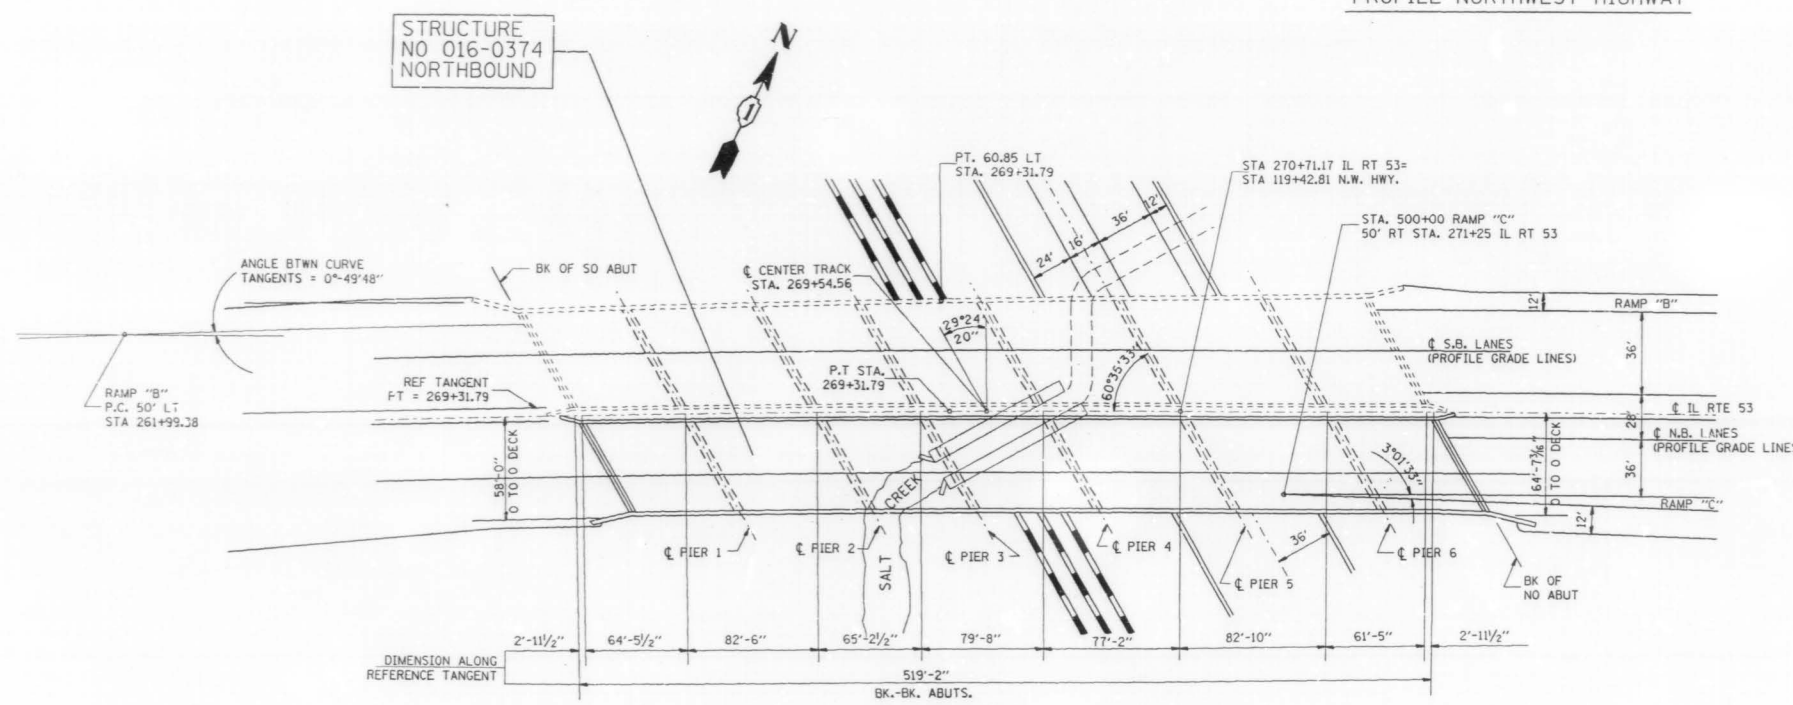

PLAN

CL NORTHBOUND LANES

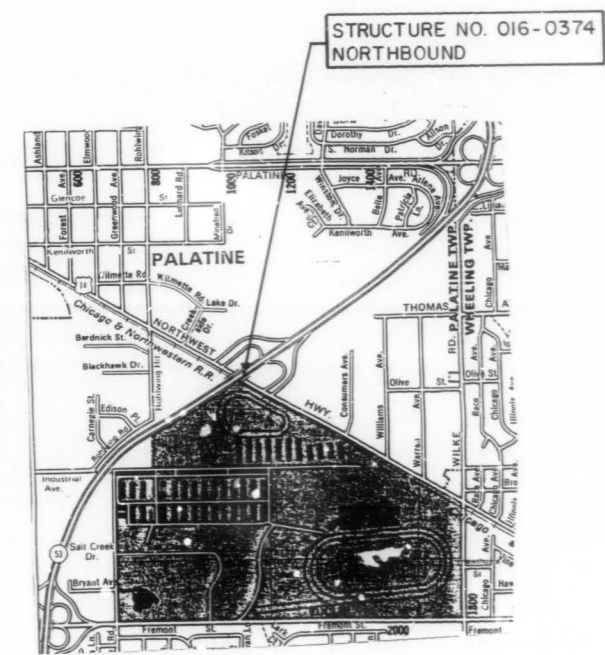

LOCATION MAP

CURVE

P.I. STA= 236+37.28
 $\Delta = 77^\circ 11' 38''$
 $D = 00^\circ 57' 17.8$
 $R = 6000'$
 $T = 4,789.21'$
 $L = 8,083.72'$
 $E = 1,677.02$
 $S.E. = 0.02-1/1$
 P.C. STA= 188+48.07
 P.T. STA= 269+31.79

LOCATION	STATION	GRADE ELEV	BTM FTG ELEV
BK SO ABUT	267+20.98	756.07	747.53
CL PIER 1	267+87.74	756.40	714.89
CL PIER 2	268+69.99	756.65	699.37
CL PIER 3	269+35.41	756.73	708.01
CL PIER 4	270+15.08	756.68	710.20
CL PIER 5	270+92.25	756.48	713.93
CL PIER 6	271+75.08	756.10	714.54
BK NO ABUT	272+39.45	755.68	746.79

TRANSITION FROM FULL SUPERELEVATION TO NORMAL CROWN STA. 268+31.79 TO STA. 270+31.79

ILLINOIS DEPARTMENT OF TRANSPORTATION

IL. RTE. 53 @ U.S. RTE. 14 N.B. BRIDGE REHABILITATION STRUCTURE NO. 016-0374 PLAN & ELEVATION

REVISIONS	
NAME	DATE

SCALE: VERT. NONE
 DATE 10/23/90
 DRAWN BY
 CHECKED BY

11-OCT-90 13:33:08 (CREATED)
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 LEVELS = 35

VI-BR7



F. A. P. RTE.	SECTION	COUNTY	TOTAL SHEETS	SHEET NO.
342	*	COOK	211	153
STA.		TO STA.		
FED. ROAD DIST. NO. 7	CLASS	FED. AID PROJECT		

* 531(2, 1, 3, 3, 1) RS-1(89) 1990 - 116 BR
SHEET 2 OF 8

NOTES:

1. ~~The Zinc-silicate and vinyl paint system shall be used for shop and field painting of Structural Steel except where otherwise noted. The color of the vinyl finish coat shall be Munsell No. 7.5G 4/8.~~
2. All structural steel shall be AASHTO M 222 except expansion joint plates and attached bars which shall be AASHTO M 183.
- 2.A. ~~DECK REPAIR METHOD II SHALL BE USED FOR THIS STRUCTURE (SEE SPECIAL PROVISIONS).~~
3. Expansion joint plates and attached bars shall be shop painted with the zinc-silicate primer.
4. ~~AASHTO M 222 structural steel shall not be painted except, that for a distance of three times the depth of the beams or girders (but not exceeding 10 feet) each way from deck joints, the AASHTO M 222 structural steel shall be cleaned and given one coat of the zinc-silicate primer and a dark maroon vinyl finish coat. The color of the finish coats shall be Munsell No. 2.5 R 3/4 reddish brown. Both coats may be applied in the shop with spot painting only in the field.~~
5. The structural steel bearing plates of the Elastomeric Bearing Assembly shall conform to the requirements of AASHTO M 223 Grade 50 (AASHTO M 222).
6. Reinforcement bars shall conform to the requirements of AASHTO M-31, M-42 or M-53 Grade 60.
7. Plan dimensions and details relative to existing structure have been taken from existing plans and are subject to nominal construction variations. It shall be the Contractor's responsibility to verify such dimensions and details in the field and make necessary approved adjustments prior to construction or ordering of materials. Such variations shall not be cause for additional compensation for a change in the scope of the work, however, the Contractor will be paid for the quantity actually furnished at the unit price bid for the work.
8. ~~All accessible end areas of steel beams, exposed top of steel beams, end diaphragms, and bearings designated by the Engineer for painting shall be cleaned by Method 1. The three coat lead and chromate free alkyd paint system shall be applied over all cleaned areas, except the exposed top of steel beams to be embedded in concrete shall receive only one coat of the primer of this system. The color of the final finish coat shall be INTERSTATE GREEN. This work will be paid for in accordance with Article 109.04 of the Standard Specifications.~~

TOTAL BILL OF MATERIALS

ITEM	UNIT	TOTAL
BITUMINOUS CONCRETE REMOVAL (DECK)	SQ. YD.	3238.0
CONCRETE BRIDGE DECK SCARIFICATION, 1/2"	SQ. YD.	3238.0
DECK SLAB REPAIR (PARTIAL DEPTH)	SQ. YD.	46.0
DECK SLAB REPAIR (FULL DEPTH)	SQ. YD.	20.0
CONCRETE REMOVAL, SPECIAL	CU. YD.	24.5
HANDRAIL REMOVAL	LIN. FT.	1031.0
NEOPRENE EXPANSION JOINT, 2"	LIN. FT.	139
REINFORCEMENT BARS, EPOXY COATED	POUND	4311.0
CLASS X CONCRETE SUPERSTRUCTURE	CU. YD.	28.4
MICROSILICIA CONCRETE BRIDGE DECK OVERLAY, 2 1/2"	SQ. YD.	3238.0
PROTECTIVE COAT	SQ. YD.	3781.0
PROTECTIVE SHIELD	SQ. YD.	1630.0
RETROFIT CONCRETE PARAPET	LIN. FT.	1031.0
FURNISHING AND ERECTING STRUCTURAL STEEL	POUND	0
SAWING P.C. CONCRETE PAVEMENT, 3/4"	LIN. FT.	470
NEOPRENE EXPANSION JOINT, 4"	LIN. FT.	68

REVISIONS	
NAME	DATE



DEPARTMENT OF TRANSPORTATION
IL RTE. 53 @ U.S. RTE. 14
(NORTHBOUND LANES)
GENERAL NOTES
AND
BILL OF MATERIALS
S.N. 016-0374
DATE
CHECKED BY R.V.



DAD COPY

- LEGEND**
- DECK SLAB REPAIR (PARTIAL DEPTH) SEE DELAMTEC SHEET NO. 4
 - DECK SLAB REPAIR (FULL DEPTH) SEE BOTTOM DECK SURVEY SHEET NO.5
 - CONCRETE TO BE REMOVED


STRUCTURE NO 016-0374 NORTHBOUND

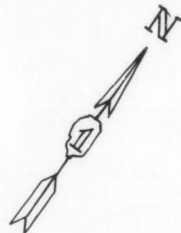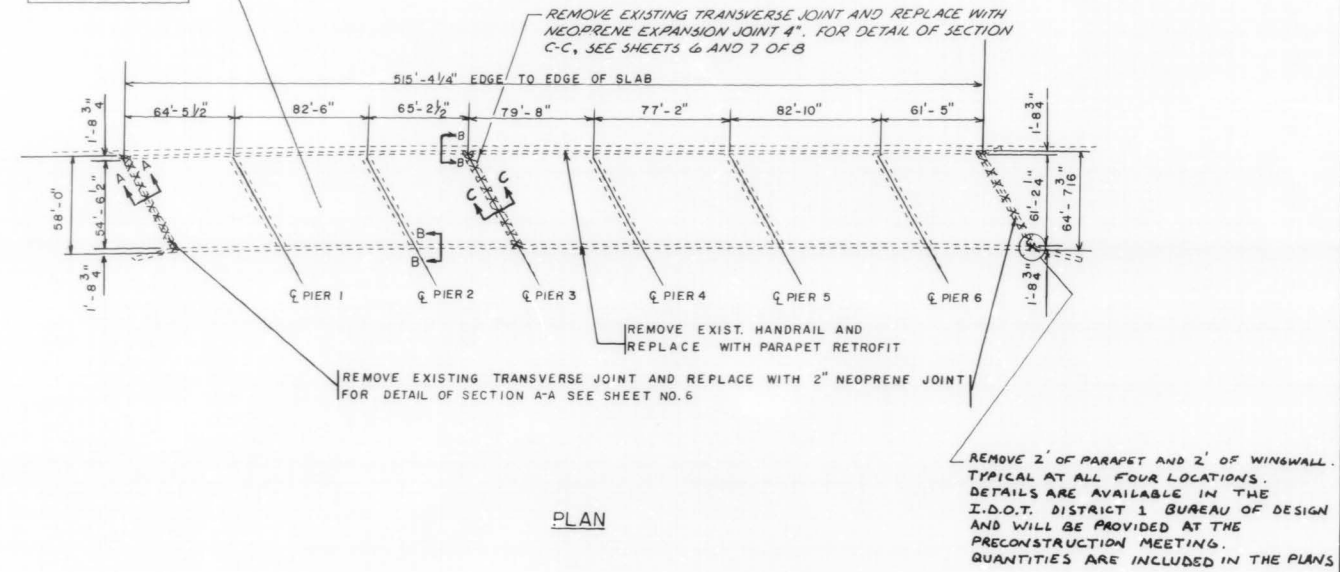


F.A.P. NO.	SECTION	COUNTY	PROJECT NO.
342	*	COOK	211 159
STA.	TO STA.		
FED. ROAD DIST. NO.	SUBMIT	FED. AID PROJECT	

* 531 (2,1,3,3,1)RS-1(89) & 1990-116BR
SHEET 3 OF 8


BILL OF MATERIALS		QUANTITIES	
ITEM	UNIT	TOTAL	
BITUMINOUS CONCRETE REMOVAL (DECK)	SQ. YD.	3238	
CONCRETE BRIDGE DECK SCARIFICATION, 1/2"	SQ. YD.	3238	
DECK SLAB REPAIR (PARTIAL DEPTH)	SQ. YD.	46	
DECK SLAB REPAIR (FULL DEPTH)	SQ. YD.	20	
MICROSILICIA CONCRETE BRIDGE DECK OVERLAY, 2 1/2"	SQ. YD.	3238	
PROTECTIVE COAT	SQ. YD.	3765	
PROTECTIVE SHIELD	SQ. YD.	1630	
RETROFIT CONCRETE PARAPET	LIN. FT.	1031	
HANDRAIL REMOVAL	LIN. FT.	1031	

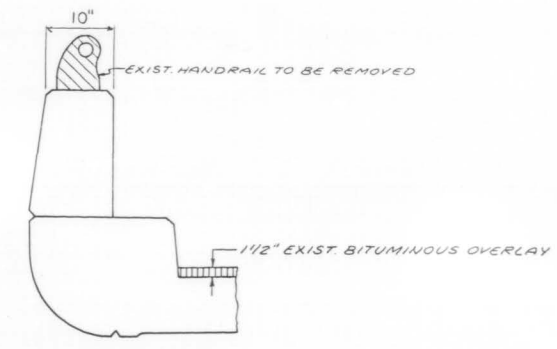


SECTION B-B
EXISTING PARAPET & HANDRAIL

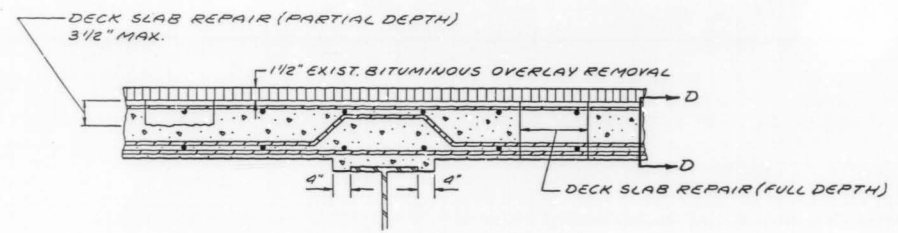

TYPICAL SECTION OF EXISTING DECK

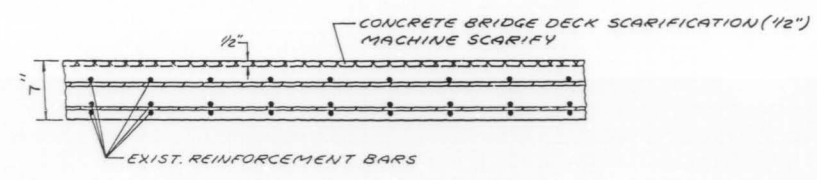

SECTION D-D

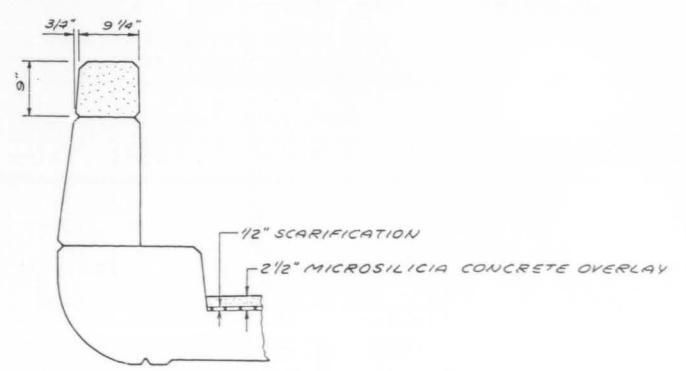

PARAPET WITH PROPOSED RETROFIT

REVISIONS	
NAME	DATE

ILLINOIS DEPARTMENT OF TRANSPORTATION
IL. RTE. 53 @ U.S. RTE. 14 N.B.
BRIDGE REHABILITATION
STRUCTURE NO. 016-0374
PLAN & ELEVATION

SCALE NO SCALE
DATE 10/23/90

DRAWN BY
CHECKED BY R.Y.



STRUCTURE NO. 016-0374 NORTHBOUND
 STRUCTURE NO. 016-0374 NORTHBOUND
 LEVEL 1.00

VI--BR17

F A P	SECTION	COUNTY	TOTAL SHEETS	SHEET NO.
342	*	COOK	211	155
STA.		TO STA.		
FED. ROAD DIST. NO. 7		ILLINOIS		FED. AID PROJECT

* 53(2,3,3.1)RS-1(89) 1990-116 BR
SHEET 4 OF 8

SOUTH ABUTMENT

MATCH LINE A-A

MATCH LINE A-A

NORTH ABUTMENT

BRIDGE: 01600374
DATE: 5/24/90
OPERATOR: MATECHICK 53 NB/14 & RR
COMMENTS: SKW 60-36'

ROADWAY AREA: 3238 SY
DELAMINATED AREA: 46 SY
% DELAMINATED: 2 %



REVISIONS	
NAME	DATE

DEPARTMENT OF TRANSPORTATION
IL. RTE. 53 @ U.S. RTE. 14 N.B.
BRIDGE REHABILITATION
STRUCTURE NO. 016-0374
DELAMTECT
DATE
CHECKED BY



F&P RTE.	SECTION	COUNTY	TOTAL SHEETS	SHEET NO.
342	*	COOK	211	156
STA.		TO STA.		
F&P ROAD DIST. NO. 7		F&P AIR PROJECT		

* 53(2,3,3)RS-1(89) 1990-116 BR
SHEET 5 OF 8

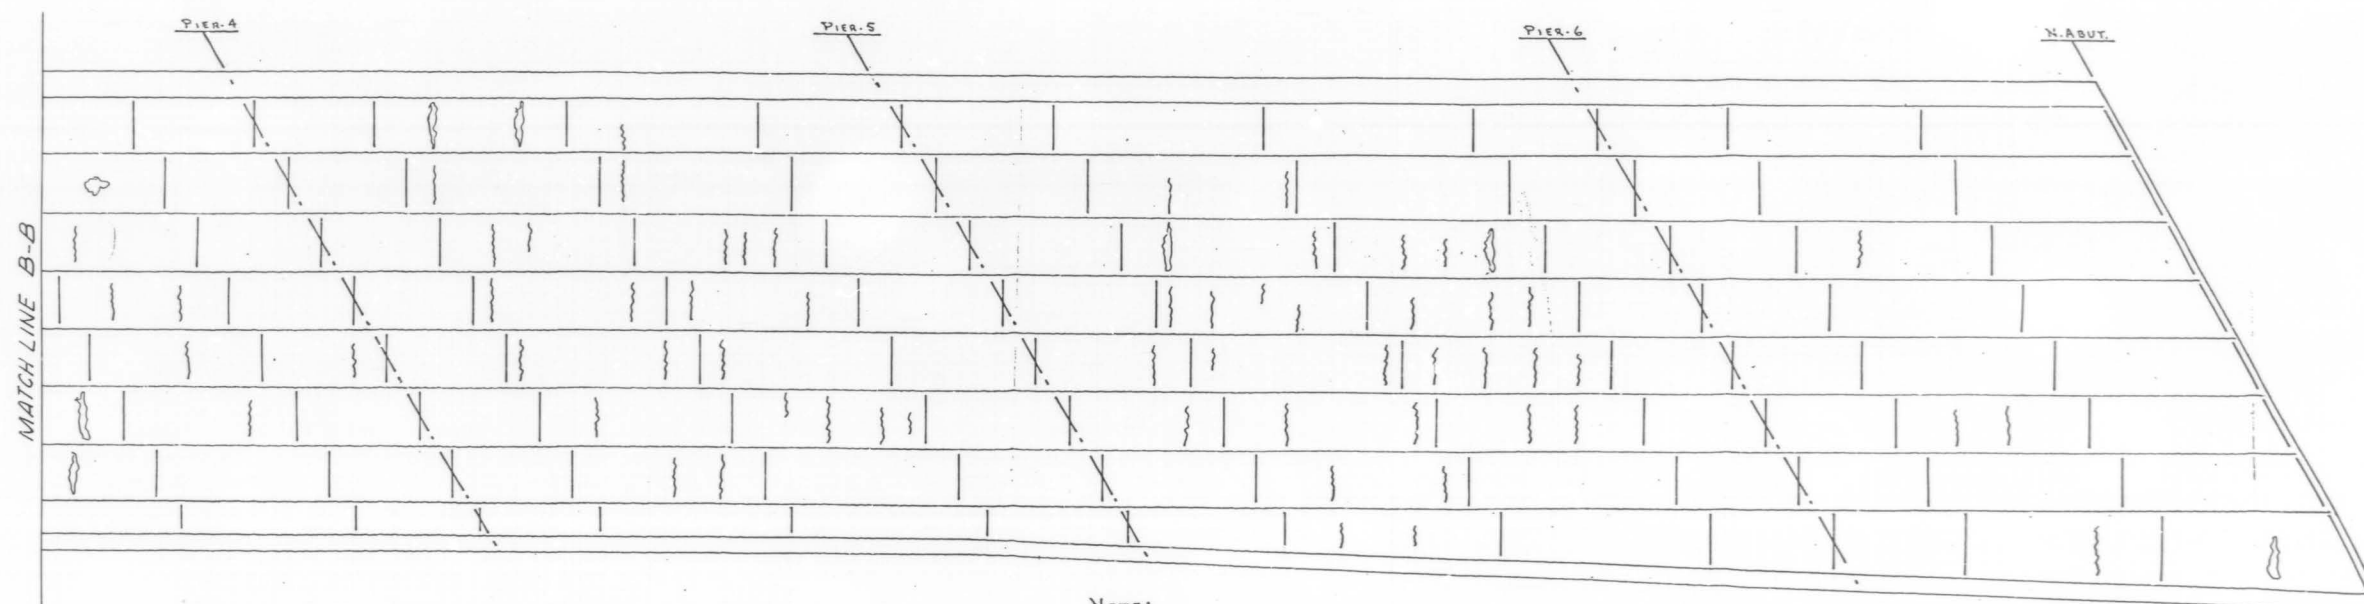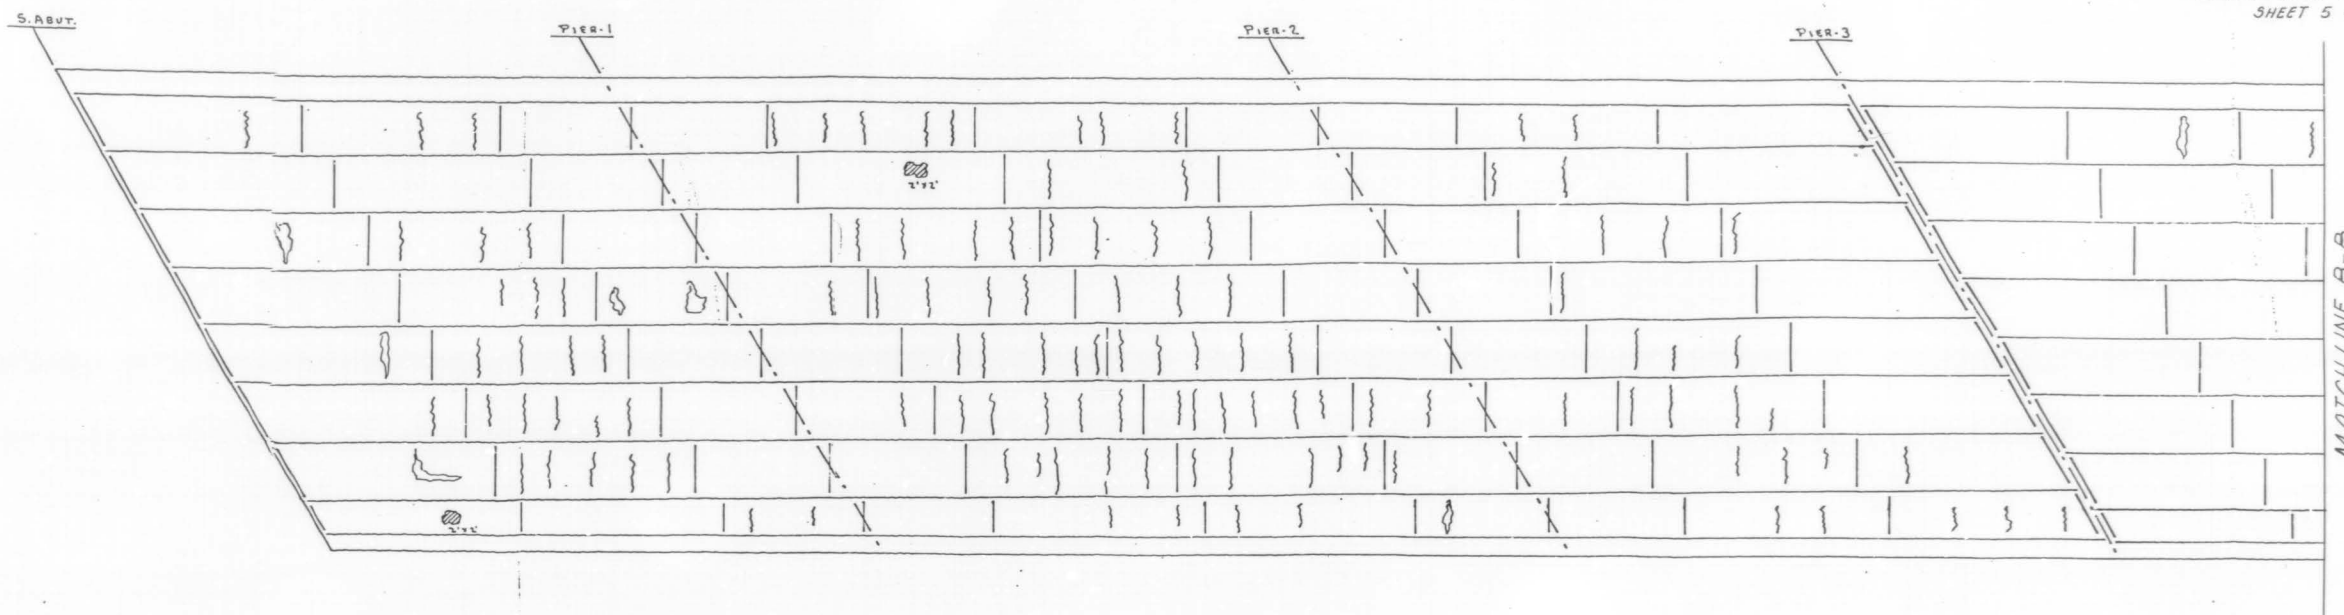

NOTE:
 ☉ - SPALL AREAS - 8 SQ. FT.
 ○ - LEACHING AREAS
 } } } - LEACHING CIRCLES

BRIDGE ILL 53NB/US14 CNW.R.R.
 BRIDGE NO. 016-0374 * 626
 BOTTOM DECK SURVEY
 FIELD DATA NM DATE 2/8/50
 DRAWN BY NM DATE 2/12/50


REVISIONS	
NAME	DATE

DEPARTMENT OF TRANSPORTATION
 ILL. RTE. 53 @ U.S. RTE. 14 N.B.
 BRIDGE REHABILITATION
 STRUCTURE NO. 016-0374
 BOTTOM DECK SURVEY
 DATE
 CHECKED BY




NOTES: EXISTING REINFORCEMENT BARS IN THE REMOVAL AREAS SHALL BE CLEANED BEFORE PLACEMENT OF NEW CLASS X CONCRETE. (COST TO BE INCIDENTAL TO CLASS X CONCRETE).
REMOVAL OF EXISTING STRUCTURAL STEEL SHALL BE INCIDENTAL TO CONCRETE REMOVAL SPECIAL.

F.D.P. DIST.	SECTION	COUNTY	SHEET NO.	SHEET
342	*	COOK	211	157
STA.		TO STA.		FED. AID PROJECT
* 531(2,1,3,3,1)RS-1(89)E1990-116 BR		SHEET 6 OF 8		

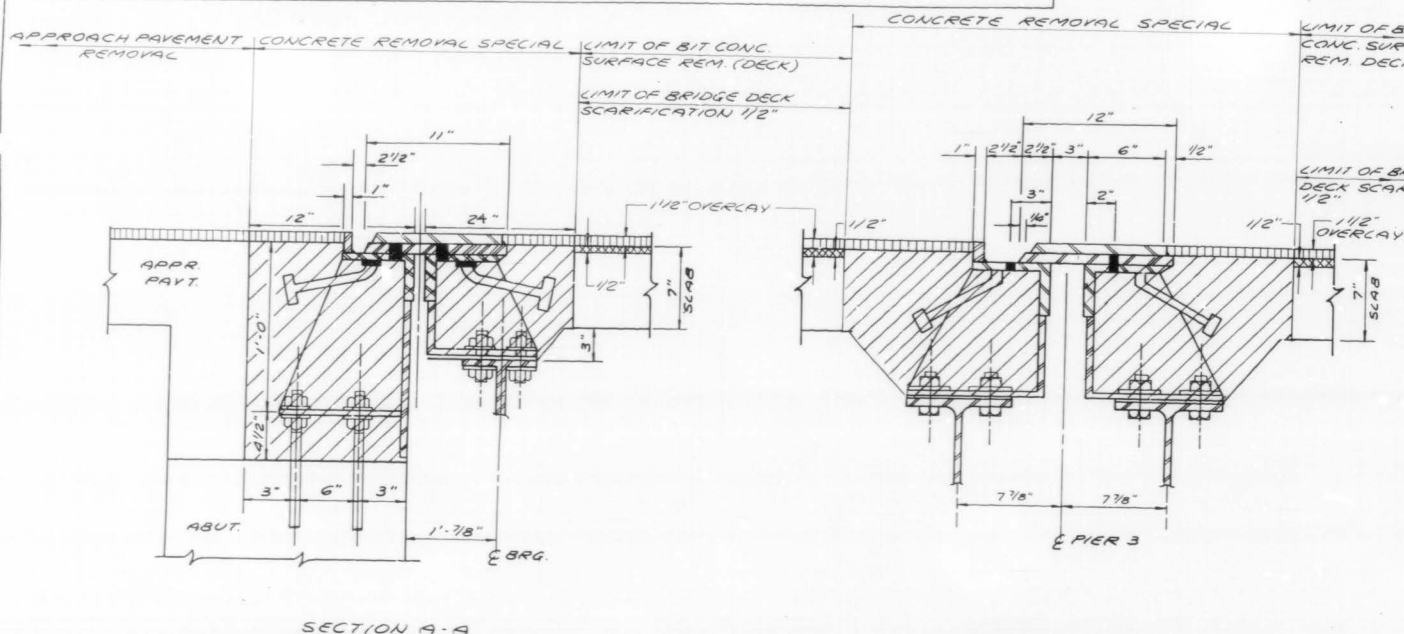

SECTION C-C
SECTION OF EXISTING EXPANSION DEVICE AT PIER 3

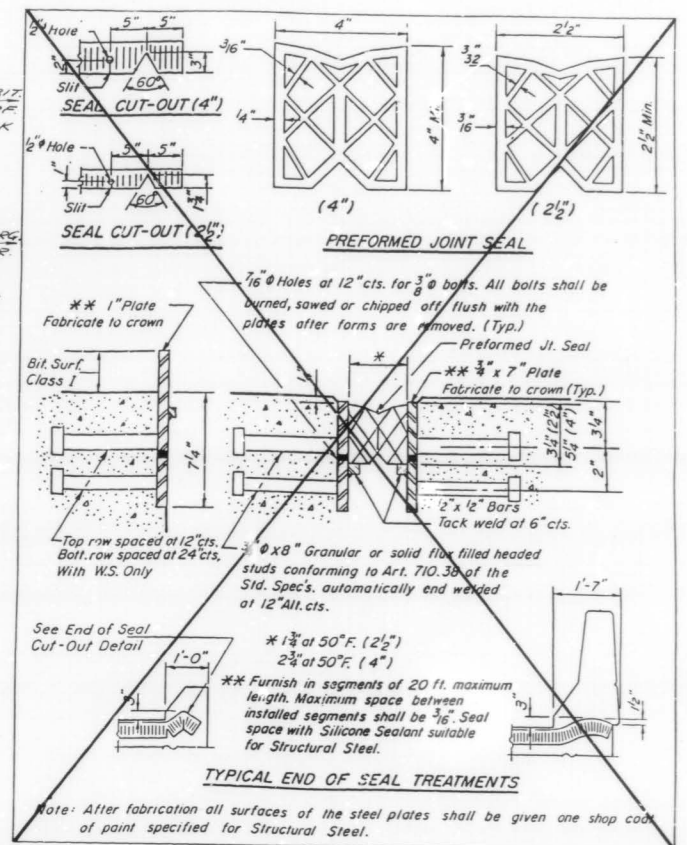


BAR LIST

BAR NO.	SIZE	LENGTH	SHAPE
Q ₁ (E)	#4	30'-7"	—
Q ₂ (E)	#6	30'-7"	—
Q ₃ (E)	#5	31'-9"	—
Q ₄ (E)	#6	20'-9"	—
Q ₅ (E)	#5	20'-7"	—
U ₁ (E)	#4	3'-10"	□
U ₁ (E)	#4	3'-1"	□
U ₂ (E)	#4	1'-11"	□


(E) DENOTES EPOXY COATED

BILL OF MATERIALS

ITEM	UNIT	QUANTITY
CONCRETE REMOVAL, SPECIAL	CU. YD.	24.5
REINFORCEMENT BARS (EPOXY COATED)	POUND	4311.0
CLASS X CONCRETE SUPERSTRUCTURE	CU. YD.	28.4
SAWING P.C.C. PAVEMENT, 3/4"	LIN. FT.	470
FURNISHING AND ERECTING STRUCTURAL STEEL	POUND	0
NEOPRENE EXPANSION JOINT, 2"	LIN. FT.	139
PROTECTIVE COAT	SQ. YD.	82
NEOPRENE EXPANSION JOINT, 4"	LIN. FT.	68

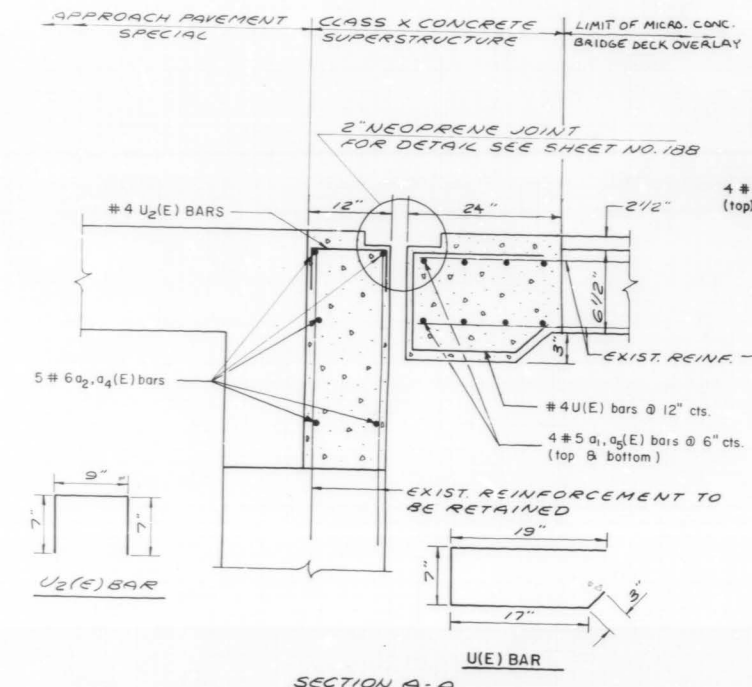

SECTION A-A
SECTION THRU PROPOSED JOINT AT N. AND S. ABUTMENT

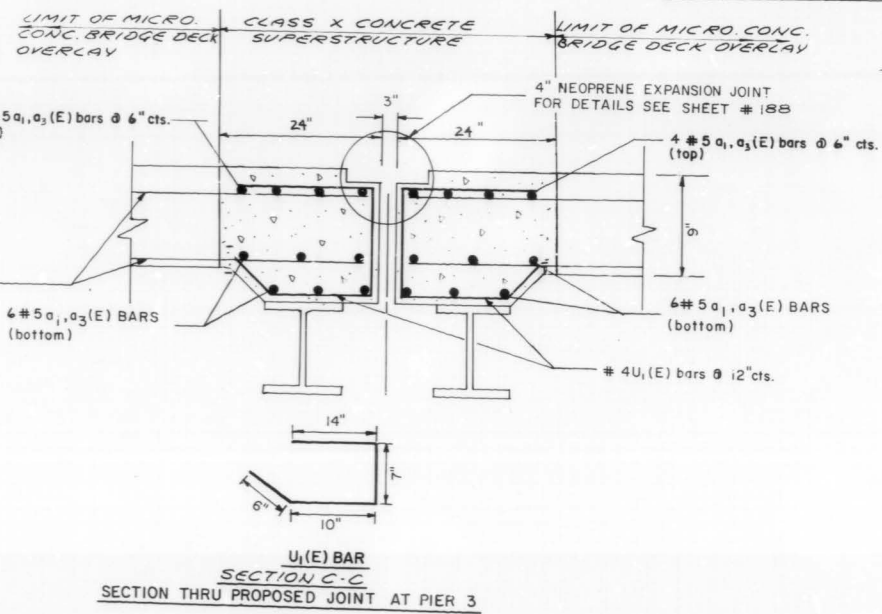

SECTION C-C
SECTION THRU PROPOSED JOINT AT PIER 3

REVISIONS

NAME	DATE




ILLINOIS DEPARTMENT OF TRANSPORTATION
IL. RTE. 53 @ U.S. RTE. 14
(NORTHBOUND LANES)
STRUCTURE NO. 016 - 0374
JOINT RECONSTRUCTION DETAILS

SCALE: VERT. NONE DRAWN BY J.R.C.
HORIZ. CHECKED BY R.V.
DATE NOVEMBER, 1990



FOA #1	SECTION	COUNTY	TOTAL SHEETS	SHEET NO.
342	*	COOK	211	158
STA.	TO STA.			
FED. ROAD DIST. NO. 1	ILLINOIS	FED. AID PROJECT		


* 531(2,1,3,3.1)RS-1(89)E1990-116BR
SHEET 7 OF 8

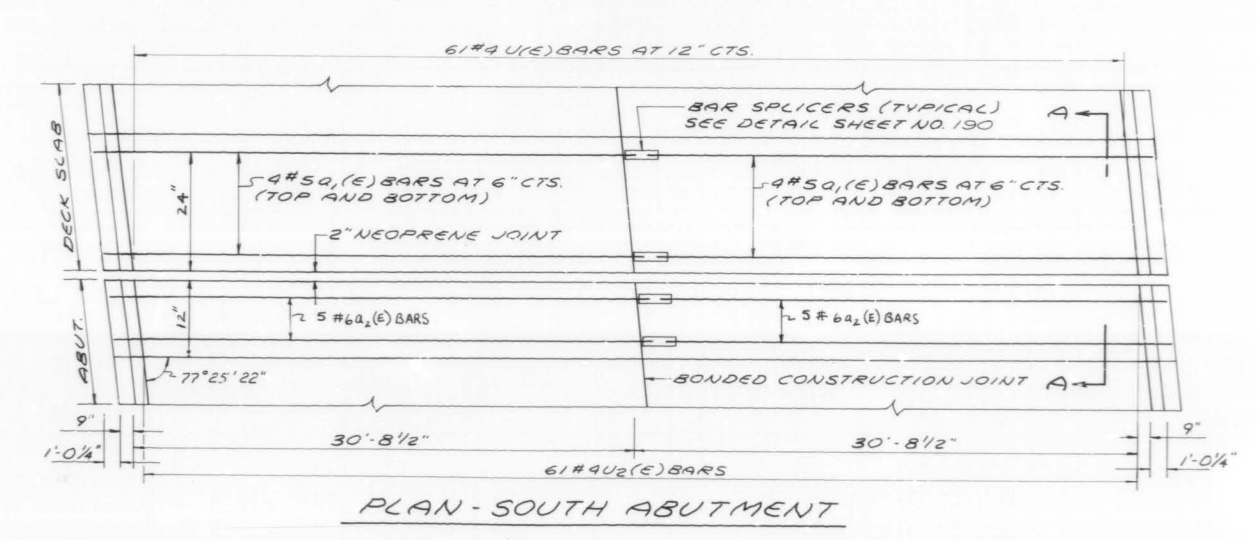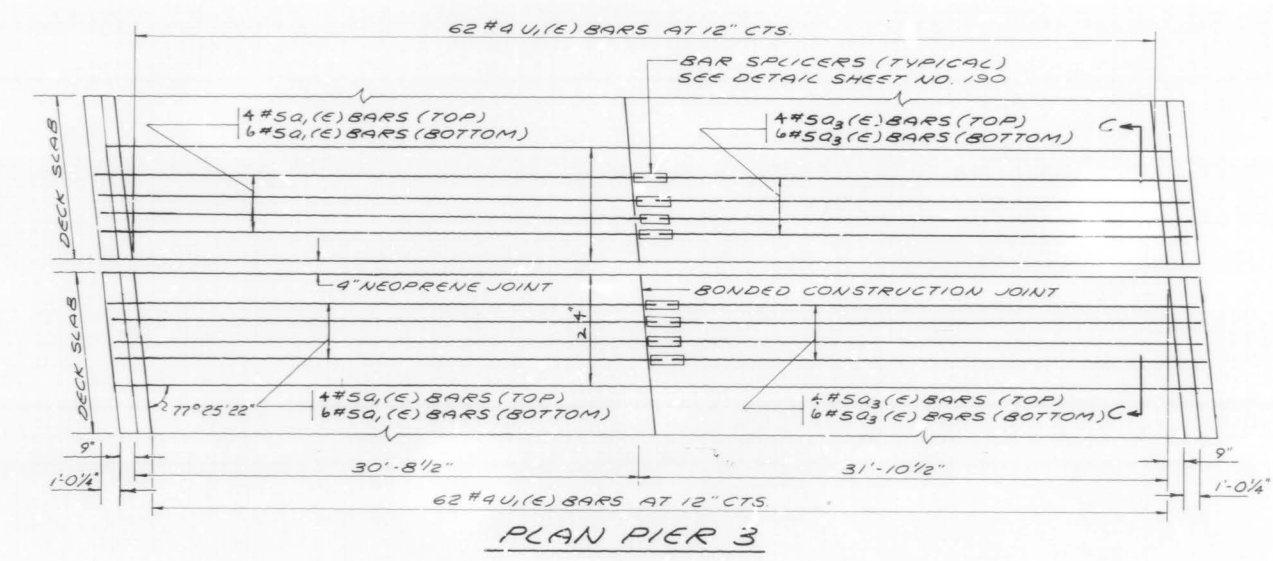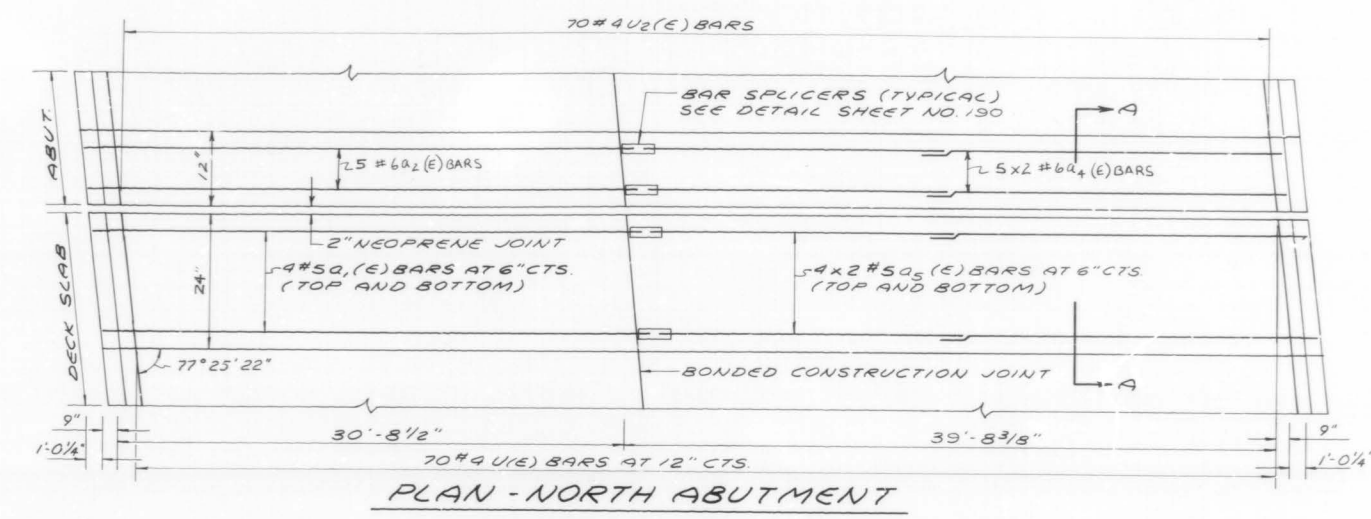

REVISIONS	
NAME	DATE


ILLINOIS DEPARTMENT OF TRANSPORTATION
IL. RTE. 53 @ U.S. RTE. 14
(NORTH BOUND LANES)
STRUCTURE NO. 016-0374
JOINT RECONSTRUCTION DETAILS

SCALE: VERT. NONE
HORIZ. 1/4" = 1'-0"
DATE: NOVEMBER, 1990
DRAWN BY: J.C.
CHECKED BY: R.V.

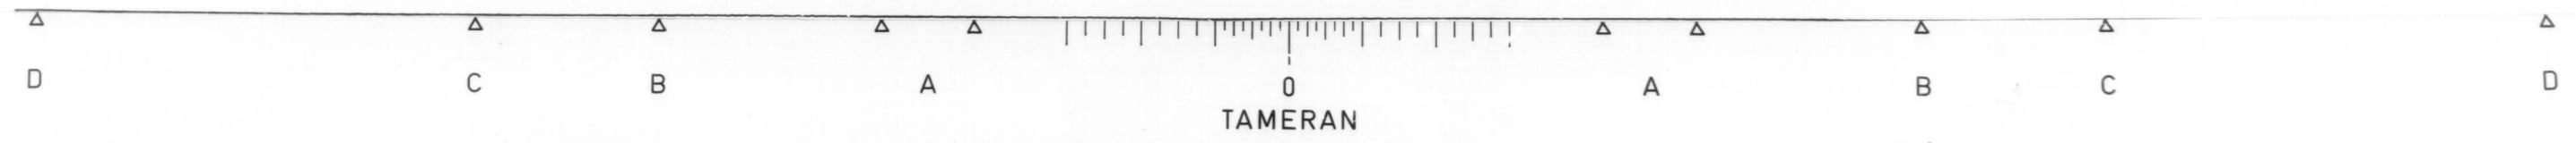


F.A.P. RTE	SECTION	COUNTY	TOTAL SHEETS	SHEET NO.
342	*	COOK	211	159
STA.		TO STA.		
FED. ROAD DIST. NO. 7		ILLINOIS	FED. AID PROJECT	

* 531(2,3,3)RS-1(89) & 1990-116 BR
SHEET 8 OF 8

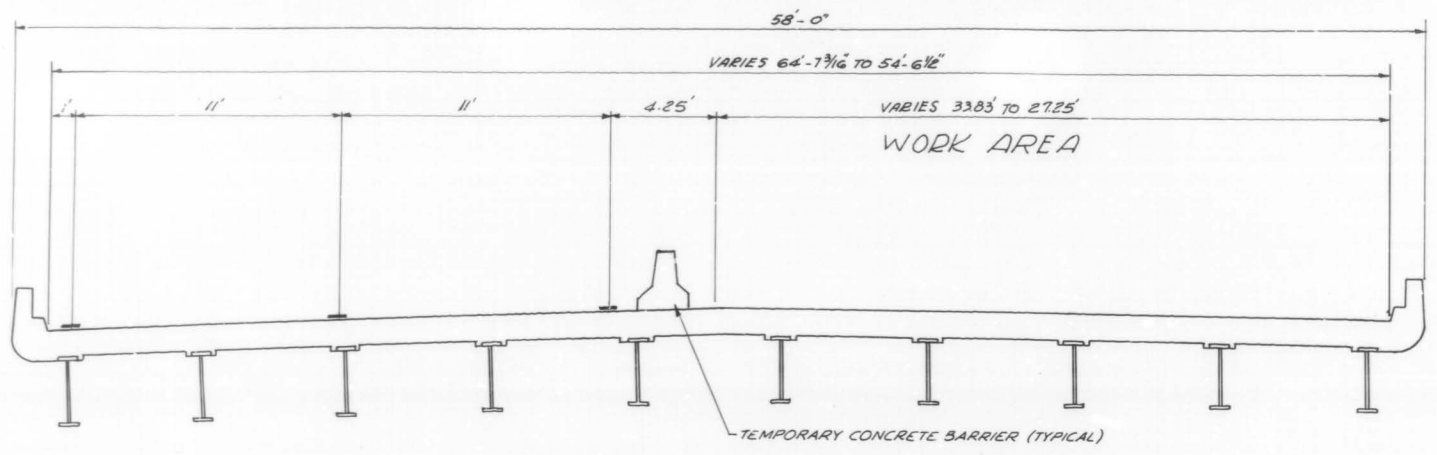

NORTHBOUND STRUCTURE NEAR SO. ABUTMENT
FACING SOUTH
STAGE-II

- STAGE II
- 1.) PLACE ALL TRAFFIC CONTROL AND REROUTE TRAFFIC TO OUTSIDE LANES
 - 2.) REMOVE EXISTING BRIDGE DECK BITUMINOUS OVERLAY 1 1/2"
 - 3.) SCARIFY BRIDGE DECK SLAB 1/2"
 - 4.) REMOVE EXISTING HANDRAIL AND REPLACE WITH A CONCRETE PARAPET RETROFIT
 - 5.) CONSTRUCT PARTIAL AND FULL DEPTH DECK SLAB REPAIRS
 - 6.) REMOVE EXISTING TRANSVERSE JOINTS
 - 7.) INSTALL PROPOSED PREFORMED JOINT SEAL OR NEOPRENE JOINTS
 - 8.) PLACE PROPOSED MICROSILICIA CONCRETE BRIDGE DECK OVERLAY 2 1/2"

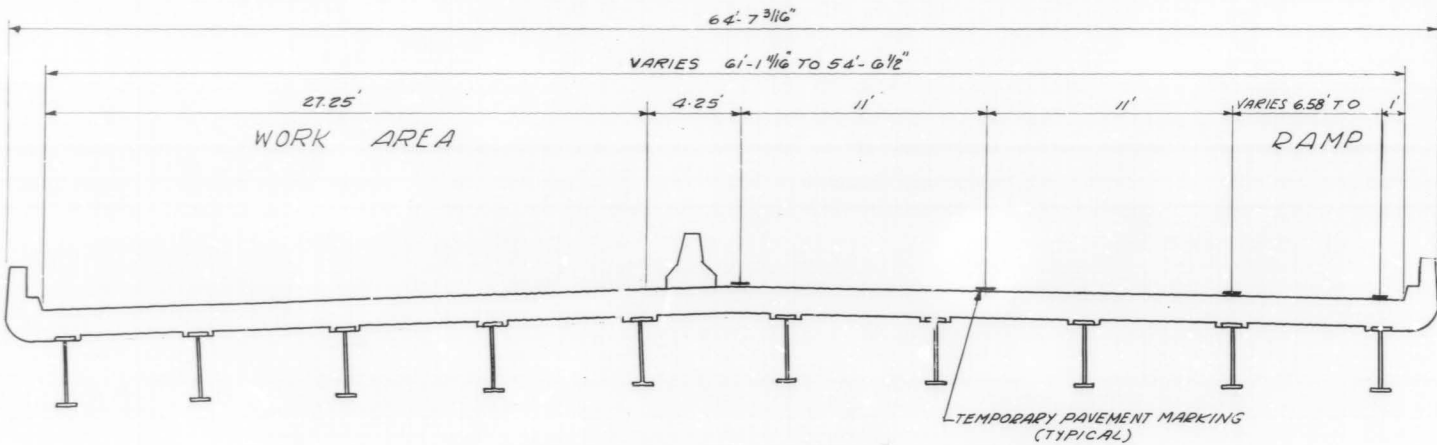

NORTHBOUND STRUCTURE NEAR NO. ABUTMENT
FACING NORTH
STAGE-III

- STAGE III
- 1.) RELOCATE ALL TRAFFIC CONTROL AND REROUTE TRAFFIC TO INSIDE LANES
 - 2.) REMOVE EXISTING BRIDGE DECK BITUMINOUS OVERLAY 1 1/2"
 - 3.) SCARIFY BRIDGE DECK SLAB 1/2"
 - 4.) REMOVE EXISTING HANDRAIL AND REPLACE WITH A CONCRETE PARAPET RETROFIT.
 - 5.) CONSTRUCT PARTIAL AND FULL DEPTH DECK SLAB REPAIRS
 - 6.) REMOVE EXISTING TRANSVERSE JOINTS
 - 7.) INSTALL PROPOSED PREFORMED JOINT SEAL OR NEOPRENE JOINTS
 - 8.) PLACE PROPOSED MICROSILICIA CONCRETE BRIDGE DECK OVERLAY 2 1/2"

REVISIONS	
NAME	DATE

DEPARTMENT OF TRANSPORTATION
ILLINOIS ROUTE-33
(NORTHBOUND)
TYPICAL STAGING CROSS SECTION
STRUCTURE OVER NORTHWEST HIGHWAY
STRUCTURE NO. 016-0374
SCALE: NO SCALE
DRAWN BY: RGM
DATE NOV, 1990
CHECKED BY: RY

