

LEGEND

- BARRICADE TYPE III WITH 2 2-WAY FLASHING LIGHTS (ONE SYMBOL SHALL REPRESENT ANY NUMBER OF BARRICADES REQUIRED TO ADEQUATELY PROTECT THE AREA SHOWN).
- BARRICADE TYPE I OR DRUMS, WITH STEADY-BURN LIGHT (50' C-C SPACING TYP. AND 25' C-C ON TAPERS AND CURVES).
- TEMPORARY TRAFFIC ADVISORY SIGN.
- SIGN LEGEND NUMBER (SEE ADJACENT LEGEND FOR SIGNS AND CORRESPONDING NUMBERS).
- DIRECTION OF TRAFFIC (NO PAVEMENT MARK)
- REMOVE EXISTING PAVEMENT MARKINGS
- WORK ZONE
- VIDEO VEHICLE DETECTION ZONE
- TEMPORARY TRAFFIC SIGNAL
- TEMPORARY CONCRETE BARRIER WALL

SEQUENCE OF OPERATIONS - STAGE 2



PLACE ALL EROSION CONTROL MEASURES PRIOR TO THE START OF STAGE 2. TEMPORARY SIGNALS WILL BE USED TO ALLOW FOR ONE LANE OF TRAFFIC ON THE ONE LANE OF OPEN ROADWAY DURING STAGE 2. TEMPORARY LANE STRIPING SHALL BE 11'-10". WEIDNER ROAD WILL BE CLOSED AT 7+50.00. NO TURNS WILL BE ALLOWED ONTO WEIDNER ROAD FROM LAWRENCE ROAD. (EXCEPT ADJACENT TO THE BRIDGE) PLACE RIP RAP AND TEMPORARY LANDSCAPING FOR STAGE 2.

REMOVE STAGE 2 OF THE EXISTING BRIDGE AS SHOWN IN THE STRUCTURAL PLANS AND ASSOCIATED PAVEMENT ON LAWRENCE RD. CONSTRUCT STAGE 2 OF THE BRIDGE AS SHOWN IN THE STRUCTURAL PLANS. PLACE THE ROADWAY BINDER AND TWO OF THREE SHOULDER LIFTS. PLACE ANY ADDITIONAL TEMPORARY LANDSCAPING ADJACENT TO THE BRIDGE.

STAGE 3


REMOVE TEMPORARY SIGNALS AND TEMPORARY BARRIER WALL. PLACE FINAL LIFT ON SHOULDERS AND PLACE SURFACE COURSE ON ROADWAY USING STANDARD 701201. INSTALL GUARDRAIL, PAVEMENT STRIPING, AND PERMANENT LANDSCAPING.

NOTE: TEMPORARY BARRIER WALL IS NOT REQUIRED BECAUSE OF SHORT DURATION OF STAGE THREE. TRAFFIC CONTROL WILL BE REQUIRE AND SHOULD FOLLOW STANDARD 701201.

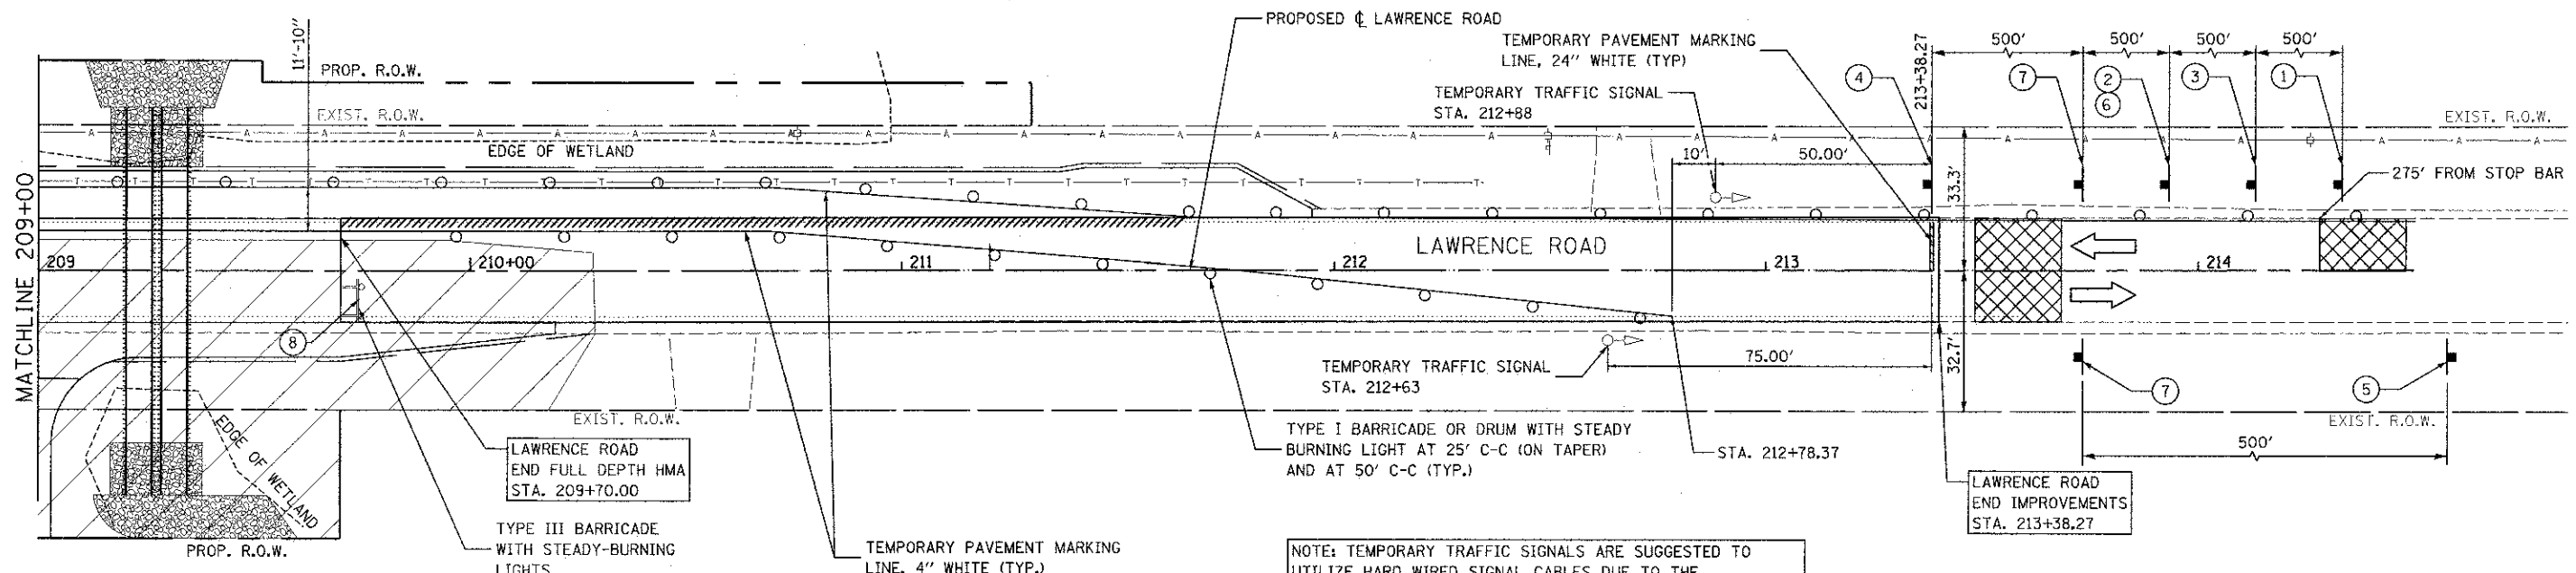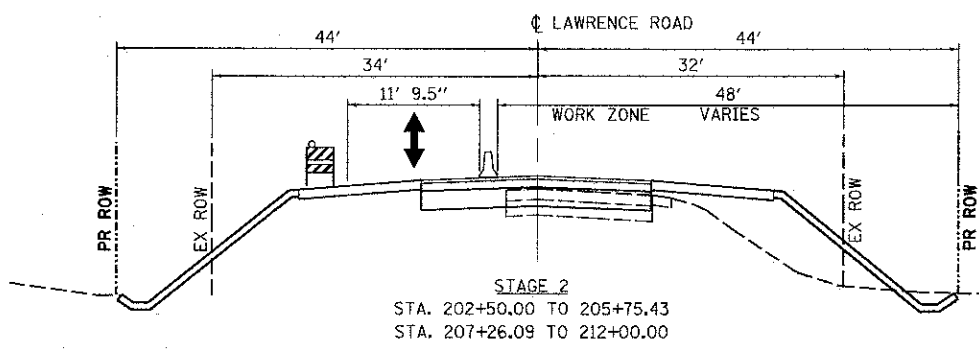

NOTE: TEMPORARY TRAFFIC SIGNALS ARE SUGGESTED TO UTILIZE HARD WIRED SIGNAL CABLES DUE TO THE REMOTE LOCATION OF THIS PROJECT. FOLLOW STANDARD 701321.

COMMUNICATION AND ELECTRICAL SERVICE COSTS ASSOCIATED WITH THE TEMPORARY SIGNALS SHALL BE INCLUDED IN THE COST OF TEMPORARY TRAFFIC SIGNALS

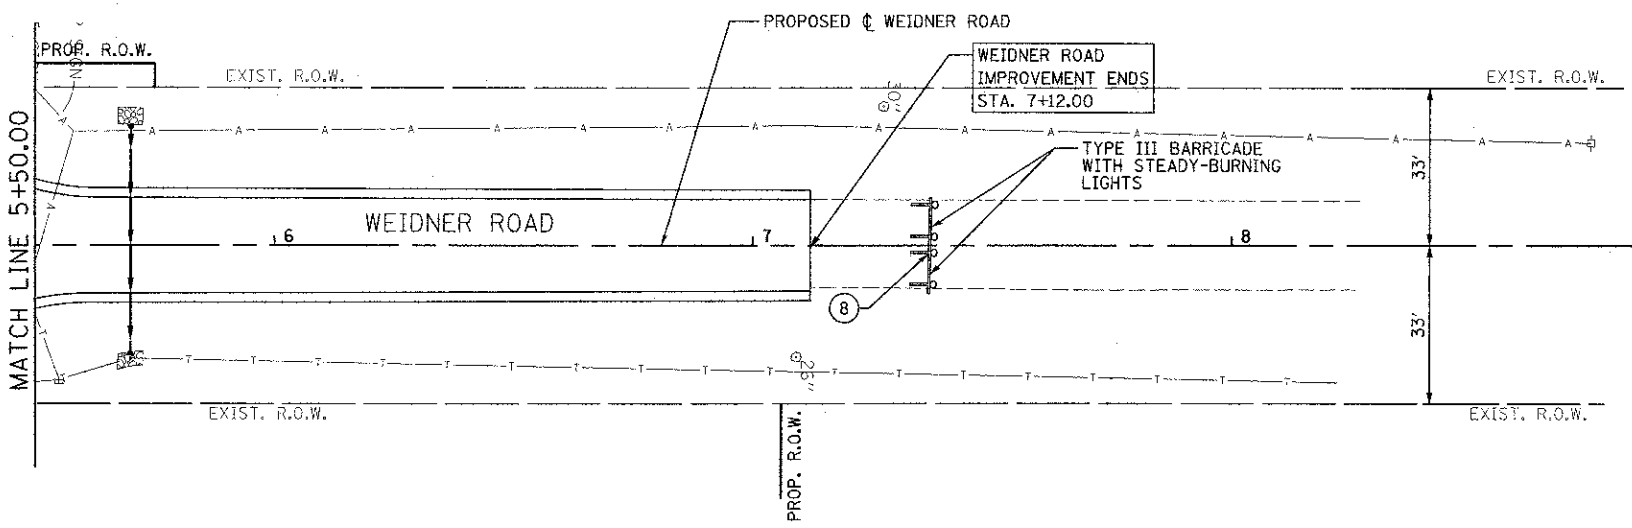

FILE NAME = W:\754-812 Lawrence Phase 1\CGADD 31EETS\755-022-alt-HOT2weidner.dgn

Bollinger, Lach & Associates, Inc.
ITASCA, ILLINOIS

USER NAME = gellwanger	DESIGNED - GJE	REVISED -
PLT SCALE = 20,000 1" = 200'	DRAWN - GJE	REVISED -
PLT DATE = 12/3/2012	CHECKED - CF	REVISED -
	DATE - 08/17/12	REVISED -

**MCHENRY COUNTY
DIVISION OF TRANSPORTATION**

**LAWRENCE ROAD BRIDGE OVER PISCASAW CREEK
LAWRENCE AND WEIDNER ROAD MAINTENANCE OF TRAFFIC - STAGE 2**

SCALE: 1"=20' SHEET NO. 15 OF 87 SHEETS STA. TO STA.

F.A.S. RTE. 0028	SECTION 08-00355-01-BR	COUNTY MCHENRY	TOTAL SHEETS 87	SHEET NO. 15
CONTRACT NO. 63694				
ILLINOIS FED. AID PROJECT				