11/18/2022 LETTING ITEM 086

INDEX OF SHEETS SEE SHEET NO. 2

HIGHWAY STANDARDS

SEE SHEET NO. 2

STATE OF ILLINOIS **DEPARTMENT OF TRANSPORTATION** 

# PLANS FOR PROPOSED

**FAU ROUTE 1601 (144TH STREET) INDIANA AVENUE TO CHICAGO ROAD ROADWAY RESURFACING SECTION NO.: 21-00119-00-RS** 

PROJECT NO.: ATSK (659)

**VILLAGE of DOLTON** 

JOB NO.: C-91-378-22

**COOK COUNTY** 


FEDERAL AID HIGHWAY

**BEGIN STA 10+50.26** 

FULL SIZE PLANS HAVE BEEN PREPARED USING STANDARD ENGINEERING SCALES, REDUCED SIZED PLANS WILL NOT CONFORM TO STANDARD SCALES, IN MAKING MEASUREMENTS

JOINT UTILITY LOCATION INFORMATION FOR EXCAVATION 1 - 800 - 892 - 0123 or 611

CONTRACT NO. 61H89

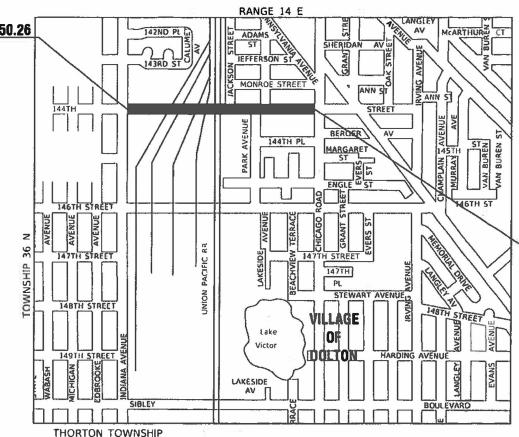

LOCATION MAP GROSS AND HET LENGTH=2,559 FEET=0.48 MILES




END STA 36+08.90



CONTRACT 61H89



**FUNCTIONAL CLASSIFICATION 144TH STREET MAJOR COLLECTOR** 2022 ADT = 4,000

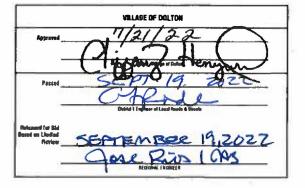

PRINTED BY THE AUTHORITY OF THE STATE OF ILLINOIS

21R0918-COVR-01 + 21R0918-COVR-01 - COV

### INDEX OF SHEETS

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- TYPICAL CROSS SECTIONS
- ALIGNMENT AND TIES
- 9-10 PROPOSED RESURFACING PLAN
- 11-12 LANDSCAPE AND EROSION CONTROL
- SIGNAGE REMOVAL PLAN 13
- PAVEMENT MARKING AND PROPOSED SIGNAGE PLAN 14-15
- IDOT DISTRICT 1 STANDARD DETAILS 16-22

# **HIGHWAY STANDARDS**

- 000001-08 STANDARD SYMBOLS, ABBREVIATIONS AND PATTERNS 424001-11 PERPENDICULAR CURB RAMPS
- 424011-04 CORNER PARALLEL CURB RAMPS FOR SIDEWALKS
- 424021-06 DEPRESSED CORNER FOR SIDEWALKS
- 442201-03 CLASS C AND D PATCHES
- 604001-05 FRAMES AND LIDS TYPE 1
- 606001-08 CONCRETE CURB TYPE B AND COMBINATION CONCRETE CURB AND GUTTER
- 701301-04 LANE CLOSURE, 2L, 2W, SHORT TIME OPERATIONS
- 701311-03 LANE CLOSURE, 2L, 2W, MOVING OPERATIONS-DAY ONLY
- 701427-05 LANE CLOSURE, MULTILANE, INTERMITTENT OR MOVING OPERATION FOR SPEEDS  $\leq$  40MPH 701501-06 URBAN LANE CLOSURE, 2L, 2W, UNDIVIDED 701502-09 URBAN LANE CLOSURE, 2L, 2W, WITH BIDIRECTIONAL LEFT TURN LANE

- 701606-10 URBAN SINGLE LANE CLOSURE, MULTILANE, 2W WITH MOUNTABLE MEDIAN
- 701701-10 URBAN LANE CLOSURE, MULTILANE INTERSECTION 701801-06 SIDEWALK, CORNER OR CROSSWALK CLOSURE
- 701901-08 TRAFFIC CONTROL DEVICES 780001-05 TYPICAL PAVEMENT MARKINGS

# **DISTRICT ONE DETAILS**

- BD-08 DETAILS FOR FRAMES AND LIDS ADJUSTMENT WITH MILLING
- BD-22 PAVEMENT PATCHING FOR HMA SURFACED PAVEMENT
- BD-32 BUTT JOINT AND HMA TAPER DETAILS
- TC-10 TRAFFIC CONTROL AND PROTECTION FOR SIDE ROADS, INTERSECTIONS, AND DRIVEWAYS
- TC-13 DISTRICT ONE TYPICAL PAVEMENT MARKINGS SHORT TERM PAVEMENT MARKING LETTERS AND SYMBOLS
- TC-22 ARTERIAL ROAD INFORMATION SIGN

#### FILE NAME = 21R0918-NOTES-01 - P01 USER NAME = DESIGNED - KJD REVISED CHECKED — WPD REVISED PLOT SCALE = DRAWN REVISED PLOT DATE = 04-15-2022 CHECKED - AG REVISED

#### STATE OF ILLINOIS DEPARTMENT OF TRANSPORTATION

#### ROADWAY RESURFACING FAU ROUTE 1691 (144TH STREET) INDEX OF SHEETS, STANDARDS & GENERAL NOTES SCALE: NONE SHEET NO. 2 OF 22 SHEETS STA.

#### SECTION COLINTY 1601 21-00119-00-RS COOK 22 CONTRACT NO. 61H89

# **GENERAL NOTES**

- ALL CONSTRUCTION SHALL CONFORM TO THE LATEST EDITION OF THE ILLINOIS DEPARTMENT OF TRANSPORTATION "STANDARD SPECIFICATIONS FOR ROAD AND BRIDGE CONSTRUCTION" ADOPTED JANUARY 1, 2022 AND THE SUPPLEMENTAL SPECIFICATION AND RECURRING SPECIAL PROVISIONS ADOPTED JANUARY 1, 2022.
- 2. ITEMS OF WORK LISTED IN THE SUMMARY OF QUANTITIES NOT SPECIFICALLY CALLED OUT ON HE PLANS SHALL BE PERFORMED AS DIRECTED BY THE ENGINEER
- 3. THE ROBINSON ENGINEERING, LTD, FIELD OFFICE (708-331-6700), AND THE PUBLIC WORKS DIRECTOR, AT THE VILLAGE OF DOLTON, SHALL BE NOTIFIED TWO (2) WORKING DAYS BEFORE
- BEFORE STARTING ANY EXCAVATION THE CONTRACTOR SHALL CALL "J.U.L.I.E." AT (800) 892-0123 OR 811 AND (312) 744-7000 FOR FIELD LOCATIONS OF BURIED ELECTRIC, TELEPHONE AND GAS UTILITIES. (48 HOUR NOTIFICATION REQUIRED)
- UTILITIES INDICATED ON THE PLANS ARE PROVIDED FOR THE CONTRACTOR'S USE AND ARE BASED UPON INFORMATION AVAILABLE AT THE TIME OF THE ADVERTISEMENT FOR BIDS. THE OWNER AND ENGINEER DO NOT GUARANTEE THE ACCURACY OF UTILITY INFORMATION.
- 6. IT SHALL BE THE CONTRACTOR'S RESPONSIBILITY TO VERIFY ALL DIMENSIONS AND CONDITIONS EXISTING IN THE FIELD PRIOR TO CONSTRUCTION AND ORDERING OF MATERIALS
- THE THICKNESS OF HMA MIXTURE STATED IN THE SPECIFICATIONS IS THE NOMINAL THICKNESS. DEVIATIONS FROM THE NOMINAL THICKNESS WILL BE PERMITTED WHEN SUCH DEVIATIONS OCCUR DUE TO IRREGULARITIES IN THE EXISTING SURFACE OR BASE ON WHICH THE HMA
- ANY LOOSE MATERIAL DEPOSITED IN THE FLOW LINE OF DITCHES GUTTERS OR OTHER DRAINAGE STRUCTURES SHALL BE REMOVED BY THE END OF EACH DAY BY THE CONTRACTOR.
- CLASS D PATCHING QUANTITIES FOR THIS CONTRACT SHALL BE PERFORMED AT THE DIRECTION OF THE ENGINEER AFTER PAVEMENT MILLING.
- 10. CONTRACTOR SHALL TAKE PRECAUTION BY PRESERVING EXISTING TREES WITHIN THE RIGHT OF WAY. IF ANY DAMAGE OCCURS, TREES SHALL BE REPLACED IN KIND PER ARTICLE 201.07 REPAIR OR REPLACEMENT OF EXISTING PLANT MATERIAL REQUIREMENTS STATED HEREIN
- 11. NO PAVEMENT PATCHING SHALL BE PERMITTED AFTER FRIDAY AT 3:00 PM OF EACH AND EVERY WEEK AND NO HOLES WILL BE ALLOWED TO REMAIN OPEN OVERNIGHT OR OVER THE
- 12. ALL EQUIPMENT SHALL BE REMOVED OFF THE VILLAGE STREETS DURING ALL HOLIDAY WEEKENDS AS COORDINATED WITH THE VILLAGE.
- 13. HMA PAVING SHALL BE PERFORMED WITH HOT JOINTS. JOINTS SHALL NOT BE LEFT OPEN
- 14. IT IS THE CONTRACTOR'S SOLE RESPONSIBILITY TO COORDINATE WITH THE UNION PACIFIC RAILROAD WHENEVER CONSTRUCTION ACTIVITY IS WITHIN 25 FEET OF THE RAILROAD ROW. THE CONTRACTOR SHALL RETAIN FLAGMEN EMPLOYED AND DESIGNATED BY THE UNION PACIFIC RAILROAD TO MONITOR ON-COMING TRAIN TRAFFIC, AND ADVISE CONTRACTOR PERSONNEL WHEN ACTIVITY ON OR NEAR THE RAILROAD RIGHT-OF-WAY MAY PROCEED. THIS ITEM WILL BE PAID FOR ACCORDING TO ARTICLE 107.12 AND WILL BE REIMBURSED ACCORDING TO ARTICLE 109.05.
- 15. THE CONTRACTOR SHALL CONTACT KALPANA KANNAN-HOSADURGA, THE DISTRICT ONE TRAFFIC CONTROL SUPERVISOR, AT KALPANA.KANNAN-HOSADURGA@ILLINOIS.GOV A MINIMUM OF 72 HOURS IN ADVANCE OF BEGINNING WORK.
- 16. THE CONTRACTOR SHALL TAKE PRECAUTION BY PRESERVING EXISTING TREES WITHIN THE RIGHT OF WAY. IF ANY DAMAGE OCCURS, TREES SHALL BE REPLACED IN KIND PER ARTICLE 201.07 REPAIR OR REPLACEMENT OF EXISTING PLANT MATERIAL REQUIREMENTS STATED

					FED 100%	FED 100%
		VILLAGE 0%	VILLAGE 0%			
			7	ROADWAY	SAFETY	
S.P. S.I.	CODE NO.	ITEM	UNIT	TOTAL QUANTITY	CONSTRUCTION	
				<u> </u>	0005	0021
	21101615	TOPSOIL FURNISH AND PLACE, 4"	SQ YD	425	425	
	25200110	SODDING, SALT TOLERANT	SQ YD	425	425	
	25200200	SUPPLEMENTAL WATERING	UNIT	13	13	
	28000250	TEMPORARY EROSION CONTROL SEEDING	POUND	10	10	
	28000510	INLET FILTERS	EACH	14	14	
	35101600	AGGREGATE BASE COURSE, TYPE B 4"	SQ YD	566		566
	35800100	PREPARATION OF BASE	SQ YD	121	121	
	35800200	AGGREGATE BASE REPAIR	TON	46	46	
Δ	40201000	AGGREGATE FOR TEMPORARY ACCESS	TON	5	5	
	40600290	BITUMINOUS MATERIALS (TACK COAT)	POUND	2508	2508	
	40600370	LONGITUDINAL JOINT SEALANT	FOOT	5129	5129	
	40600400	MIXTURE FOR CRACKS, JOINTS, AND FLANGEWAYS	TON	5	5	
	40600982	HOT-MIX ASPHALT SURFACE REMOVAL - BUTT JOINT	SQ YD	55	55	
	40603200	POLYMERIZED HOT-MIX ASPHALT BINDER COURSE, IL-4.75, N50	TON	483	483	
	40604060	HOT-MIX ASPHALT SURFACE COURSE, IL-9.5, MIX "D", N50	TON	965	965	
Δ *	42300300	PORTLAND CEMENT CONCRETE DRIVEWAY PAVEMENT, 7 INCH	SQ YD	86	86	

\* - INDICATES SPECIALITY ITEM  $\Delta$  - INDICATES SPECIAL PROVISION

STATE OF ILLINOIS
DEPARTMENT OF TRANSPORTATION

INDIANA AVENUE TO CHICAGO ROAD
ROADWAY RESURFACING FAU ROUTE 1691 (144TH STREET)
SUMMARY OF QUANTITIES

SCALE. NONE SHEET NO. 3 OF 22 SHEETS STA. TO STA.

						FED 100%	FED 100%
			SUMMARY OF QUANTITIES				VILLAGE 0%
						ROADWAY	SAFETY
S P	S.I.	CODE NO.	ITEM	UNIT	TOTAL	CONSTRUCTION	.,
					QUANTITY	0005	0021
Δ		42400200	PORTLAND CEMENT CONCRETE SIDEWALK 5 INCH	SQ FT	3641		3641
Δ		42400400	PORTLAND CEMENT CONCRETE SIDEWALK 7 INCH	SQ FT	1442		1442
		42400800	DETECTABLE WARNINGS	SQ FT	140		140
		44000157	HOT-MIX ASPHALT SURFACE REMOVAL, 2"	SQ YD	11145	11145	
		44000200	DRIVEWAY PAVEMENT REMOVAL	SQ YD	273	273	
		44000500	COMBINATION CURB AND GUTTER REMOVAL	FOOT	840	840	
				SQ FT	5216		5216
Δ		44000600	SIDEWALK REMOVAL	3Q F1	5216		3210
Δ		44201761	CLASS D PATCHES, TYPE I, 10 INCH	SQ YD	4	4	
Δ		44201765	CLASS D PATCHES, TYPE II, 10 INCH	SQ YD	29	29	
Δ		44201769	CLASS D PATCHES, TYPE III, 10 INCH	SQ YD	58	58	
Δ		44201771	CLASS D PATCHES, TYPE IV, 10 [NCH	SQ YD	30	30	
		40101400	AGGREGATE SHOULDERS, TYPE B 4"	SQ YD	51		51
		48101498	Addredate shoulders, tire b 4	34.10			
		60601805	CONCRETE CURB TRANSITION	FOOT	30	30	
		60603800	COMBINATION CONCRETE CURB AND GUTTER, TYPE B-6.12	FOOT	11	11	
		60608562	COMBINATION CONCRETE CURB AND GUTTER, TYPE M-4.12	FOOT	802	802	
L		40.MM. 13-14-1			DICATES SPECIALIT		

- INDICATES SPECIALITY ITEM
 Δ - INDICATES SPECIAL PROVISION

FILE NAME = 21R0018-NOTES-01 - QTY02	USER NAME ==	DESIGNED — KJD	REVISED		INDIANA AVENUE TO CHICAGO ROAD	F.A.U. SECTION	COUNTY TOTAL SHEET SHEETS NO.
		CHECKED - WPD	REVISED —	STATE OF ILLINOIS	ROADWAY RESURFACING FAU ROUTE 1691 (144TH STREET)	1601 21-00119-00-RS	COOK 22 4
	PLOT SCALE =	DRAWN — MD	REVISED —	DEPARTMENT OF TRANSPORTATION	SUMMARY OF QUANTITIES		CONTRACT NO. 61H89
1	PLOT DATE = 04-15-2022	CHECKED — AG	REVISED —		SCALE NONE SHEET NO. 4 OF 22 SHEETS STA. TO STA.	FED. ROAD DIST. NO. 1 ILUNOIS FED.	AID PROJECT ATSK(059)

		, , , , , , , , , , , , , , , , , , ,	SUMMARY OF QUANTITIES			FED 100% VILLAGE 0%	FED 100% VILLAGE 0%
						ROADWAY	SAFETY
		CODE 110		LINIX	TOTAL	CONSTRUCTION	TYPE CODE
S.P.	S.I.	CODE NO.	ITEM	UNIT	QUANTITY	0005	0021
		67100100	MOBILIZATION	LSUM	1	1	
		70102620	TRAFFIC CONTROL AND PROTECTION, STANDARD 701501	LSUM	1	1	
		70102622	TRAFFIC CONTROL AND PROTECTION, STANDARD 701502	LSUM	1	1	
		70102625	TRAFFIC CONTROL AND PROTECTION, STANDARD 701606	LSUM	1	1	
		70102640	TRAFFIC CONTROL AND PROTECTION, STANDARD 701801	LSUM	1	1	
		70300100	SHORT TERM PAVEMENT MARKING	FOOT	1,886		1,886
·····		70300150	CHORT TERM DAVEMENT MARKING REMOVAL	SQ FT	686		
		70300150	SHORT TERM PAVEMENT MARKING REMOVAL	30,11	000		686
	*	72000100	SIGN PANEL - TYPE 1	SQ FT	95		95
		72400200	REMOVE SIGN PANEL ASSEMBLY - TYPE B	EACH	13		13
					20		20
		72400310	REMOVE SIGN PANEL - TYPE 1	SQ FT	28		28
	*	72900200	METAL POST - TYPE B	FOOT	137		137
	*	78000100	THERMOPLASTIC PAVEMENT MARKING - LETTERS AND SYMBOLS	SQ FT	224		224
							7544
	*	78000200	THERMOPLASTIC PAVEMENT MARKING - LINE 4"	FOOT	7544		7544
	*	78000400	THERMOPLASTIC PAVEMENT MARKING - LINE 6"	FOOT	442		442
	*	78000600	THERMOPLASTIC PAVEMENT MARKING - LINE 12"	FOOT	170		170
	*	78000650	THERMOPLASTIC PAVEMENT MARKING - LINE 24"	FOOT	168		168

# - INDICATES SPECIALITY ITEM Δ - INDICATES SPECIAL PROVISION

FILE NAME = 21R0918-NOTES-01 - QTY03	USER NAME	DESIGNED - KJD	REVISED —
		CHECKED — WPD	REVISED —
	PLOTSCALE =	DRAWN MD	REVISED —
	PLOT DATE = 04-15-2022	CHECKED - AG	REVISED —

STATE OF ILLINOIS DEPARTMENT OF TRANSPORTATION

ROADV	VAY RESURF	A AVENUE TO CH FACING FAU ROU JMMARY OF QUA	JTE 169	1 (144TH STREET)							
SCALE: NONE SHEET NO. 5 OF 22 SHEETS STA. TO STA.											


F.A.U. RTE,			SEC	пом		COUNTY	TOTAL SHEETS	SHEET NO.
1601		21-	0011	9-00-RS		COOK	22	5
						CONTRACT	NO. 61H	89
CED RO	AD DIST	NO.	4	ILLINOIS I	EED A	DEPOSECT ATSK	660)	

			FED 100% VILLAGE 0%	FED 100% VILLAGE 0%			
-					TOTAL	ROADWAY CONSTRUCTION	SAFETY
5.P	. S.I.	CODE NO.	ITEM	UNIT	QUANTITY	0005	0021
		·					
	*	88600600	DETECTOR LOOP REPLACEMENT	FOOT	366		366
Δ		X4421672	CLASS D PATCHES, TYPE II, 11 INCH (SPECIAL)	SQ YD	5	5	
Δ		Z0004522	HOT-MIX ASPHALT DRIVEWAY PAVEMENT, 6"	SQ YD	67	67	
Δ		Z0017400	DRAINAGE & UTILITY STRUCTURES TO BE ADJUSTED	EACH	40	40	
Δ		Z0017700	DRAINAGE & UTILITY STRUCTURES TO BE RECONSTRUCTED	EACH	1	1	
		Z0030850	TEMPORARY INFORMATION SIGNING	SQ FT	52		52
		Z0048665	RAILROAD PROTECTIVE LIABILITY INSURANCE	LSUM	1	1	
		Z0076600	TRAINEES	HOUR	500	500	
		Z0076604	TRAINEES TRAINING PROGRAM GRADUATE	HOUR	500	500	


\* - INDICATES SPECIALITY ITEM
Δ - INDICATES SPECIAL PROVISION

# - 0042


FILE NAME = 21R0918-NOTES-01 - QTY04 USER NAME -DESIGNED — KJD INDIANA AVENUE TO CHICAGO ROAD ROADWAY RESURFACING FAU ROUTE 1691 (144TH STREET) REVISED — STATE OF ILLINOIS DEPARTMENT OF TRANSPORTATION CHECKED --- WPD REVISED — PLOT SCALE = DRAWN -- MD REVISED ---SUMMARY OF QUANTITIES PLOT DATE = 04-15-2022 CHECKED - AG REVISED — SCALE: NONE SHEET NO. 6 OF 22 SHEETS STA.

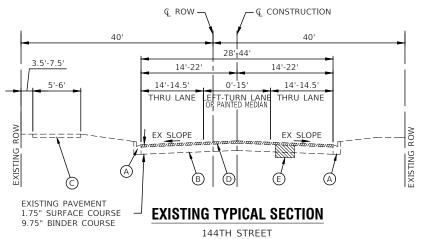


STA 10+50.26 TO STA 21+22.51

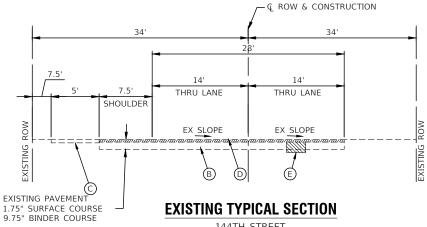

144TH STREET STA 21+22.51 TO STA 23+62.92 UNION PACIFIC RAILROAD

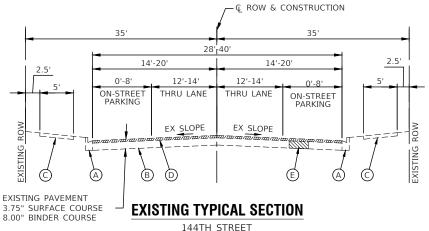

STA 23+62.92 TO STA 36+08.90

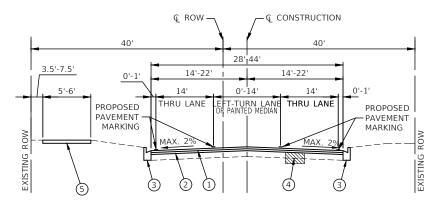


# PROPOSED TYPICAL SECTION

144TH STREET STA 10+50.26 TO STA 21+22.51

# **Q** ROW & CONSTRUCTION THRU LANE THRU LANE SHOULDER MAX. 2% MAX.\_2%

# PROPOSED TYPICAL SECTION

144TH STREET STA 21+22.51 TO STA 23+62.92 UNION PACIFIC RAILROAD

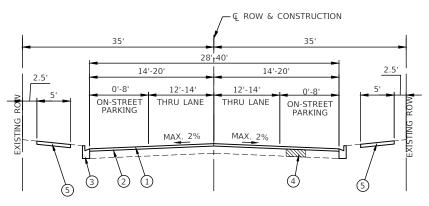

# PROPOSED TYPICAL SECTION

144TH STREET STA 23+62.92 TO STA 36+08.90

# **EXISTING LEGEND**

- EXISTING CURB AND GUTTER TO BE REMOVED AT LOCATIONS AS SHOWN ON PLANS OR DIRECTED BY THE ENGINEER.
- B EXISTING HOT-MIX ASPHALT PAVEMENT (11.5" TO 11.75" PER CORES)
- EXISTING PORTLAND CEMENT CONCRETE SIDEWALK TO BE REMOVED AT LOCATIONS AS SHOWN ON PLANS OR DIRECTED BY THE ENGINEER.
- D HOT-MIX ASPHALT SURFACE REMOVAL, 2"
- E PAVEMENT REMOVAL FOR CLASS D PATCHES, 10"

# PROPOSED LEGEND

FILE NAME = 21R0918-TYPX-01 - TYPX(22X34)

- HOT MIX ASPHALT SURFACE COURSE, MIX "D", N50, IL-9.5, 1-1/2"
- 2 POLYMERIZED HOT-MIX ASPHALT BINDER COURSE, IL-4.75, N50, 3/4"
- COMBINATION CONCRETE CURB AND GUTTER, AT LOCATIONS AS SHOWN ON PLANS OR DIRECTED BY THE ENGINEER
- CLASS D PATCHES, 6 INCH PREPARATION OF BASE, AGGREGATE BASE REPAIR, AT LOCATIONS SHOWN ON THE PLANS OR AS DIRECTED BY THE ENGINEER
- PORTLAND CEMENT CONCRETE SIDEWALK, 5" OR 7" AT LOCATIONS AS


# **HOT-MIX ASPHALT MIXTURE REQUIREMENTS**


MIXTURE TYPE	AIR VOIDS @ NDES	QMP
RESURFACING		
HOT-MIX ASPHALT SURFACE COURSE, IL-9.5, MIX "D", N50 (1.5")	4% @ 50 Gyr.	LR 1030-2
POLYMERIZED HOT-MIX ASPHALT BINDER COURSE, IL-4.75, N50, (0.75")	3.5% @ 50 Gyr.	LR 1030-2
CLASS D PATCHES		
CLASS D PATCHES, TYPE SPECIFIED, 10' (HMA BINDER IL-19.0mm)	4% @ 70 Gyr.	LR 1030-2
CLASS D PATCHES, TYPE II, 11" (SPECIAL)		
HMA SURFACE COURSE IL-9.5, MIX "D", N50 (2")	4% @ 50 Gyr.	LR 1030-2
HMA BINDER COURSE IL-19.0, N70 (9")	4% @ 70 Gyr.	LR 1030-2
DRIVEWAYS		
HOT-MIX ASPHALT SURFACE COURSE, MIX "D", IL-9.5, N50 (2")	4% @ 50 Gyr.	LR 1030-2
HOT-MIX ASPHALT BINDER COURSE, IL-19.0mm, N50 (4")	4% @ 50 Gyr.	LR 1030-2
QMP DESIGNATION: QUALITY CONTROL/QUALITY ASSURANCE (QC/QA) PER LR1030-2	-	


- 1. THE UNIT WEIGHT USED TO CALCULATE ALL HOT-MIX ASPHALT SURFACE MIXTURE QUANTITIES IS 112 LBS/SY/IN.
- 2. THE "AC TYPE" FOR POLYMERIZED HMA MIXES SHALL BE "SBS/SBR PG 76-22" AND FOR NON-POLYMERIZED HMA THE "AC TYPE" SHALL BE "PG 64-22" UNLESS MODIFIED BY RECLAIMED MATERIALS SPECIFICATIONS.
- 3. THE LONGITUDINAL JOINT SEALANT SHALL BE PLACED OVER THE POLYMERIZED HOT-MIX ASPHALT BINDER COURSE, IL-4.75, N50


N	ON	PLANS	OR	DIRECTED	BY	THE	<b>ENGINEER</b>				

USER NAME =	DESIGNED — KJD	REVISED —		INDIANA AVENUE TO CHICAGO ROAD	F.A.U RTE	SECTION	COUNTY	TOTAL	SHEET			
	CHECKED — WPD	REVISED —	STATE OF ILLINOIS	ROAD	ROADWAY RESURFACING FAU ROUTE 1691 (144TH STREET) TYPICAL CROSS SECTIONS					соок	22	7
PLOT SCALE =	DRAWN — MED	REVISED —	DEPARTMENT OF TRANSPORTATION							CONTRACT	T NO. 61H	189
PLOT DATE = 04-15-2022	CHECKED — AG	REVISED —		SCALE: NONE	SHEET NO. 7 OF 22 SHEETS	STA.	TO STA.	FED. BOAD D	ST. NO. 1 ILLINOIS FED.	AID PROJECT ATS	K(659)	$\overline{}$

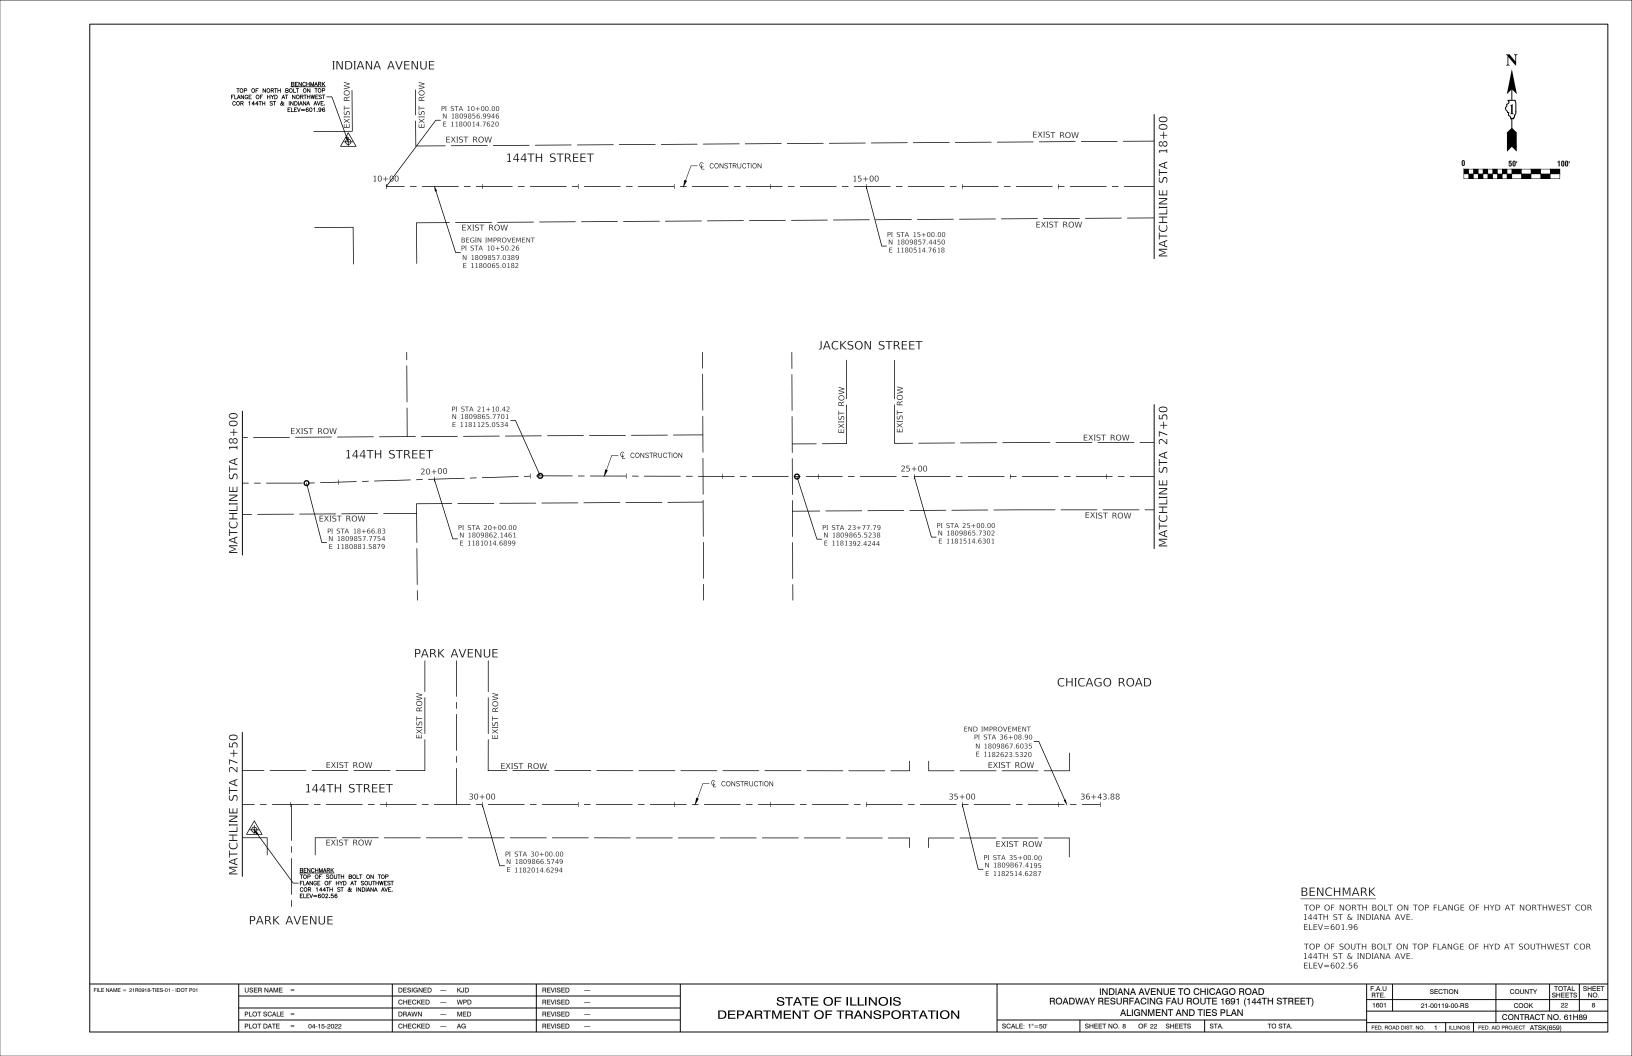

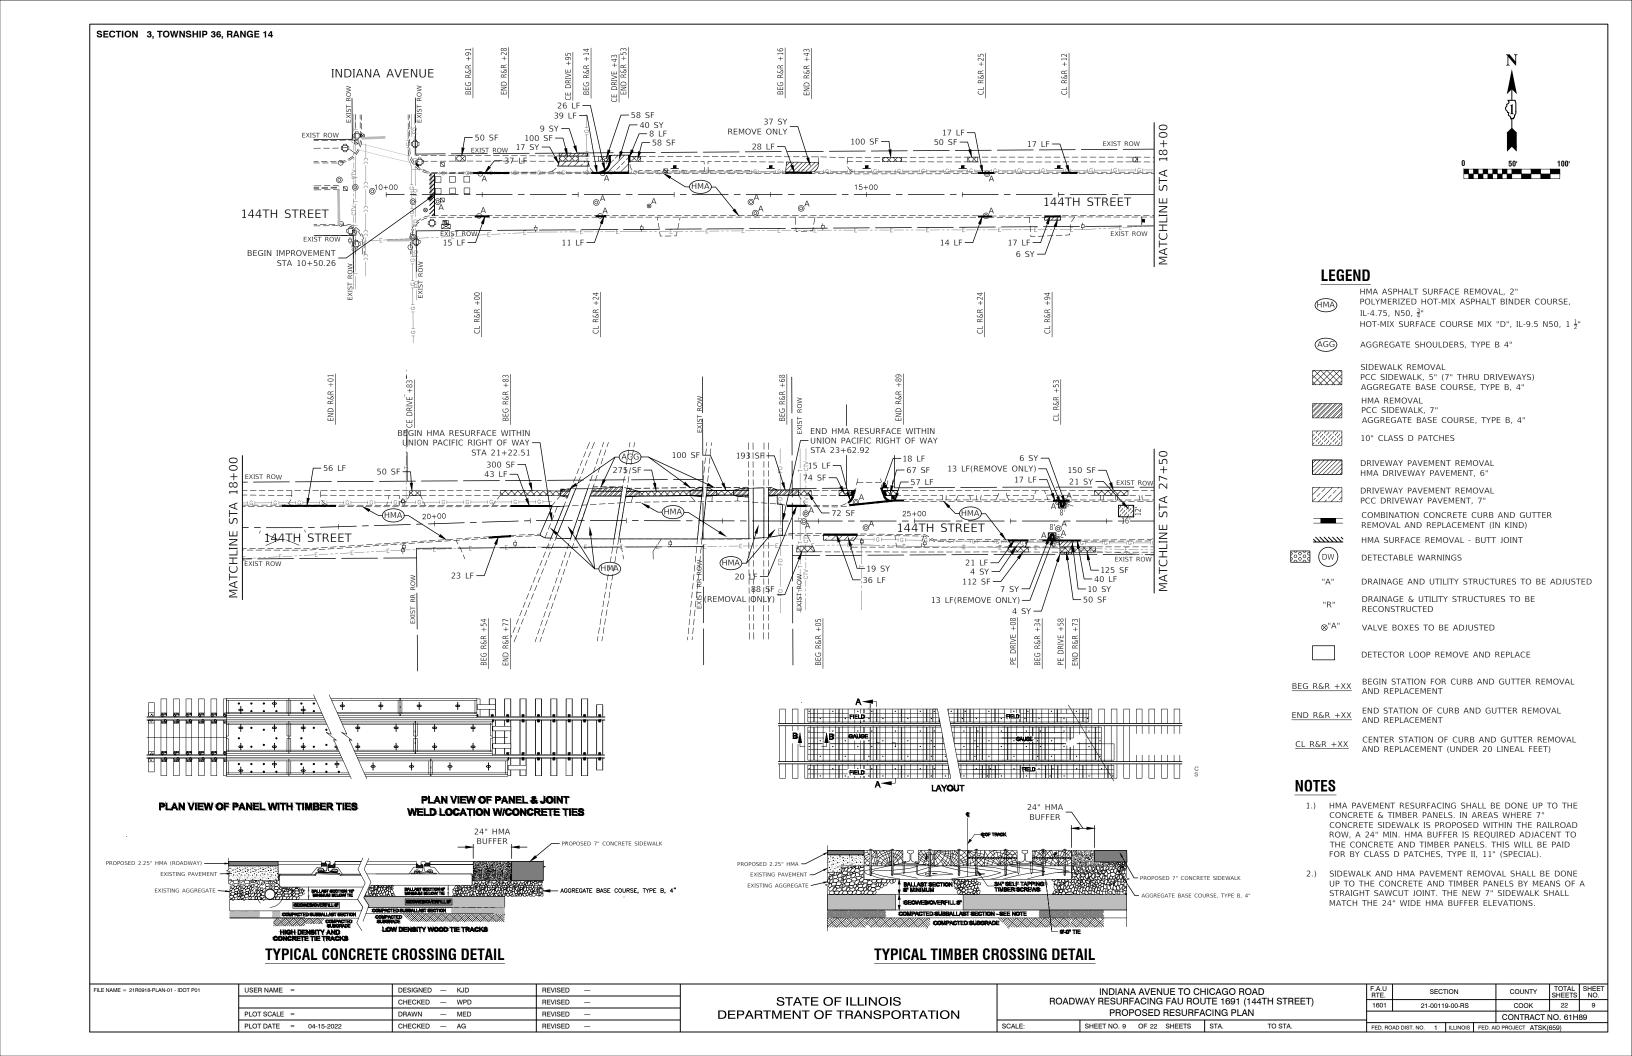

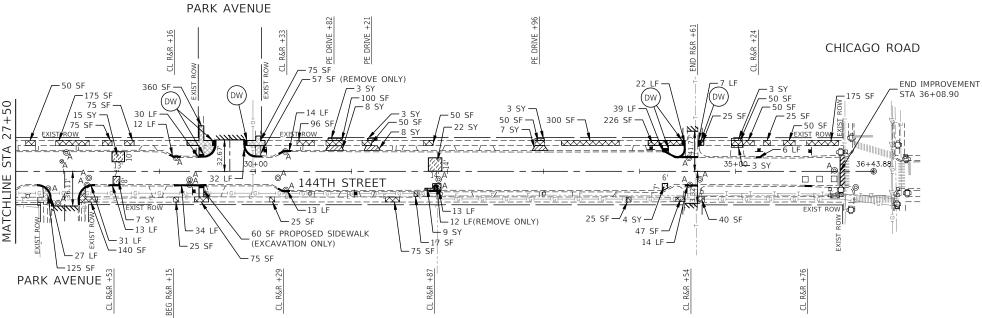

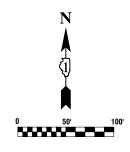

# **LEGEND**

HMA ASPHALT SURFACE REMOVAL, 2" POLYMERIZED HOT-MIX ASPHALT BINDER COURSE, IL-4.75, N50,  $\frac{3}{4}$ " HOT-MIX SURFACE COURSE MIX "D", IL-9.5 N50, 1  $\frac{1}{2}$ "

AGGREGATE SHOULDERS, TYPE B 4"

SIDEWALK REMOVAL PCC SIDEWALK, 5" (7" THRU DRIVEWAYS) AGGREGATE BASE COURSE, TYPE B, 4"

HMA REMOVAL PCC SIDEWALK, 7" AGGREGATE BASE COURSE, TYPE B, 4"

10" CLASS D PATCHES

DRIVEWAY PAVEMENT REMOVAL HMA DRIVEWAY PAVEMENT, 6"

DRIVEWAY PAVEMENT REMOVAL PCC DRIVEWAY PAVEMENT, 7"

> COMBINATION CONCRETE CURB AND GUTTER REMOVAL AND REPLACEMENT (IN KIND)

HMA SURFACE REMOVAL - BUTT JOINT

DW) DETECTABLE WARNINGS

DRAINAGE AND UTILITY STRUCTURES TO BE ADJUSTED

DRAINAGE & UTILITY STRUCTURES TO BE RECONSTRUCTED

VALVE BOXES TO BE ADJUSTED

DETECTOR LOOP REMOVE AND REPLACE

BEGIN STATION FOR CURB AND GUTTER REMOVAL BEG R&R +XX AND REPLACEMENT

END STATION OF CURB AND GUTTER REMOVAL

END R&R +XX AND REPLACEMENT


CENTER STATION OF CURB AND GUTTER REMOVAL AND REPLACEMENT (UNDER 20 LINEAL FEET)


# NOTES


- 1.) HMA PAVEMENT RESURFACING SHALL BE DONE UP TO THE CONCRETE & TIMBER PANELS. IN AREAS WHERE 7" CONCRETE SIDEWALK IS PROPOSED WITHIN THE RAILROAD ROW, A 24" MIN. HMA BUFFER IS REQUIRED ADJACENT TO THE CONCRETE AND TIMBER PANELS. THIS WILL BE PAID FOR BY CLASS D PATCHES, TYPE II, 11" (SPECIAL).
- 2.) SIDEWALK AND HMA PAVEMENT REMOVAL SHALL BE DONE UP TO THE CONCRETE AND TIMBER PANELS BY MEANS OF A STRAIGHT SAWCUT JOINT. THE NEW 7" SIDEWALK SHALL MATCH THE 24" WIDE HMA BUFFER ELEVATIONS.

FILE NAME = 21R0918-PLAN-01 - IDOT P01 (2) USER NAME = DESIGNED - KJD INDIANA AVENUE TO CHICAGO ROAD ROADWAY RESURFACING FAU ROUTE 1691 (144TH STREET) REVISED SECTION COUNTY STATE OF ILLINOIS CHECKED - WPD REVISED 1601 21-00119-00-RS соок 22 10 PROPOSED RESURFACING PLAN PLOT SCALE = DRAWN REVISED DEPARTMENT OF TRANSPORTATION CONTRACT NO. 61H89 SCALE: SHEET NO. 10 OF 22 SHEETS STA. PLOT DATE = 04-15-2022 CHECKED - AG REVISED



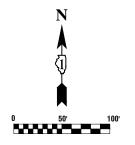

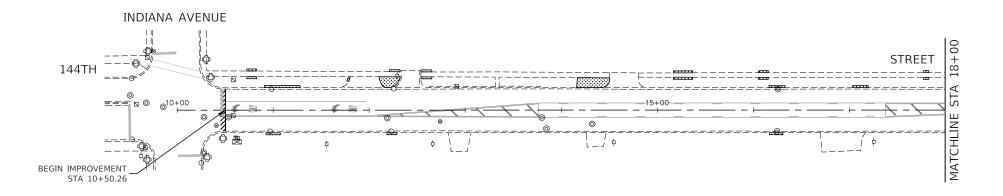


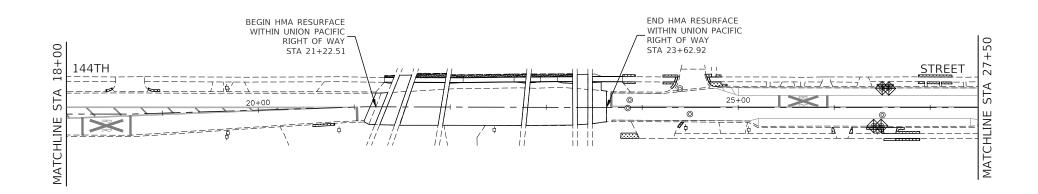

# NOTE

IF IN THE OPINION OF THE ENGINEER, MORE SURFACE AREA THAN NECESSARY HAS BEEN DAMAGED, IT SHALL BE REPLACED BY THE CONTRACTOR. THE MAXIMUM WIDTH OF RESTORATION WILL BE TWO FEET UNLESS OTHERWISE DIRECTED BY THE ENGINEER.


# LEGEND

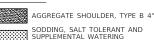


SODDING, SALT TOLERANT AND SUPPLEMENTAL WATERING TOPSOIL FURNISH & PLACE 4"



FILE NAME = 21R0918-LNSC-01 - LNSC-01	USER NAME =	DESIGNED — KJD	REVISED —		INDIANA AVENUE TO CHICAGO ROAD ROADWAY RESURFACING FAU ROUTE 1691 (144TH STREET)				F.A.U RTE.	SECTION	COUNTY	TOTAL	SHEET NO.
		CHECKED — WPD	REVISED —	STATE OF ILLINOIS	ROADWAY RESURFACING FAU ROUTE 1691 (144TH STREET) LANDSCAPE AND EROSION CONTROL PLAN			1601	21-00119-00-RS	соок	22	11	
	PLOT SCALE =	DRAWN — MED	REVISED —	DEPARTMENT OF TRANSPORTATION			LAN			CONTRACT	NO. 61H	189	
	PLOT DATE = 04-15-2022	CHECKED — AG	REVISED —		SCALE: 1"=50'	SHEET NO. 11 OF 22 SHEETS	STA.	TO STA.	FED. ROAD	D DIST. NO. 1 ILLINOIS FED. A	ND PROJECT ATSK	((659)	

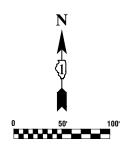


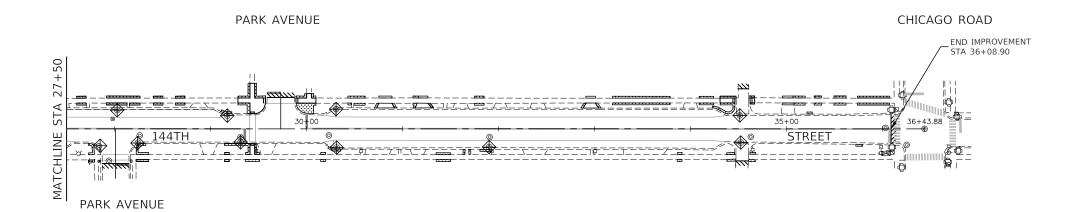

# NOTE

IF IN THE OPINION OF THE ENGINEER, MORE SURFACE AREA THAN NECESSARY HAS BEEN DAMAGED, IT SHALL BE REPLACED BY THE CONTRACTOR. THE MAXIMUM WIDTH OF RESTORATION WILL BE TWO FEET UNLESS OTHERWISE DIRECTED BY THE ENGINEER.


# LEGEND

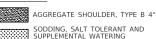



SODDING, SALT TOLERANT AND SUPPLEMENTAL WATERING TOPSOIL FURNISH & PLACE 4"



FILE NAME = 21R0918-LNSC-01 - LNSC-02	USER NAME =	DESIGNED — KJD	REVISED —			INDIANA AVENUE TO CH			F.A.U RTE.	SECTION	COUNTY	TOTAL SHEETS	SHEET NO.
		CHECKED — WPD	REVISED —	STATE OF ILLINOIS	ROADWAY RESURFACING FAU ROUTE 1691 (144TH STREET)  LANDSCAPE AND EROSION CONTROL PLAN				1601	21-00119-00-RS	соок	22	12
	PLOT SCALE =	DRAWN — MED	REVISED —	DEPARTMENT OF TRANSPORTATION				PLAN			CONTRACT	NO. 61H	.89
	PLOT DATE = 04-15-2022	CHECKED — AG	REVISED —	sc	SCALE: 1"=50'	SHEET NO. 12 OF 22 SHEETS	STA.	TO STA.	FED. ROAL	D DIST. NO. 1 ILLINOIS FED. A	ND PROJECT ATSK	((659)	

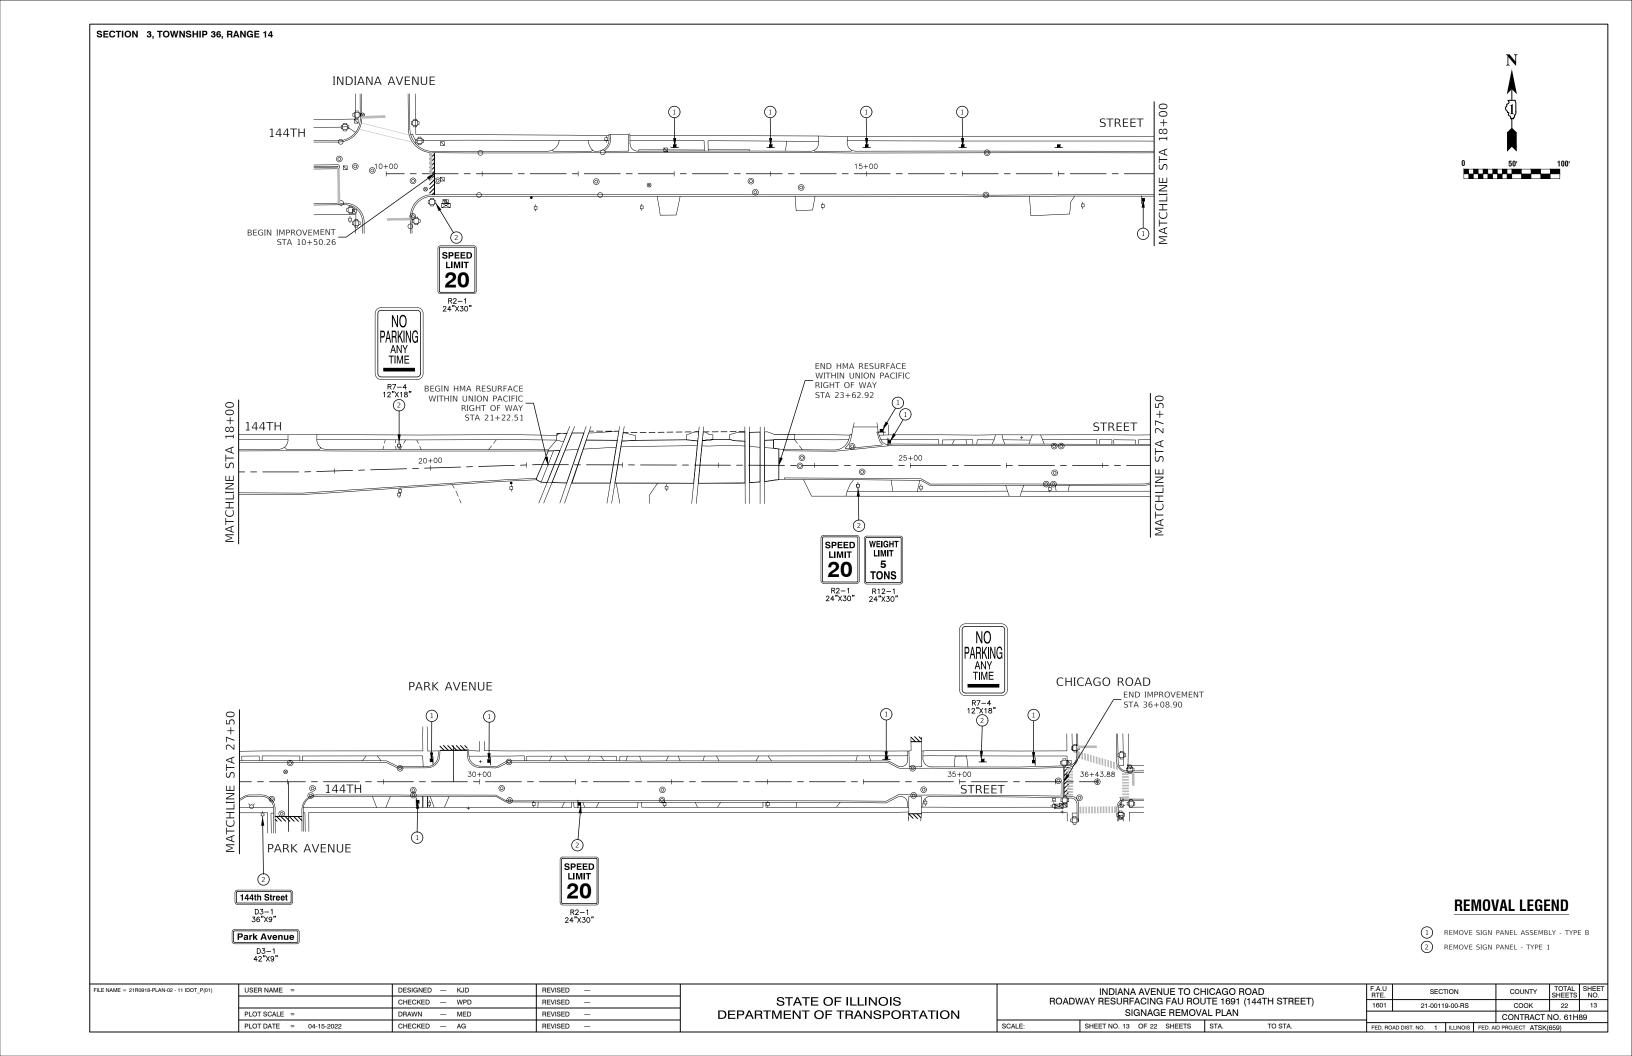

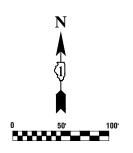

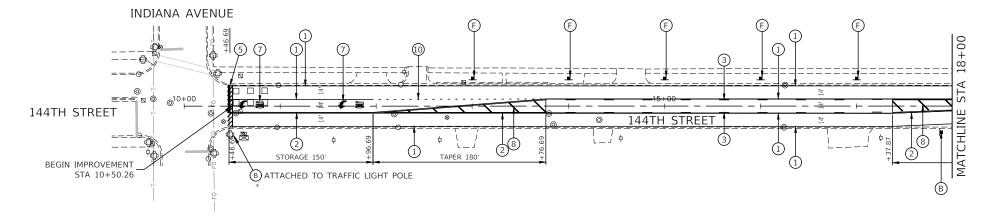

UNION PACIFIC RAILROAD (5)

# TRAFFIC SIGN LEGEND





 $\bigcirc$ B









1












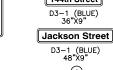



# **PAVEMENT MARKING LEGEND**

THERMOPLASTIC PAVEMENT MARKING - WHITE LINE, 4" LINE (PARKING)

THERMOPLASTIC PAVEMENT MARKING - YELLOW LINE, 4" LINE (11" C-C)

THERMOPLASTIC PAVEMENT MARKING - WHITE LINE, 4" SKIP DASH (10' LINE - 30' SPACE)

THERMOPLASTIC PAVEMENT MARKING - WHITE LINE, 6" LINE

THERMOPLASTIC PAVEMENT MARKING - WHITE LINE, 24" (STOP BAR)

THERMOPLASTIC PAVEMENT MARKING - WHITE LINE, 6" CROSSWALK (6' C-C)

THERMOPLASTIC PAVEMENT MARKING - WHITE LINE, LETTERS AND SYMBOLS

THERMOPLASTIC PAVEMENT MARKING - YELLOW LINE, 12" DIAGONAL LINE (20' C-C) THERMOPLASTIC PAVEMENT MARKING - WHITE LINE, 12' DIAGONAL LINE (10' C-C)

THERMOPLASTIC PAVEMENT MARKING - WHITE LINE, 6" SKIPDASH (2' LINE - 6' SPACE)

ONE-WAY AMBER MARKER 40' C/C UNLESS OTHERWISE INDICATED

ONE-WAY CRYSTAL MARKER 80' C/C UNLESS OTHERWISE INDICATED

TWO-WAY AMBER MARKER 40' C/C UNLESS OTHERWISE INDICATED

■ TRAFFIC SIGN

INSTALLED ON EXISTING POST

# NOTES

1.) SEE TC-13 DISTRICT 1 TYPICAL PAVEMENT MARKING FOR GUIDANCE.

2.) ALL PAVEMENT MARKINGS SHALL BE THERMOPLASTIC, UNLESS OTHERWISE SHOWN.

FILE NAME = 21R0918-PLAN-01 - PMKG-01	USER NAME =	DESIGNED — KJD	REVISED —	
		CHECKED — WPD	REVISED —	
	PLOT SCALE =	DRAWN — MED	REVISED —	
	PLOT DATE = 04-15-2022	CHECKED — AG	REVISED —	

BEGIN HMA RESURFACE WITHIN


UNION PACIFIC RIGHT OF WAY-


STA 21+22.51

END HMA RESURFACE WITHIN

-UNION PACIFIC RIGHT OF WAY

F.A.U RTE.		SECT	TION	COUNTY		TOTAL SHEETS	SHEE NO.		
1601	21-	-0011	9-00-RS		COOK	22	14		
				CONTRACT NO. 61H89					
FED. RO	AD DIST. NO.	1	ILLINOIS	FED. Al	D PROJECT AT	SK(	659)		

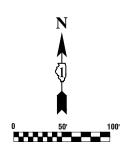

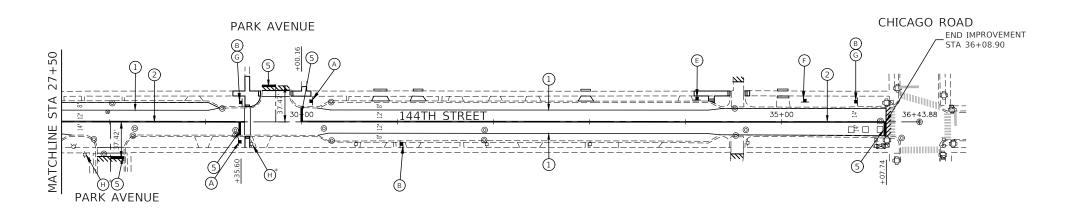

# TRAFFIC SIGN LEGEND





 $\bigcirc$ B





D





\$250 FINE R7-I101P 12"X6" E







Park Avenue D3-1 (BLUE) 42"X9"  $\bigoplus$ 


# **PAVEMENT MARKING LEGEND**

- THERMOPLASTIC PAVEMENT MARKING WHITE LINE, 4" LINE (PARKING)
- 2 THERMOPLASTIC PAVEMENT MARKING - YELLOW LINE, 4" LINE (11" C-C)
- 3 THERMOPLASTIC PAVEMENT MARKING - WHITE LINE, 4" SKIP DASH (10' LINE - 30' SPACE)
- 4 THERMOPLASTIC PAVEMENT MARKING - WHITE LINE, 6" LINE
- THERMOPLASTIC PAVEMENT MARKING WHITE LINE, 24" (STOP BAR)
- THERMOPLASTIC PAVEMENT MARKING WHITE LINE, 6" CROSSWALK (6' C-C)
- THERMOPLASTIC PAVEMENT MARKING WHITE LINE, LETTERS AND SYMBOLS
- THERMOPLASTIC PAVEMENT MARKING YELLOW LINE, 12" DIAGONAL LINE (20' C-C) THERMOPLASTIC PAVEMENT MARKING - WHITE LINE, 12' DIAGONAL LINE (10' C-C)
- THERMOPLASTIC PAVEMENT MARKING WHITE LINE, 6" SKIPDASH (2' LINE 6' SPACE)
- ONE-WAY AMBER MARKER 40' C/C UNLESS OTHERWISE INDICATED
- ONE-WAY CRYSTAL MARKER 80' C/C UNLESS OTHERWISE INDICATED
- TWO-WAY AMBER MARKER
  40' C/C UNLESS OTHERWISE INDICATED
- TRAFFIC SIGN
- INSTALLED ON EXISTING POST

# NOTES

- 1.) SEE TC-13 DISTRICT 1 TYPICAL PAVEMENT MARKING FOR GUIDANCE.
- 2.) ALL PAVEMENT MARKINGS SHALL BE THERMOPLASTIC, UNLESS OTHERWISE SHOWN.

													- 1
	FILE NAME = 21R0918-PLAN-01 - PMKG-02	USER NAME =	DESIGNED — KJD	REVISED —			INDIANA AVENUE TO CHICAGO ROAD		F.A.U RTF	SECTION	COUNTY	TOTAL SHEE	ΞŢ
			CHECKED — WPD	REVISED —	STATE OF ILLINOIS		WAY RESURFACING FAU ROUTE	,	1601	21-00119-00-RS	соок	22 15	ᅥ
		PLOT SCALE =	DRAWN — MED REVISED —	REVISED —	DEPARTMENT OF TRANSPORTATION	PAVEMENT MARKING AND PROPOSED SIGNAGE PLAN		ED SIGNAGE PLAN	<b>'</b>		CONTRACT	NO. 61H89	┥
		DLOT DATE 04 45 0000	CHECKED 40	DEVICED.		COALE	CHEET NO 15 OF 22 CHEETC CTA	TO 0T4					$\rightarrow$

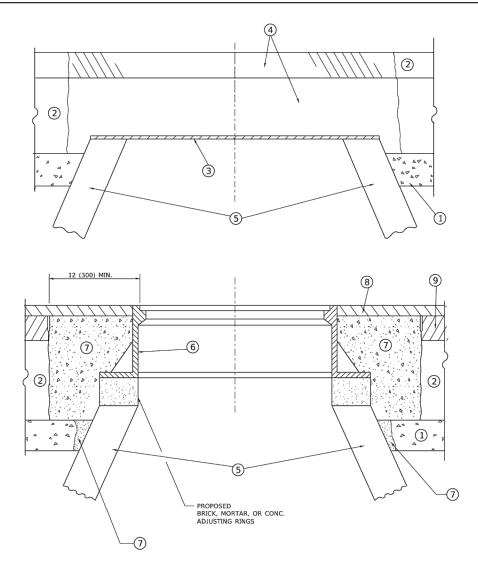

# DETAILS FOR FRAMES AND LIDS ADJUSTMENT WITH MILLING

#### <u>NOTES</u>

- 1. EXISTING BROKEN FRAMES AND LIDS SHALL BE REMOVED AND DISPOSED OF BY THE CONTRACTOR AND SHALL BE REPLACED AS DIRECTED BY THE ENGINEER. REPLACEMENT FRAMES AND LIDS WILL BE PAID FOR IN ACCORDANCE WITH ARTICLE 109.04 OF THE STANDARD SPECIFICATIONS UNLESS A SEPARATE PAY ITEM HAS BEEN PROVIDED.
- IF THE EXISTING LIDS ARE OPEN, THE FRAME WILL BE ADJUSTED TO THE ELEVATION OF THE MILLED PAVEMENT SURFACE PRIOR TO THE MILLING OPERATION. THE FRAME WILL NOT BE REMOVED AND COVERED BY THE METAL PLATE.
- CITY OF CHICAGO CASTINGS ARE THE PROPERTY OF THE CITY AND THE CONTRACTOR SHALL NOTIFY THE CITY FOR REMOVAL AND DISPOSITION OF THE CASTINGS.
- THE METAL PLATE USED TO COVER THE STRUCTURE SHALL REMAIN THE PROPERTY OF THE CONTRACTOR.

#### CONSTRUCTION PROCEDURES

#### STAGE 1 (BEFORE PAVEMENT MILLING)

- A) REMOVE A MINIMUM OF 12 (300) OF THE PAVEMENT FROM AROUND THE STRUCTURE.
- B) REMOVE THE EXISTING FRAME AND LID FROM THE STRUCTURE.
- C) COVER THE STRUCTURE OPENING WITH A 36 (900) DIAMETER METAL PLATE.
- D) BACKFILL WITH CRUSHED STONE AND HMA SURFACE MIX APPROVED BY THE ENGINEER. (MIN. 1 1/2 (40) HMA TO REMAIN AFTER MILLING).

#### STAGE 2 (AFTER PAVEMENT MILLING)

- A) REMOVE THE HMA SURFACE MIX AND CRUSHED STONE
- B) INSTALL THE FRAME AND LID; ADJUST THE FRAME TO ITS FINAL SURFACE ELEVATION.
- C) THE SURROUNDING SPACE SHALL BE FILLED WITH CLASS\*PP-1 CONCRETE TO THE ELEVATION OF THE SURFACE OF THE EXISTING BASE COURSE OR THE BINDER COURSE.
- \*UNLESS OTHERWISE SPECIFIED IN THE PLANS.

THE PROCEDURE EXPLAINED ABOVE SHALL CONFORM TO THE APPLICABLE PORTIONS OF SECTIONS 353, 406, 602, AND 603 OF THE STANDARD SPECIFICATIONS EXCEPT THAT "THE CONTRACTOR SHALL ADJUST THE STRUCTURES TO THE FINISHED PAVEMENT ELEVATION NO MORE THAN 5 CALENDAR DAYS PRIOR TO PLACEMENT OF THE FINAL LIFT OF SURFACE UNLESS APPROVED BY THE ENGINEER."

#### LEGE

- 1 SUB-BASE GRANULAR MATERIAL
- (6) FRAME AND LID (SEE NOTES)
- 2 EXISTING PAVEMENT
- 7 CLASS\*PP-1 CONCRETE
- 3 36 (900) DIAMETER METAL PLATE
- (8) PROPOSED HMA SURFACE COURSE
- 4 PROPOSED CRUSHED STONE AND HMA SURFACE MIX
- O THOI OSED TIMA SOM ACE COOK
- (5) EXISTING STRUCTURE
- 9 PROPOSED HMA BINDER COURSE

#### **LOCATION OF STRUCTURES**

THE CONTRACTOR WILL BE REQUIRED TO KEEP A RECORD OF THE LOCATIONS OF THE BURIED STRUCTURES ACCORDING TO THE STATION AND DISTANCE LEFT OR RIGHT OF THE CENTERLINE OF PAVEMENT. UPON COMPLETION OF THE WORK, THE CONTRACTOR WILL DELIVER THE RECORD TO THE ENGINEER.

#### **BASIS OF PAYMENT**

- REMOVING FRAMES AND LIDS ON DRAINAGE AND UTILITY STRUCTURES IN THE PAVEMENT PRIOR TO MILLING, AND ADJUSTING TO FINAL GRADE PRIOR TO PLACING THE SURFACE COURSE, WILL BE PAID FOR AT THE CONTRACT UNIT PRICE EACH FOR "FRAMES AND LIDS TO BE ADJUSTED (SPECIAL)."
- THIS WORK WILL NOT BE PAID FOR WHEN DRAINAGE AND UTILITY STRUCTURES ARE SPECIFIED FOR PAYMENT AS STRUCTURE RECONSTRUCTION.
- NEW FRAMES AND LIDS, WHEN SPECIFIED, WILL BE PAID FOR SEPARATELY.
- 4. WHEN STRUCTURES ARE TO BE ADJUSTED OR RECONSTRUCTED, THE LOWERING AND RAISING OF THE FRAMES AND LIDS WILL NOT BE PAID FOR SEPARATELY BUT WILL BE INCLUDED IN THE COST OF THE CORRESPONDING PAY ITEM.

ALL DIMENSIONS ARE IN INCHES (MILLIMETERS) UNLESS OTHERWISE SHOWN

JSER NAME = demanchelt DESIGNED -R. SHAH REVISED - R. BORO 01-01-07 **DETAILS FOR** STATE OF ILLINOIS DRAWN REVISED - R. BORO 03-09-11 FRAMES AND LIDS ADJUSTMENT WITH MILLING PLOT SCALE = 100.0000 ' / ir CHECKED REVISED - R. BORO 12-06-11 **DEPARTMENT OF TRANSPORTATION** BD600-03 (BD-08) CONTRACT NO SCALE: NONE DATE 10-25-94 REVISED K. SMITH 02-01-22 SHEET 1 OF 1 SHEETS STA.

STATE OF ILLINOIS
DEPARTMENT OF TRANSPORTATION

# METHOD OF MEASUREMENT

REFER TO SECTION 442 OF THE STANDARD SPECIFICATIONS FOR ROAD AND BRIDGE CONSTRUCTION AND THE RECURRING SPECIAL PROVISION "PATCHING WITH HOT-MIX ASPHALT OVERLAY REMOVAL."

# **BASIS OF PAYMENT**

- 1. REFER TO SECTION 442 OF THE STANDARD SPECIFICATIONS FOR ROAD AND BRIDGE CONSTRUCTION AND THE RECURRING SPECIAL PROVISION "PATCHING WITH HOT-MIX ASPHALT OVERLAY REMOVAL."
- 2. SAW CUT/SCORING OF EXISTING HMA OVERLAY IS INCLUDED IN THE COST OF PAVEMENT PATCHING.
- IS INCLUDED IN THE COST

3. SAW CUT/SCORING OF EXISTING PAVEMENT OF PAVEMENT PATCHING. 12 (300) **EXISTING PAVEMENT** \* SEE TYPICAL SECTIONS FOR THICKNESS AND MATERIALS

FOR PATCHING FIRST CONSTRUCTION

TOP OF EXIST. HMA

OR MILLED SURFACE

6 (150) MIN. -

UTILITY OR STORM SEWER TRENCH (IF PATCH IS DUE TO UTILITY OR SEWER WORK, THE WIDTH OF THE FULL DEPTH PATCH SHALL BE 12 (300) WIDER ON EACH SIDE OF THE TRENCH).

CLASS C OR CLASS D

PATCH OF THE THICKNESS SPECIFIED

SAW CUT/SCORING EXIST. HMA

PROPOSED UNSUITABLE SUBGRADE REMOVAL AND REPLACEMENT

OVERLAY, TYPICAL.

- SAW CUT/SCORING, TYPICAL

HMA REMOVAL OVER PATCHES \*

AND HMA REPLACEMENT OVER PATCHES

FOR PATCHING FIRST CONSTRUCTION

# SEQUENCE OF CONSTRUCTION (PATCHING FIRST)

- 1. REMOVE THE EXISTING HMA MATERIAL OVER THE AREA TO BE PATCHED.
- 2. REMOVE AND REPLACE WITH CLASS C OR D PATCH.
- 3. REPLACE HMA MATERIAL OVER THE AREA TO BE PATCHED.


# SEQUENCE OF CONSTRUCTION (MILLING FIRST)


- 1. MILL HMA FIRST IF THERE IS AT LEAST 4½ INCHES OR MORE OF HMA MATERIAL ON TOP OF THE EXISTING PAVEMENT OR IF THE PAVEMENT IS FULL DEPTH HMA. A MINIMUM OF 2 INCHES OF HMA MATERIAL SHALL BE IN PLACE AFTER MILLING.
- 2. REMOVE AND REPLACE WITH FULL DEPTH CLASS D PATCHES TO TOP OF MILLED SURFACE.

ALL DIMENSIONS ARE IN INCHES (MILLIMETERS) UNLESS OTHERWISE SHOWN.

USER NAME = demanchelt	DESIGNED - R. SHAH	REVISED - R. BORO 01-01-07			PAVEMENT PATCHING FOR	F.A. RTF	SECTION	COUNTY	TOTAL	SHEET
	DRAWN -	REVISED - R. BORO 09-04-07	STATE OF ILLINOIS			III .		·	Johnson	
PLOT SCALE = 100.0000 ' / in.	CHECKED -	REVISED - K. ENG 10-27-08	DEPARTMENT OF TRANSPORTATION		HMA SURFACED PAVEMENT		BD400-04 (BD-22)	CONTRACT	T NO.	
PLOT DATE = 2/2/2022	DATE - 10-25-94	REVISED - K. SMITH 02-01-22		SCALE: NONE	SHEET 1 OF 1 SHEETS STA. TO STA.		ILLINOIS FED. A	D PROJECT		

INDIANA AVENUE TO CHICAGO ROAD ROADWAY RESURFACING FAU ROUTE 1691 (144TH STREET) FILE NAME = 21R0918-DTLS-01 - BD22 USER NAME = DESIGNED - KJD REVISED SECTION COUNTY STATE OF ILLINOIS CHECKED - WPD REVISED 1601 21-00119-00-RS COOK 22 17 DISTRICT 1 DETAILS PLOT SCALE = REVISED DEPARTMENT OF TRANSPORTATION CONTRACT NO. 61H89 SCALE: NONE SHEET NO. 17 OF 22 SHEETS STA. PLOT DATE = 04-15-2022 CHECKED - AG REVISED

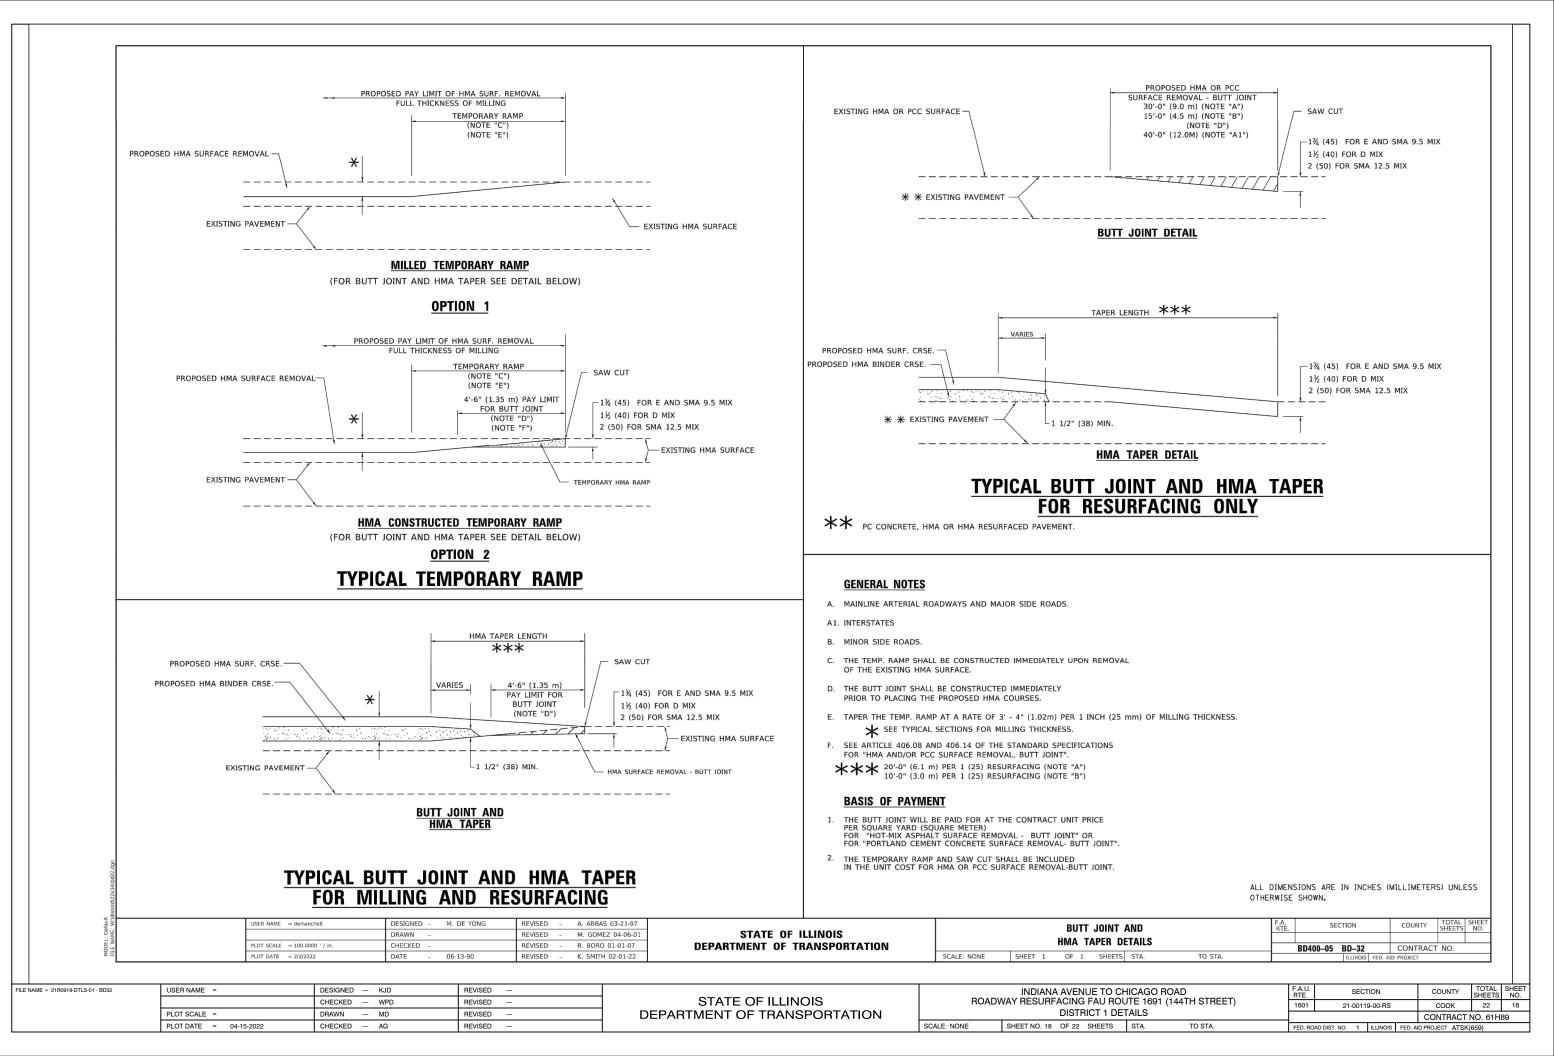

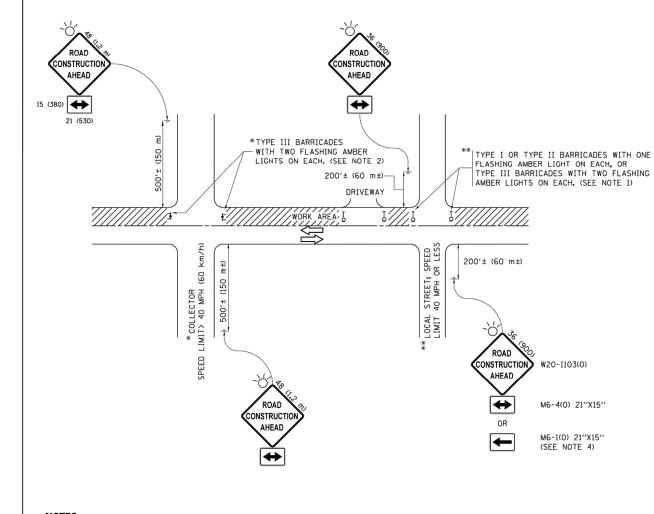

# NOTES:

- 1. SIDE ROAD WITH A SPEED LIMIT OF 40 MPH (60 km/h) OR LESS AS SHOWN ON THE DRAWING AND AS DIRECTED BY THE ENGINEER:
  - a) ONE "ROAD CONSTRUCTION AHEAD" SIGN 36 x 36 (900x900) WITH A FLASHER MOUNTED ON IT APPROXIMATELY 200' (60 m) IN ADVANCE OF THE MAIN ROUTE.
  - b) THE CLOSED PORTION OF THE MAIN ROUTE SHALL BE PROTECTED BY BLOCKING WITH TYPE I, TYPE II OR TYPE III BARRICADES, 1/3 OF THE CROSS SECTION OF THE CLOSED PORTION.
- SIDE ROAD WITH A SPEED LIMIT GREATER THAN 40 MPH (60 km/h) AS SHOWN ON THE DRAWING AND AS DIRECTED BY THE ENGINEER:
  - O) ONE "ROAD CONSTRUCTION AHEAD" SIGN 48 x 48 (1.2 m x 1.2 m) WITH A FLASHER MOUNTED ON IT APPROXIMATELY 500" (150 m) IN ADVANCE OF THE MAIN ROUTE.
  - b) THE CLOSED PORTION OF THE MAIN ROUTE SHALL BE PROTECTED BY BLOCKING WITH TYPE III BARRICADES, 1/2 OF THE CROSS SECTION OF THE CLOSED PORTION
- CONES MAY BE SUBSTITUTED FOR BARRICADES OR DRUMS AT HALF THE SPACING DURING DAY OPERATIONS. CONES SHALL BE A MINIMUM OF 28 (710) IN HEIGHT.
- 4. WHEN THE SIDE ROAD LIES BETWEEN THE BEGINNING OF THE MAINLINE SIGNING AND THE WORK ZONE, A SINGLE HEADED ARROW (M6-1) SHALL BE USED IN LIEU OF THE DOUBLE HEADED ARROW (M6-4).

- 5. WHEN WORK IS BEING PERFORMED ON A SIDE ROAD OR DRIVEWAY, FOLLOW THE APPLICABLE STANDARD(S). THE DIRECTIONAL ARROW (M6-1 OR M6-4) SHALL BE COVERED OR REMOVED WHEN NO LONGER CONSISTENT WITH THE TRAFFIC CONTROL SET-UP.
- 6. ADVANCE WARNING SIGNS ARE TO BE OMITTED ON DRIVEWAYS UNLESS OTHERWISE SPECIFIED IN THE PLANS OR BY THE FINGINFER.
- 7. THE TRAFFIC CONTROL AND PROTECTION FOR SIDE ROADS, INTERSECTIONS, AND DRIVEWAYS SHALL BE INCLUDED IN THE COST OF SPECIFIED TRAFFIC CONTROL STANDARDS OR ITEMS.

All dimensions are in inches (millimeters) unless otherwise shown.

TC-10

DESIGNED - L.H.A. REVISED - A. HOUSEH 10-15-96 FILE NAME = JSER NAME = footemj TRAFFIC CONTROL AND PROTECTION FOR STATE OF ILLINOIS ents\IDOT Offices\District 1\Projects\Di to **DRAWN**\CADData\CADsheets\to10.dgn REVISED -T. RAMMACHER 01-06-0 SIDE ROADS, INTERSECTIONS, AND DRIVEWAYS PLOT SCALE = 50.000 ' / in CHECKED REVISED - A. SCHUETZE 07-01-1 **DEPARTMENT OF TRANSPORTATION** DATE REVISED - A. SCHUETZE 09-15-SCALE: NONE SHEET 1 OF 1 SHEETS STA.

m 9/15/7016 12:46:49 PM Thermforteni

FILE NAME = 21R0918-DTLS-01 - TC10

 USER NAME
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 PLOT SCALE
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 DRAWN
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 MD
 REVISED
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 PLOT DATE
 =
 04-15-2022
 CHECKED
 —
 AG
 REVISED
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STATE OF ILLINOIS
DEPARTMENT OF TRANSPORTATION

ROADWAY RESURFACING FAU ROUTE 1691 (144TH STREET)

DISTRICT 1 DETAILS

SCALE: NONE SHEET NO. 19 OF 22 SHEETS STA. TO STA.

CONTRACT NO.

