
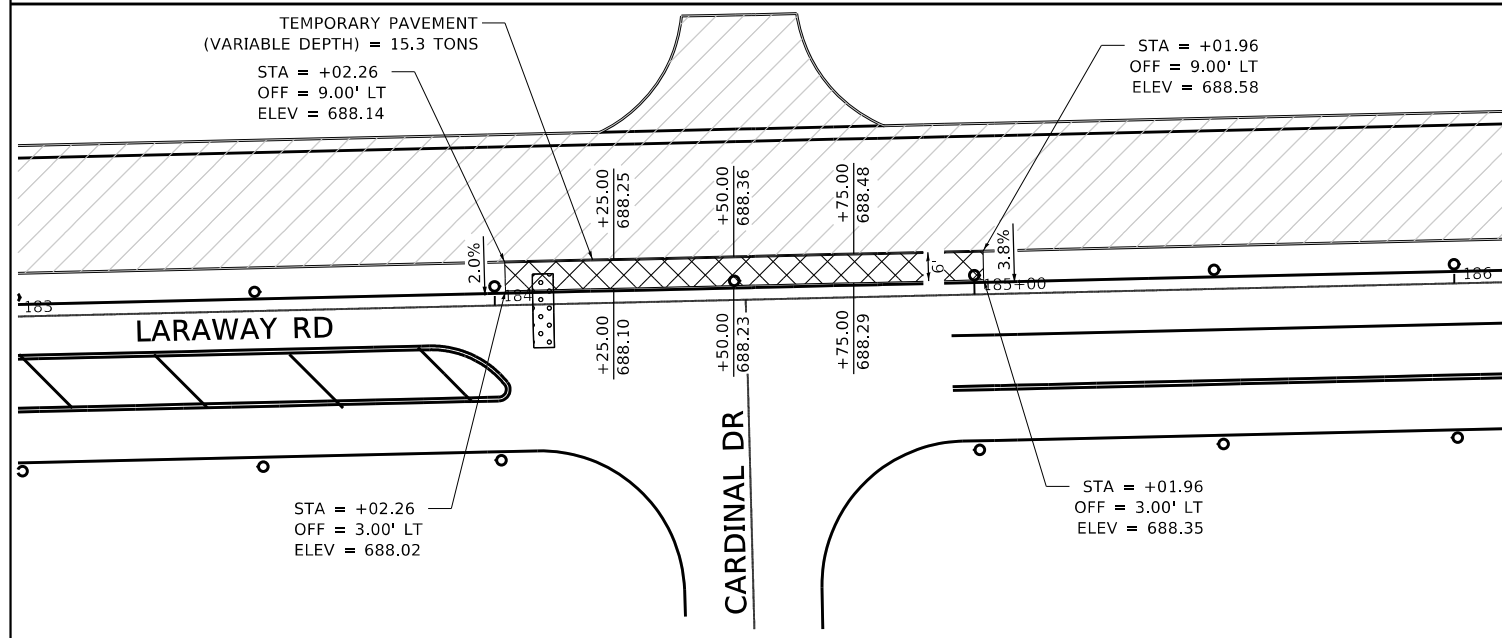
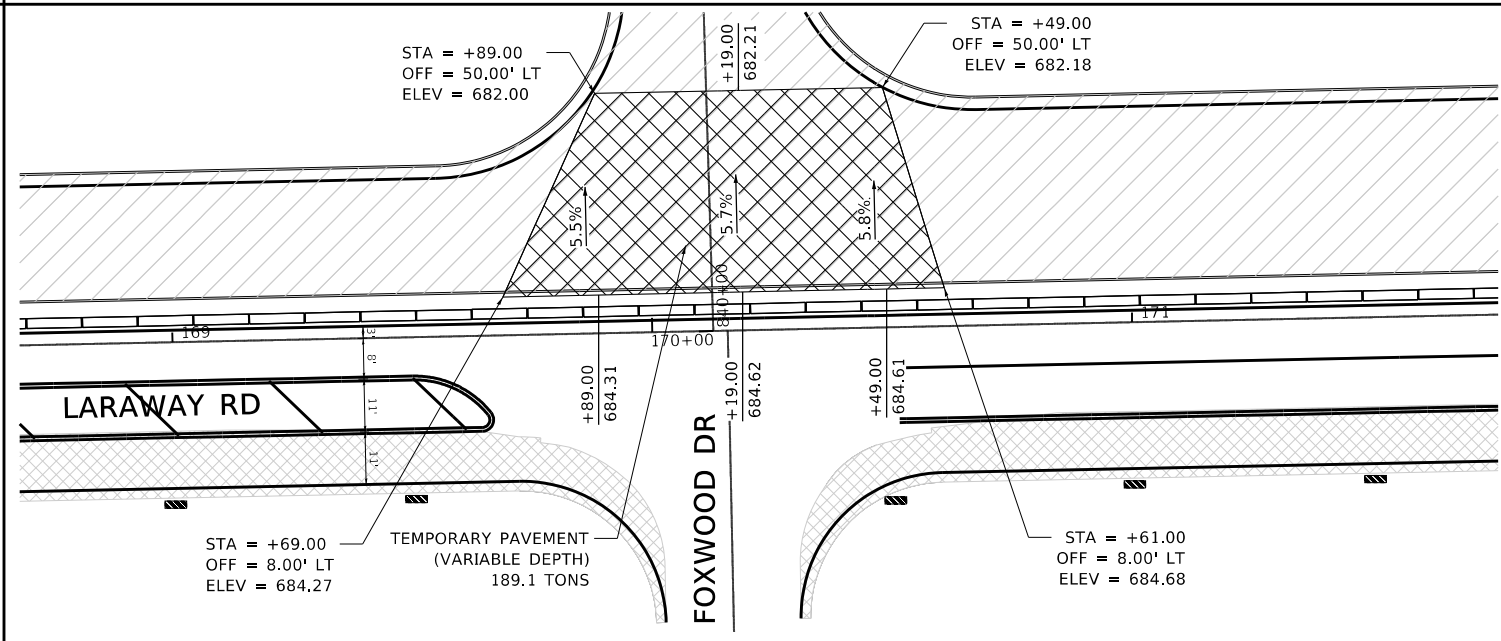
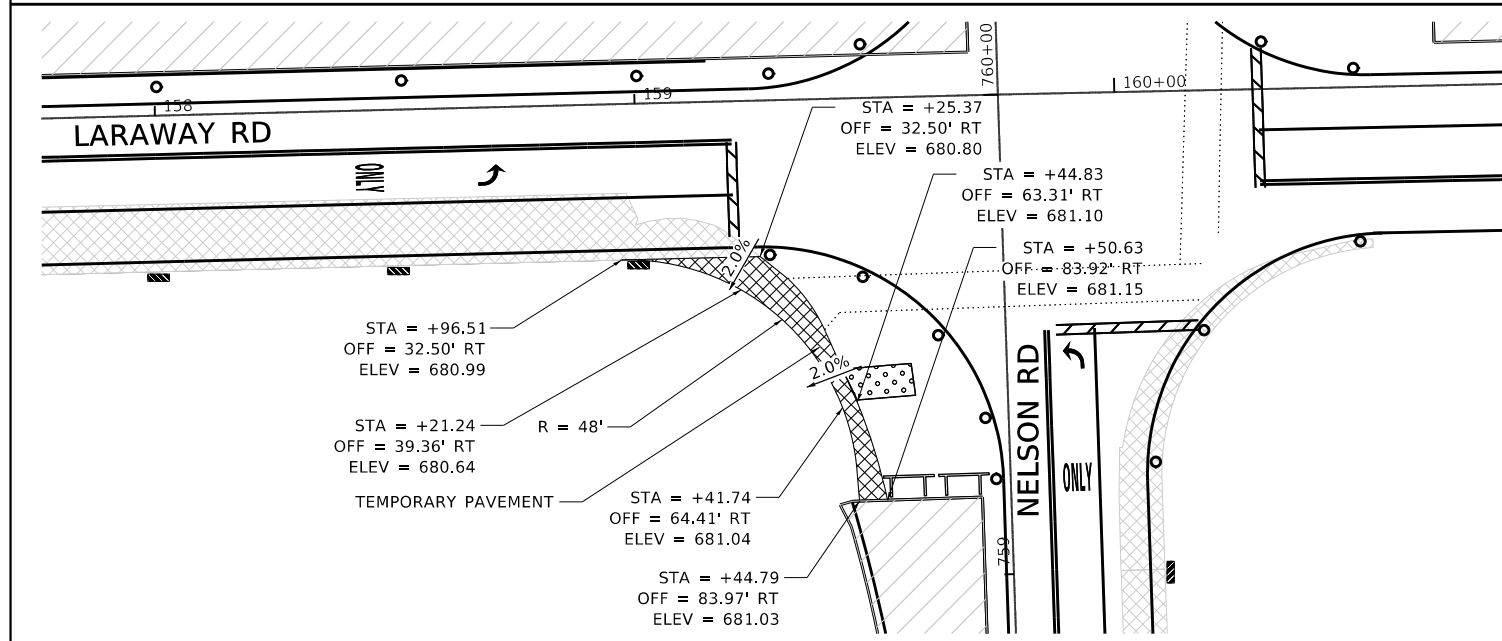
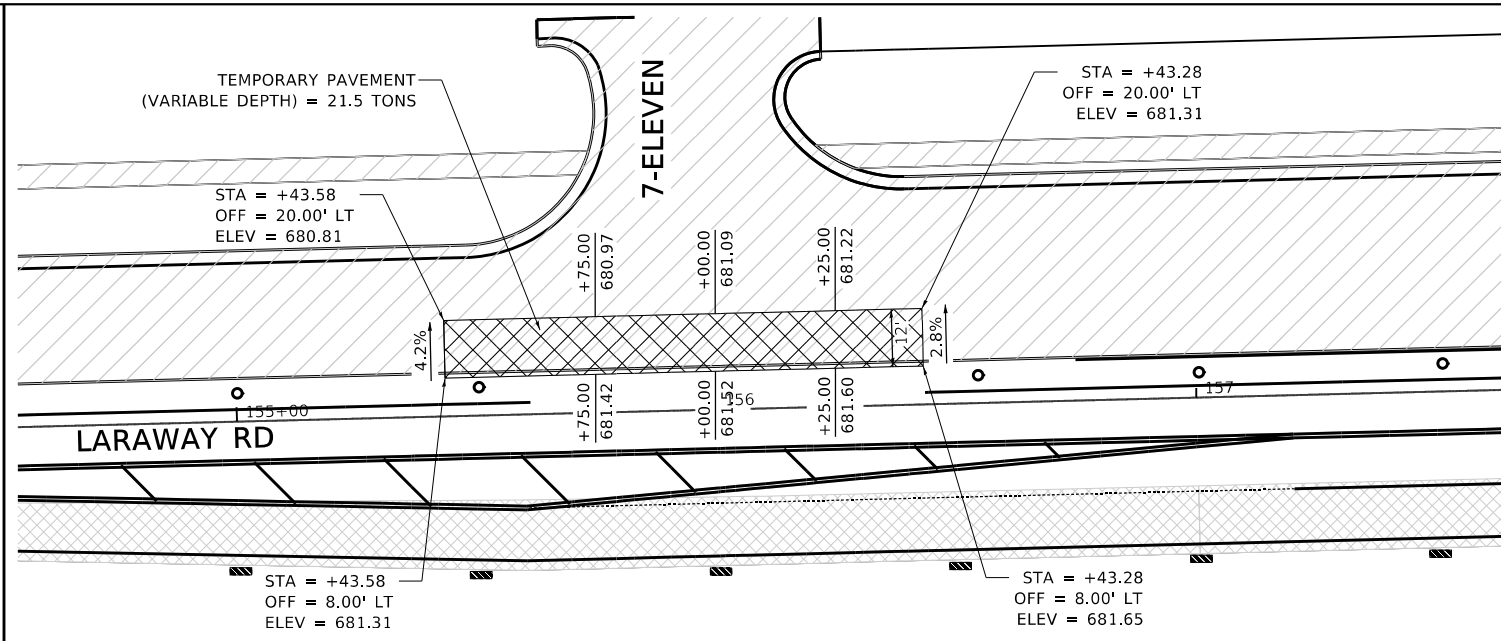


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 PLOT SCALE = 1/4" = 40.0000' / ft
 PLOT DATE = 9/9/2022 (12:15:03 PM)

PLOT DRIVER = PENTABLE
 PLOT SCALE = 1/4" = 40.0000' / ft
 PLOT DATE = 9/9/2022 (12:15:03 PM)

USER NAME = Mike Moser
 DIRECTORY = L:\MILL\CO117204-01\Draw\CADD_Sheets

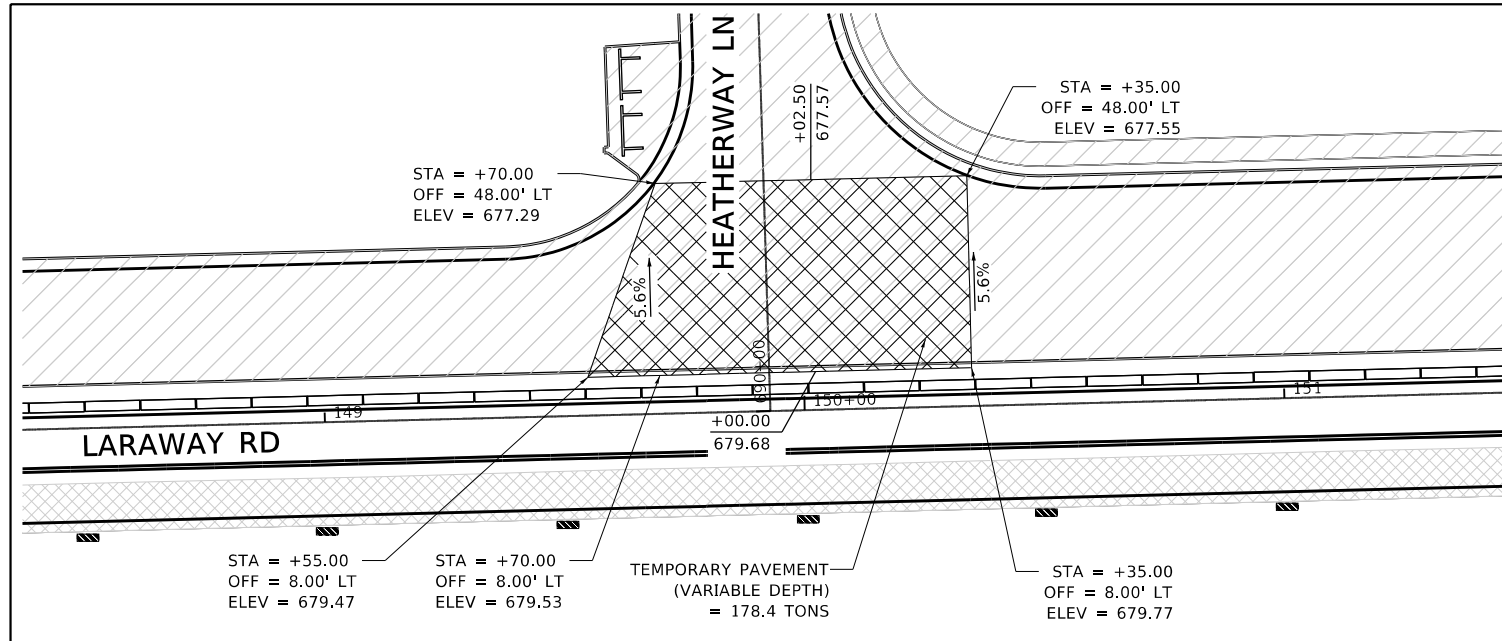

1. AT ALL DRIVEWAYS AND SIDE ROAD LOCATIONS FOLLOWING COMPLETION OF PROPOSED PAVEMENT TO TOP OF BINDER COURSE, TEMPORARY PAVEMENT AND TEMPORARY PAVEMENT, VARIABLE DEPTH WILL BE INSTALLED AS DETAILED.

2. WHEN TEMP PAVEMENT IS PLACED ABOVE PROPOSED PAVEMENT, A BOND BREAKER WILL BE INSTALLED TO ALLOW CLEAN REMOVAL OF TEMPORARY PAVEMENT (VARIABLE DEPTH).

LEGEND

- VERTICAL PANEL WITH STEADY-BURN LIGHT. (50' C-C TYP., 25' C-C ON TAPERS & CURVES)
- DRUM WITH STEADY-BURN LIGHT. (50' C-C TYP., 25' C-C ON TAPERS & CURVES)
- TYPE II BARRICADE WITH STEADY-BURN LIGHT. (50' C-C TYP., 25' C-C ON TAPERS & CURVES)
- TEMPORARY CONCRETE BARRIER
- DIRECTION OF TRAFFIC
- STORM SEWER CONSTRUCTED THIS STAGE
- STORM SEWER CONSTRUCTED PREVIOUS STAGE
- TEMPORARY PAVEMENT WIDENING CONSTRUCTED CURRENT STAGE
- TEMPORARY PAVEMENT WIDENING CONSTRUCTED PREVIOUS STAGE
- COMPLETED PAVEMENT (TO TOP OF BINDER COURSE)
- WORK ZONE
- PAVEMENT PATCHING CLASS D (SEE PAVEMENT PATCHING TABLE)
- AGGREGATE FOR TEMPORARY ACCESS

0 20 40 60
SCALE IN FEET




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STATE OF ILLINOIS
 DEPARTMENT OF TRANSPORTATION


SUGGESTED SEQUENCE OF CONSTRUCTION
 STAGE 1A - TEMPORARY PAVEMENT DETAILS

SCALE: 1"=20' SHEET 1 OF 1 SHEETS STA. N/A TO STA. N/A


F.A.U. RTE.	SECTION	COUNTY	TOTAL SHEETS	SHEET NO.
0320	13-00138-37-PV	WILL	413	101
CONTRACT NO. 61H20				
ILLINOIS		FED. AID PROJECT		

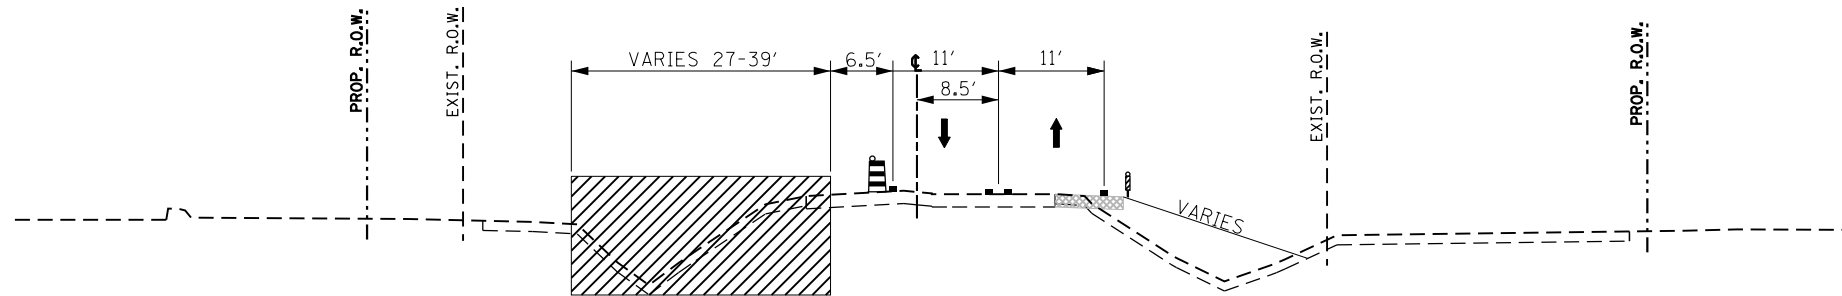

STAGE 1B TYPICAL SECTION
STA 139+00 TO 142+12.80

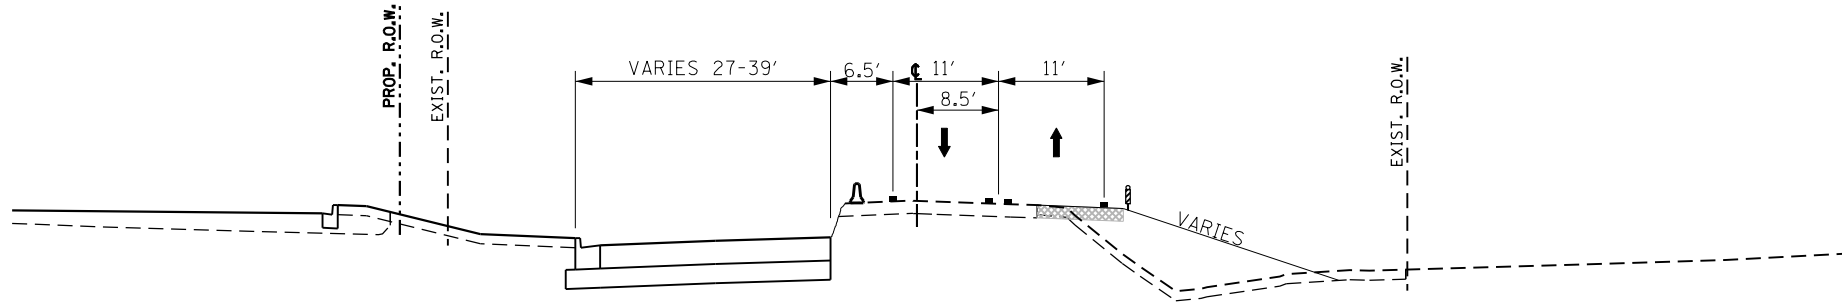

STAGE 1B TYPICAL SECTION
STA 142+12.80 TO 153+10.20

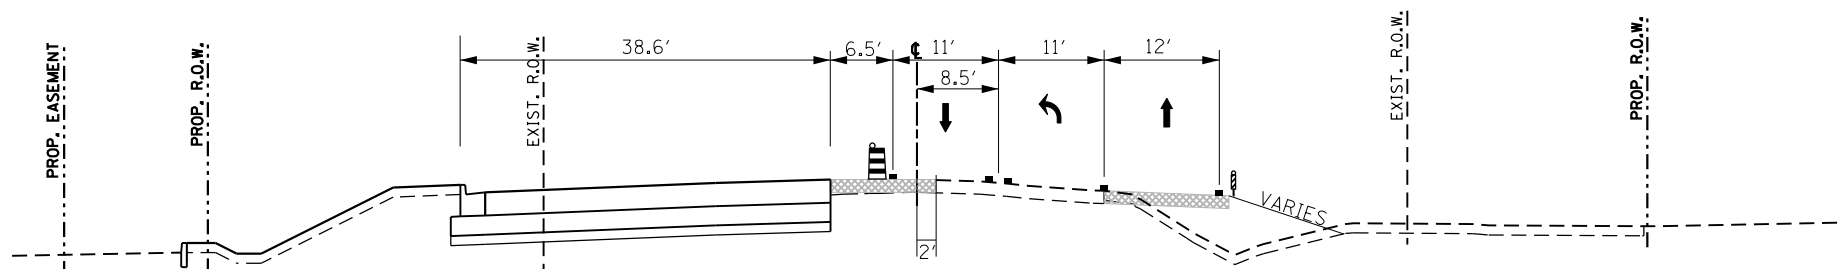

STAGE 1B TYPICAL SECTION
STA 157+20 TO 160+66.81

LEGEND	
	TEMPORARY PAVEMENT MARKING LINE
	VERTICAL PANEL WITH STEADY BURN LIGHT AS REQUIRED BY SPECIFICATIONS. (50' C-C TYP., 25' C-C ON TAPERS & CURVES)
	DRUM WITH STEADY-BURN LIGHT AS REQUIRED BY SPECIFICATIONS. (50' C-C TYP., 25' C-C ON TAPERS & CURVES)
	TYPE II BARRICADE WITH STEADY-BURN LIGHT AS REQUIRED BY SPECIFICATIONS. (50' C-C TYP., 25' C-C ON TAPERS & CURVES)
	TEMPORARY CONCRETE BARRIER WITH TYPE C REFLECTORS
	DIRECTION OF TRAFFIC
	TEMPORARY PAVEMENT WIDENING CONSTRUCTED CURRENT STAGE
	TEMPORARY PAVEMENT WIDENING CONSTRUCTED PREVIOUS STAGE
	COMPLETED PAVEMENT
	WORK ZONE




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STATE OF ILLINOIS
DEPARTMENT OF TRANSPORTATION

SUGGESTED SEQUENCE OF CONSTRUCTION
STAGE 1B TYPICAL SECTION - LARAWAY RD


SCALE: SHEET 1 OF 4 SHEETS STA. TO STA.

F.A.U. RTE.	SECTION	COUNTY	TOTAL SHEETS	SHEET NO.
0320	13-00138-37-PV	WILL	413	102
CONTRACT NO. 61H20				
ILLINOIS FED. AID PROJECT				

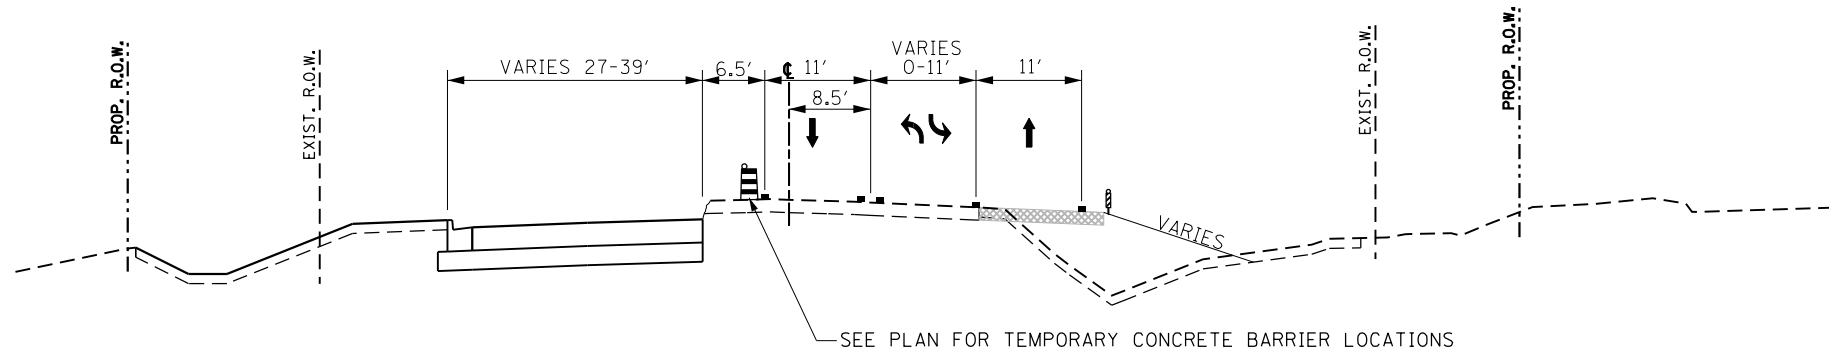


STAGE 1B TYPICAL SECTION

STA 153+10 TO 157+20,
160+66.81 TO 179+88.46

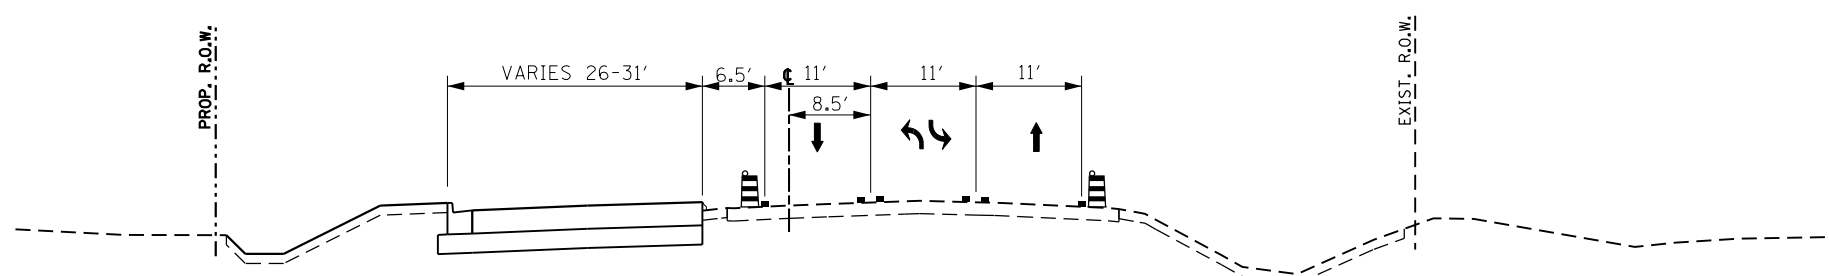

STAGE 1B TYPICAL SECTION

STA 179+88 TO 191+85

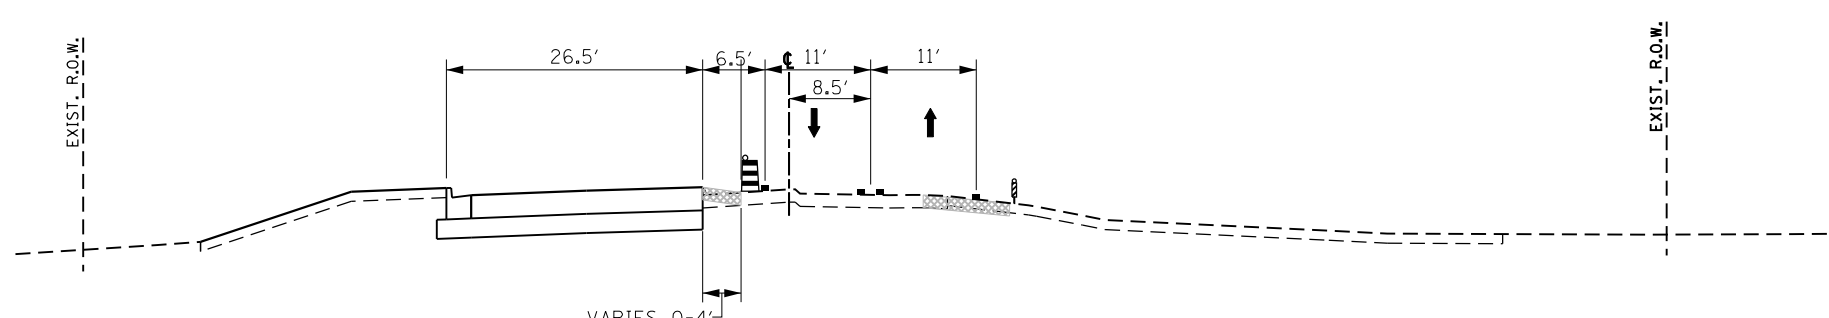

STAGE 1B TYPICAL SECTION

STA 191+85 TO 198+07.81

LEGEND


- TEMPORARY PAVEMENT MARKING LINE
- ▨ VERTICAL PANEL WITH STEADY BURN LIGHT AS REQUIRED BY SPECIFICATIONS. (50' C-C TYP., 25' C-C ON TAPERS & CURVES)
- ▨ DRUM WITH STEADY-BURN LIGHT AS REQUIRED BY SPECIFICATIONS. (50' C-C TYP., 25' C-C ON TAPERS & CURVES)
- ▨ TYPE II BARRICADE WITH STEADY-BURN LIGHT AS REQUIRED BY SPECIFICATIONS. (50' C-C TYP., 25' C-C ON TAPERS & CURVES)
- ▨ TEMPORARY CONCRETE BARRIER WITH TYPE C REFLECTORS
- ↑ DIRECTION OF TRAFFIC
- ▨ TEMPORARY PAVEMENT WIDENING CONSTRUCTED CURRENT STAGE
- ▨ TEMPORARY PAVEMENT WIDENING CONSTRUCTED PREVIOUS STAGE
- ▨ COMPLETED PAVEMENT
- ▨ WORK ZONE

CMT License No. 184-000613	FILE NAME = sht-staging-tp-stage01B-02.dgn	DESIGNED - PML	REVISED -
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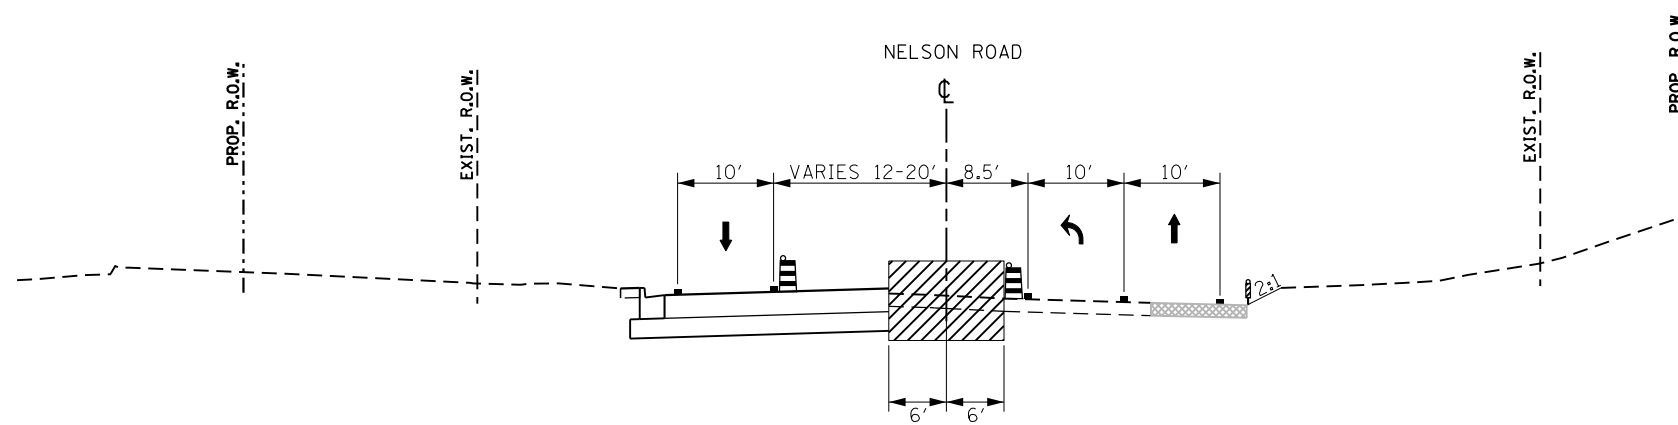
**STATE OF ILLINOIS
DEPARTMENT OF TRANSPORTATION**

SUGGESTED SEQUENCE OF CONSTRUCTION STAGE 1B TYPICAL SECTION - LARAWAY RD			
SCALE:	SHEET 2	OF 4 SHEETS	STA. TO STA.

F.A.U. RTE.	SECTION	COUNTY	TOTAL SHEETS	SHEET NO.
0320	13-00138-37-PV	WILL	413	103
CONTRACT NO. 61H20				
		ILLINOIS	FED. AID PROJECT	

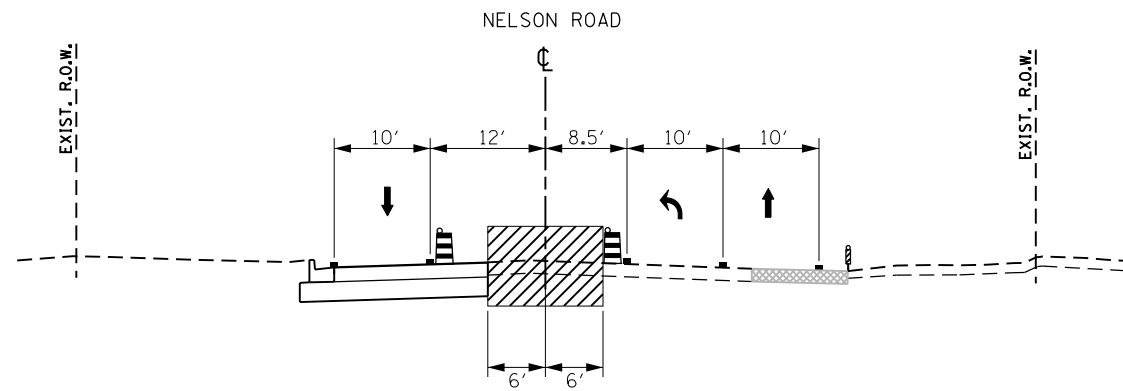

STAGE 1B TYPICAL SECTION
STA 756+10 TO 758+20



STAGE 1B TYPICAL SECTION
STA 758+20 TO 759+16

LEGEND

■	TEMPORARY PAVEMENT MARKING LINE	▨	TEMPORARY PAVEMENT WIDENING CONSTRUCTED CURRENT STAGE
⌋	VERTICAL PANEL WITH STEADY BURN LIGHT AS REQUIRED BY SPECIFICATIONS. (50' C-C TYP., 25' C-C ON TAPERS & CURVES)	▧	TEMPORARY PAVEMENT WIDENING CONSTRUCTED PREVIOUS STAGE
⌋	DRUM WITH STEADY-BURN LIGHT AS REQUIRED BY SPECIFICATIONS. (50' C-C TYP., 25' C-C ON TAPERS & CURVES)	▩	COMPLETED PAVEMENT
⌋	TYPE II BARRICADE WITH STEADY-BURN LIGHT AS REQUIRED BY SPECIFICATIONS. (50' C-C TYP., 25' C-C ON TAPERS & CURVES)	▨	WORK ZONE
⌋	TEMPORARY CONCRETE BARRIER WITH TYPE C REFLECTORS		
↑	DIRECTION OF TRAFFIC		



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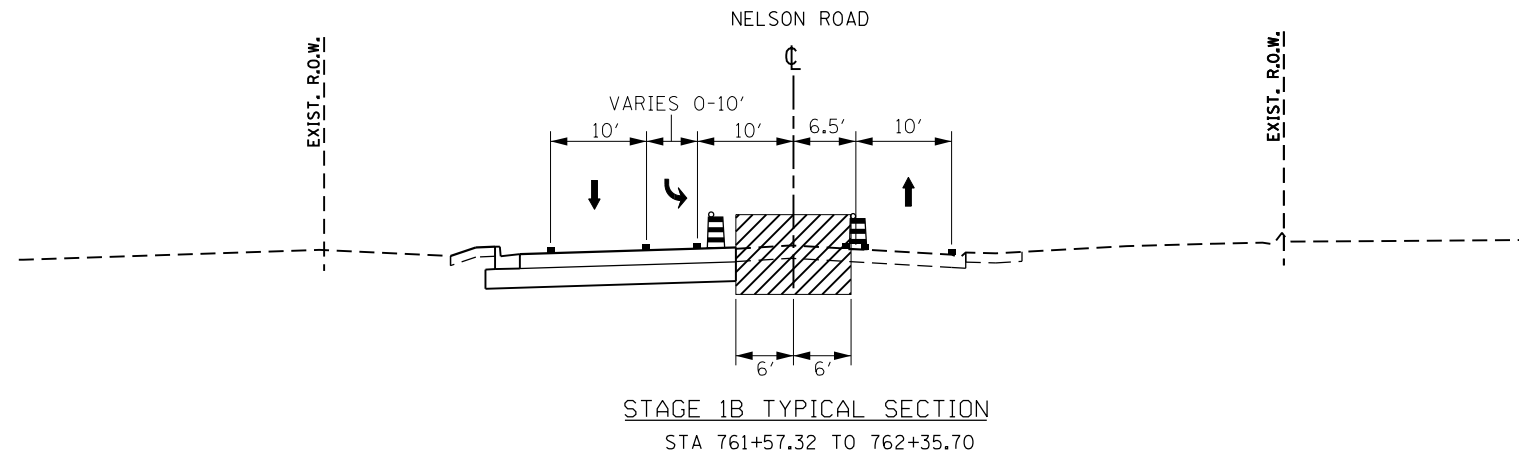
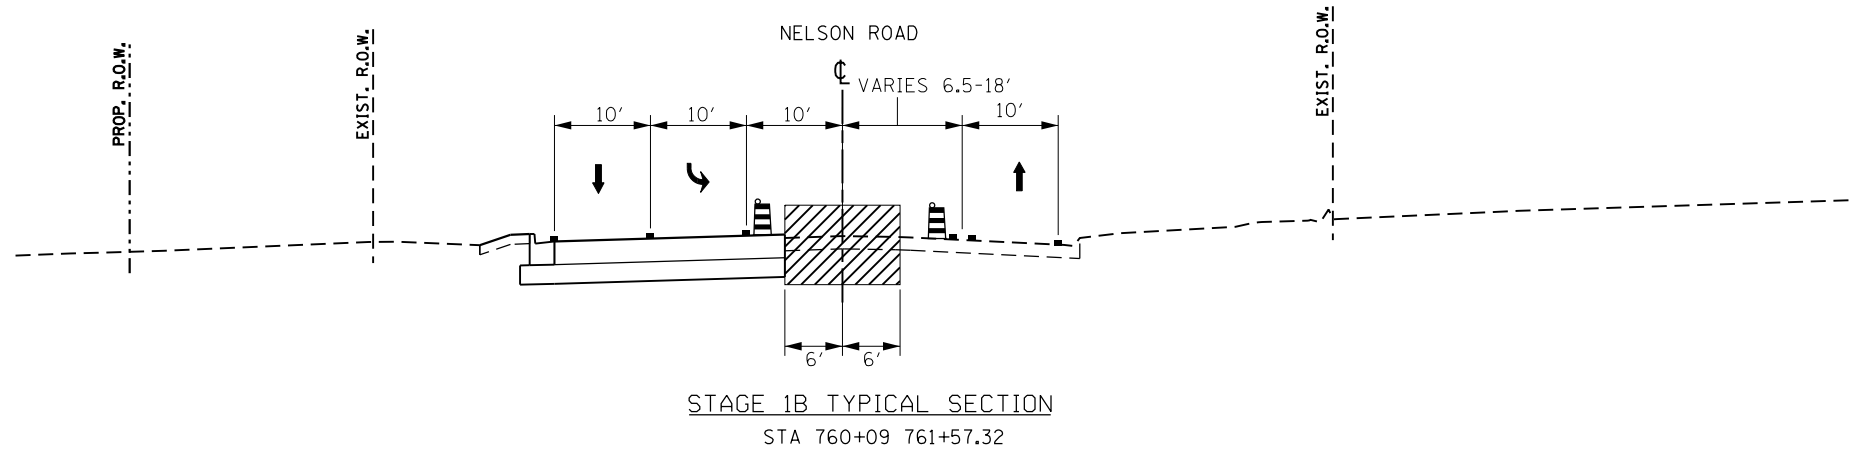
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PLOT DATE =	9/9/2022 - 12:15:08 PM	DATE -	09/09/2022	REVISED -	

STATE OF ILLINOIS
DEPARTMENT OF TRANSPORTATION

SUGGESTED SEQUENCE OF CONSTRUCTION
STAGE 1B TYPICAL SECTION - NELSON RD

SCALE: SHEET 3 OF 4 SHEETS STA. TO STA.

F.A.U. RTE.	SECTION	COUNTY	TOTAL SHEETS	SHEET NO.
0320	13-00138-37-PV	WILL	413	104
CONTRACT NO. 61H20				
ILLINOIS FED. AID PROJECT				



LEGEND

	TEMPORARY PAVEMENT MARKING LINE		TEMPORARY PAVEMENT WIDENING CONSTRUCTED CURRENT STAGE
	VERTICAL PANEL WITH STEADY BURN LIGHT AS REQUIRED BY SPECIFICATIONS. (50' C-C TYP., 25' C-C ON TAPERS & CURVES)		TEMPORARY PAVEMENT WIDENING CONSTRUCTED PREVIOUS STAGE
	DRUM WITH STEADY-BURN LIGHT AS REQUIRED BY SPECIFICATIONS. (50' C-C TYP., 25' C-C ON TAPERS & CURVES)		COMPLETED PAVEMENT
	TYPE II BARRICADE WITH STEADY-BURN LIGHT AS REQUIRED BY SPECIFICATIONS. (50' C-C TYP., 25' C-C ON TAPERS & CURVES)		WORK ZONE
	TEMPORARY CONCRETE BARRIER WITH TYPE C REFLECTORS		
	DIRECTION OF TRAFFIC		



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PLOT DATE = 9/9/2022 - 12:15:09 PM	DATE - 09/09/2022	REVISED -

**STATE OF ILLINOIS
 DEPARTMENT OF TRANSPORTATION**

**SUGGESTED SEQUENCE OF CONSTRUCTION
 STAGE 1B TYPICAL SECTION - NELSON RD**

SCALE: SHEET 4 OF 4 SHEETS STA. TO STA.

F.A.U. RTE.	SECTION	COUNTY	TOTAL SHEETS	SHEET NO.
0320	13-00138-37-PV	WILL	413	105
CONTRACT NO. 61H20				
ILLINOIS		FED. AID PROJECT		


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PENTABLE
= L:\M\LAYERS\PERSONAL\jms
= L:\M\LAYERS\PERSONAL\jms

LEGEND


- VERTICAL PANEL WITH STEADY BURN LIGHT AS REQUIRED BY SPECIFICATIONS. (50' C-C TYP., 25' C-C ON TAPERS & CURVES)
- DRUM WITH STEADY-BURN LIGHT AS REQUIRED BY SPECIFICATIONS. (50' C-C TYP., 25' C-C ON TAPERS & CURVES)
- TYPE III BARRICADE WITH STEADY-BURN LIGHT AS REQUIRED BY SPECIFICATIONS.
- TEMPORARY CONCRETE BARRIER WITH TYPE C REFLECTOR ROW PR
- DIRECTION OF TRAFFIC
- STORM SEWER CONSTRUCTED THIS STAGE
- STORM SEWER CONSTRUCTED PREVIOUS STAGE
- TEMPORARY PAVEMENT WIDENING CONSTRUCTED CURRENT STAGE
- TEMPORARY PAVEMENT WIDENING CONSTRUCTED PREVIOUS STAGE
- COMPLETED PAVEMENT (TO TOP OF BINDER COURSE)
- WORK ZONE
- PAVEMENT PATCHING CLASS D (SEE PVMT PATCH DETAIL SHEETS)
- TEMPORARY ACCESS
- TEMPORARY PAVEMENT MARKINGS:
 - ① 4" YELLOW (SOLID)
 - ② 4" WHITE (SOLID)
 - ③ 4" WHITE (SKIP-DASH)
 - ④ 6" WHITE (2' DASH, 6' SKIP)
 - ⑤ 6" WHITE (SOLID)
 - ⑥ 12" YELLOW (DIAGONALS) 30' C-C @45°
 - ⑦ 12" WHITE (DIAGONALS)
 - ⑧ 24" WHITE (STOP BAR)
 - ⑨ 4" DOUBLE YELLOW (SOLID) @11" C-C
 - ⑩ LETTERS & SYMBOLS

NOTES:


- 1. STAGE 1B LANE CONFIGURATIONS ARE THE SAME AS IN STAGE 1A UNLESS OTHERWISE NOTED.

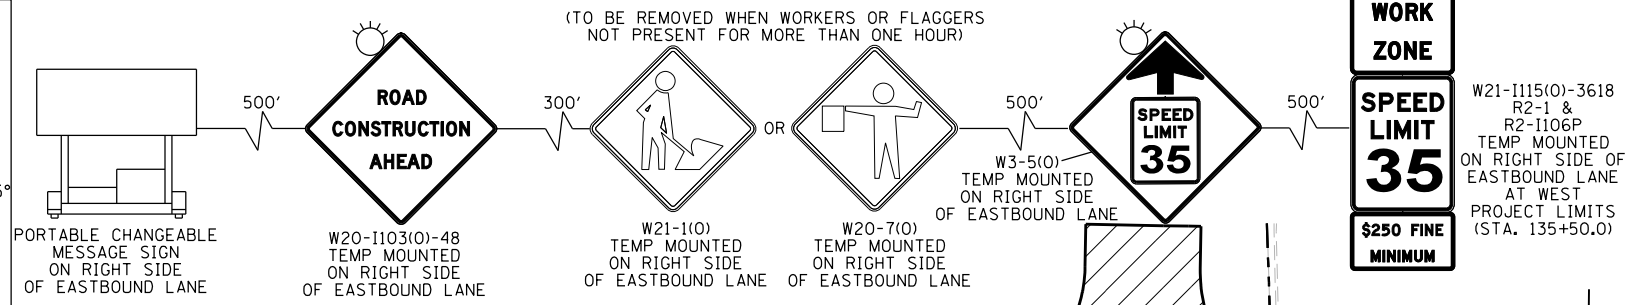

PLOT SCALE
PLOT DATE
= 40.0018" / in.
= 9/9/2022 (12:15:13 PM)

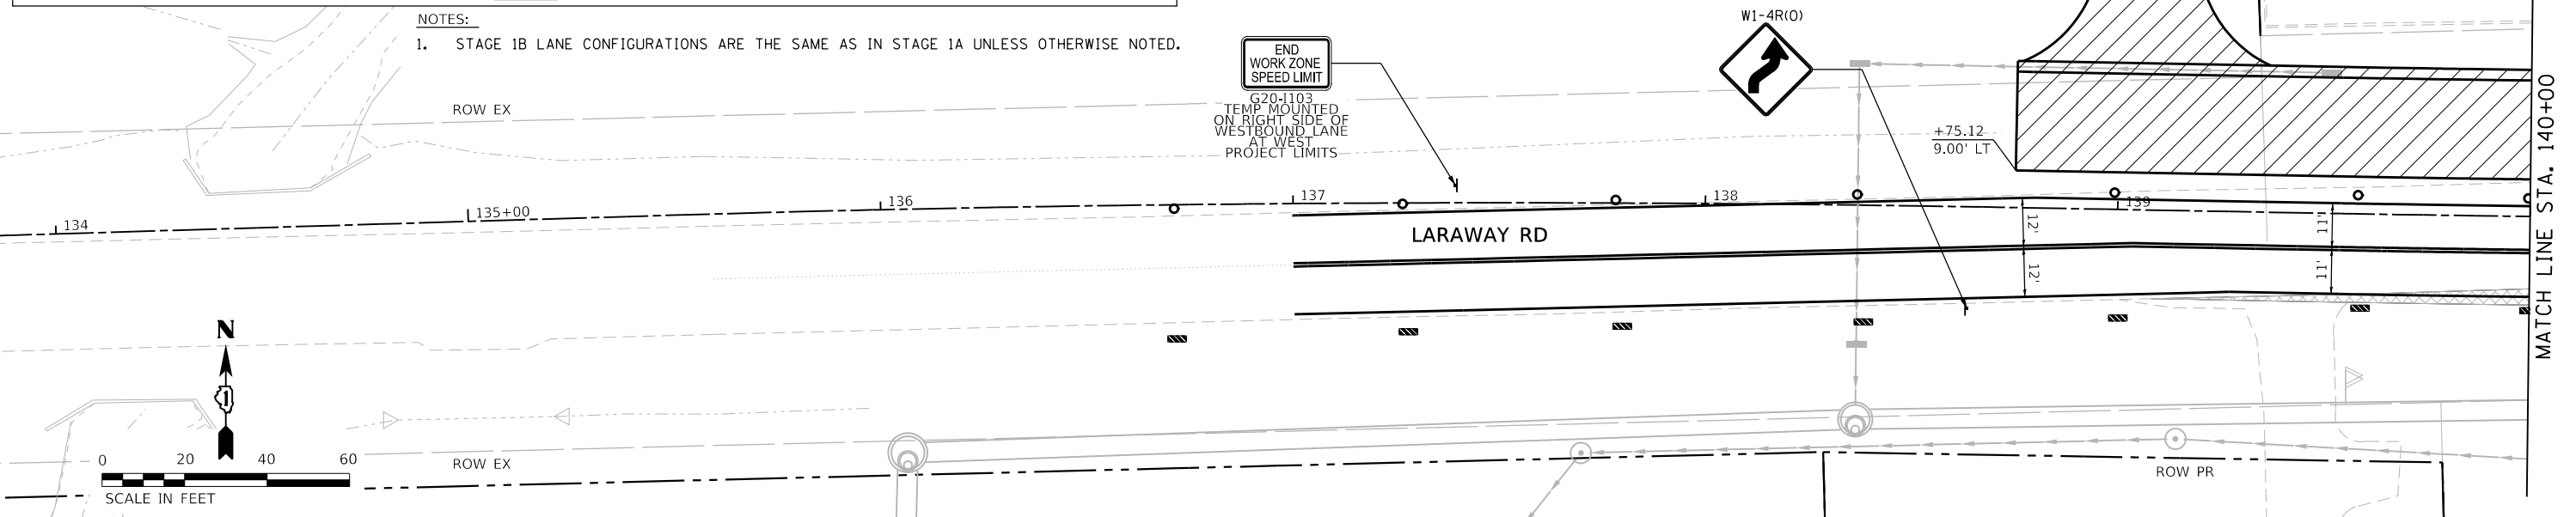

USER NAME
DIRECTORY
= M:\Users
= L:\M\LAYERS\PERSONAL\jms

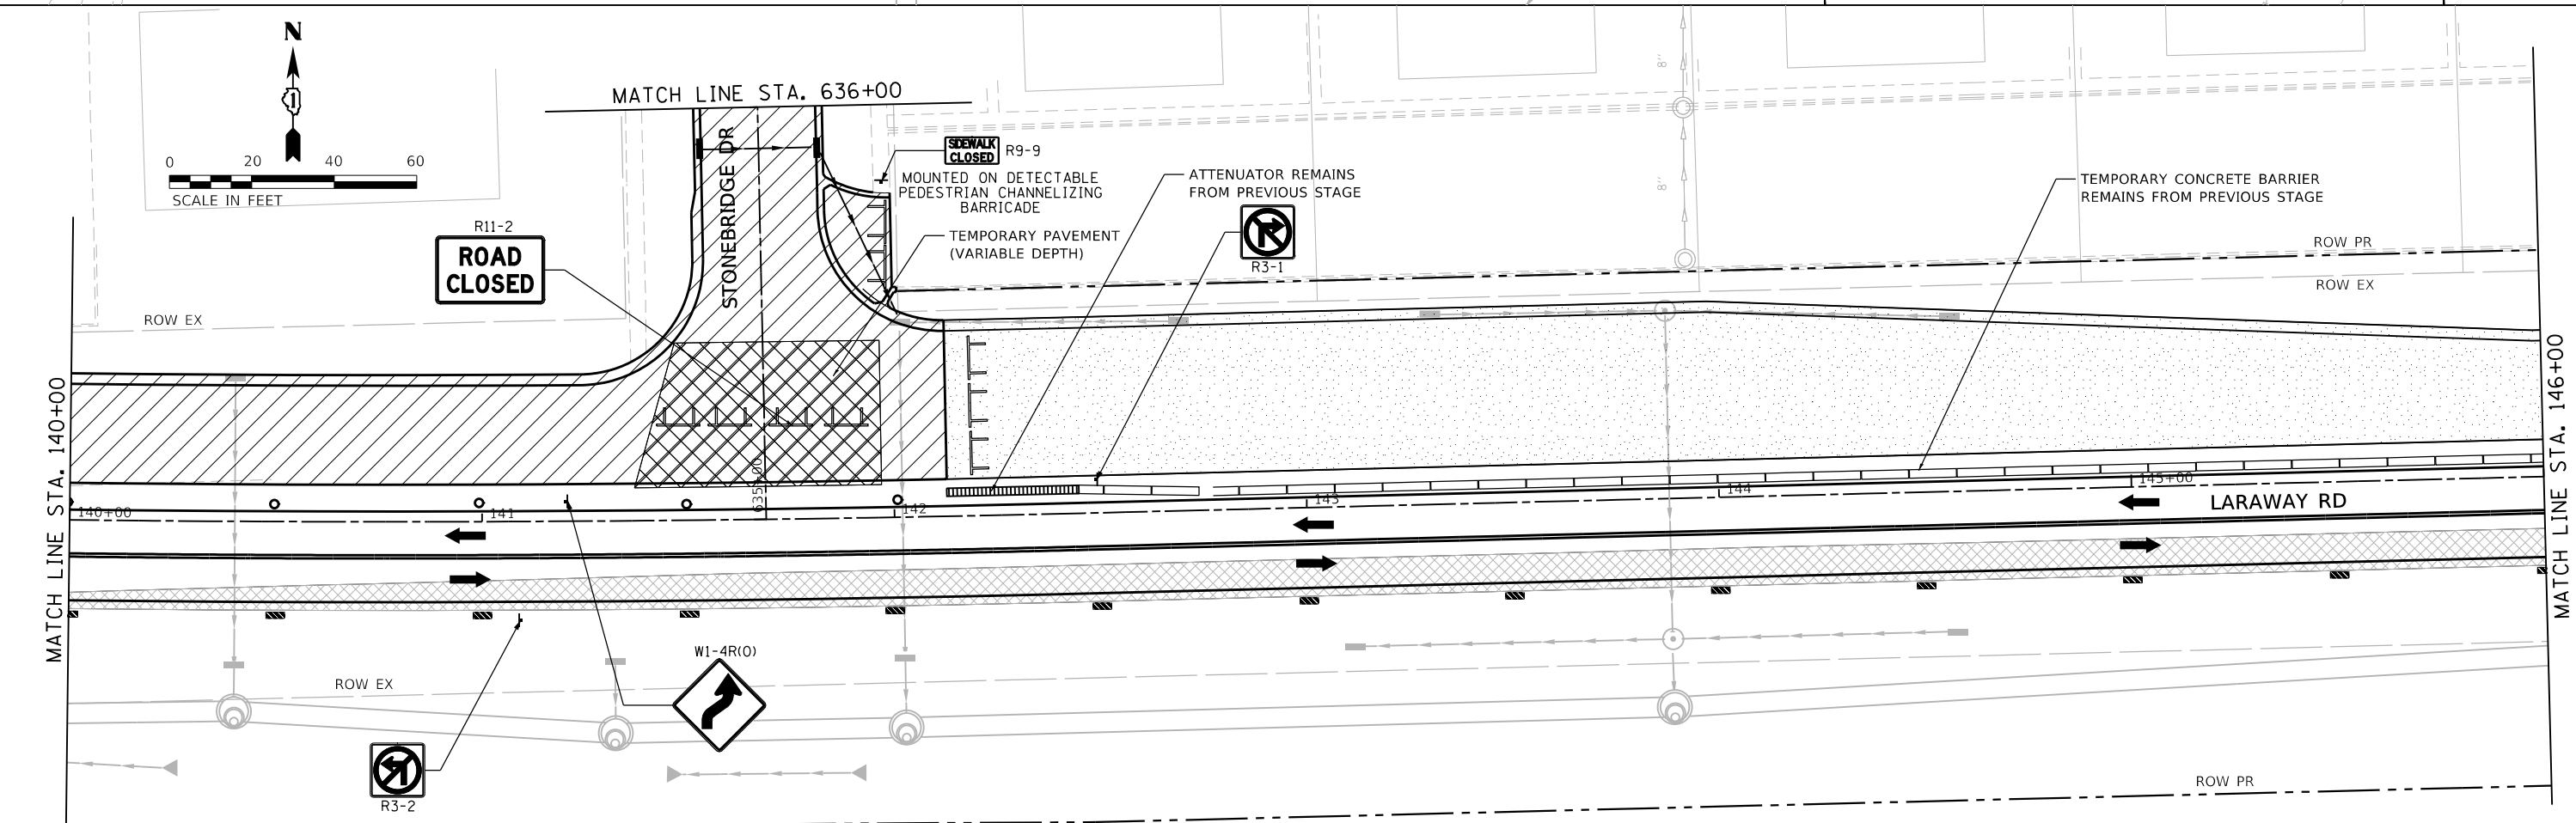

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MODEL NAME	= Default	DRAWN	- PML	REVISED	-
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PLOT DATE	= 9/9/2022 - 12:15:13 PM	DATE	- 09/09/2022	REVISED	-

**STATE OF ILLINOIS
DEPARTMENT OF TRANSPORTATION**

**SUGGESTED SEQUENCE OF CONSTRUCTION
LARAWAY RD - STAGE 1B**


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F.A.U. RTE.	SECTION	COUNTY	TOTAL SHEETS	SHEET NO.
0320	13-00138-37-PV	WILL	413	106
CONTRACT NO. 61H20				
ILLINOIS FED. AID PROJECT				

PLOT DRIVER
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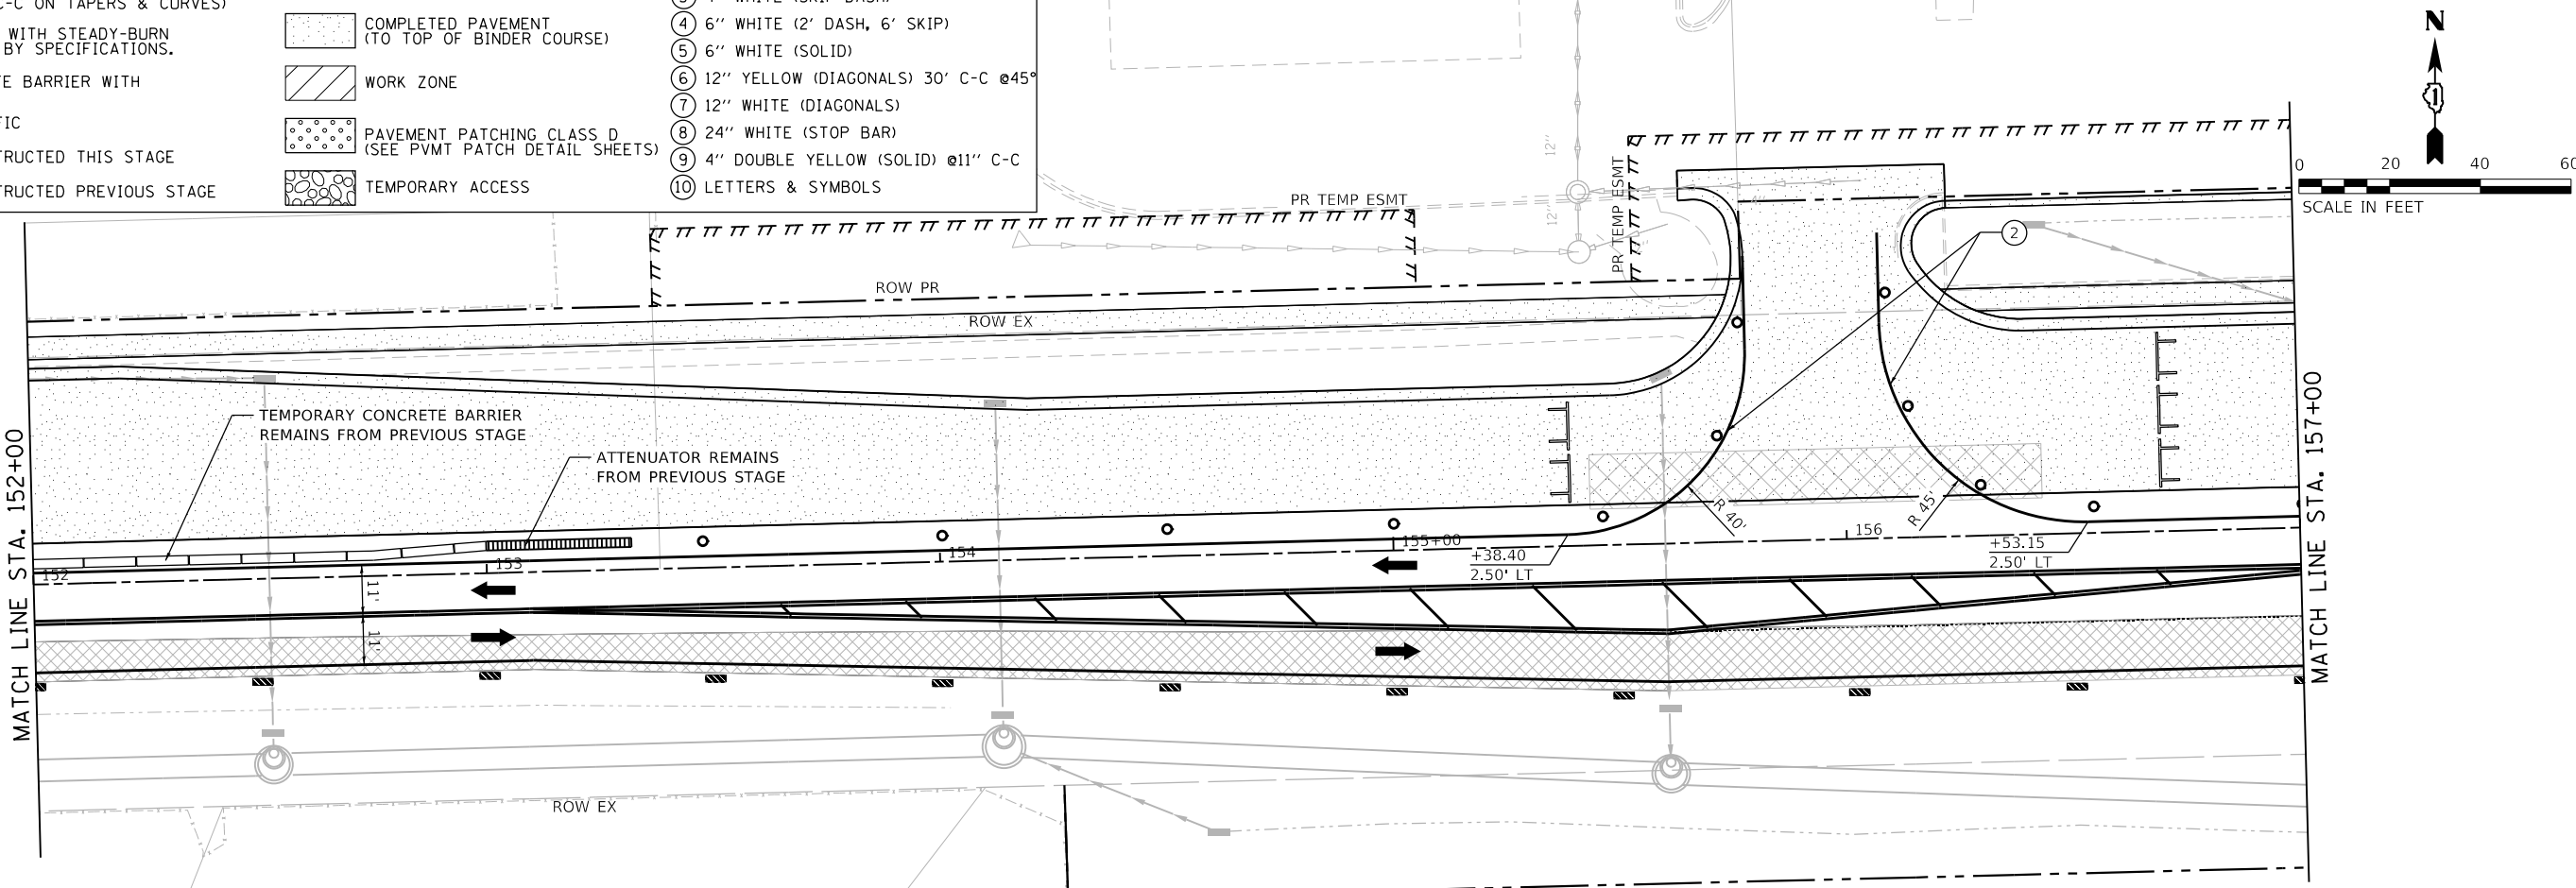
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PLOT DATE
= 40.0018' / in.
= 9/9/2022 (12:15:15 PM)

USER NAME
DIRECTORY
= Mike Moses
= L:\MILLCOIT\7204-01\Drawn\CADD_Sheets\



LEGEND

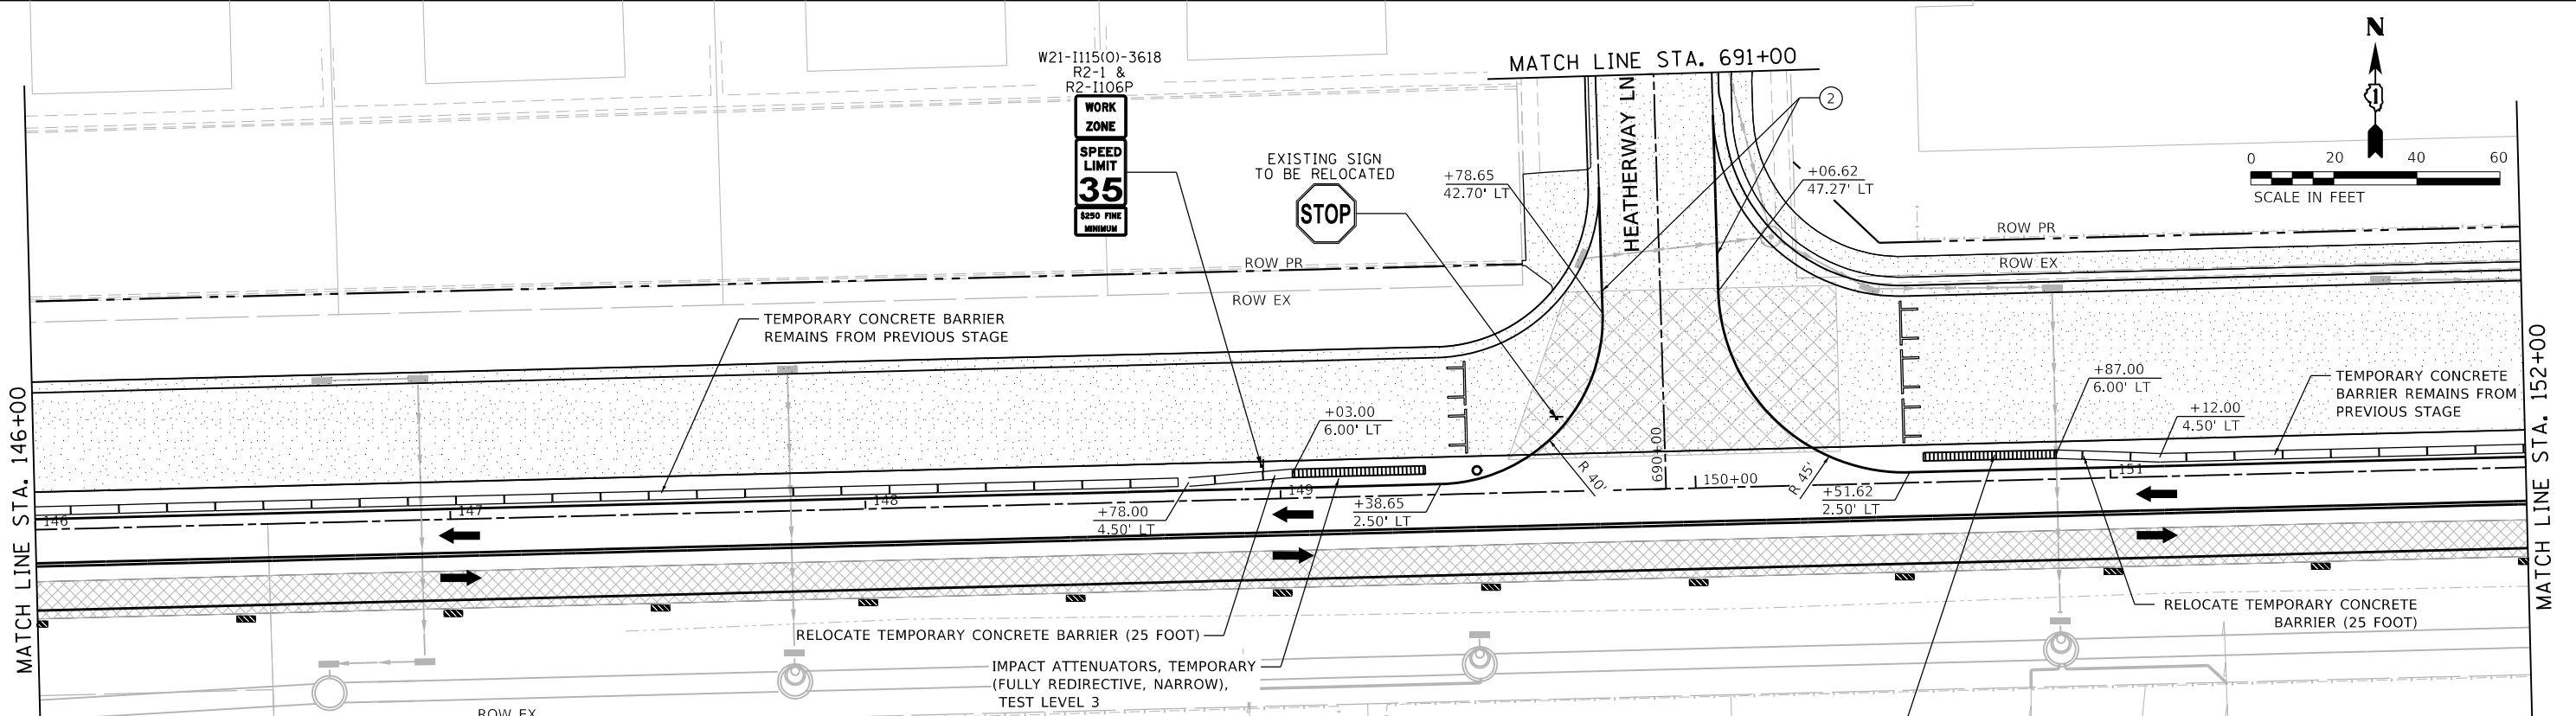	VERTICAL PANEL WITH STEADY BURN LIGHT AS REQUIRED BY SPECIFICATIONS. (50' C-C TYP., 25' C-C ON TAPERS & CURVES)		TEMPORARY PAVEMENT WIDENING CONSTRUCTED CURRENT STAGE	TEMPORARY PAVEMENT MARKINGS
	DRUM WITH STEADY-BURN LIGHT AS REQUIRED BY SPECIFICATIONS. (50' C-C TYP., 25' C-C ON TAPERS & CURVES)		TEMPORARY PAVEMENT WIDENING CONSTRUCTED PREVIOUS STAGE	① 4" YELLOW (SOLID)
	TYPE III BARRICADE WITH STEADY-BURN LIGHT AS REQUIRED BY SPECIFICATIONS.		COMPLETED PAVEMENT (TO TOP OF BINDER COURSE)	② 4" WHITE (SOLID)
	TEMPORARY CONCRETE BARRIER WITH TYPE C REFLECTOR		WORK ZONE	③ 4" WHITE (SKIP-DASH)
	DIRECTION OF TRAFFIC		PAVEMENT PATCHING CLASS D (SEE PVMT PATCH DETAIL SHEETS)	④ 6" WHITE (2' DASH, 6' SKIP)
	STORM SEWER CONSTRUCTED THIS STAGE		TEMPORARY ACCESS	⑤ 6" WHITE (SOLID)
	STORM SEWER CONSTRUCTED PREVIOUS STAGE			⑥ 12" YELLOW (DIAGONALS) 30' C-C @45°
				⑦ 12" WHITE (DIAGONALS)
				⑧ 24" WHITE (STOP BAR)
				⑨ 4" DOUBLE YELLOW (SOLID) @11" C-C
				⑩ LETTERS & SYMBOLS




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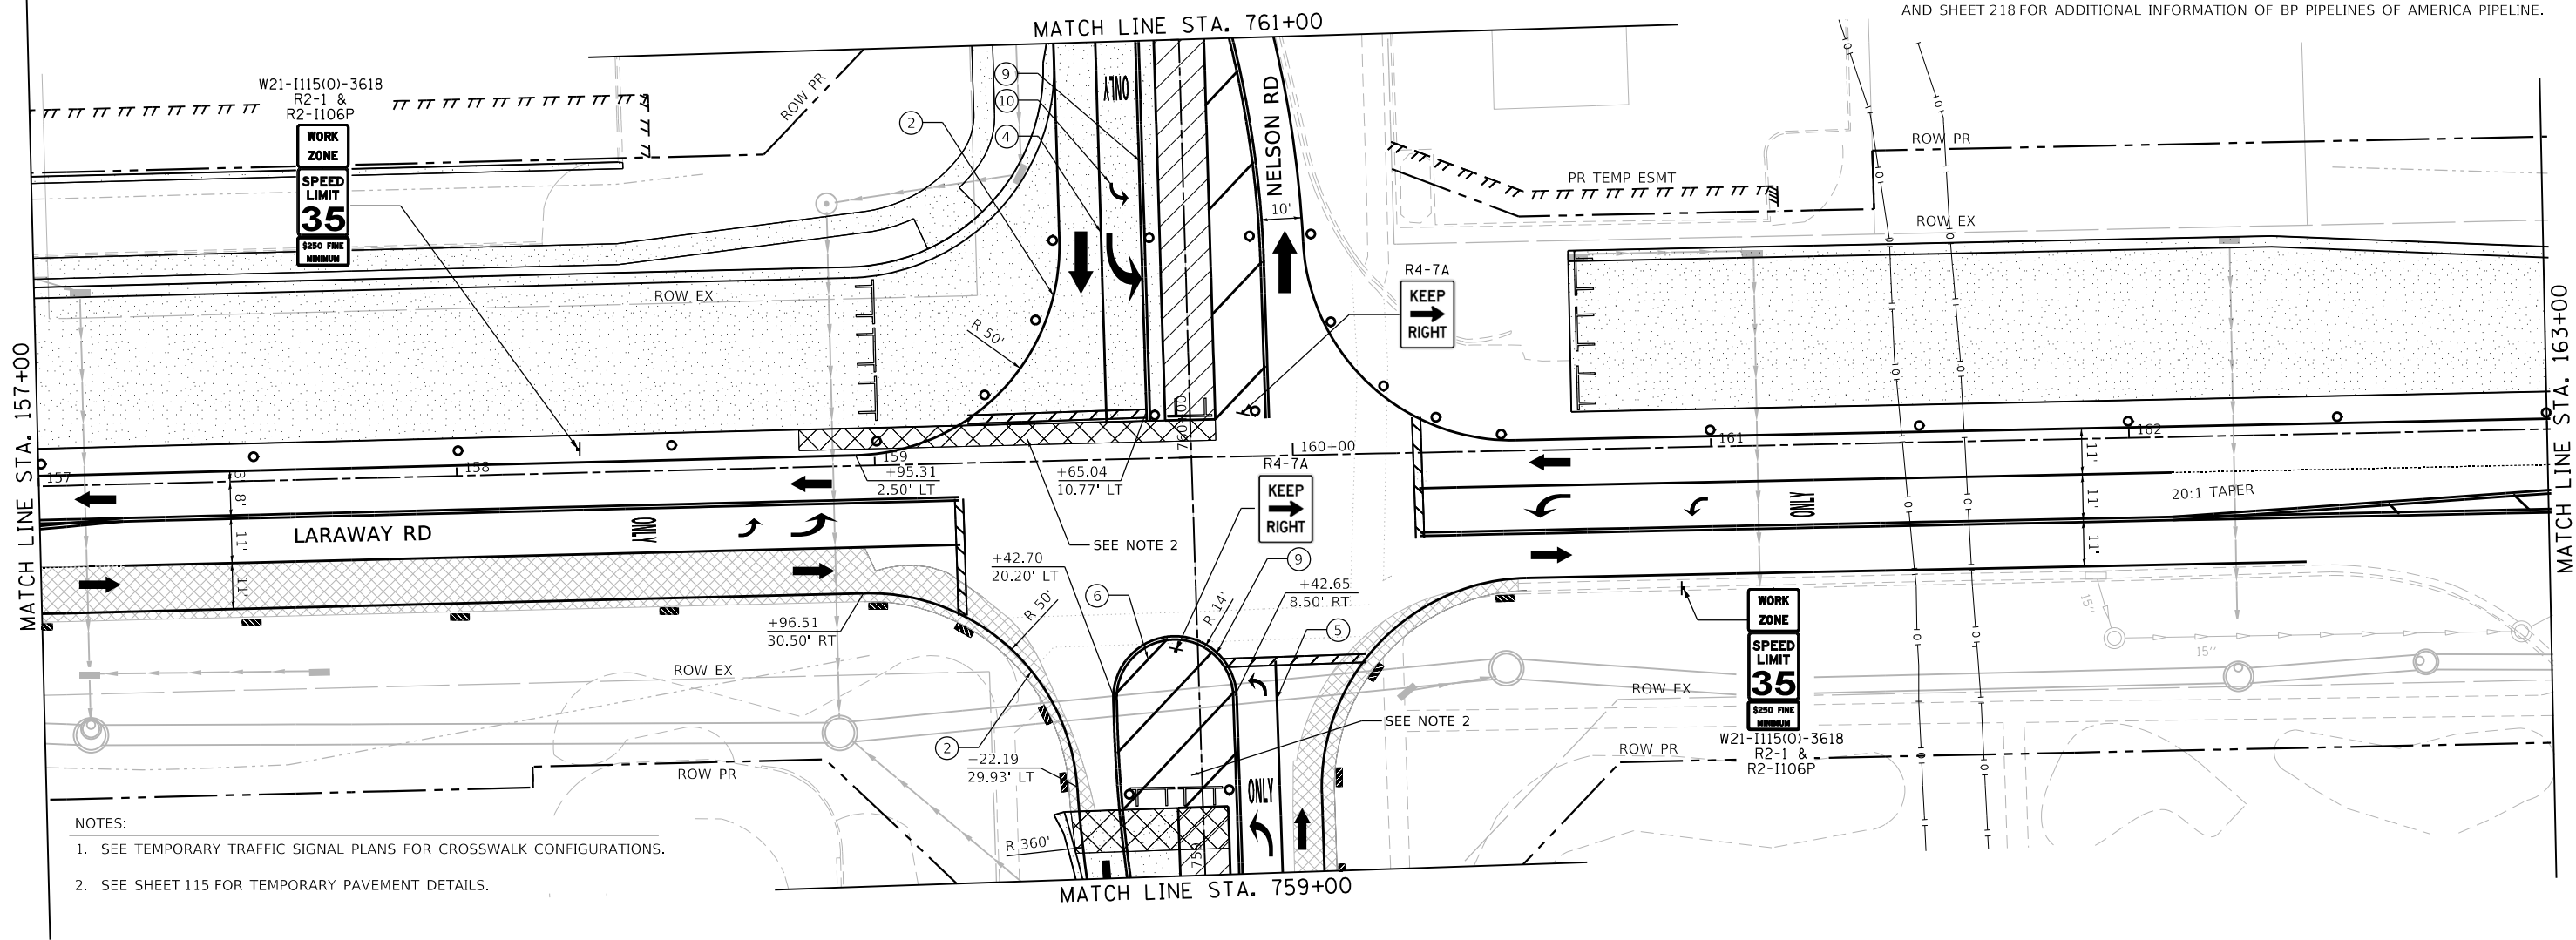
STATE OF ILLINOIS
DEPARTMENT OF TRANSPORTATION

SUGGESTED SEQUENCE OF CONSTRUCTION
LARAWAY RD - STAGE 1B
SCALE: 1"=20'
SHEET 2 OF 7 SHEETS
STA. 146+00 TO STA. 157+00

F.A.U. RTE.	SECTION	COUNTY	TOTAL SHEETS	SHEET NO.
0320	13-00138-37-PV	WILL	413	107
CONTRACT NO. 61H20				
ILLINOIS FED. AID PROJECT				

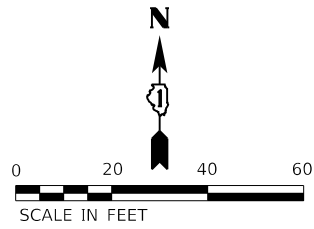

- PIPELINE STAGING NOTES:**
- CONTRACTOR MUST CONTACT PIPELINE COMPANIES TO COORDINATE ALL WORK IN THE VICINITY OF THE PIPELINES. CONTRACTOR MUST FOLLOW ALL REQUIREMENTS OF THESE PLANS, SPECIFICATIONS, PIPELINE ENCROACHMENT GUIDELINES, AND ANY OTHER REQUIREMENTS COMMUNICATED BY PIPELINE COMPANY REPRESENTATIVES REGARDING WORK AROUND THE PIPELINES.
- BP PIPELINES OF AMERICA**
STEVE ADAMS
OFFICE: 779.801.4969
EMAIL: steve.adams@bp.com
- ENTERPRISE PRODUCTS**
BLAKE HAMILTON
OFFICE: 815.277.7286
CELL: 217.508.2991
EMAIL: bdhamilton@eprod.com
- TEMPORARY FENCE SHALL BE REPOSITIONED TO A LOCATION APPROVED BY THE ENGINEER AND THE PIPELINE REPRESENTATIVES TO LIMIT EQUIPMENT CROSSING TO A 15' WIDE OPENING PERPENDICULAR TO PIPELINES. 5' GAP IN FENCE IS PERMITTED TO ALLOW PEDESTRAIN PASSAGE.
 - SEE SHEET 217 FOR ADDITIONAL INFORMATION ON ENTERPRISE PRODUCTS PIPELINE AND SHEET 218 FOR ADDITIONAL INFORMATION OF BP PIPELINES OF AMERICA PIPELINE.



- NOTES:**
- SEE TEMPORARY TRAFFIC SIGNAL PLANS FOR CROSSWALK CONFIGURATIONS.
 - SEE SHEET 115 FOR TEMPORARY PAVEMENT DETAILS.

LEGEND

VERTICAL PANEL WITH STEADY BURN LIGHT AS REQUIRED BY SPECIFICATIONS. (50' C-C TYP., 25' C-C ON TAPERS & CURVES)	TEMPORARY PAVEMENT WIDENING CONSTRUCTED CURRENT STAGE	TEMPORARY PAVEMENT MARKINGS
DRUM WITH STEADY-BURN LIGHT AS REQUIRED BY SPECIFICATIONS. (50' C-C TYP., 25' C-C ON TAPERS & CURVES)	TEMPORARY PAVEMENT WIDENING CONSTRUCTED PREVIOUS STAGE	① 4" YELLOW (SOLID)
TYPE III BARRICADE WITH STEADY-BURN LIGHT AS REQUIRED BY SPECIFICATIONS.	COMPLETED PAVEMENT (TO TOP OF BINDER COURSE)	② 4" WHITE (SOLID)
TEMPORARY CONCRETE BARRIER WITH TYPE C REFLECTOR	WORK ZONE	③ 4" WHITE (SKIP-DASH)
DIRECTION OF TRAFFIC	PAVEMENT PATCHING CLASS D (SEE PVMT PATCH DETAIL SHEETS)	④ 6" WHITE (2' DASH, 6' SKIP)
STORM SEWER CONSTRUCTED THIS STAGE	TEMPORARY ACCESS	⑤ 6" WHITE (SOLID)
STORM SEWER CONSTRUCTED PREVIOUS STAGE		⑥ 12" YELLOW (DIAGONALS) 30' C-C @45°
		⑦ 12" WHITE (DIAGONALS)
		⑧ 24" WHITE (STOP BAR)
		⑨ 4" DOUBLE YELLOW (SOLID) @11" C-C
		⑩ LETTERS & SYMBOLS



FILE NAME =	sht-staging-stage01B-03.dgn	DESIGNED -	BRF	REVISED -	
MODEL NAME =	Default	DRAWN -	BRF	REVISED -	
PLOT SCALE =	40.0018' / ft.	CHECKED -	JMS	REVISED -	
PLOT DATE =	9/9/2022 - 12:15:17 PM	DATE -	09/09/2022	REVISED -	

**STATE OF ILLINOIS
DEPARTMENT OF TRANSPORTATION**

**SUGGESTED SEQUENCE OF CONSTRUCTION
LARAWAY RD - STAGE 1B**





SCALE: 1"=20' SHEET 3 OF 7 SHEETS STA. 157+00 TO STA. 163+00

F.A.U. RTE.	SECTION	COUNTY	TOTAL SHEETS	SHEET NO.
0320	13-00138-37-PV	WILL	413	108
CONTRACT NO. 61H20				
		ILLINOIS	FED. AID PROJECT	

PLOT DRIVER = jpl\NOLA\ERS\sw_dwg
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PLOT SCALE = 40.0001' / in.
PLOT DATE = 9/9/2022 12:15:19 PM

USER NAME = Mike Moses
DIRECTORY = L:\MILL\CO17204-01\Drawn\CADD_Sheets\

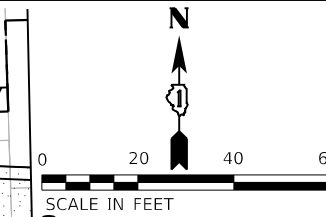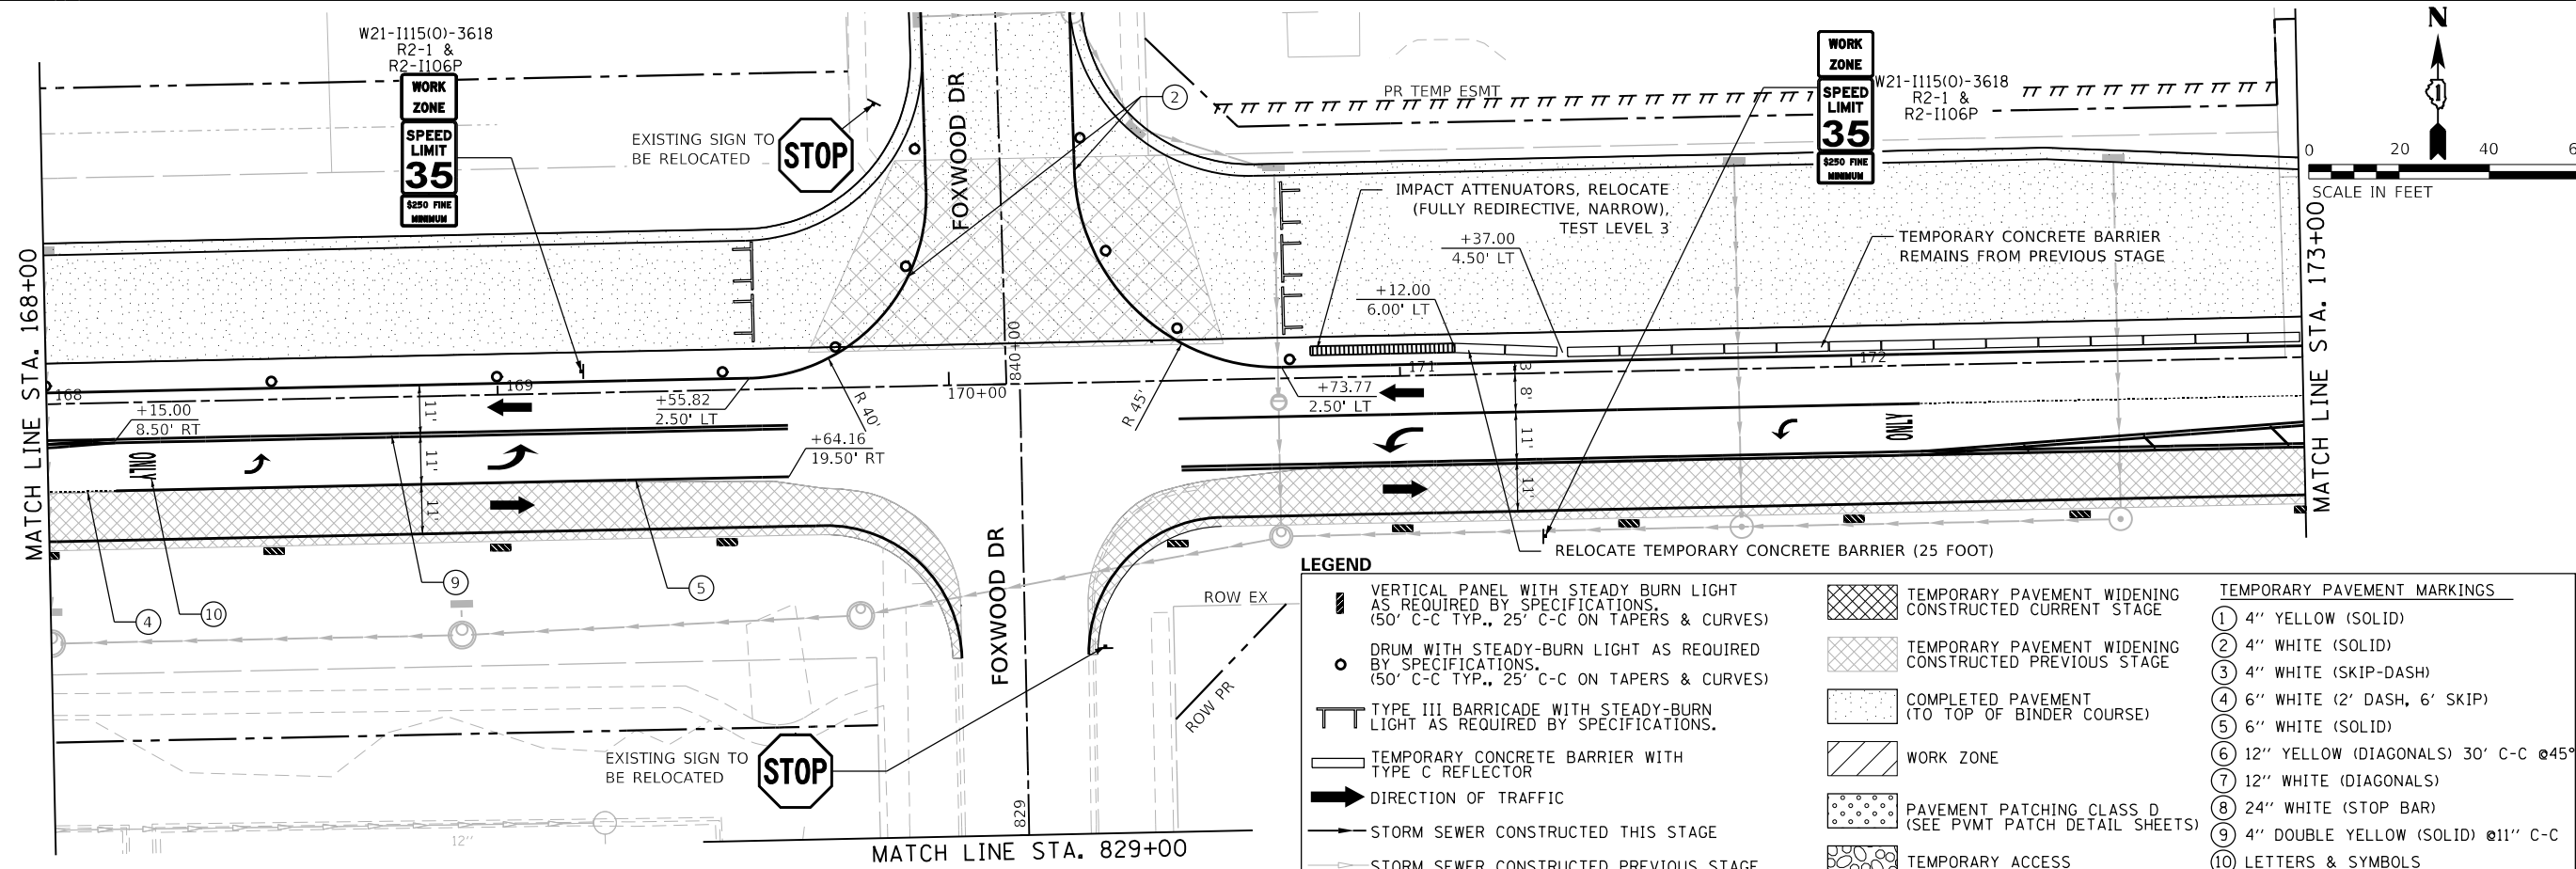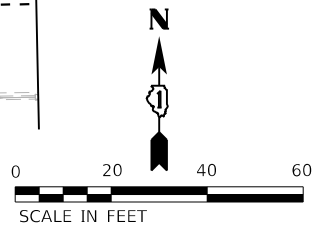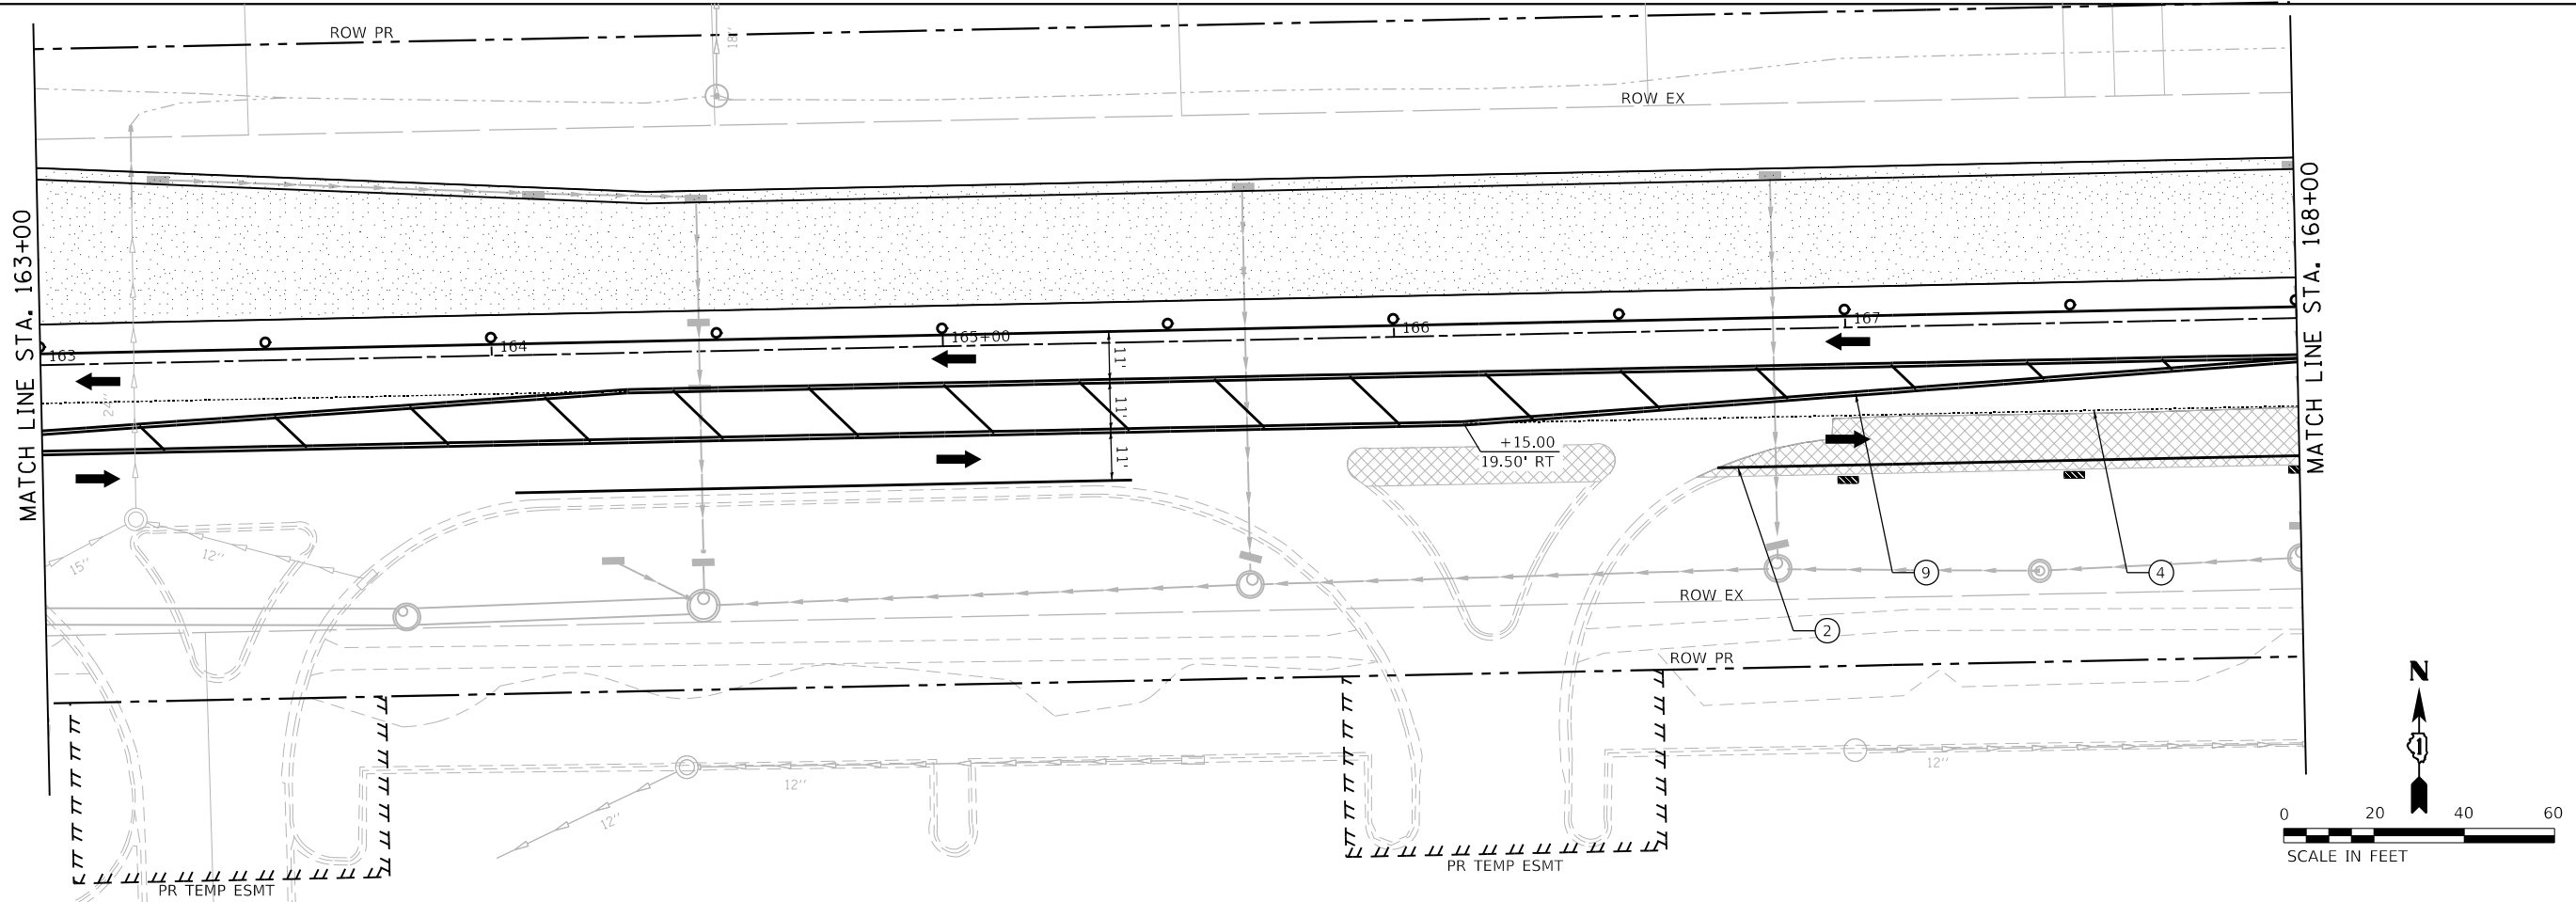

LEGEND		TEMPORARY PAVEMENT MARKINGS	
	VERTICAL PANEL WITH STEADY BURN LIGHT AS REQUIRED BY SPECIFICATIONS. (50' C-C TYP., 25' C-C ON TAPERS & CURVES)		TEMPORARY PAVEMENT WIDENING CONSTRUCTED CURRENT STAGE
	DRUM WITH STEADY-BURN LIGHT AS REQUIRED BY SPECIFICATIONS. (50' C-C TYP., 25' C-C ON TAPERS & CURVES)		TEMPORARY PAVEMENT WIDENING CONSTRUCTED PREVIOUS STAGE
	TYPE III BARRICADE WITH STEADY-BURN LIGHT AS REQUIRED BY SPECIFICATIONS.		COMPLETED PAVEMENT (TO TOP OF BINDER COURSE)
	TEMPORARY CONCRETE BARRIER WITH TYPE C REFLECTOR		WORK ZONE
	DIRECTION OF TRAFFIC		PAVEMENT PATCHING CLASS D (SEE PVMT PATCH DETAIL SHEETS)
	STORM SEWER CONSTRUCTED THIS STAGE		TEMPORARY ACCESS
	STORM SEWER CONSTRUCTED PREVIOUS STAGE		① 4" YELLOW (SOLID)
			② 4" WHITE (SOLID)
			③ 4" WHITE (SKIP-DASH)
			④ 6" WHITE (2' DASH, 6' SKIP)
			⑤ 6" WHITE (SOLID)
			⑥ 12" YELLOW (DIAGONALS) 30' C-C @45°
			⑦ 12" WHITE (DIAGONALS)
			⑧ 24" WHITE (STOP BAR)
			⑨ 4" DOUBLE YELLOW (SOLID) @11" C-C
			⑩ LETTERS & SYMBOLS



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STATE OF ILLINOIS
DEPARTMENT OF TRANSPORTATION


SUGGESTED SEQUENCE OF CONSTRUCTION			
LARAWAY RD - STAGE 1B			
SCALE: 1"=20'	SHEET 4	OF 7 SHEETS	STA. 163+00 TO STA. 173+00

F.A.U. RTE.	SECTION	COUNTY	TOTAL SHEETS	SHEET NO.
0320	13-00138-37-PV	WILL	413	109
CONTRACT NO. 61H20				
ILLINOIS FED. AID PROJECT				

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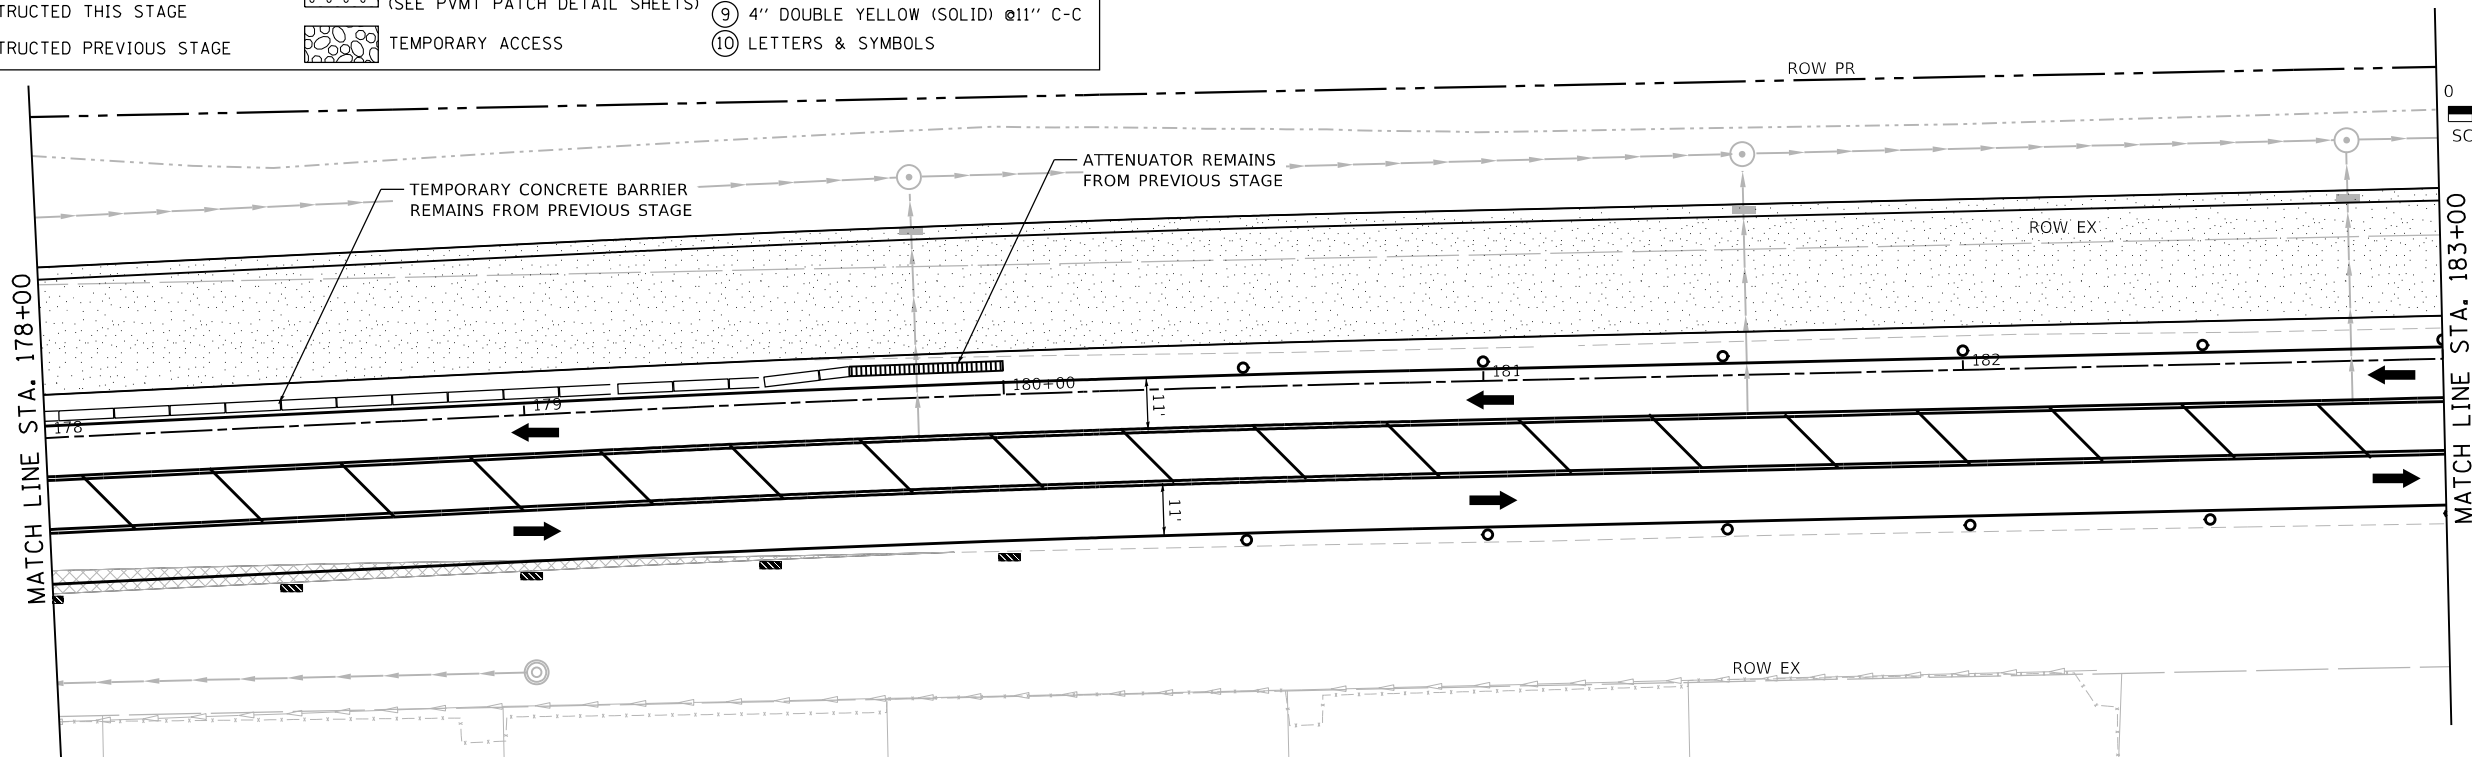
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= 9/9/2022 (12:15:21 PM)

USER NAME
DIRECTORY
= Mike Moses
= L:\M\LAYERS\Drawings

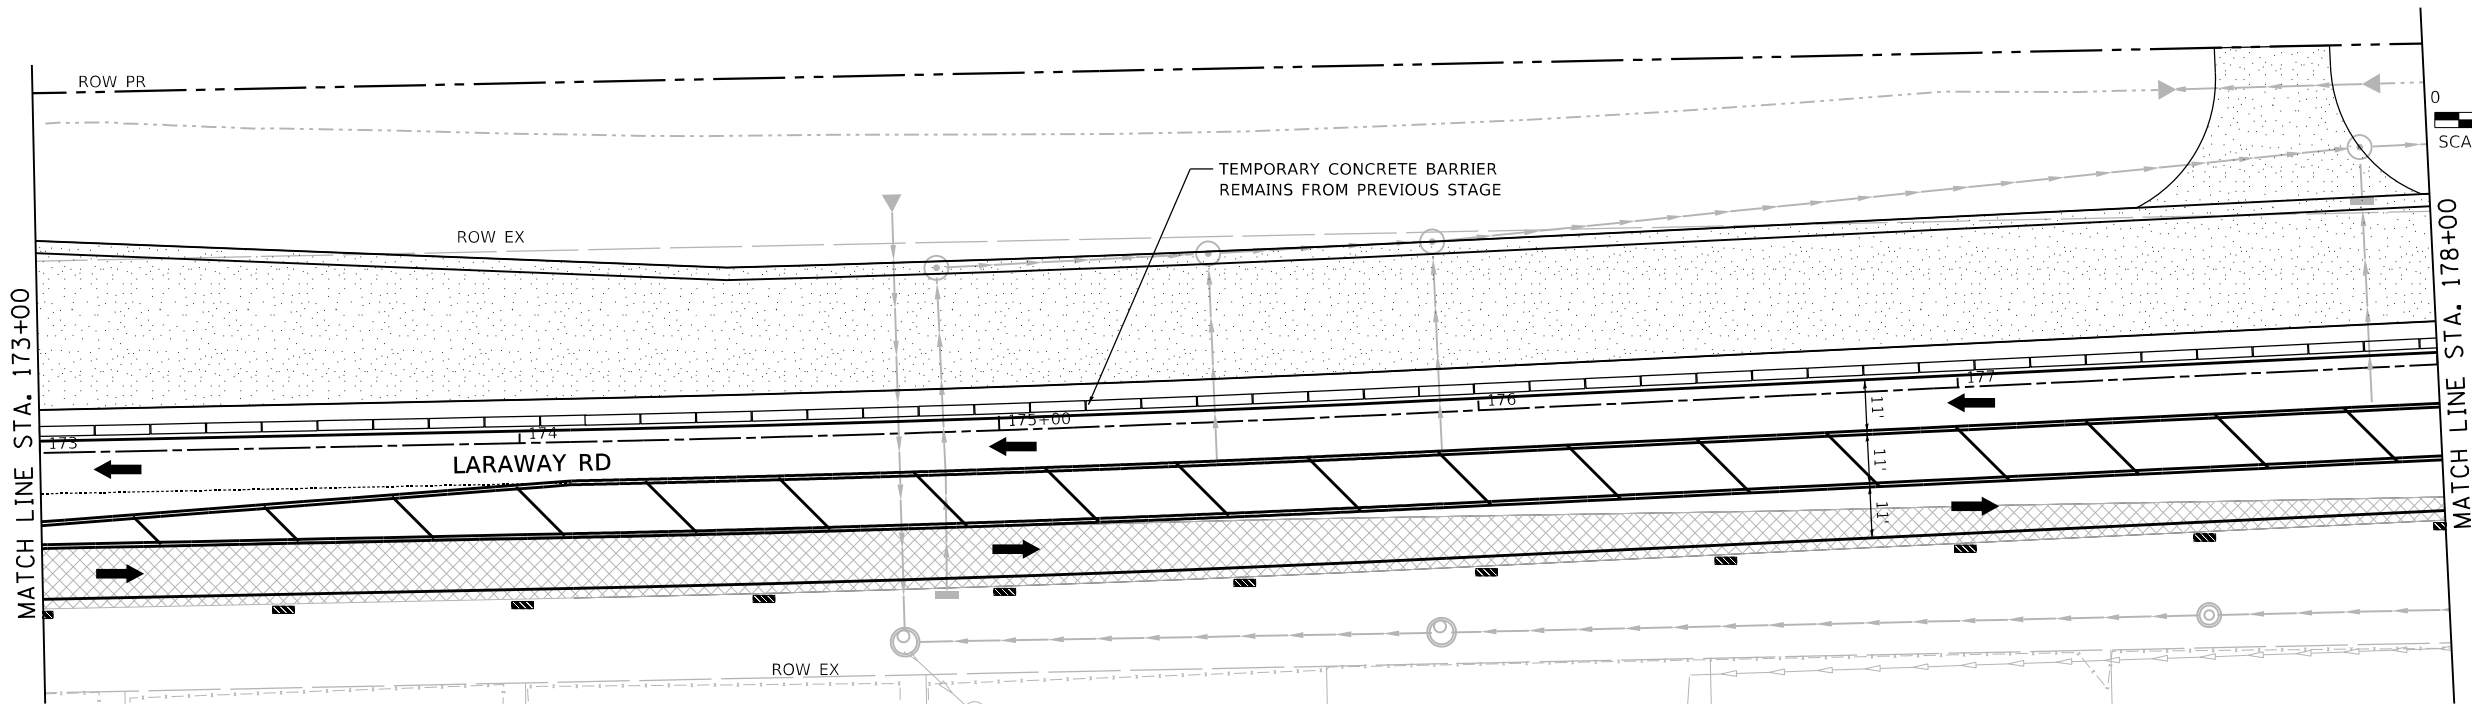

LEGEND

	VERTICAL PANEL WITH STEADY BURN LIGHT AS REQUIRED BY SPECIFICATIONS. (50' C-C TYP., 25' C-C ON TAPERS & CURVES)		TEMPORARY PAVEMENT WIDENING CONSTRUCTED CURRENT STAGE		TEMPORARY PAVEMENT MARKINGS
	DRUM WITH STEADY-BURN LIGHT AS REQUIRED BY SPECIFICATIONS. (50' C-C TYP., 25' C-C ON TAPERS & CURVES)		TEMPORARY PAVEMENT WIDENING CONSTRUCTED PREVIOUS STAGE		① 4" YELLOW (SOLID)
	TYPE III BARRICADE WITH STEADY-BURN LIGHT AS REQUIRED BY SPECIFICATIONS.		COMPLETED PAVEMENT (TO TOP OF BINDER COURSE)		② 4" WHITE (SOLID)
	TEMPORARY CONCRETE BARRIER WITH TYPE C REFLECTOR		WORK ZONE		③ 4" WHITE (SKIP-DASH)
	DIRECTION OF TRAFFIC		PAVEMENT PATCHING CLASS D (SEE PVMT PATCH DETAIL SHEETS)		④ 6" WHITE (2' DASH, 6' SKIP)
	STORM SEWER CONSTRUCTED THIS STAGE		TEMPORARY ACCESS		⑤ 6" WHITE (SOLID)
	STORM SEWER CONSTRUCTED PREVIOUS STAGE				⑥ 12" YELLOW (DIAGONALS) 30' C-C @45°
					⑦ 12" WHITE (DIAGONALS)
					⑧ 24" WHITE (STOP BAR)
					⑨ 4" DOUBLE YELLOW (SOLID) @11" C-C
					⑩ LETTERS & SYMBOLS







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STATE OF ILLINOIS
DEPARTMENT OF TRANSPORTATION

SUGGESTED SEQUENCE OF CONSTRUCTION
LARAWAY RD - STAGE 1B

SCALE: 1"=20' SHEET 5 OF 7 SHEETS STA. 173+00 TO STA. 183+00

F.A.U. RTE.	SECTION	COUNTY	TOTAL SHEETS	SHEET NO.
0320	13-00138-37-PV	WILL	413	110
CONTRACT NO. 61H20				
ILLINOIS FED. AID PROJECT				

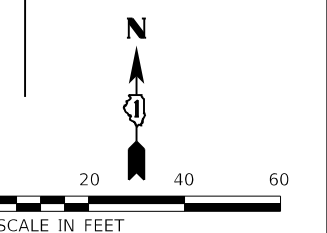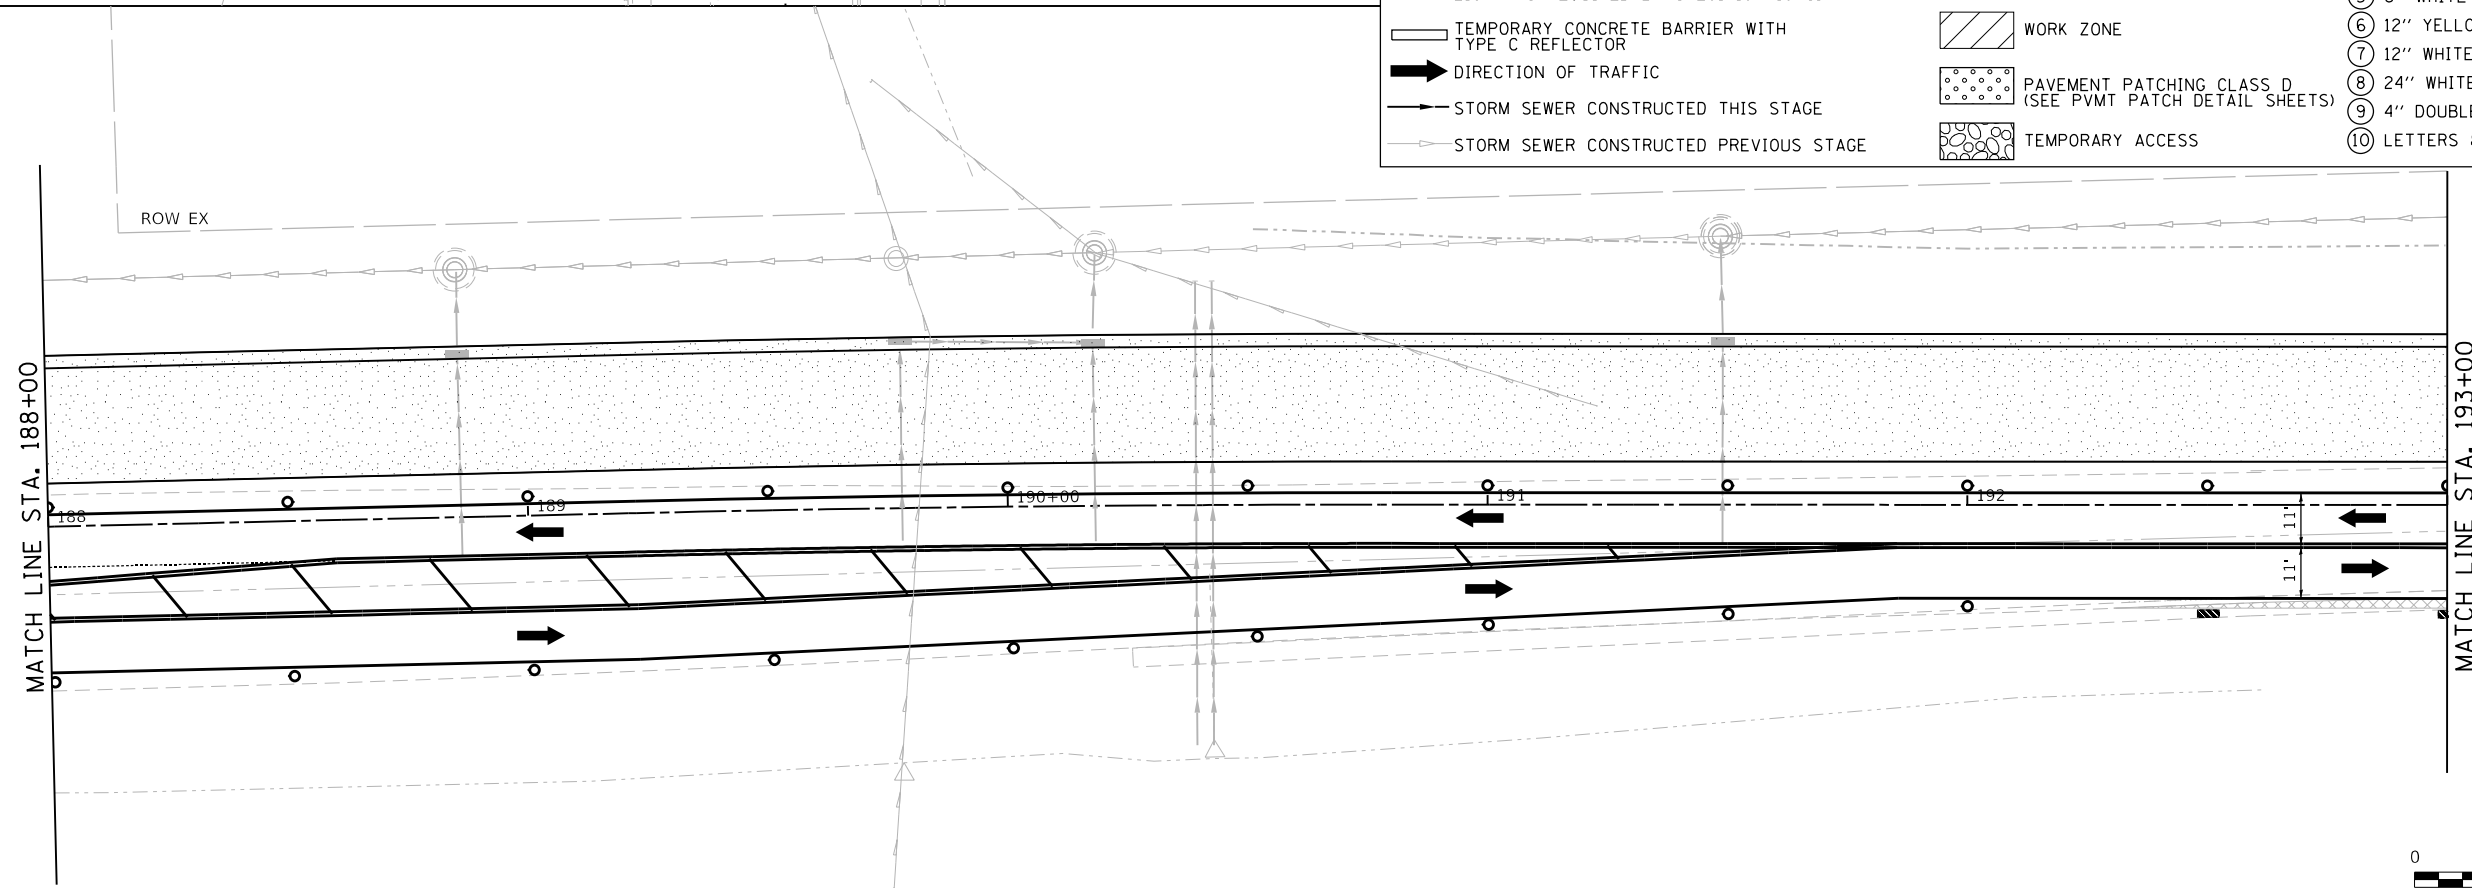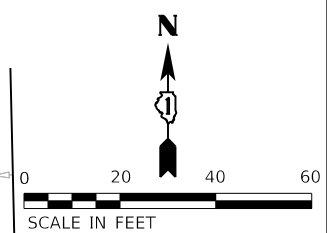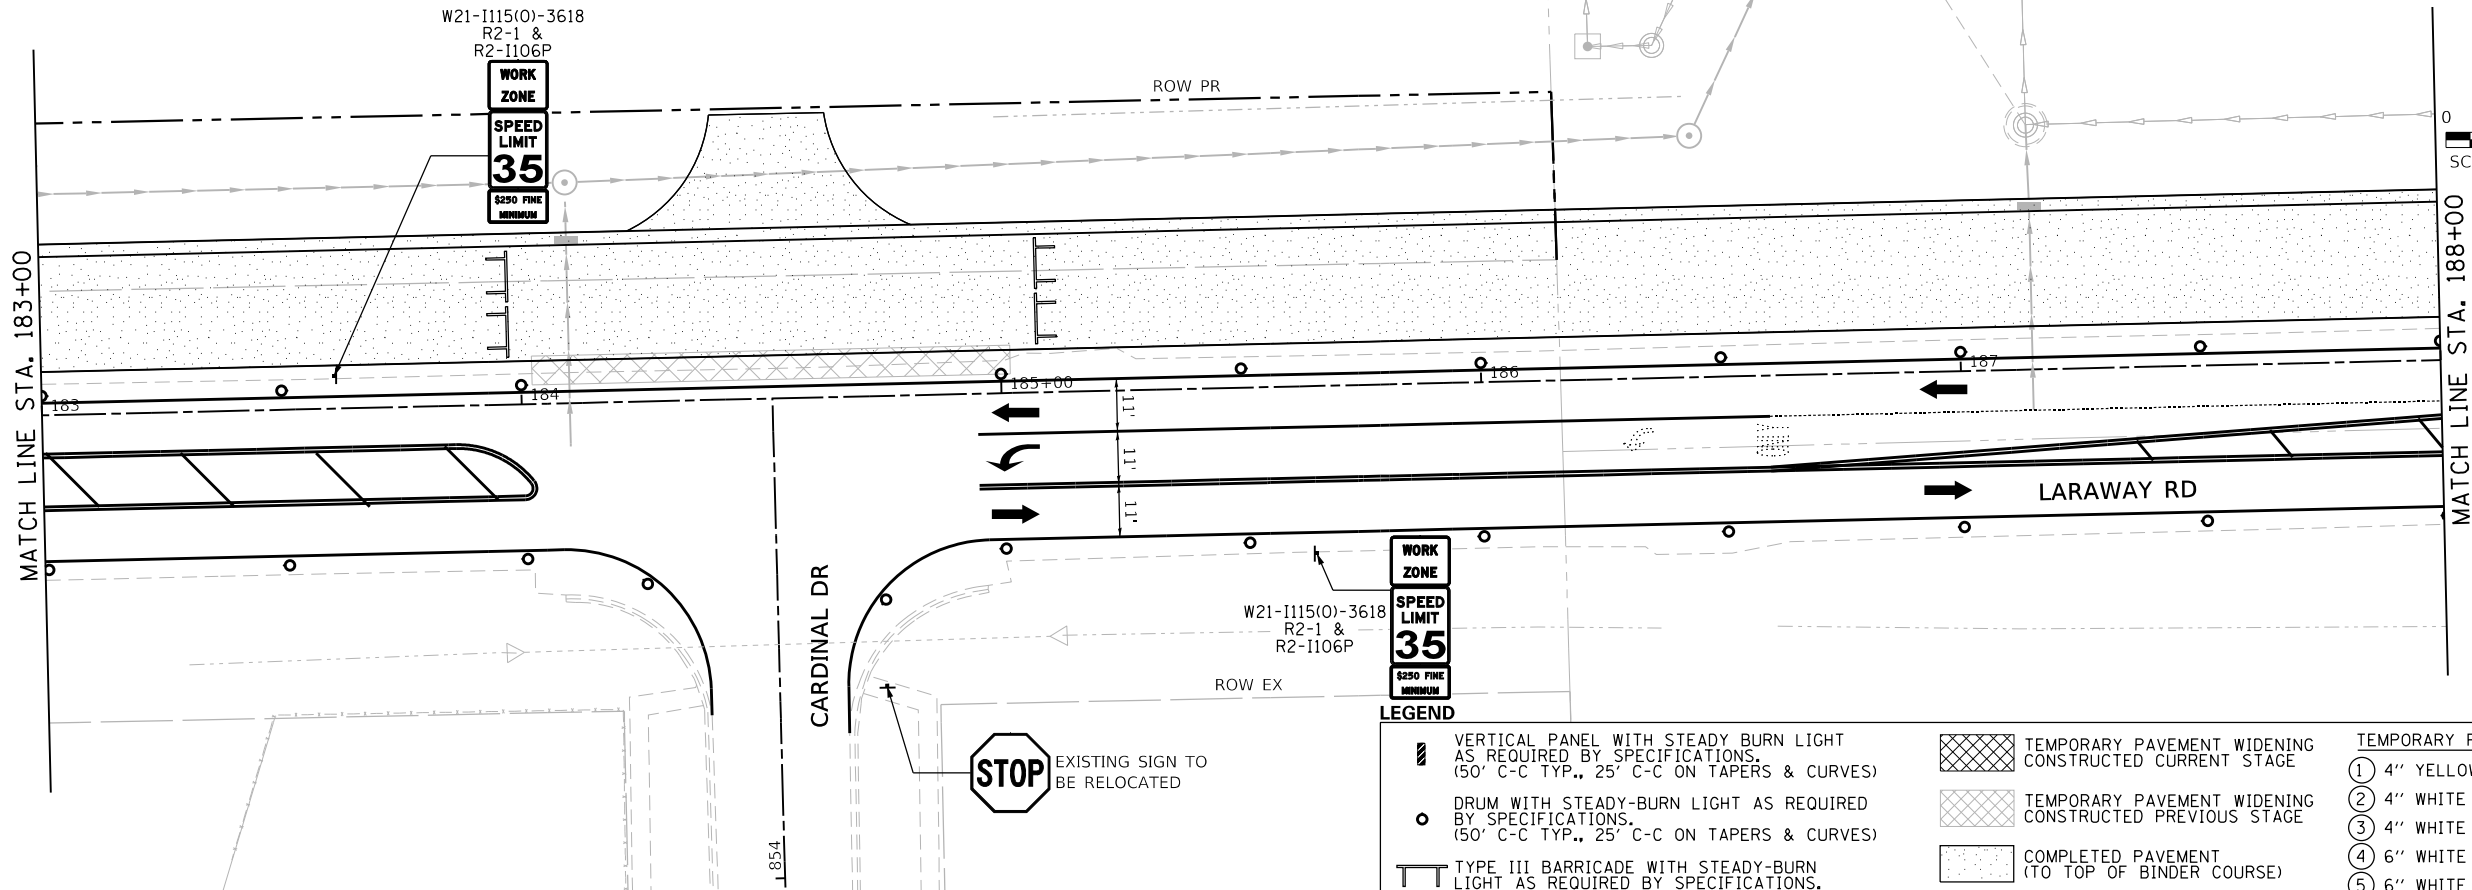

LEGEND

VERTICAL PANEL WITH STEADY BURN LIGHT AS REQUIRED BY SPECIFICATIONS. (50' C-C TYP., 25' C-C ON TAPERS & CURVES)	TEMPORARY PAVEMENT WIDENING CONSTRUCTED CURRENT STAGE	TEMPORARY PAVEMENT MARKINGS
DRUM WITH STEADY-BURN LIGHT AS REQUIRED BY SPECIFICATIONS. (50' C-C TYP., 25' C-C ON TAPERS & CURVES)	TEMPORARY PAVEMENT WIDENING CONSTRUCTED PREVIOUS STAGE	① 4" YELLOW (SOLID)
TYPE III BARRICADE WITH STEADY-BURN LIGHT AS REQUIRED BY SPECIFICATIONS.	COMPLETED PAVEMENT (TO TOP OF BINDER COURSE)	② 4" WHITE (SOLID)
TEMPORARY CONCRETE BARRIER WITH TYPE C REFLECTOR	WORK ZONE	③ 4" WHITE (SKIP-DASH)
DIRECTION OF TRAFFIC	PAVEMENT PATCHING CLASS D (SEE PVMT PATCH DETAIL SHEETS)	④ 6" WHITE (2' DASH, 6' SKIP)
STORM SEWER CONSTRUCTED THIS STAGE	TEMPORARY ACCESS	⑤ 6" WHITE (SOLID)
STORM SEWER CONSTRUCTED PREVIOUS STAGE		⑥ 12" YELLOW (DIAGONALS) 30' C-C @45°
		⑦ 12" WHITE (DIAGONALS)
		⑧ 24" WHITE (STOP BAR)
		⑨ 4" DOUBLE YELLOW (SOLID) @11" C-C
		⑩ LETTERS & SYMBOLS

**STATE OF ILLINOIS
DEPARTMENT OF TRANSPORTATION**

**SUGGESTED SEQUENCE OF CONSTRUCTION
LARAWAY RD - STAGE 1B**

SCALE: 1"=20' SHEET 6 OF 7 SHEETS STA. 183+00 TO STA. 193+00

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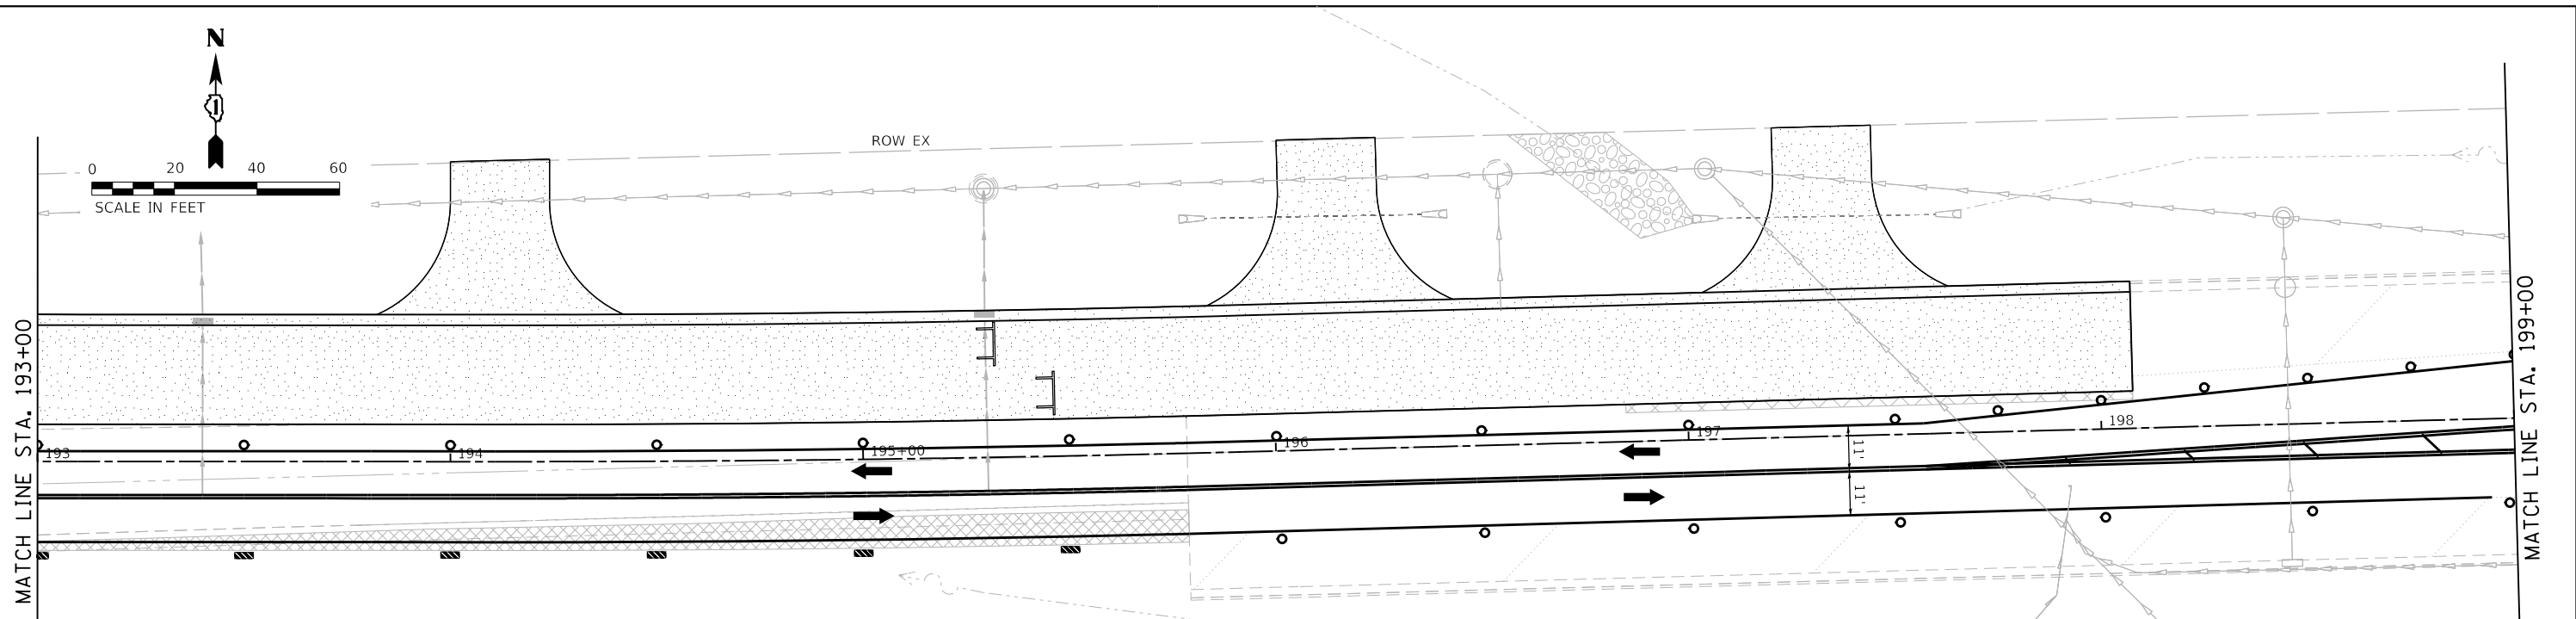
F.A.U. RTE. 0320	SECTION 13-00138-37-PV	COUNTY WILL	TOTAL SHEETS 413	SHEET NO. 111
CONTRACT NO. 61H20				
ILLINOIS FED. AID PROJECT				



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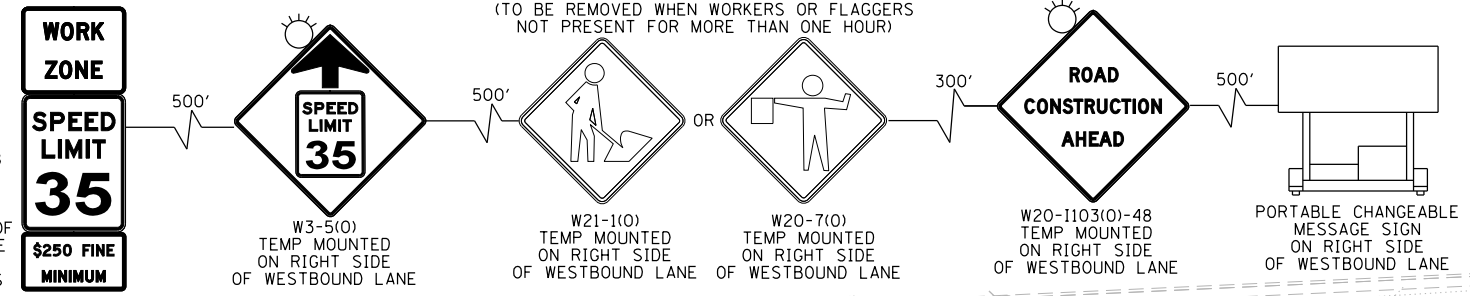
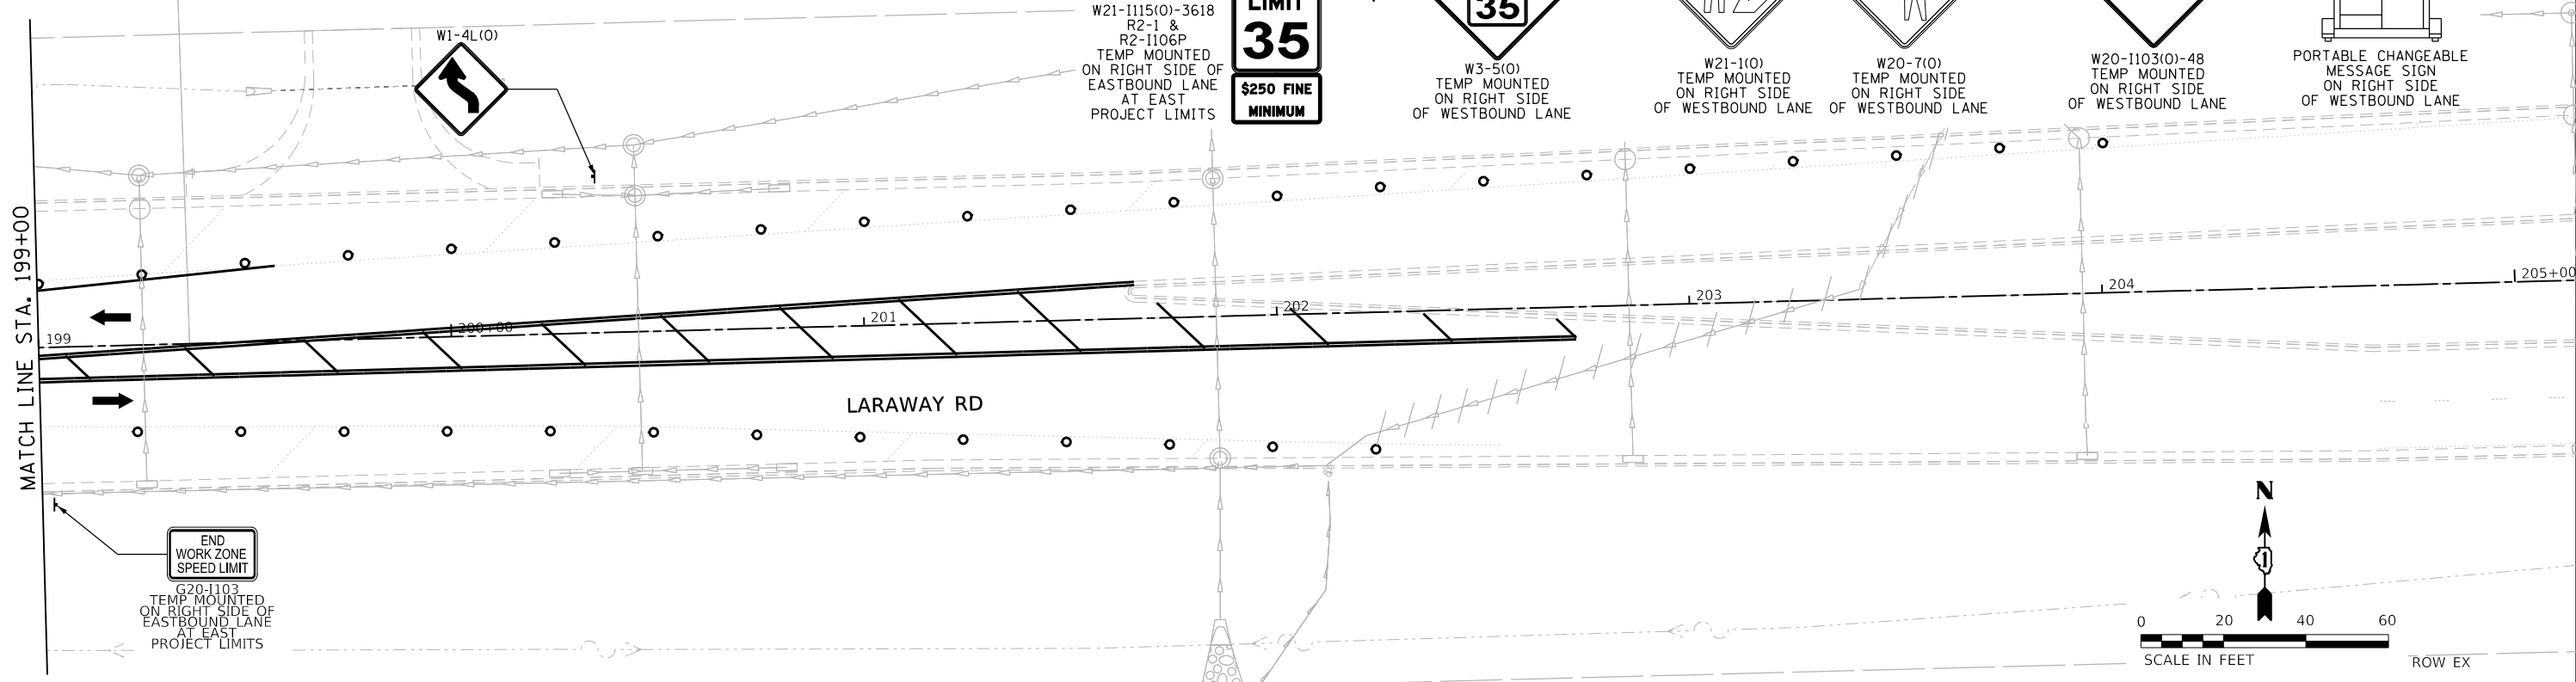
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USER NAME = Mike Moos
DIRECTORY = L:\MILL\017204-01\Draw\CADD_Sheets\



LEGEND

VERTICAL PANEL WITH STEADY BURN LIGHT AS REQUIRED BY SPECIFICATIONS. (50' C-C TYP., 25' C-C ON TAPERS & CURVES)	TEMPORARY PAVEMENT WIDENING CONSTRUCTED CURRENT STAGE	TEMPORARY PAVEMENT MARKINGS
DRUM WITH STEADY-BURN LIGHT AS REQUIRED BY SPECIFICATIONS. (50' C-C TYP., 25' C-C ON TAPERS & CURVES)	TEMPORARY PAVEMENT WIDENING CONSTRUCTED PREVIOUS STAGE	① 4" YELLOW (SOLID)
TYPE III BARRICADE WITH STEADY-BURN LIGHT AS REQUIRED BY SPECIFICATIONS.	COMPLETED PAVEMENT (TO TOP OF BINDER COURSE)	② 4" WHITE (SOLID)
TEMPORARY CONCRETE BARRIER WITH TYPE C REFLECTOR	WORK ZONE	③ 4" WHITE (SKIP-DASH)
DIRECTION OF TRAFFIC	PAVEMENT PATCHING CLASS D (SEE PVMT PATCH DETAIL SHEETS)	④ 6" WHITE (2' DASH, 6' SKIP)
STORM SEWER CONSTRUCTED THIS STAGE	TEMPORARY ACCESS	⑤ 6" WHITE (SOLID)
STORM SEWER CONSTRUCTED PREVIOUS STAGE		⑥ 12" YELLOW (DIAGONALS) 30' C-C @45°
		⑦ 12" WHITE (DIAGONALS)
		⑧ 24" WHITE (STOP BAR)
		⑨ 4" DOUBLE YELLOW (SOLID) @11" C-C
		⑩ LETTERS & SYMBOLS



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	MODEL NAME = Default	DRAWN - BRF	REVISED -
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**STATE OF ILLINOIS
DEPARTMENT OF TRANSPORTATION**

**SUGGESTED SEQUENCE OF CONSTRUCTION
LARAWAY RD - STAGE 1B**


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F.A.U. RTE.	SECTION	COUNTY	TOTAL SHEETS	SHEET NO.
0320	13-00138-37-PV	WILL	413	112
CONTRACT NO. 61H20				
ILLINOIS FED. AID PROJECT				



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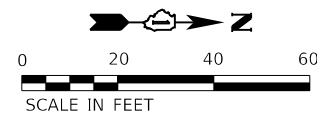


MATCH LINE STA. 636+00




LEGEND

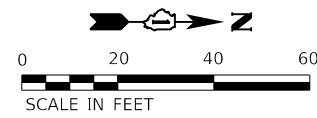	VERTICAL PANEL WITH STEADY BURN LIGHT AS REQUIRED BY SPECIFICATIONS. (50' C-C TYP., 25' C-C ON TAPERS & CURVES)		TEMPORARY PAVEMENT WIDENING CONSTRUCTED CURRENT STAGE	TEMPORARY PAVEMENT MARKINGS	
	DRUM WITH STEADY-BURN LIGHT AS REQUIRED BY SPECIFICATIONS. (50' C-C TYP., 25' C-C ON TAPERS & CURVES)		TEMPORARY PAVEMENT WIDENING CONSTRUCTED PREVIOUS STAGE	①	4" YELLOW (SOLID)
	TYPE III BARRICADE WITH STEADY-BURN LIGHT AS REQUIRED BY SPECIFICATIONS.		COMPLETED PAVEMENT (TO TOP OF BINDER COURSE)	②	4" WHITE (SOLID)
	TEMPORARY CONCRETE BARRIER WITH TYPE C REFLECTOR		WORK ZONE	③	4" WHITE (SKIP-DASH)
	DIRECTION OF TRAFFIC		PAVEMENT PATCHING CLASS D (SEE PVMT PATCH DETAIL SHEETS)	④	6" WHITE (2' DASH, 6' SKIP)
	STORM SEWER CONSTRUCTED THIS STAGE		TEMPORARY ACCESS	⑤	6" WHITE (SOLID)
	STORM SEWER CONSTRUCTED PREVIOUS STAGE			⑥	12" YELLOW (DIAGONALS) 30' C-C @45°
				⑦	12" WHITE (DIAGONALS)
				⑧	24" WHITE (STOP BAR)
				⑨	4" DOUBLE YELLOW (SOLID) @11" C-C
				⑩	LETTERS & SYMBOLS

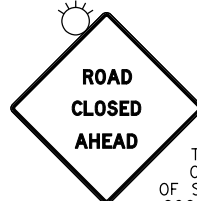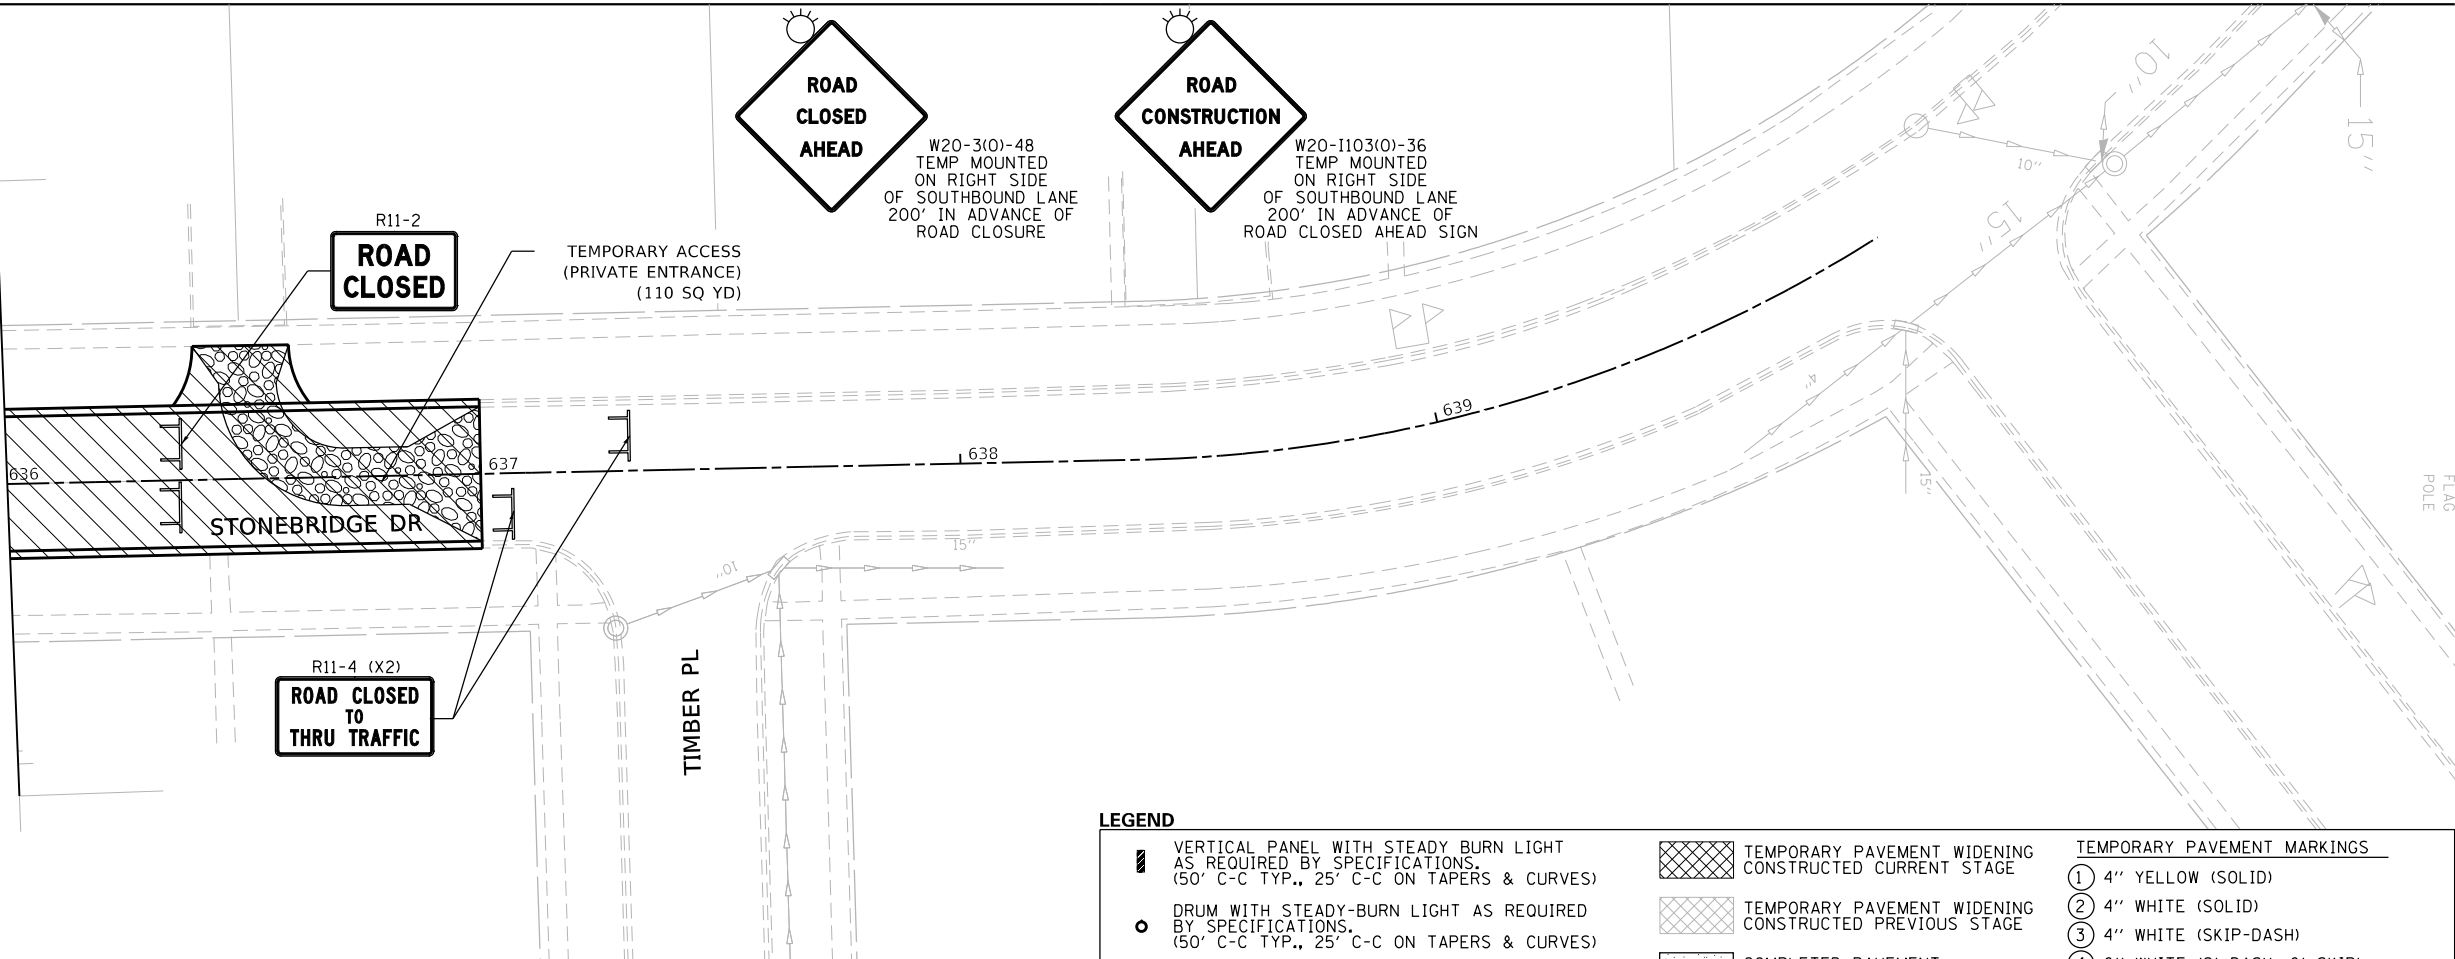

MATCH LINE STA. 691+00

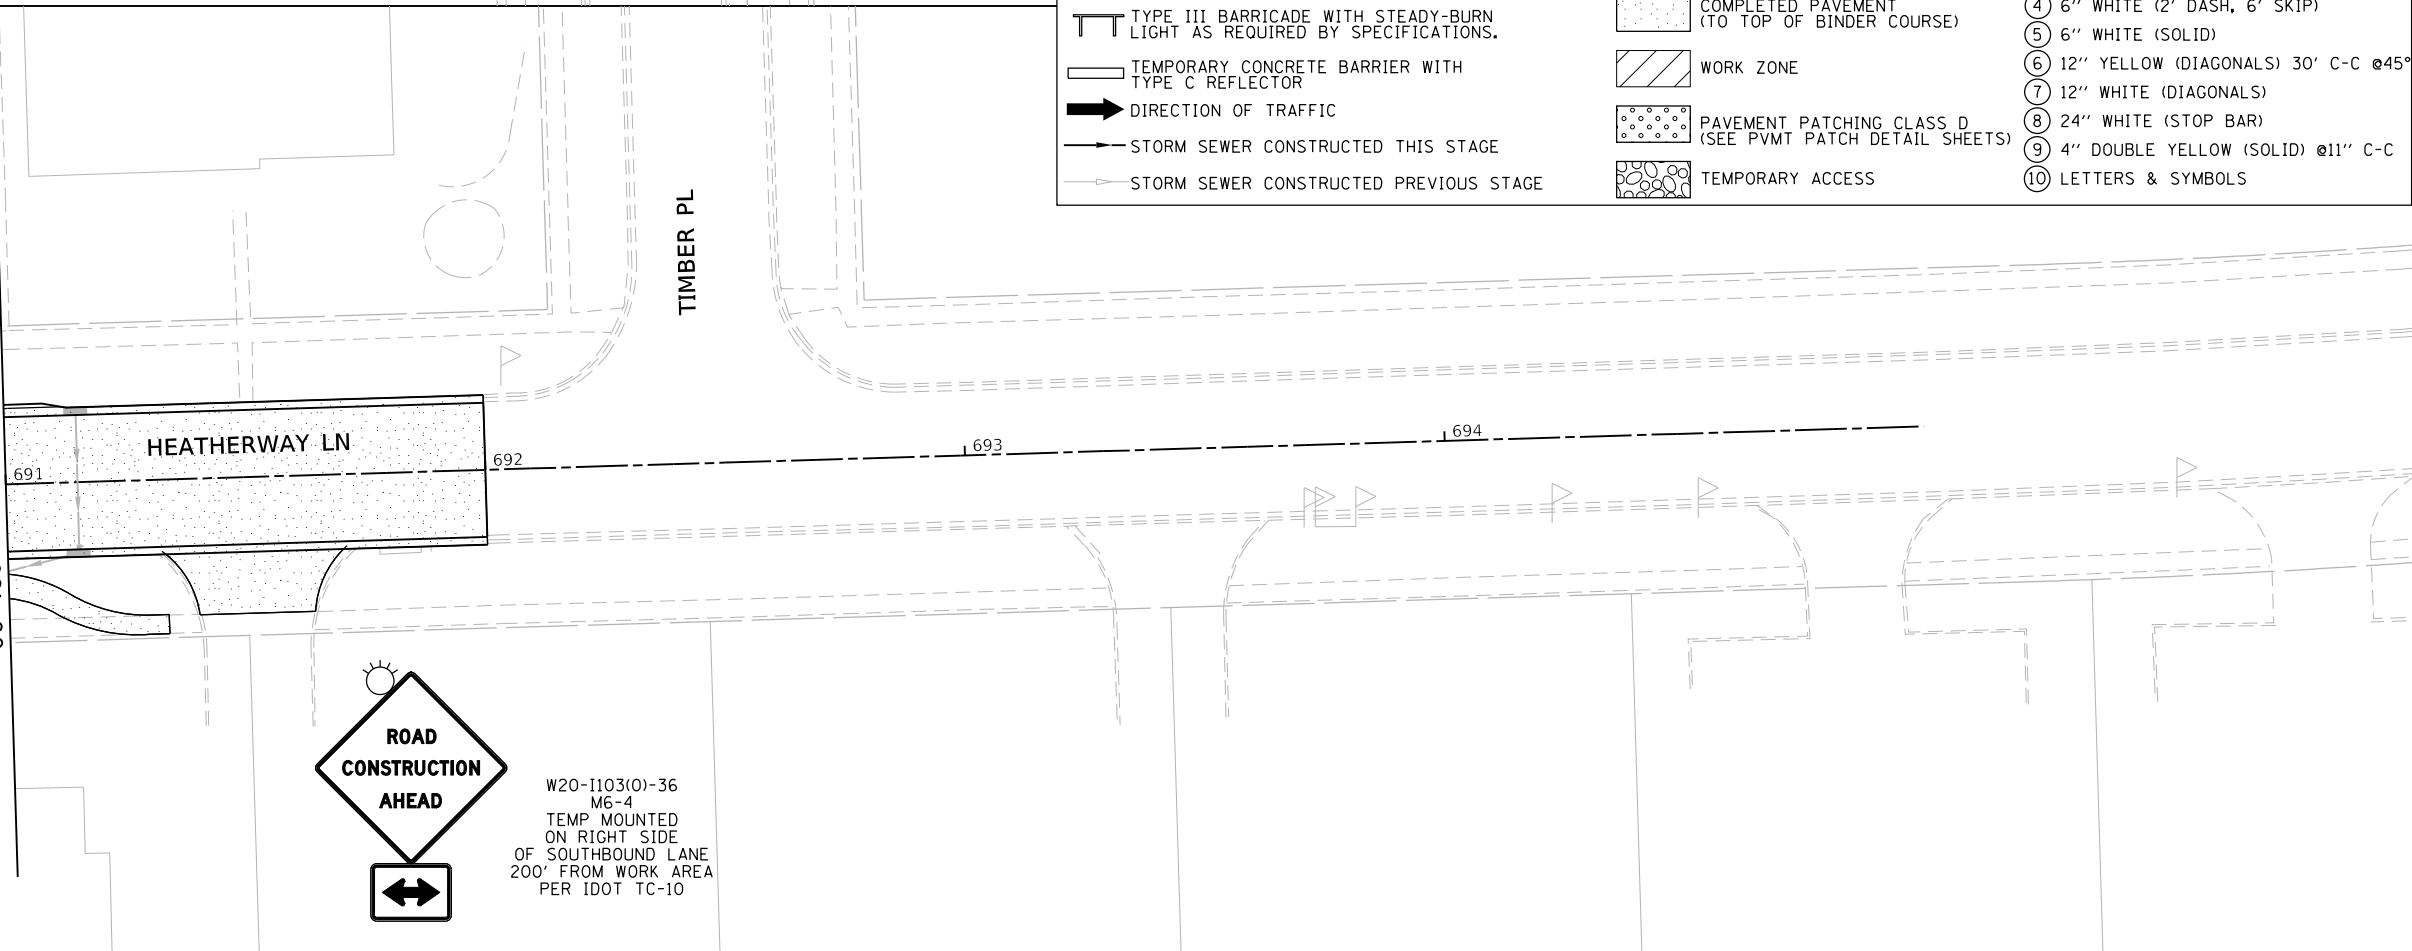

STATE OF ILLINOIS
DEPARTMENT OF TRANSPORTATION

SUGGESTED SEQUENCE OF CONSTRUCTION
STONEBRIDGE DR / HEATHERWAY LN - STAGE 1B

SCALE: 1"=20' SHEET 1 OF 1 SHEETS STA. TO STA.

F.A.U. RTE.	SECTION	COUNTY	TOTAL SHEETS	SHEET NO.
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CONTRACT NO. 61H20				
ILLINOIS FED. AID PROJECT				






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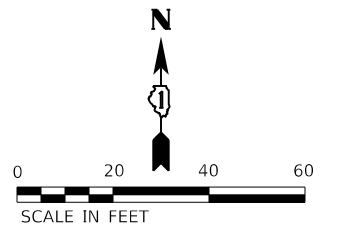
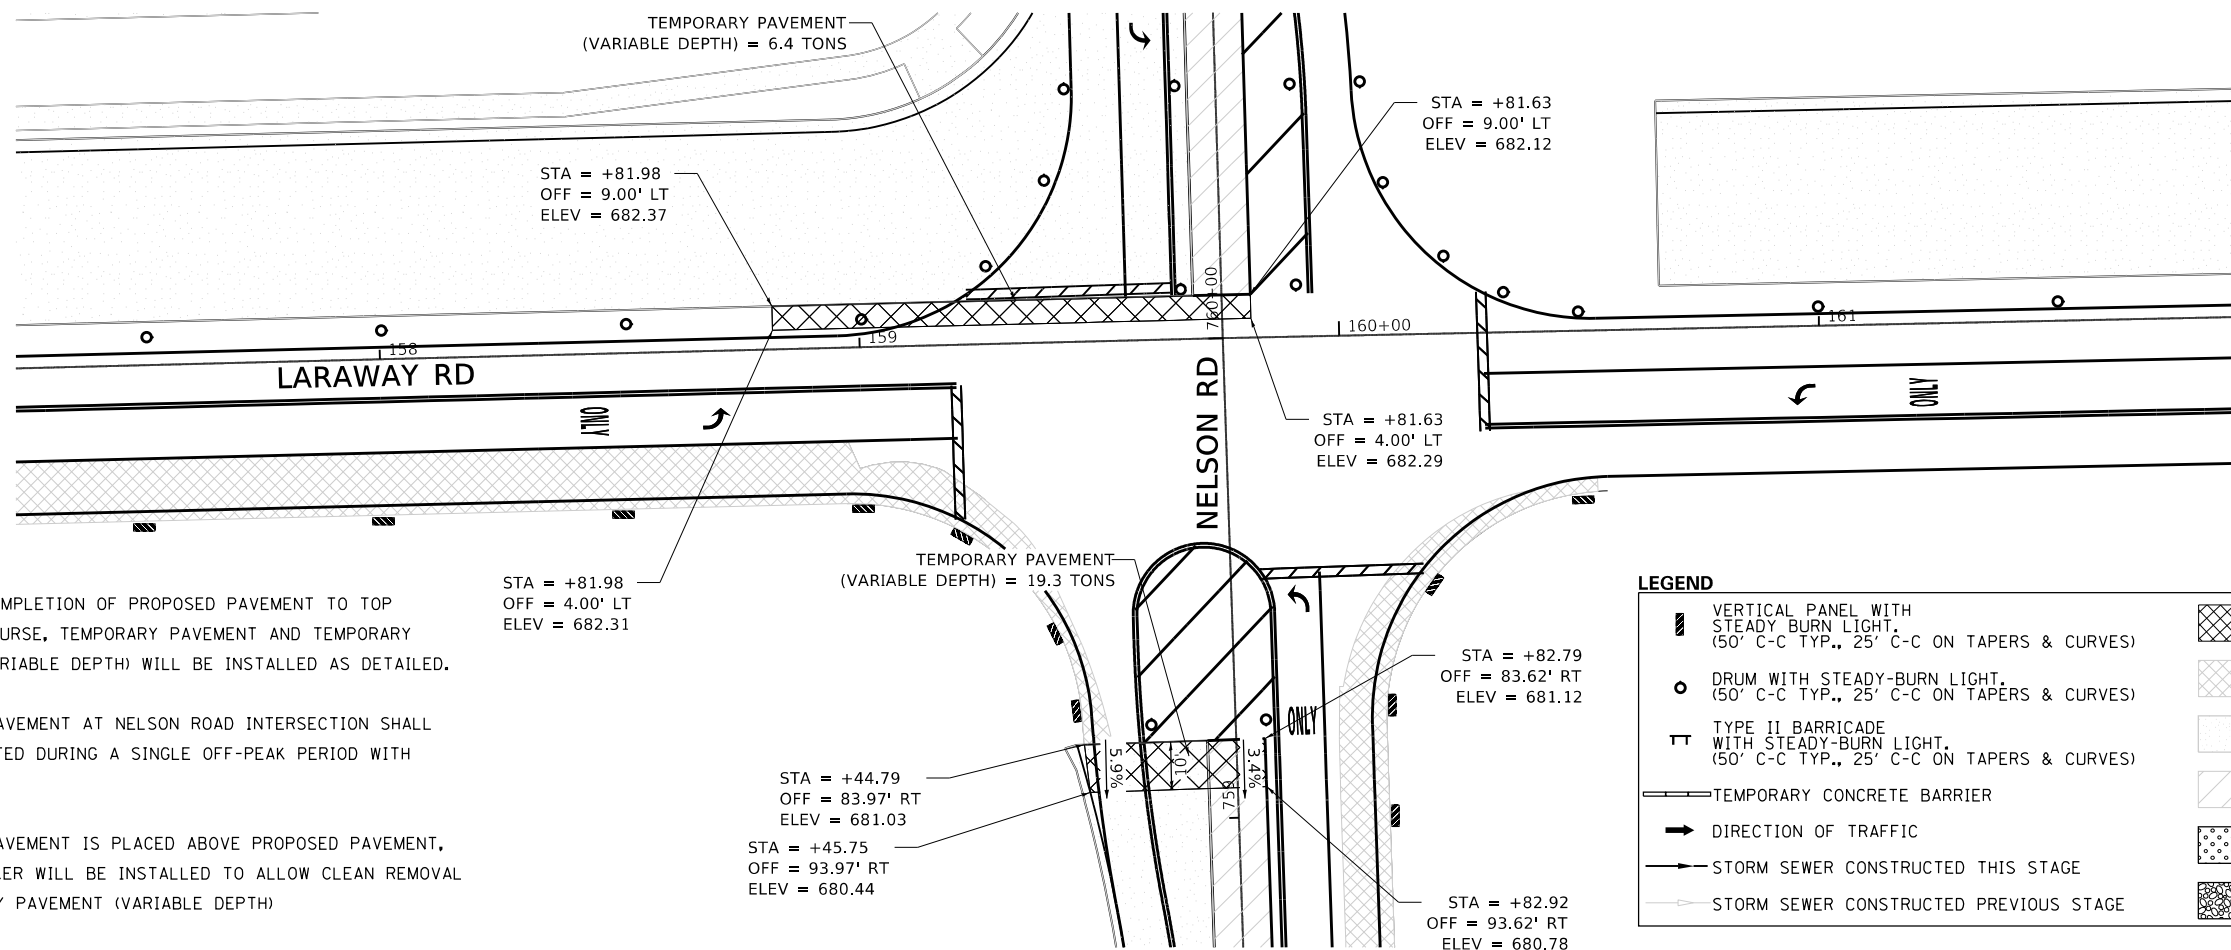
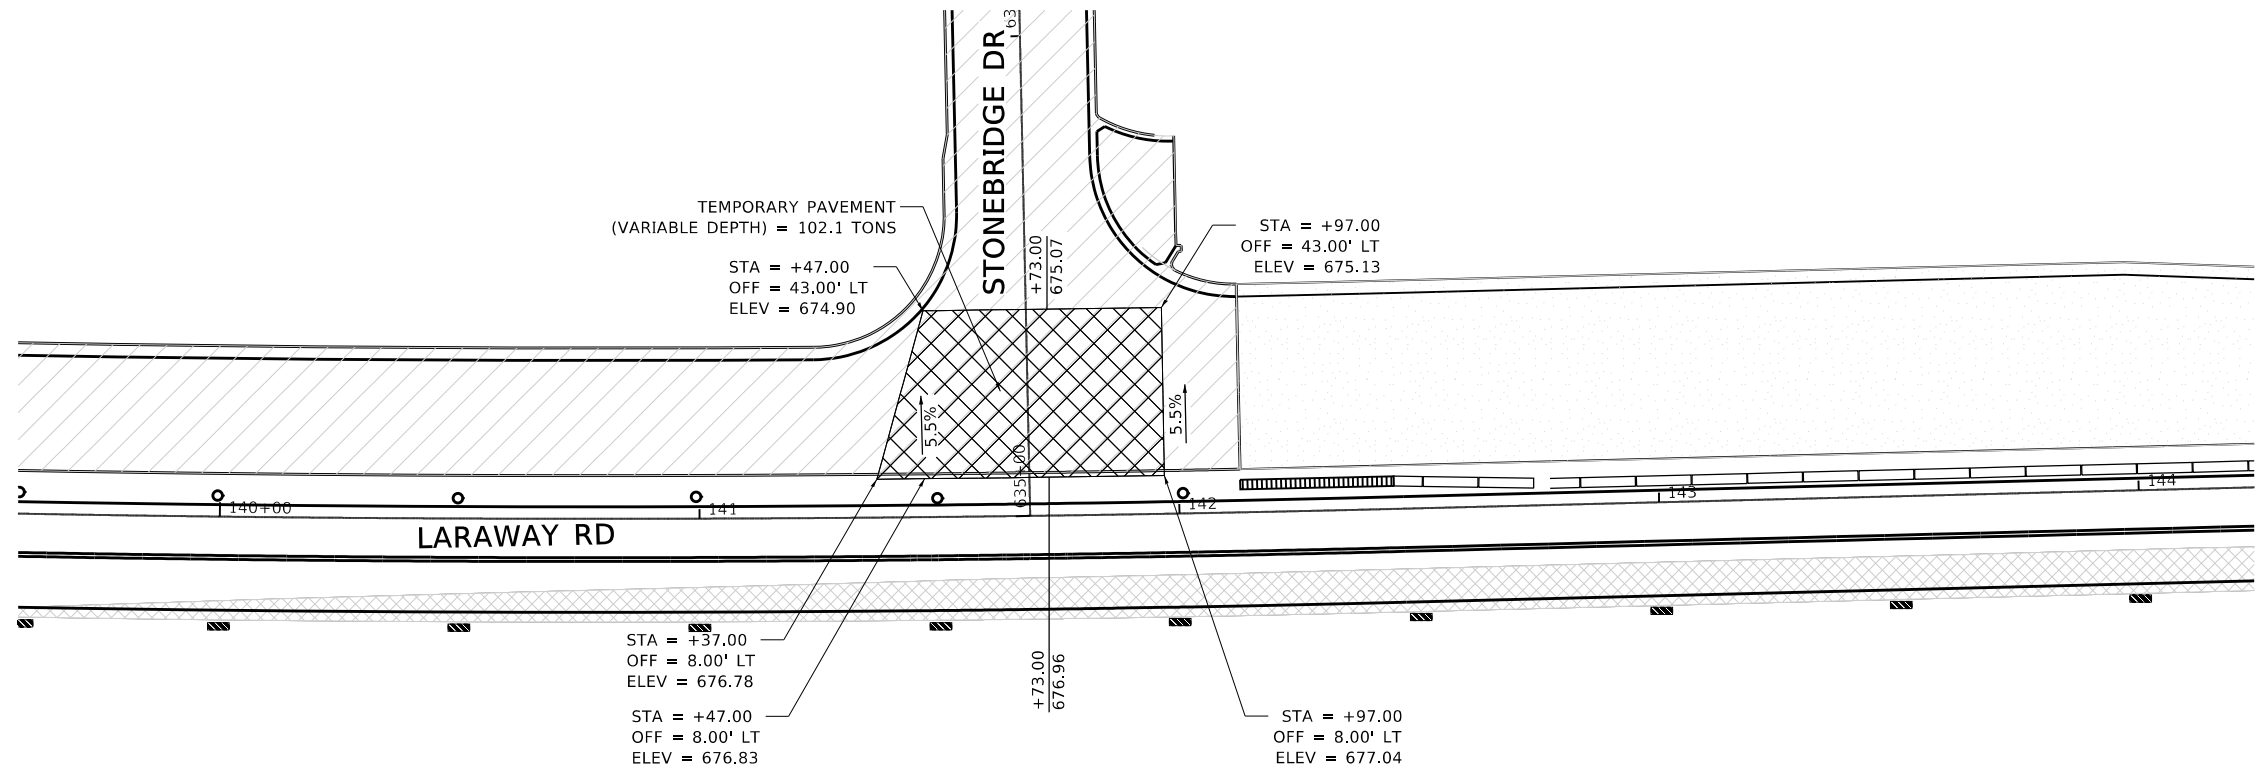
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PLOT DATE = 9/9/2022 - 12:15:27 PM	DATE - 09/09/2022	REVISED -							ILLINOIS		FED. AID PROJECT	



NOTES:

1. FOLLOWING COMPLETION OF PROPOSED PAVEMENT TO TOP OF BINDER COURSE, TEMPORARY PAVEMENT AND TEMPORARY PAVEMENT (VARIABLE DEPTH) WILL BE INSTALLED AS DETAILED.
2. TEMPORARY PAVEMENT AT NELSON ROAD INTERSECTION SHALL BE CONSTRUCTED DURING A SINGLE OFF-PEAK PERIOD WITH FLAGGERS.
3. WHEN TEMP PAVEMENT IS PLACED ABOVE PROPOSED PAVEMENT, A BOND BREAKER WILL BE INSTALLED TO ALLOW CLEAN REMOVAL OF TEMPORARY PAVEMENT (VARIABLE DEPTH)

LEGEND

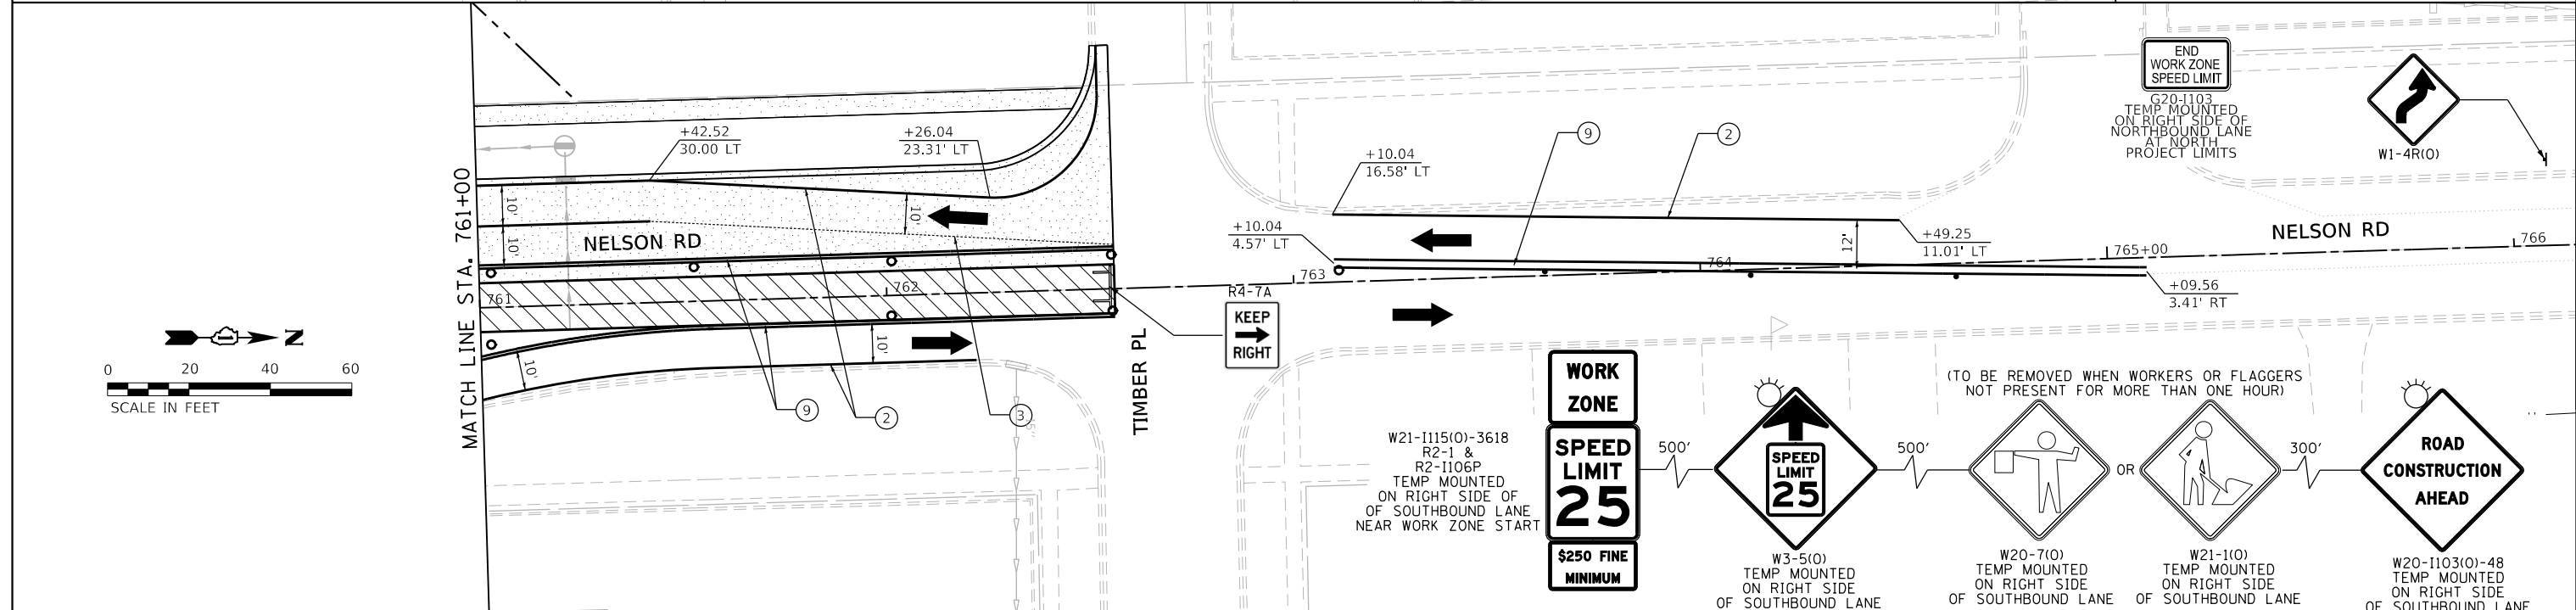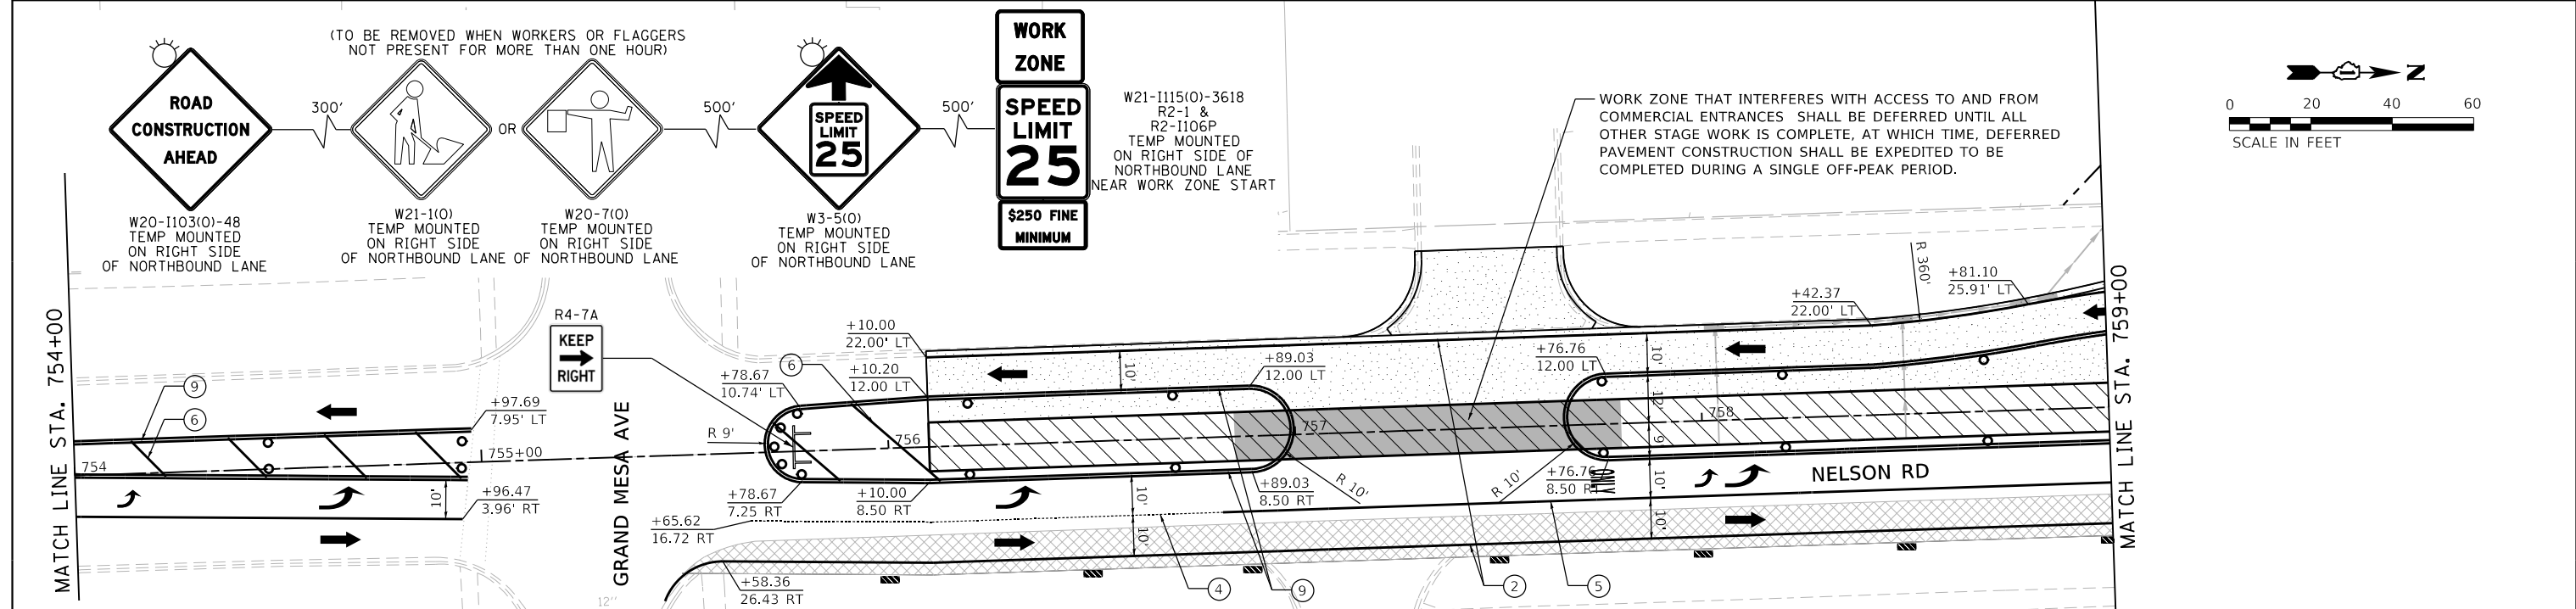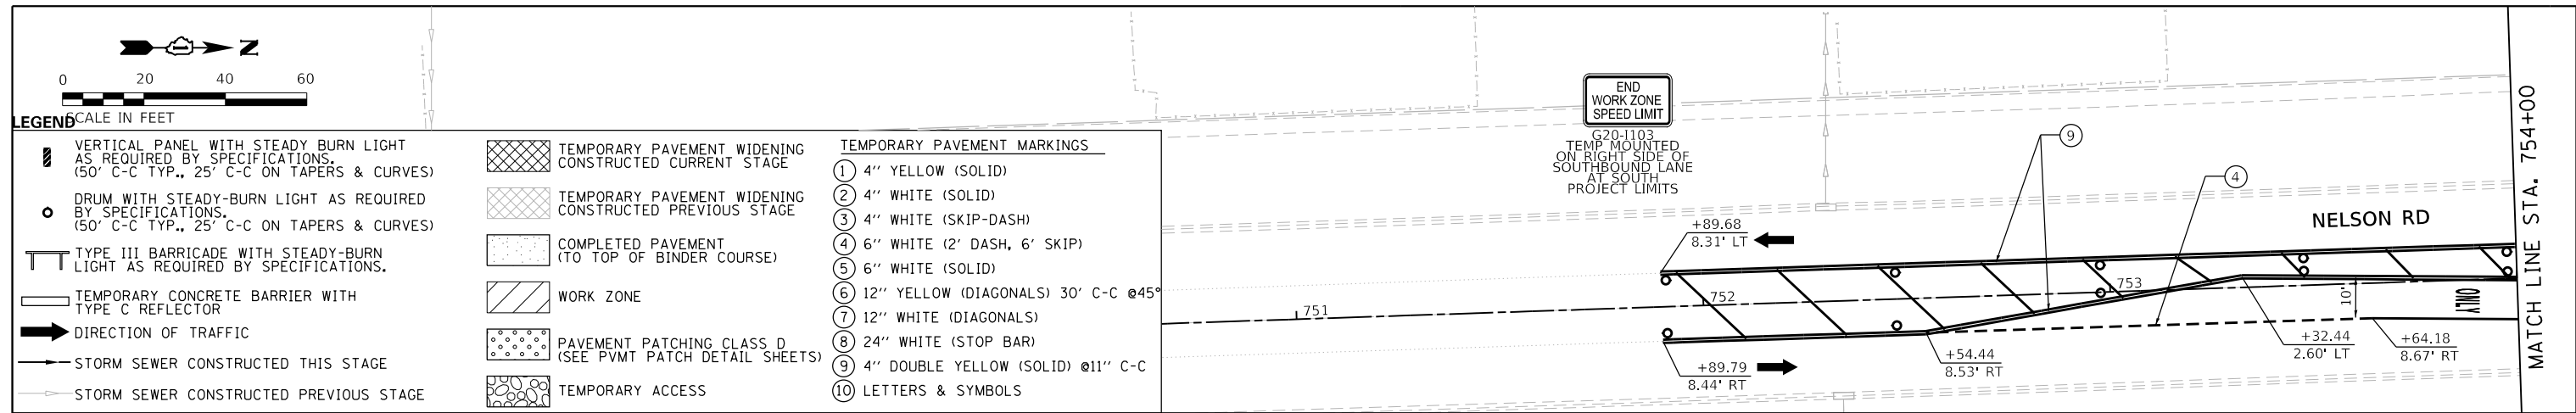	VERTICAL PANEL WITH STEADY BURN LIGHT. (50' C-C TYP., 25' C-C ON TAPERS & CURVES)		TEMPORARY PAVEMENT WIDENING CONSTRUCTED CURRENT STAGE
	DRUM WITH STEADY-BURN LIGHT. (50' C-C TYP., 25' C-C ON TAPERS & CURVES)		TEMPORARY PAVEMENT WIDENING CONSTRUCTED PREVIOUS STAGE
	TYPE II BARRICADE WITH STEADY-BURN LIGHT. (50' C-C TYP., 25' C-C ON TAPERS & CURVES)		COMPLETED PAVEMENT (TO TOP OF BINDER COURSE)
	TEMPORARY CONCRETE BARRIER		WORK ZONE
	DIRECTION OF TRAFFIC		PAVEMENT PATCHING CLASS D (SEE PAVEMENT PATCHING TABLE)
	STORM SEWER CONSTRUCTED THIS STAGE		AGGREGATE FOR TEMPORARY ACCESS
	STORM SEWER CONSTRUCTED PREVIOUS STAGE		




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**STATE OF ILLINOIS
DEPARTMENT OF TRANSPORTATION**


**SUGGESTED SEQUENCE OF CONSTRUCTION
STAGE 1B - TEMPORARY PAVEMENT DETAILS**

SCALE: 1"=20' SHEET 1 OF 1 SHEETS STA. N/A TO STA. N/A


F.A.U. RTE.	SECTION	COUNTY	TOTAL SHEETS	SHEET NO.
0320	13-00138-37-PV	WILL	413	115
CONTRACT NO. 61H20				
ILLINOIS FED. AID PROJECT				

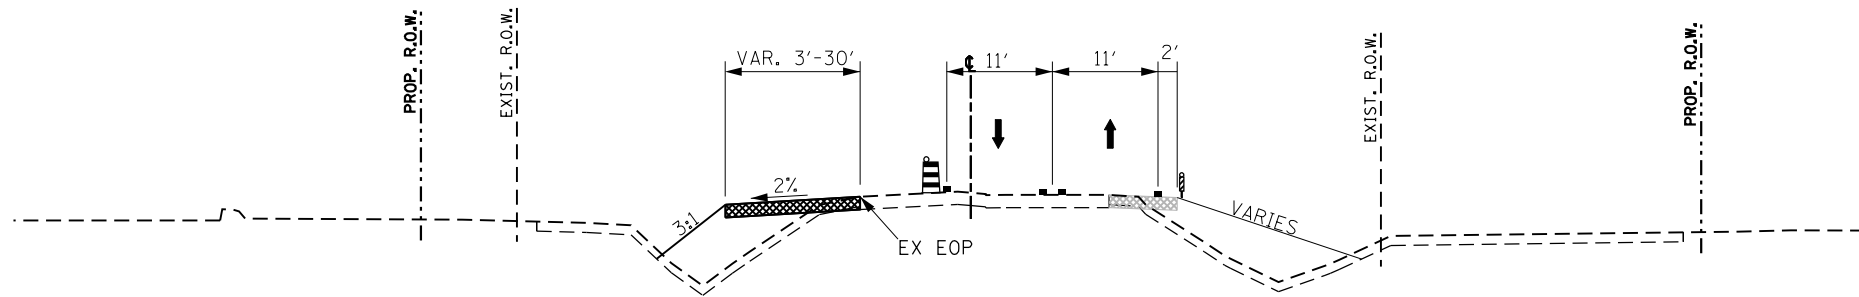


STAGE 1C TYPICAL SECTION
STA 135+00 TO 138+75.13

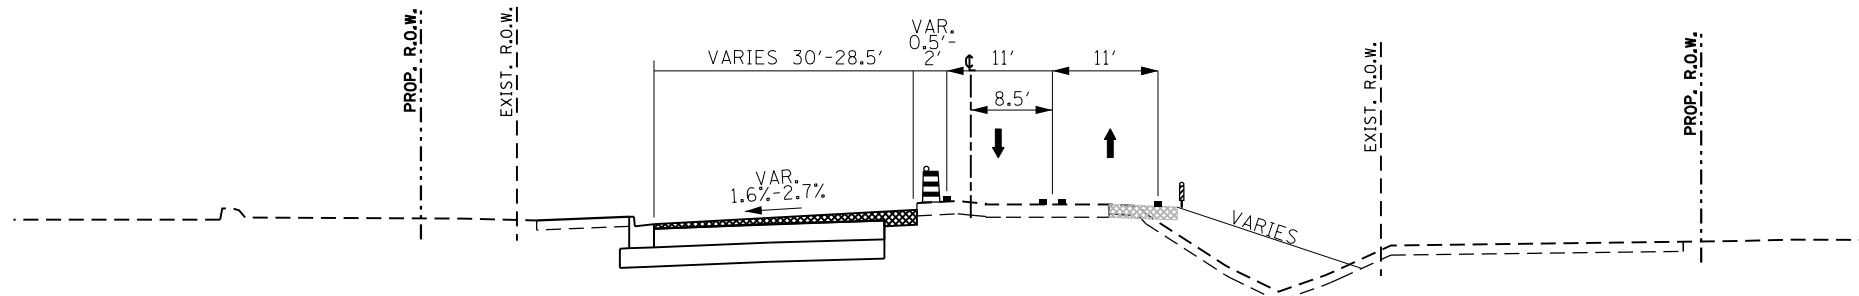

STAGE 1C TYPICAL SECTION
138+75.13 TO 139+25

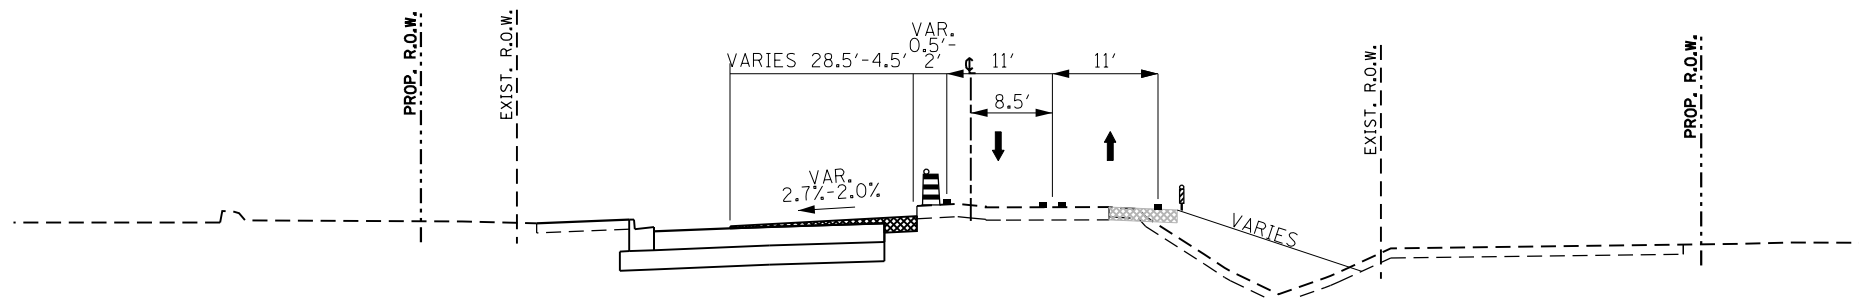

STAGE 1C TYPICAL SECTION
139+25 TO 139+50

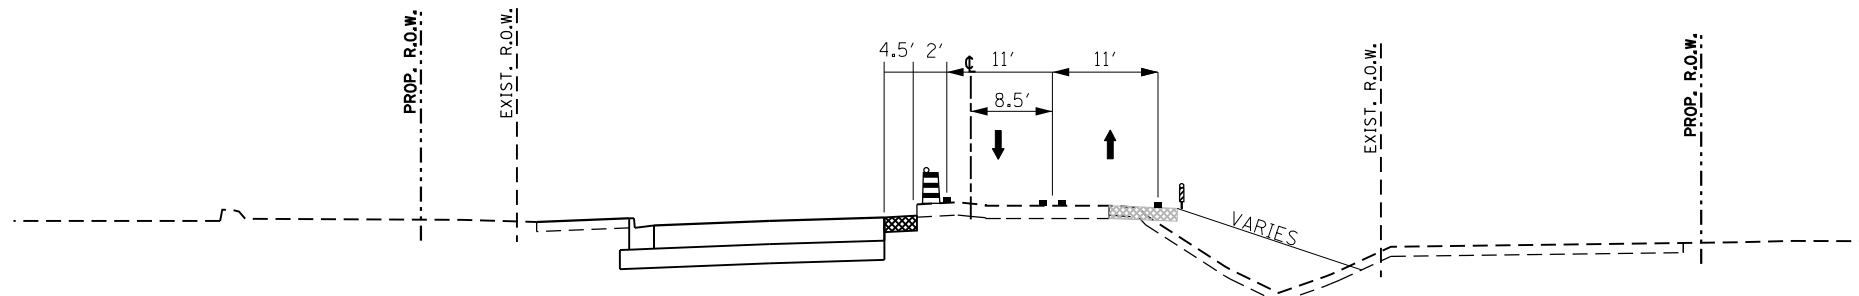

STAGE 1C TYPICAL SECTION
139+50 TO 140+00

LEGEND

	TEMPORARY PAVEMENT MARKING LINE		TEMPORARY PAVEMENT WIDENING CONSTRUCTED CURRENT STAGE
	VERTICAL PANEL WITH STEADY BURN LIGHT AS REQUIRED BY SPECIFICATIONS. (50' C-C TYP., 25' C-C ON TAPERS & CURVES)		TEMPORARY PAVEMENT WIDENING CONSTRUCTED PREVIOUS STAGE
	DRUM WITH STEADY-BURN LIGHT AS REQUIRED BY SPECIFICATIONS. (50' C-C TYP., 25' C-C ON TAPERS & CURVES)		COMPLETED PAVEMENT
	TYPE II BARRICADE WITH STEADY-BURN LIGHT AS REQUIRED BY SPECIFICATIONS. (50' C-C TYP., 25' C-C ON TAPERS & CURVES)		WORK ZONE
	TEMPORARY CONCRETE BARRIER WITH TYPE C REFLECTORS		
	DIRECTION OF TRAFFIC		



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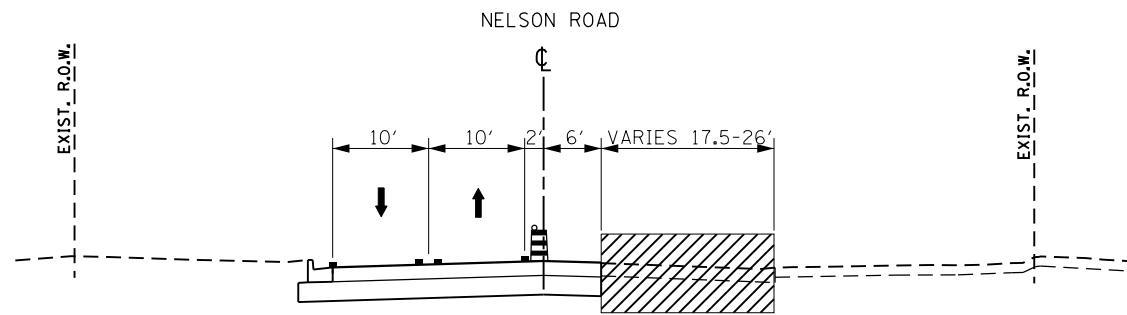
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**STATE OF ILLINOIS
DEPARTMENT OF TRANSPORTATION**


**SUGGESTED SEQUENCE OF CONSTRUCTION
STAGE 1C TYPICAL SECTION - LARAWAY RD**

SCALE: SHEET 1 OF 3 SHEETS STA. TO STA.

F.A.U. RTE.	SECTION	COUNTY	TOTAL SHEETS	SHEET NO.
0320	13-00138-37-PV	WILL	413	116
CONTRACT NO. 61H20				
		ILLINOIS	FED. AID PROJECT	



STAGE 1C TYPICAL SECTION
STA 756+10 TO 758+42.60

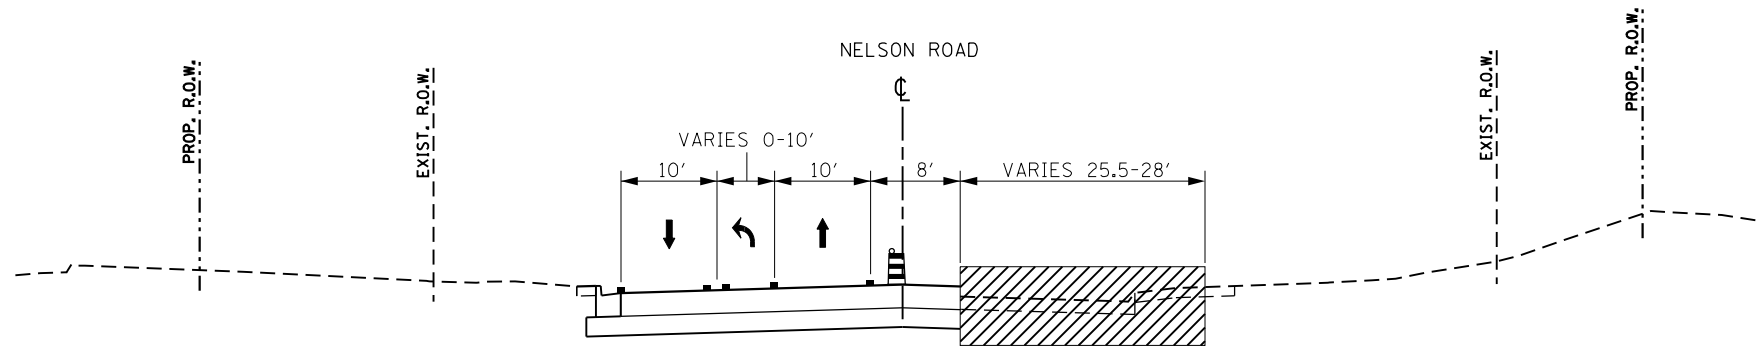

STAGE 1C TYPICAL SECTION
STA 758+42.60 TO 759+18.88

LEGEND

	TEMPORARY PAVEMENT MARKING LINE		TEMPORARY PAVEMENT WIDENING CONSTRUCTED CURRENT STAGE
	VERTICAL PANEL WITH STEADY BURN LIGHT AS REQUIRED BY SPECIFICATIONS. (50' C-C TYP., 25' C-C ON TAPERS & CURVES)		TEMPORARY PAVEMENT WIDENING CONSTRUCTED PREVIOUS STAGE
	DRUM WITH STEADY-BURN LIGHT AS REQUIRED BY SPECIFICATIONS. (50' C-C TYP., 25' C-C ON TAPERS & CURVES)		COMPLETED PAVEMENT
	TYPE II BARRICADE WITH STEADY-BURN LIGHT AS REQUIRED BY SPECIFICATIONS. (50' C-C TYP., 25' C-C ON TAPERS & CURVES)		WORK ZONE
	TEMPORARY CONCRETE BARRIER WITH TYPE C REFLECTORS		
	DIRECTION OF TRAFFIC		



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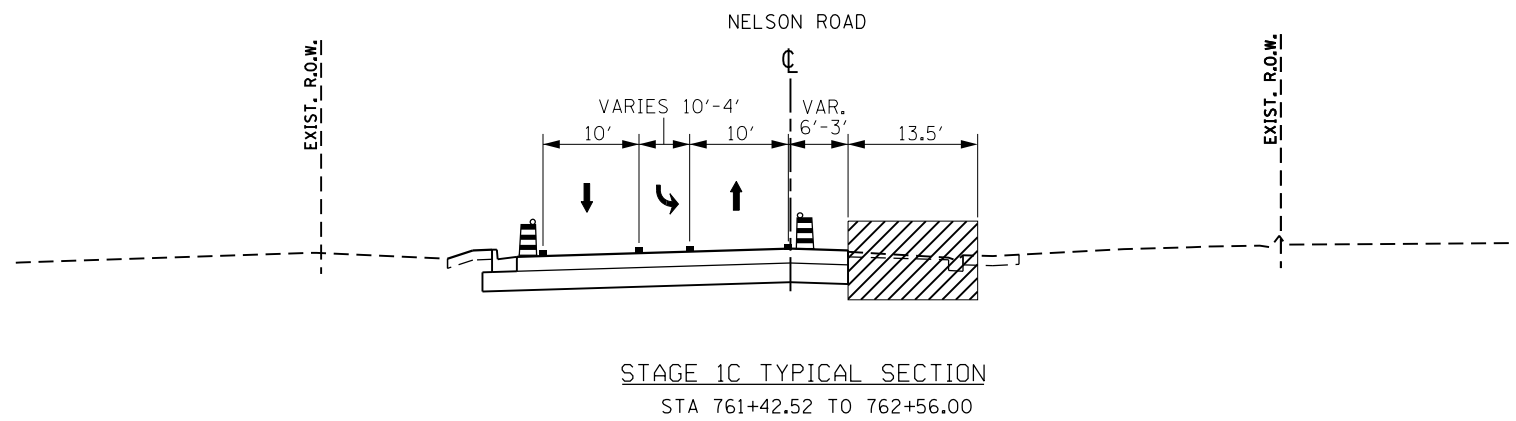
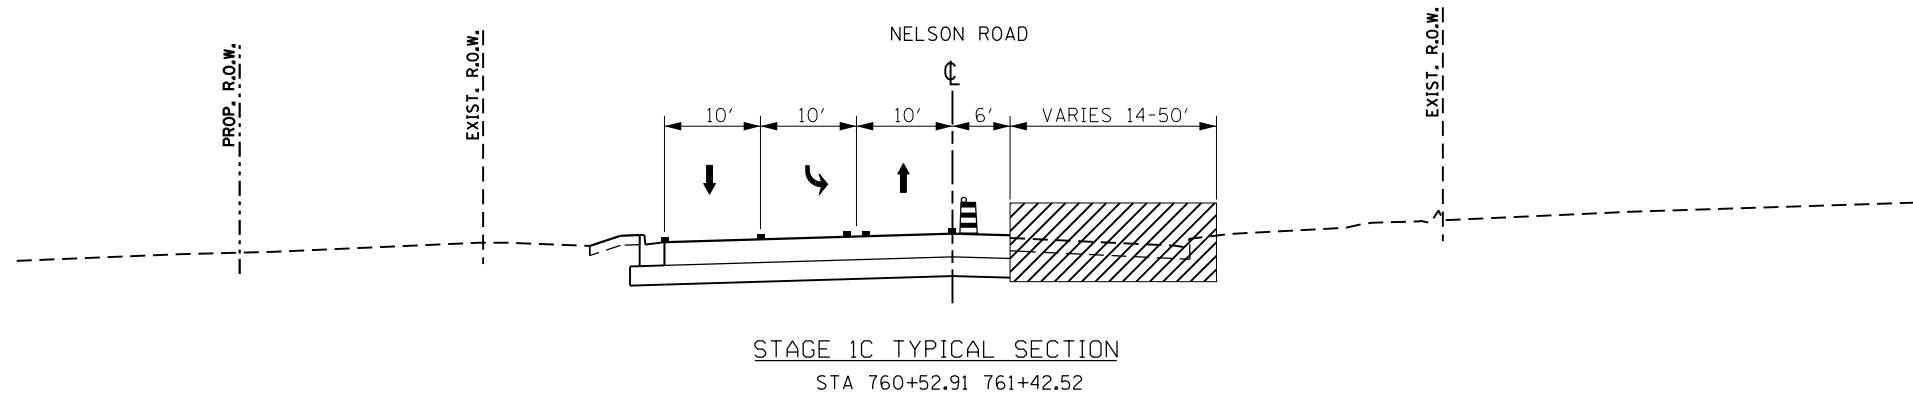
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PLOT DATE = 9/9/2022 - 12:15:32 PM	DATE - 09/09/2022	REVISED -

**STATE OF ILLINOIS
DEPARTMENT OF TRANSPORTATION**

**SUGGESTED SEQUENCE OF CONSTRUCTION
STAGE 1C TYPICAL SECTION - NELSON RD**

SCALE: SHEET 2 OF 3 SHEETS STA. TO STA.

F.A.U. RTE.	SECTION	COUNTY	TOTAL SHEETS	SHEET NO.
0320	13-00138-37-PV	WILL	413	117
CONTRACT NO. 61H20				
		ILLINOIS	FED. AID PROJECT	



LEGEND

	TEMPORARY PAVEMENT MARKING LINE		TEMPORARY PAVEMENT WIDENING CONSTRUCTED CURRENT STAGE
	VERTICAL PANEL WITH STEADY BURN LIGHT AS REQUIRED BY SPECIFICATIONS. (50' C-C TYP., 25' C-C ON TAPERS & CURVES)		TEMPORARY PAVEMENT WIDENING CONSTRUCTED PREVIOUS STAGE
	DRUM WITH STEADY-BURN LIGHT AS REQUIRED BY SPECIFICATIONS. (50' C-C TYP., 25' C-C ON TAPERS & CURVES)		COMPLETED PAVEMENT
	TYPE II BARRICADE WITH STEADY-BURN LIGHT AS REQUIRED BY SPECIFICATIONS. (50' C-C TYP., 25' C-C ON TAPERS & CURVES)		WORK ZONE
	TEMPORARY CONCRETE BARRIER WITH TYPE C REFLECTORS		
	DIRECTION OF TRAFFIC		



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FILE NAME = sht-staging-tp-Nelson-stage01C-02.dgn	DESIGNED - PML	REVISED -
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PLOT DATE = 9/9/2022 - 12:15:33 PM	DATE - 09/09/2022	REVISED -

**STATE OF ILLINOIS
DEPARTMENT OF TRANSPORTATION**

**SUGGESTED SEQUENCE OF CONSTRUCTION
STAGE 1C TYPICAL SECTION - NELSON RD**

SCALE: SHEET 3 OF 3 SHEETS STA. TO STA.

F.A.U. RTE.	SECTION	COUNTY	TOTAL SHEETS	SHEET NO.
0320	13-00138-37-PV	WILL	413	118
CONTRACT NO. 61H20				
ILLINOIS FED. AID PROJECT				

LEGEND




- VERTICAL PANEL WITH STEADY BURN LIGHT AS REQUIRED BY SPECIFICATIONS. (50' C-C TYP., 25' C-C ON TAPERS & CURVES)
- DRUM WITH STEADY-BURN LIGHT AS REQUIRED BY SPECIFICATIONS. (50' C-C TYP., 25' C-C ON TAPERS & CURVES)
- TYPE III BARRICADE WITH STEADY-BURN LIGHT AS REQUIRED BY SPECIFICATIONS.
- TEMPORARY CONCRETE BARRIER WITH TYPE C REFLECTOR
- DIRECTION OF TRAFFIC
- STORM SEWER CONSTRUCTED THIS STAGE
- STORM SEWER CONSTRUCTED PREVIOUS STAGE
- TEMPORARY PAVEMENT WIDENING CONSTRUCTED CURRENT STAGE
- TEMPORARY PAVEMENT WIDENING CONSTRUCTED PREVIOUS STAGE
- COMPLETED PAVEMENT (TO TOP OF BINDER COURSE)
- WORK ZONE
- PAVEMENT PATCHING CLASS D (SEE PVMT PATCH DETAIL SHEETS)
- TEMPORARY ACCESS

TEMPORARY PAVEMENT MARKINGS

- 4" YELLOW (SOLID)
- 4" WHITE (SOLID)
- 4" WHITE (SKIP-DASH)
- 6" WHITE (2' DASH, 6' SKIP)
- 6" WHITE (SOLID)
- 12" YELLOW (DIAGONALS) 30' C-C @45°
- 12" WHITE (DIAGONALS)
- 24" WHITE (STOP BAR)
- 4" DOUBLE YELLOW (SOLID) @11" C-C
- LETTERS & SYMBOLS



NOTES:

- SEE SHEET 122 FOR TEMPORARY PAVEMENT DETAILS.
- STAGE 1C LANE CONFIGURATIONS ARE THE SAME AS IN STAGE 1B UNLESS OTHERWISE NOTED.

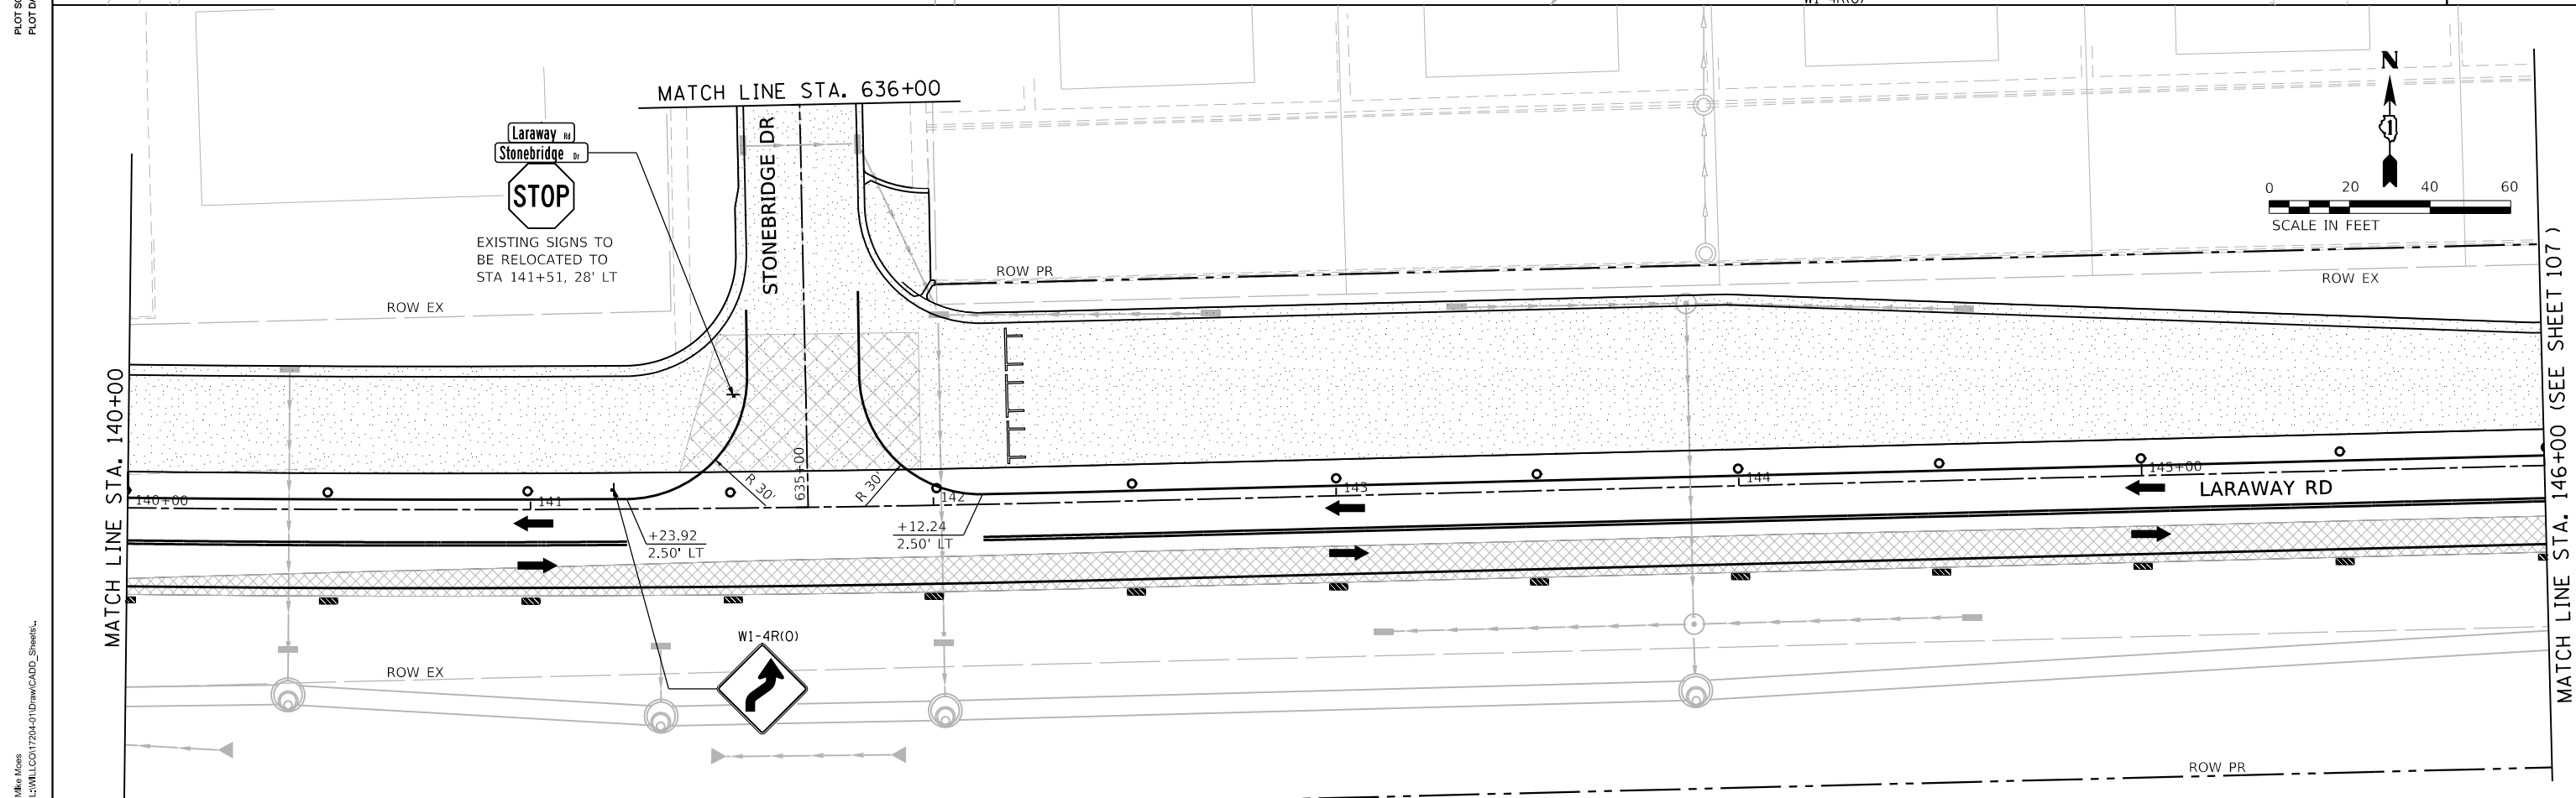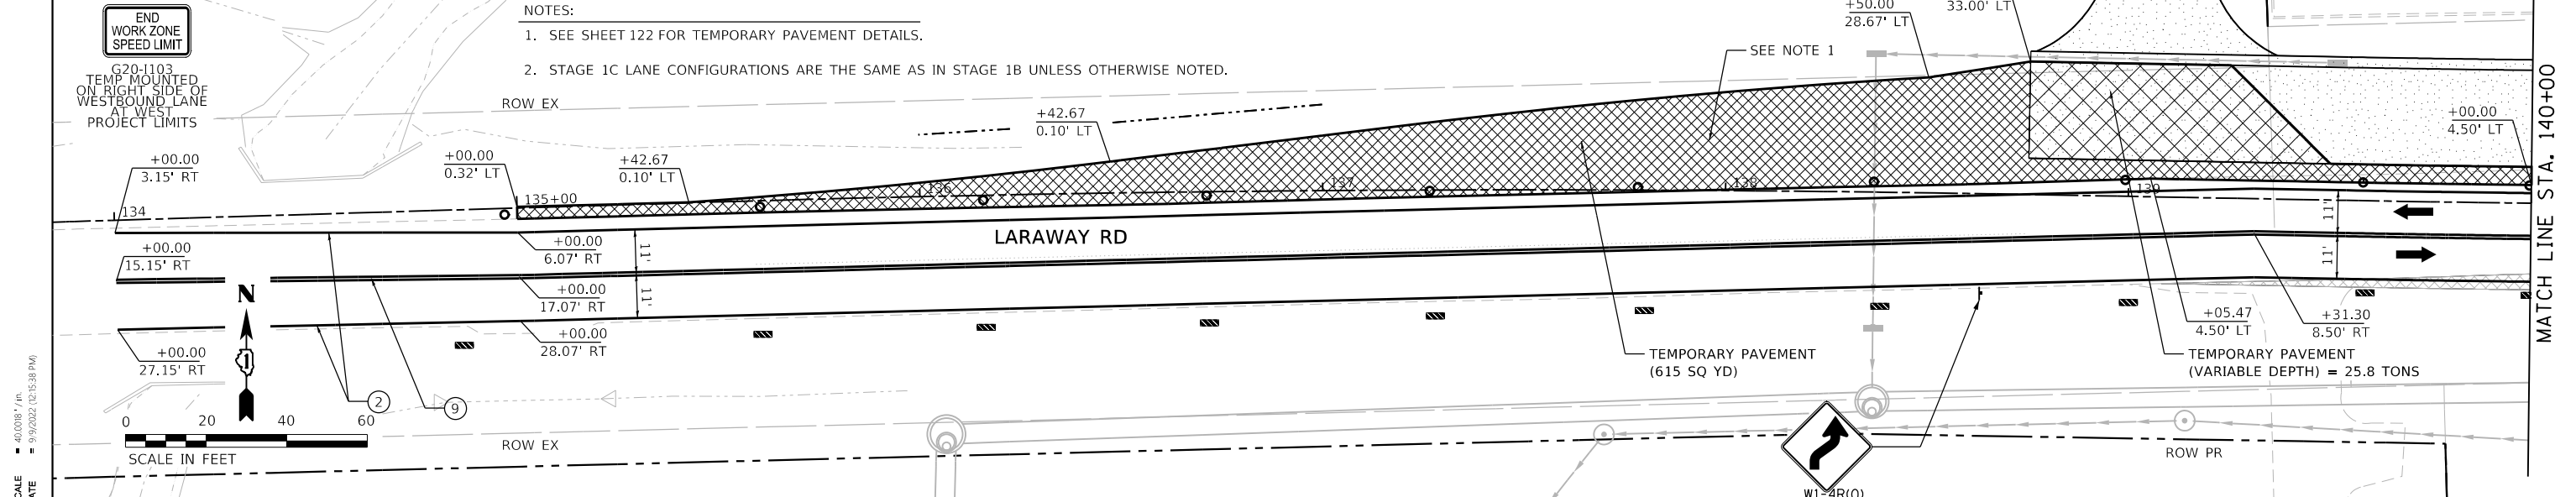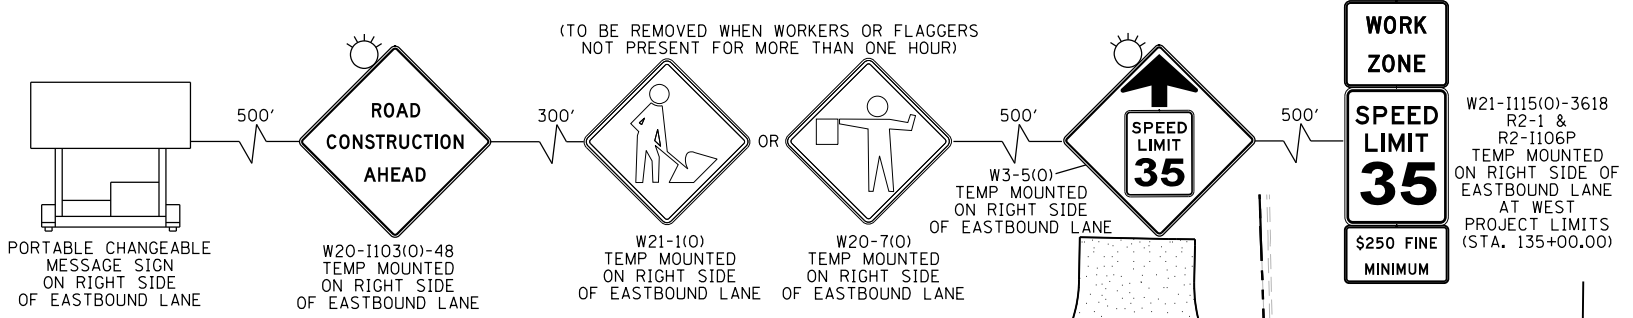

	FILE NAME = sht-staging-stage01C-01.dgn	DESIGNED - JMS	REVISED -	STATE OF ILLINOIS DEPARTMENT OF TRANSPORTATION	SUGGESTED SEQUENCE OF CONSTRUCTION LARAWAY RD - STAGE 1C			F.A.U. RTE. = 0320	SECTION = 13-00138-37-PV	COUNTY = WILL	TOTAL SHEETS = 413	SHEET NO. = 119
	MODEL NAME = Default	DRAWN - PML	REVISED -		SCALE: 1"=20'	SHEET 1	OF 2 SHEETS	STA. 134+00 TO STA. 146+00	ILLINOIS FED. AID PROJECT		CONTRACT NO. 61H20	
PLOT SCALE = 40.0000' / in. PLOT DATE = 9/9/2022 - 12:15:38 PM	CHECKED - JMS	DATE - 09/09/2022	REVISED -									

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 PLOT DATE = 9/9/2022 (12:15:38 PM)

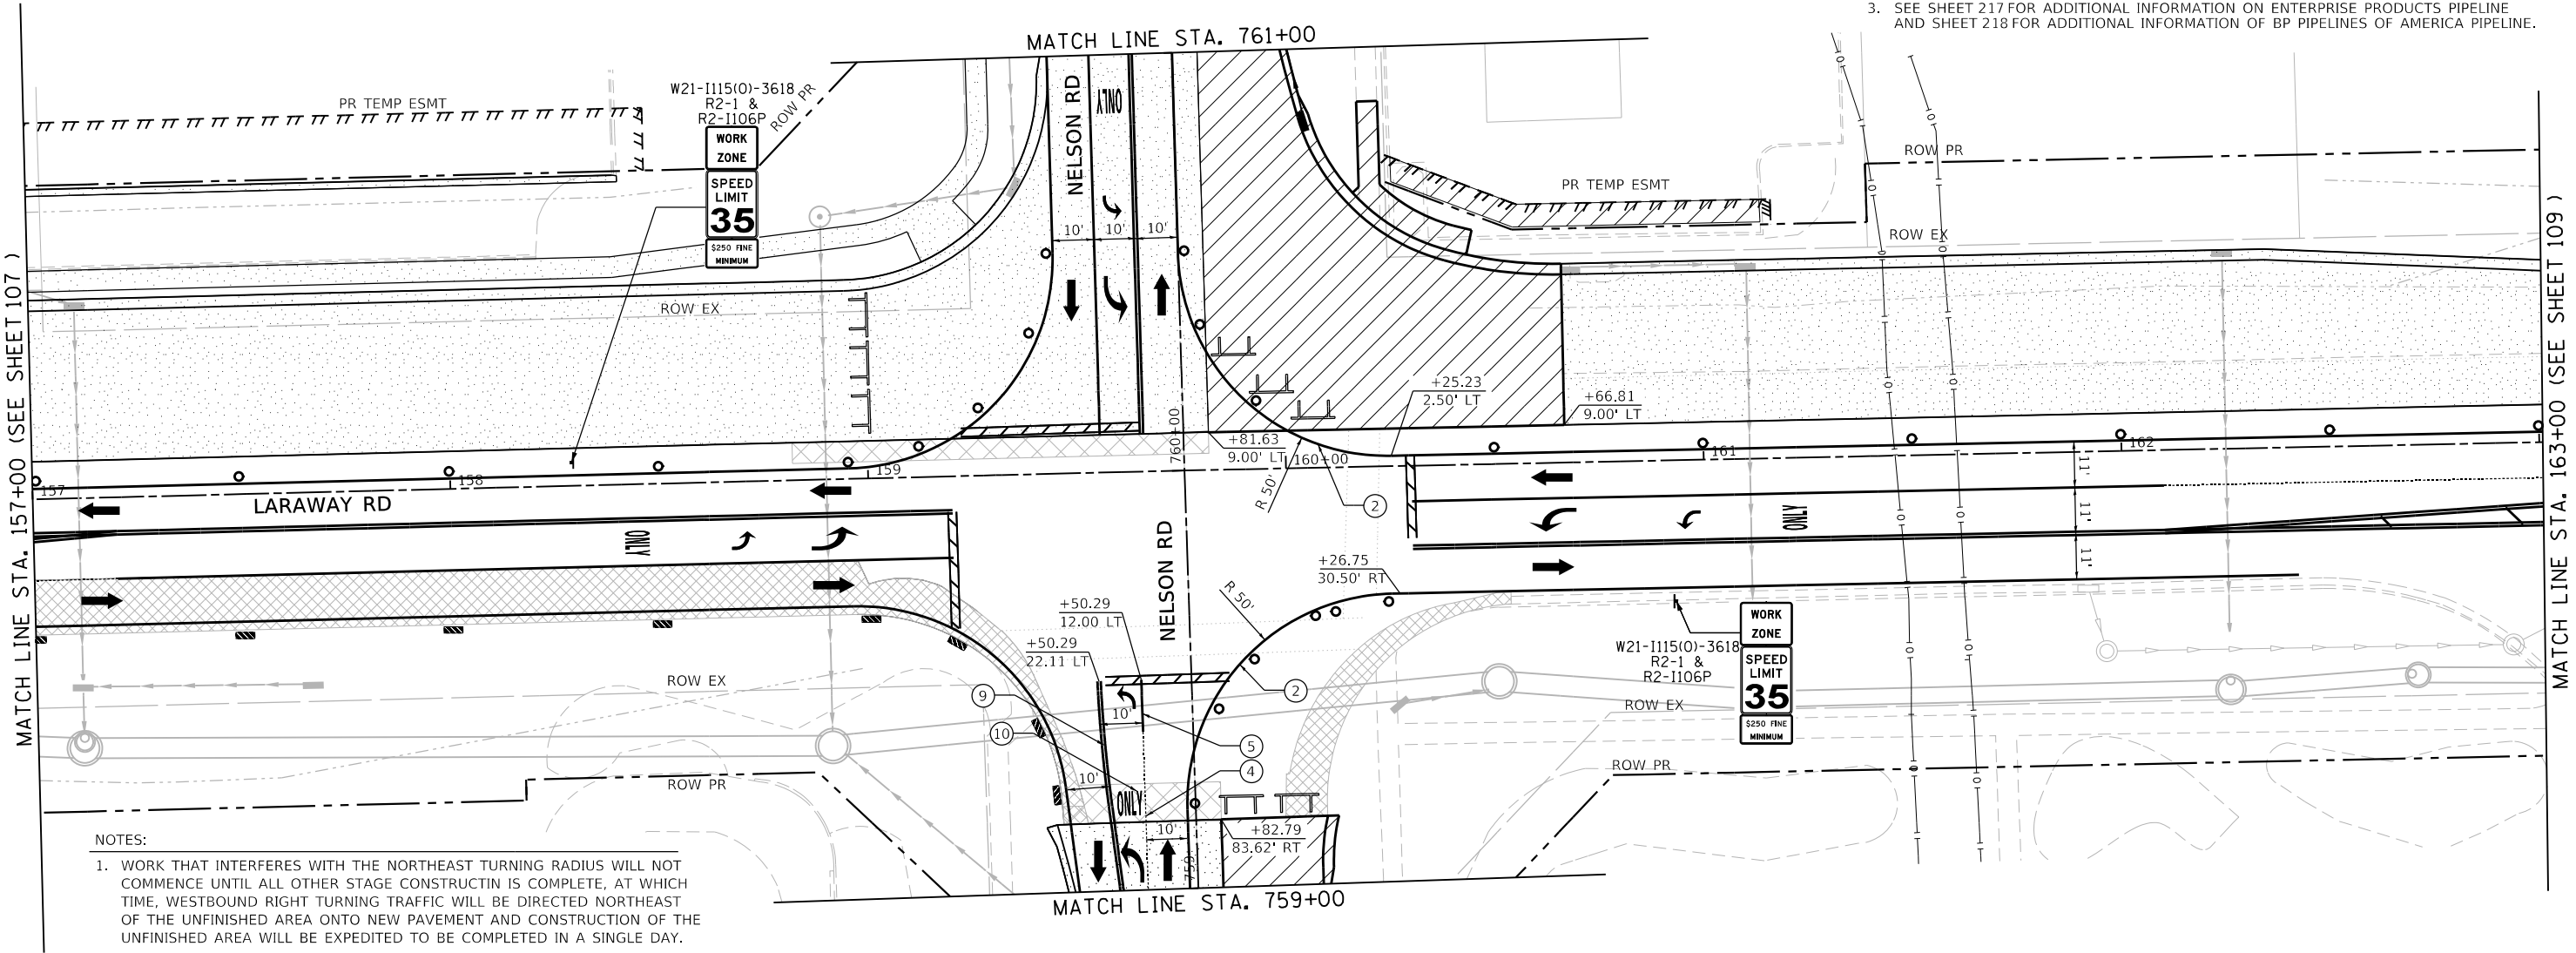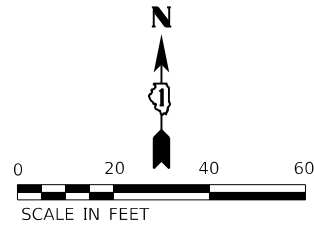

MATCH LINE STA. 157+00 (SEE SHEET 107)

MATCH LINE STA. 163+00 (SEE SHEET 109)

- PIPELINE STAGING NOTES:**
- CONTRACTOR MUST CONTACT PIPELINE COMPANIES TO COORDINATE ALL WORK IN THE VICINITY OF THE PIPELINES. CONTRACTOR MUST FOLLOW ALL REQUIREMENTS OF THESE PLANS, SPECIFICATIONS, PIPELINE ENCROACHMENT GUIDELINES, AND ANY OTHER REQUIREMENTS COMMUNICATED BY PIPELINE COMPANY REPRESENTATIVES REGARDING WORK AROUND THE PIPELINES.
 - TEMPORARY FENCE SHALL BE REPOSITIONED TO A LOCATION APPROVED BY THE ENGINEER AND THE PIPELINE REPRESENTATIVES TO LIMIT EQUIPMENT CROSSING TO A 15' WIDE OPENING PERPENDICULAR TO PIPELINES. 5' GAP IN FENCE IS PERMITTED TO ALLOW PEDESTRAIN PASSAGE.
 - SEE SHEET 217 FOR ADDITIONAL INFORMATION ON ENTERPRISE PRODUCTS PIPELINE AND SHEET 218 FOR ADDITIONAL INFORMATION OF BP PIPELINES OF AMERICA PIPELINE.

BP PIPELINES OF AMERICA
STEVE ADAMS
OFFICE: 779.801.4969
EMAIL: steve.adams@bp.com

ENTERPRISE PRODUCTS
BLAKE HAMILTON
OFFICE: 815.277.7286
CELL: 217.508.2991
EMAIL: bdhamilton@eprod.com

- NOTES:**
- WORK THAT INTERFERES WITH THE NORTHEAST TURNING RADIUS WILL NOT COMMENCE UNTIL ALL OTHER STAGE CONSTRUCTION IS COMPLETE, AT WHICH TIME, WESTBOUND RIGHT TURNING TRAFFIC WILL BE DIRECTED NORTHEAST OF THE UNFINISHED AREA ONTO NEW PAVEMENT AND CONSTRUCTION OF THE UNFINISHED AREA WILL BE EXPEDITED TO BE COMPLETED IN A SINGLE DAY.
 - SEE TEMPORARY TRAFFIC SIGNAL PLANS FOR CROSSWALK CONFIGURATIONS.

LEGEND		TEMPORARY PAVEMENT MARKINGS	
	VERTICAL PANEL WITH STEADY BURN LIGHT AS REQUIRED BY SPECIFICATIONS. (50' C-C TYP., 25' C-C ON TAPERS & CURVES)		TEMPORARY PAVEMENT WIDENING CONSTRUCTED CURRENT STAGE
	DRUM WITH STEADY-BURN LIGHT AS REQUIRED BY SPECIFICATIONS. (50' C-C TYP., 25' C-C ON TAPERS & CURVES)		TEMPORARY PAVEMENT WIDENING CONSTRUCTED PREVIOUS STAGE
	TYPE III BARRICADE WITH STEADY-BURN LIGHT AS REQUIRED BY SPECIFICATIONS.		COMPLETED PAVEMENT (TO TOP OF BINDER COURSE)
	TEMPORARY CONCRETE BARRIER WITH TYPE C REFLECTOR		WORK ZONE
	DIRECTION OF TRAFFIC		PAVEMENT PATCHING CLASS D (SEE PVMT PATCH DETAIL SHEETS)
	STORM SEWER CONSTRUCTED THIS STAGE		TEMPORARY ACCESS
	STORM SEWER CONSTRUCTED PREVIOUS STAGE		① 4" YELLOW (SOLID)
			② 4" WHITE (SOLID)
			③ 4" WHITE (SKIP-DASH)
			④ 6" WHITE (2' DASH, 6' SKIP)
			⑤ 6" WHITE (SOLID)
			⑥ 12" YELLOW (DIAGONALS) 30' C-C @45°
			⑦ 12" WHITE (DIAGONALS)
			⑧ 24" WHITE (STOP BAR)
			⑨ 4" DOUBLE YELLOW (SOLID) @11" C-C
			⑩ LETTERS & SYMBOLS



FILE NAME =	sht-staging-stage01C-03.dgn	DESIGNED -	BRF	REVISED -	
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PLOT SCALE =	40,0018' / in	CHECKED -	JMS	REVISED -	
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**STATE OF ILLINOIS
DEPARTMENT OF TRANSPORTATION**




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LARAWAY RD - STAGE 1C			
SCALE: 1"=20'	SHEET 2	OF 2 SHEETS	STA. 157+00 TO STA. 163+00

F.A.U. RTE.	SECTION	COUNTY	TOTAL SHEETS	SHEET NO.
0320	13-00138-37-PV	WILL	413	120
CONTRACT NO. 61H20				
ILLINOIS		FED. AID PROJECT		

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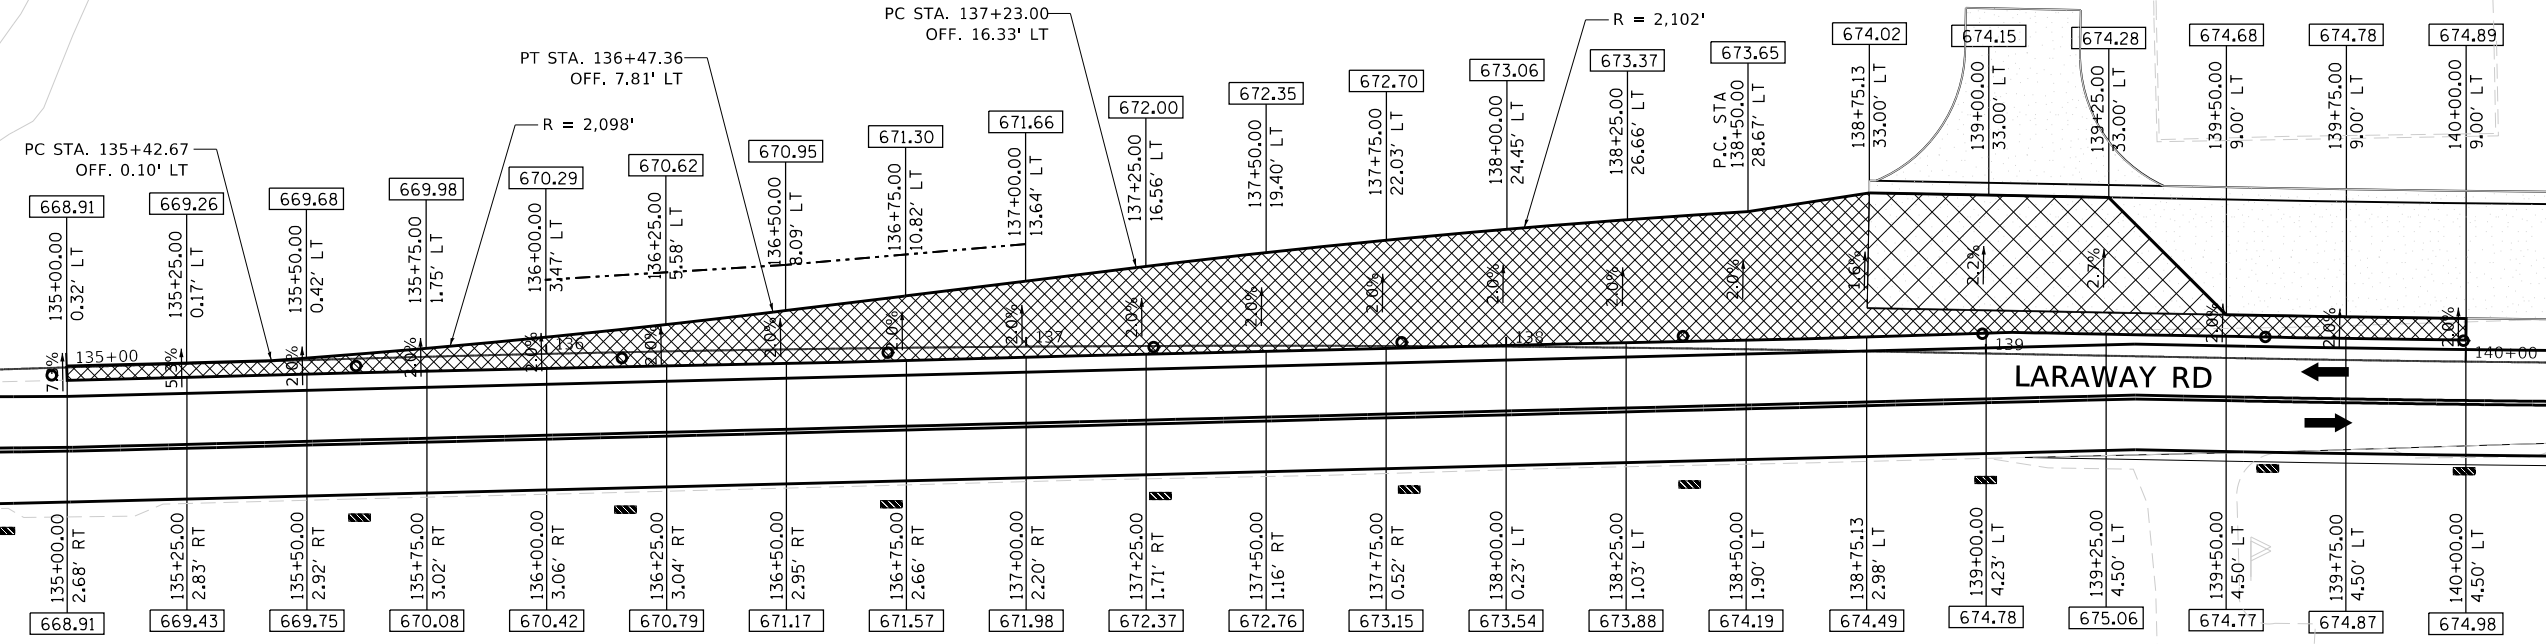
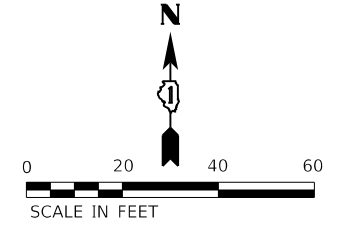
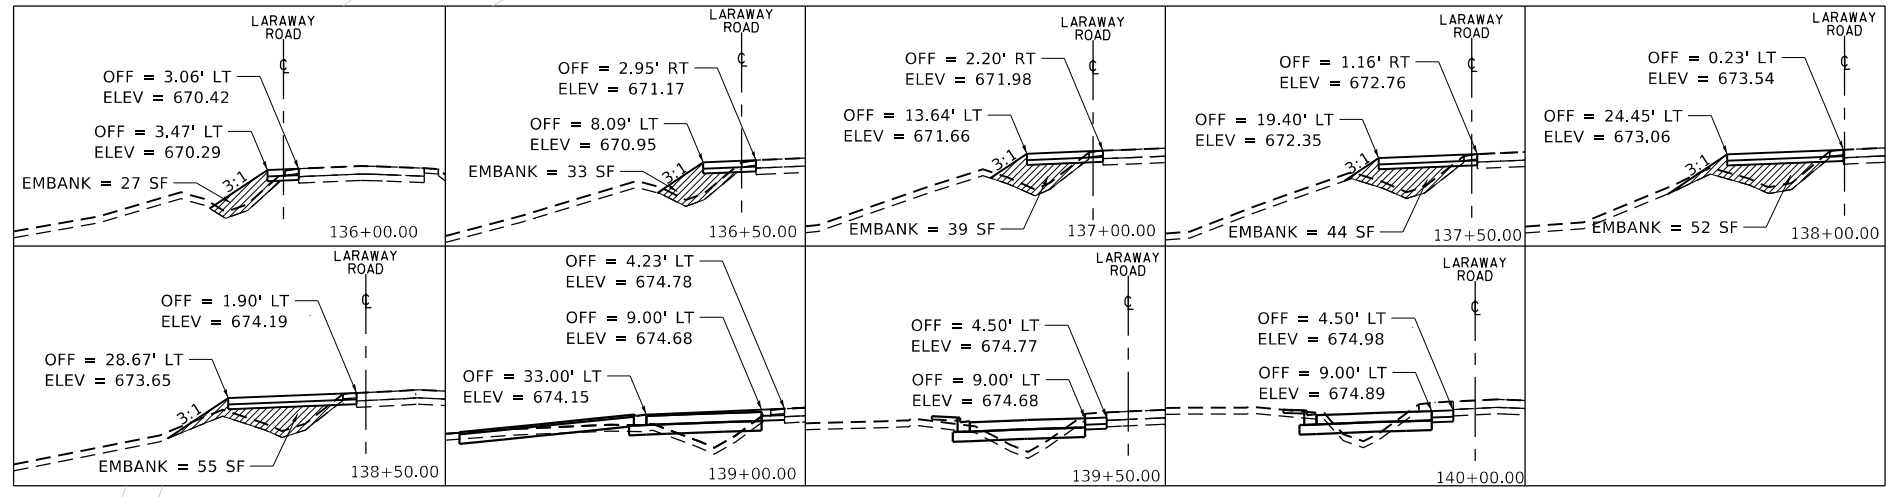


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STATE OF ILLINOIS
DEPARTMENT OF TRANSPORTATION

SUGGESTED SEQUENCE OF CONSTRUCTION	
NELSON RD - STAGE 1C	
SCALE: 1"=20'	SHEET 1 OF 1 SHEETS
STA. 751+00	TO STA. 765+00

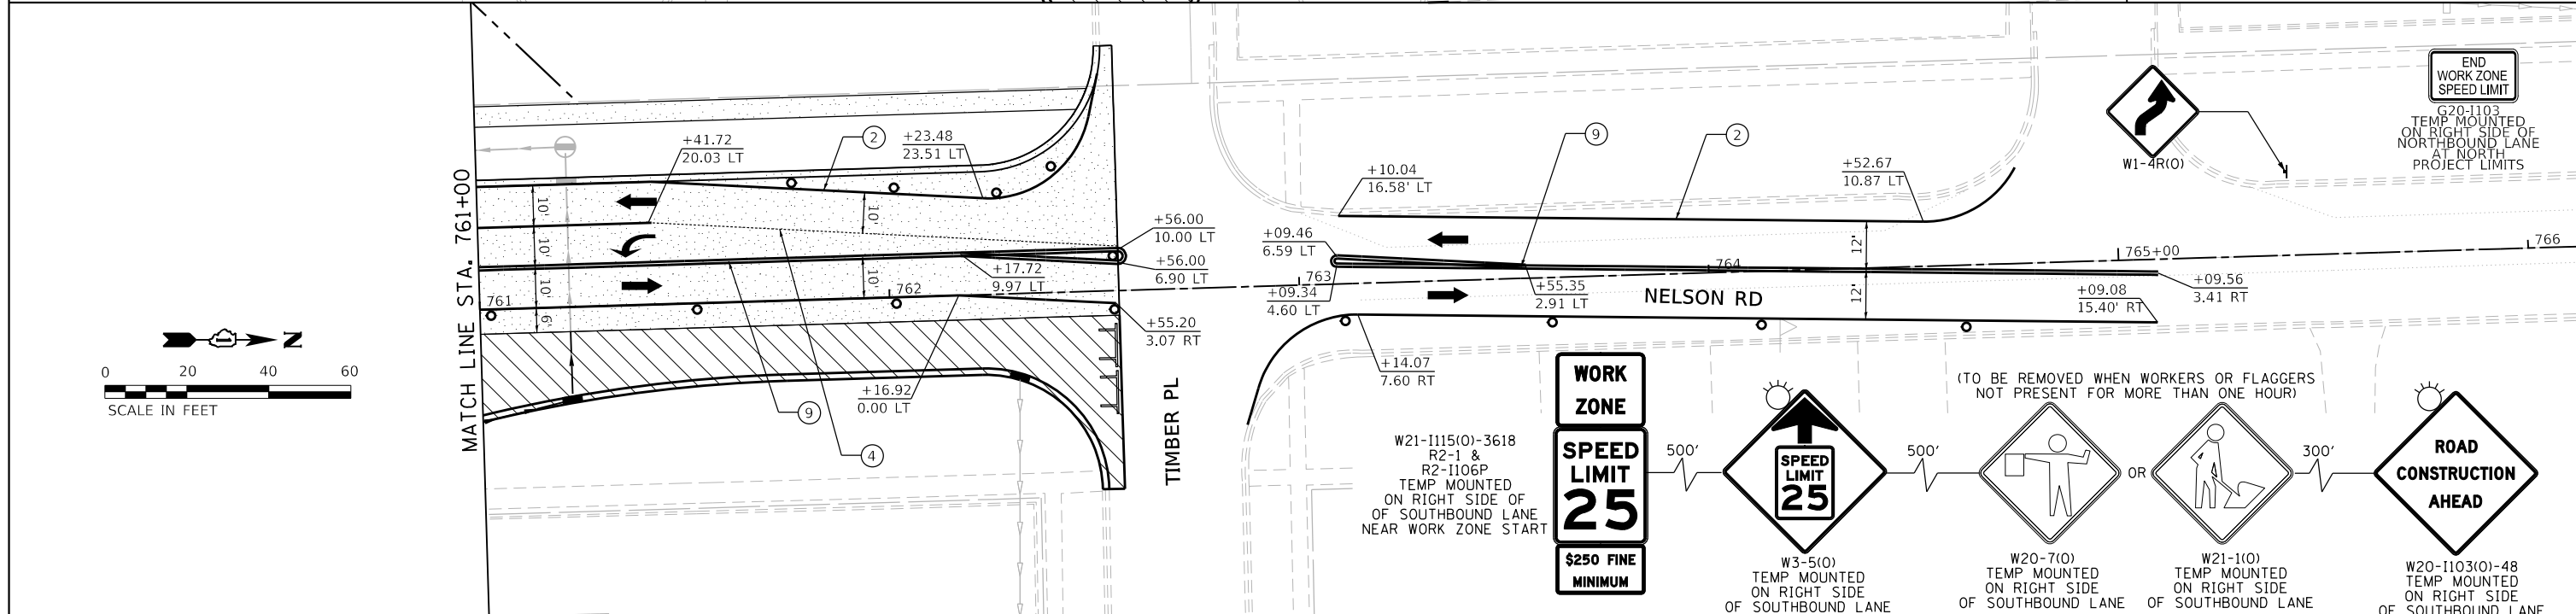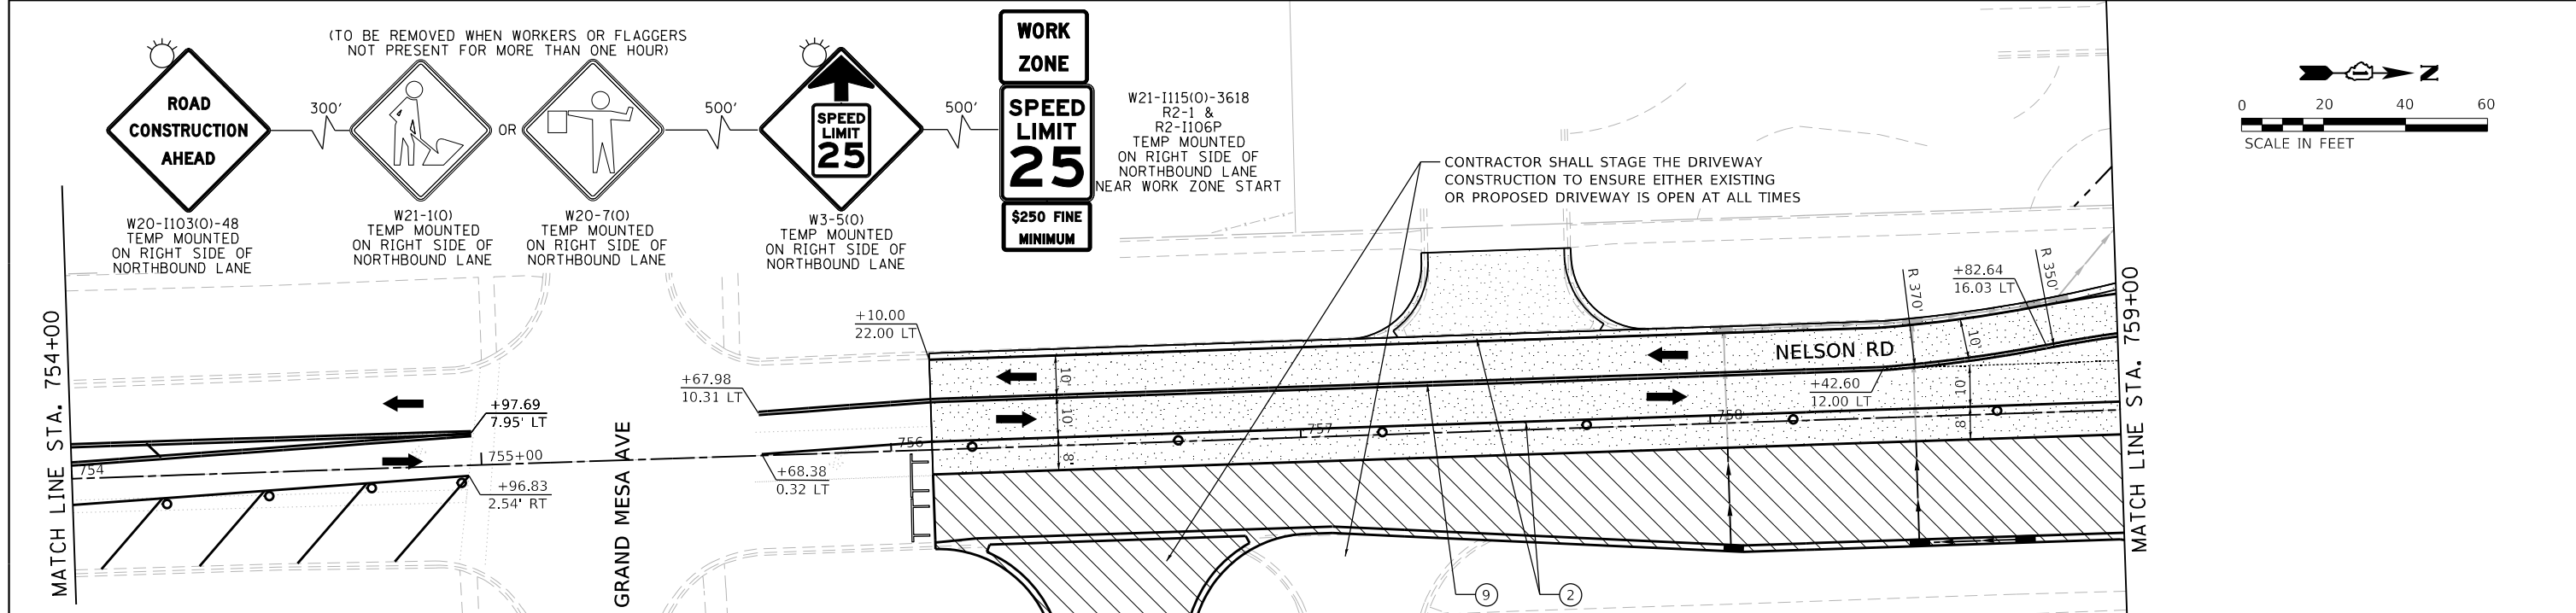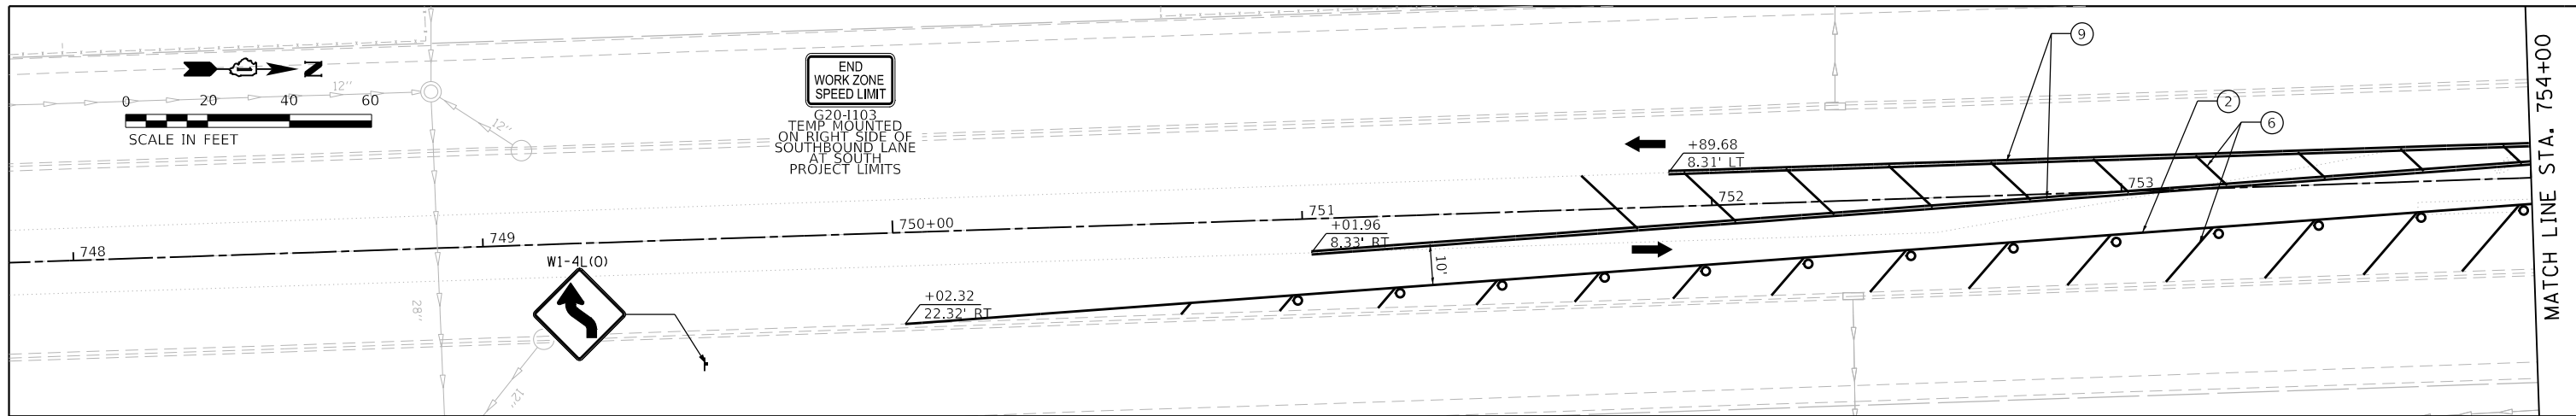F.A.U. RTE.	SECTION	COUNTY	TOTAL SHEETS	SHEET NO.
0320	13-00138-37-PV	WILL	413	121
CONTRACT NO. 61H20				
ILLINOIS FED. AID PROJECT				



NOTES:

- FOLLOWING COMPLETION OF PROPOSED PAVEMENT TO TOP OF BINDER COURSE, TEMPORARY PAVEMENT AND TEMPORARY PAVEMENT (VARIABLE DEPTH) WILL BE INSTALLED AS DETAILED.
- WHEN TEMP PAVEMENT IS PLACED ABOVE PROPOSED PAVEMENT, A BOND BREAKER WILL BE INSTALLED TO ALLOW CLEAN REMOVAL OF TEMPORARY PAVEMENT (VARIABLE DEPTH)
- WHERE EXISTING PAVEMENT INTERFERES WITH TEMPORARY PAVEMENT, THE EXISTING PAVEMENT WILL BE SAW CUT AND REMOVED.

LEGEND

	VERTICAL PANEL WITH STEADY BURN LIGHT, (50' C-C TYP., 25' C-C ON TAPERS & CURVES)		TEMPORARY PAVEMENT WIDENING CONSTRUCTED CURRENT STAGE
	DRUM WITH STEADY-BURN LIGHT, (50' C-C TYP., 25' C-C ON TAPERS & CURVES)		TEMPORARY PAVEMENT WIDENING CONSTRUCTED PREVIOUS STAGE
	TYPE II BARRICADE WITH STEADY-BURN LIGHT, (50' C-C TYP., 25' C-C ON TAPERS & CURVES)		COMPLETED PAVEMENT (TO TOP OF BINDER COURSE)
	TEMPORARY CONCRETE BARRIER		WORK ZONE
	DIRECTION OF TRAFFIC		PAVEMENT PATCHING CLASS D (SEE PAVEMENT PATCHING TABLE)
	STORM SEWER CONSTRUCTED THIS STAGE		AGGREGATE FOR TEMPORARY ACCESS
	STORM SEWER CONSTRUCTED PREVIOUS STAGE		




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**STATE OF ILLINOIS
 DEPARTMENT OF TRANSPORTATION**


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 STAGE 1C - TEMPORARY PAVEMENT**

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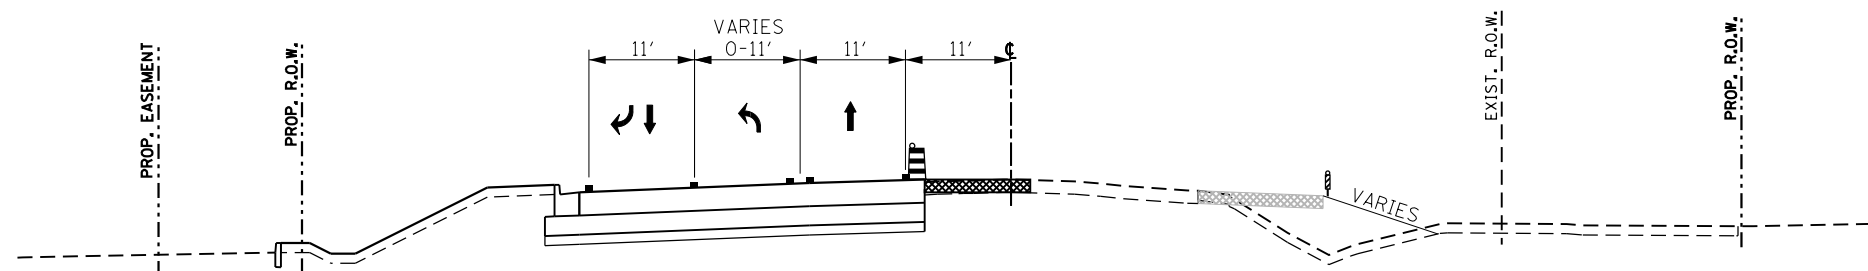
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CONTRACT NO. 61H20				
ILLINOIS		FED. AID PROJECT		



STAGE 2A TYPICAL SECTION
STA 136+75 TO 142+12.80

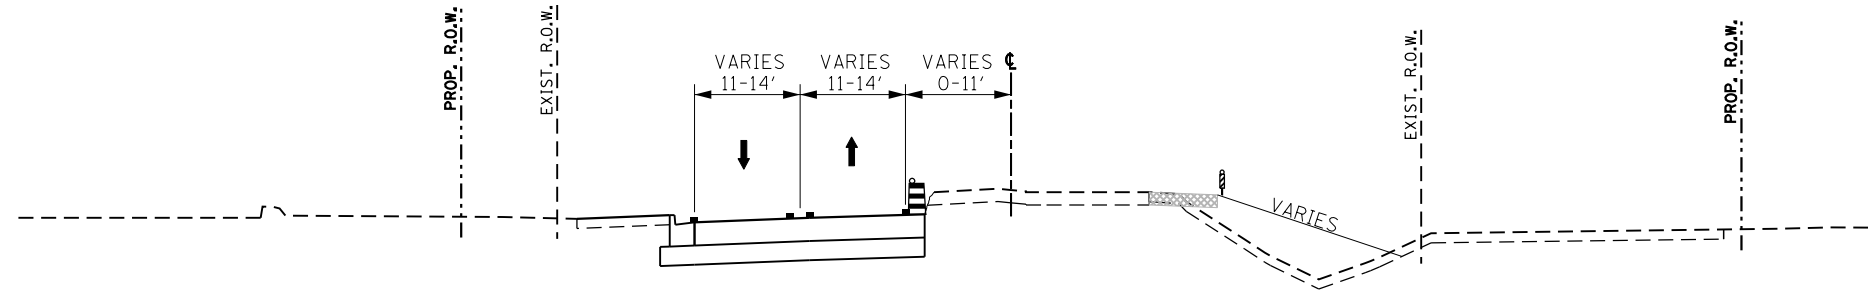

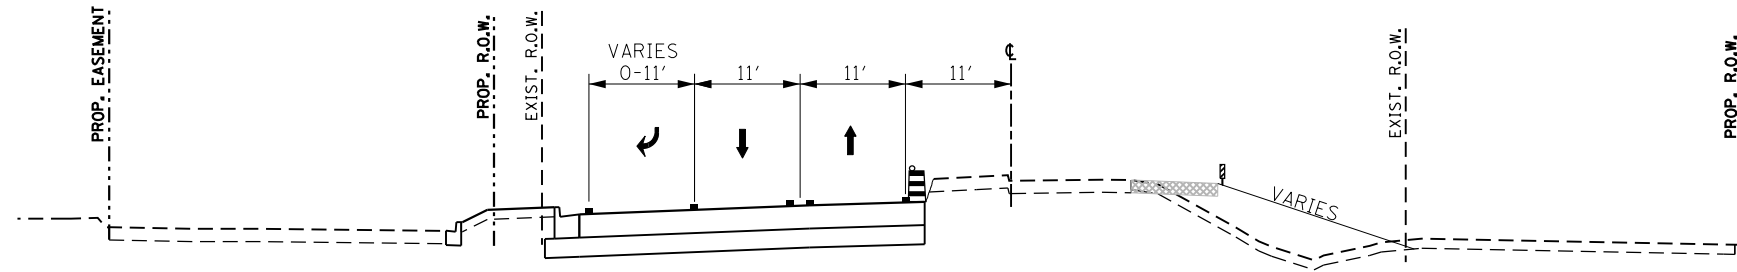






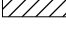


STAGE 2A TYPICAL SECTION
STA 142+12.80 TO 155+60



STAGE 2A TYPICAL SECTION
STA 155+60 TO 160+25

LEGEND

-  TEMPORARY PAVEMENT MARKING LINE
-  VERTICAL PANEL WITH STEADY BURN LIGHT AS REQUIRED BY SPECIFICATIONS. (50' C-C TYP., 25' C-C ON TAPERS & CURVES)
-  DRUM WITH STEADY-BURN LIGHT AS REQUIRED BY SPECIFICATIONS. (50' C-C TYP., 25' C-C ON TAPERS & CURVES)
-  TYPE II BARRICADE WITH STEADY-BURN LIGHT AS REQUIRED BY SPECIFICATIONS. (50' C-C TYP., 25' C-C ON TAPERS & CURVES)
-  TEMPORARY CONCRETE BARRIER WITH TYPE C REFLECTORS
-  DIRECTION OF TRAFFIC
-  TEMPORARY PAVEMENT WIDENING CONSTRUCTED CURRENT STAGE
-  TEMPORARY PAVEMENT WIDENING CONSTRUCTED PREVIOUS STAGE
-  COMPLETED PAVEMENT
-  WORK ZONE




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STATE OF ILLINOIS
DEPARTMENT OF TRANSPORTATION


SUGGESTED SEQUENCE OF CONSTRUCTION
STAGE 2A TYPICAL SECTION - LARAWAY RD

SCALE: SHEET 1 OF 4 SHEETS STA. TO STA.


F.A.U. RTE.	SECTION	COUNTY	TOTAL SHEETS	SHEET NO.
0320	13-00138-37-PV	WILL	413	123
CONTRACT NO. 61H20				
ILLINOIS FED. AID PROJECT				

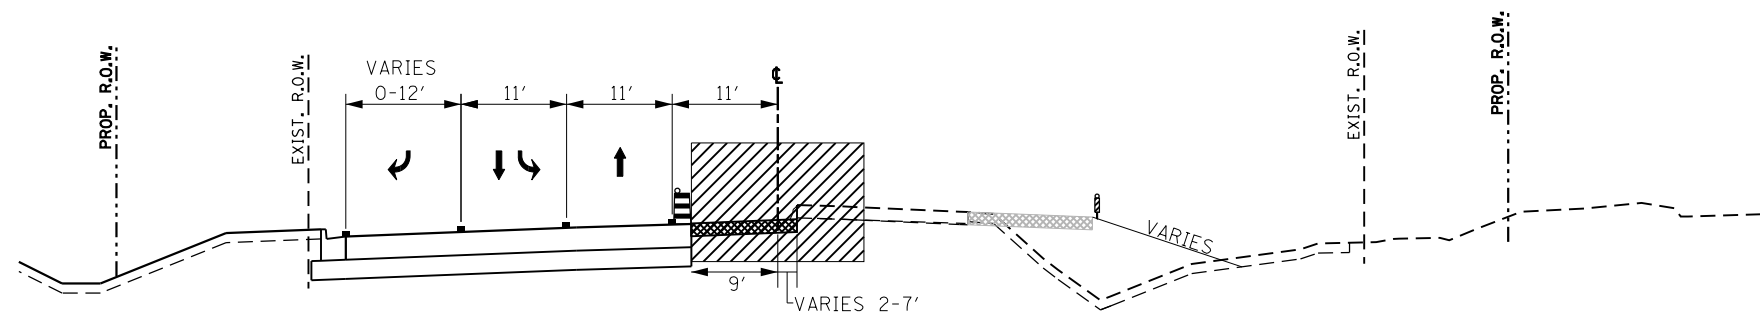

STAGE 2A TYPICAL SECTION
160+25 TO 181+32.50

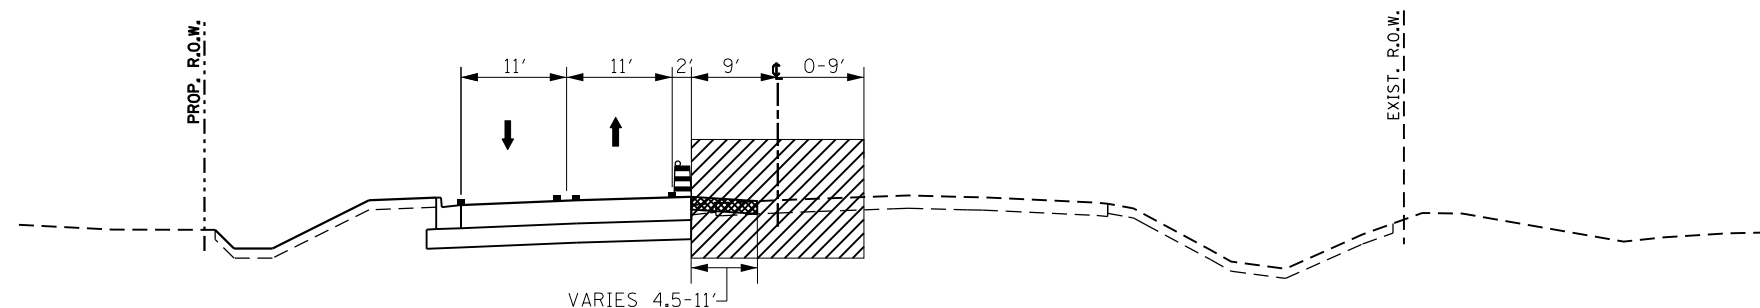

STAGE 2A TYPICAL SECTION
STA 181+32.50 TO 188+81

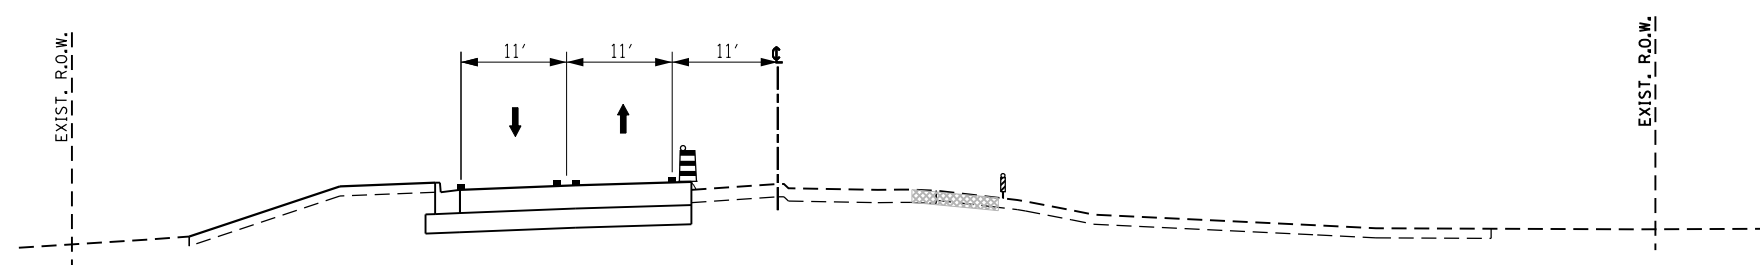

STAGE 2A TYPICAL SECTION
STA 188+81 TO 191+85

LEGEND



	TEMPORARY PAVEMENT MARKING LINE		TEMPORARY PAVEMENT WIDENING CONSTRUCTED CURRENT STAGE
	VERTICAL PANEL WITH STEADY BURN LIGHT AS REQUIRED BY SPECIFICATIONS. (50' C-C TYP., 25' C-C ON TAPERS & CURVES)		TEMPORARY PAVEMENT WIDENING CONSTRUCTED PREVIOUS STAGE
	DRUM WITH STEADY-BURN LIGHT AS REQUIRED BY SPECIFICATIONS. (50' C-C TYP., 25' C-C ON TAPERS & CURVES)		COMPLETED PAVEMENT
	TYPE II BARRICADE WITH STEADY-BURN LIGHT AS REQUIRED BY SPECIFICATIONS. (50' C-C TYP., 25' C-C ON TAPERS & CURVES)		WORK ZONE
	TEMPORARY CONCRETE BARRIER WITH TYPE C REFLECTORS		
	DIRECTION OF TRAFFIC		

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**STATE OF ILLINOIS
DEPARTMENT OF TRANSPORTATION**

SUGGESTED SEQUENCE OF CONSTRUCTION			
STAGE 2A TYPICAL SECTION - LARAWAY RD			
SCALE:	SHEET 2	OF 4	SHEETS
	STA.		TO STA.

F.A.U. RTE.	SECTION	COUNTY	TOTAL SHEETS	SHEET NO.
0320	13-00138-37-PV	WILL	413	124
CONTRACT NO. 61H20				
ILLINOIS FED. AID PROJECT				

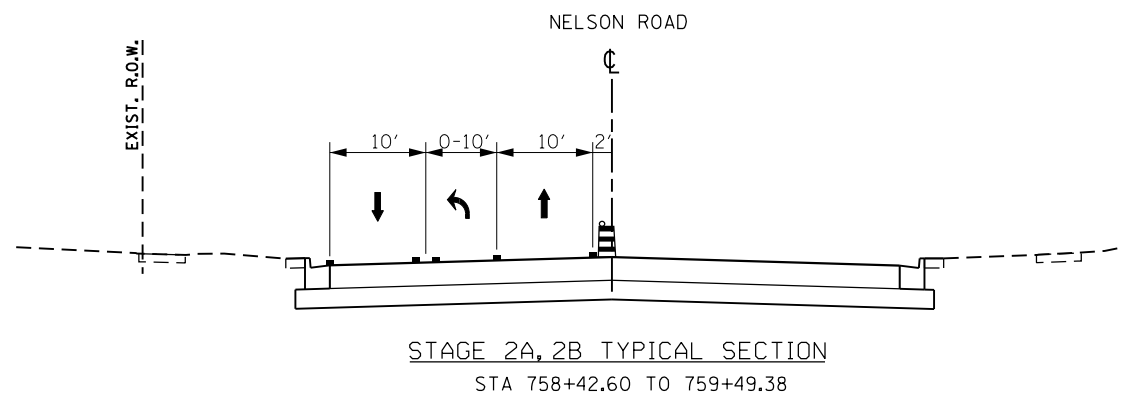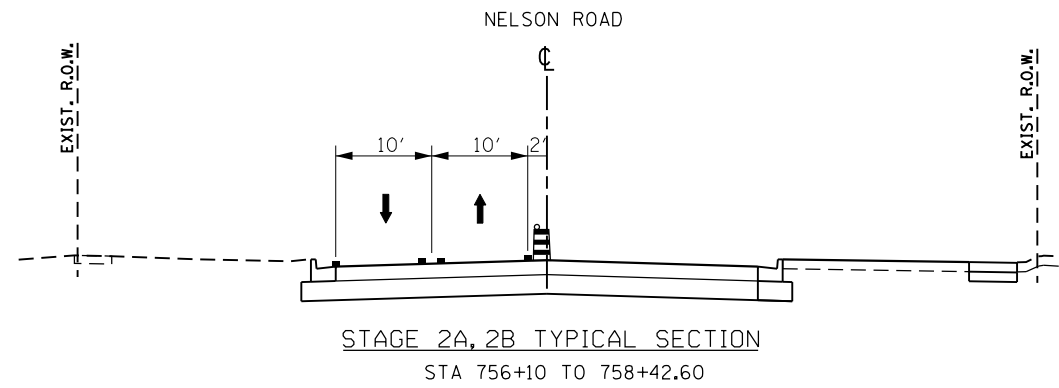

LEGEND

	TEMPORARY PAVEMENT MARKING LINE		TEMPORARY PAVEMENT WIDENING CONSTRUCTED CURRENT STAGE
	VERTICAL PANEL WITH STEADY BURN LIGHT AS REQUIRED BY SPECIFICATIONS. (50' C-C TYP., 25' C-C ON TAPERS & CURVES)		TEMPORARY PAVEMENT WIDENING CONSTRUCTED PREVIOUS STAGE
	DRUM WITH STEADY-BURN LIGHT AS REQUIRED BY SPECIFICATIONS. (50' C-C TYP., 25' C-C ON TAPERS & CURVES)		COMPLETED PAVEMENT
	TYPE II BARRICADE WITH STEADY-BURN LIGHT AS REQUIRED BY SPECIFICATIONS. (50' C-C TYP., 25' C-C ON TAPERS & CURVES)		WORK ZONE
	TEMPORARY CONCRETE BARRIER WITH TYPE C REFLECTORS		
	DIRECTION OF TRAFFIC		





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PLOT DATE = 9/9/2022 - 12:15:46 PM	DATE - 09/09/2022	REVISED -

STATE OF ILLINOIS
DEPARTMENT OF TRANSPORTATION

SUGGESTED SEQUENCE OF CONSTRUCTION
STAGE 2A TYPICAL SECTION - NELSON RD

SCALE: SHEET 3 OF 4 SHEETS STA. TO STA.

F.A.U. RTE.	SECTION	COUNTY	TOTAL SHEETS	SHEET NO.
0320	13-00138-37-PV	WILL	413	125
CONTRACT NO. 61H20				
ILLINOIS		FED. AID PROJECT		

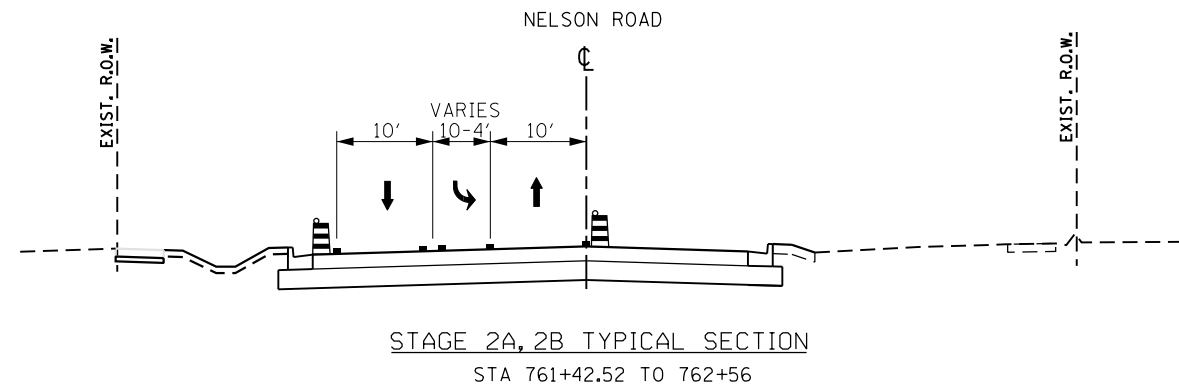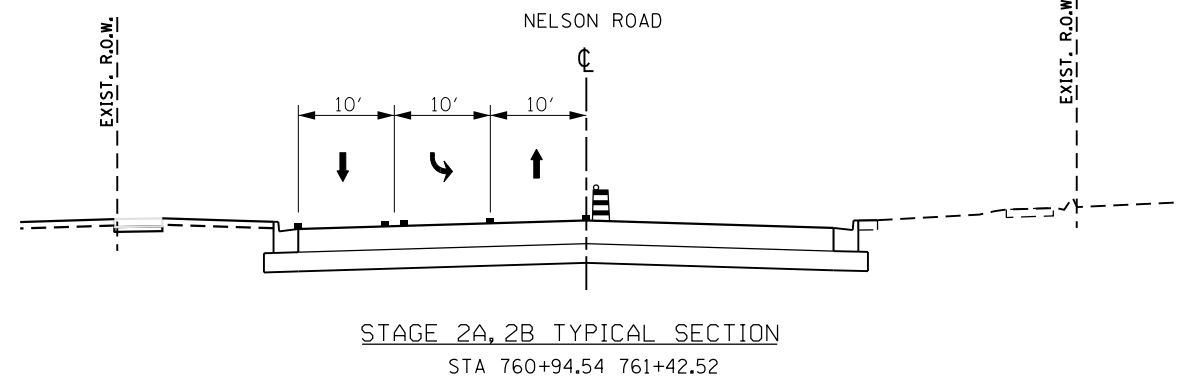

LEGEND

	TEMPORARY PAVEMENT MARKING LINE		TEMPORARY PAVEMENT WIDENING CONSTRUCTED CURRENT STAGE
	VERTICAL PANEL WITH STEADY BURN LIGHT AS REQUIRED BY SPECIFICATIONS. (50' C-C TYP., 25' C-C ON TAPERS & CURVES)		TEMPORARY PAVEMENT WIDENING CONSTRUCTED PREVIOUS STAGE
	DRUM WITH STEADY-BURN LIGHT AS REQUIRED BY SPECIFICATIONS. (50' C-C TYP., 25' C-C ON TAPERS & CURVES)		COMPLETED PAVEMENT
	TYPE II BARRICADE WITH STEADY-BURN LIGHT AS REQUIRED BY SPECIFICATIONS. (50' C-C TYP., 25' C-C ON TAPERS & CURVES)		WORK ZONE
	TEMPORARY CONCRETE BARRIER WITH TYPE C REFLECTORS		
	DIRECTION OF TRAFFIC		



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FILE NAME =	sht-staging-tp-Nelson-stage02A-02.dgn	DESIGNED -	PML	REVISED -	
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PLOT DATE =	9/9/2022 - 12:15:47 PM	DATE -	09/09/2022	REVISED -	

**STATE OF ILLINOIS
DEPARTMENT OF TRANSPORTATION**

**SUGGESTED SEQUENCE OF CONSTRUCTION
STAGE 2A TYPICAL SECTION - NELSON RD**



SCALE: SHEET 4 OF 4 SHEETS STA. TO STA.

F.A.U. RTE.	SECTION	COUNTY	TOTAL SHEETS	SHEET NO.
0320	13-00138-37-PV	WILL	413	126
CONTRACT NO. 61H20				
ILLINOIS			FED. AID PROJECT	

PLOT DRIVER
PENTABLE = Laraway_slipfig.dwg

PLOT SCALE
PLOT DATE = 40.0000 / in
= 9/9/2022 (12:15:52 PM)

USER NAME
DIRECTORY = M:\s_moss
= L:\MILL\017204-01\Draw\CADD_Sheets\

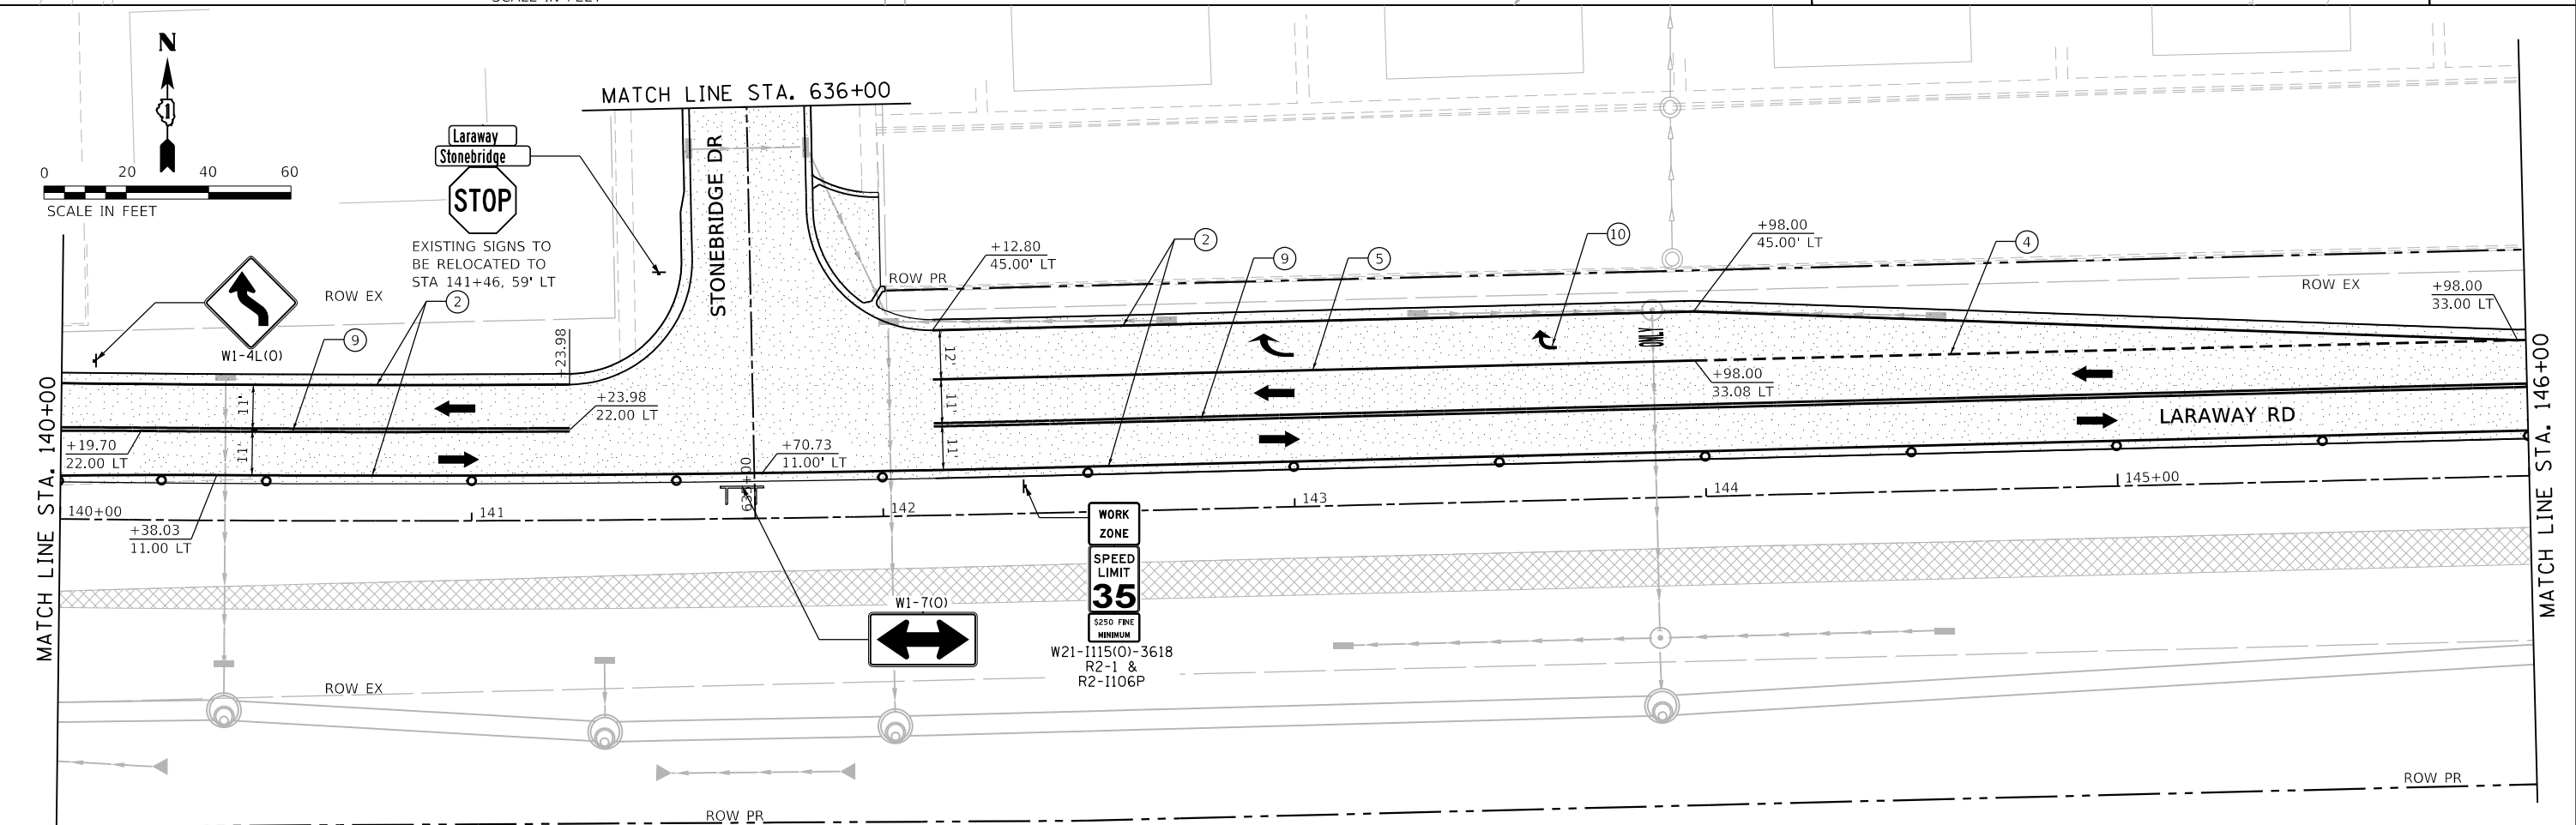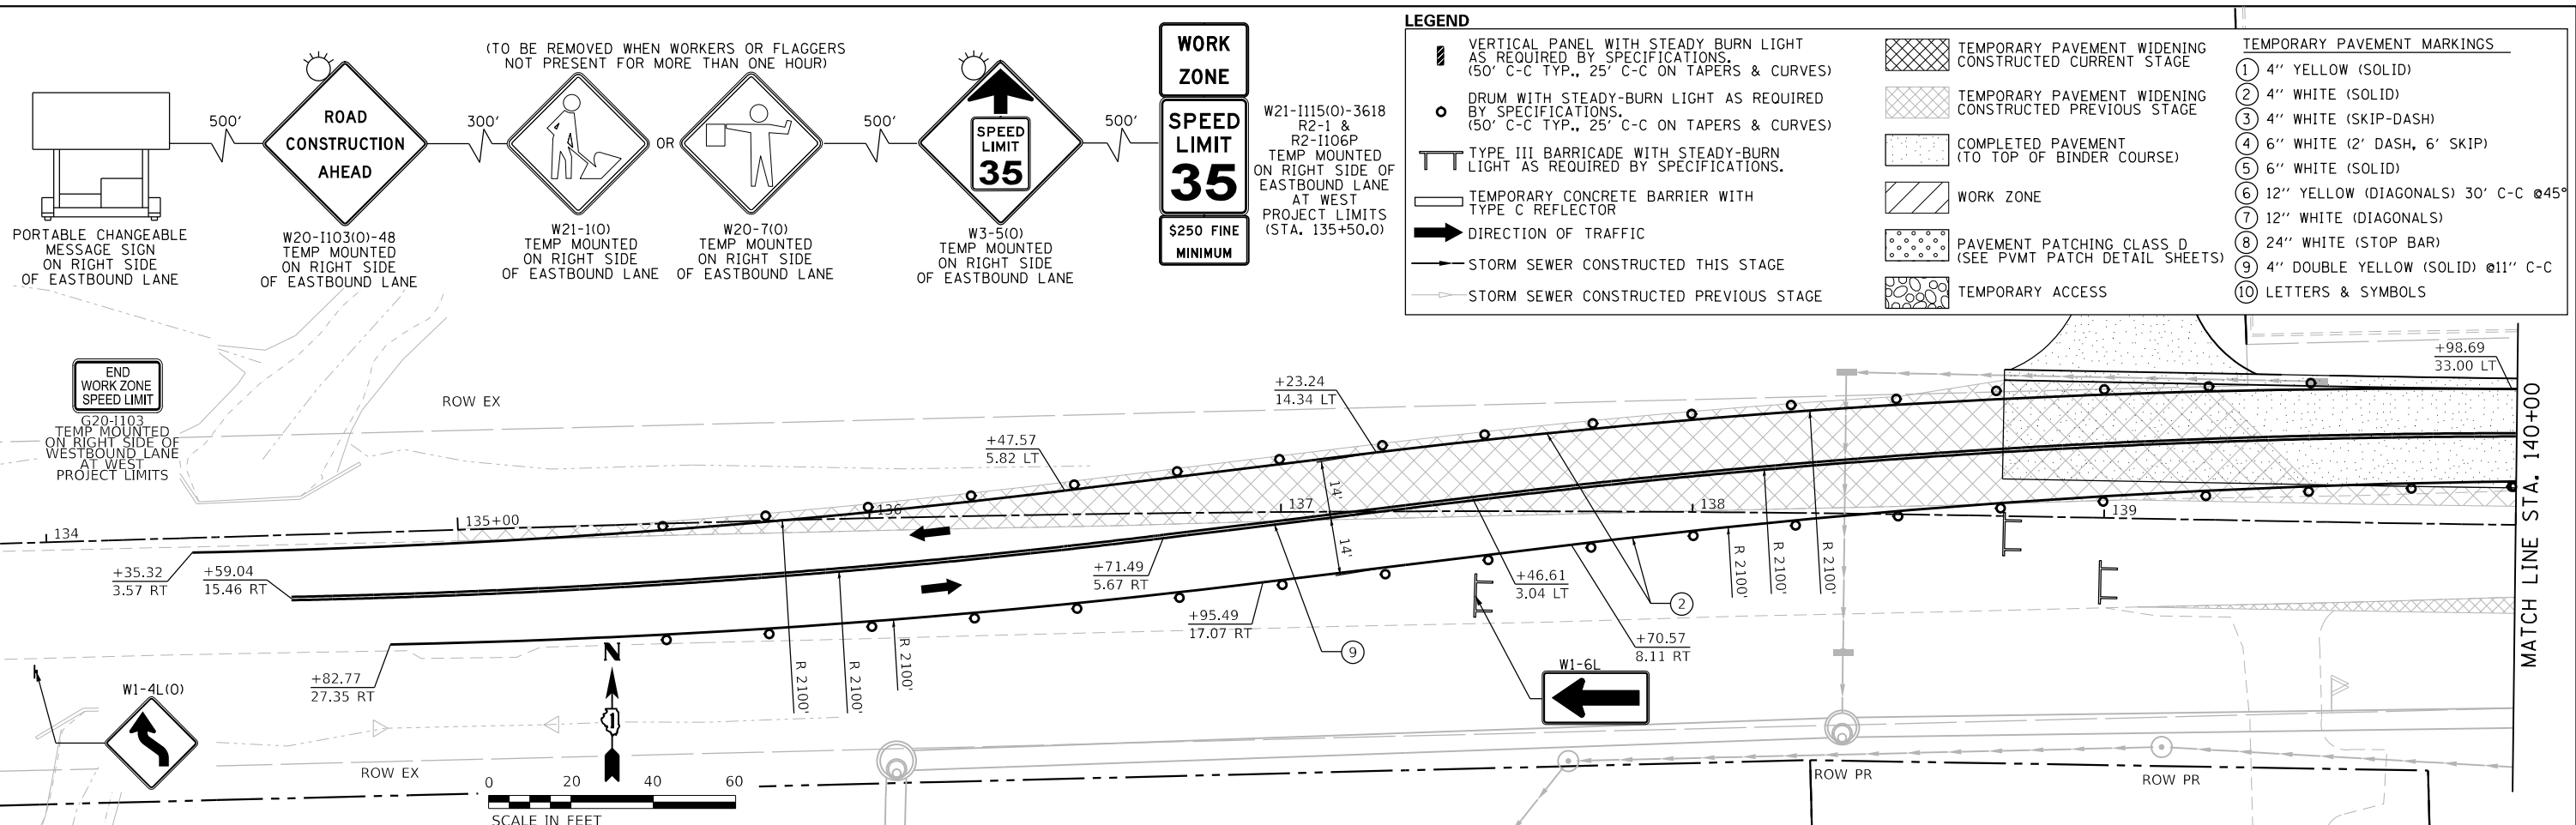

FILE NAME =	shf-staging-stage02A-01.dgn	DESIGNED -	JMS	REVISED -	
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STATE OF ILLINOIS
DEPARTMENT OF TRANSPORTATION


SUGGESTED SEQUENCE OF CONSTRUCTION			
LARAWAY RD - STAGE 2A			
SCALE: 1"=20'	SHEET 1	OF 7 SHEETS	STA. 134+00 TO STA. 146+00

F.A.U. RTE.	SECTION	COUNTY	TOTAL SHEETS	SHEET NO.
0320	13-00138-37-PV	WILL	413	127
CONTRACT NO. 61H20				
ILLINOIS FED. AID PROJECT				

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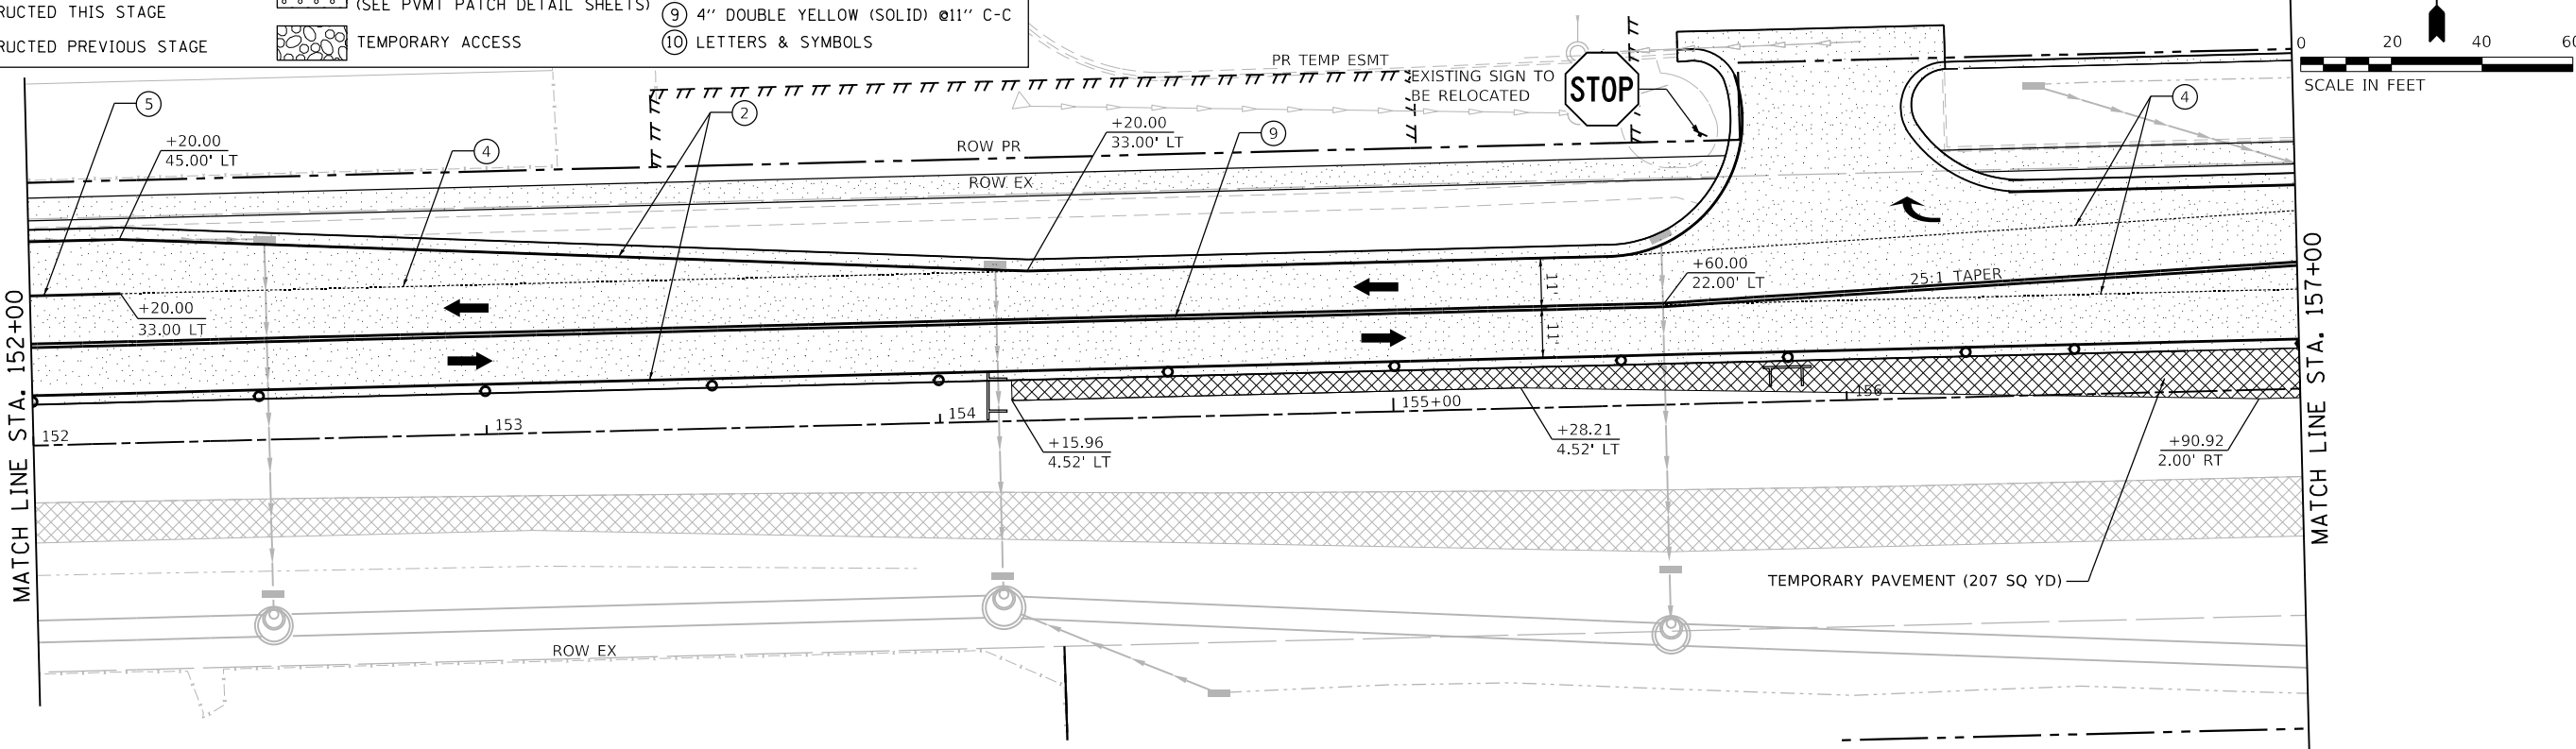
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PLOT DATE = 9/9/2022 (12:15:53 PM)

USER NAME = Mike Moses
DIRECTORY = L:\MILL\017204-01\Drawn\CADD_Sheets\

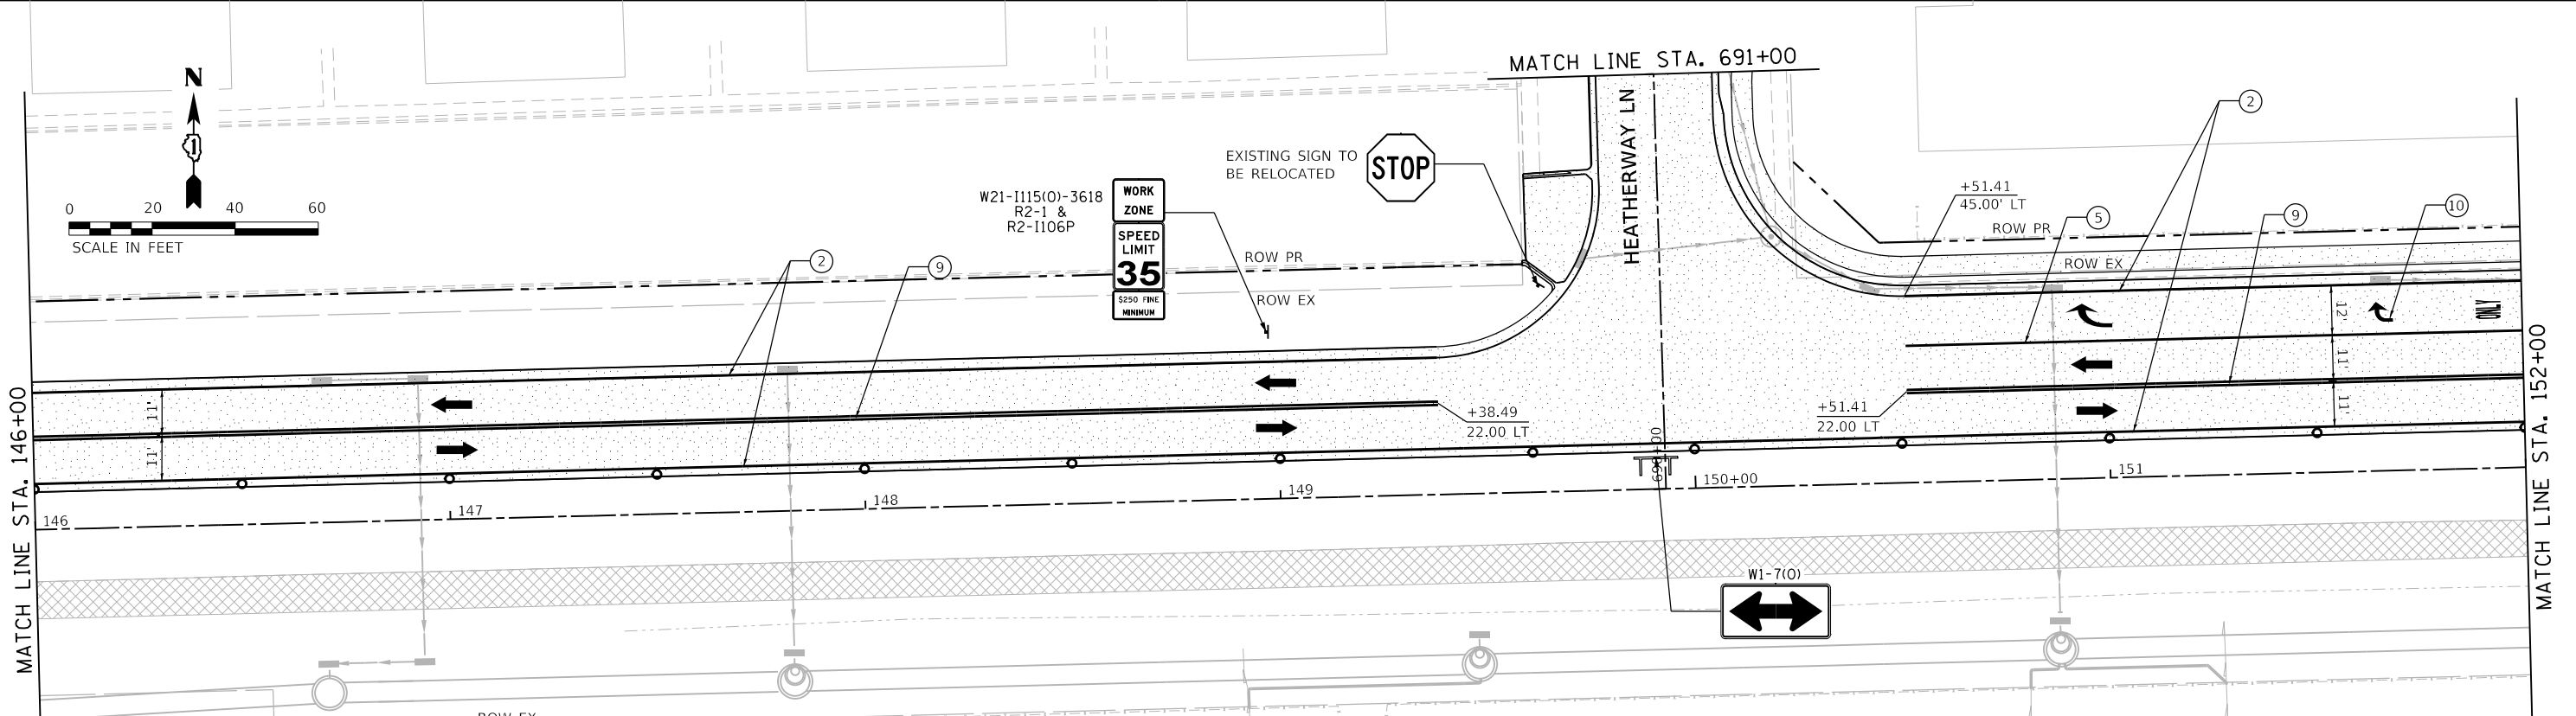

LEGEND

	VERTICAL PANEL WITH STEADY BURN LIGHT AS REQUIRED BY SPECIFICATIONS. (50' C-C TYP., 25' C-C ON TAPERS & CURVES)		TEMPORARY PAVEMENT WIDENING CONSTRUCTED CURRENT STAGE	TEMPORARY PAVEMENT MARKINGS
	DRUM WITH STEADY-BURN LIGHT AS REQUIRED BY SPECIFICATIONS. (50' C-C TYP., 25' C-C ON TAPERS & CURVES)		TEMPORARY PAVEMENT WIDENING CONSTRUCTED PREVIOUS STAGE	① 4" YELLOW (SOLID)
	TYPE III BARRICADE WITH STEADY-BURN LIGHT AS REQUIRED BY SPECIFICATIONS.		COMPLETED PAVEMENT (TO TOP OF BINDER COURSE)	② 4" WHITE (SOLID)
	TEMPORARY CONCRETE BARRIER WITH TYPE C REFLECTOR		WORK ZONE	③ 4" WHITE (SKIP-DASH)
	DIRECTION OF TRAFFIC		PAVEMENT PATCHING CLASS D (SEE PVMT PATCH DETAIL SHEETS)	④ 6" WHITE (2' DASH, 6' SKIP)
	STORM SEWER CONSTRUCTED THIS STAGE		TEMPORARY ACCESS	⑤ 6" WHITE (SOLID)
	STORM SEWER CONSTRUCTED PREVIOUS STAGE			⑥ 12" YELLOW (DIAGONALS) 30' C-C @45°
				⑦ 12" WHITE (DIAGONALS)
				⑧ 24" WHITE (STOP BAR)
				⑨ 4" DOUBLE YELLOW (SOLID) @11" C-C
				⑩ LETTERS & SYMBOLS




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PLOT DATE = 9/9/2022 - 12:15:53 PM	DATE - 09/09/2022	REVISED -

**STATE OF ILLINOIS
DEPARTMENT OF TRANSPORTATION**

**SUGGESTED SEQUENCE OF CONSTRUCTION
LARAWAY RD - STAGE 2A**

SCALE: 1"=20' SHEET 2 OF 7 SHEETS STA. 146+00 TO STA. 157+00


F.A.U. RTE. 0320	SECTION 13-00138-37-PV	COUNTY WILL	TOTAL SHEETS 413	SHEET NO. 128
CONTRACT NO. 61H20				
ILLINOIS FED. AID PROJECT				

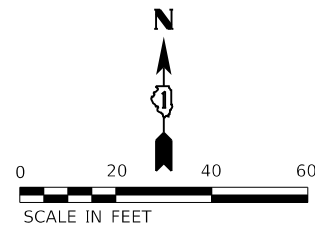

PIPELINE STAGING NOTES:

- CONTRACTOR MUST CONTACT PIPELINE COMPANIES TO COORDINATE ALL WORK IN THE VICINITY OF THE PIPELINES. CONTRACTOR MUST FOLLOW ALL REQUIREMENTS OF THESE PLANS, SPECIFICATIONS, PIPELINE ENCROACHMENT GUIDELINES, AND ANY OTHER REQUIREMENTS COMMUNICATED BY PIPELINE COMPANY REPRESENTATIVES REGARDING WORK AROUND THE PIPELINES.



BP PIPELINES OF AMERICA STEVE ADAMS OFFICE: 779.801.4969 EMAIL: steve.adams@bp.com	ENTERPRISE PRODUCTS BLAKE HAMILTON OFFICE: 815.277.7286 CELL: 217.508.2991 EMAIL: bdhamilton@eprod.com
---	--
- TEMPORARY FENCE SHALL BE REPOSITIONED TO A LOCATION APPROVED BY THE ENGINEER AND THE PIPELINE REPRESENTATIVES TO LIMIT EQUIPMENT CROSSING TO A 15' WIDE OPENING PERPENDICULAR TO PIPELINES. 5' GAP IN FENCE IS PERMITTED TO ALLOW PEDESTRAIN PASSAGE.
- SEE SHEET 217 FOR ADDITIONAL INFORMATION ON ENTERPRISE PRODUCTS PIPELINE AND SHEET 218 FOR ADDITIONAL INFORMATION OF BP PIPELINES OF AMERICA PIPELINE.

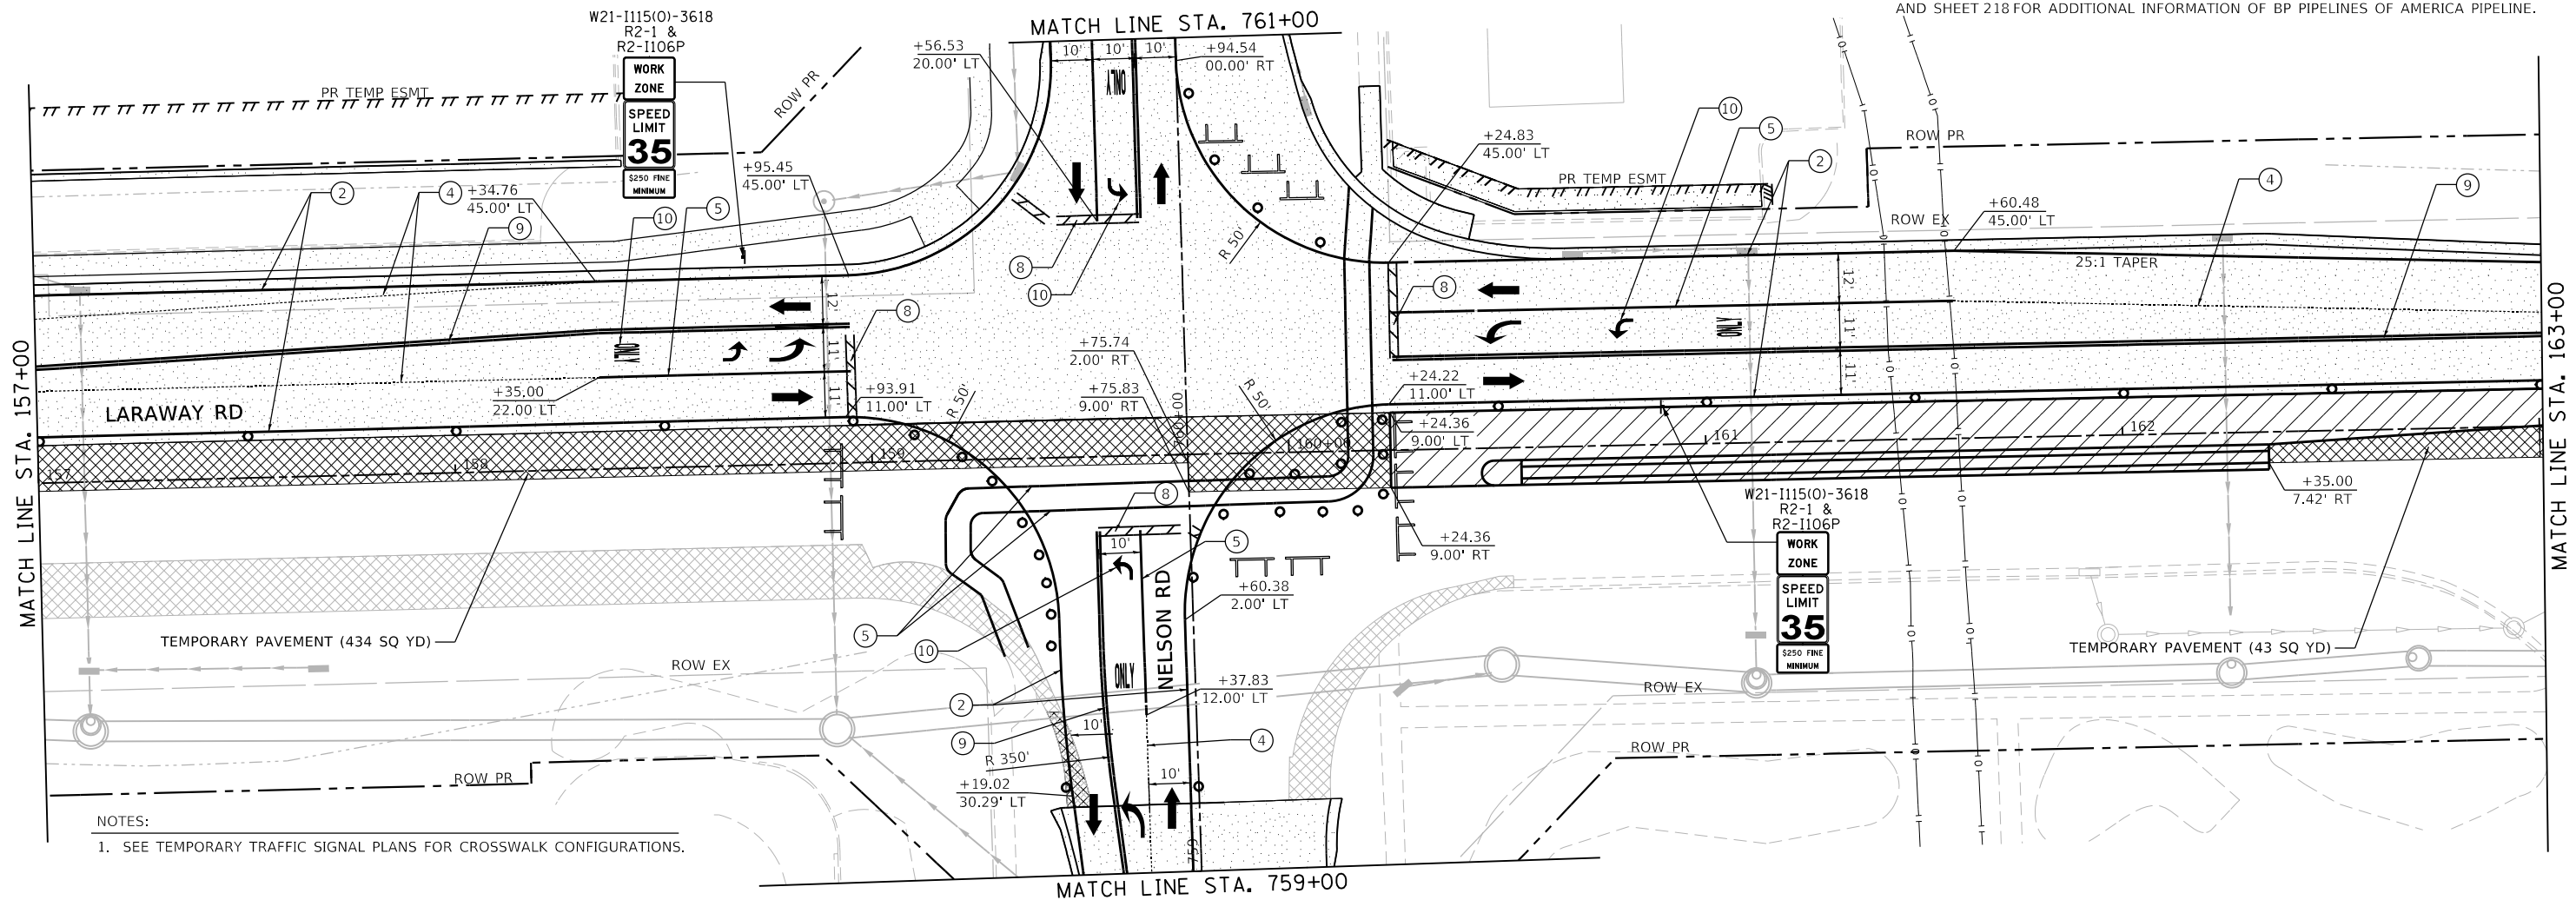

NOTES:
1. SEE TEMPORARY TRAFFIC SIGNAL PLANS FOR CROSSWALK CONFIGURATIONS.

LEGEND

VERTICAL PANEL WITH STEADY BURN LIGHT AS REQUIRED BY SPECIFICATIONS. (50' C-C TYP., 25' C-C ON TAPERS & CURVES)	TEMPORARY PAVEMENT WIDENING CONSTRUCTED CURRENT STAGE	TEMPORARY PAVEMENT MARKINGS
DRUM WITH STEADY-BURN LIGHT AS REQUIRED BY SPECIFICATIONS. (50' C-C TYP., 25' C-C ON TAPERS & CURVES)	TEMPORARY PAVEMENT WIDENING CONSTRUCTED PREVIOUS STAGE	① 4" YELLOW (SOLID)
TYPE III BARRICADE WITH STEADY-BURN LIGHT AS REQUIRED BY SPECIFICATIONS.	COMPLETED PAVEMENT (TO TOP OF BINDER COURSE)	② 4" WHITE (SOLID)
TEMPORARY CONCRETE BARRIER WITH TYPE C REFLECTOR	WORK ZONE	③ 4" WHITE (SKIP-DASH)
DIRECTION OF TRAFFIC	PAVEMENT PATCHING CLASS D (SEE PVMT PATCH DETAIL SHEETS)	④ 6" WHITE (2' DASH, 6' SKIP)
STORM SEWER CONSTRUCTED THIS STAGE	TEMPORARY ACCESS	⑤ 6" WHITE (SOLID)
STORM SEWER CONSTRUCTED PREVIOUS STAGE		⑥ 12" YELLOW (DIAGONALS) 30' C-C @45°
		⑦ 12" WHITE (DIAGONALS)
		⑧ 24" WHITE (STOP BAR)
		⑨ 4" DOUBLE YELLOW (SOLID) @11" C-C
		⑩ LETTERS & SYMBOLS

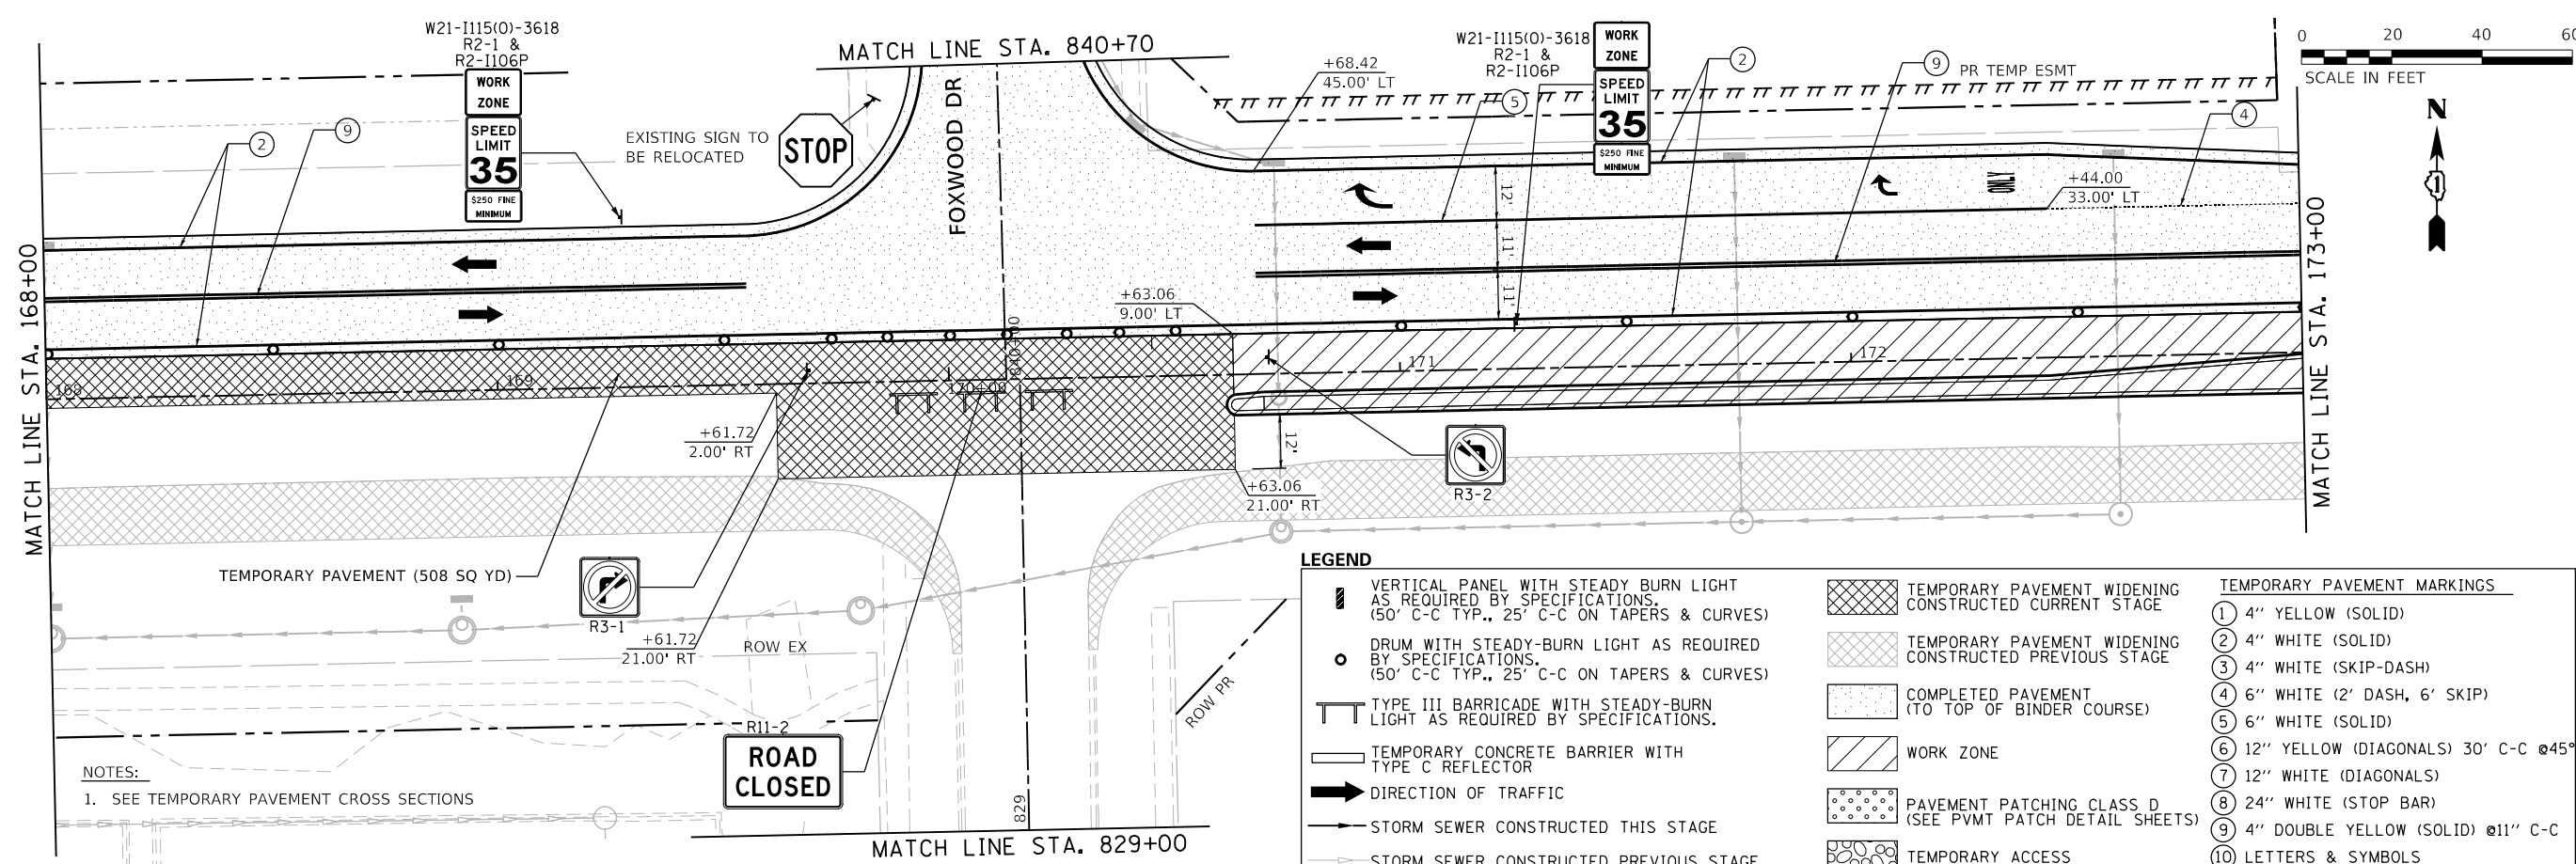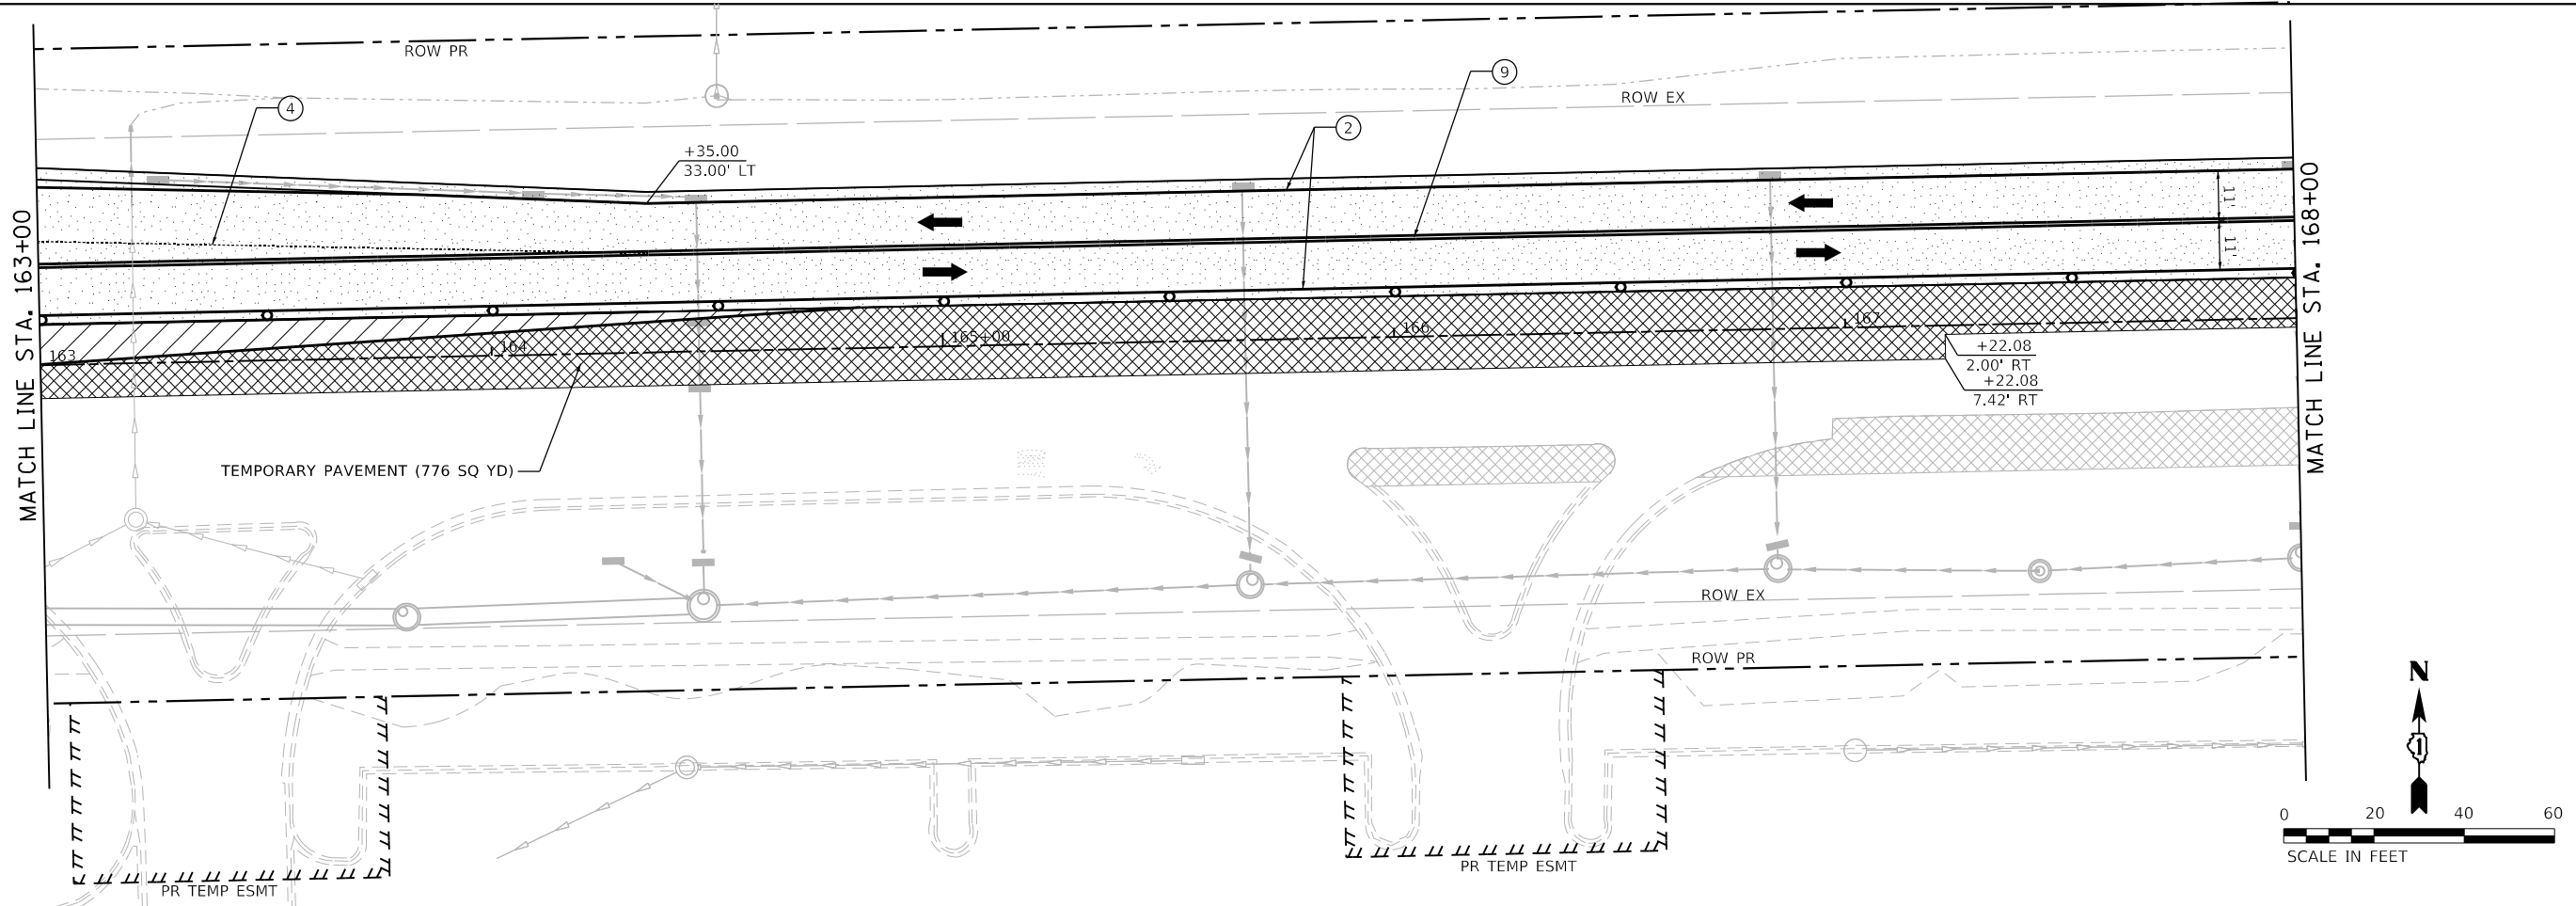

NOTES:
1. SEE TEMPORARY PAVEMENT CROSS SECTIONS

LEGEND		TEMPORARY PAVEMENT MARKINGS	
	VERTICAL PANEL WITH STEADY BURN LIGHT AS REQUIRED BY SPECIFICATIONS. (50' C-C TYP., 25' C-C ON TAPERS & CURVES)		TEMPORARY PAVEMENT WIDENING CONSTRUCTED CURRENT STAGE
	DRUM WITH STEADY-BURN LIGHT AS REQUIRED BY SPECIFICATIONS. (50' C-C TYP., 25' C-C ON TAPERS & CURVES)		TEMPORARY PAVEMENT WIDENING CONSTRUCTED PREVIOUS STAGE
	TYPE III BARRICADE WITH STEADY-BURN LIGHT AS REQUIRED BY SPECIFICATIONS.		COMPLETED PAVEMENT (TO TOP OF BINDER COURSE)
	TEMPORARY CONCRETE BARRIER WITH TYPE C REFLECTOR		WORK ZONE
	DIRECTION OF TRAFFIC		PAVEMENT PATCHING CLASS D (SEE PVMT PATCH DETAIL SHEETS)
	STORM SEWER CONSTRUCTED THIS STAGE		TEMPORARY ACCESS
	STORM SEWER CONSTRUCTED PREVIOUS STAGE		
			① 4" YELLOW (SOLID)
			② 4" WHITE (SOLID)
			③ 4" WHITE (SKIP-DASH)
			④ 6" WHITE (2' DASH, 6' SKIP)
			⑤ 6" WHITE (SOLID)
			⑥ 12" YELLOW (DIAGONALS) 30' C-C @45°
			⑦ 12" WHITE (DIAGONALS)
			⑧ 24" WHITE (STOP BAR)
			⑨ 4" DOUBLE YELLOW (SOLID) @11" C-C
			⑩ LETTERS & SYMBOLS




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STATE OF ILLINOIS
DEPARTMENT OF TRANSPORTATION


SUGGESTED SEQUENCE OF CONSTRUCTION			
LARAWAY RD - STAGE 2A			
SCALE: 1"=20'	SHEET 4	OF 7 SHEETS	STA. 163+00 TO STA. 173+00

F.A.U. RTE.	SECTION	COUNTY	TOTAL SHEETS	SHEET NO.
0320	13-00138-37-PV	WILL	413	130
CONTRACT NO. 61H20				
ILLINOIS FED. AID PROJECT				

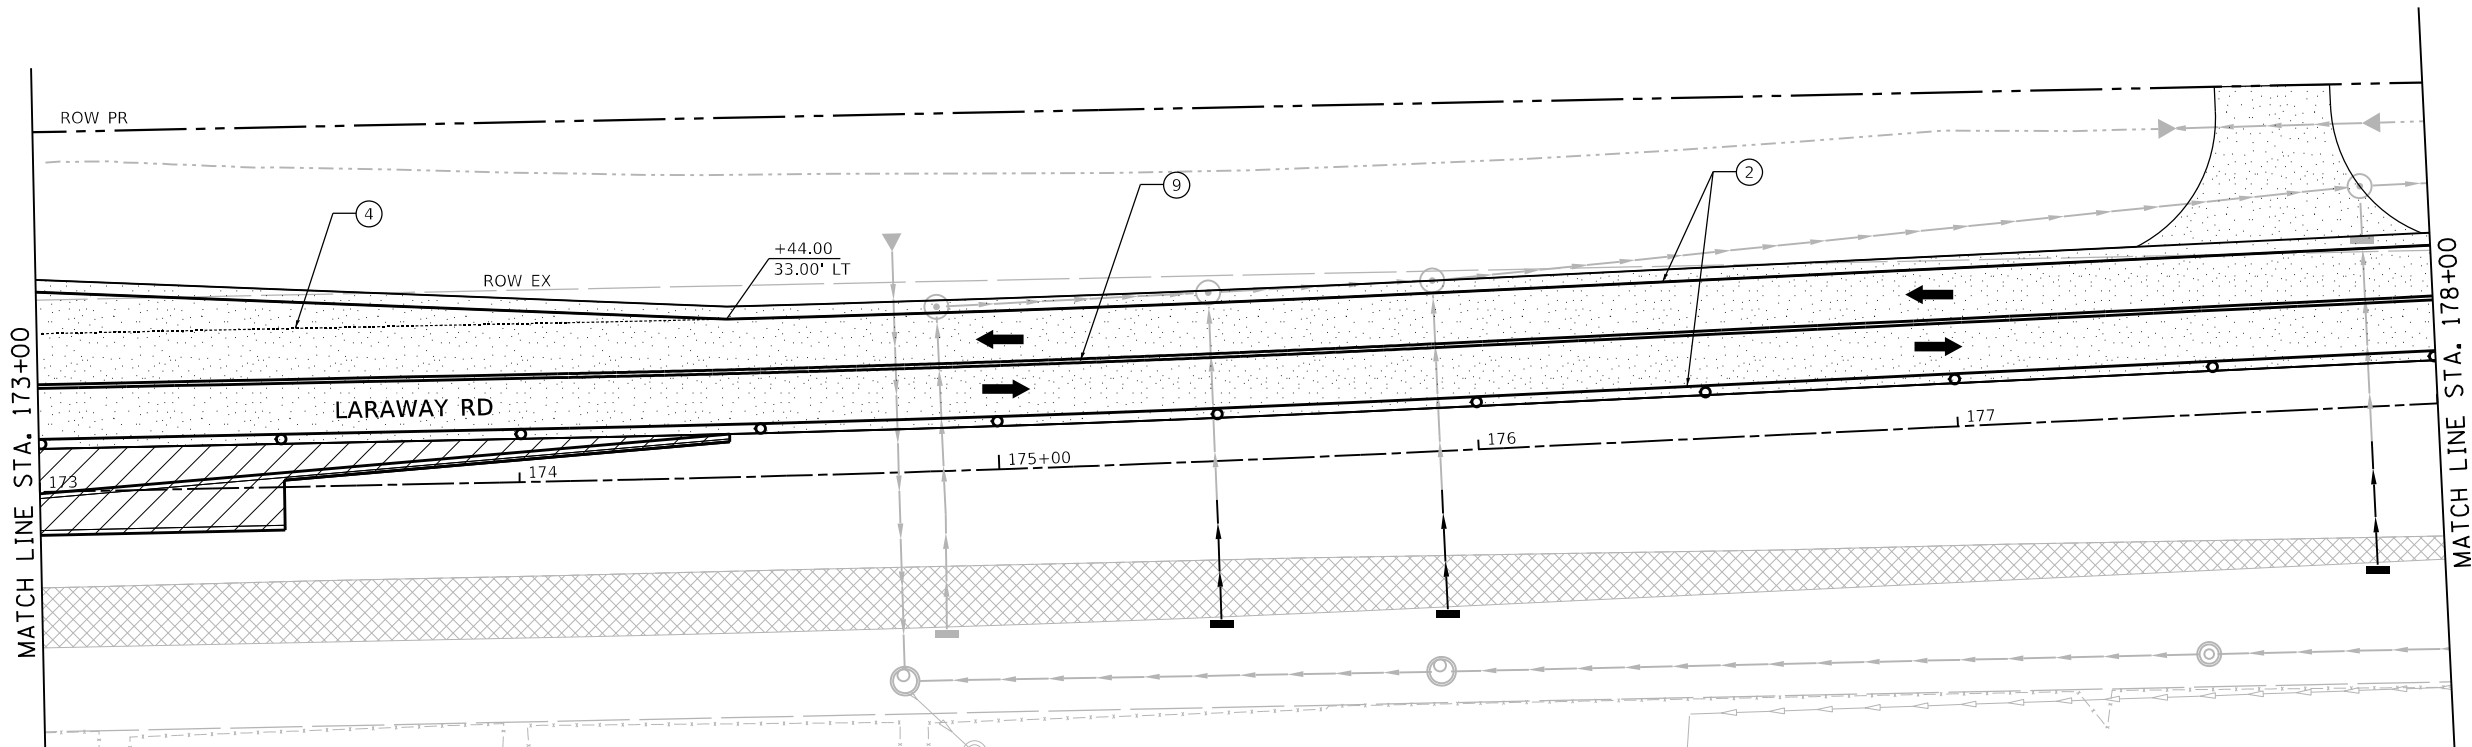

LEGEND

VERTICAL PANEL WITH STEADY BURN LIGHT AS REQUIRED BY SPECIFICATIONS. (50' C-C TYP., 25' C-C ON TAPERS & CURVES)	TEMPORARY PAVEMENT WIDENING CONSTRUCTED CURRENT STAGE	TEMPORARY PAVEMENT MARKINGS
DRUM WITH STEADY-BURN LIGHT AS REQUIRED BY SPECIFICATIONS. (50' C-C TYP., 25' C-C ON TAPERS & CURVES)	TEMPORARY PAVEMENT WIDENING CONSTRUCTED PREVIOUS STAGE	① 4" YELLOW (SOLID)
TYPE III BARRICADE WITH STEADY-BURN LIGHT AS REQUIRED BY SPECIFICATIONS.	COMPLETED PAVEMENT (TO TOP OF BINDER COURSE)	② 4" WHITE (SOLID)
TEMPORARY CONCRETE BARRIER WITH TYPE C REFLECTOR	WORK ZONE	③ 4" WHITE (SKIP-DASH)
DIRECTION OF TRAFFIC	PAVEMENT PATCHING CLASS D (SEE PVMT PATCH DETAIL SHEETS)	④ 6" WHITE (2' DASH, 6' SKIP)
STORM SEWER CONSTRUCTED THIS STAGE	TEMPORARY ACCESS	⑤ 6" WHITE (SOLID)
STORM SEWER CONSTRUCTED PREVIOUS STAGE		⑥ 12" YELLOW (DIAGONALS) 30' C-C @45°
		⑦ 12" WHITE (DIAGONALS)
		⑧ 24" WHITE (STOP BAR)
		⑨ 4" DOUBLE YELLOW (SOLID) @11" C-C
		⑩ LETTERS & SYMBOLS

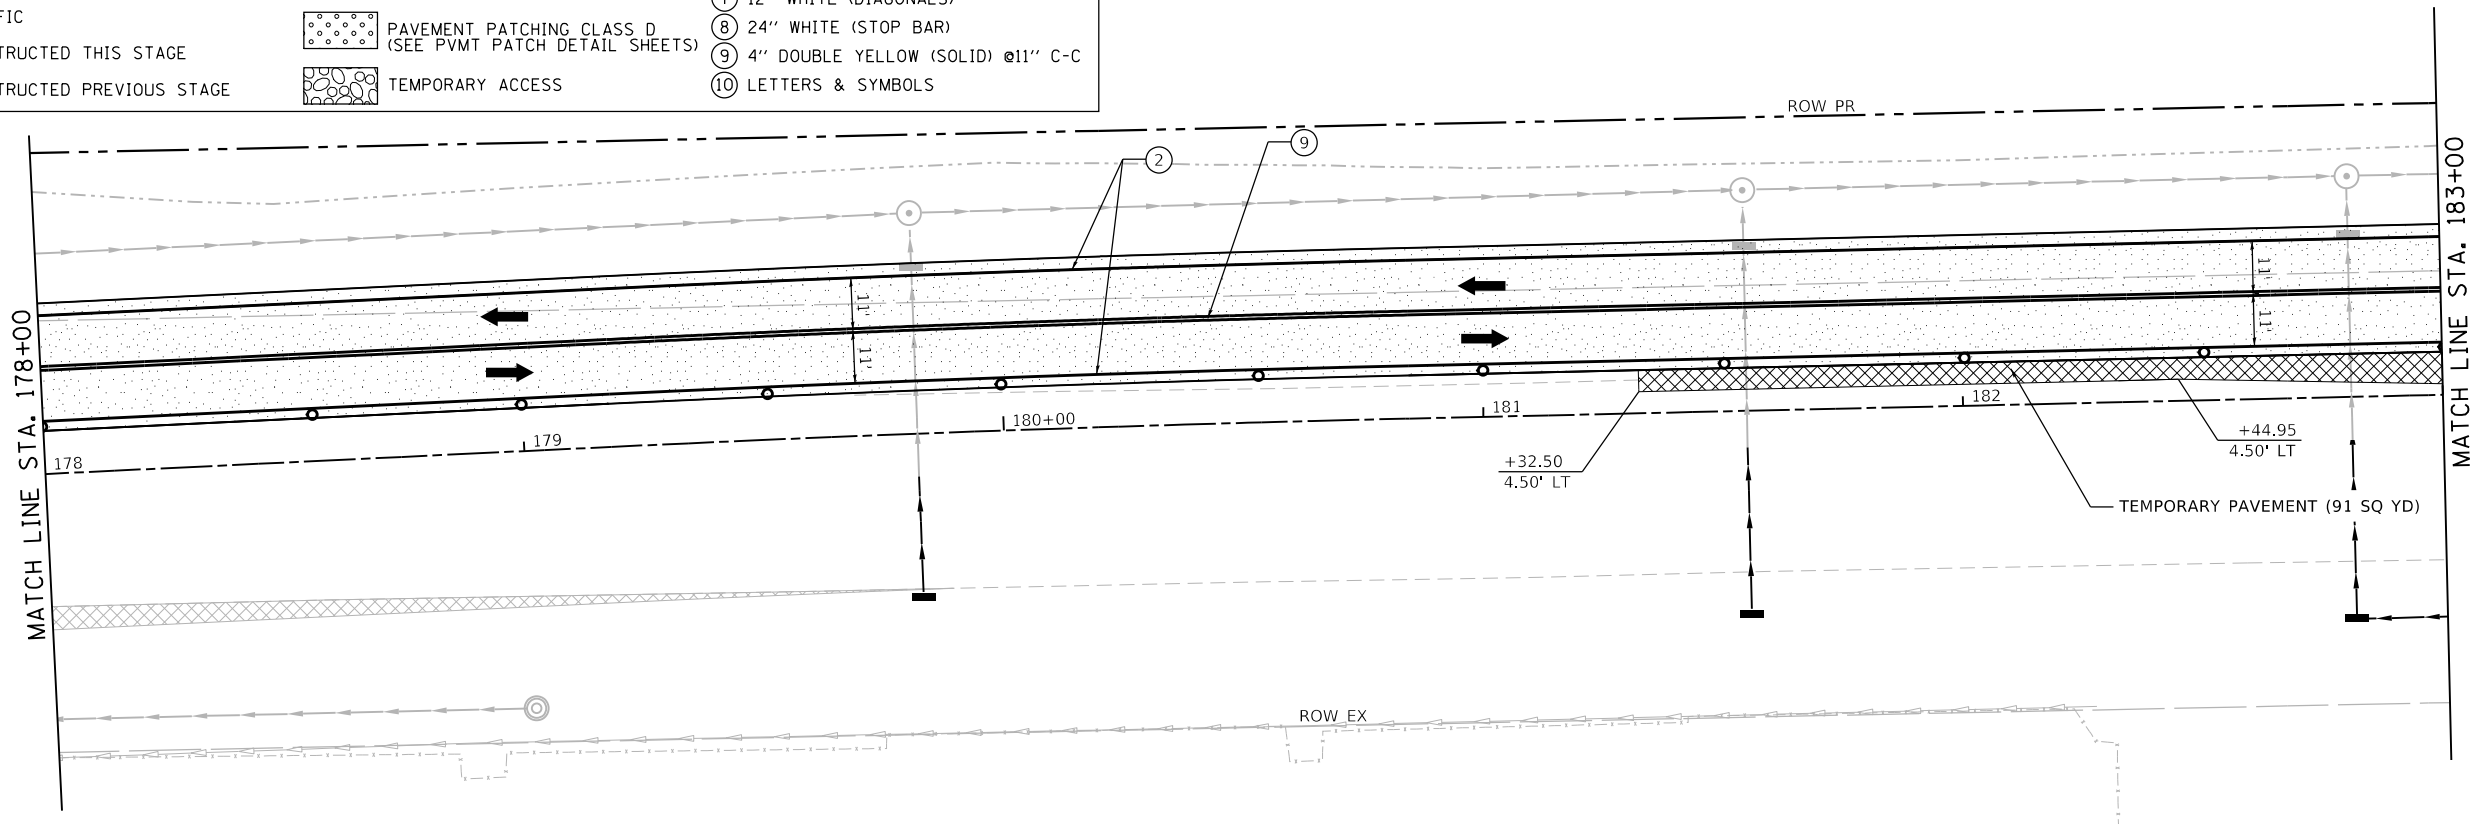

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**STATE OF ILLINOIS
DEPARTMENT OF TRANSPORTATION**

**SUGGESTED SEQUENCE OF CONSTRUCTION
LARAWAY RD - STAGE 2A**



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F.A.U. RTE.	SECTION	COUNTY	TOTAL SHEETS	SHEET NO.
0320	13-00138-37-PV	WILL	413	131
CONTRACT NO. 61H20				
ILLINOIS FED. AID PROJECT				

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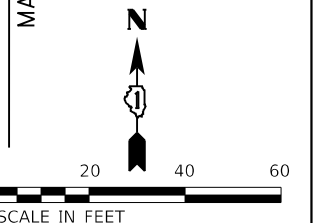
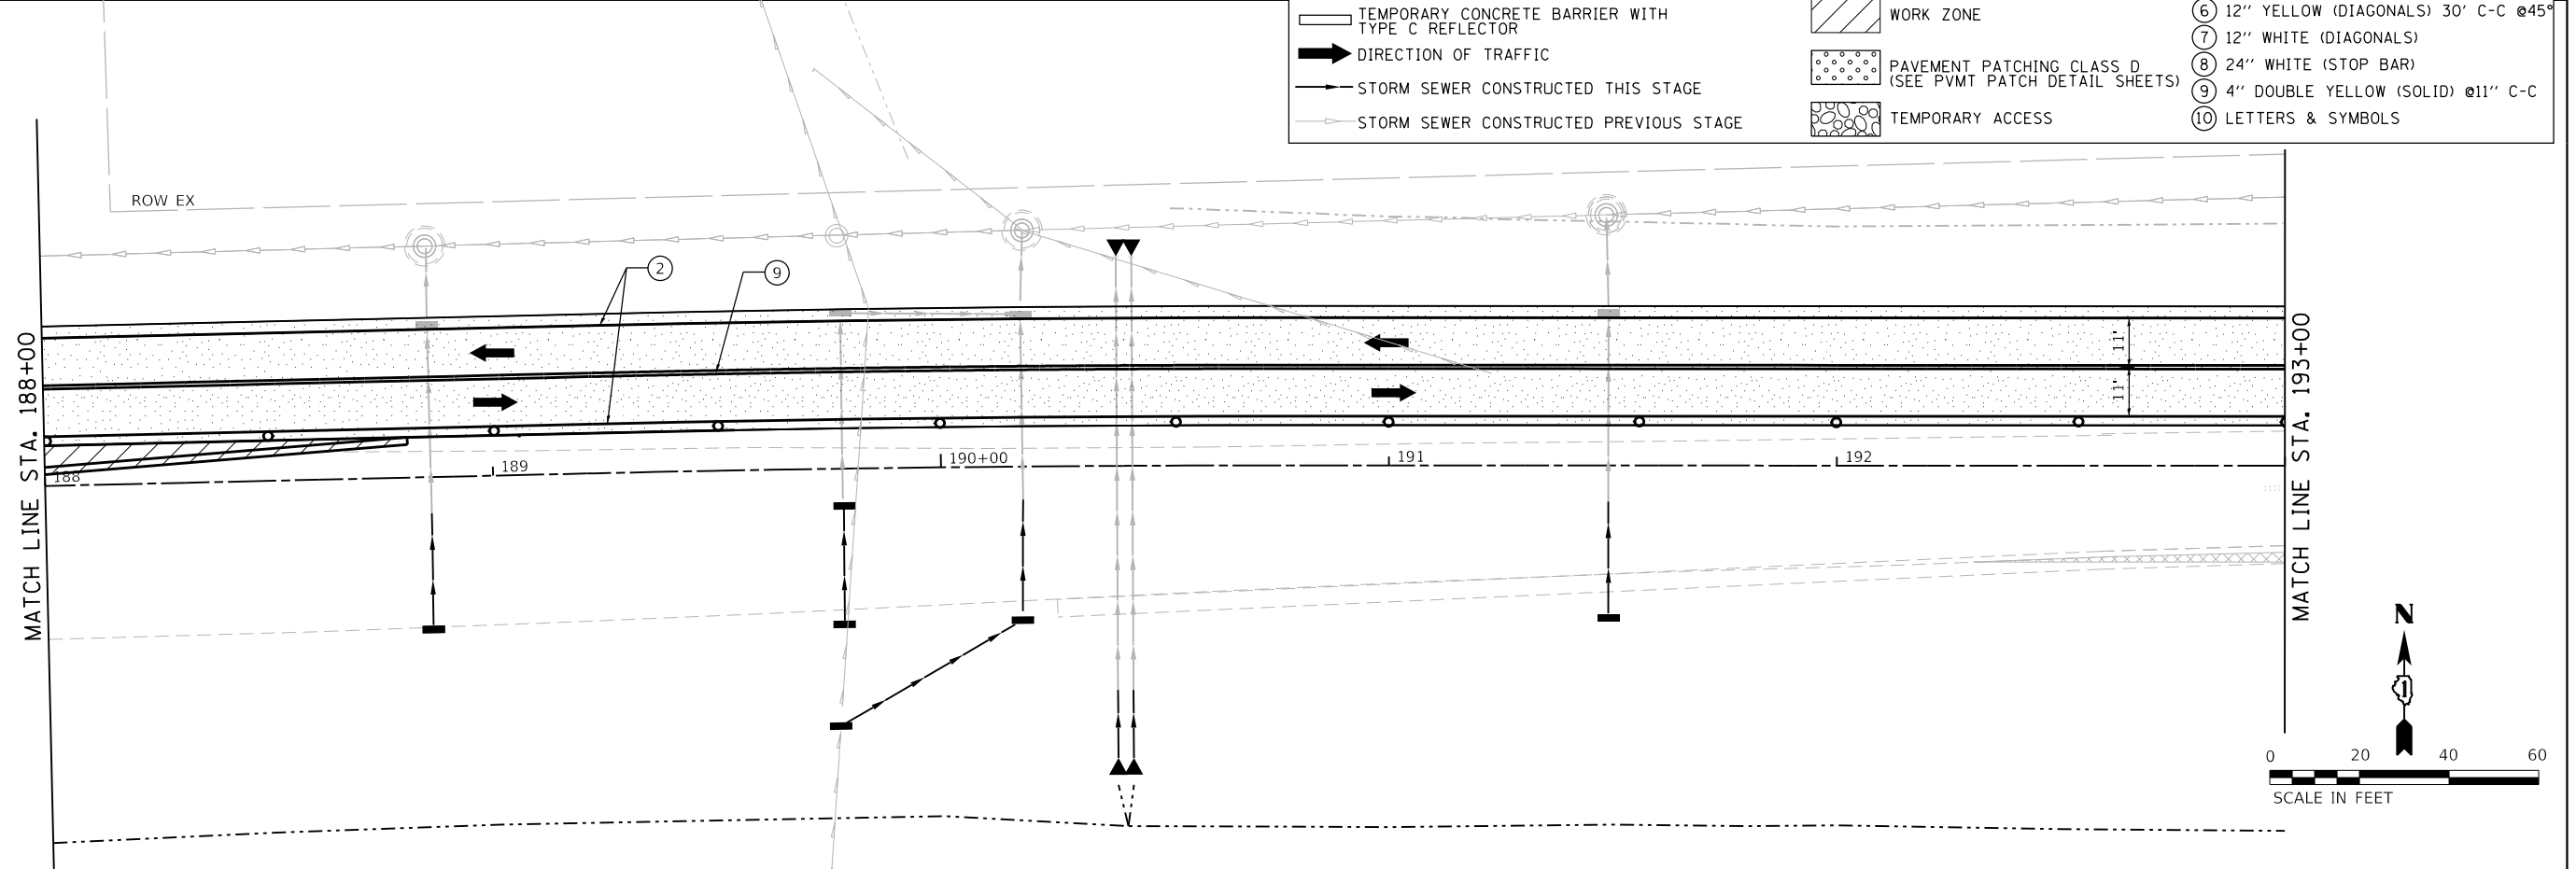
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PLOT DATE = 9/9/2022 (12:16:00 PM)

USER NAME = Mike Moses
DIRECTORY = L:\MILL\CO117204-01\Drawn\CADD_Sheets\



NOTES:
1. WORK THAT INTERFERES WITH THE SOUTH LEG OF CARDINAL DRIVE WILL NOT COMMENCE UNTIL ALL OTHER STAGE CONSTRUCTION IS COMPLETE. AT THAT TIME, CARDINAL DRIVE SHALL BE CLOSED AND CONFLICTING PAVEMENT SHALL BE CONSTRUCTED IN ONE SINGLE OFF-PEAK ROAD CLOSURE

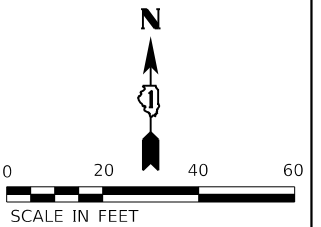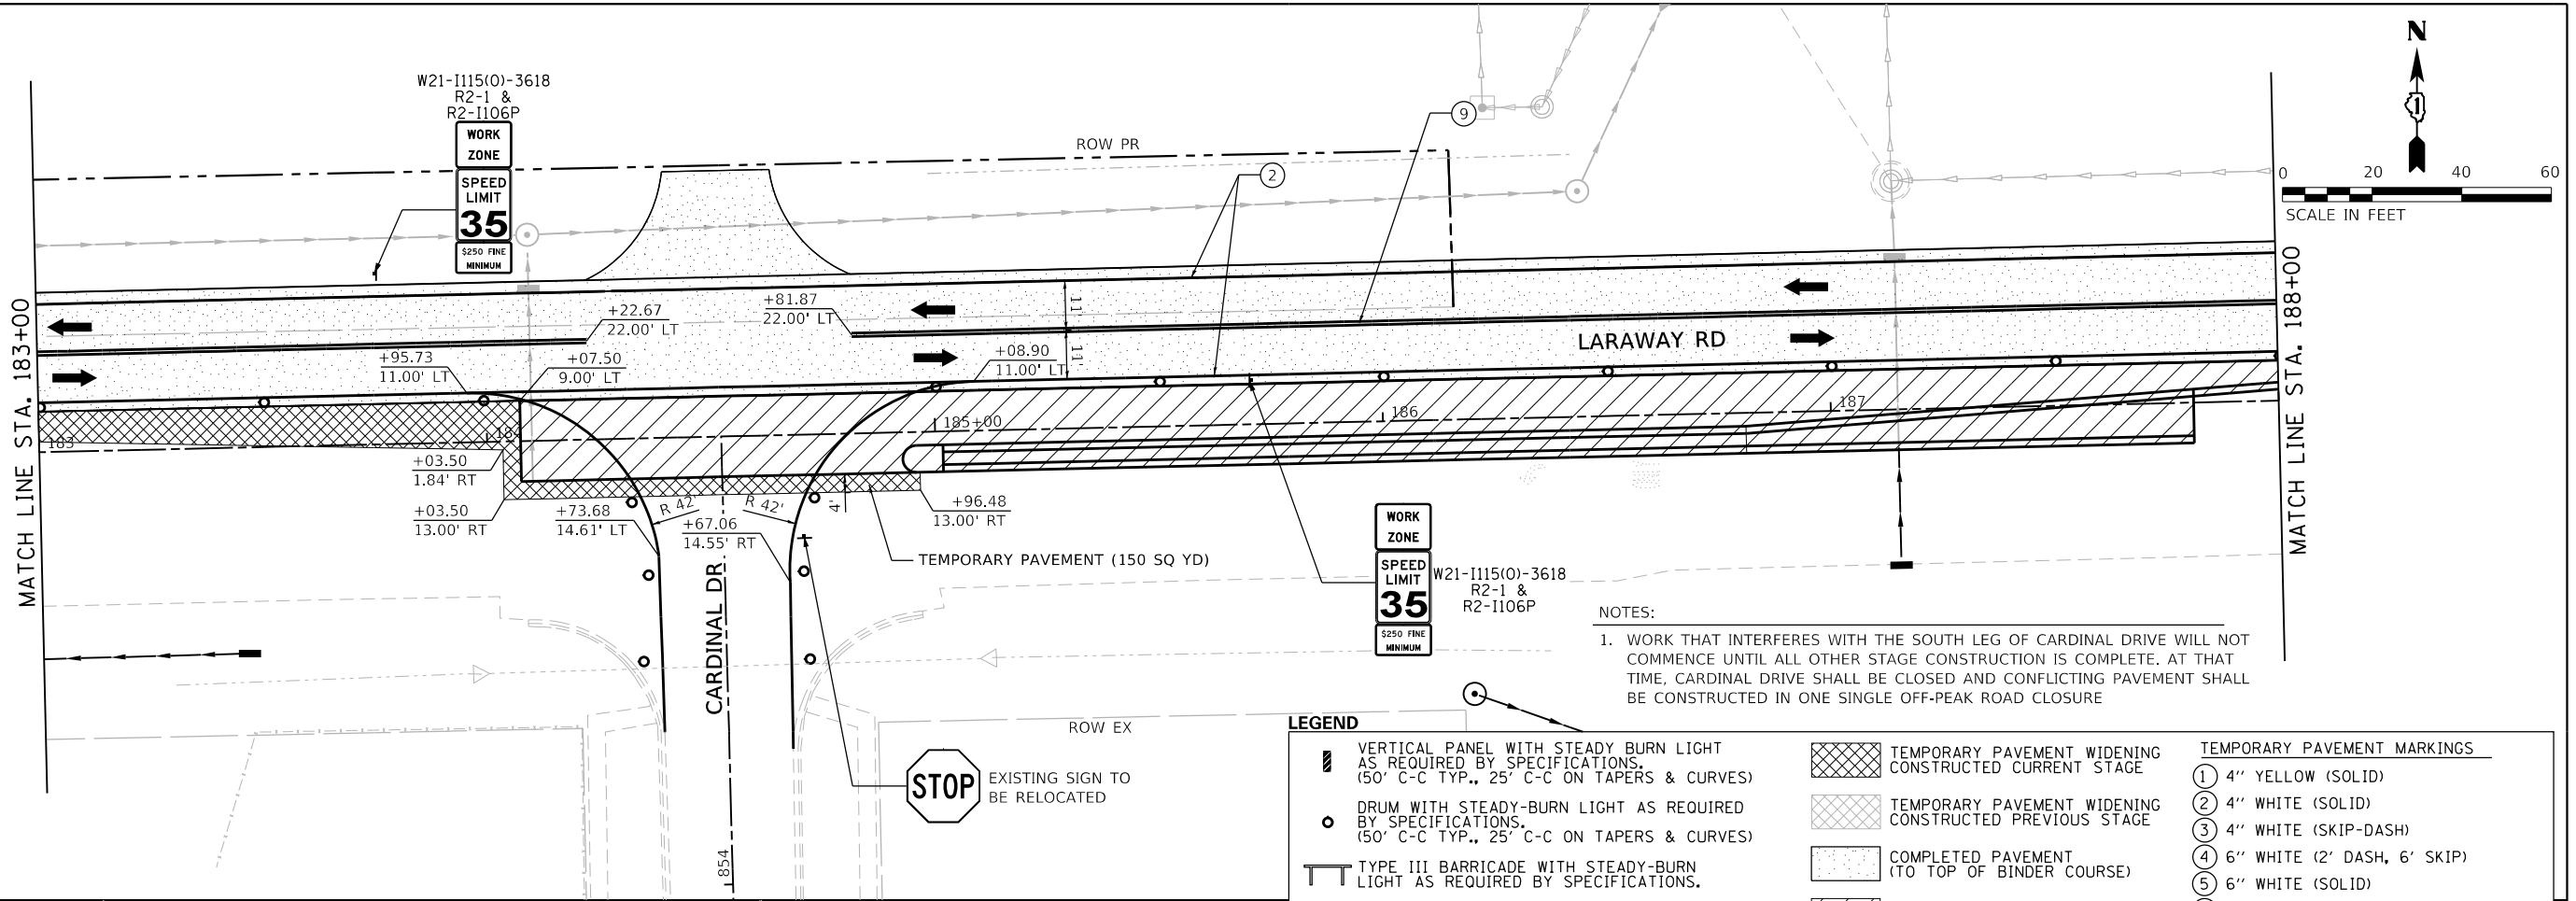LEGEND		TEMPORARY PAVEMENT MARKINGS	
	VERTICAL PANEL WITH STEADY BURN LIGHT AS REQUIRED BY SPECIFICATIONS. (50' C-C TYP., 25' C-C ON TAPERS & CURVES)		TEMPORARY PAVEMENT WIDENING CONSTRUCTED CURRENT STAGE
	DRUM WITH STEADY-BURN LIGHT AS REQUIRED BY SPECIFICATIONS. (50' C-C TYP., 25' C-C ON TAPERS & CURVES)		TEMPORARY PAVEMENT WIDENING CONSTRUCTED PREVIOUS STAGE
	TYPE III BARRICADE WITH STEADY-BURN LIGHT AS REQUIRED BY SPECIFICATIONS.		COMPLETED PAVEMENT (TO TOP OF BINDER COURSE)
	TEMPORARY CONCRETE BARRIER WITH TYPE C REFLECTOR		WORK ZONE
	DIRECTION OF TRAFFIC		PAVEMENT PATCHING CLASS D (SEE PVMT PATCH DETAIL SHEETS)
	STORM SEWER CONSTRUCTED THIS STAGE		TEMPORARY ACCESS
	STORM SEWER CONSTRUCTED PREVIOUS STAGE		
			① 4" YELLOW (SOLID)
			② 4" WHITE (SOLID)
			③ 4" WHITE (SKIP-DASH)
			④ 6" WHITE (2' DASH, 6' SKIP)
			⑤ 6" WHITE (SOLID)
			⑥ 12" YELLOW (DIAGONALS) 30' C-C @45°
			⑦ 12" WHITE (DIAGONALS)
			⑧ 24" WHITE (STOP BAR)
			⑨ 4" DOUBLE YELLOW (SOLID) @11" C-C
			⑩ LETTERS & SYMBOLS



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STATE OF ILLINOIS
DEPARTMENT OF TRANSPORTATION

SUGGESTED SEQUENCE OF CONSTRUCTION
LARAWAY RD - STAGE 2A


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F.A.U. RTE.	SECTION	COUNTY	TOTAL SHEETS	SHEET NO.
0320	13-00138-37-PV	WILL	413	132
CONTRACT NO. 61H20				
ILLINOIS FED. AID PROJECT				

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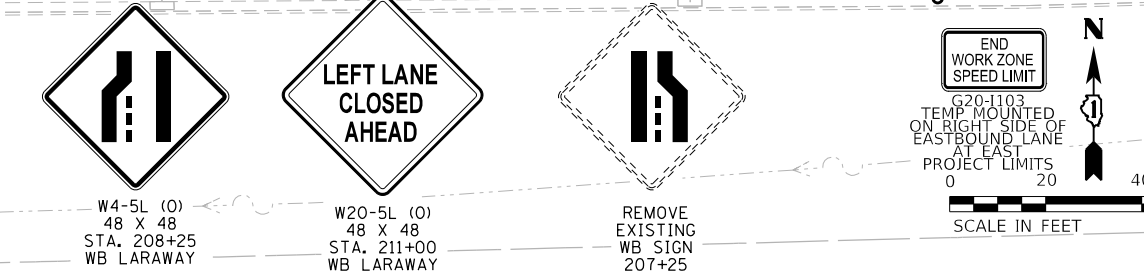
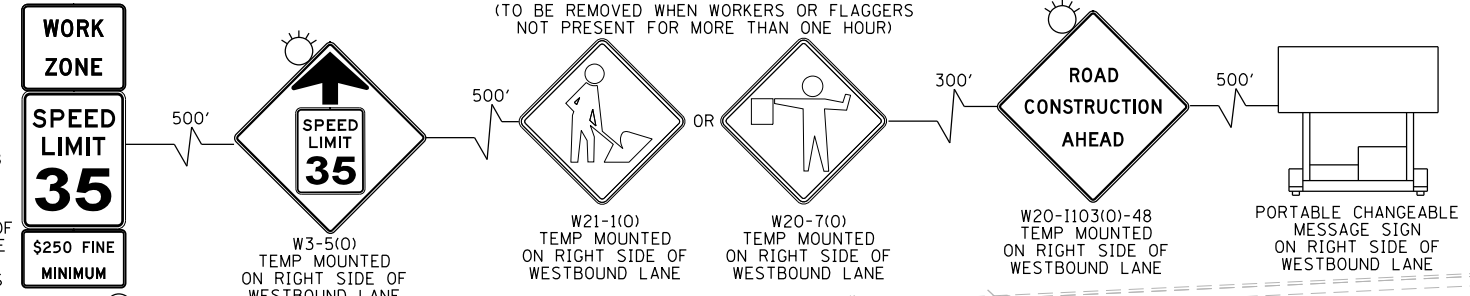
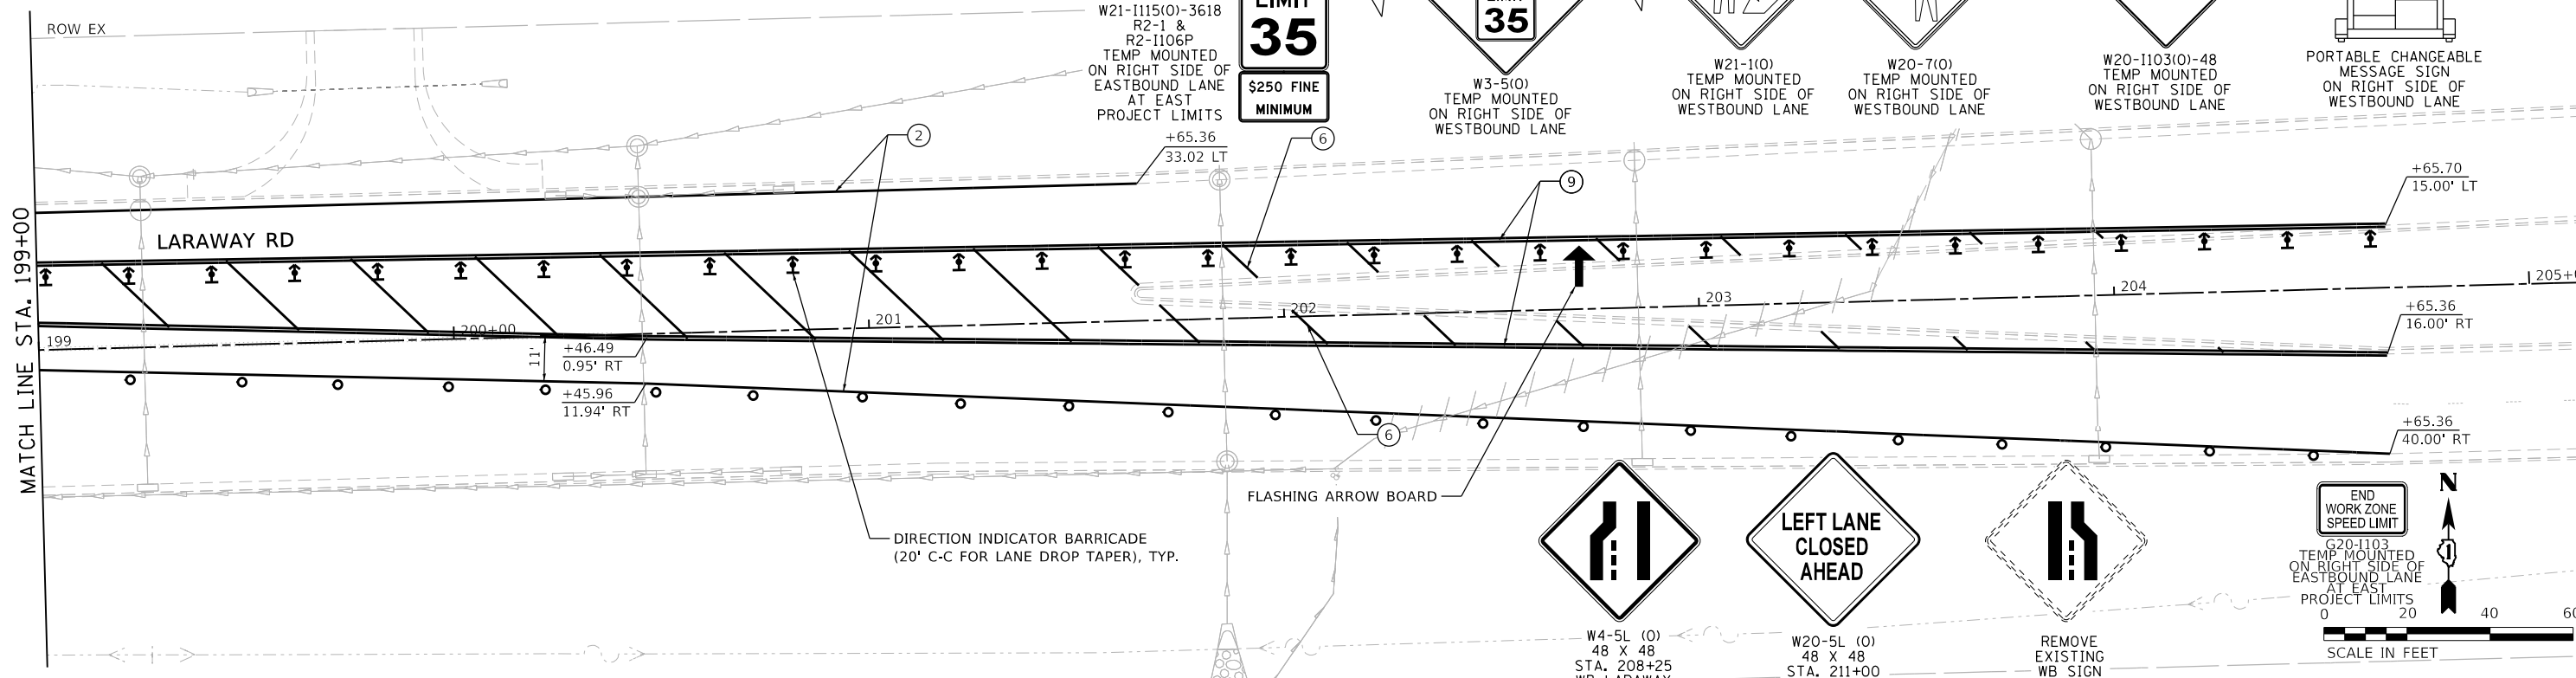
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PLOT DATE = 9/9/2022 (12:16:02 PM)

USER NAME = Mikes_Moore
DIRECTORY = L:\MILL\017204-01\Draw\CADD_Sheets\



LEGEND

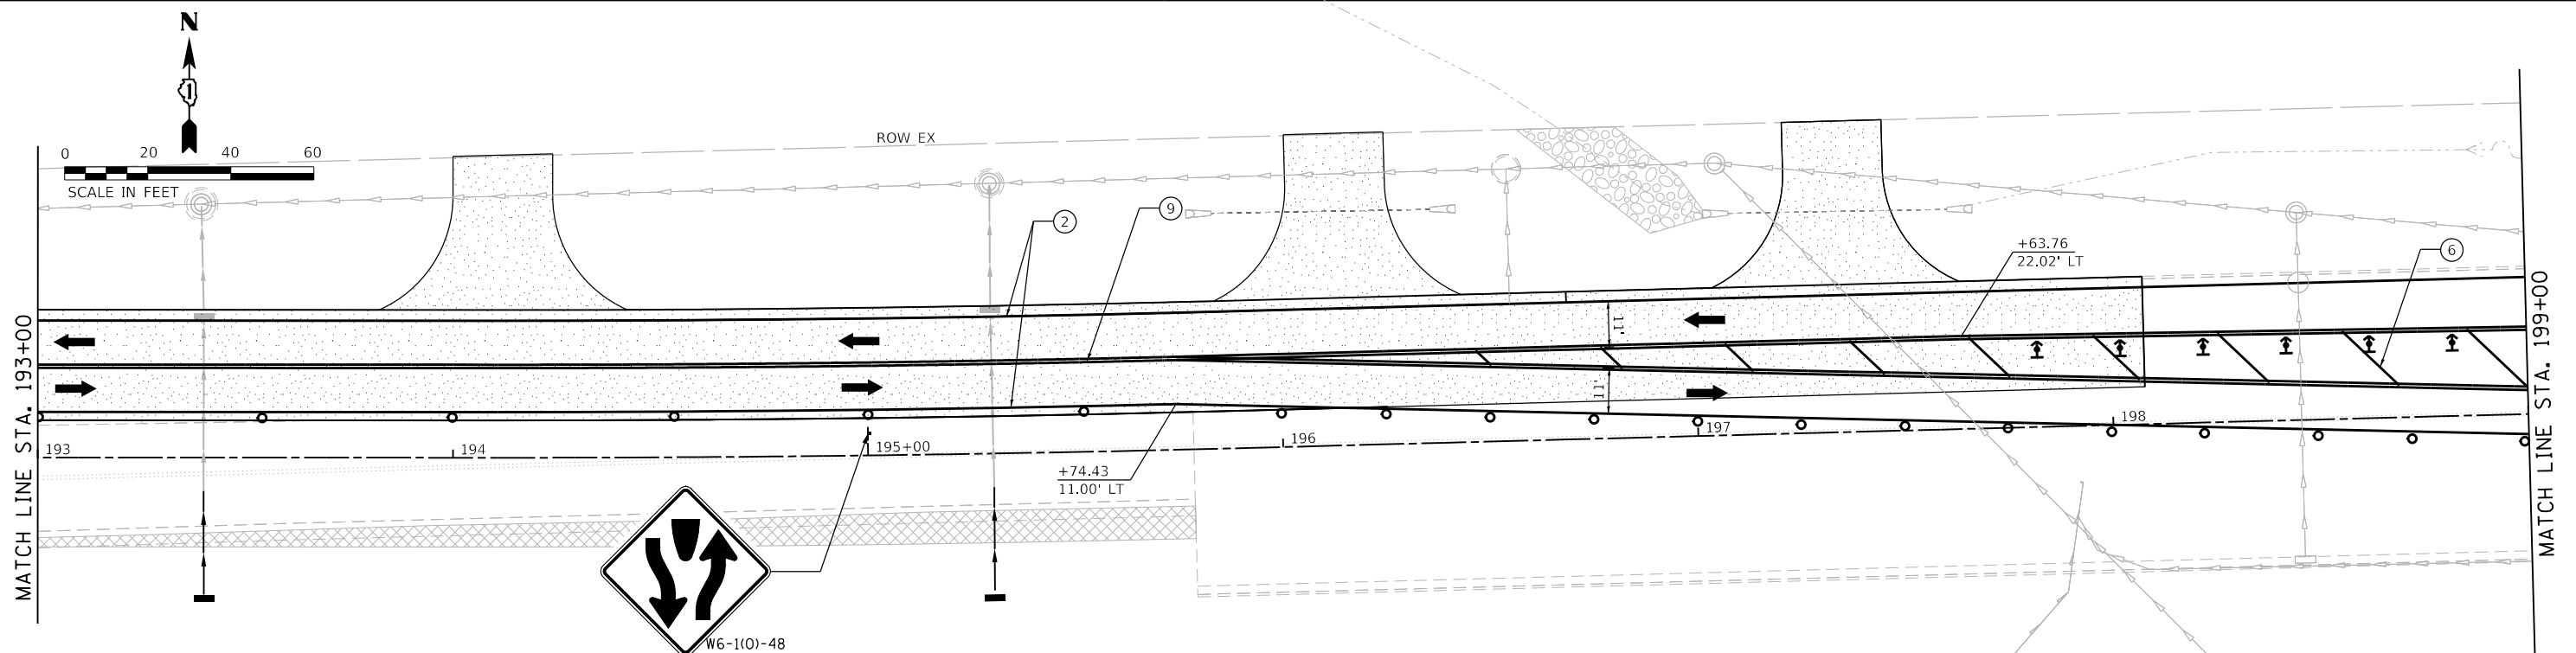- VERTICAL PANEL WITH STEADY BURN LIGHT AS REQUIRED BY SPECIFICATIONS (50' C-C TYP., 25' C-C ON TAPERS & CURVES)
- DRUM WITH STEADY-BURN LIGHT AS REQUIRED BY SPECIFICATIONS (50' C-C TYP., 25' C-C ON TAPERS & CURVES)
- TYPE III BARRICADE WITH STEADY-BURN LIGHT AS REQUIRED BY SPECIFICATIONS.
- TEMPORARY CONCRETE BARRIER WITH TYPE C REFLECTOR
- DIRECTION OF TRAFFIC
- STORM SEWER CONSTRUCTED THIS STAGE
- STORM SEWER CONSTRUCTED PREVIOUS STAGE
- TEMPORARY PAVEMENT WIDENING CONSTRUCTED CURRENT STAGE
- TEMPORARY PAVEMENT WIDENING CONSTRUCTED PREVIOUS STAGE
- COMPLETED PAVEMENT (TO TOP OF BINDER COURSE)
- WORK ZONE
- PAVEMENT PATCHING CLASS D (SEE PVMT PATCH DETAIL SHEETS)
- TEMPORARY ACCESS
- TEMPORARY PAVEMENT MARKINGS**
- ① 4" YELLOW (SOLID)
- ② 4" WHITE (SOLID)
- ③ 4" WHITE (SKIP-DASH)
- ④ 6" WHITE (2' DASH, 6' SKIP)
- ⑤ 6" WHITE (SOLID)
- ⑥ 12" YELLOW (DIAGONALS) 30' C-C @45°
- ⑦ 12" WHITE (DIAGONALS)
- ⑧ 24" WHITE (STOP BAR)
- ⑨ 4" DOUBLE YELLOW (SOLID) @11" C-C
- ⑩ LETTERS & SYMBOLS




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**STATE OF ILLINOIS
DEPARTMENT OF TRANSPORTATION**

**SUGGESTED SEQUENCE OF CONSTRUCTION
LARAWAY RD - STAGE 2A**

SCALE: 1"=20' SHEET 7 OF 7 SHEETS STA. 193+00 TO STA. 205+00

F.A.U. RTE.	SECTION	COUNTY	TOTAL SHEETS	SHEET NO.
0320	13-00138-37-PV	WILL	413	133
CONTRACT NO. 61H20				
ILLINOIS FED. AID PROJECT				

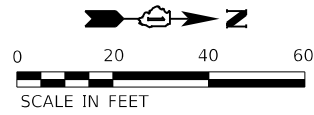

MATCH LINE STA. 636+00

STONEBRIDGE DR
636 637 638



W20-I103(O)-36
M6-4
TEMP MOUNTED
ON RIGHT SIDE
OF SOUTHBOUND LANE
200' FROM WORK AREA
PER IDOT TC-10

TIMBER PL

LEGEND


	VERTICAL PANEL WITH STEADY BURN LIGHT AS REQUIRED BY SPECIFICATIONS. (50' C-C TYP., 25' C-C ON TAPERS & CURVES)		TEMPORARY PAVEMENT WIDENING CONSTRUCTED CURRENT STAGE	TEMPORARY PAVEMENT MARKINGS	
	DRUM WITH STEADY-BURN LIGHT AS REQUIRED BY SPECIFICATIONS. (50' C-C TYP., 25' C-C ON TAPERS & CURVES)		TEMPORARY PAVEMENT WIDENING CONSTRUCTED PREVIOUS STAGE	①	4" YELLOW (SOLID)
	TYPE III BARRICADE WITH STEADY-BURN LIGHT AS REQUIRED BY SPECIFICATIONS.		COMPLETED PAVEMENT (TO TOP OF BINDER COURSE)	②	4" WHITE (SOLID)
	TEMPORARY CONCRETE BARRIER WITH TYPE C REFLECTOR		WORK ZONE	③	4" WHITE (SKIP-DASH)
	DIRECTION OF TRAFFIC		PAVEMENT PATCHING CLASS D (SEE PVMT PATCH DETAIL SHEETS)	④	6" WHITE (2' DASH, 6' SKIP)
	STORM SEWER CONSTRUCTED THIS STAGE		TEMPORARY ACCESS	⑤	6" WHITE (SOLID)
	STORM SEWER CONSTRUCTED PREVIOUS STAGE			⑥	12" YELLOW (DIAGONALS) 30' C-C @45°
				⑦	12" WHITE (DIAGONALS)
				⑧	24" WHITE (STOP BAR)
				⑨	4" DOUBLE YELLOW (SOLID) @11" C-C
				⑩	LETTERS & SYMBOLS

MATCH LINE STA. 691+00

HEATHERWAY LN
691 692 693 694



W20-I103(O)-36
M6-4
TEMP MOUNTED
ON RIGHT SIDE
OF SOUTHBOUND LANE
200' FROM WORK AREA
PER IDOT TC-10

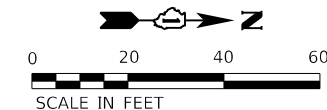

FILE NAME = sht-staging-stage02A-09.dgn
MODEL NAME = Default
PLOT SCALE = 40.0018' / in.
PLOT DATE = 9/9/2022 - 12:16:04 PM

DESIGNED - BRF
DRAWN - BRF
CHECKED - JMS
DATE - 09/09/2022

REVISED -
REVISED -
REVISED -
REVISED -

STATE OF ILLINOIS
DEPARTMENT OF TRANSPORTATION

SUGGESTED SEQUENCE OF CONSTRUCTION
STONEBRIDGE DR / HEATHERWAY LN - STAGE 2A




SCALE: 1"=20' SHEET 1 OF 1 SHEETS STA. TO STA.

F.A.U. RTE.	SECTION	COUNTY	TOTAL SHEETS	SHEET NO.
0320	13-00138-37-PV	WILL	413	134
CONTRACT NO. 61H20				
ILLINOIS FED. AID PROJECT				

PLOT DRIVER
PENTABLE
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PLOT SCALE
PLOT DATE
= 40.0018' / in
= 9/9/2022 (12:16:05 PM)

USER NAME
DIRECTORY
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= L:\MILL\CON\754-01\Draw\CADD_Sheet.dgn

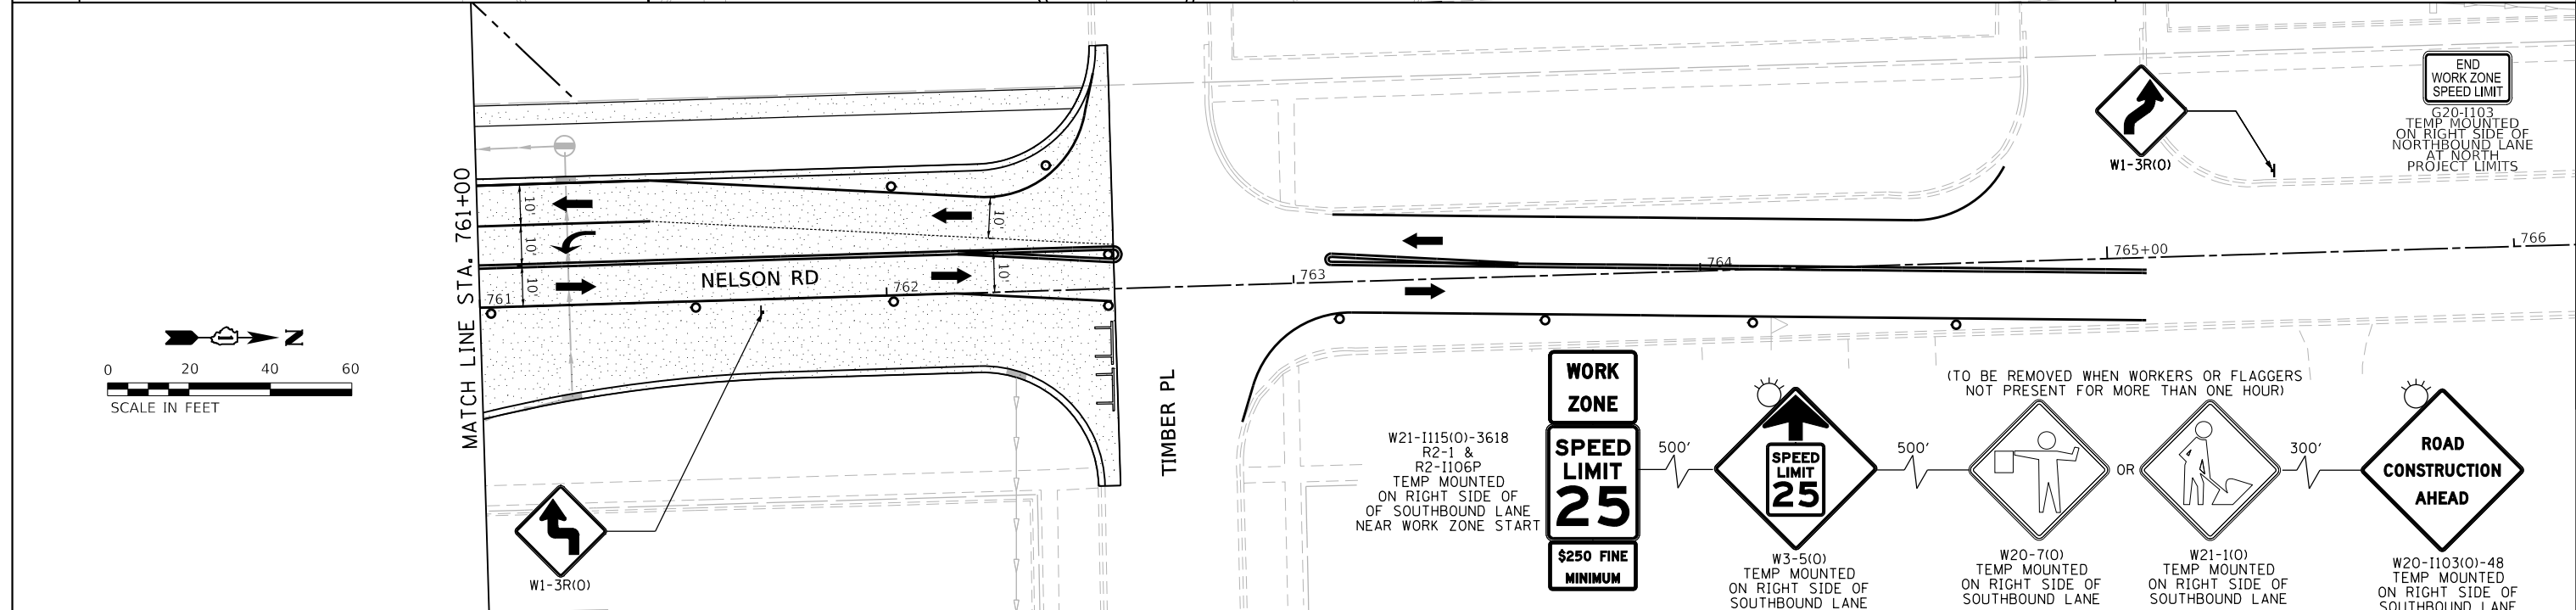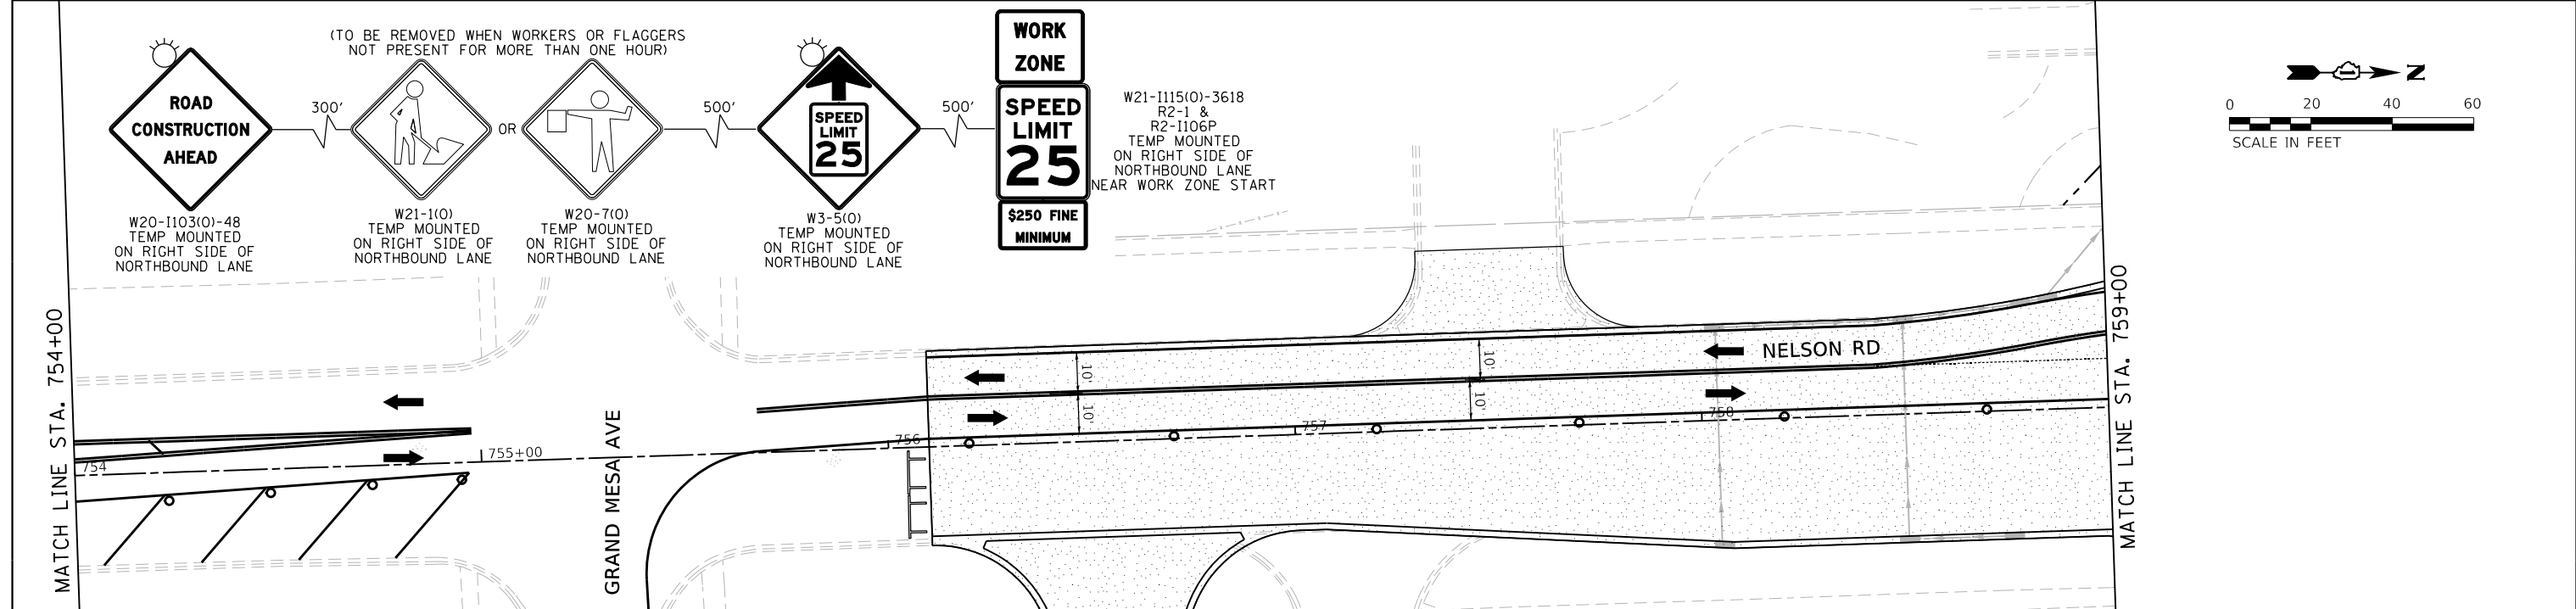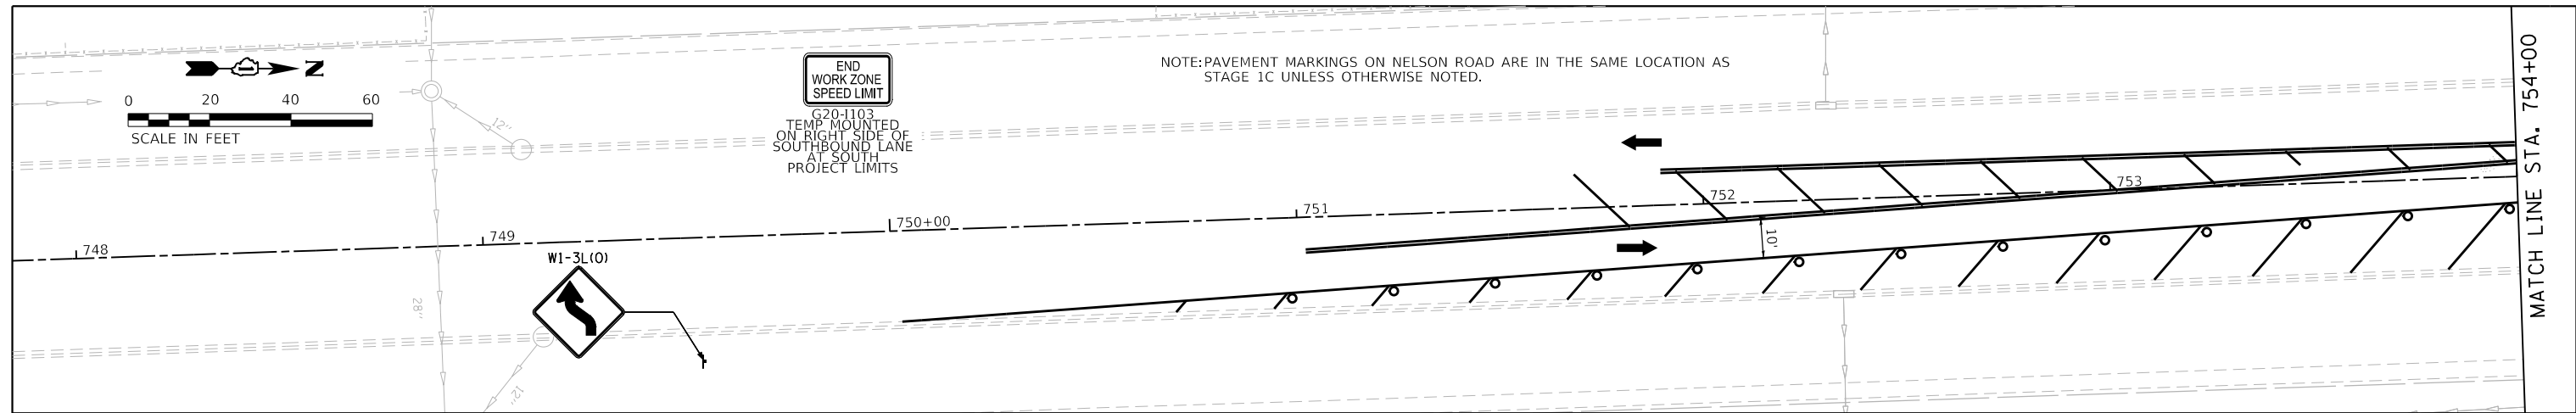

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PLOT DATE =	9/9/2022 - 12:16:05 PM	DATE -	09/09/2022	REVISED -	

STATE OF ILLINOIS
DEPARTMENT OF TRANSPORTATION

SUGGESTED SEQUENCE OF CONSTRUCTION
NELSON RD - STAGE 2A


SCALE: 1"=20' SHEET 1 OF 1 SHEETS STA. 748+00 TO STA. 765+00

F.A.U. RTE.	SECTION	COUNTY	TOTAL SHEETS	SHEET NO.
0320	13-00138-37-PV	WILL	413	135
CONTRACT NO. 61H20				
ILLINOIS FED. AID PROJECT				

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PENTABLE = Laramay_Signage.tbl

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USER NAME = Mike Moses
DIRECTORY = L:\MILL\017204-01\Drawings\CADD_Sheets_L

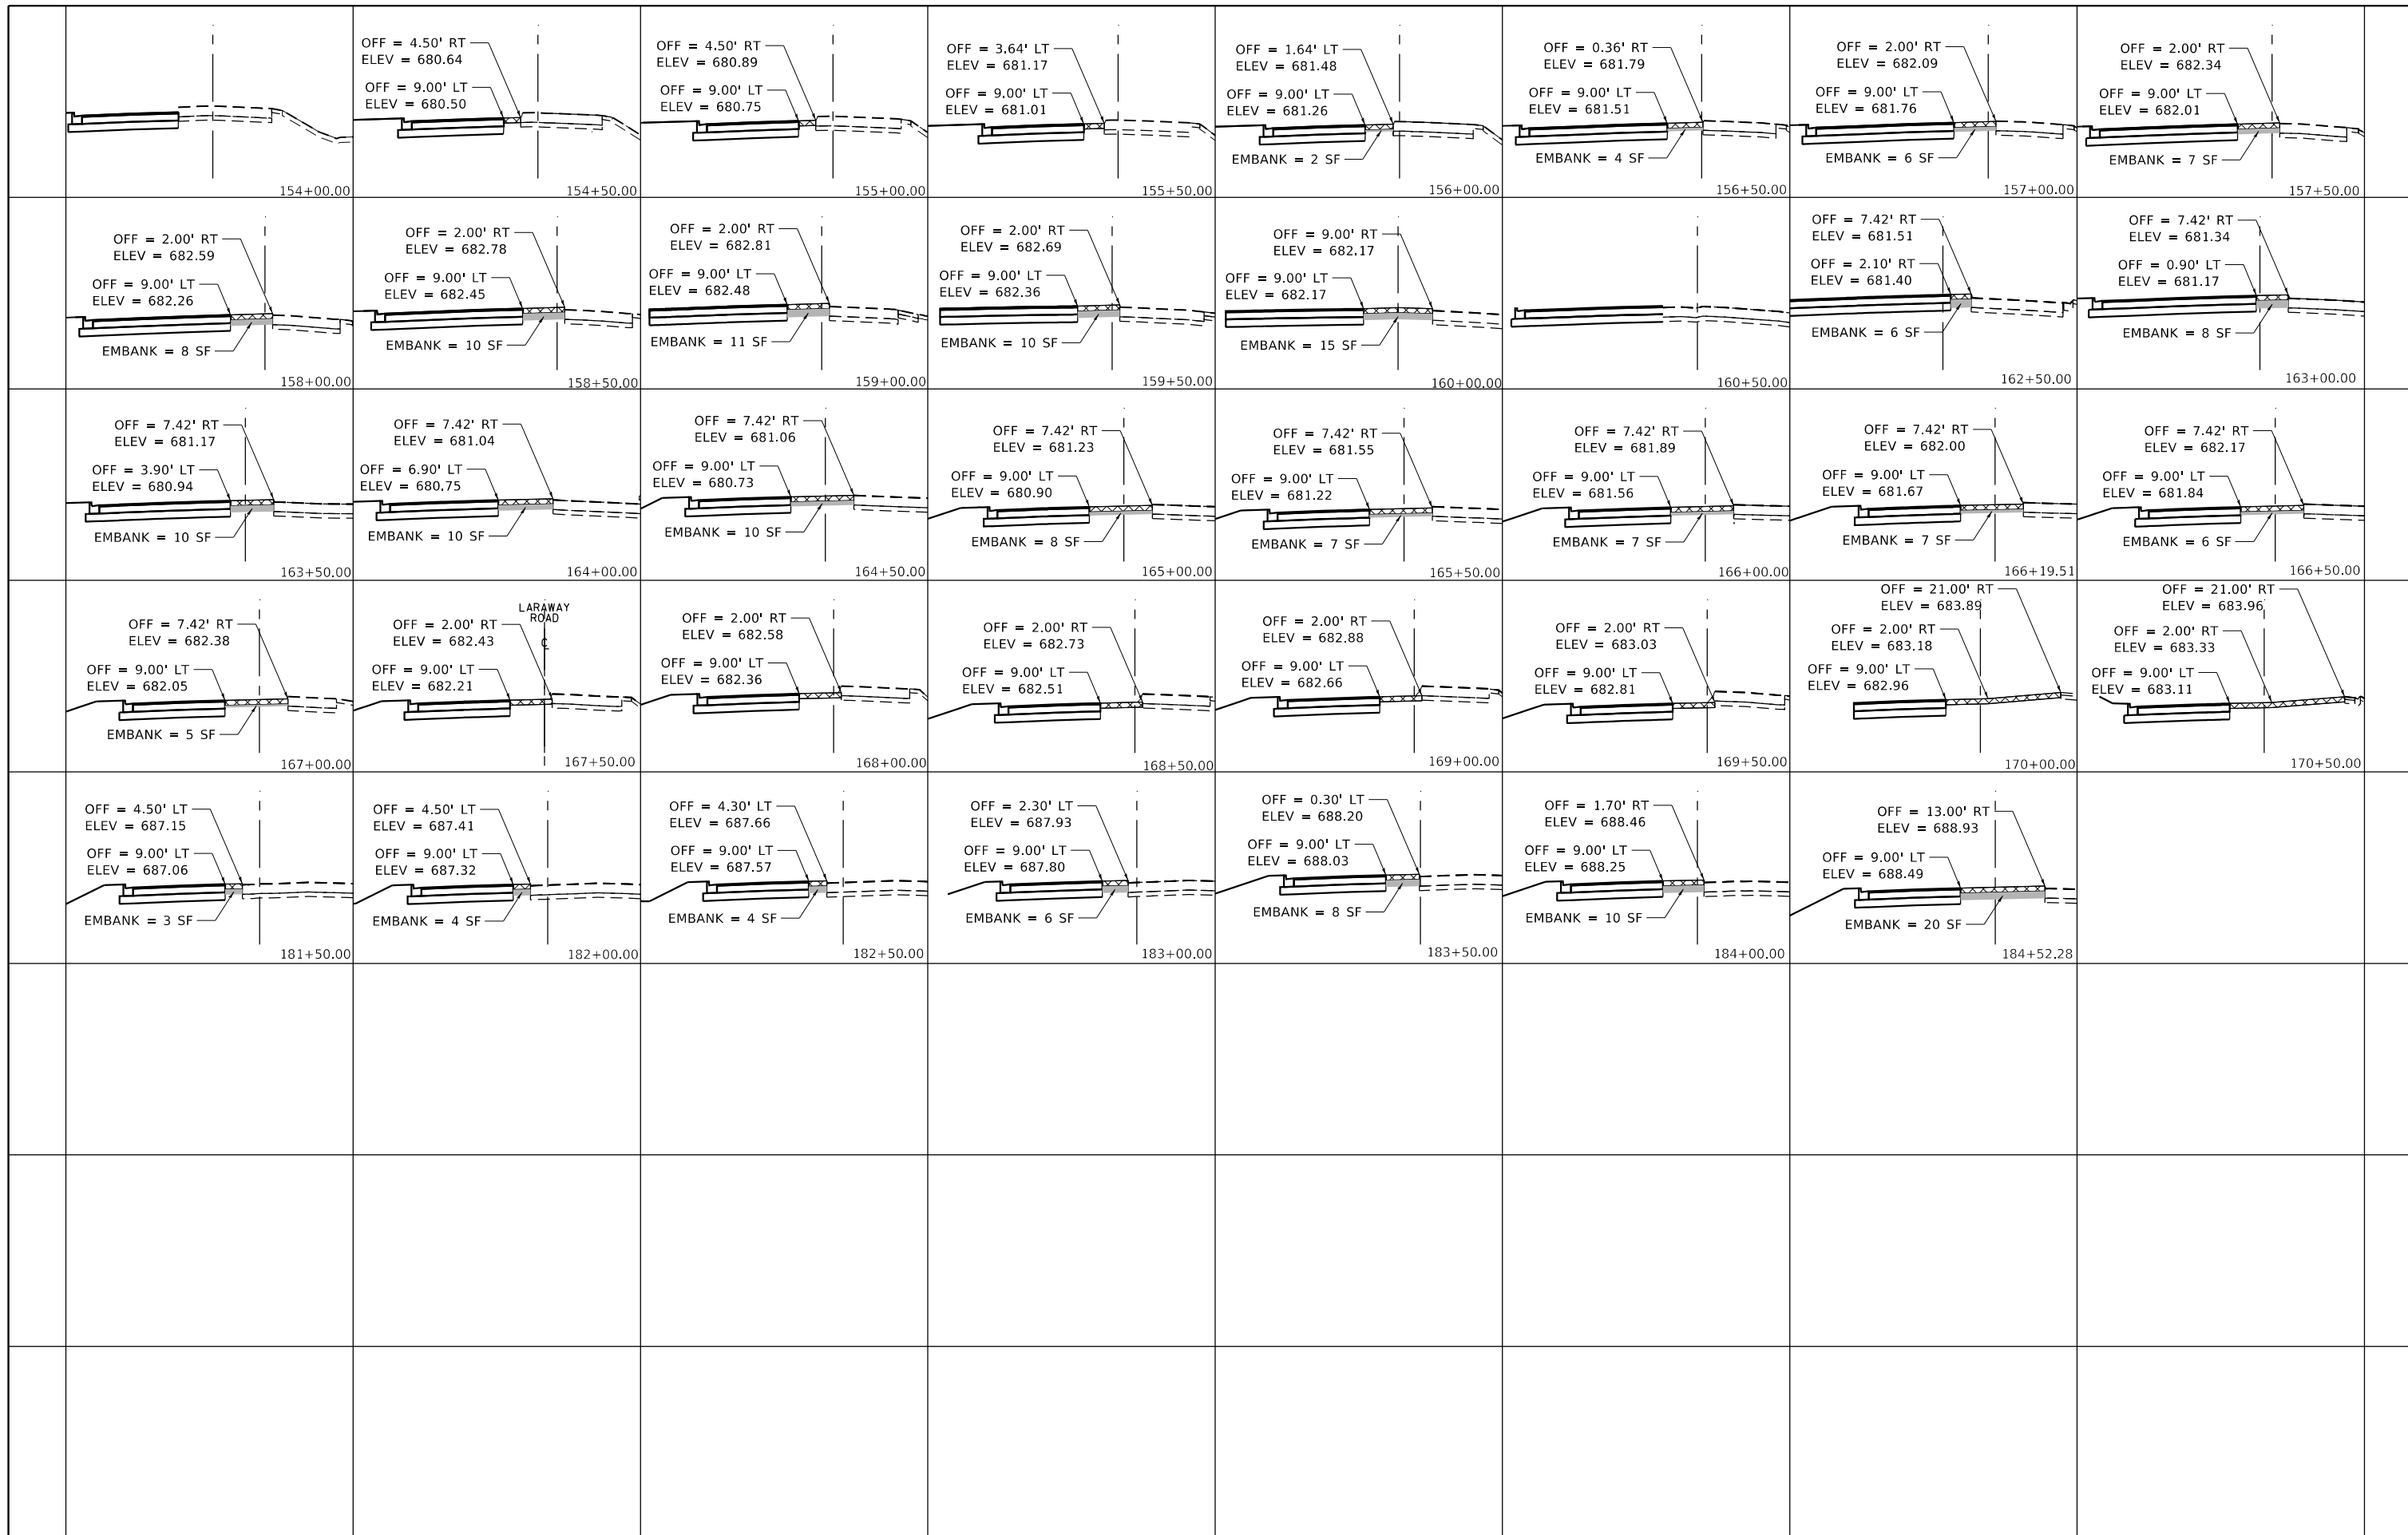


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**STATE OF ILLINOIS
DEPARTMENT OF TRANSPORTATION**


**SUGGESTED SEQUENCE OF CONSTRUCTION
STAGE 2A - TEMPORARY PAVEMENT CROSS SECTIONS**

SCALE: 1"=20' SHEET 1 OF 8 SHEETS STA. N/A TO STA. N/A


F.A.U. RTE. = 0320	SECTION = 13-00138-37-PV	COUNTY = WILL	TOTAL SHEETS = 413	SHEET NO. = 136
CONTRACT NO. 61H20				
ILLINOIS FED. AID PROJECT				

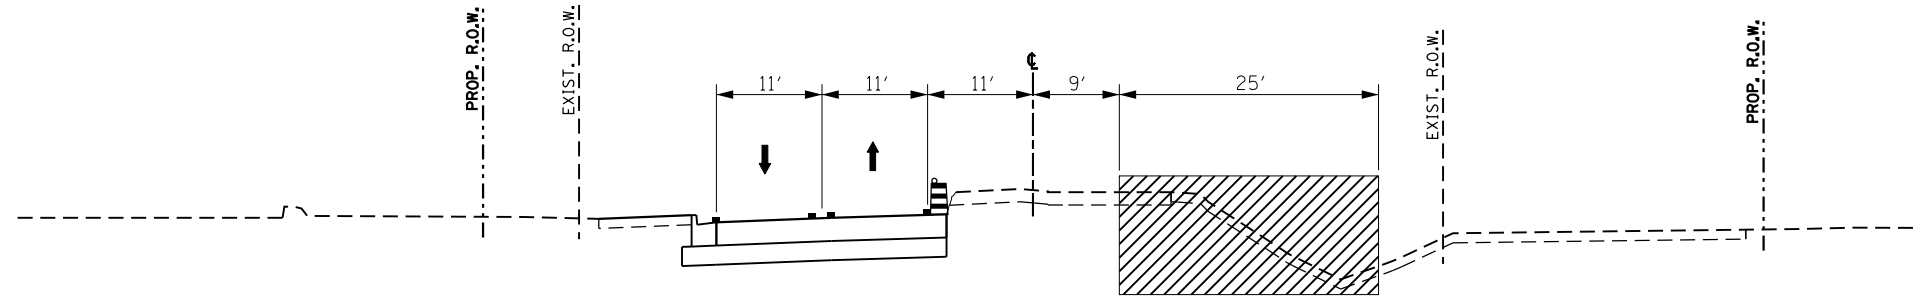

STAGE 2B TYPICAL SECTION
STA 135+79 TO 142+12.80

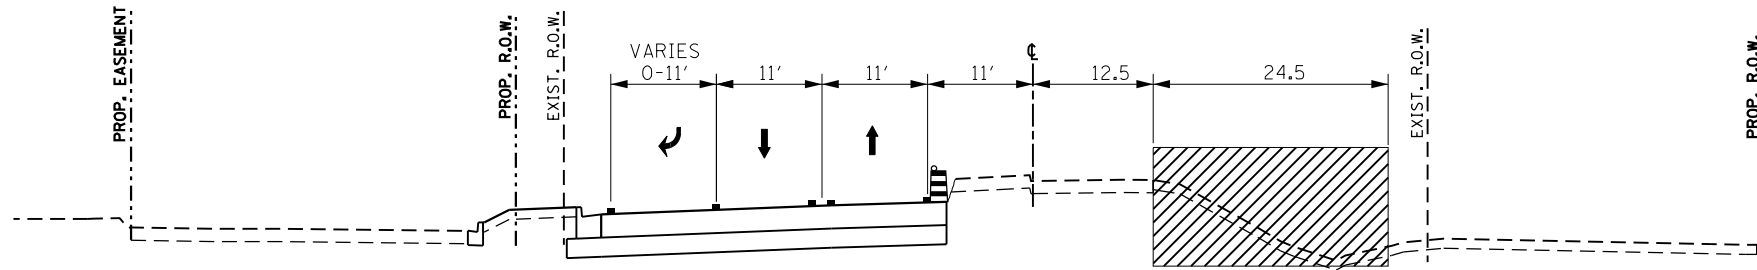

STAGE 2B TYPICAL SECTION
STA 142+12.80 TO 153+10.20

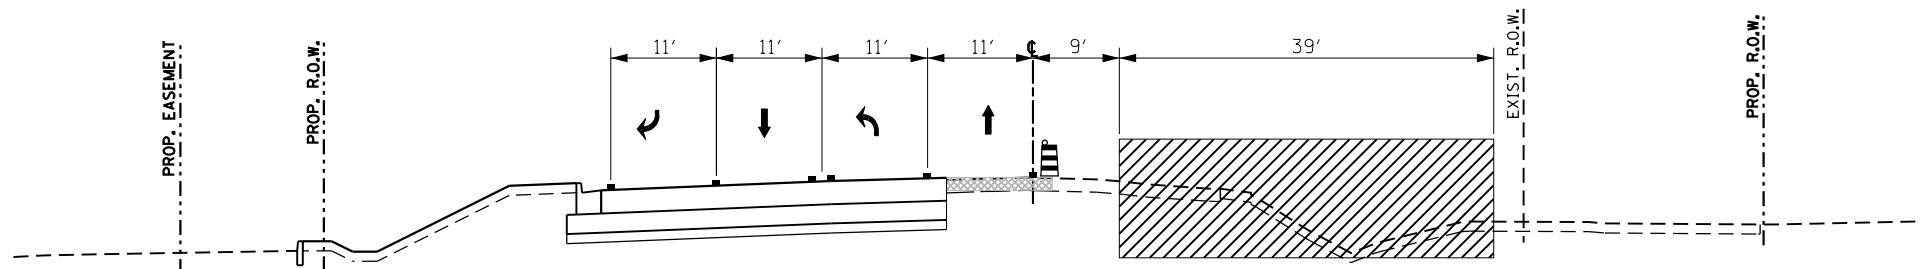

STAGE 2B TYPICAL SECTION
STA 156+75 TO 160+66.81

LEGEND


- TEMPORARY PAVEMENT MARKING LINE
- VERTICAL PANEL WITH STEADY BURN LIGHT AS REQUIRED BY SPECIFICATIONS. (50' C-C TYP., 25' C-C ON TAPERS & CURVES)
- DRUM WITH STEADY-BURN LIGHT AS REQUIRED BY SPECIFICATIONS. (50' C-C TYP., 25' C-C ON TAPERS & CURVES)
- TYPE II BARRICADE WITH STEADY-BURN LIGHT AS REQUIRED BY SPECIFICATIONS. (50' C-C TYP., 25' C-C ON TAPERS & CURVES)
- TEMPORARY CONCRETE BARRIER WITH TYPE C REFLECTORS
- DIRECTION OF TRAFFIC
- TEMPORARY PAVEMENT WIDENING CONSTRUCTED CURRENT STAGE
- TEMPORARY PAVEMENT WIDENING CONSTRUCTED PREVIOUS STAGE
- COMPLETED PAVEMENT
- WORK ZONE

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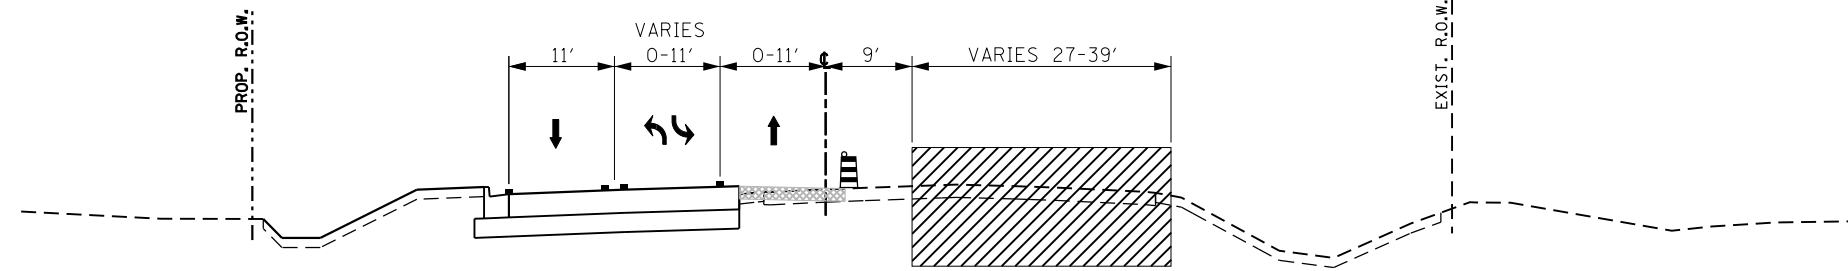
**STATE OF ILLINOIS
DEPARTMENT OF TRANSPORTATION**

SUGGESTED SEQUENCE OF CONSTRUCTION STAGE 2B TYPICAL SECTION - LARAWAY RD			
SCALE:	SHEET 1	OF 2 SHEETS	STA. TO STA.


F.A.U. RTE.	SECTION	COUNTY	TOTAL SHEETS	SHEET NO.
0320	13-00138-37-PV	WILL	413	137
CONTRACT NO. 61H20				
		ILLINOIS	FED. AID PROJECT	

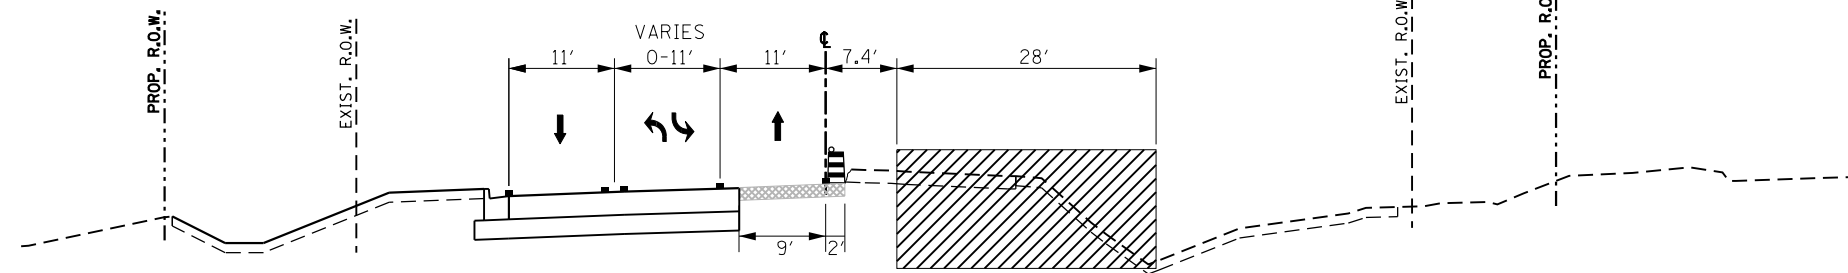

STAGE 2B TYPICAL SECTION
STA 153+10 TO 156+75.00,
160+66.81 TO 179+88.46



STAGE 2B TYPICAL SECTION
STA 179+88 TO 191+85

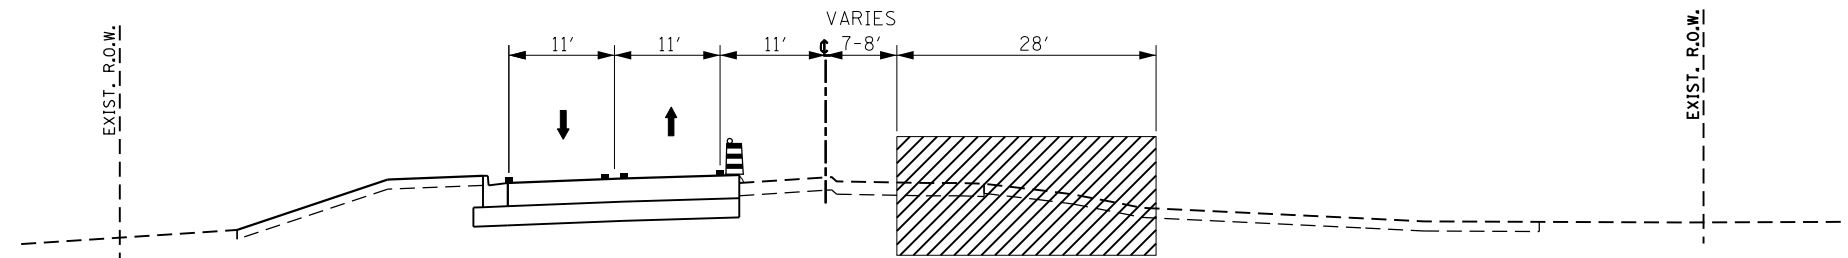

STAGE 2B TYPICAL SECTION
STA 191+85 TO 198+07.81

LEGEND

- TEMPORARY PAVEMENT MARKING LINE
- ▨ VERTICAL PANEL WITH STEADY BURN LIGHT AS REQUIRED BY SPECIFICATIONS. (50' C-C TYP., 25' C-C ON TAPERS & CURVES)
- ▩ DRUM WITH STEADY-BURN LIGHT AS REQUIRED BY SPECIFICATIONS. (50' C-C TYP., 25' C-C ON TAPERS & CURVES)
- ▧ TYPE II BARRICADE WITH STEADY-BURN LIGHT AS REQUIRED BY SPECIFICATIONS. (50' C-C TYP., 25' C-C ON TAPERS & CURVES)
- ▤ TEMPORARY CONCRETE BARRIER WITH TYPE C REFLECTORS
- ↑ DIRECTION OF TRAFFIC
- ▨ TEMPORARY PAVEMENT WIDENING CONSTRUCTED CURRENT STAGE
- ▩ TEMPORARY PAVEMENT WIDENING CONSTRUCTED PREVIOUS STAGE
- ▤ COMPLETED PAVEMENT
- ▧ WORK ZONE



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FILE NAME = sht-staging-tp-stage2b-02.dgn	DESIGNED - PML	REVISED -
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STATE OF ILLINOIS
DEPARTMENT OF TRANSPORTATION

SUGGESTED SEQUENCE OF CONSTRUCTION
STAGE 2B TYPICAL SECTION - LARAWAY RD




SCALE: SHEET 2 OF 2 SHEETS STA. TO STA.

F.A.U. RTE.	SECTION	COUNTY	TOTAL SHEETS	SHEET NO.
0320	13-00138-37-PV	WILL	413	138
CONTRACT NO. 61H20				
ILLINOIS FED. AID PROJECT				

LEGEND

VERTICAL PANEL WITH STEADY BURN LIGHT AS REQUIRED BY SPECIFICATIONS. (50' C-C TYP., 25' C-C ON TAPERS & CURVES)	TEMPORARY PAVEMENT WIDENING CONSTRUCTED CURRENT STAGE	TEMPORARY PAVEMENT MARKINGS
DRUM WITH STEADY-BURN LIGHT AS REQUIRED BY SPECIFICATIONS. (50' C-C TYP., 25' C-C ON TAPERS & CURVES)	TEMPORARY PAVEMENT WIDENING CONSTRUCTED PREVIOUS STAGE	① 4" YELLOW (SOLID)
TYPE III BARRICADE WITH STEADY-BURN LIGHT AS REQUIRED BY SPECIFICATIONS.	COMPLETED PAVEMENT (TO TOP OF BINDER COURSE)	② 4" WHITE (SOLID)
TEMPORARY CONCRETE BARRIER WITH TYPE C REFLECTOR	WORK ZONE	③ 4" WHITE (SKIP-DASH)
DIRECTION OF TRAFFIC	PAVEMENT PATCHING CLASS D (SEE PVMT PATCH DETAIL SHEETS)	④ 6" WHITE (2' DASH, 6' SKIP)
STORM SEWER CONSTRUCTED THIS STAGE	TEMPORARY ACCESS	⑤ 6" WHITE (SOLID)
STORM SEWER CONSTRUCTED PREVIOUS STAGE		⑥ 12" YELLOW (DIAGONALS) 30' C-C @45°
		⑦ 12" WHITE (DIAGONALS)
		⑧ 24" WHITE (STOP BAR)
		⑨ 4" DOUBLE YELLOW (SOLID) @11" C-C
		⑩ LETTERS & SYMBOLS

NOTES:
1. STAGE 2B LANE CONFIGURATIONS ARE THE SAME AS IN STAGE 2A UNLESS OTHERWISE NOTED.

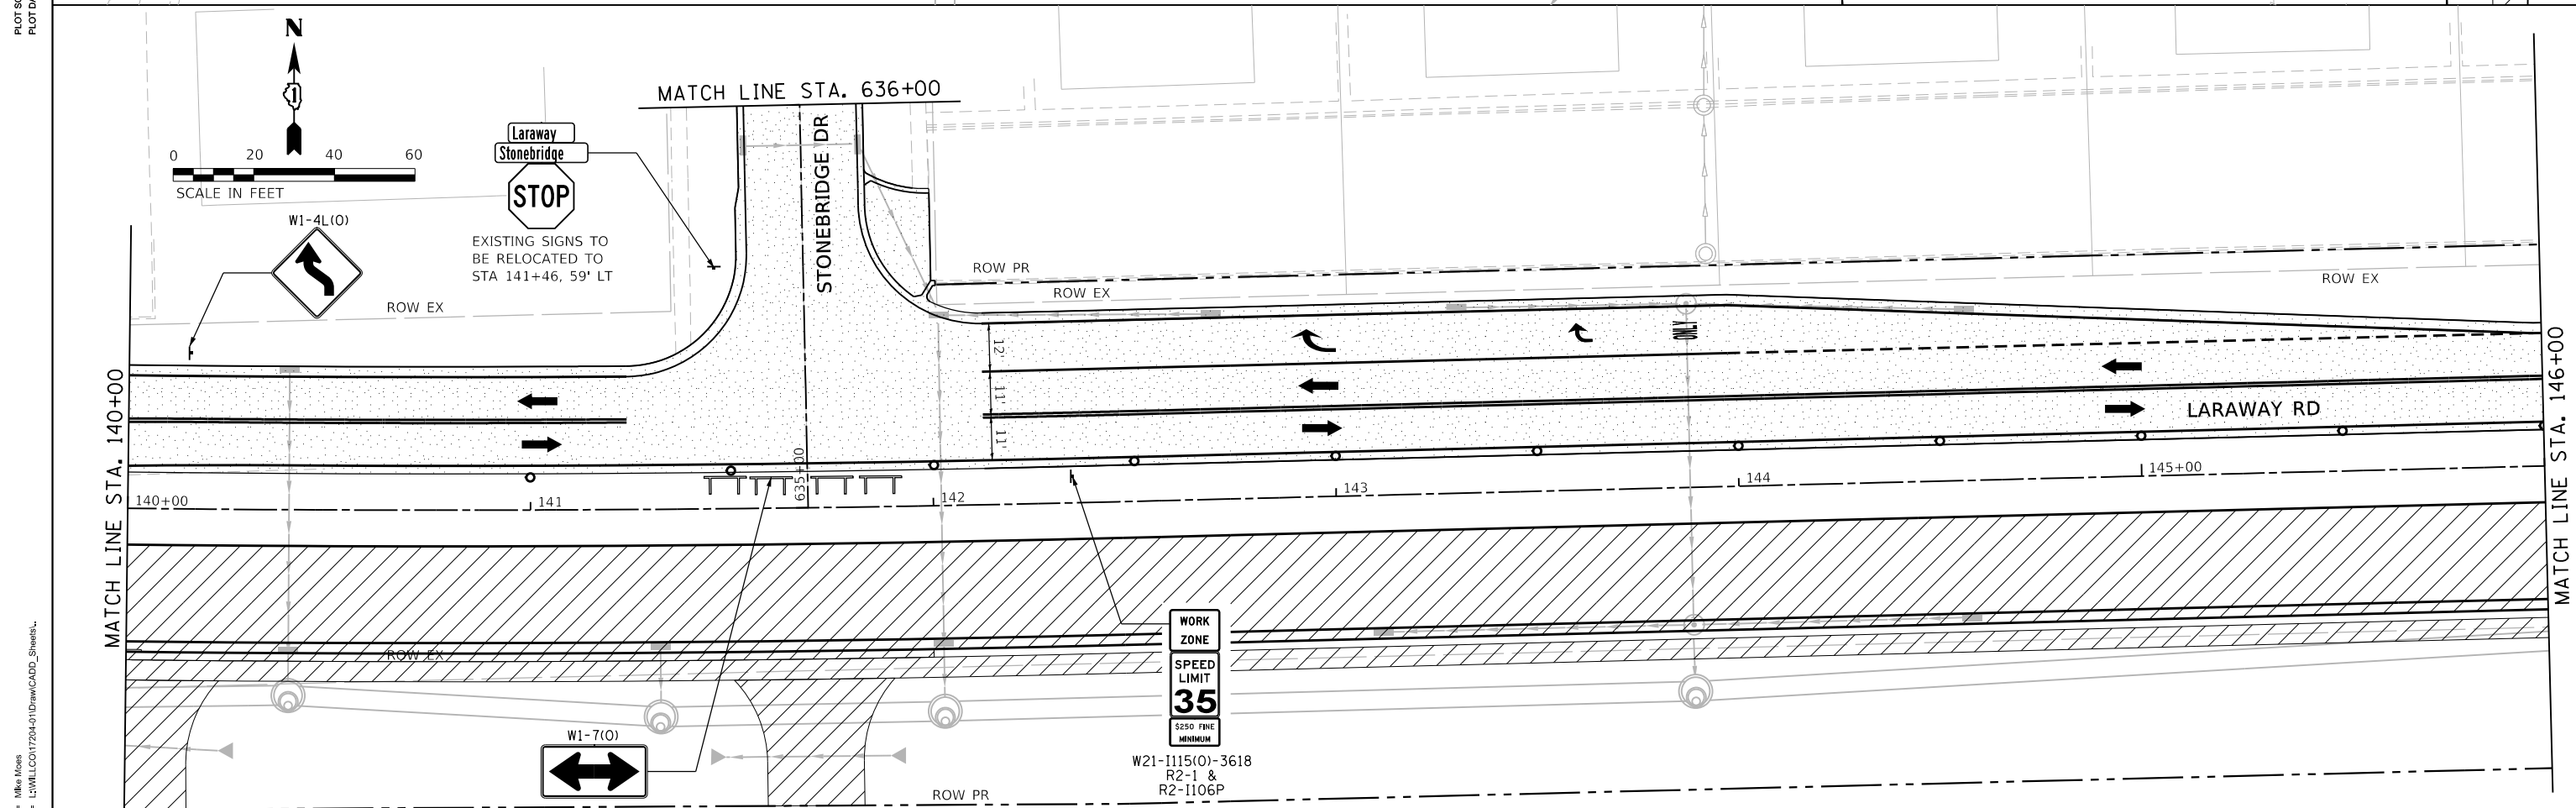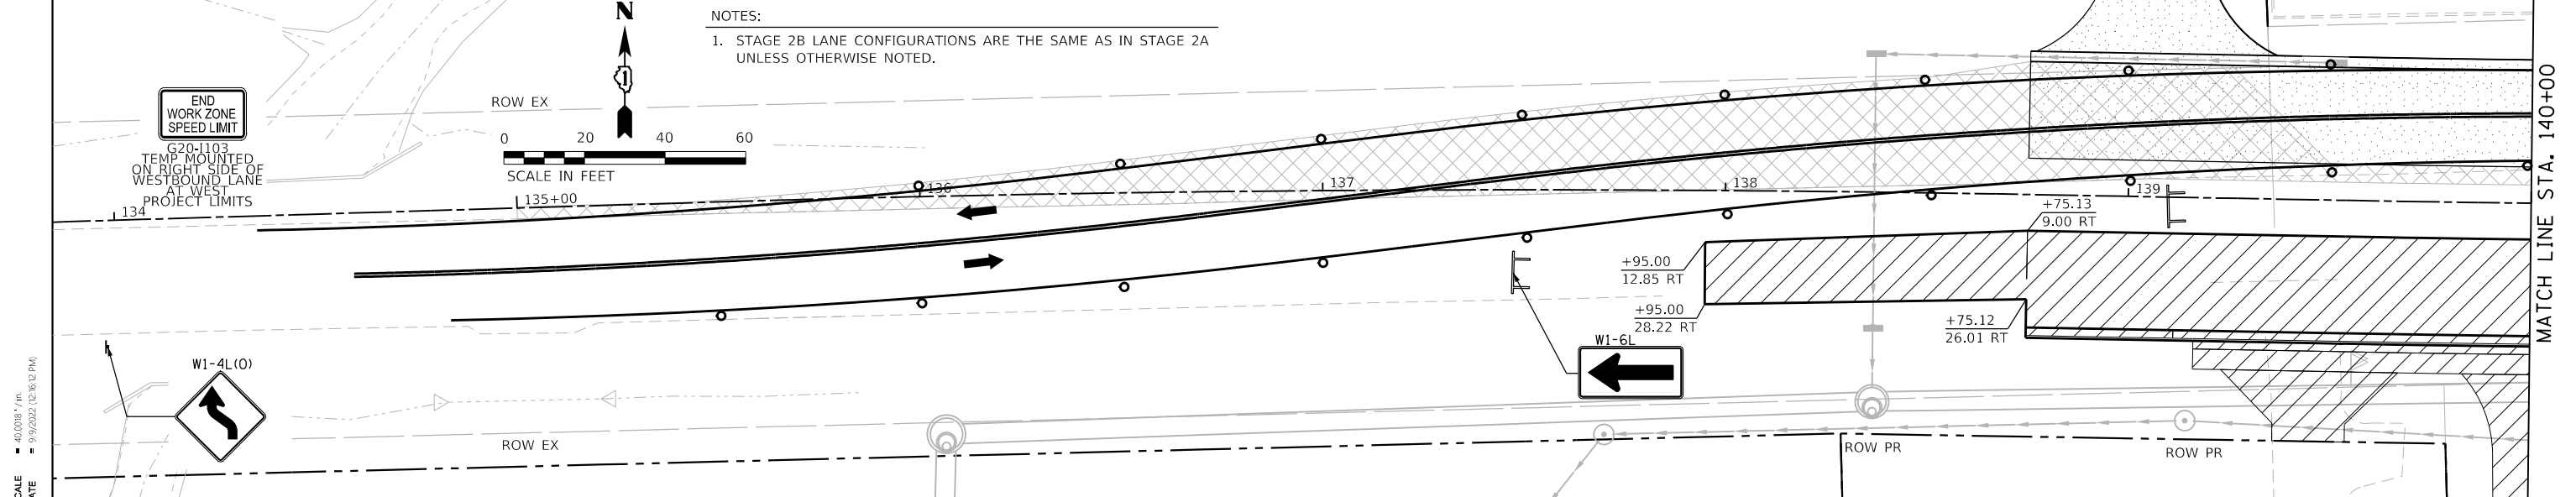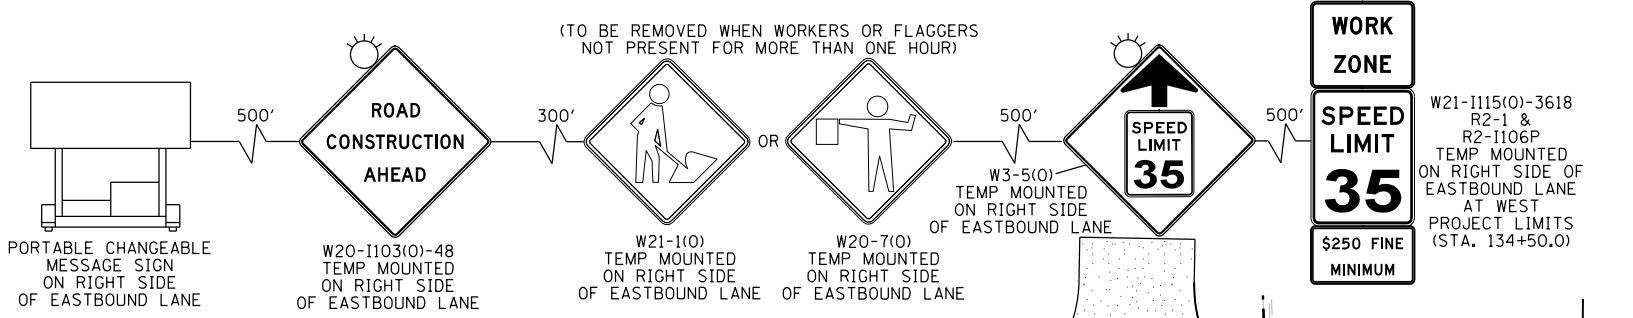


CMT License No. 184-00813	FILE NAME = sht-staging-stage02B-01.dgn	DESIGNED - JMS	REVISED -	STATE OF ILLINOIS DEPARTMENT OF TRANSPORTATION	SUGGESTED SEQUENCE OF CONSTRUCTION LARAWAY RD - STAGE 2B			F.A.U. RTE. 0320	SECTION 13-00138-37-PV	COUNTY WILL	TOTAL SHEETS 413	SHEET NO. 139
	MODEL NAME = Default	DRAWN - PML	REVISED -		SCALE: 1"=20'	SHEET 1	OF 7 SHEETS	STA. 134+00	TO STA. 146+00	CONTRACT NO. 61H20		
PLOT SCALE = 40.0018" / in.	CHECKED - JMS	REVISED -	DATE - 09/09/2022				ILLINOIS FED. AID PROJECT					
PLOT DATE = 9/9/2022 12:16:12 PM												

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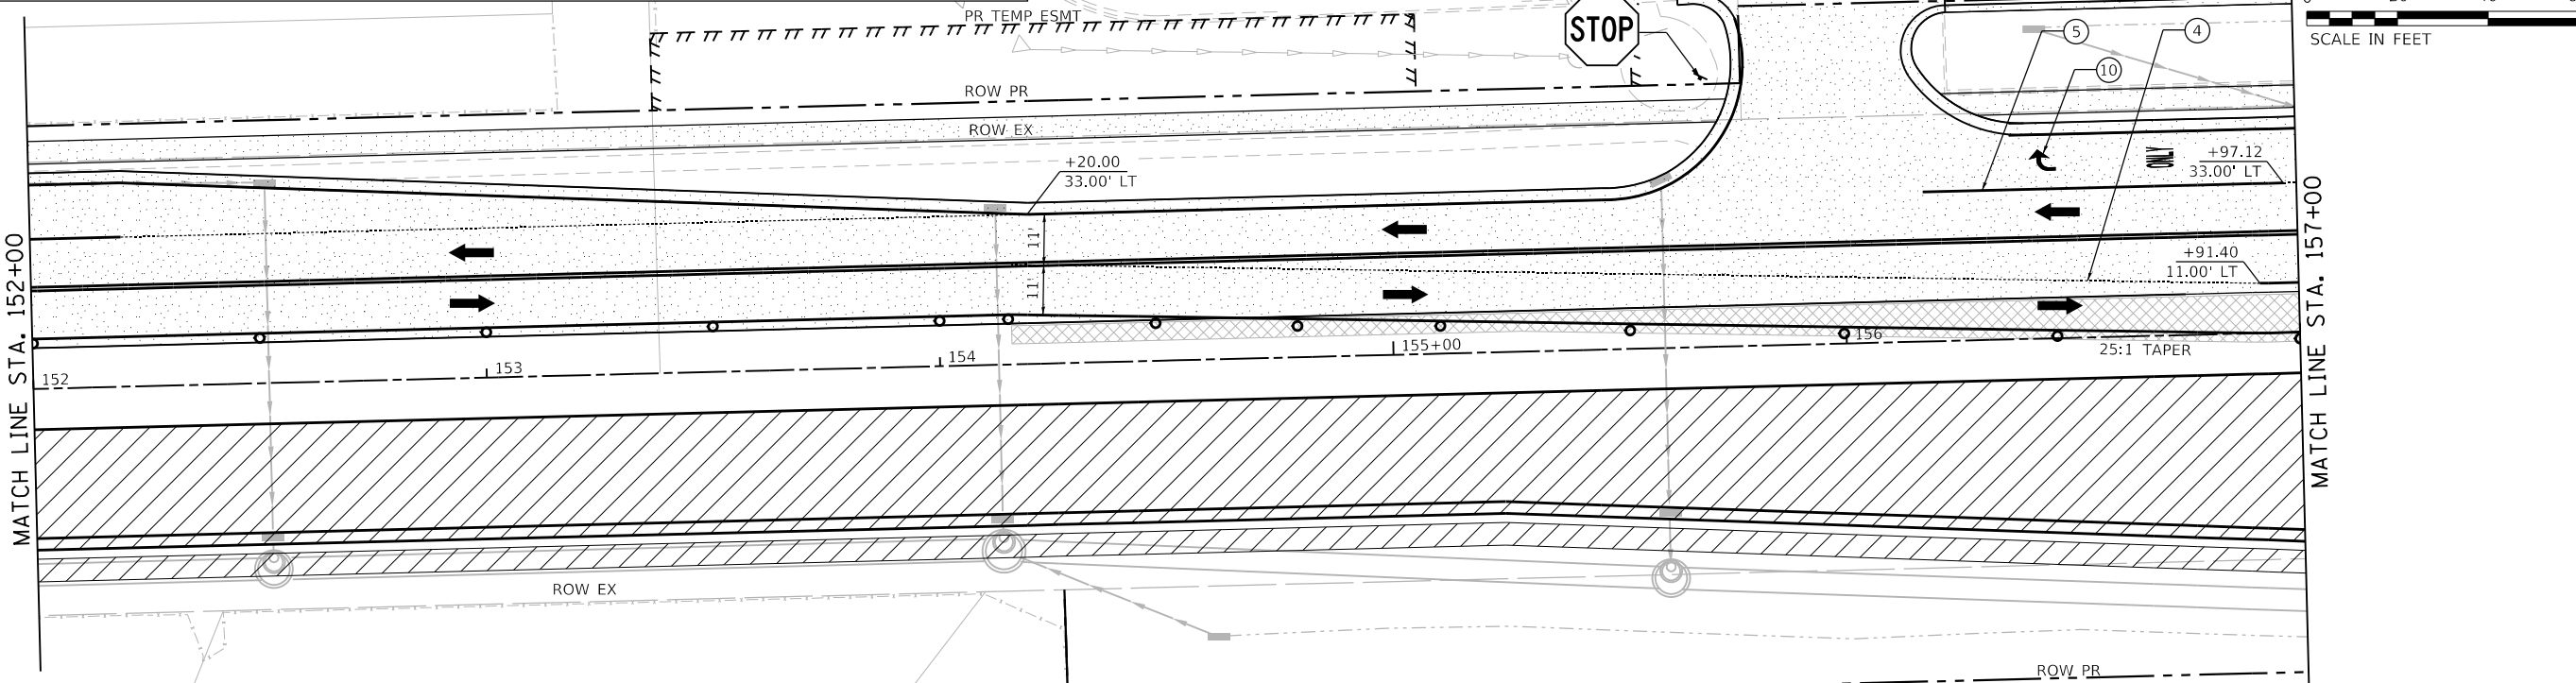
PLOT SCALE = 40.0000' / in.
PLOT DATE = 9/9/2022 12:16:13 PM

USER NAME = Mike Moses
DIRECTORY = L:\MILL\017204-01\Draw\CADD_Sheets\

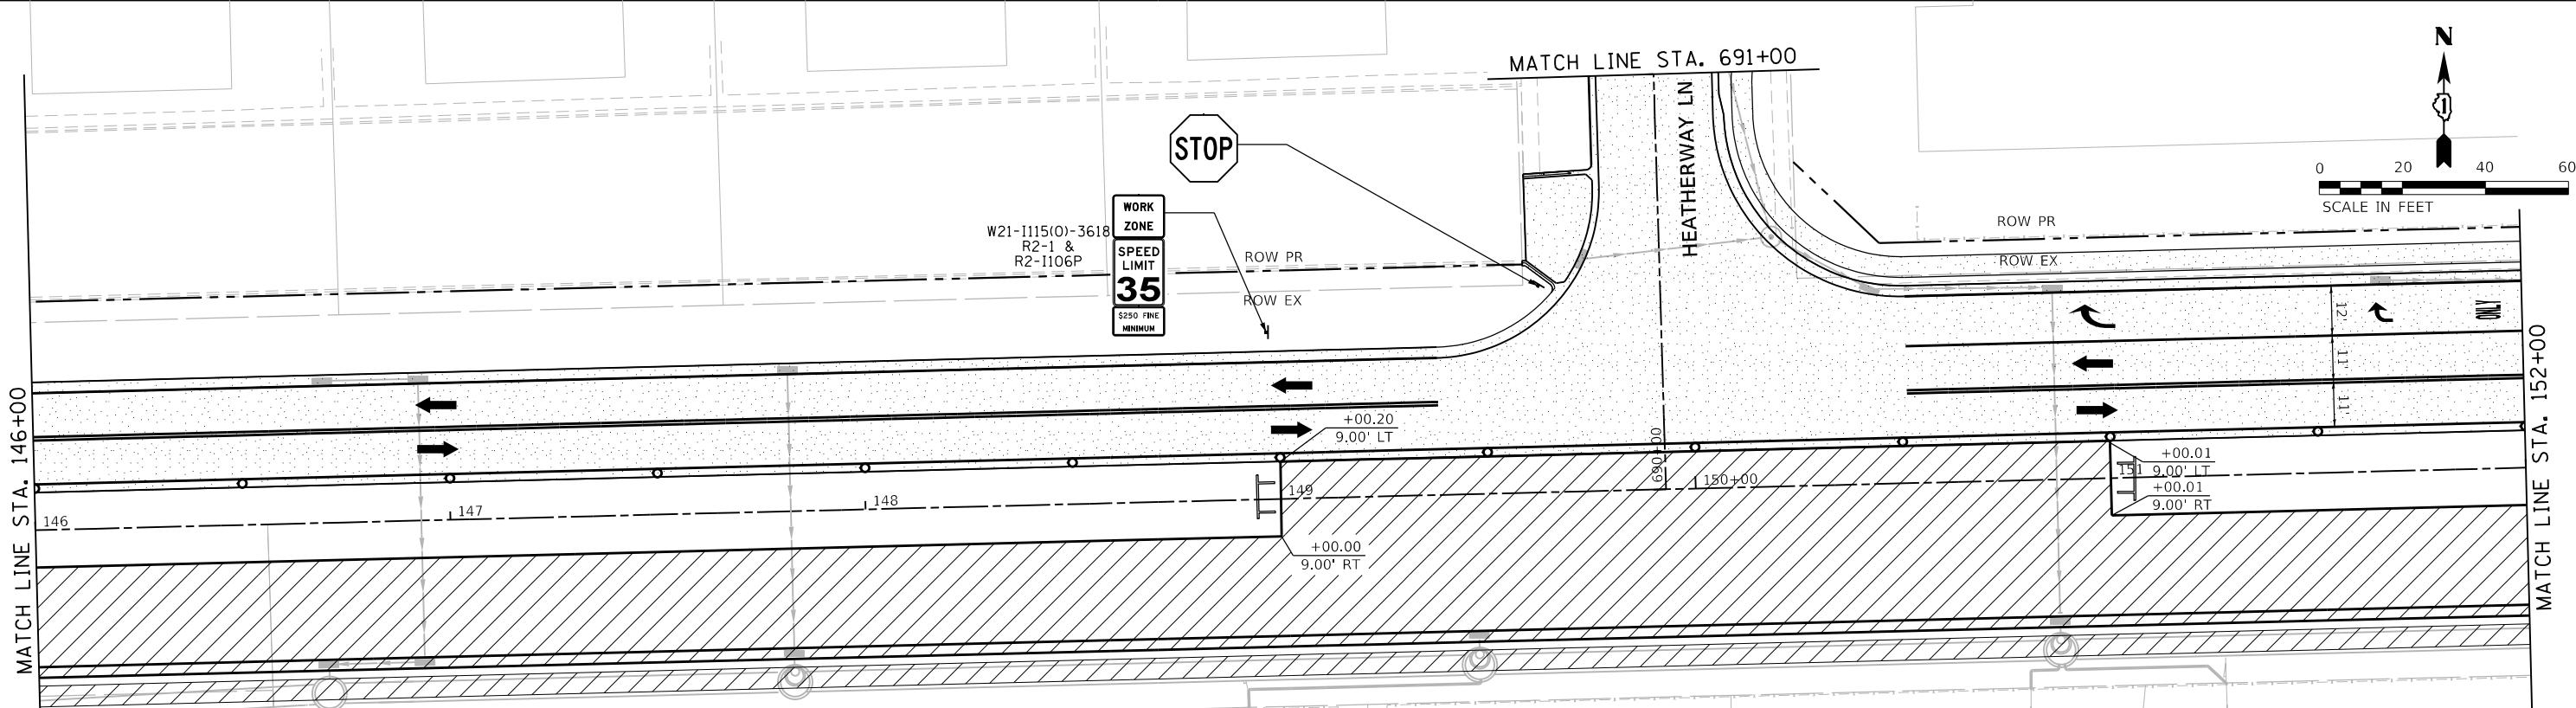

LEGEND

VERTICAL PANEL WITH STEADY BURN LIGHT AS REQUIRED BY SPECIFICATIONS. (50' C-C TYP., 25' C-C ON TAPERS & CURVES)	TEMPORARY PAVEMENT WIDENING CONSTRUCTED CURRENT STAGE	TEMPORARY PAVEMENT MARKINGS
DRUM WITH STEADY-BURN LIGHT AS REQUIRED BY SPECIFICATIONS. (50' C-C TYP., 25' C-C ON TAPERS & CURVES)	TEMPORARY PAVEMENT WIDENING CONSTRUCTED PREVIOUS STAGE	① 4" YELLOW (SOLID)
TYPE III BARRICADE WITH STEADY-BURN LIGHT AS REQUIRED BY SPECIFICATIONS.	COMPLETED PAVEMENT (TO TOP OF BINDER COURSE)	② 4" WHITE (SOLID)
TEMPORARY CONCRETE BARRIER WITH TYPE C REFLECTOR	WORK ZONE	③ 4" WHITE (SKIP-DASH)
DIRECTION OF TRAFFIC	PAVEMENT PATCHING CLASS D (SEE PVMT PATCH DETAIL SHEETS)	④ 6" WHITE (2' DASH, 6' SKIP)
STORM SEWER CONSTRUCTED THIS STAGE	TEMPORARY ACCESS	⑤ 6" WHITE (SOLID)
STORM SEWER CONSTRUCTED PREVIOUS STAGE		⑥ 12" YELLOW (DIAGONALS) 30' C-C @45°
		⑦ 12" WHITE (DIAGONALS)
		⑧ 24" WHITE (STOP BAR)
		⑨ 4" DOUBLE YELLOW (SOLID) @11" C-C
		⑩ LETTERS & SYMBOLS



FILE NAME = sht-staging-stage02B-02.dgn	DESIGNED - BRF	REVISED -
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PLOT DATE = 9/9/2022 - 12:16:13 PM	DATE - 09/09/2022	REVISED -

**STATE OF ILLINOIS
DEPARTMENT OF TRANSPORTATION**

**SUGGESTED SEQUENCE OF CONSTRUCTION
LARAWAY RD - STAGE 2B**



SCALE: 1"=20' SHEET 2 OF 7 SHEETS STA. 146+00 TO STA. 157+00

F.A.U. RTE. 0320	SECTION 13-00138-37-PV	COUNTY WILL	TOTAL SHEETS 413	SHEET NO. 140
CONTRACT NO. 61H20				
ILLINOIS FED. AID PROJECT				

PLOT DRIVER
PENTABLE
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PLOT SCALE
PLOT DATE
= 40.0000' / 1" = 9/9/2022 (12:16:15 PM)

USER NAME
DIRECTORY
= Mike Moses = L:\MILLCO\17204-01\Draw\CADD_Sheets\

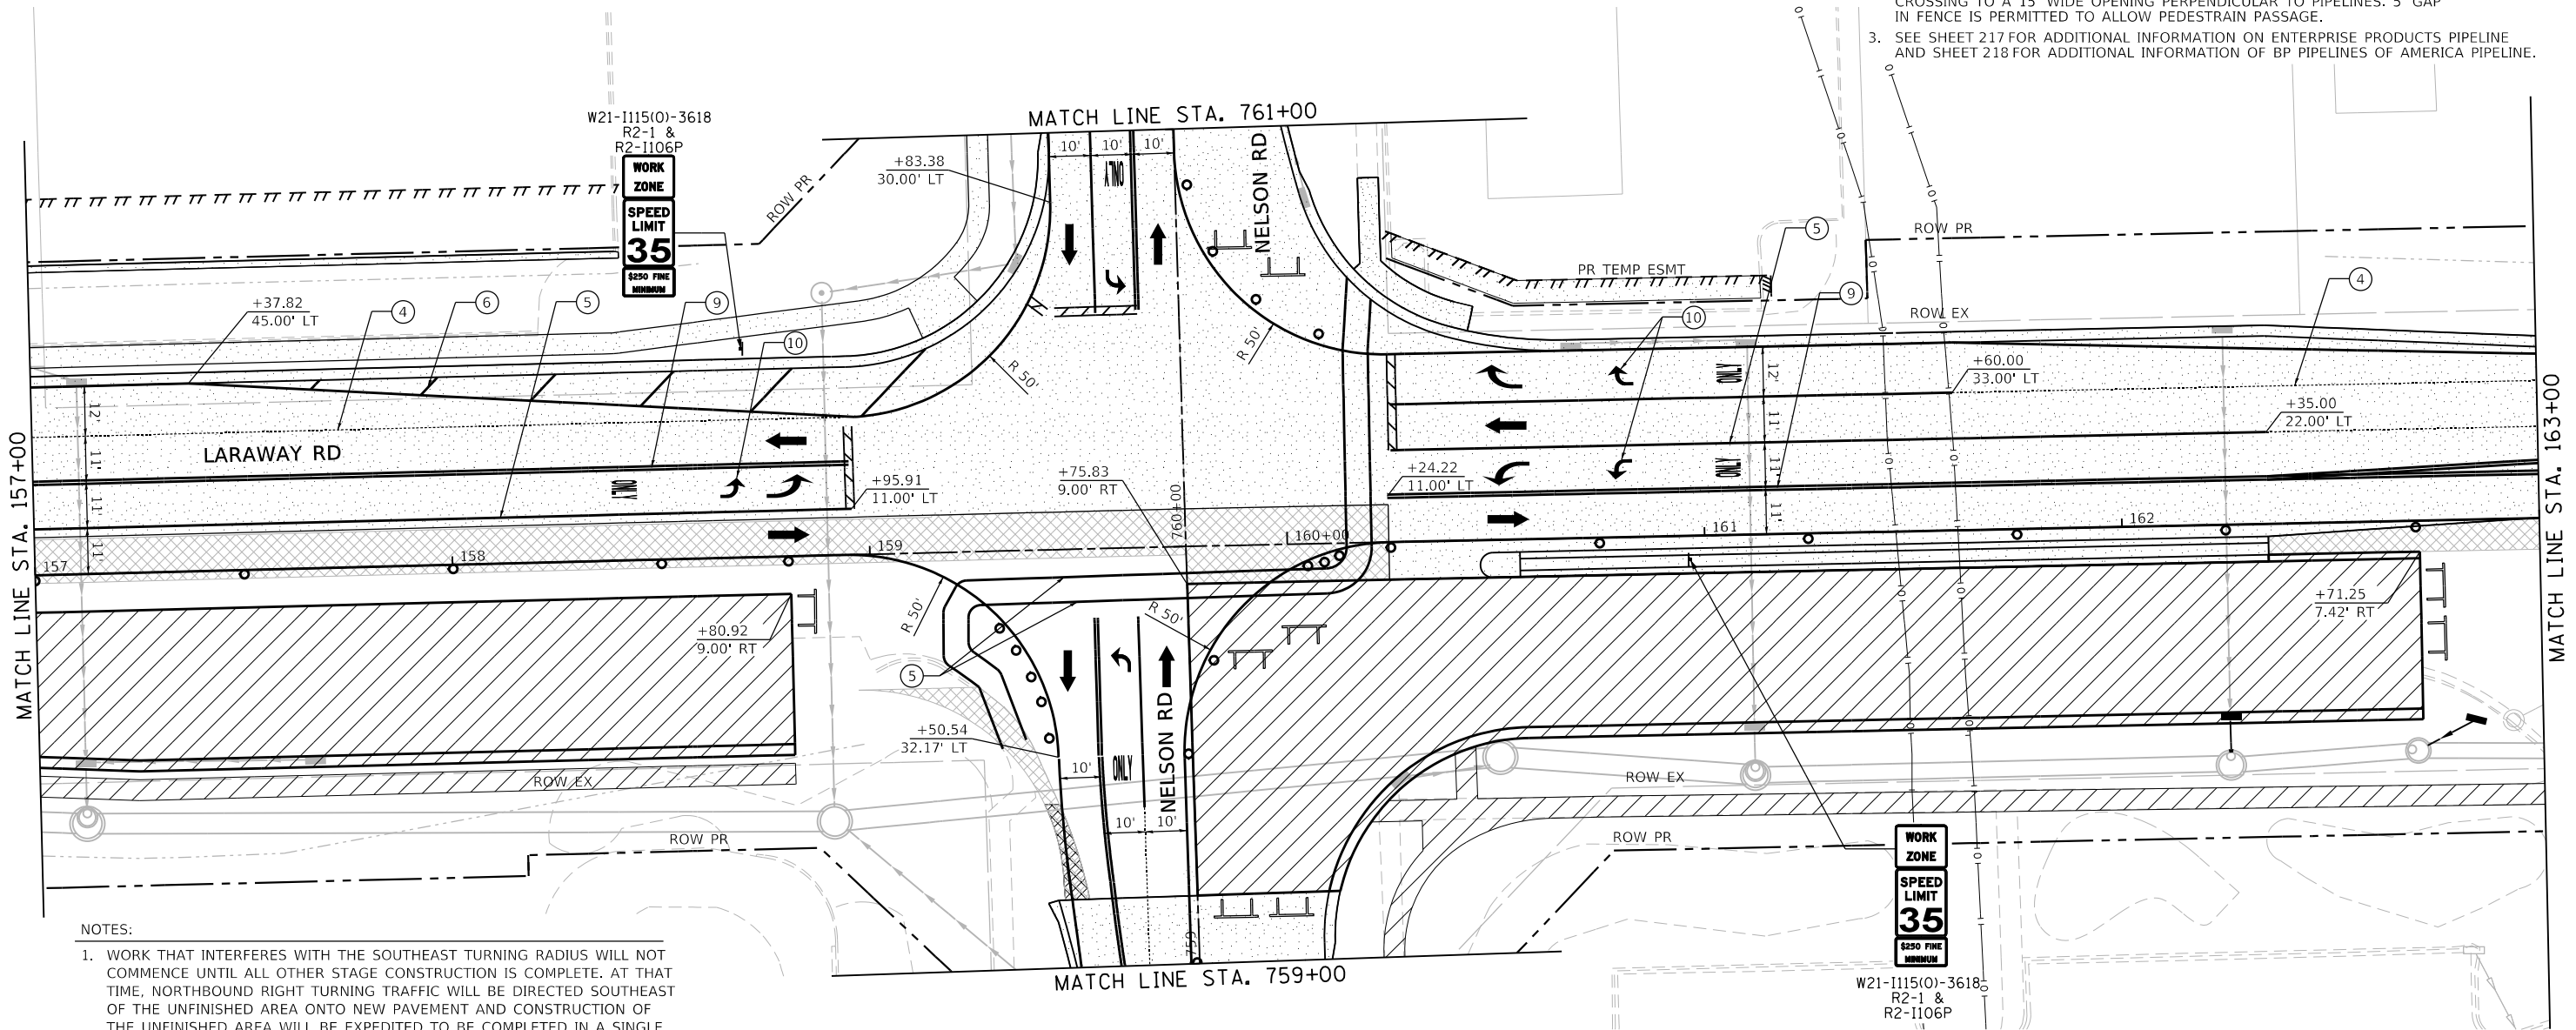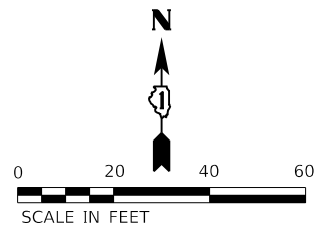

- PIPELINE STAGING NOTES:**
- CONTRACTOR MUST CONTACT PIPELINE COMPANIES TO COORDINATE ALL WORK IN THE VICINITY OF THE PIPELINES. CONTRACTOR MUST FOLLOW ALL REQUIREMENTS OF THESE PLANS, SPECIFICATIONS, PIPELINE ENCROACHMENT GUIDELINES, AND ANY OTHER REQUIREMENTS COMMUNICATED BY PIPELINE COMPANY REPRESENTATIVES REGARDING WORK AROUND THE PIPELINES.
BP PIPELINES OF AMERICA
 STEVE ADAMS
 OFFICE: 779.801.4969
 EMAIL: steve.adams@bp.com
ENTERPRISE PRODUCTS
 BLAKE HAMILTON
 OFFICE: 815.277.7286
 CELL: 217.508.2991
 EMAIL: bdhamilton@eprod.com
 - TEMPORARY FENCE SHALL BE REPOSITIONED TO A LOCATION APPROVED BY THE ENGINEER AND THE PIPELINE REPRESENTATIVES TO LIMIT EQUIPMENT CROSSING TO A 15' WIDE OPENING PERPENDICULAR TO PIPELINES. 5' GAP IN FENCE IS PERMITTED TO ALLOW PEDESTRIAN PASSAGE.
 - SEE SHEET 217 FOR ADDITIONAL INFORMATION ON ENTERPRISE PRODUCTS PIPELINE AND SHEET 218 FOR ADDITIONAL INFORMATION OF BP PIPELINES OF AMERICA PIPELINE.

- NOTES:**
- WORK THAT INTERFERES WITH THE SOUTHEAST TURNING RADIUS WILL NOT COMMENCE UNTIL ALL OTHER STAGE CONSTRUCTION IS COMPLETE. AT THAT TIME, NORTHBOUND RIGHT TURNING TRAFFIC WILL BE DIRECTED SOUTHEAST OF THE UNFINISHED AREA ONTO NEW PAVEMENT AND CONSTRUCTION OF THE UNFINISHED AREA WILL BE EXPEDITED TO BE COMPLETED IN A SINGLE DAY.
 - SEE TEMPORARY TRAFFIC SIGNAL PLANS FOR CROSSWALK CONFIGURATIONS.

LEGEND

VERTICAL PANEL WITH STEADY BURN LIGHT AS REQUIRED BY SPECIFICATIONS. (50' C-C TYP., 25' C-C ON TAPERS & CURVES)	TEMPORARY PAVEMENT WIDENING CONSTRUCTED CURRENT STAGE	TEMPORARY PAVEMENT MARKINGS
DRUM WITH STEADY-BURN LIGHT AS REQUIRED BY SPECIFICATIONS. (50' C-C TYP., 25' C-C ON TAPERS & CURVES)	TEMPORARY PAVEMENT WIDENING CONSTRUCTED PREVIOUS STAGE	① 4" YELLOW (SOLID)
TYPE III BARRICADE WITH STEADY-BURN LIGHT AS REQUIRED BY SPECIFICATIONS.	COMPLETED PAVEMENT (TO TOP OF BINDER COURSE)	② 4" WHITE (SOLID)
TEMPORARY CONCRETE BARRIER WITH TYPE C REFLECTOR	WORK ZONE	③ 4" WHITE (SKIP-DASH)
DIRECTION OF TRAFFIC	PAVEMENT PATCHING CLASS D (SEE PVMT PATCH DETAIL SHEETS)	④ 6" WHITE (2' DASH, 6' SKIP)
STORM SEWER CONSTRUCTED THIS STAGE	TEMPORARY ACCESS	⑤ 6" WHITE (SOLID)
STORM SEWER CONSTRUCTED PREVIOUS STAGE		⑥ 12" YELLOW (DIAGONALS) 30' C-C @45°
		⑦ 12" WHITE (DIAGONALS)
		⑧ 24" WHITE (STOP BAR)
		⑨ 4" DOUBLE YELLOW (SOLID) @11" C-C
		⑩ LETTERS & SYMBOLS

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	PLOT DATE = 9/9/2022 - 12:16:15 PM	DATE - 09/09/2022	REVISED -

**STATE OF ILLINOIS
DEPARTMENT OF TRANSPORTATION**

**SUGGESTED SEQUENCE OF CONSTRUCTION
LARAWAY RD - STAGE 2B**



SCALE: 1"=20' SHEET 3 OF 7 SHEETS STA. 157+00 TO STA. 163+00

F.A.U. RTE.	SECTION	COUNTY	TOTAL SHEETS	SHEET NO.
0320	13-00138-37-PV	WILL	413	141
CONTRACT NO. 61H20				
ILLINOIS FED. AID PROJECT				

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PENTABLE = Laraway_Stage2B.dwg

PLOT SCALE = 40.0000' / in.
PLOT DATE = 9/9/2022 (12:16:16 PM)

USER NAME = Mike Moses
DIRECTORY = L:\MILL\017204-01\Drawn\CADD_Sheets\

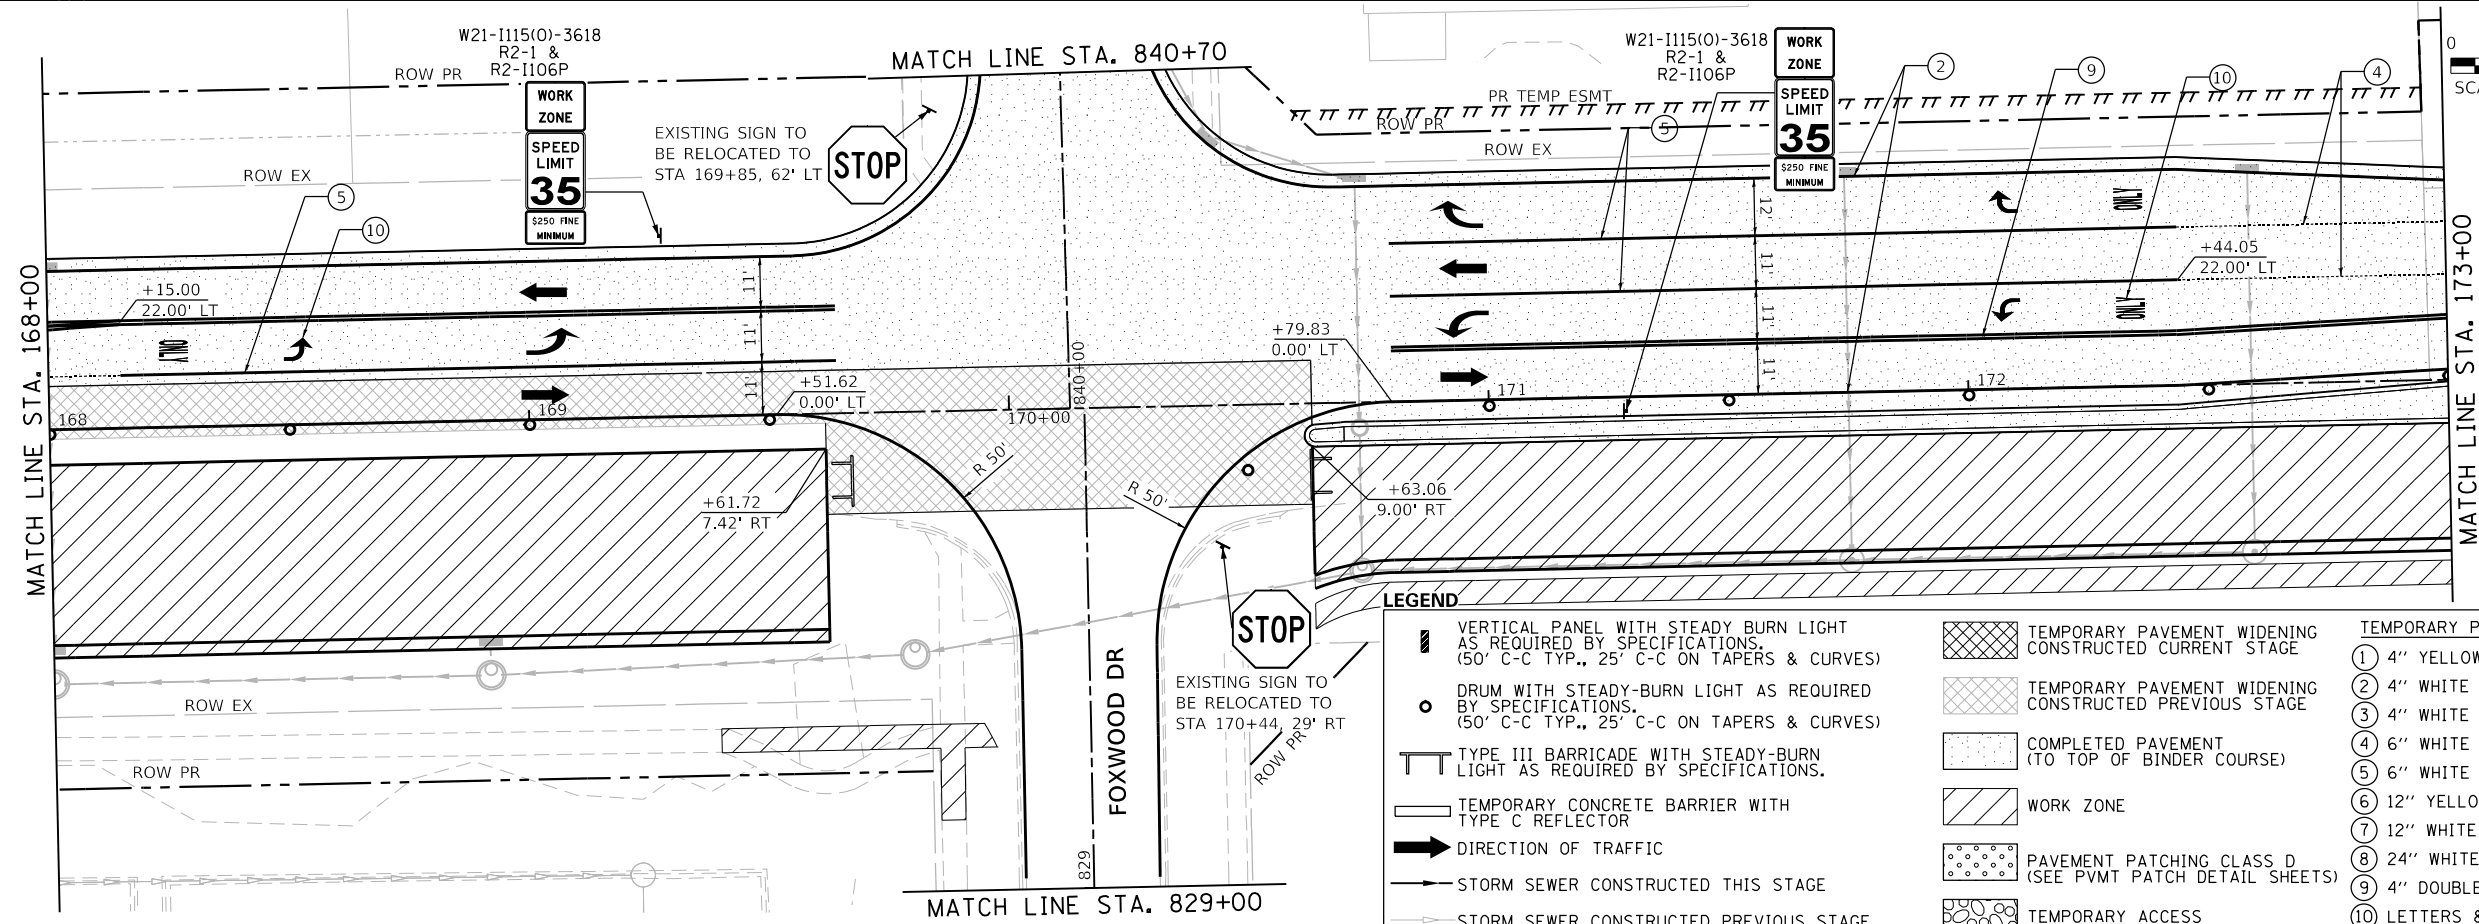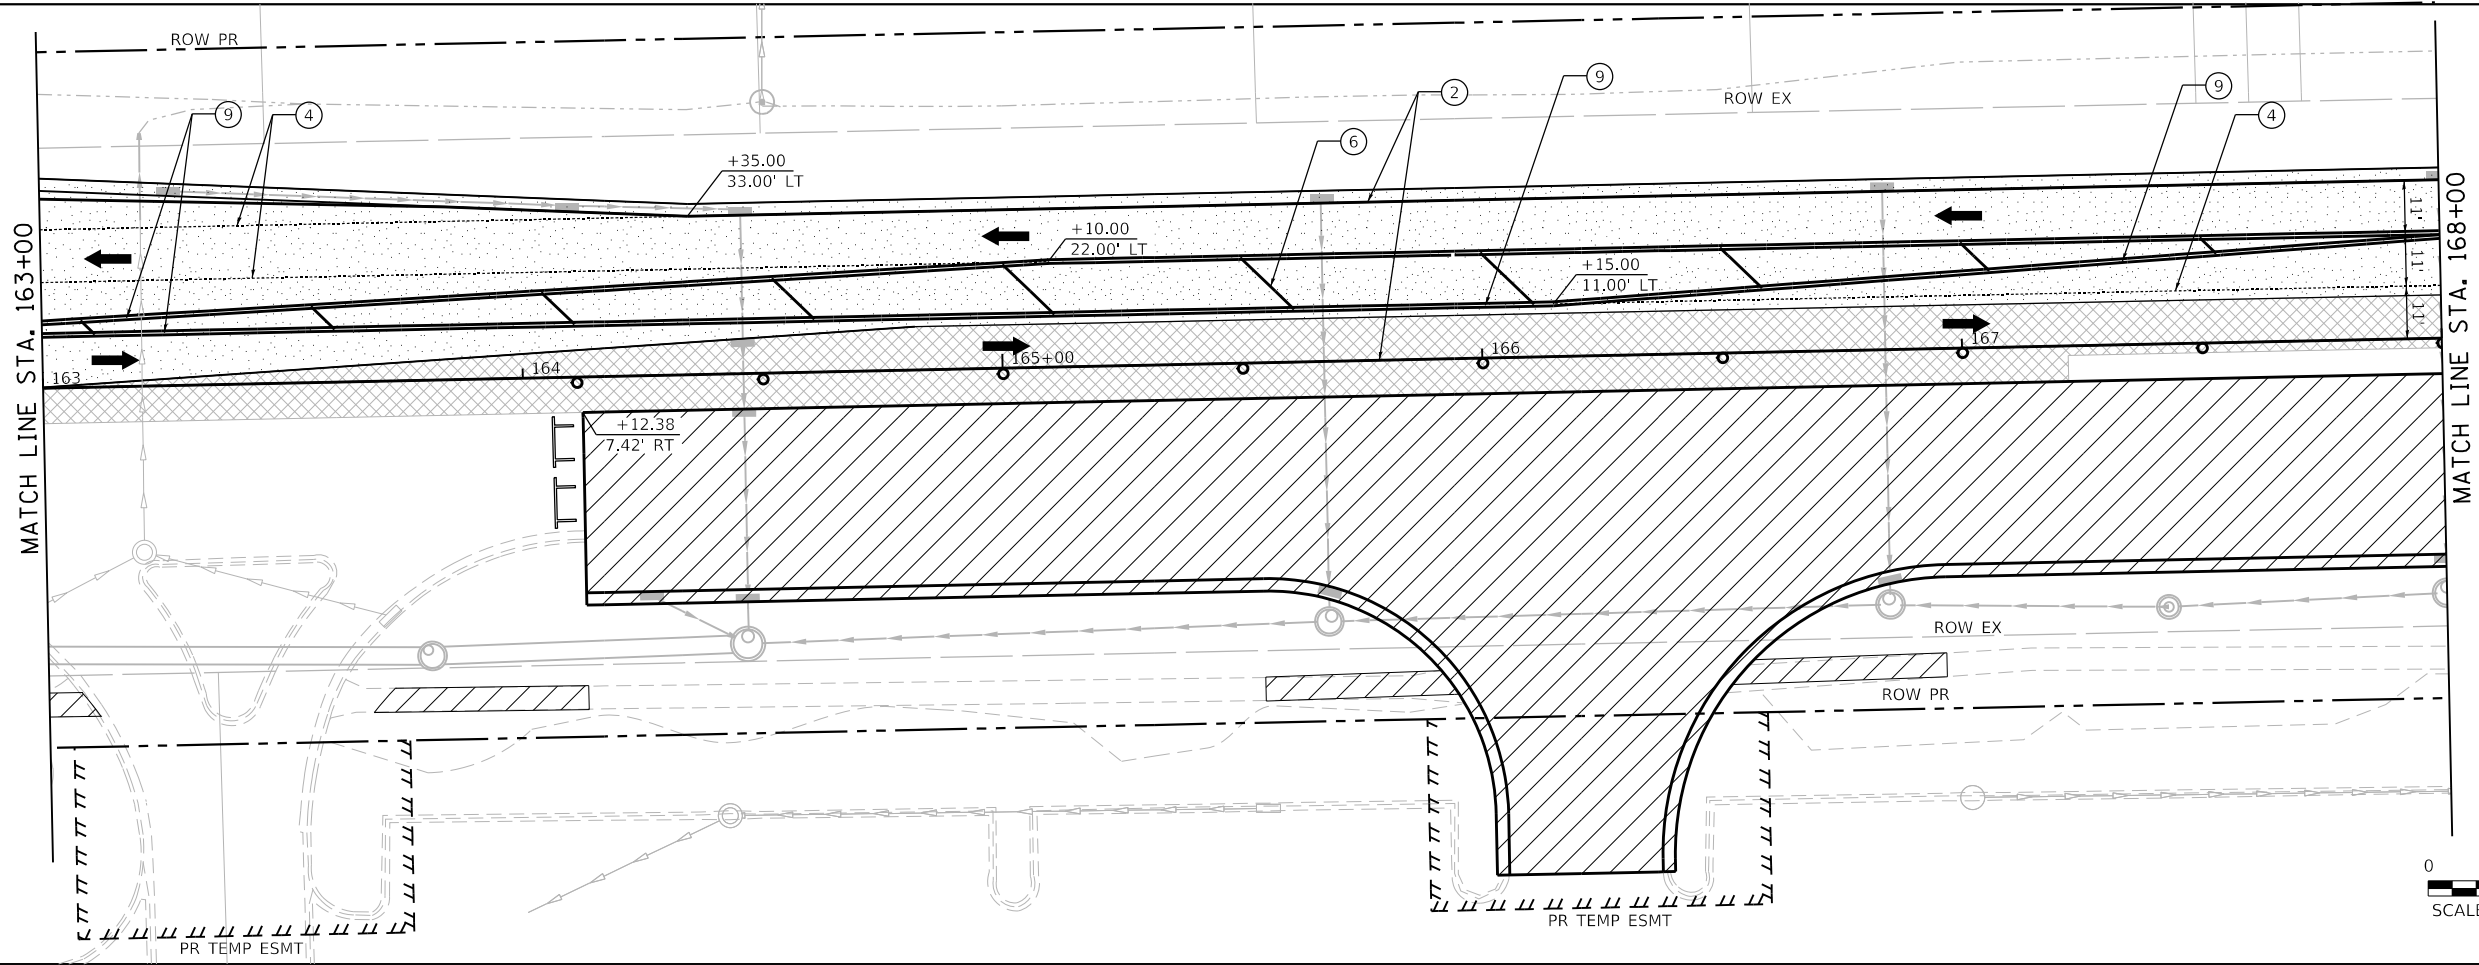

LEGEND

VERTICAL PANEL WITH STEADY BURN LIGHT AS REQUIRED BY SPECIFICATIONS. (50' C-C TYP., 25' C-C ON TAPERS & CURVES)	TEMPORARY PAVEMENT WIDENING CONSTRUCTED CURRENT STAGE	TEMPORARY PAVEMENT MARKINGS
DRUM WITH STEADY-BURN LIGHT AS REQUIRED BY SPECIFICATIONS. (50' C-C TYP., 25' C-C ON TAPERS & CURVES)	TEMPORARY PAVEMENT WIDENING CONSTRUCTED PREVIOUS STAGE	① 4" YELLOW (SOLID)
TYPE III BARRICADE WITH STEADY-BURN LIGHT AS REQUIRED BY SPECIFICATIONS.	COMPLETED PAVEMENT (TO TOP OF BINDER COURSE)	② 4" WHITE (SOLID)
TEMPORARY CONCRETE BARRIER WITH TYPE C REFLECTOR	WORK ZONE	③ 4" WHITE (SKIP-DASH)
DIRECTION OF TRAFFIC	PAVEMENT PATCHING CLASS D (SEE PVMT PATCH DETAIL SHEETS)	④ 6" WHITE (2' DASH, 6' SKIP)
STORM SEWER CONSTRUCTED THIS STAGE	TEMPORARY ACCESS	⑤ 6" WHITE (SOLID)
STORM SEWER CONSTRUCTED PREVIOUS STAGE		⑥ 12" YELLOW (DIAGONALS) 30' C-C @45°
		⑦ 12" WHITE (DIAGONALS)
		⑧ 24" WHITE (STOP BAR)
		⑨ 4" DOUBLE YELLOW (SOLID) @11" C-C
		⑩ LETTERS & SYMBOLS



FILE NAME = sht-staging-stage02B-04.dgn	DESIGNED - BRF	REVISED -
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PLOT DATE = 9/9/2022 - 12:16:16 PM	DATE - 09/09/2022	REVISED -

**STATE OF ILLINOIS
DEPARTMENT OF TRANSPORTATION**

**SUGGESTED SEQUENCE OF CONSTRUCTION
LARAWAY RD - STAGE 2B**


SCALE: 1"=20' SHEET 4 OF 7 SHEETS STA. 163+00 TO STA. 173+00

F.A.U. RTE. 0320	SECTION 13-00138-37-PV	COUNTY WILL	TOTAL SHEETS 413	SHEET NO. 142
CONTRACT NO. 61H20				
ILLINOIS FED. AID PROJECT				

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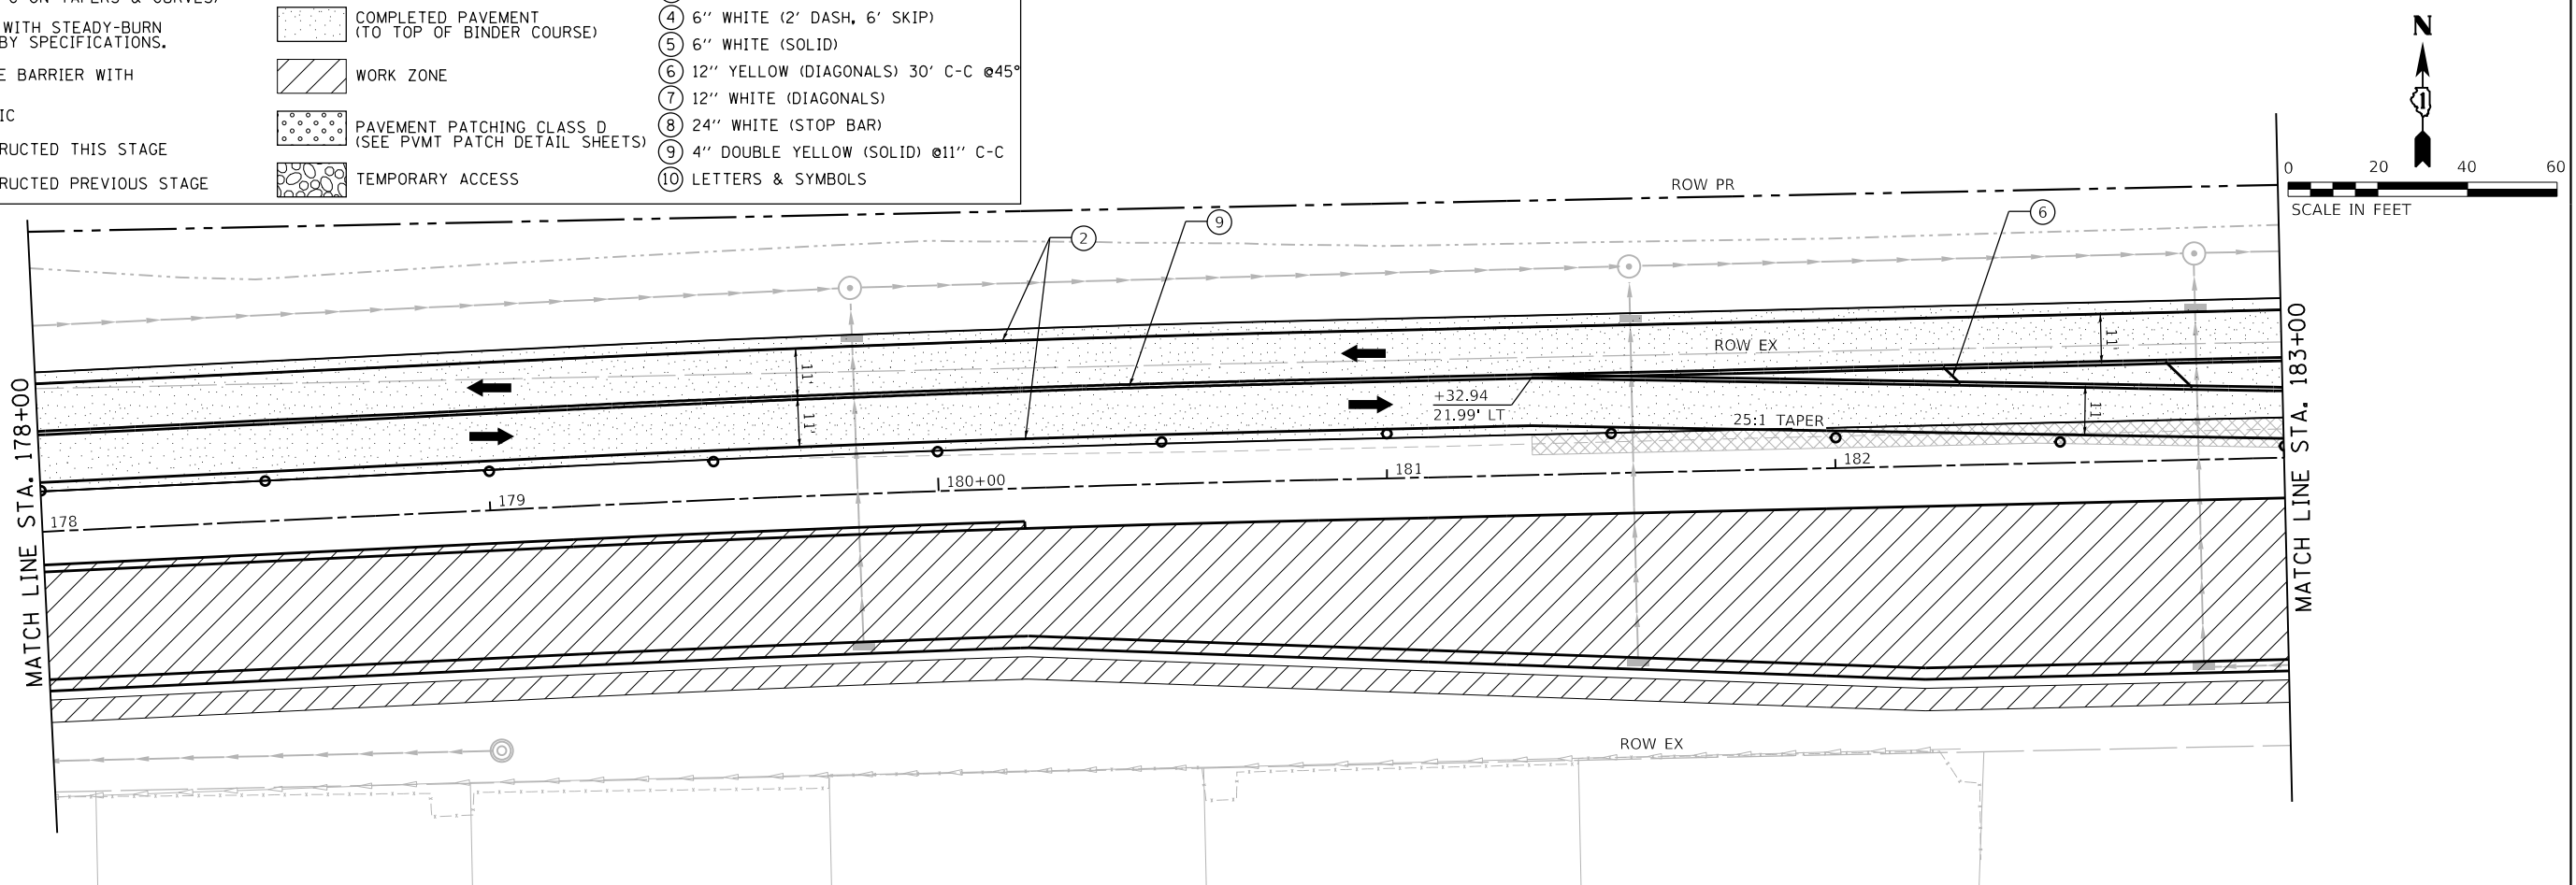
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USER NAME = Mike Moses
DIRECTORY = L:\MILL\017204-01\Drawn\CADD_Sheets\



LEGEND

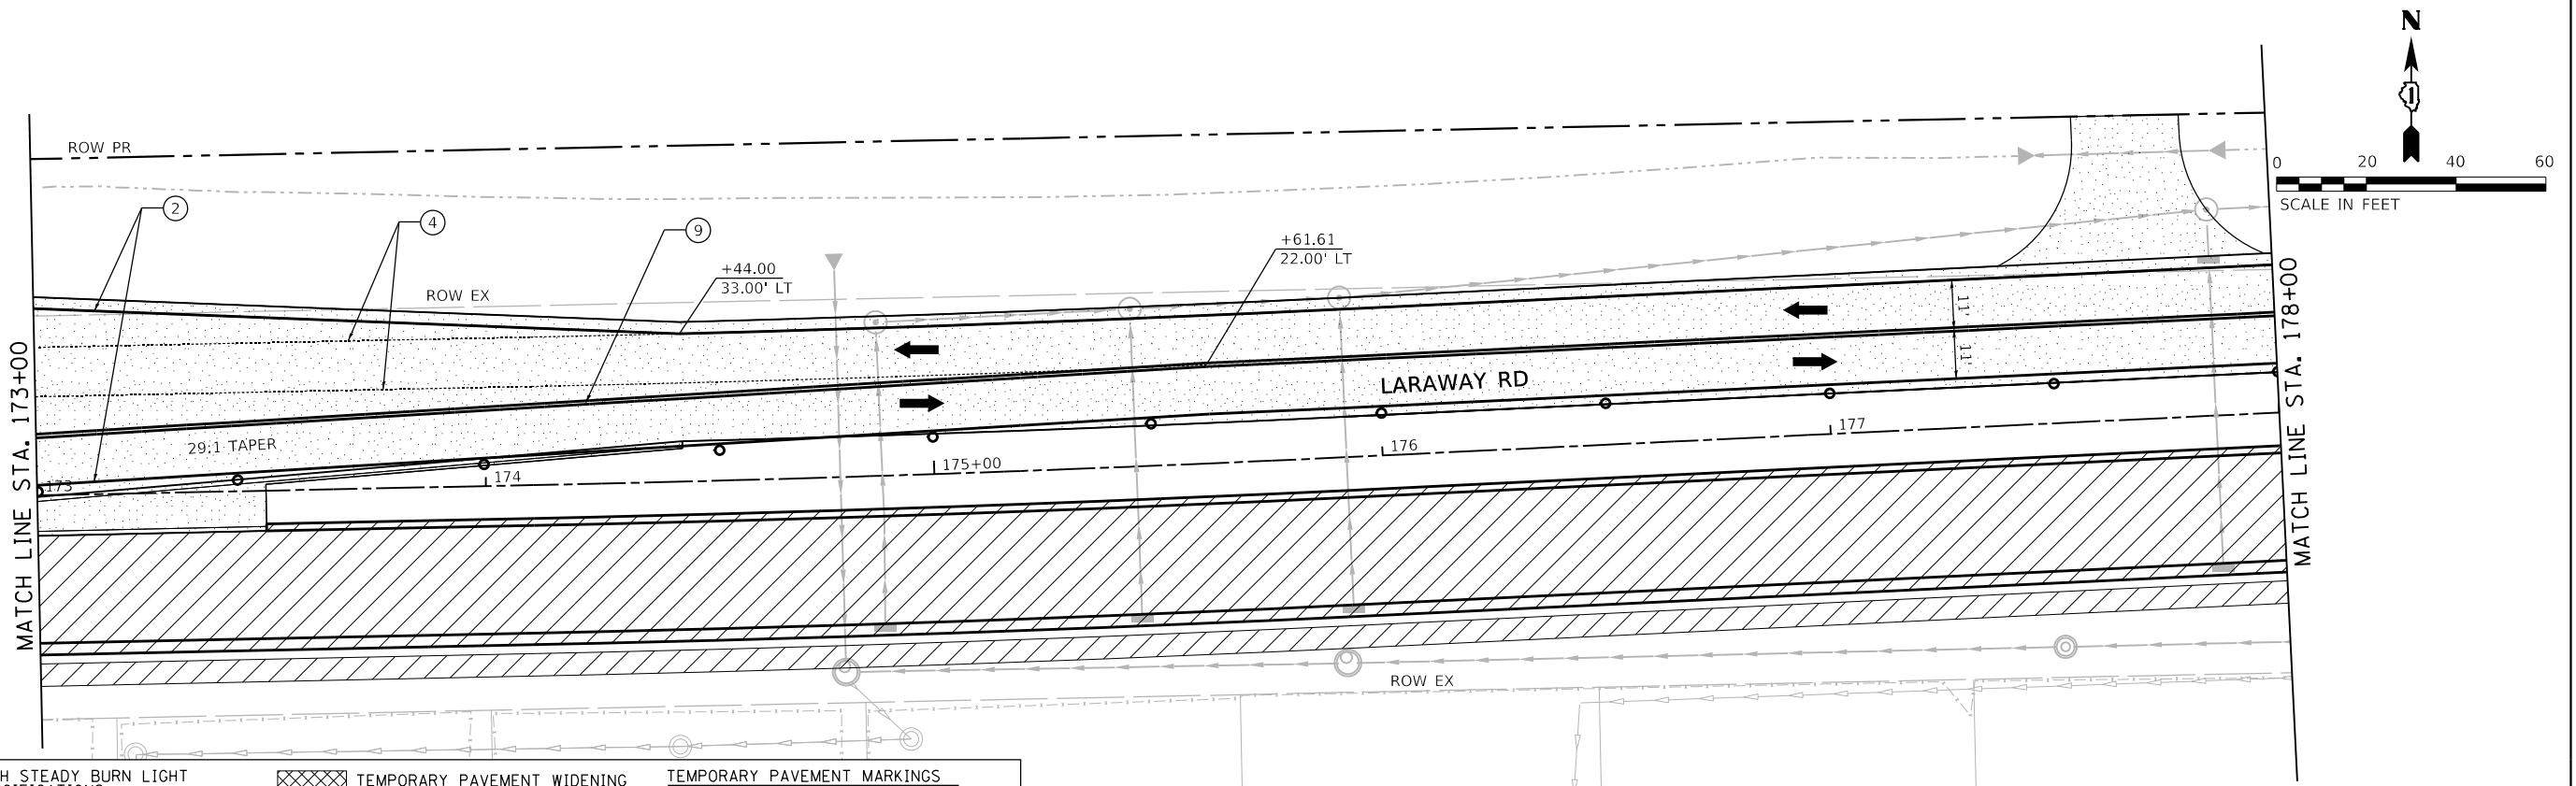	VERTICAL PANEL WITH STEADY BURN LIGHT AS REQUIRED BY SPECIFICATIONS. (50' C-C TYP., 25' C-C ON TAPERS & CURVES)		TEMPORARY PAVEMENT WIDENING CONSTRUCTED CURRENT STAGE	TEMPORARY PAVEMENT MARKINGS
	DRUM WITH STEADY-BURN LIGHT AS REQUIRED BY SPECIFICATIONS. (50' C-C TYP., 25' C-C ON TAPERS & CURVES)		TEMPORARY PAVEMENT WIDENING CONSTRUCTED PREVIOUS STAGE	① 4" YELLOW (SOLID)
	TYPE III BARRICADE WITH STEADY-BURN LIGHT AS REQUIRED BY SPECIFICATIONS.		COMPLETED PAVEMENT (TO TOP OF BINDER COURSE)	② 4" WHITE (SOLID)
	TEMPORARY CONCRETE BARRIER WITH TYPE C REFLECTOR		WORK ZONE	③ 4" WHITE (SKIP-DASH)
	DIRECTION OF TRAFFIC		PAVEMENT PATCHING CLASS D (SEE PVMT PATCH DETAIL SHEETS)	④ 6" WHITE (2' DASH, 6' SKIP)
	STORM SEWER CONSTRUCTED THIS STAGE		TEMPORARY ACCESS	⑤ 6" WHITE (SOLID)
	STORM SEWER CONSTRUCTED PREVIOUS STAGE			⑥ 12" YELLOW (DIAGONALS) 30' C-C @45°
				⑦ 12" WHITE (DIAGONALS)
				⑧ 24" WHITE (STOP BAR)
				⑨ 4" DOUBLE YELLOW (SOLID) @11" C-C
				⑩ LETTERS & SYMBOLS



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PLOT DATE = 9/9/2022 - 12:16:18 PM	DATE - 09/09/2022	REVISED -

STATE OF ILLINOIS
DEPARTMENT OF TRANSPORTATION

SUGGESTED SEQUENCE OF CONSTRUCTION
LARAWAY RD - STAGE 2B


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F.A.U. RTE.	SECTION	COUNTY	TOTAL SHEETS	SHEET NO.
0320	13-00138-37-PV	WILL	413	143
CONTRACT NO. 61H20				
ILLINOIS FED. AID PROJECT				

PLOT DRIVER
PENTABLE
= Laraway_stage2b.dwg

PLOT SCALE
PLOT DATE
= 40.0018' / in.
= 9/9/2022 (12:16:20 PM)

USER NAME
DIRECTORY
= Mike Moses
= L:\MILL\017204-01\Drawn\CADD_Sheets\

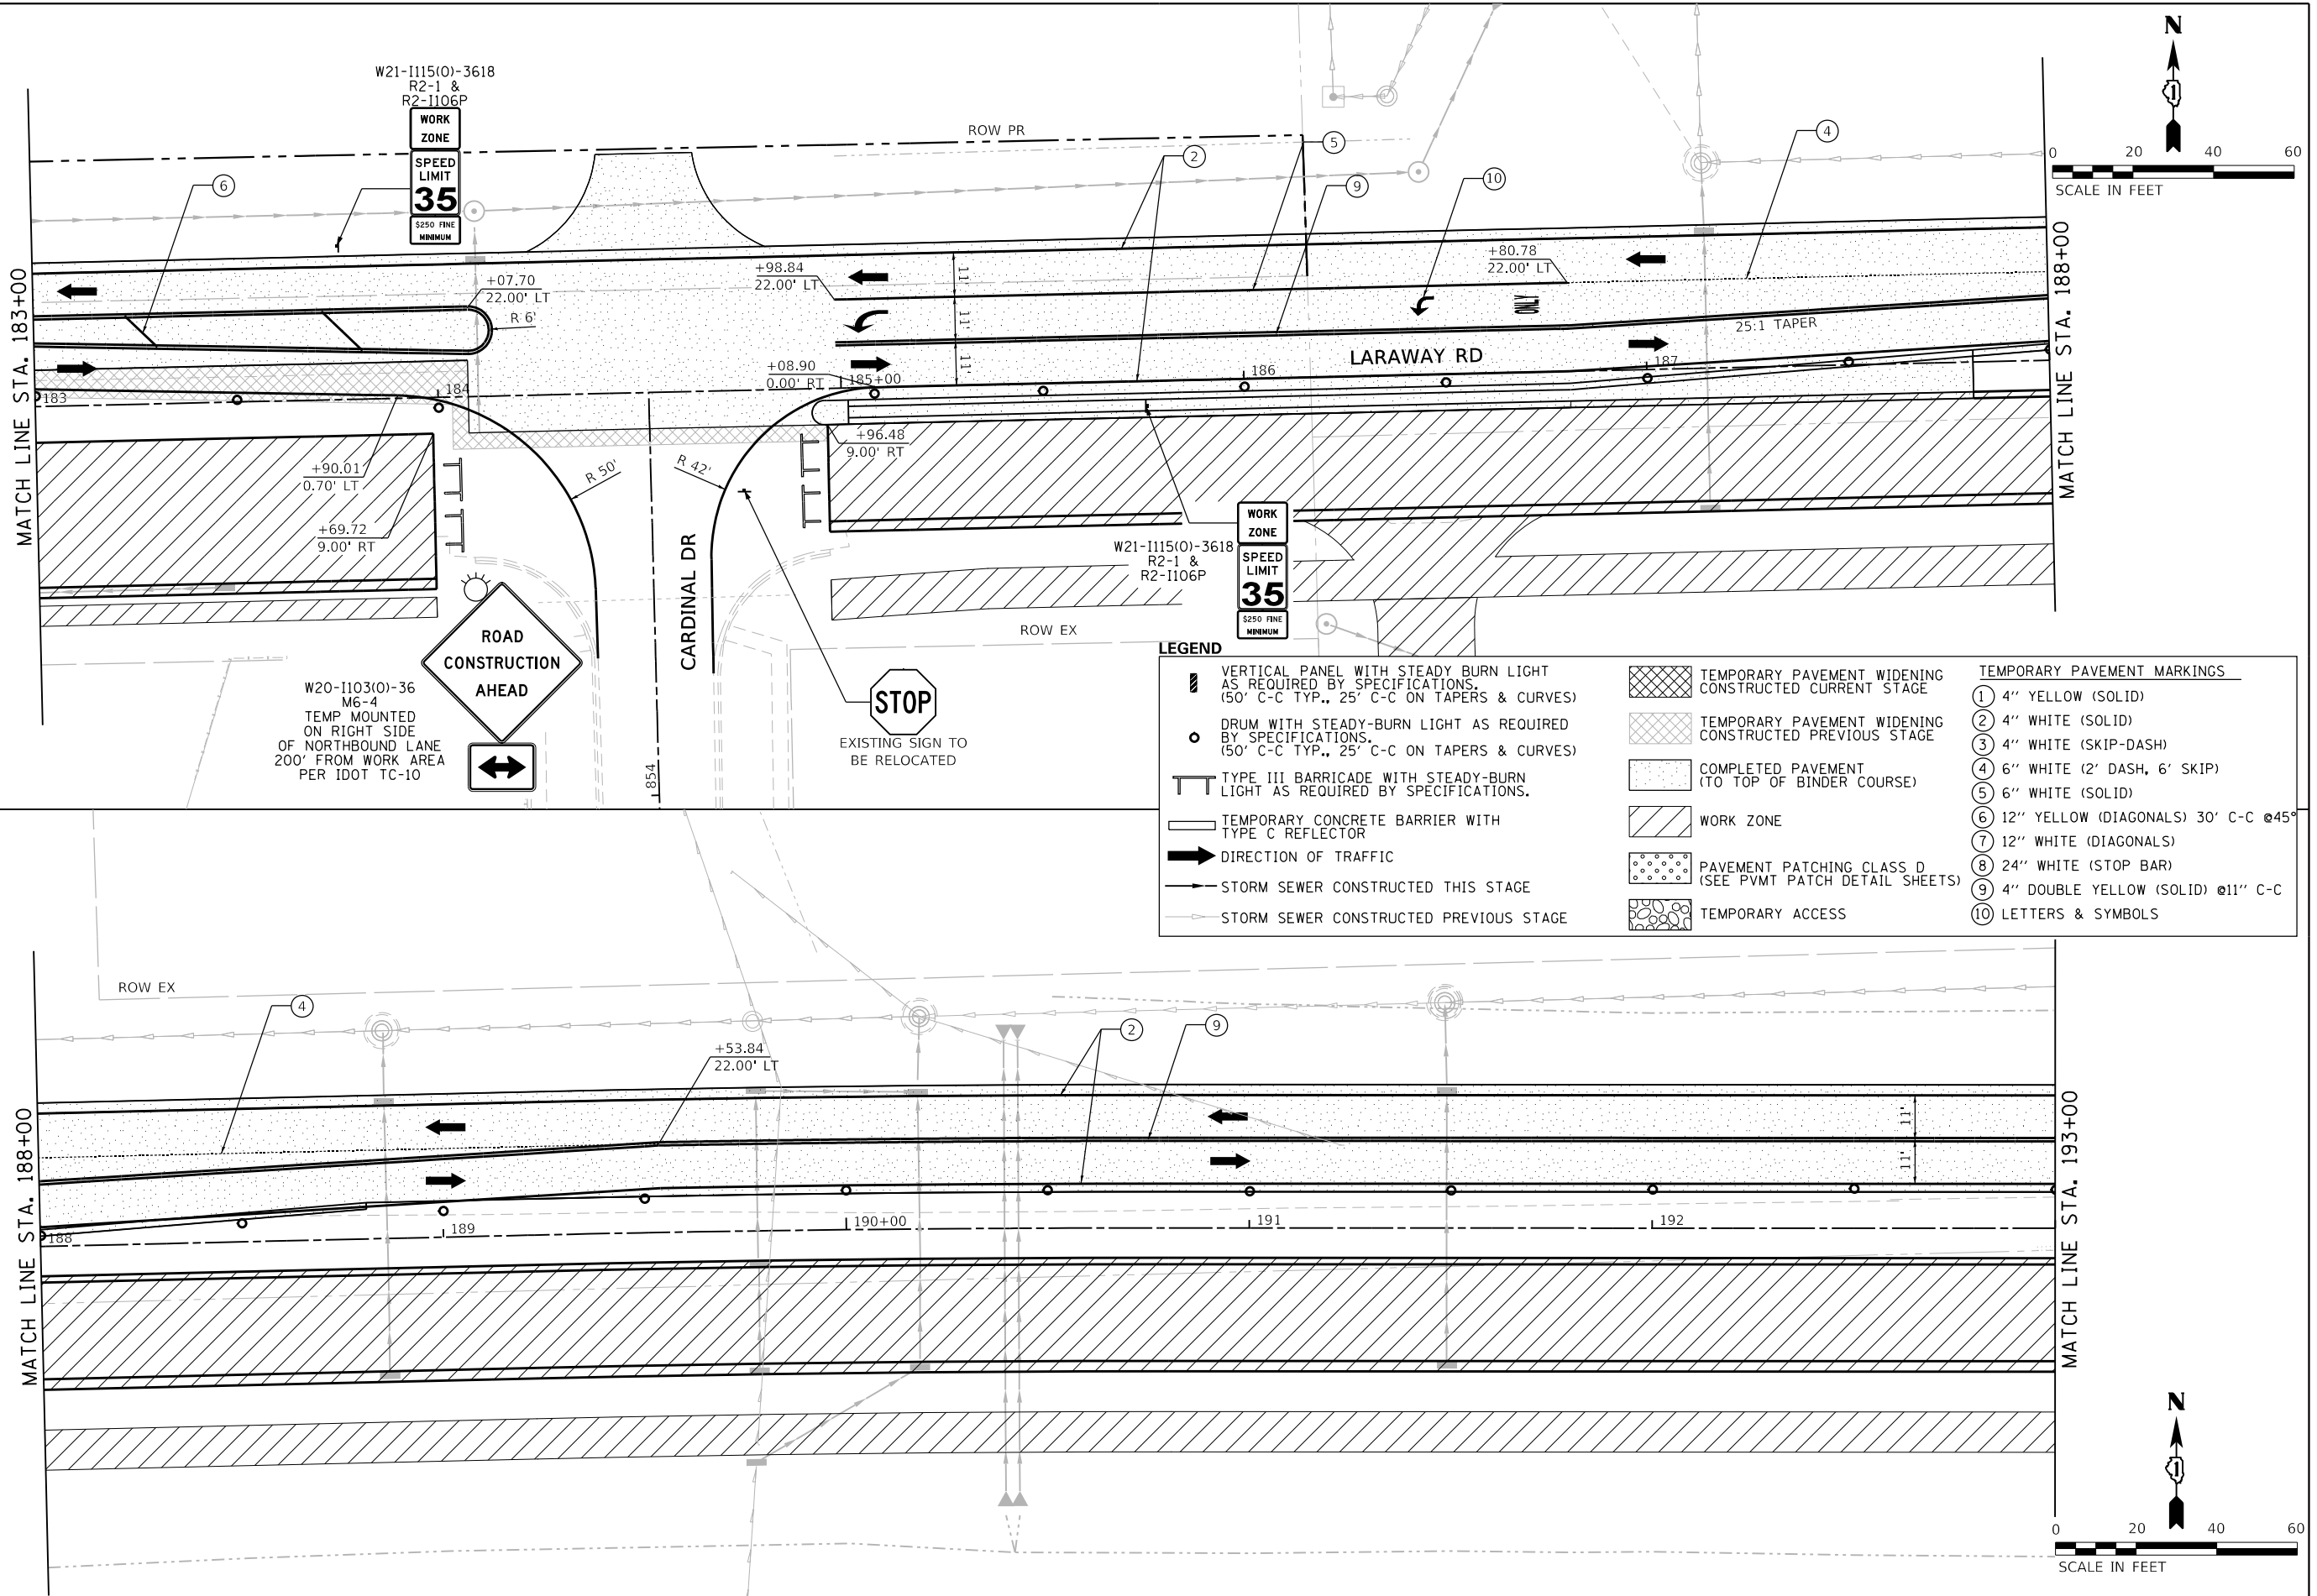

LEGEND

	VERTICAL PANEL WITH STEADY BURN LIGHT AS REQUIRED BY SPECIFICATIONS. (50' C-C TYP., 25' C-C ON TAPERS & CURVES)		TEMPORARY PAVEMENT WIDENING CONSTRUCTED CURRENT STAGE	TEMPORARY PAVEMENT MARKINGS
	DRUM WITH STEADY-BURN LIGHT AS REQUIRED BY SPECIFICATIONS. (50' C-C TYP., 25' C-C ON TAPERS & CURVES)		TEMPORARY PAVEMENT WIDENING CONSTRUCTED PREVIOUS STAGE	① 4" YELLOW (SOLID)
	TYPE III BARRICADE WITH STEADY-BURN LIGHT AS REQUIRED BY SPECIFICATIONS.		COMPLETED PAVEMENT (TO TOP OF BINDER COURSE)	② 4" WHITE (SOLID)
	TEMPORARY CONCRETE BARRIER WITH TYPE C REFLECTOR		WORK ZONE	③ 4" WHITE (SKIP-DASH)
	DIRECTION OF TRAFFIC		PAVEMENT PATCHING CLASS D (SEE PVMT PATCH DETAIL SHEETS)	④ 6" WHITE (2' DASH, 6' SKIP)
	STORM SEWER CONSTRUCTED THIS STAGE		TEMPORARY ACCESS	⑤ 6" WHITE (SOLID)
	STORM SEWER CONSTRUCTED PREVIOUS STAGE			⑥ 12" YELLOW (DIAGONALS) 30' C-C @45°
				⑦ 12" WHITE (DIAGONALS)
				⑧ 24" WHITE (STOP BAR)
				⑨ 4" DOUBLE YELLOW (SOLID) @11" C-C
				⑩ LETTERS & SYMBOLS



FILE NAME = sht-staging-stage02B-06.dgn	DESIGNED - BRF	REVISED -
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PLOT DATE = 9/9/2022 - 12:16:20 PM	DATE - 09/09/2022	REVISED -

**STATE OF ILLINOIS
DEPARTMENT OF TRANSPORTATION**

**SUGGESTED SEQUENCE OF CONSTRUCTION
LARAWAY RD - STAGE 2B**


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F.A.U. RTE.	SECTION	COUNTY	TOTAL SHEETS	SHEET NO.
0320	13-00138-37-PV	WILL	413	144
CONTRACT NO. 61H20				
ILLINOIS FED. AID PROJECT				

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PENTABLE = L:\PLOT\DRIVER\SWI\SWI.tbl


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PLOT DATE = 9/9/2022 12:16:21 PM

USER NAME = Mikes.Moses
DIRECTORY = L:\MILL\CO17204-01\Drawn\CADD_Sheets

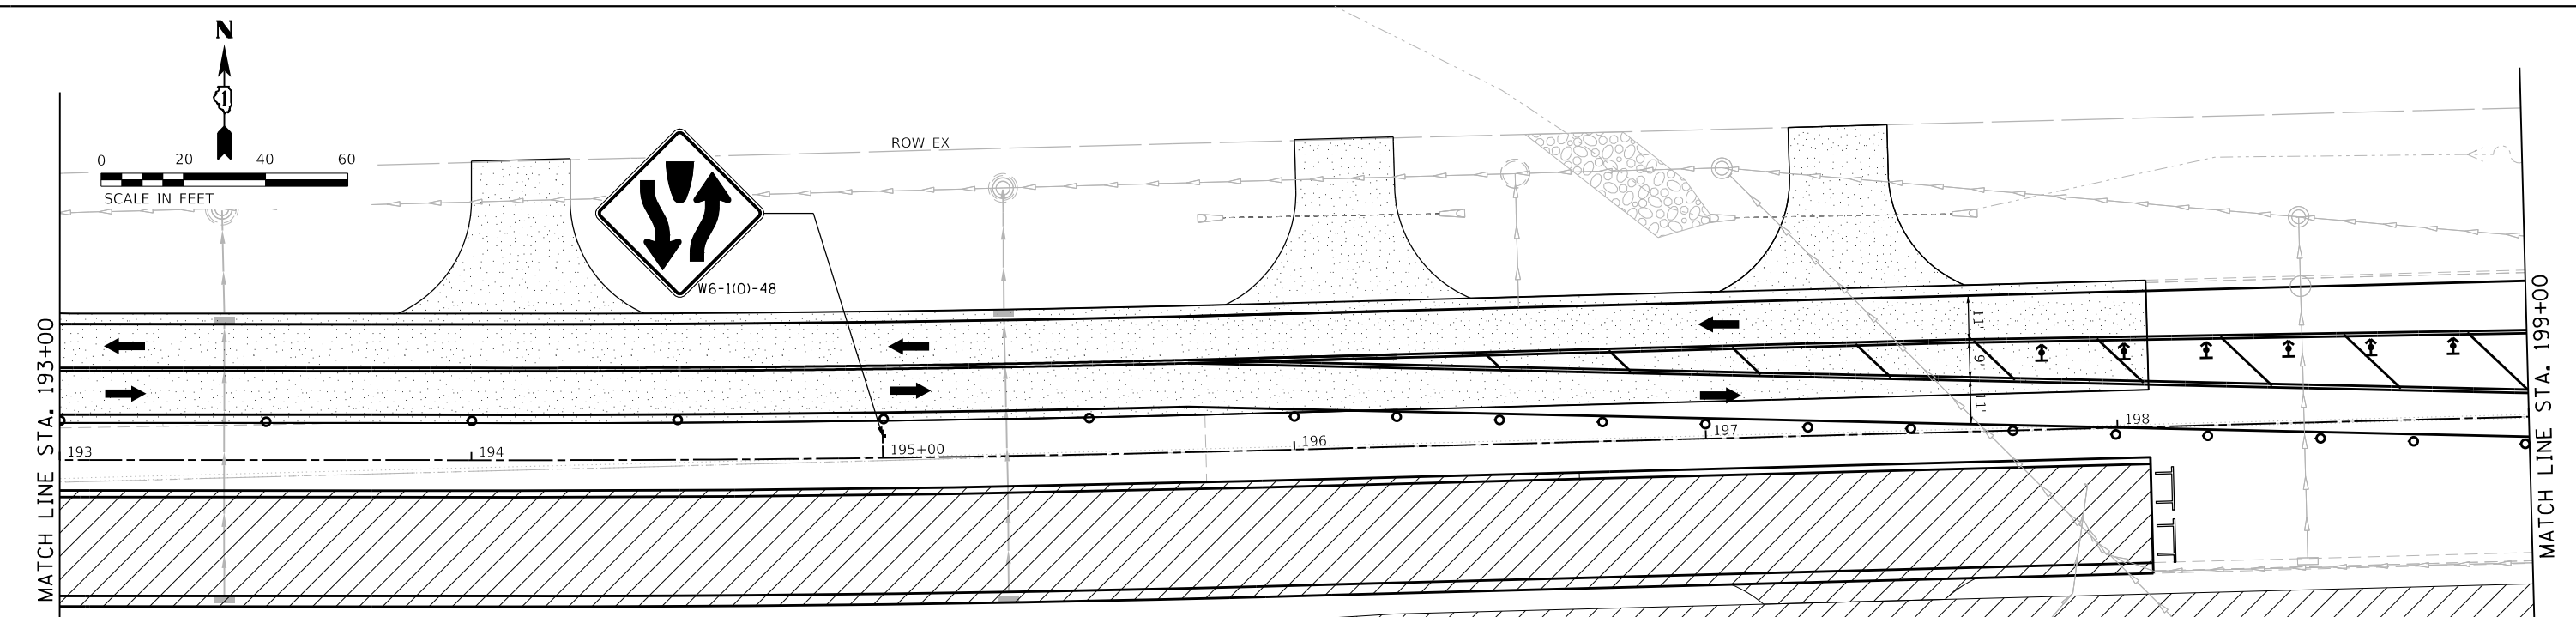

LEGEND

VERTICAL PANEL WITH STEADY BURN LIGHT AS REQUIRED BY SPECIFICATIONS. (50' C-C TYP., 25' C-C ON TAPERS & CURVES)	TEMPORARY PAVEMENT WIDENING CONSTRUCTED CURRENT STAGE	TEMPORARY PAVEMENT MARKINGS	
DRUM WITH STEADY-BURN LIGHT AS REQUIRED BY SPECIFICATIONS. (50' C-C TYP., 25' C-C ON TAPERS & CURVES)	TEMPORARY PAVEMENT WIDENING CONSTRUCTED PREVIOUS STAGE	① 4" YELLOW (SOLID)	
TYPE III BARRICADE WITH STEADY-BURN LIGHT AS REQUIRED BY SPECIFICATIONS.	COMPLETED PAVEMENT (TO TOP OF BINDER COURSE)	② 4" WHITE (SOLID)	
TEMPORARY CONCRETE BARRIER WITH TYPE C REFLECTOR	WORK ZONE	③ 4" WHITE (SKIP-DASH)	
DIRECTION OF TRAFFIC	PAVEMENT PATCHING CLASS D (SEE PVMT PATCH DETAIL SHEETS)	④ 6" WHITE (2' DASH, 6' SKIP)	
STORM SEWER CONSTRUCTED THIS STAGE	TEMPORARY ACCESS	⑤ 6" WHITE (SOLID)	
STORM SEWER CONSTRUCTED PREVIOUS STAGE		⑥ 12" YELLOW (DIAGONALS) 30' C-C @45°	
		⑦ 12" WHITE (DIAGONALS)	
		⑧ 24" WHITE (STOP BAR)	
		⑨ 4" DOUBLE YELLOW (SOLID) @11" C-C	
		⑩ LETTERS & SYMBOLS	

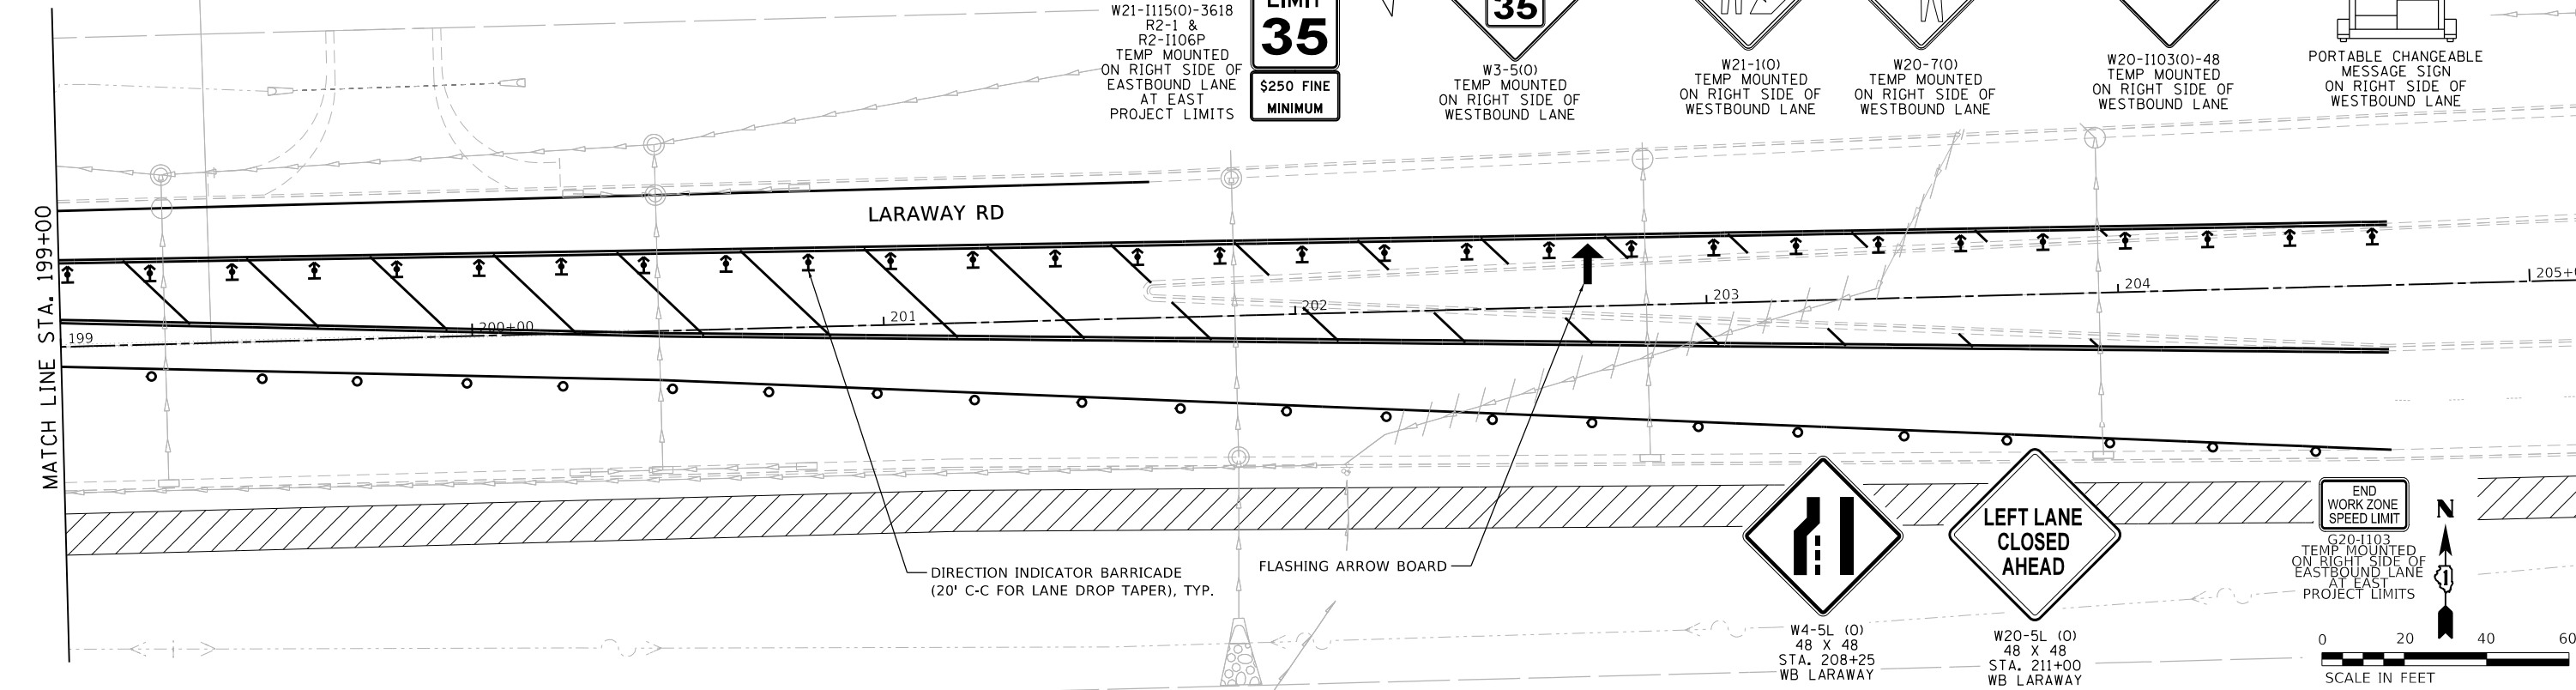

SUGGESTED SEQUENCE OF CONSTRUCTION
LARAWAY RD - STAGE 2B

(TO BE REMOVED WHEN WORKERS OR FLAGGERS NOT PRESENT FOR MORE THAN ONE HOUR)

500' WORK ZONE

500' SPEED LIMIT 35 (\$250 FINE MINIMUM)

500' W3-5(0) TEMP MOUNTED ON RIGHT SIDE OF WESTBOUND LANE

OR

500' W21-1(0) TEMP MOUNTED ON RIGHT SIDE OF WESTBOUND LANE

OR


500' W20-7(0) TEMP MOUNTED ON RIGHT SIDE OF WESTBOUND LANE

300' ROAD CONSTRUCTION AHEAD

500' W20-1103(0)-48 TEMP MOUNTED ON RIGHT SIDE OF WESTBOUND LANE

PORTABLE CHANGEABLE MESSAGE SIGN ON RIGHT SIDE OF WESTBOUND LANE

<p>License No. 184-000813</p>	FILE NAME = sht-staging-stage02B-07.dgn MODEL NAME = Default PLOT SCALE = 40.0018' / In. PLOT DATE = 9/9/2022 - 12:16:21 PM	DESIGNED - BRF DRAWN - BRF CHECKED - JMS DATE - 09/09/2022	REVISED - REVISED - REVISED - REVISED -	STATE OF ILLINOIS DEPARTMENT OF TRANSPORTATION	SUGGESTED SEQUENCE OF CONSTRUCTION LARAWAY RD - STAGE 2B		SCALE: 1"=20' SHEET 7 OF 7 SHEETS STA. 193+00 TO STA. 205+00	F.A.U. RTE. 0320 SECTION 13-00138-37-PV COUNTY WILL TOTAL SHEETS 413 SHEET NO. 145 CONTRACT NO. 61H20 ILLINOIS FED. AID PROJECT
					END WORK ZONE SPEED LIMIT G20-1103 TEMP MOUNTED ON RIGHT SIDE OF EASTBOUND LANE AT EAST PROJECT LIMITS		0 20 40 60 SCALE IN FEET	

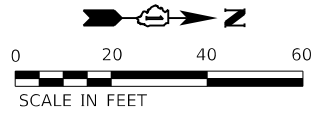

MATCH LINE STA. 636+00

STONEBRIDGE DR
636 637 638




W20-I103(O)-36
M6-4
TEMP MOUNTED
ON RIGHT SIDE
OF SOUTHBOUND LANE
200' FROM WORK AREA
PER IDOT TC-10

TIMBER PL

LEGEND

	VERTICAL PANEL WITH STEADY BURN LIGHT AS REQUIRED BY SPECIFICATIONS. (50' C-C TYP., 25' C-C ON TAPERS & CURVES)		TEMPORARY PAVEMENT WIDENING CONSTRUCTED CURRENT STAGE	TEMPORARY PAVEMENT MARKINGS	
	DRUM WITH STEADY-BURN LIGHT AS REQUIRED BY SPECIFICATIONS. (50' C-C TYP., 25' C-C ON TAPERS & CURVES)		TEMPORARY PAVEMENT WIDENING CONSTRUCTED PREVIOUS STAGE	① 4" YELLOW (SOLID)	
	TYPE III BARRICADE WITH STEADY-BURN LIGHT AS REQUIRED BY SPECIFICATIONS.		COMPLETED PAVEMENT (TO TOP OF BINDER COURSE)	② 4" WHITE (SOLID)	
	TEMPORARY CONCRETE BARRIER WITH TYPE C REFLECTOR		WORK ZONE	③ 4" WHITE (SKIP-DASH)	
	DIRECTION OF TRAFFIC		PAVEMENT PATCHING CLASS D (SEE PVMT PATCH DETAIL SHEETS)	④ 6" WHITE (2' DASH, 6' SKIP)	
	STORM SEWER CONSTRUCTED THIS STAGE		TEMPORARY ACCESS	⑤ 6" WHITE (SOLID)	
	STORM SEWER CONSTRUCTED PREVIOUS STAGE			⑥ 12" YELLOW (DIAGONALS) 30' C-C @45°	
				⑦ 12" WHITE (DIAGONALS)	
				⑧ 24" WHITE (STOP BAR)	
				⑨ 4" DOUBLE YELLOW (SOLID) @11" C-C	
				⑩ LETTERS & SYMBOLS	

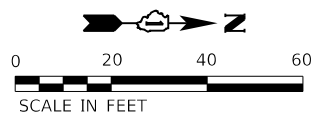

MATCH LINE STA. 691+00

HEATHERWAY LN
691 692 693 694



W20-I103(O)-36
M6-4
TEMP MOUNTED
ON RIGHT SIDE
OF SOUTHBOUND LANE
200' FROMWORK AREA
PER IDOT TC-10

TIMBER PL



FILE NAME = sht-staging-stage02B-09.dgn	DESIGNED - BRF	REVISED -
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PLOT SCALE = 40.0018' / in.	CHECKED - JMS	REVISED -
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STATE OF ILLINOIS
DEPARTMENT OF TRANSPORTATION




SUGGESTED SEQUENCE OF CONSTRUCTION			
STONEBRIDGE DR / HEATHERWAY LN - STAGE 2B			
SCALE: 1"=20'	SHEET 1	OF 1 SHEETS	STA. TO STA.

F.A.U. RTE.	SECTION	COUNTY	TOTAL SHEETS	SHEET NO.
0320	13-00138-37-PV	WILL	413	146
CONTRACT NO. 61H20				
ILLINOIS FED. AID PROJECT				

PLOT DRIVER
PENTABLE
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PLOT SCALE
PLOT DATE
40,000:1" / 1"
9/9/2022 (12:16:24 PM)

USER NAME
DIRECTORY
Mike Moses
L:\work\17204-01\Drawn\CADD_Sheet.dwg

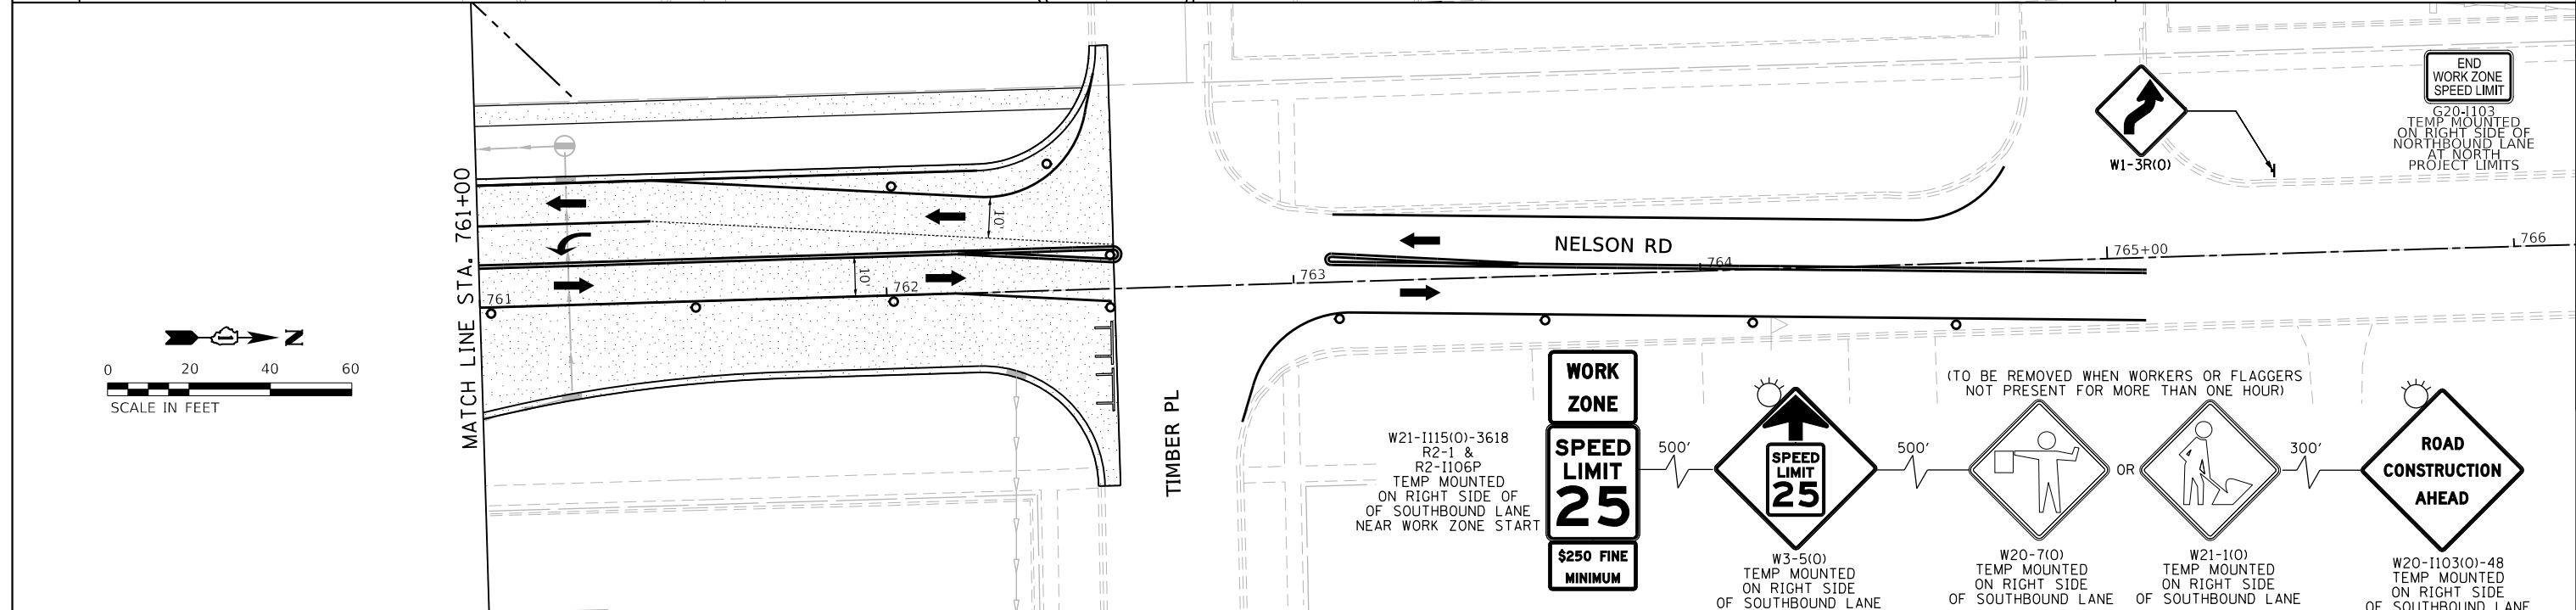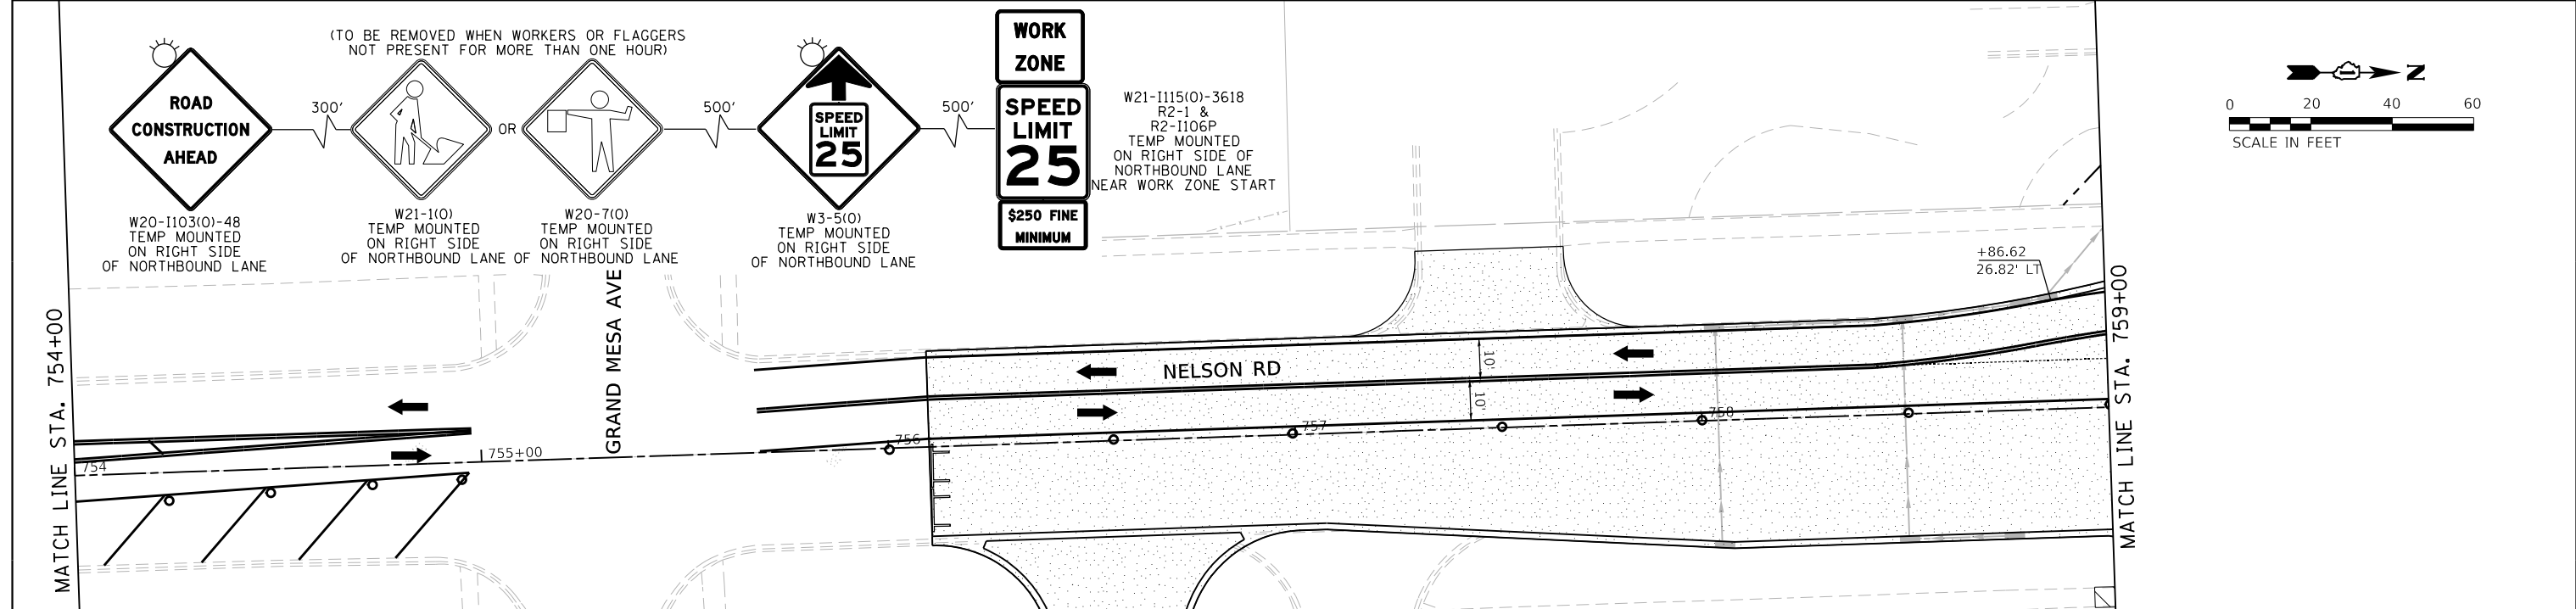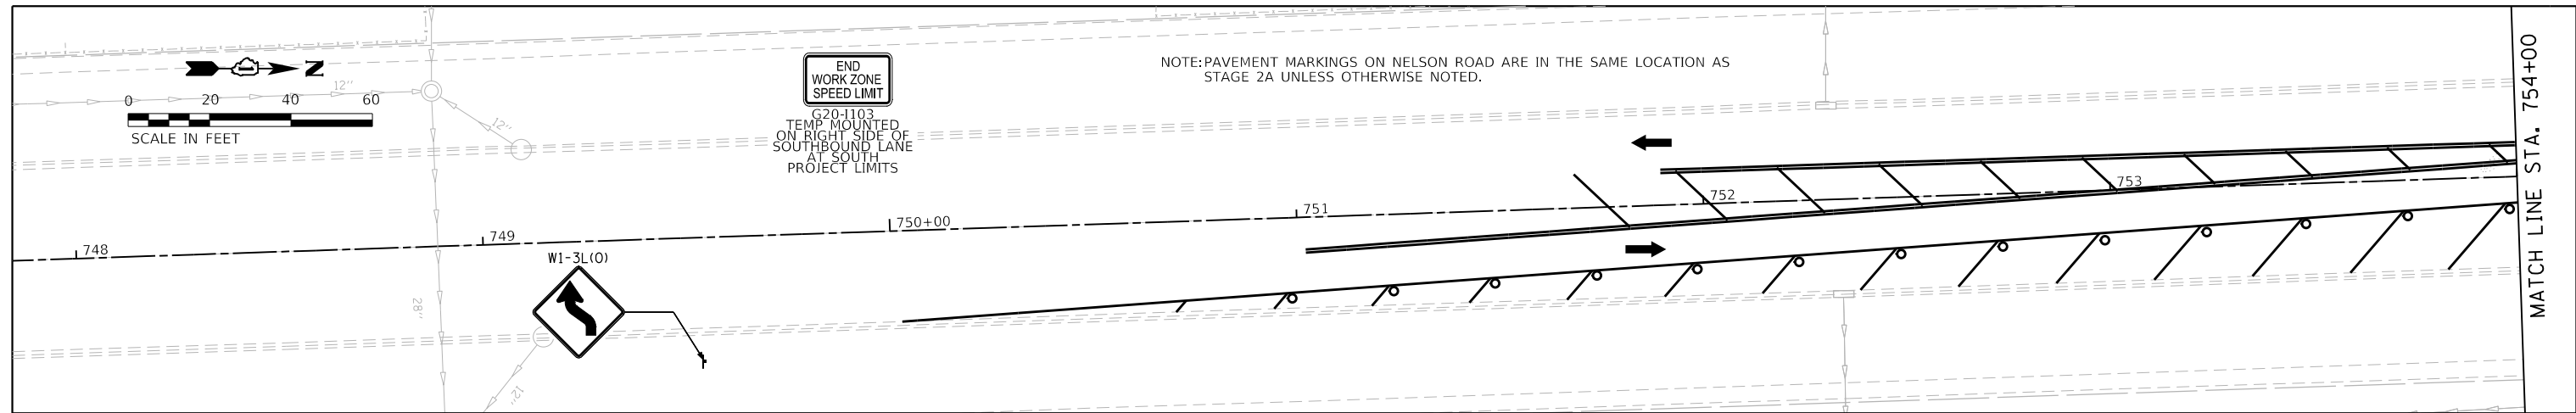


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**STATE OF ILLINOIS
DEPARTMENT OF TRANSPORTATION**


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NELSON RD - STAGE 2B**

SCALE: 1"=20' SHEET 1 OF 1 SHEETS STA. 748+00 TO STA. 765+00


F.A.U. RTE.	SECTION	COUNTY	TOTAL SHEETS	SHEET NO.
0320	13-00138-37-PV	WILL	413	147
CONTRACT NO. 61H20				
ILLINOIS FED. AID PROJECT				

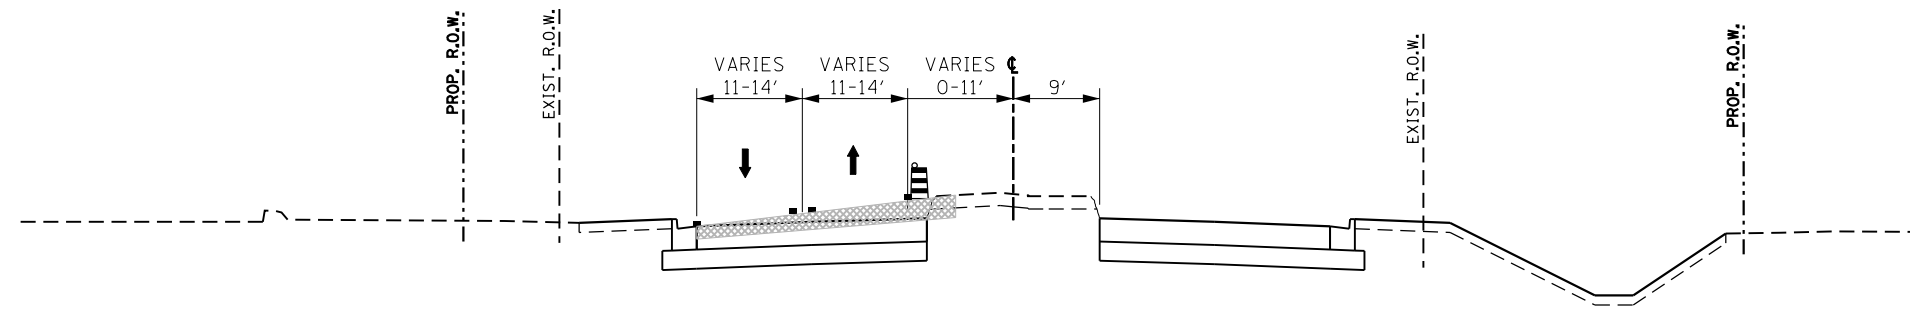

STAGE 2C TYPICAL SECTION
STA 139+00 TO 142+12.80

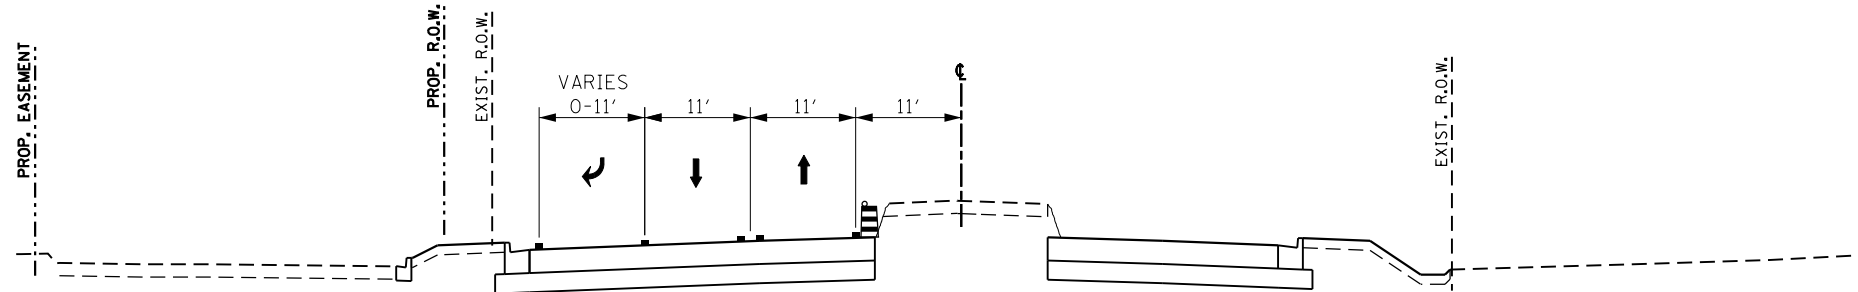

STAGE 2C TYPICAL SECTION
STA 142+12.80 TO 153+10.20

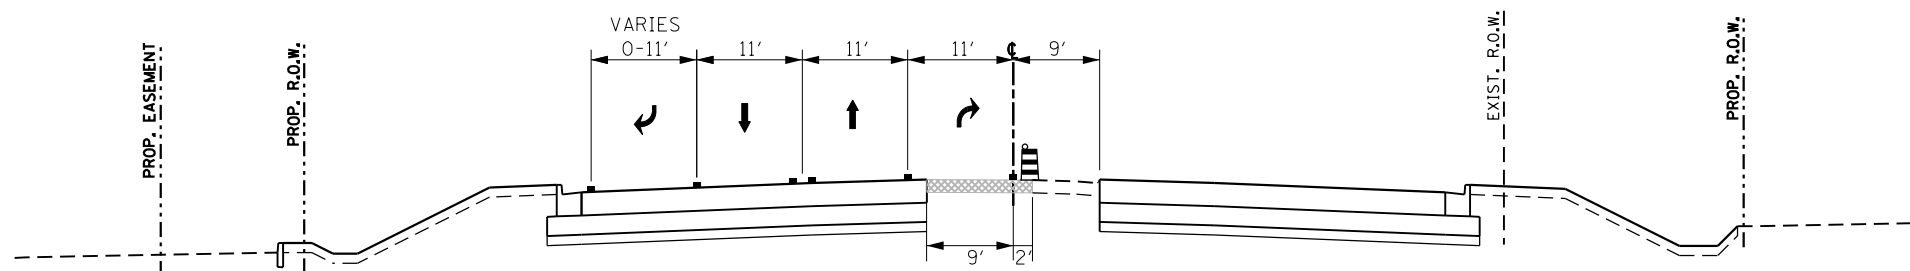

STAGE 2C TYPICAL SECTION
STA 156+75 TO 160+66.81

LEGEND

- TEMPORARY PAVEMENT MARKING LINE
- VERTICAL PANEL WITH STEADY BURN LIGHT AS REQUIRED BY SPECIFICATIONS. (50' C-C TYP., 25' C-C ON TAPERS & CURVES)
- DRUM WITH STEADY-BURN LIGHT AS REQUIRED BY SPECIFICATIONS. (50' C-C TYP., 25' C-C ON TAPERS & CURVES)
- TYPE II BARRICADE WITH STEADY-BURN LIGHT AS REQUIRED BY SPECIFICATIONS. (50' C-C TYP., 25' C-C ON TAPERS & CURVES)
- TEMPORARY CONCRETE BARRIER WITH TYPE C REFLECTORS
- DIRECTION OF TRAFFIC
- TEMPORARY PAVEMENT WIDENING CONSTRUCTED CURRENT STAGE
- TEMPORARY PAVEMENT WIDENING CONSTRUCTED PREVIOUS STAGE
- COMPLETED PAVEMENT
- WORK ZONE




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STATE OF ILLINOIS
DEPARTMENT OF TRANSPORTATION

SUGGESTED SEQUENCE OF CONSTRUCTION
STAGE 2C TYPICAL SECTION - LARAWAY RD


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F.A.U. RTE.	SECTION	COUNTY	TOTAL SHEETS	SHEET NO.
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CONTRACT NO. 61H20				
		ILLINOIS	FED. AID PROJECT	




STAGE 2C TYPICAL SECTION

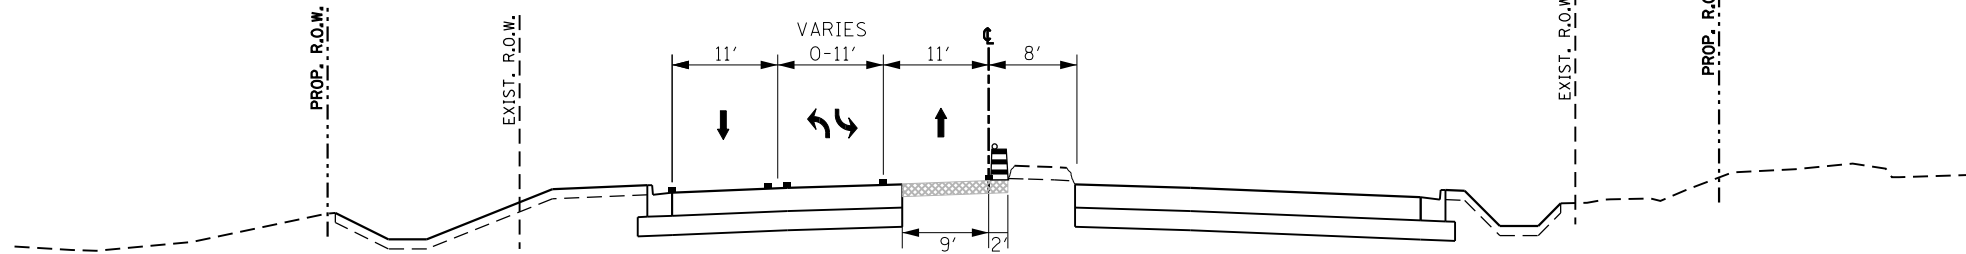STA 153+10 TO 156+75.00,
160+66.81 TO 174+44

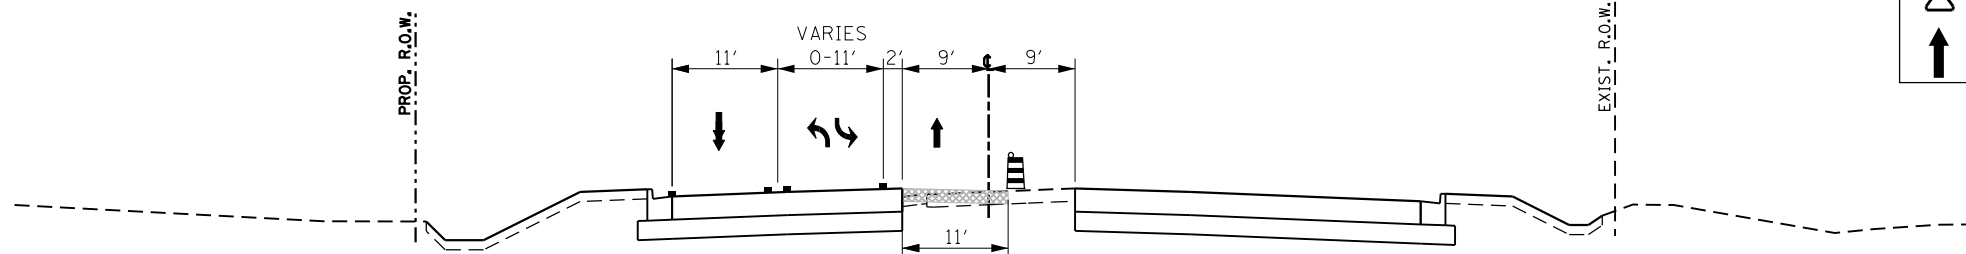

STAGE 2C TYPICAL SECTION

STA 174+44 TO 189+54

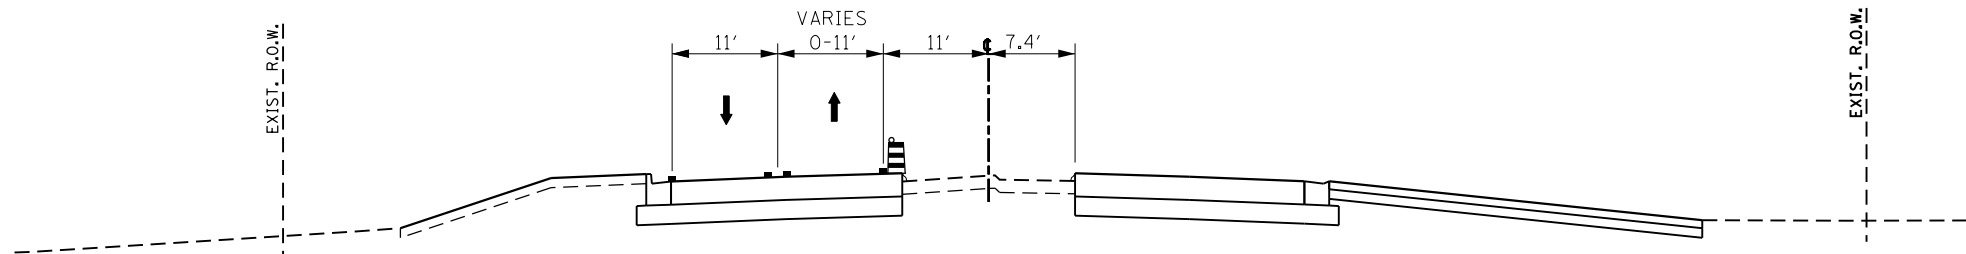

STAGE 2C TYPICAL SECTION

STA 189+54 TO 206+00

LEGEND

- TEMPORARY PAVEMENT MARKING LINE
- ▨ VERTICAL PANEL WITH STEADY BURN LIGHT AS REQUIRED BY SPECIFICATIONS. (50' C-C TYP., 25' C-C ON TAPERS & CURVES)
- ▨ DRUM WITH STEADY-BURN LIGHT AS REQUIRED BY SPECIFICATIONS. (50' C-C TYP., 25' C-C ON TAPERS & CURVES)
- ▨ TYPE II BARRICADE WITH STEADY-BURN LIGHT AS REQUIRED BY SPECIFICATIONS. (50' C-C TYP., 25' C-C ON TAPERS & CURVES)
- ▨ TEMPORARY CONCRETE BARRIER WITH TYPE C REFLECTORS
- ↑ DIRECTION OF TRAFFIC
- ▨ TEMPORARY PAVEMENT WIDENING CONSTRUCTED CURRENT STAGE
- ▨ TEMPORARY PAVEMENT WIDENING CONSTRUCTED PREVIOUS STAGE
- ▨ COMPLETED PAVEMENT
- ▨ WORK ZONE



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STATE OF ILLINOIS
DEPARTMENT OF TRANSPORTATION



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STAGE 2C TYPICAL SECTION - LARAWAY RD			
SCALE:	SHEET 2	OF 2 SHEETS	STA. TO STA.

F.A.U. RTE.	SECTION	COUNTY	TOTAL SHEETS	SHEET NO.
0320	13-00138-37-PV	WILL	413	149
CONTRACT NO. 61H20				
ILLINOIS FED. AID PROJECT				

PLOT DRIVER
PENTABLE
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= L:\PLOT\LAYERS\stage2c.tbl

PLOT SCALE
PLOT DATE
= 40.0018' / 1" / 9/9/2022 (12:16:30 PM)

USER NAME
DIRECTORY
= M:\s\moss
= L:\MILL\CON\7204\01\Draw\CADD_Sheets

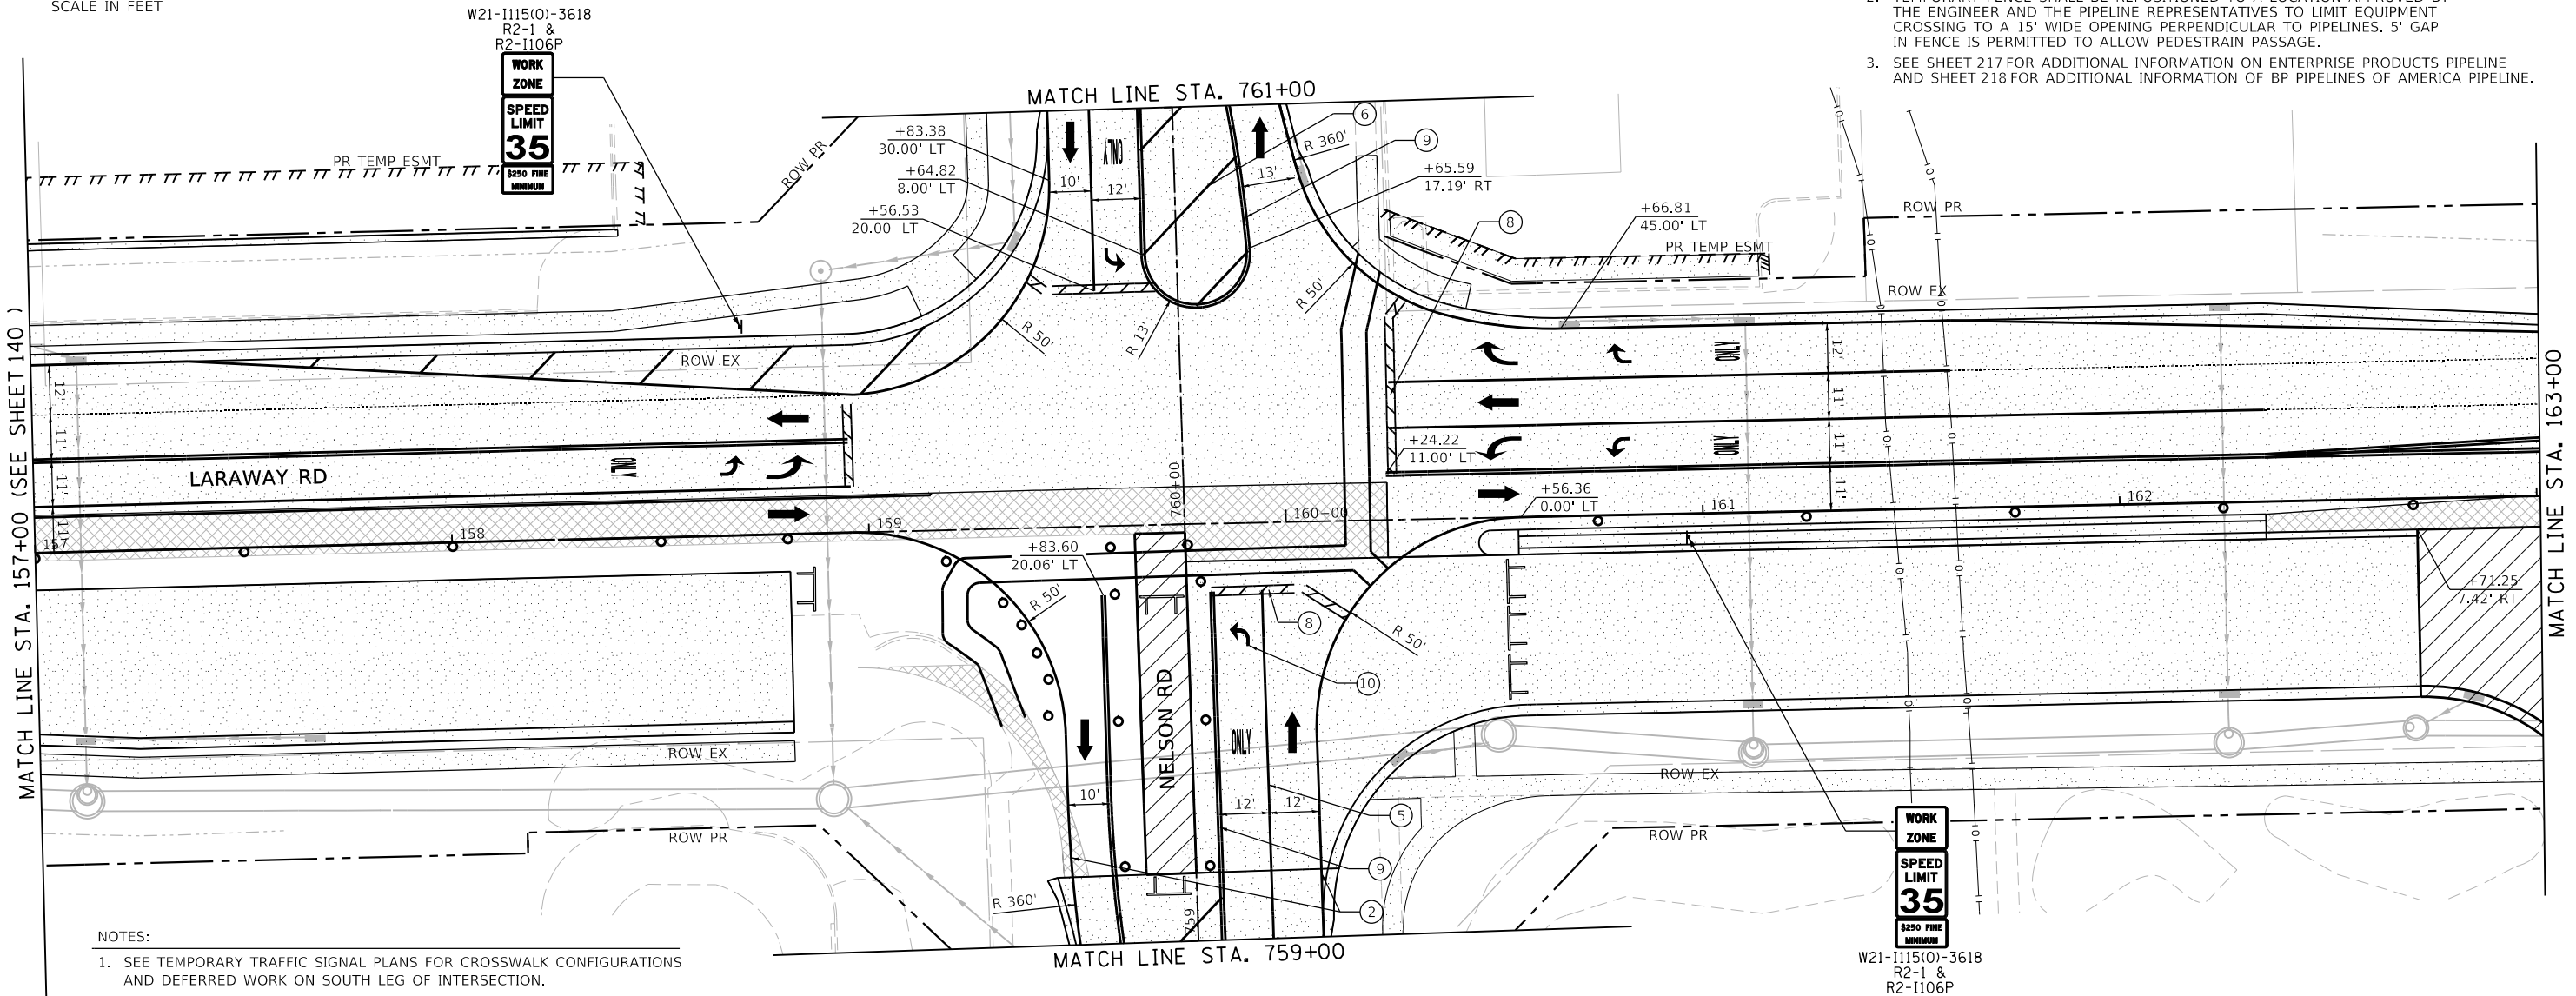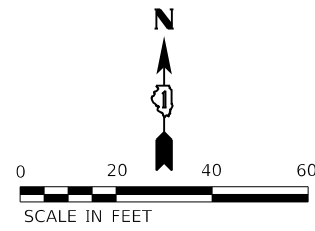

- PIPELINE STAGING NOTES:**
- CONTRACTOR MUST CONTACT PIPELINE COMPANIES TO COORDINATE ALL WORK IN THE VICINITY OF THE PIPELINES. CONTRACTOR MUST FOLLOW ALL REQUIREMENTS OF THESE PLANS, SPECIFICATIONS, PIPELINE ENCROACHMENT GUIDELINES, AND ANY OTHER REQUIREMENTS COMMUNICATED BY PIPELINE COMPANY REPRESENTATIVES REGARDING WORK AROUND THE PIPELINES.
 - TEMPORARY FENCE SHALL BE REPOSITIONED TO A LOCATION APPROVED BY THE ENGINEER AND THE PIPELINE REPRESENTATIVES TO LIMIT EQUIPMENT CROSSING TO A 15' WIDE OPENING PERPENDICULAR TO PIPELINES. 5' GAP IN FENCE IS PERMITTED TO ALLOW PEDESTRAIN PASSAGE.
 - SEE SHEET 217 FOR ADDITIONAL INFORMATION ON ENTERPRISE PRODUCTS PIPELINE AND SHEET 218 FOR ADDITIONAL INFORMATION OF BP PIPELINES OF AMERICA PIPELINE.

BP PIPELINES OF AMERICA	ENTERPRISE PRODUCTS
STEVE ADAMS	BLAKE HAMILTON
OFFICE: 779.801.4969	OFFICE: 815.277.7286
EMAIL: steve.adams@bp.com	CELL: 217.508.2991
	EMAIL: bdhamilton@eprod.com

- NOTES:**
- SEE TEMPORARY TRAFFIC SIGNAL PLANS FOR CROSSWALK CONFIGURATIONS AND DEFERRED WORK ON SOUTH LEG OF INTERSECTION.

LEGEND

VERTICAL PANEL WITH STEADY BURN LIGHT AS REQUIRED BY SPECIFICATIONS. (50' C-C TYP., 25' C-C ON TAPERS & CURVES)	TEMPORARY PAVEMENT WIDENING CONSTRUCTED CURRENT STAGE	TEMPORARY PAVEMENT MARKINGS
DRUM WITH STEADY-BURN LIGHT AS REQUIRED BY SPECIFICATIONS. (50' C-C TYP., 25' C-C ON TAPERS & CURVES)	TEMPORARY PAVEMENT WIDENING CONSTRUCTED PREVIOUS STAGE	① 4" YELLOW (SOLID)
TYPE III BARRICADE WITH STEADY-BURN LIGHT AS REQUIRED BY SPECIFICATIONS.	COMPLETED PAVEMENT (TO TOP OF BINDER COURSE)	② 4" WHITE (SOLID)
TEMPORARY CONCRETE BARRIER WITH TYPE C REFLECTOR	WORK ZONE	③ 4" WHITE (SKIP-DASH)
DIRECTION OF TRAFFIC	PAVEMENT PATCHING CLASS D (SEE PVMT PATCH DETAIL SHEETS)	④ 6" WHITE (2" DASH, 6' SKIP)
STORM SEWER CONSTRUCTED THIS STAGE	TEMPORARY ACCESS	⑤ 6" WHITE (SOLID)
STORM SEWER CONSTRUCTED PREVIOUS STAGE		⑥ 12" YELLOW (DIAGONALS) 30' C-C @45°
		⑦ 12" WHITE (DIAGONALS)
		⑧ 24" WHITE (STOP BAR)
		⑨ 4" DOUBLE YELLOW (SOLID) @11" C-C
		⑩ LETTERS & SYMBOLS



FILE NAME = sht-staging-stage2c-03.dgn	DESIGNED - JMS	REVISED -
MODEL NAME = Default	DRAWN - PML	REVISED -
PLOT SCALE = 40.0018' / 1"	CHECKED - JMS	REVISED -
PLOT DATE = 9/9/2022 - 12:16:30 PM	DATE = 09/09/2022	REVISED -

**STATE OF ILLINOIS
DEPARTMENT OF TRANSPORTATION**

**SUGGESTED SEQUENCE OF CONSTRUCTION
LARAWAY RD - STAGE 2C**





SCALE: 1"=20'	SHEET 1 OF 3 SHEETS	STA. 157+00 TO STA. 163+00
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F.A.U. RTE. 0320	SECTION 13-00138-37-PV	COUNTY WILL	TOTAL SHEETS 413	SHEET NO. 150
CONTRACT NO. 61H20				
ILLINOIS		FED. AID PROJECT		

PLOT DRIVER
PENTABLE
= Laraway_Stage2c.dwg

PLOT SCALE
PLOT DATE
= 40.0018' / in.
= 9/9/2022 (12:16:32 PM)

USER NAME
DIRECTORY
= Mike Moses
= L:\MILL\017204-01\Drawn\CADD_Sheets\

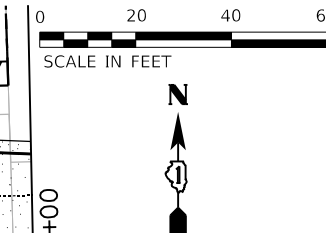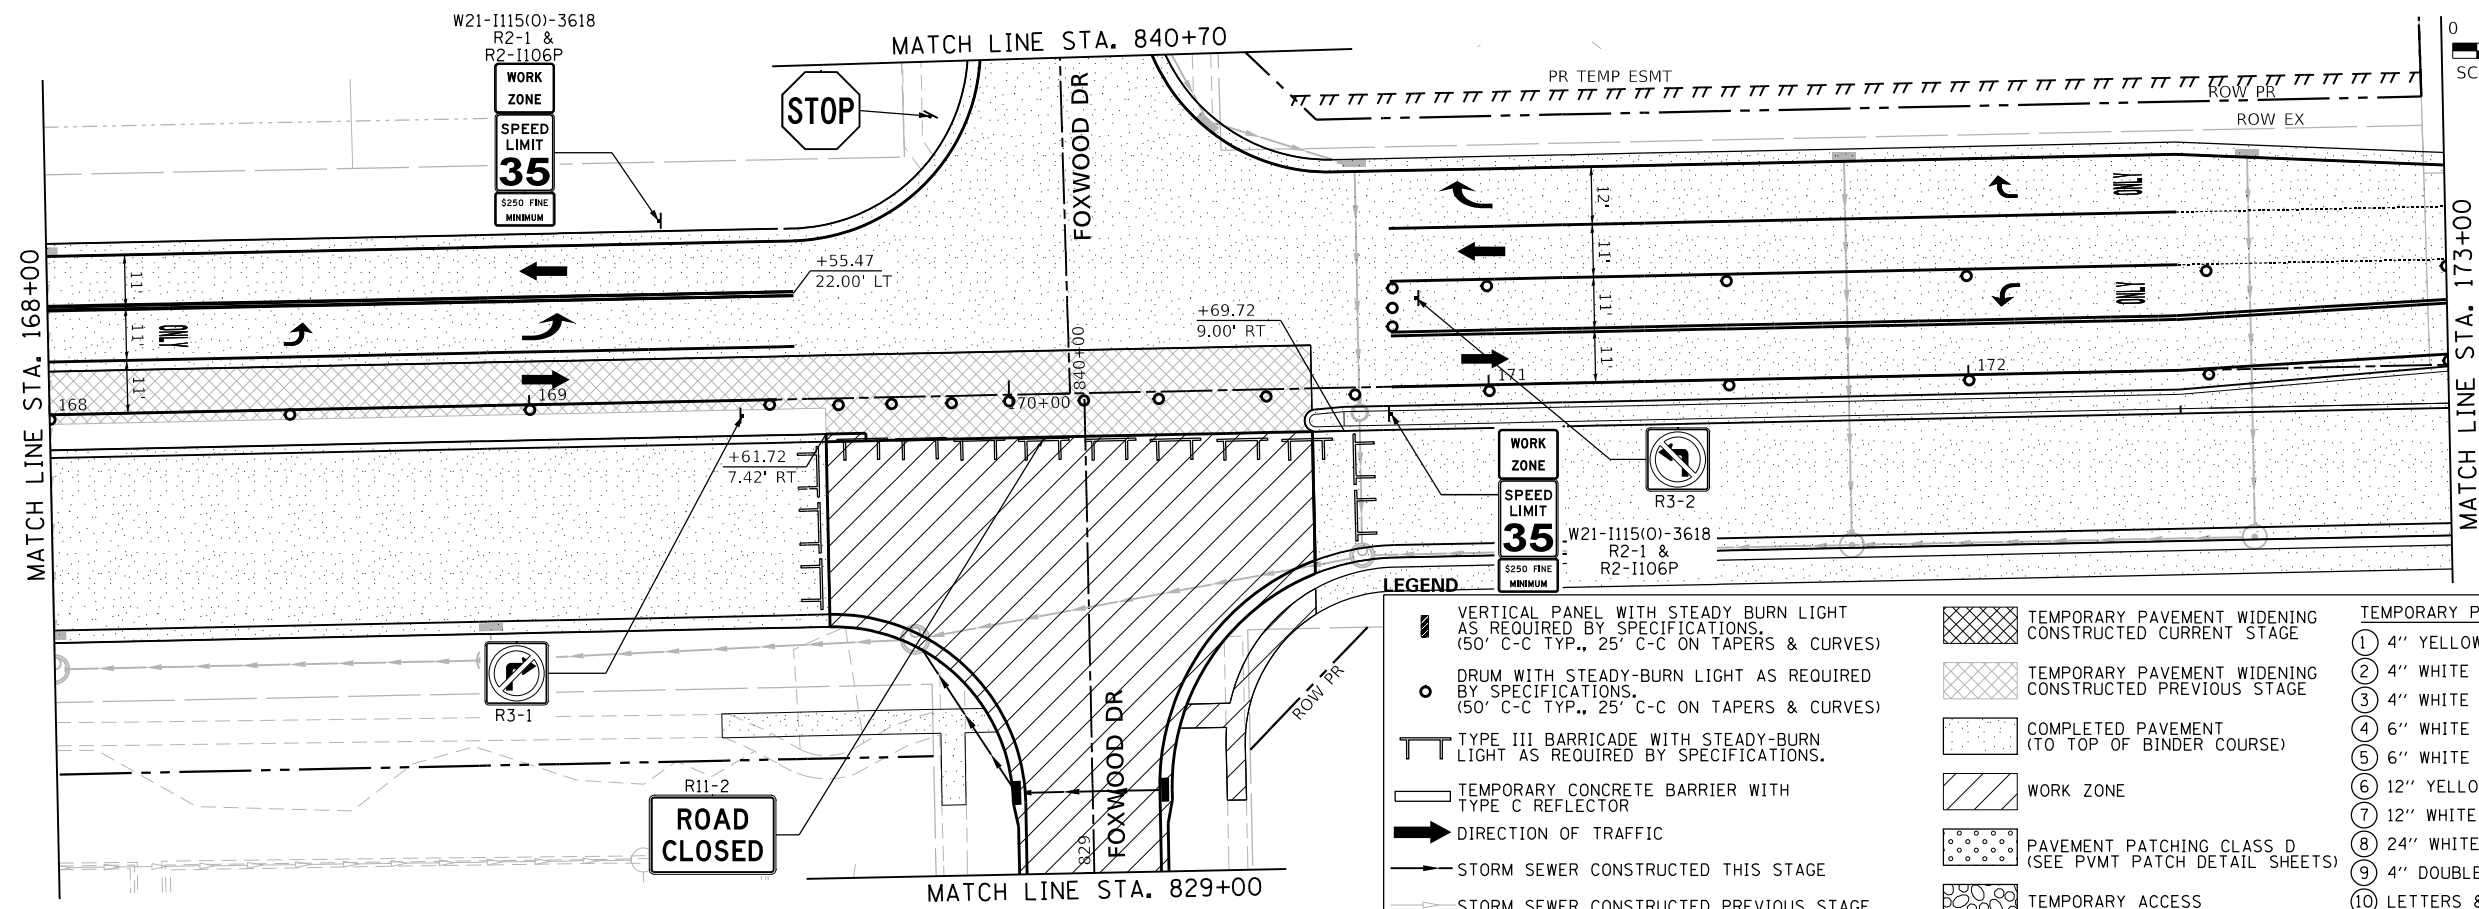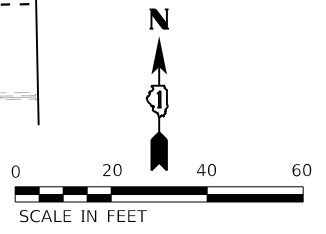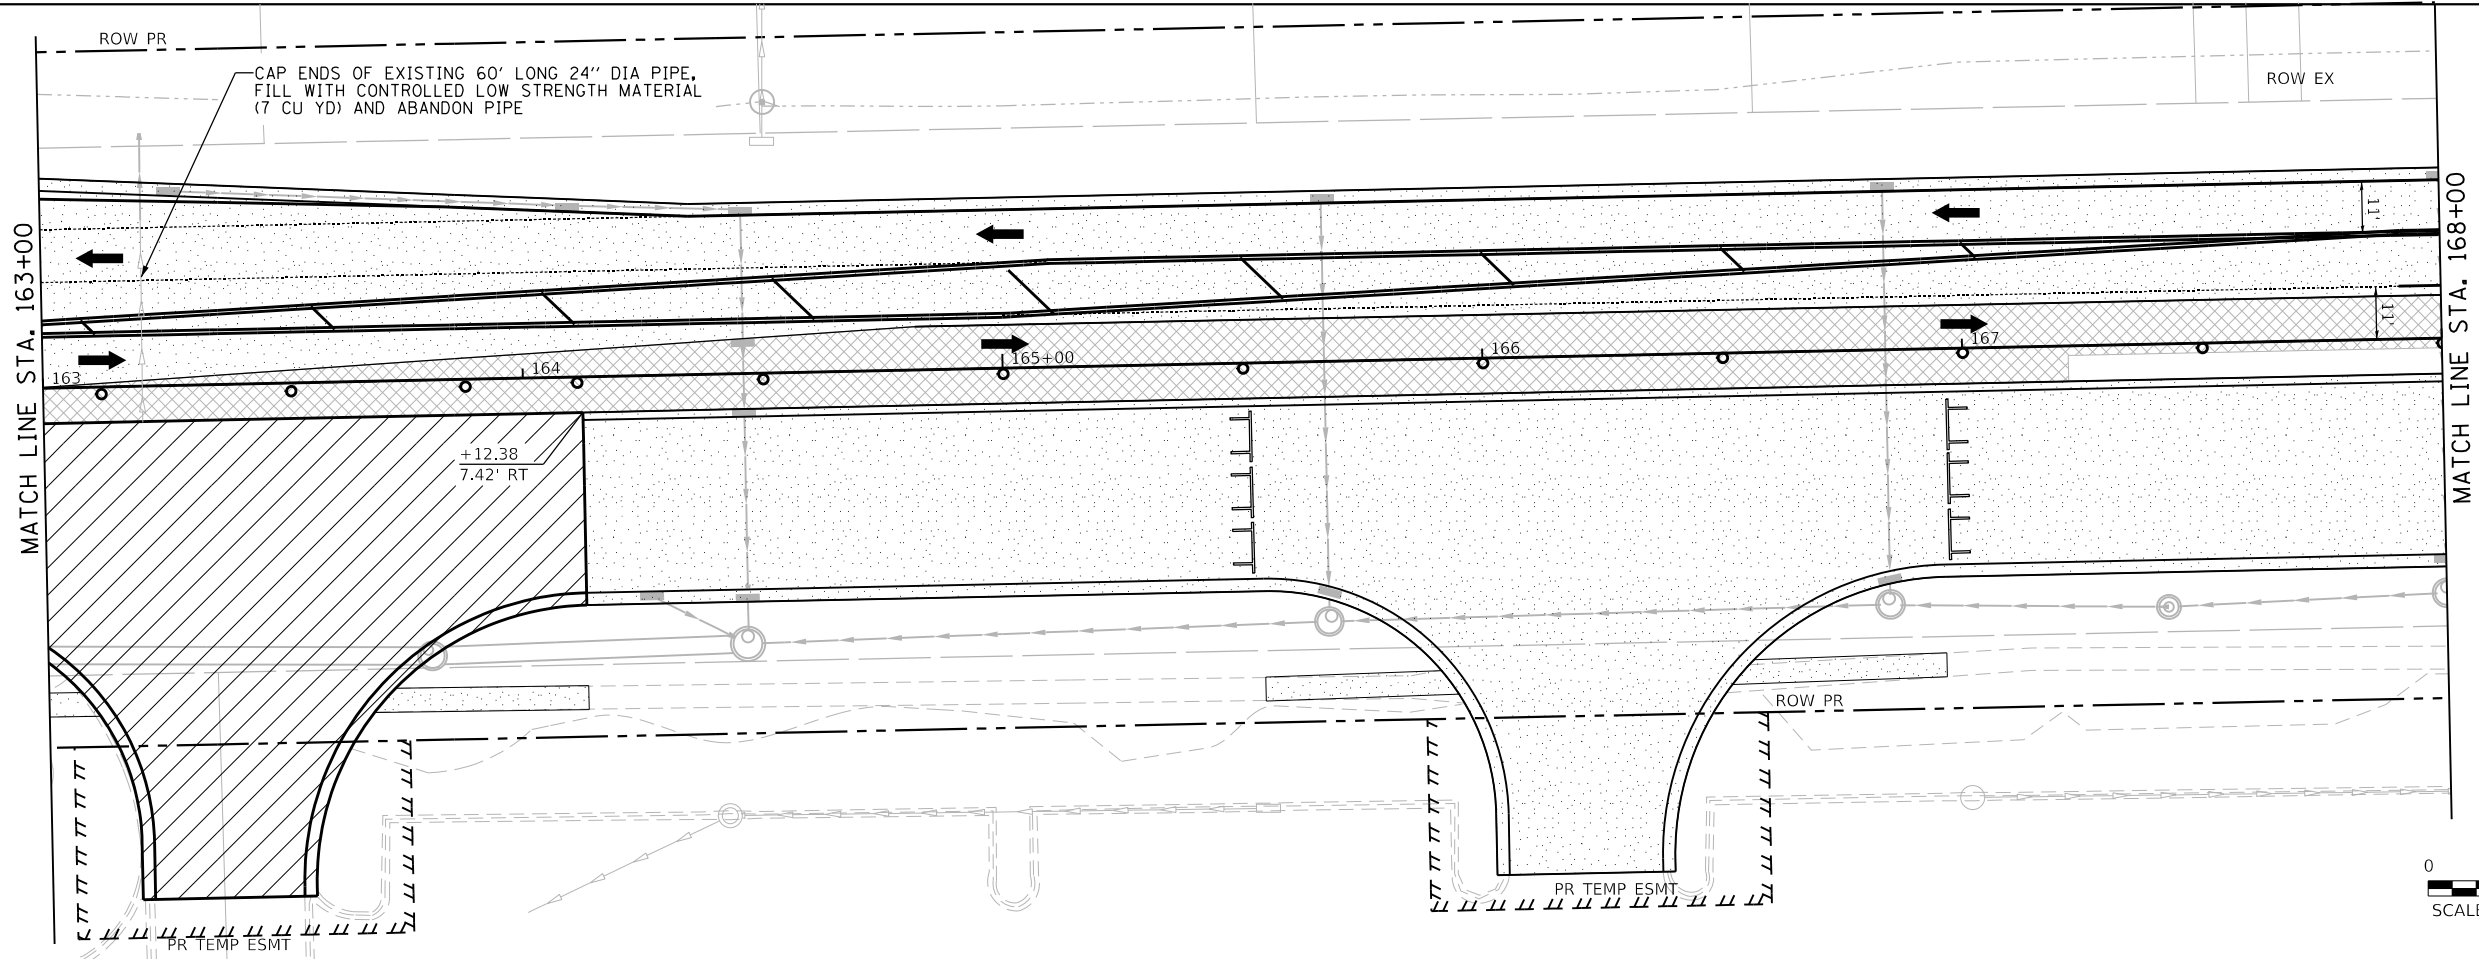

LEGEND

VERTICAL PANEL WITH STEADY BURN LIGHT AS REQUIRED BY SPECIFICATIONS. (50' C-C TYP., 25' C-C ON TAPERS & CURVES)	TEMPORARY PAVEMENT WIDENING CONSTRUCTED CURRENT STAGE	<p>TEMPORARY PAVEMENT MARKINGS</p> <ul style="list-style-type: none"> ① 4" YELLOW (SOLID) ② 4" WHITE (SOLID) ③ 4" WHITE (SKIP-DASH) ④ 6" WHITE (2' DASH, 6' SKIP) ⑤ 6" WHITE (SOLID) ⑥ 12" YELLOW (DIAGONALS) 30' C-C @45° ⑦ 12" WHITE (DIAGONALS) ⑧ 24" WHITE (STOP BAR) ⑨ 4" DOUBLE YELLOW (SOLID) @11" C-C ⑩ LETTERS & SYMBOLS
DRUM WITH STEADY-BURN LIGHT AS REQUIRED BY SPECIFICATIONS. (50' C-C TYP., 25' C-C ON TAPERS & CURVES)	TEMPORARY PAVEMENT WIDENING CONSTRUCTED PREVIOUS STAGE	
TYPE III BARRICADE WITH STEADY-BURN LIGHT AS REQUIRED BY SPECIFICATIONS.	COMPLETED PAVEMENT (TO TOP OF BINDER COURSE)	
TEMPORARY CONCRETE BARRIER WITH TYPE C REFLECTOR	WORK ZONE	
DIRECTION OF TRAFFIC	PAVEMENT PATCHING CLASS D (SEE PVMT PATCH DETAIL SHEETS)	
STORM SEWER CONSTRUCTED THIS STAGE	TEMPORARY ACCESS	
STORM SEWER CONSTRUCTED PREVIOUS STAGE		



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PLOT SCALE = 40.0018' / in.	CHECKED - JMS	REVISED -
PLOT DATE = 9/9/2022 - 12:16:32 PM	DATE - 09/09/2022	REVISED -

**STATE OF ILLINOIS
DEPARTMENT OF TRANSPORTATION**

**SUGGESTED SEQUENCE OF CONSTRUCTION
LARAWAY RD - STAGE 2C**



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F.A.U. RTE.	SECTION	COUNTY	TOTAL SHEETS	SHEET NO.
0320	13-00138-37-PV	WILL	413	151
CONTRACT NO. 61H20				
ILLINOIS FED. AID PROJECT				

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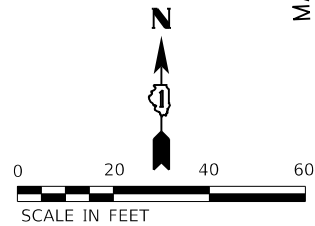
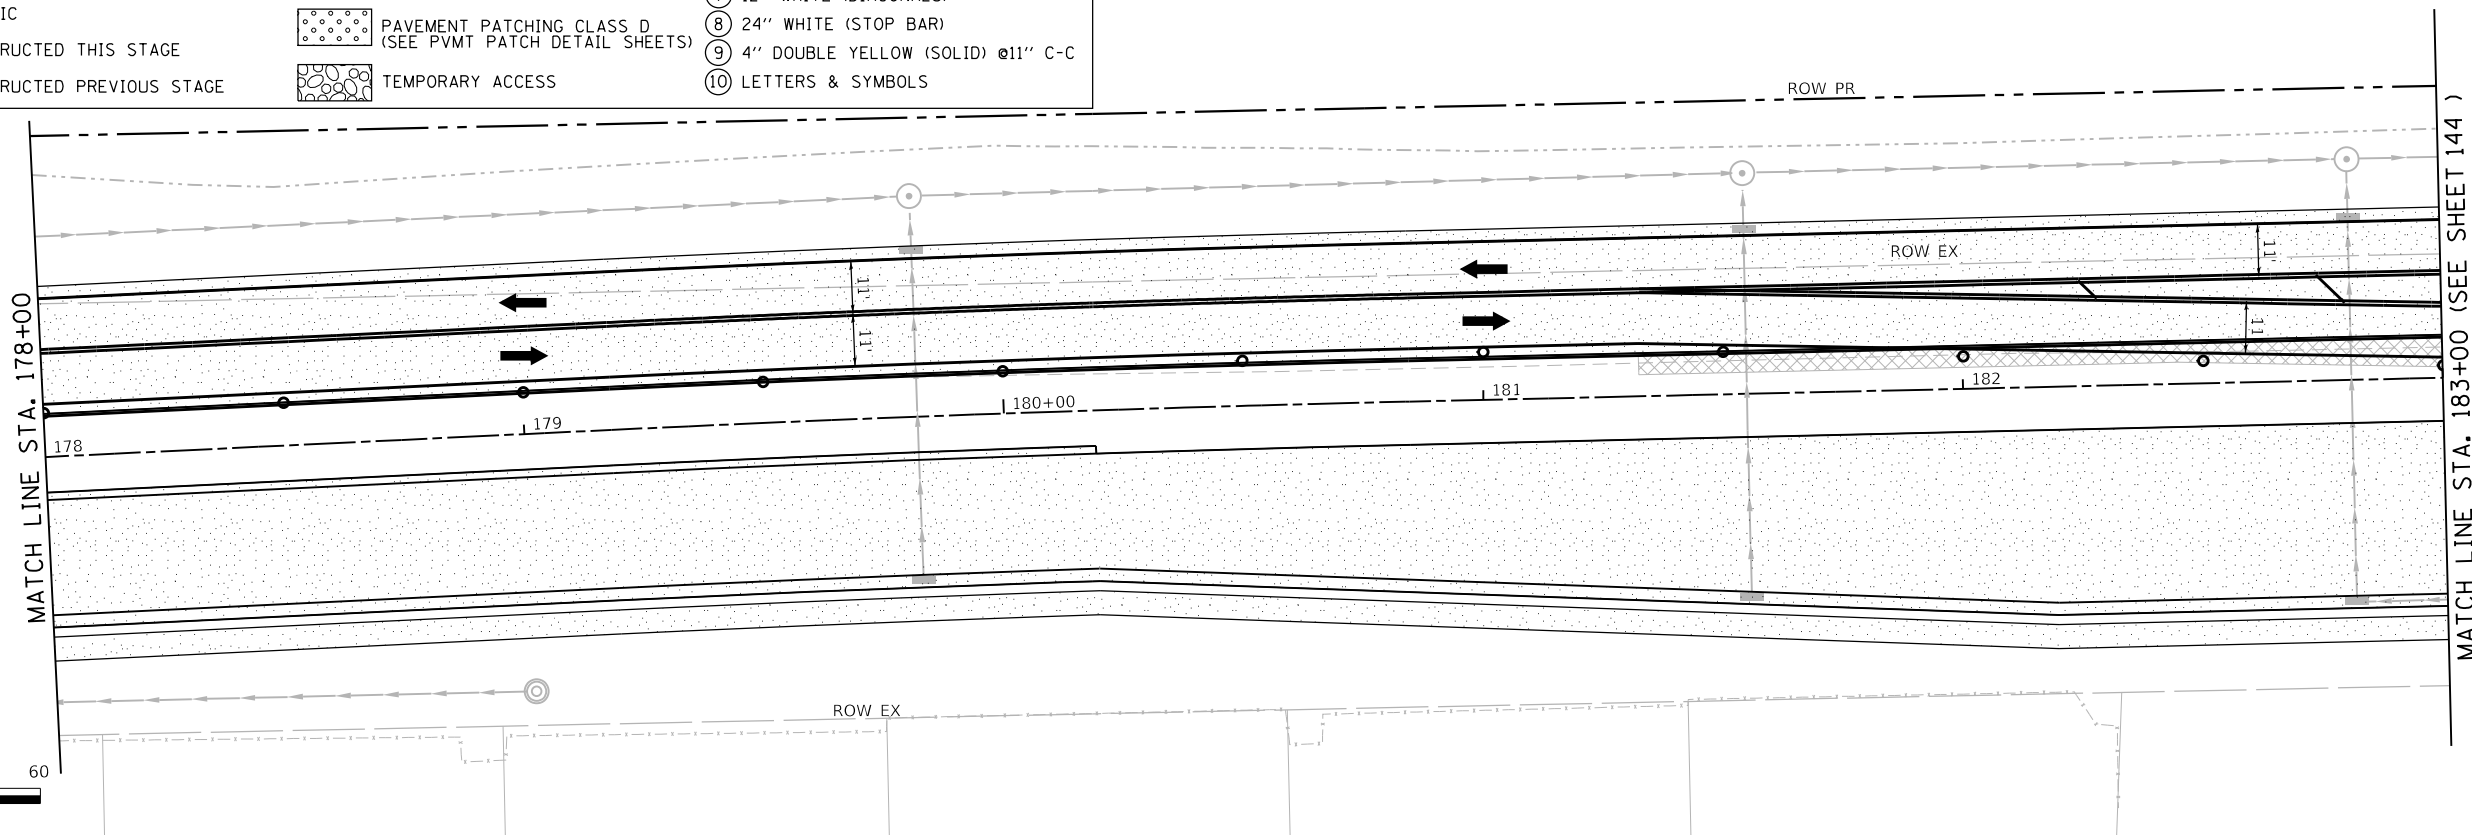
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PLOT DATE = 9/9/2022 (12:16:33 PM)

USER NAME = Mike Moses
DIRECTORY = L:\MILL\017204-01\Draw\CADD_Sheets\



LEGEND

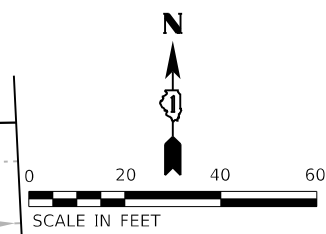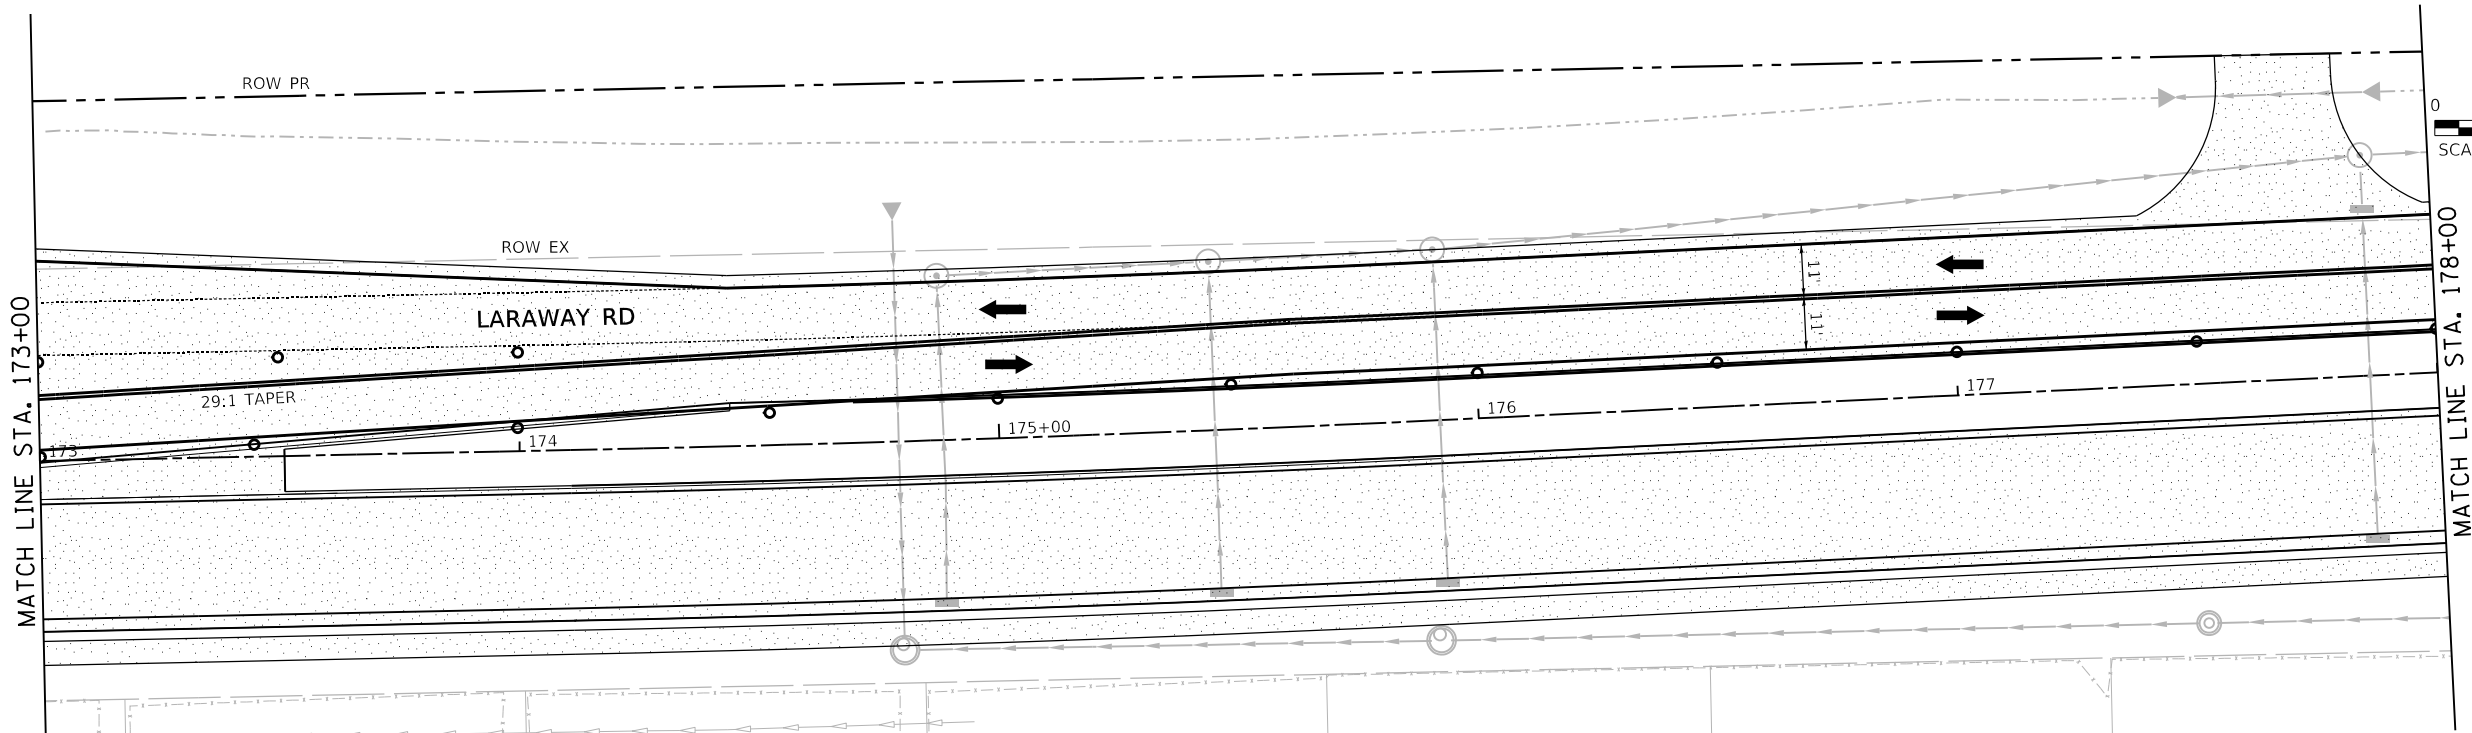	VERTICAL PANEL WITH STEADY BURN LIGHT AS REQUIRED BY SPECIFICATIONS. (50' C-C TYP., 25' C-C ON TAPERS & CURVES)		TEMPORARY PAVEMENT WIDENING CONSTRUCTED CURRENT STAGE		TEMPORARY PAVEMENT MARKINGS
	DRUM WITH STEADY-BURN LIGHT AS REQUIRED BY SPECIFICATIONS. (50' C-C TYP., 25' C-C ON TAPERS & CURVES)		TEMPORARY PAVEMENT WIDENING CONSTRUCTED PREVIOUS STAGE		① 4" YELLOW (SOLID)
	TYPE III BARRICADE WITH STEADY-BURN LIGHT AS REQUIRED BY SPECIFICATIONS.		COMPLETED PAVEMENT (TO TOP OF BINDER COURSE)		② 4" WHITE (SOLID)
	TEMPORARY CONCRETE BARRIER WITH TYPE C REFLECTOR		WORK ZONE		③ 4" WHITE (SKIP-DASH)
	DIRECTION OF TRAFFIC		PAVEMENT PATCHING CLASS D (SEE PVMT PATCH DETAIL SHEETS)		④ 6" WHITE (2' DASH, 6' SKIP)
	STORM SEWER CONSTRUCTED THIS STAGE		TEMPORARY ACCESS		⑤ 6" WHITE (SOLID)
	STORM SEWER CONSTRUCTED PREVIOUS STAGE				⑥ 12" YELLOW (DIAGONALS) 30' C-C @45°
					⑦ 12" WHITE (DIAGONALS)
					⑧ 24" WHITE (STOP BAR)
					⑨ 4" DOUBLE YELLOW (SOLID) @11" C-C
					⑩ LETTERS & SYMBOLS



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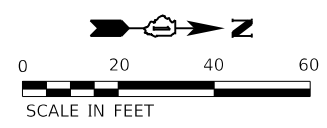
**STATE OF ILLINOIS
DEPARTMENT OF TRANSPORTATION**

**SUGGESTED SEQUENCE OF CONSTRUCTION
LARAWAY RD - STAGE 2C**

SCALE: 1"=20' SHEET 3 OF 3 SHEETS STA. 173+00 TO STA. 183+00






F.A.U. RTE.	SECTION	COUNTY	TOTAL SHEETS	SHEET NO.
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CONTRACT NO. 61H20				
ILLINOIS FED. AID PROJECT				

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LEGEND

	VERTICAL PANEL WITH STEADY BURN LIGHT AS REQUIRED BY SPECIFICATIONS. (50' C-C TYP., 25' C-C ON TAPERS & CURVES)		TEMPORARY PAVEMENT WIDENING CONSTRUCTED CURRENT STAGE	TEMPORARY PAVEMENT MARKINGS
	DRUM WITH STEADY-BURN LIGHT AS REQUIRED BY SPECIFICATIONS. (50' C-C TYP., 25' C-C ON TAPERS & CURVES)		TEMPORARY PAVEMENT WIDENING CONSTRUCTED PREVIOUS STAGE	① 4" YELLOW (SOLID)
	TYPE III BARRICADE WITH STEADY-BURN LIGHT AS REQUIRED BY SPECIFICATIONS.		COMPLETED PAVEMENT (TO TOP OF BINDER COURSE)	② 4" WHITE (SOLID)
	TEMPORARY CONCRETE BARRIER WITH TYPE C REFLECTOR		WORK ZONE	③ 4" WHITE (SKIP-DASH)
	DIRECTION OF TRAFFIC		PAVEMENT PATCHING CLASS D (SEE PVMT PATCH DETAIL SHEETS)	④ 6" WHITE (2' DASH, 6' SKIP)
	STORM SEWER CONSTRUCTED THIS STAGE		TEMPORARY ACCESS	⑤ 6" WHITE (SOLID)
	STORM SEWER CONSTRUCTED PREVIOUS STAGE			⑥ 12" YELLOW (DIAGONALS) 30' C-C @45°
				⑦ 12" WHITE (DIAGONALS)
				⑧ 24" WHITE (STOP BAR)
				⑨ 4" DOUBLE YELLOW (SOLID) @11" C-C
				⑩ LETTERS & SYMBOLS



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STATE OF ILLINOIS
DEPARTMENT OF TRANSPORTATION

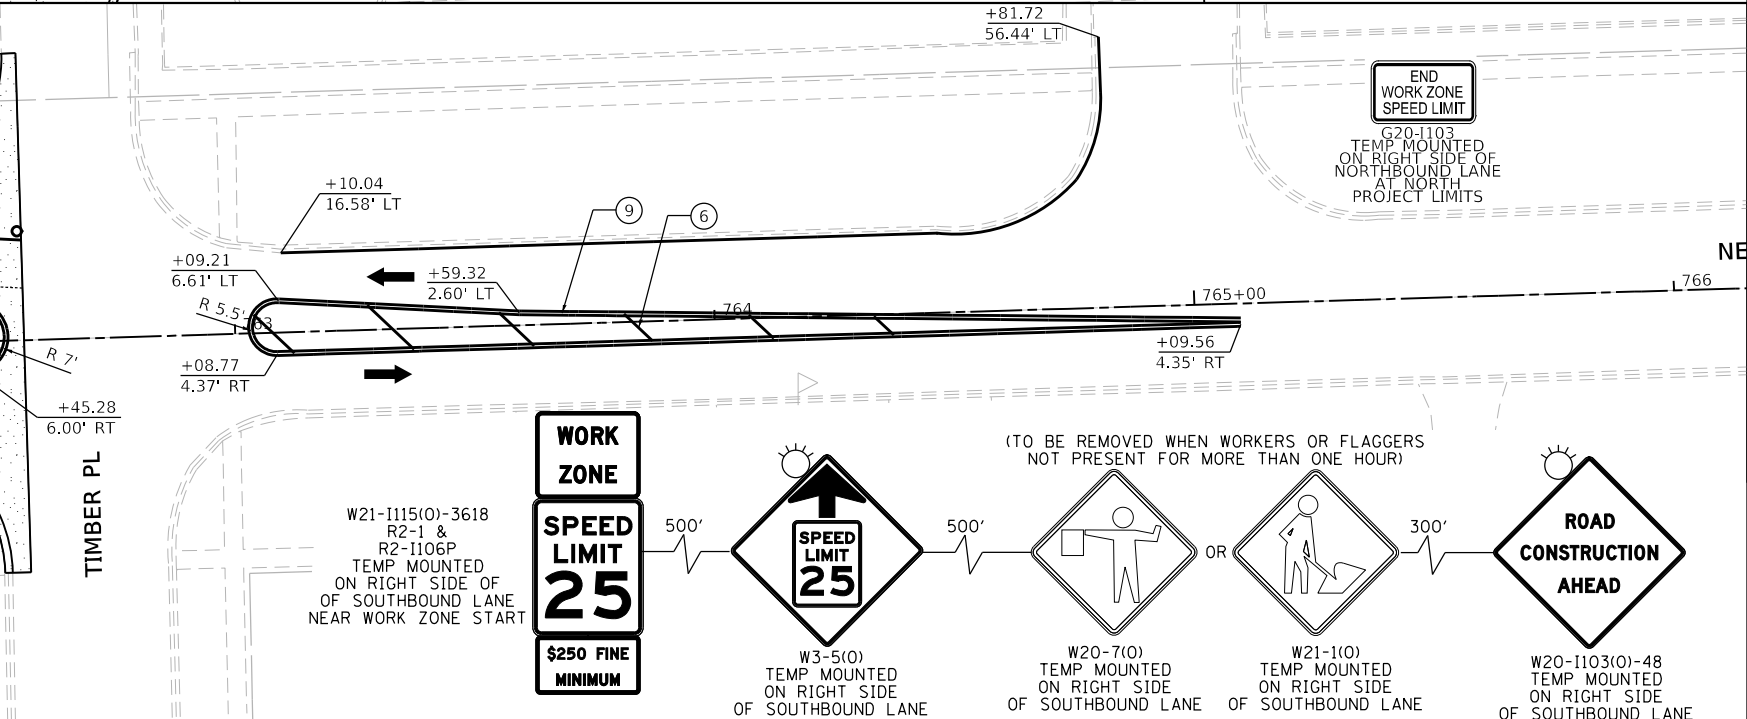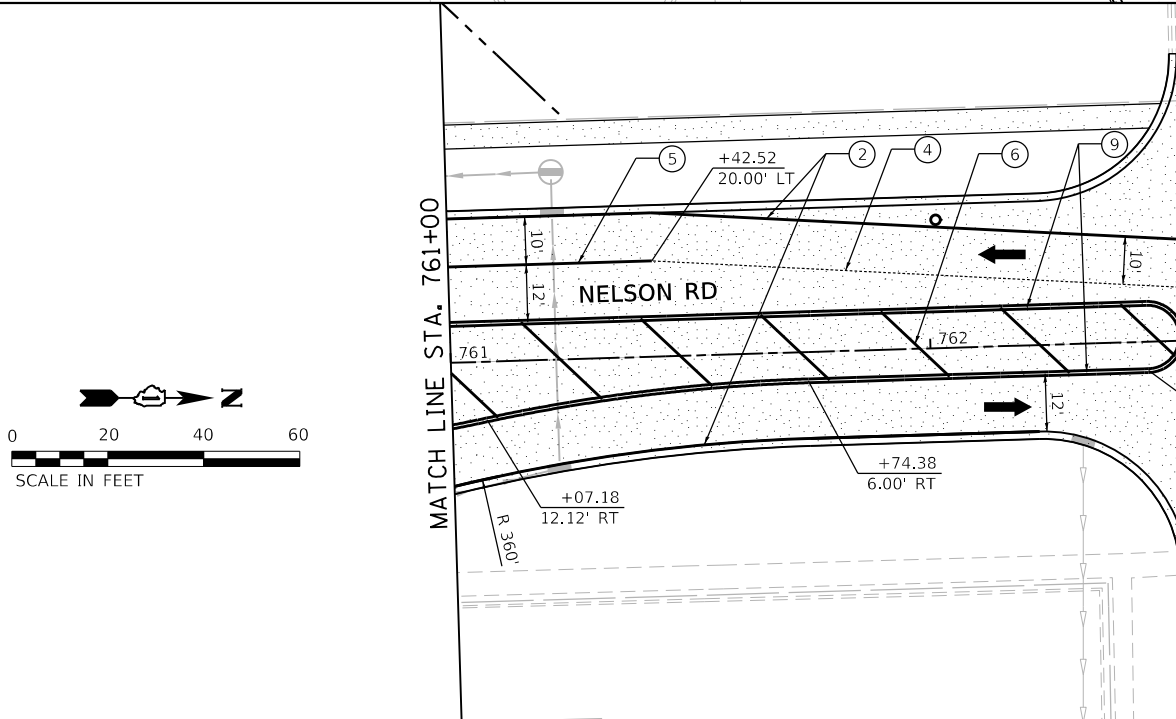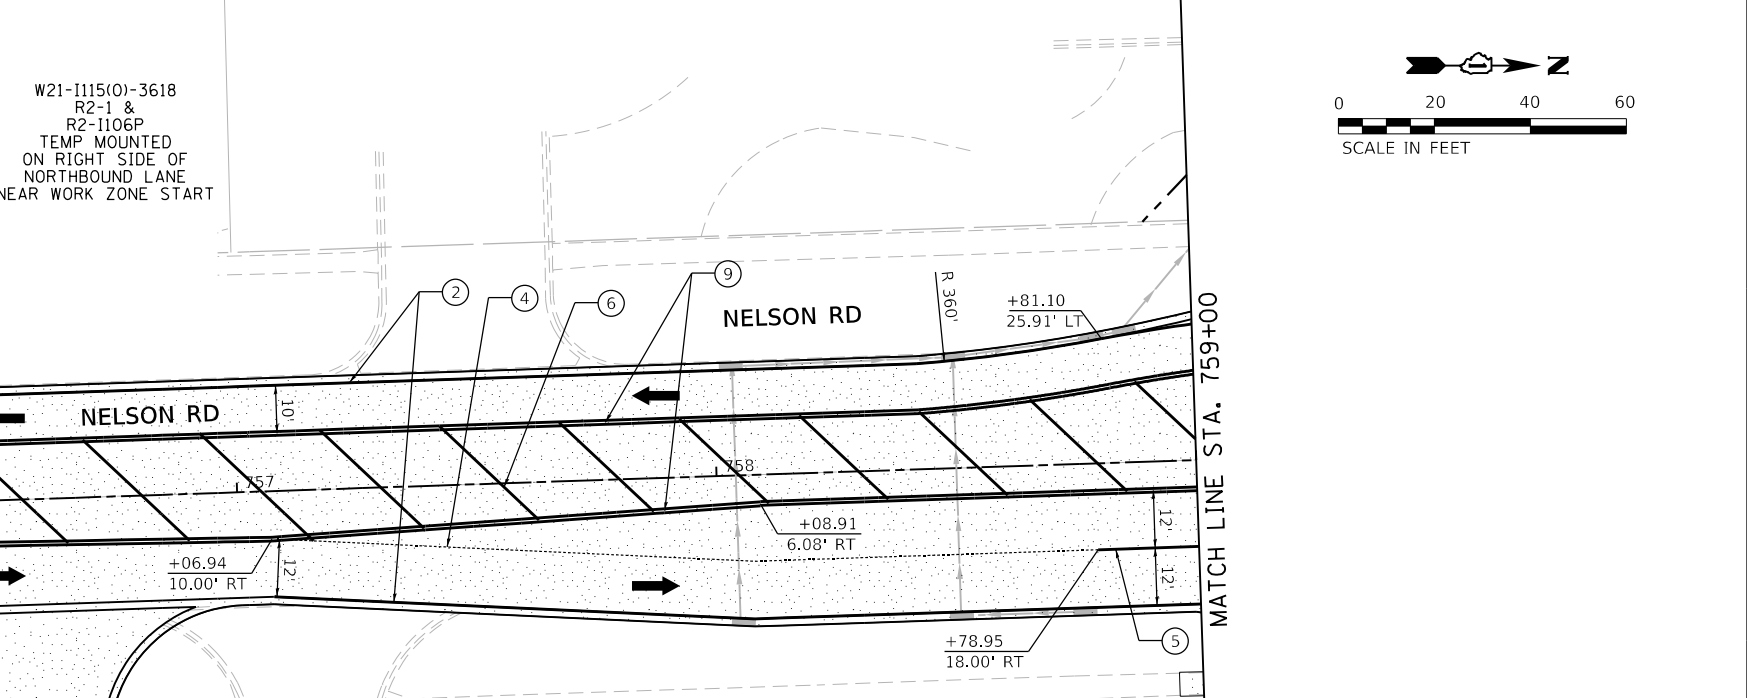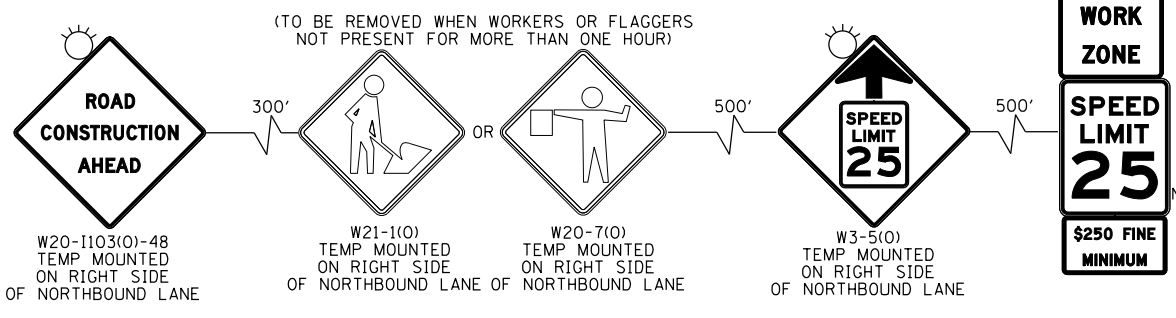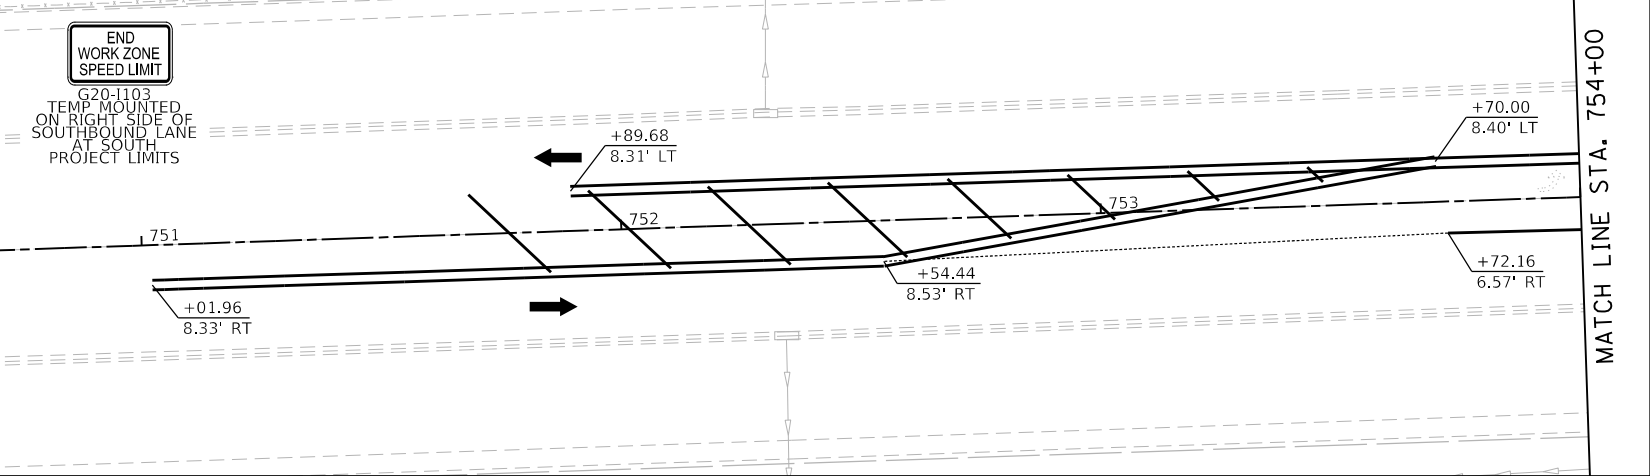SUGGESTED SEQUENCE OF CONSTRUCTION
NELSON RD - STAGE 2C



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0320	13-00138-37-PV	WILL	413	153
CONTRACT NO. 61H20				
ILLINOIS		FED. AID PROJECT		

SCALE: 1"=20' SHEET 1 OF 1 SHEETS STA. 751+00 TO STA. 765+00


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PLOT SCALE
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= 9/9/2022 (12:16:37 PM)

USER NAME
DIRECTORY
= Mike Moses
= L:\MILL\COIT\704-01\Draw\CADD_Sheets_L

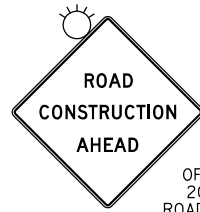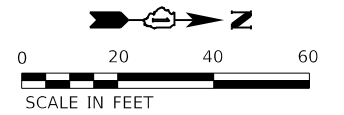

W20-1103(O)-36
TEMP MOUNTED
ON RIGHT SIDE
OF NORTHBOUND LANE
200' IN ADVANCE OF
ROAD CLOSED AHEAD SIGN

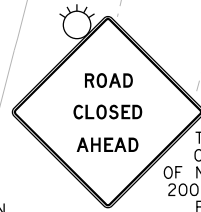


W20-3(O)-48
TEMP MOUNTED
ON RIGHT SIDE
OF NORTHBOUND LANE
200' IN ADVANCE OF
ROAD CLOSURE

LEGEND																								
	VERTICAL PANEL WITH STEADY BURN LIGHT AS REQUIRED BY SPECIFICATIONS. (50' C-C TYP., 25' C-C ON TAPERS & CURVES)																							
	DRUM WITH STEADY-BURN LIGHT AS REQUIRED BY SPECIFICATIONS. (50' C-C TYP., 25' C-C ON TAPERS & CURVES)																							
	TYPE III BARRICADE WITH STEADY-BURN LIGHT AS REQUIRED BY SPECIFICATIONS.																							
	TEMPORARY CONCRETE BARRIER WITH TYPE C REFLECTOR																							
	DIRECTION OF TRAFFIC																							
	STORM SEWER CONSTRUCTED THIS STAGE																							
	STORM SEWER CONSTRUCTED PREVIOUS STAGE																							
<table border="0"> <thead> <tr> <th colspan="2">TEMPORARY PAVEMENT MARKINGS</th> </tr> </thead> <tbody> <tr><td>①</td><td>4" YELLOW (SOLID)</td></tr> <tr><td>②</td><td>4" WHITE (SOLID)</td></tr> <tr><td>③</td><td>4" WHITE (SKIP-DASH)</td></tr> <tr><td>④</td><td>6" WHITE (2' DASH, 6' SKIP)</td></tr> <tr><td>⑤</td><td>6" WHITE (SOLID)</td></tr> <tr><td>⑥</td><td>12" YELLOW (DIAGONALS) 30' C-C @45°</td></tr> <tr><td>⑦</td><td>12" WHITE (DIAGONALS)</td></tr> <tr><td>⑧</td><td>24" WHITE (STOP BAR)</td></tr> <tr><td>⑨</td><td>4" DOUBLE YELLOW (SOLID) @11" C-C</td></tr> <tr><td>⑩</td><td>LETTERS & SYMBOLS</td></tr> </tbody> </table>			TEMPORARY PAVEMENT MARKINGS		①	4" YELLOW (SOLID)	②	4" WHITE (SOLID)	③	4" WHITE (SKIP-DASH)	④	6" WHITE (2' DASH, 6' SKIP)	⑤	6" WHITE (SOLID)	⑥	12" YELLOW (DIAGONALS) 30' C-C @45°	⑦	12" WHITE (DIAGONALS)	⑧	24" WHITE (STOP BAR)	⑨	4" DOUBLE YELLOW (SOLID) @11" C-C	⑩	LETTERS & SYMBOLS
TEMPORARY PAVEMENT MARKINGS																								
①	4" YELLOW (SOLID)																							
②	4" WHITE (SOLID)																							
③	4" WHITE (SKIP-DASH)																							
④	6" WHITE (2' DASH, 6' SKIP)																							
⑤	6" WHITE (SOLID)																							
⑥	12" YELLOW (DIAGONALS) 30' C-C @45°																							
⑦	12" WHITE (DIAGONALS)																							
⑧	24" WHITE (STOP BAR)																							
⑨	4" DOUBLE YELLOW (SOLID) @11" C-C																							
⑩	LETTERS & SYMBOLS																							



BOBWHITE LANE

MATCH LINE STA. 829+00

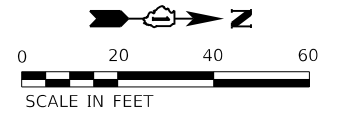

W20-1103(O)-36
M6-4
TEMP MOUNTED
ON RIGHT SIDE
OF SOUTHBOUND LANE
200' FROM WORK AREA
PER IDOT TC-10

MATCH LINE STA. 840+70

TIMBER PL



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DATE - 09/09/2022


REVISED -
REVISED -
REVISED -
REVISED -

STATE OF ILLINOIS
DEPARTMENT OF TRANSPORTATION

SUGGESTED SEQUENCE OF CONSTRUCTION
FOXWOOD DR - STAGE 2C


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F.A.U. RTE.	SECTION	COUNTY	TOTAL SHEETS	SHEET NO.
0320	13-00138-37-PV	WILL	413	154
CONTRACT NO. 61H20				
ILLINOIS FED. AID PROJECT				

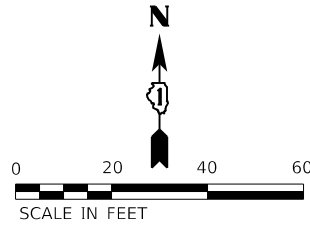

- PIPELINE STAGING NOTES:**
- CONTRACTOR MUST CONTACT PIPELINE COMPANIES TO COORDINATE ALL WORK IN THE VICINITY OF THE PIPELINES. CONTRACTOR MUST FOLLOW ALL REQUIREMENTS OF THESE PLANS, SPECIFICATIONS, PIPELINE ENCROACHMENT GUIDELINES, AND ANY OTHER REQUIREMENTS COMMUNICATED BY PIPELINE COMPANY REPRESENTATIVES REGARDING WORK AROUND THE PIPELINES.

BP PIPELINES OF AMERICA STEVE ADAMS OFFICE: 779.801.4969 EMAIL: steve.adams@bp.com	ENTERPRISE PRODUCTS BLAKE HAMILTON OFFICE: 815.277.7286 CELL: 217.508.2991 EMAIL: bdhamilton@eprod.com
---	--
 - TEMPORARY FENCE SHALL BE REPOSITIONED TO A LOCATION APPROVED BY THE ENGINEER AND THE PIPELINE REPRESENTATIVES TO LIMIT EQUIPMENT CROSSING TO A 15' WIDE OPENING PERPENDICULAR TO PIPELINES. 5' GAP IN FENCE IS PERMITTED TO ALLOW PEDESTRAIN PASSAGE.
 - SEE SHEET 217 FOR ADDITIONAL INFORMATION ON ENTERPRISE PRODUCTS PIPELINE AND SHEET 218 FOR ADDITIONAL INFORMATION OF BP PIPELINES OF AMERICA PIPELINE.

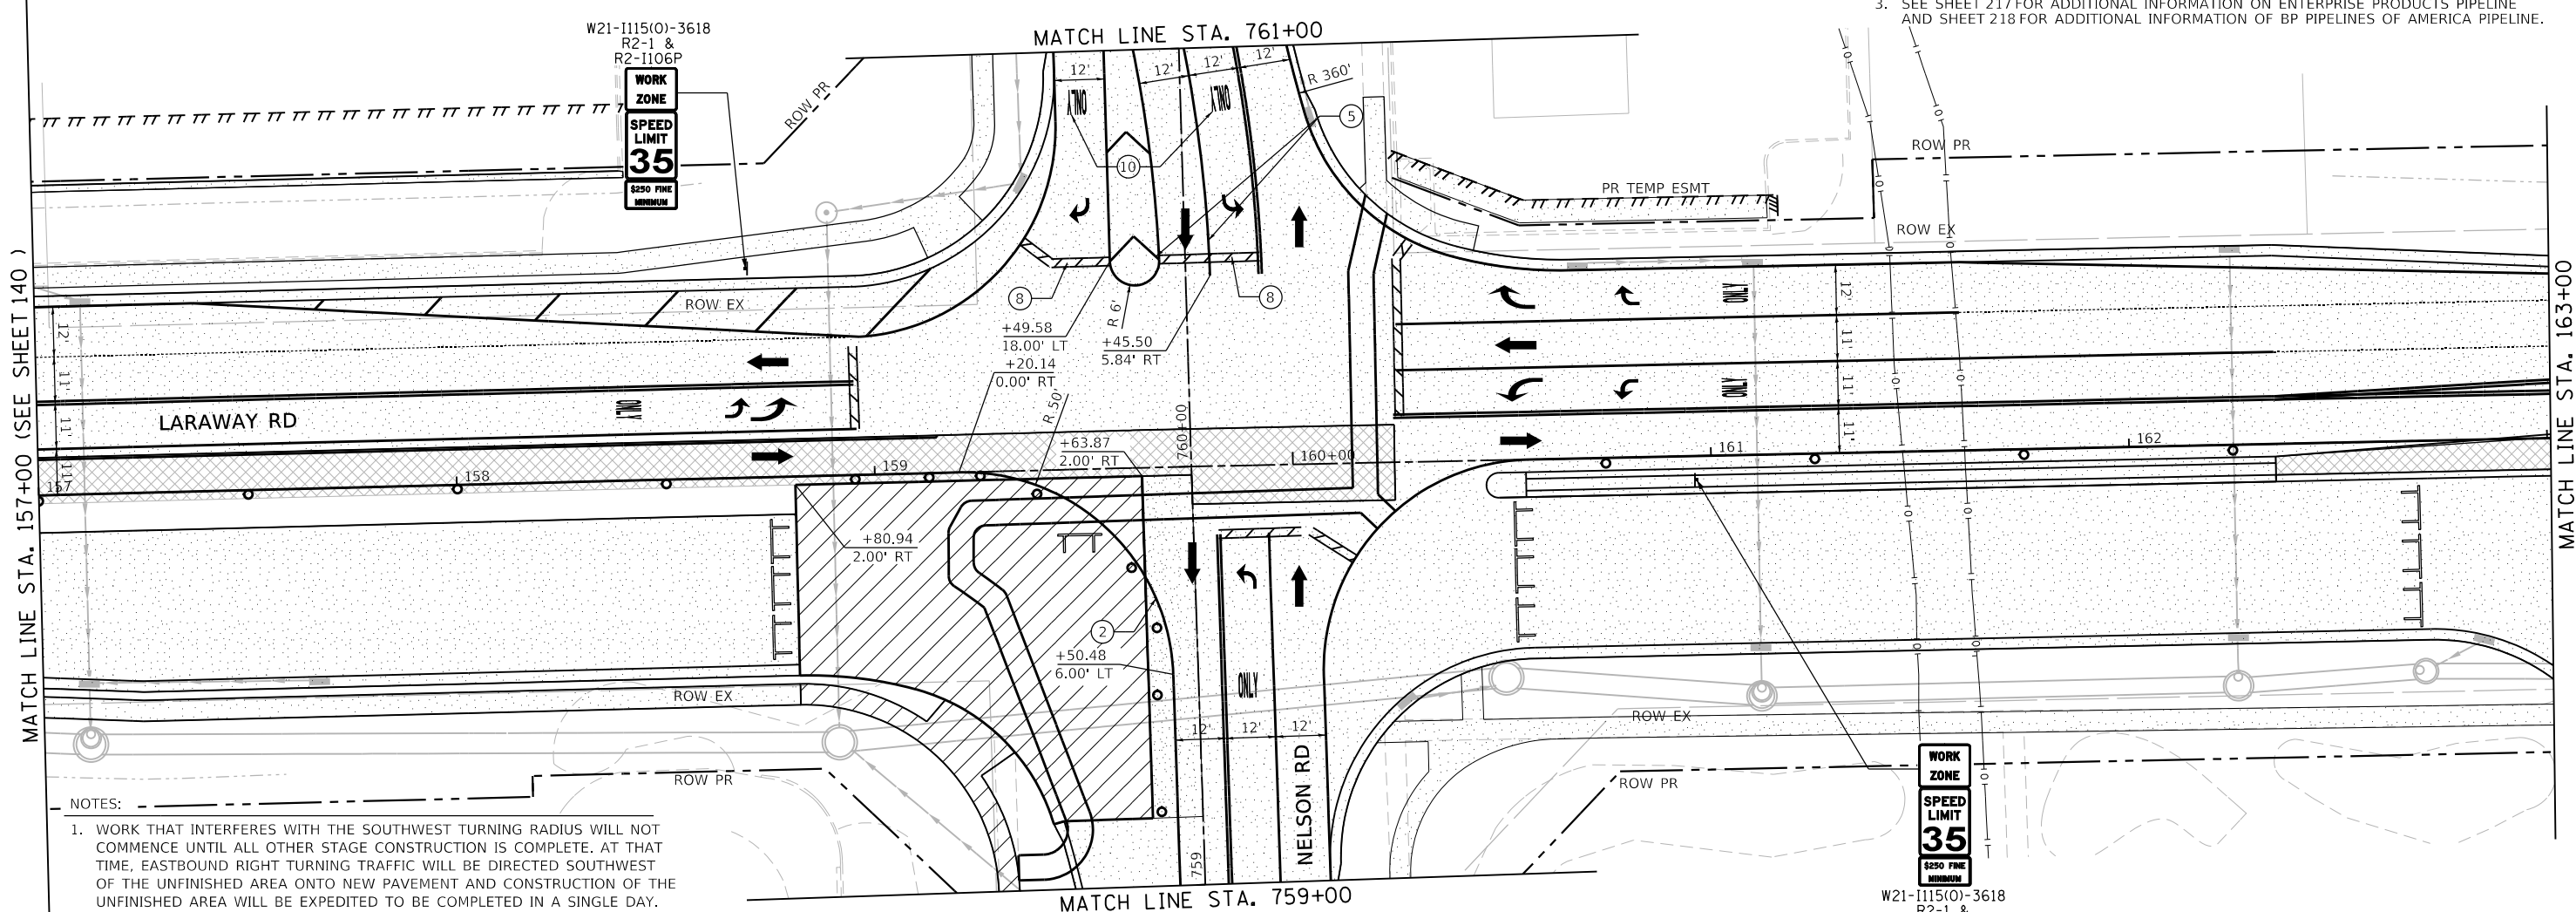

- NOTES:**
- WORK THAT INTERFERES WITH THE SOUTHWEST TURNING RADIUS WILL NOT COMMENCE UNTIL ALL OTHER STAGE CONSTRUCTION IS COMPLETE. AT THAT TIME, EASTBOUND RIGHT TURNING TRAFFIC WILL BE DIRECTED SOUTHWEST OF THE UNFINISHED AREA ONTO NEW PAVEMENT AND CONSTRUCTION OF THE UNFINISHED AREA WILL BE EXPEDITED TO BE COMPLETED IN A SINGLE DAY.
 - SEE TEMPORARY TRAFFIC SIGNAL PLANS FOR CROSSWALK CONFIGURATIONS.

LEGEND		TEMPORARY PAVEMENT MARKINGS	
	VERTICAL PANEL WITH STEADY BURN LIGHT AS REQUIRED BY SPECIFICATIONS. (50' C-C TYP., 25' C-C ON TAPERS & CURVES)		TEMPORARY PAVEMENT WIDENING CONSTRUCTED CURRENT STAGE
	DRUM WITH STEADY-BURN LIGHT AS REQUIRED BY SPECIFICATIONS. (50' C-C TYP., 25' C-C ON TAPERS & CURVES)		TEMPORARY PAVEMENT WIDENING CONSTRUCTED PREVIOUS STAGE
	TYPE III BARRICADE WITH STEADY-BURN LIGHT AS REQUIRED BY SPECIFICATIONS.		COMPLETED PAVEMENT (TO TOP OF BINDER COURSE)
	TEMPORARY CONCRETE BARRIER WITH TYPE C REFLECTOR		WORK ZONE
	DIRECTION OF TRAFFIC		PAVEMENT PATCHING CLASS D (SEE PVMT PATCH DETAIL SHEETS)
	STORM SEWER CONSTRUCTED THIS STAGE		TEMPORARY ACCESS
	STORM SEWER CONSTRUCTED PREVIOUS STAGE		① 4" YELLOW (SOLID)
			② 4" WHITE (SOLID)
			③ 4" WHITE (SKIP-DASH)
			④ 6" WHITE (2' DASH, 6' SKIP)
			⑤ 6" WHITE (SOLID)
			⑥ 12" YELLOW (DIAGONALS) 30' C-C @45°
			⑦ 12" WHITE (DIAGONALS)
			⑧ 24" WHITE (STOP BAR)
			⑨ 4" DOUBLE YELLOW (SOLID) @11" C-C
			⑩ LETTERS & SYMBOLS

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**STATE OF ILLINOIS
DEPARTMENT OF TRANSPORTATION**



SUGGESTED SEQUENCE OF CONSTRUCTION	
LARAWAY RD - STAGE 2D	
SCALE: 1"=20'	SHEET 1 OF 4 SHEETS
STA. 157+00	TO STA. 163+00

F.A.U. RTE.	SECTION	COUNTY	TOTAL SHEETS	SHEET NO.
0320	13-00138-37-PV	WILL	413	155
CONTRACT NO. 61H20				
ILLINOIS FED. AID PROJECT				

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PLOT SCALE
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= 40.0018' / in.
= 9/9/2022 (12:16:40 PM)

USER NAME
DIRECTORY
= Mike Moses
= L:\MILL\017204-01\Drawn\CADD_Sheets\

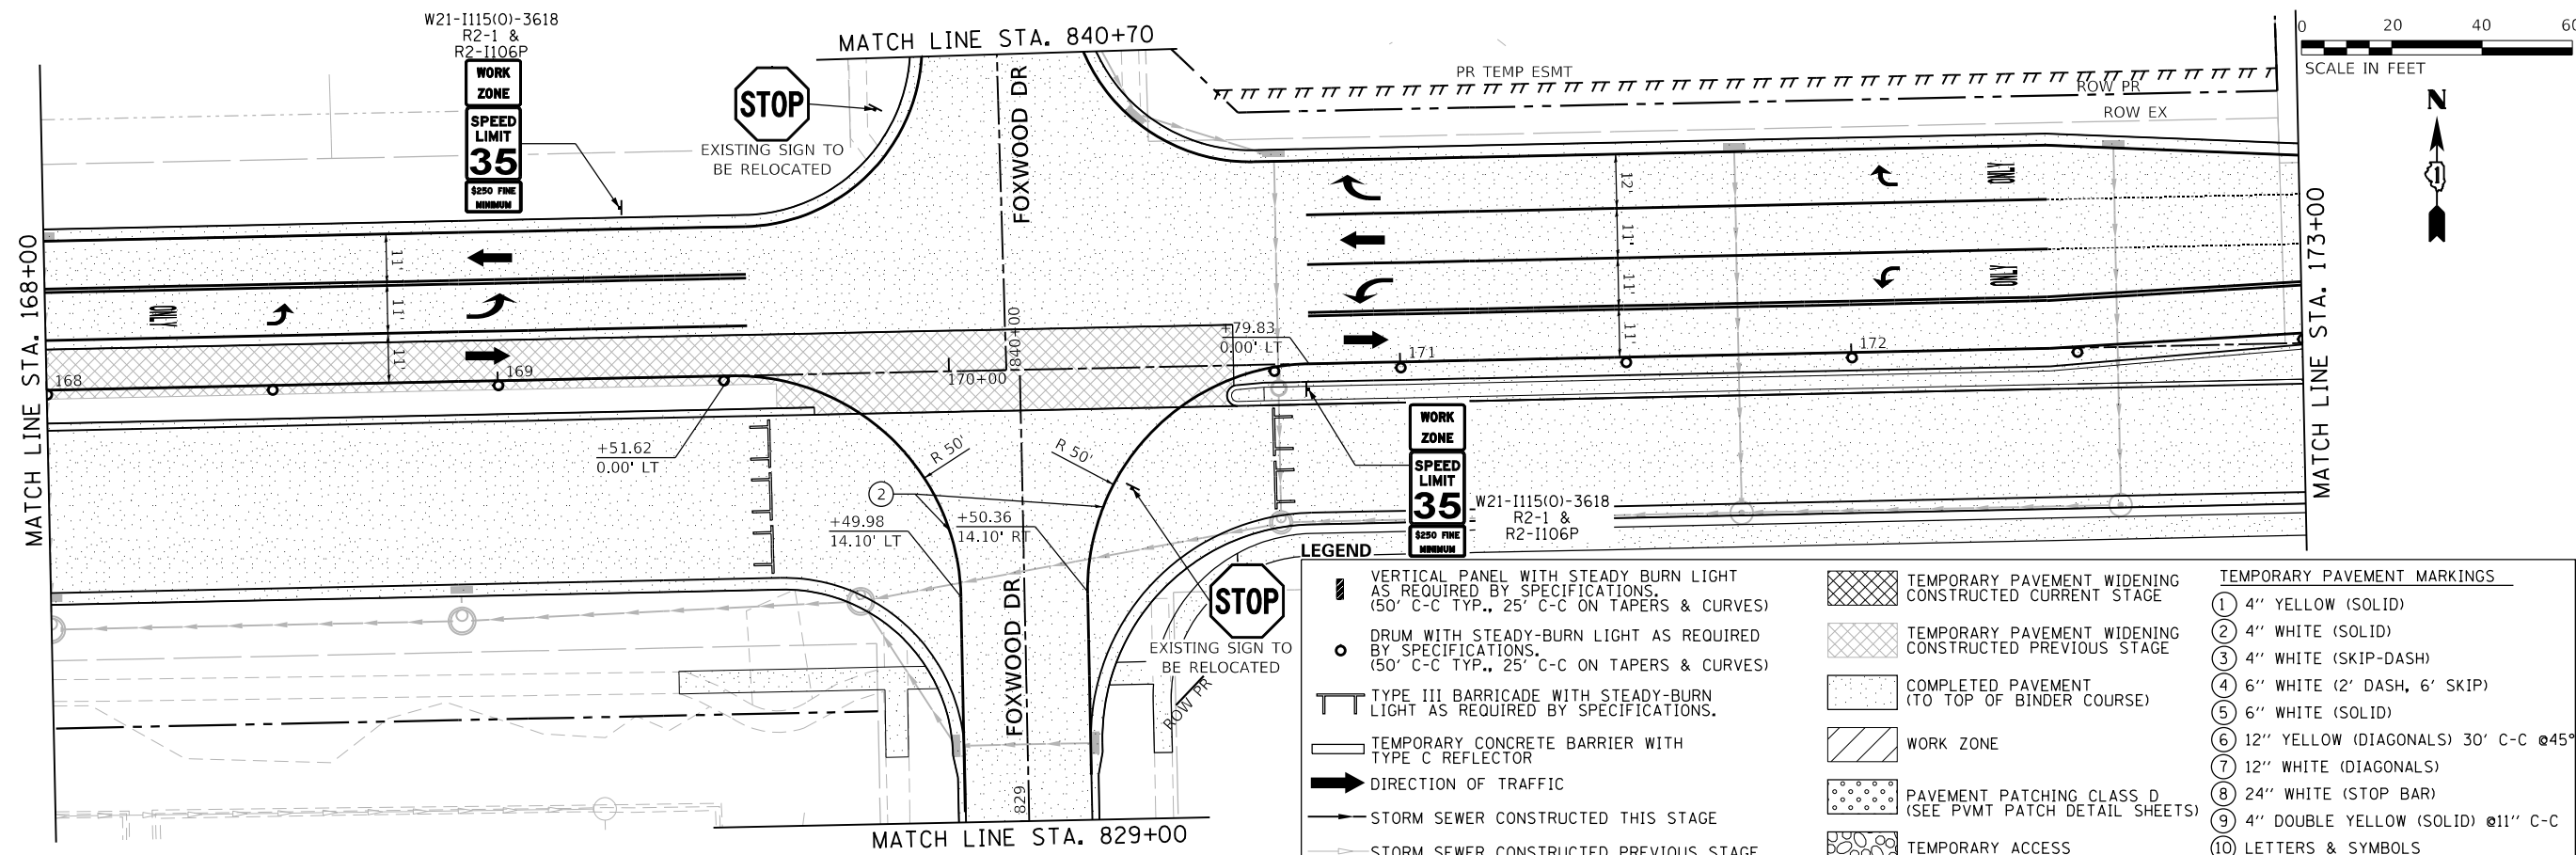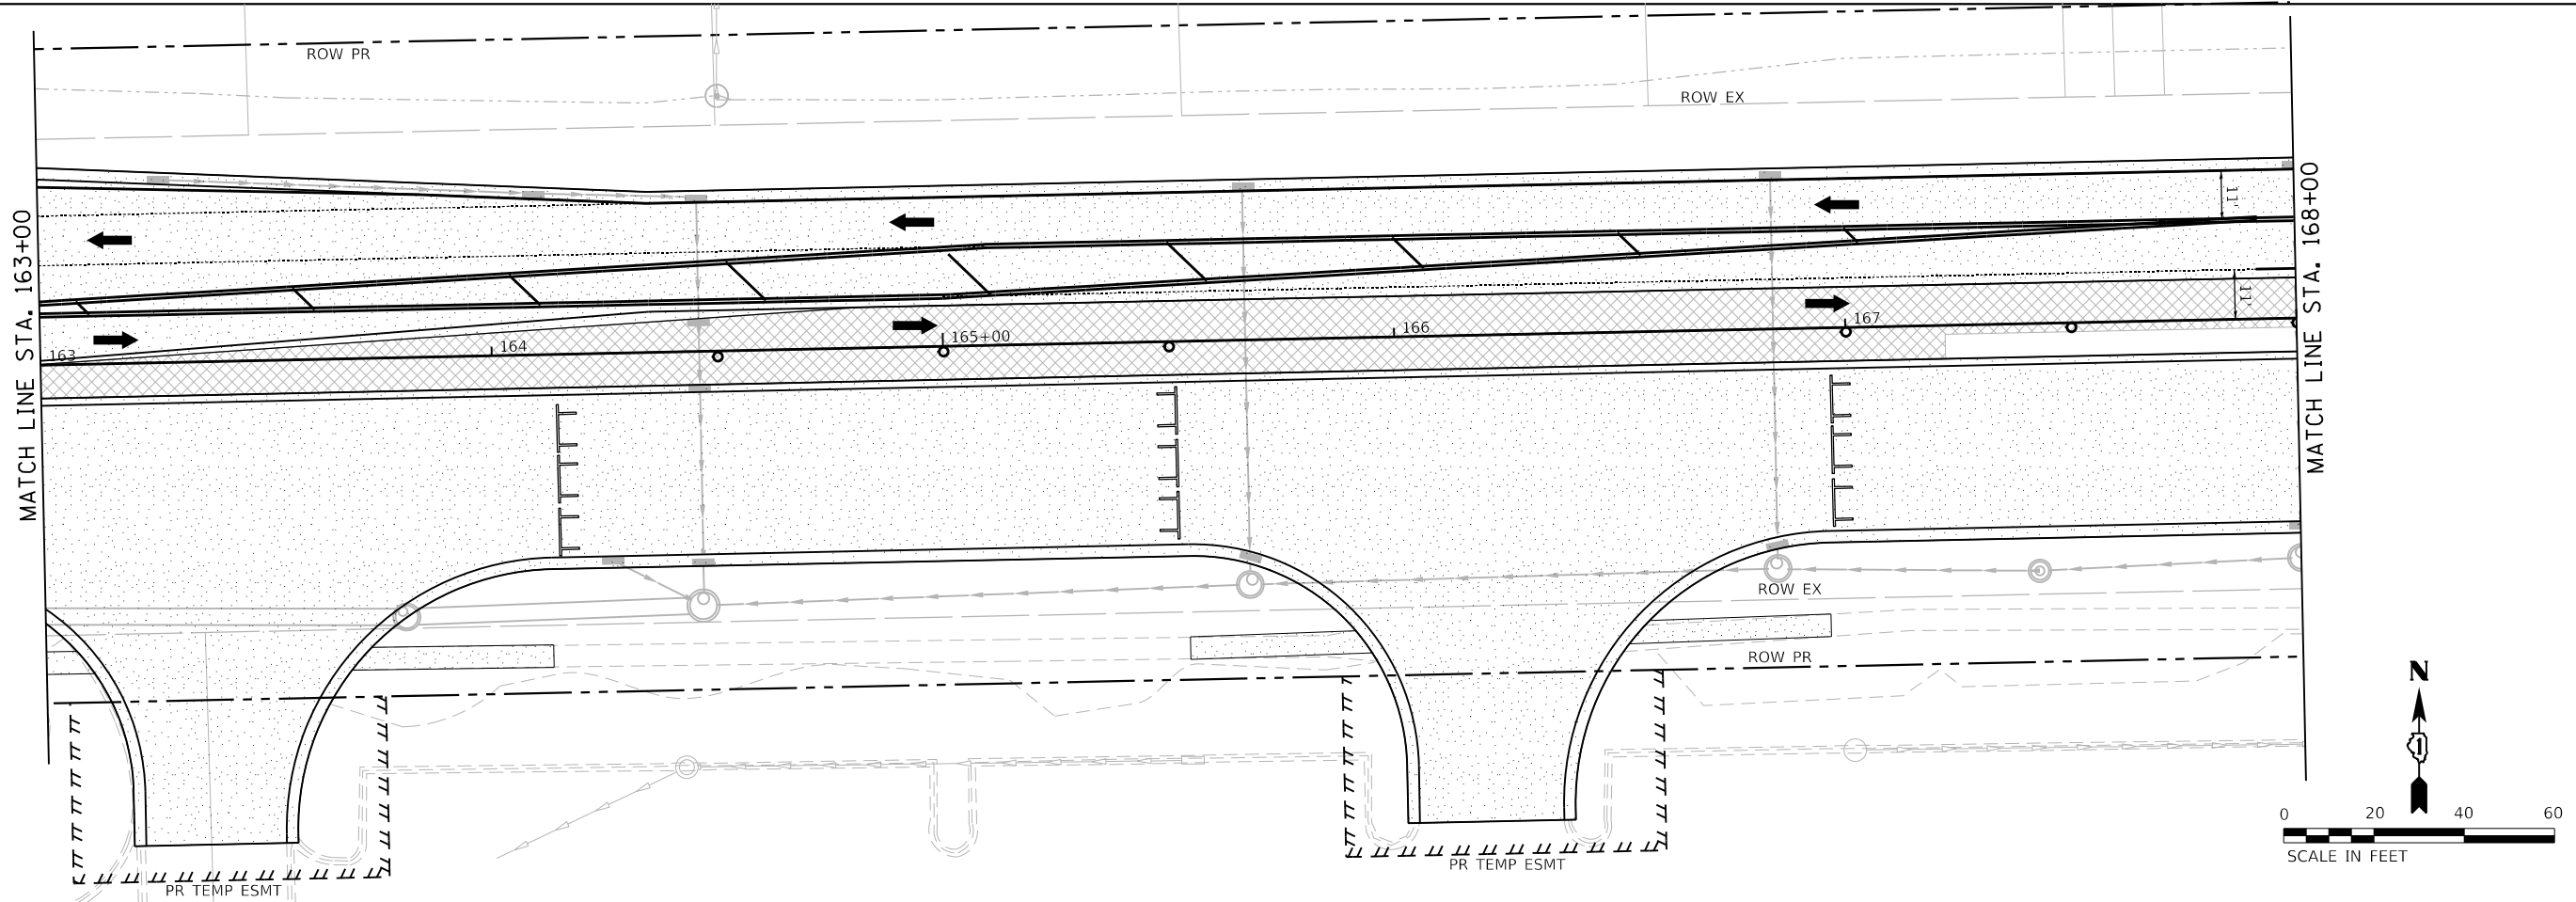

LEGEND

	VERTICAL PANEL WITH STEADY BURN LIGHT AS REQUIRED BY SPECIFICATIONS. (50' C-C TYP., 25' C-C ON TAPERS & CURVES)		TEMPORARY PAVEMENT WIDENING CONSTRUCTED CURRENT STAGE	TEMPORARY PAVEMENT MARKINGS (1) 4" YELLOW (SOLID) (2) 4" WHITE (SOLID) (3) 4" WHITE (SKIP-DASH) (4) 6" WHITE (2' DASH, 6' SKIP) (5) 6" WHITE (SOLID) (6) 12" YELLOW (DIAGONALS) 30' C-C @45° (7) 12" WHITE (DIAGONALS) (8) 24" WHITE (STOP BAR) (9) 4" DOUBLE YELLOW (SOLID) @11" C-C (10) LETTERS & SYMBOLS
	DRUM WITH STEADY-BURN LIGHT AS REQUIRED BY SPECIFICATIONS. (50' C-C TYP., 25' C-C ON TAPERS & CURVES)		TEMPORARY PAVEMENT WIDENING CONSTRUCTED PREVIOUS STAGE	
	TYPE III BARRICADE WITH STEADY-BURN LIGHT AS REQUIRED BY SPECIFICATIONS.		COMPLETED PAVEMENT (TO TOP OF BINDER COURSE)	
	TEMPORARY CONCRETE BARRIER WITH TYPE C REFLECTOR		WORK ZONE	
	DIRECTION OF TRAFFIC		PAVEMENT PATCHING CLASS D (SEE PVMT PATCH DETAIL SHEETS)	
	STORM SEWER CONSTRUCTED THIS STAGE		TEMPORARY ACCESS	
	STORM SEWER CONSTRUCTED PREVIOUS STAGE			



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**STATE OF ILLINOIS
DEPARTMENT OF TRANSPORTATION**



SUGGESTED SEQUENCE OF CONSTRUCTION			
LARAWAY RD - STAGE 2D			
SCALE: 1"=20'	SHEET 2	OF 4 SHEETS	STA. 163+00 TO STA. 173+00

F.A.U. RTE.	SECTION	COUNTY	TOTAL SHEETS	SHEET NO.
0320	13-00138-37-PV	WILL	413	156
CONTRACT NO. 61H20				
ILLINOIS FED. AID PROJECT				

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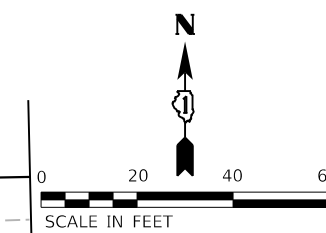
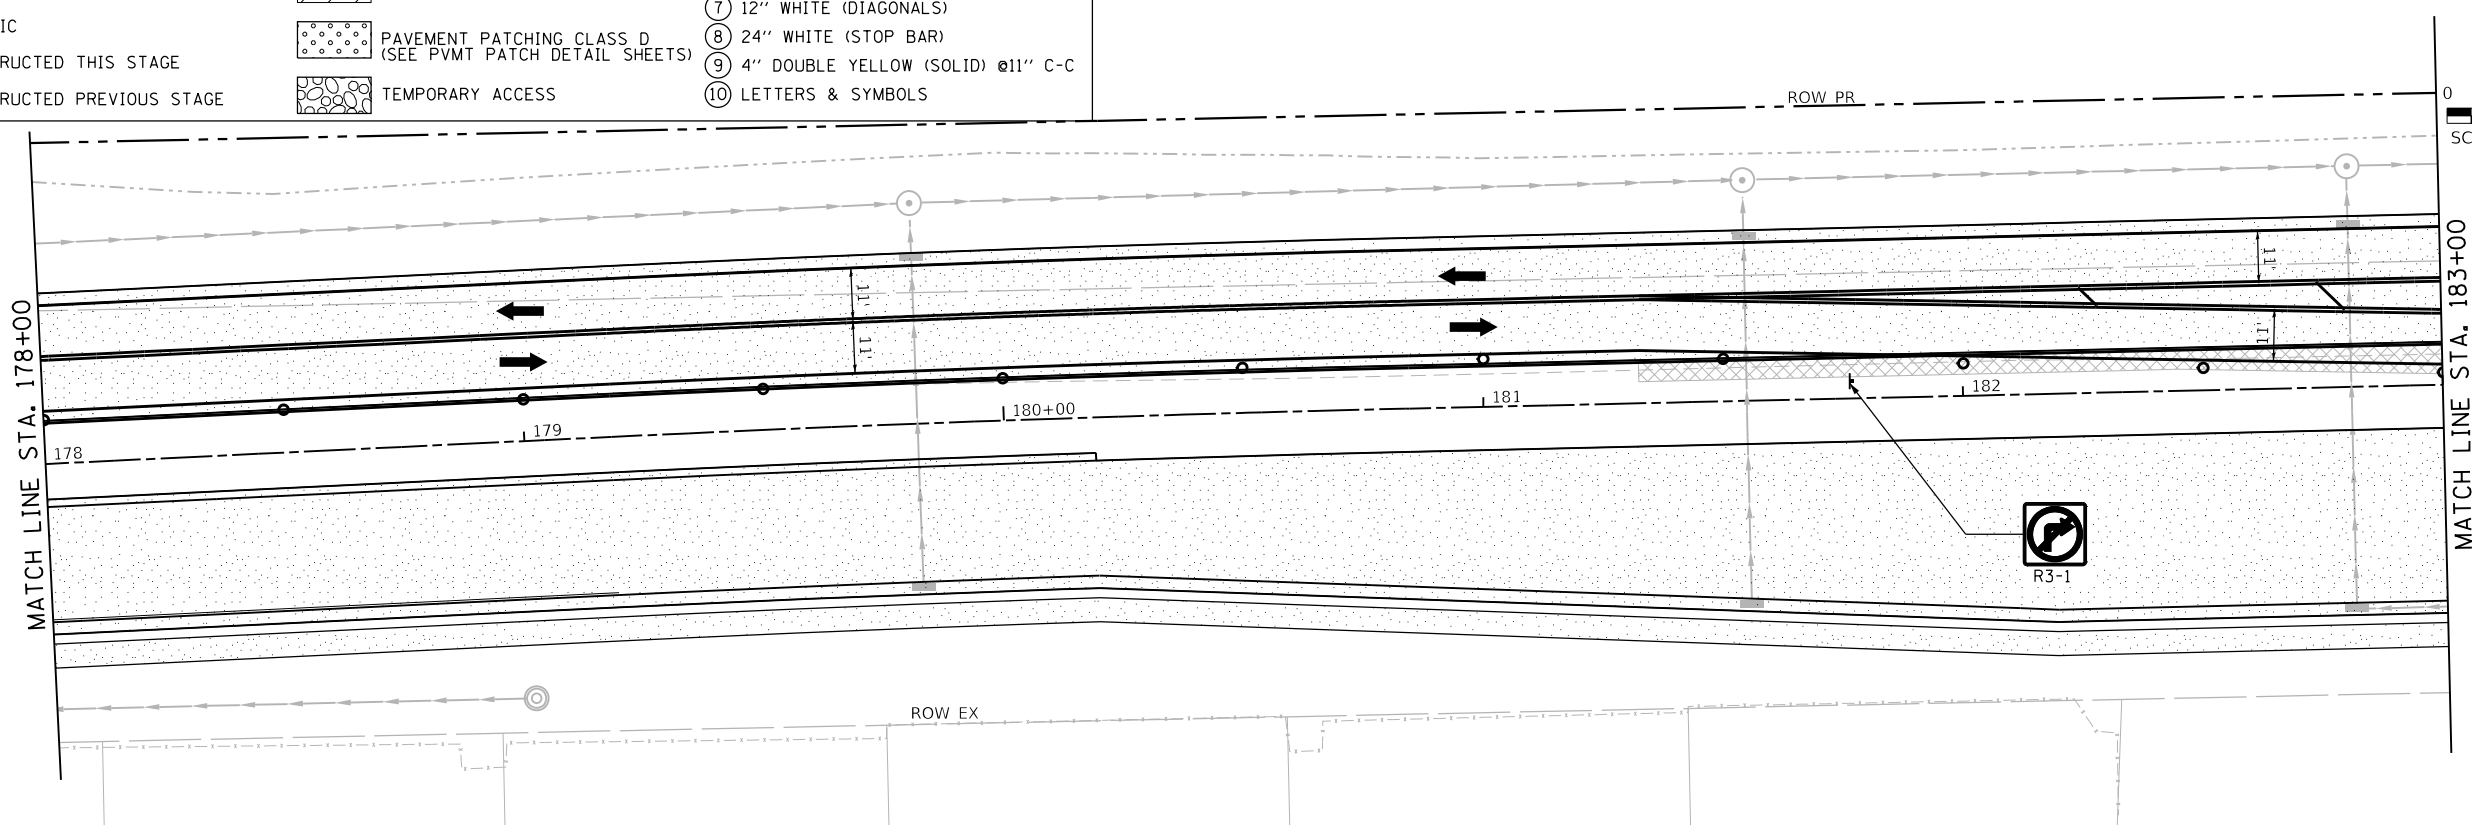
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USER NAME = Mike Moses
 DIRECTORY = L:\MILL\CO17204-01\Draw\CADD_Sheets



LEGEND

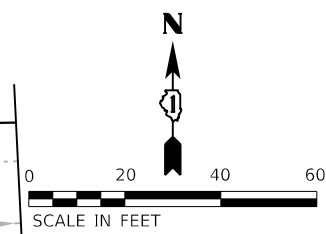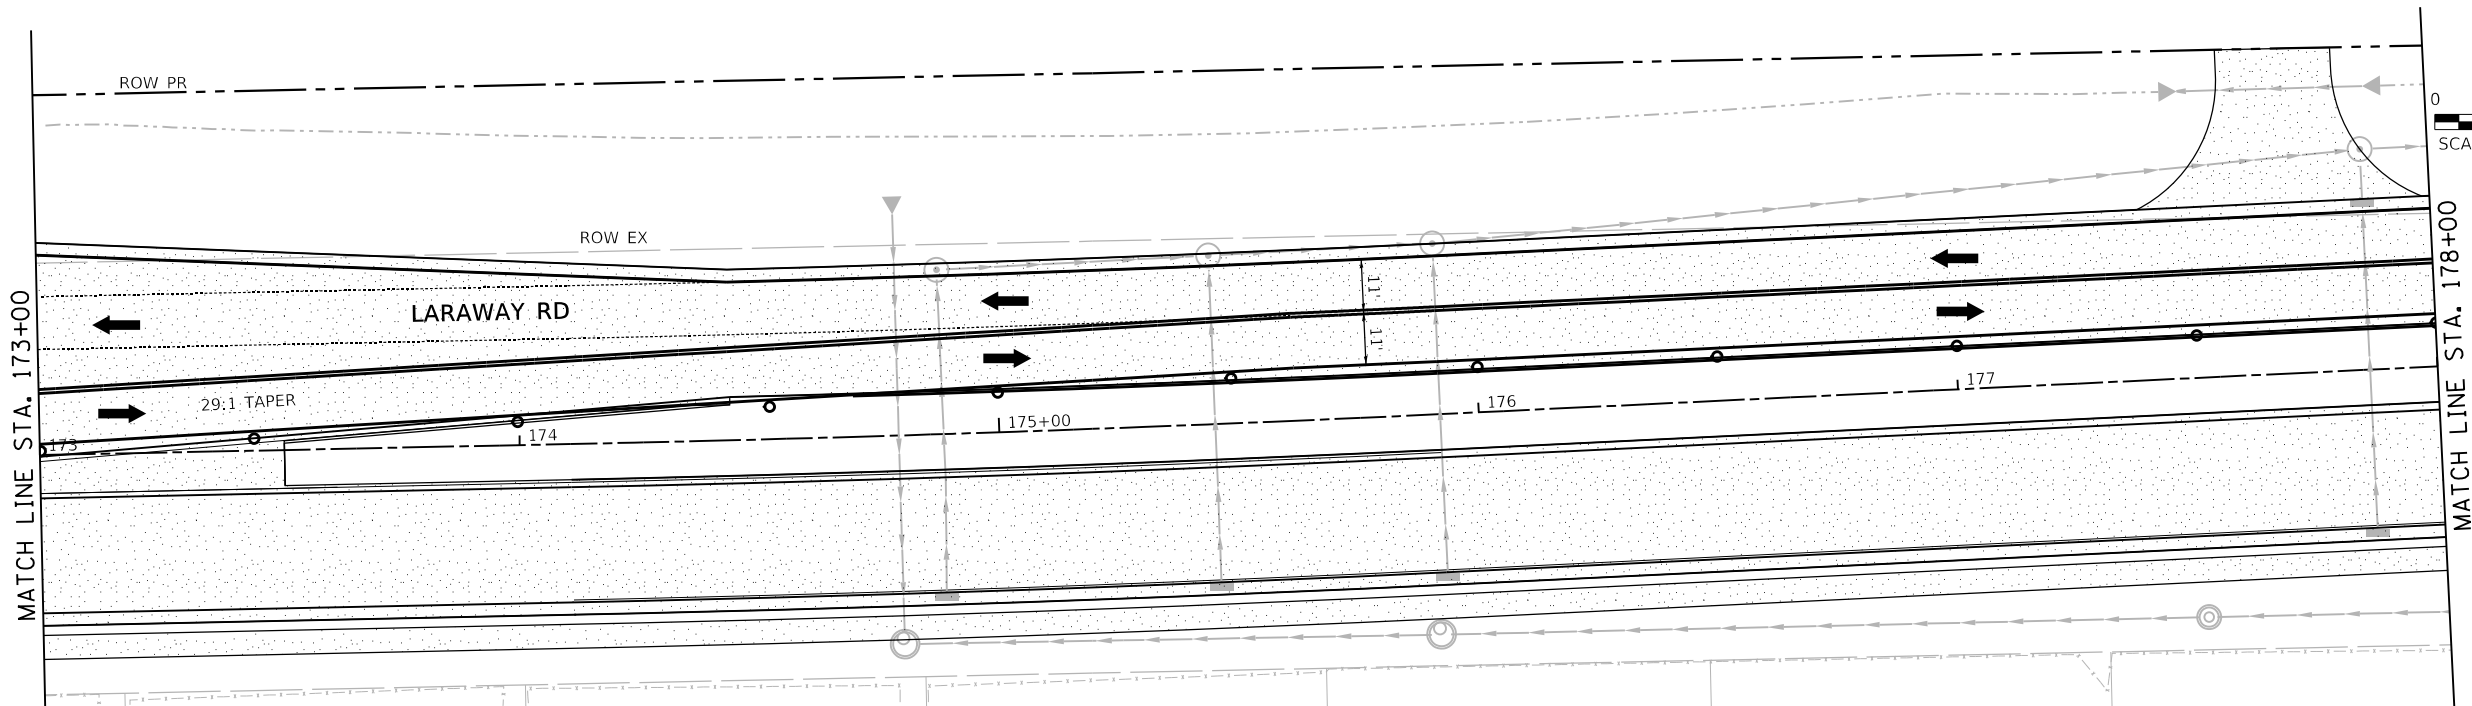- | | | |
|---|--|---------------------------------------|
| VERTICAL PANEL WITH STEADY BURN LIGHT AS REQUIRED BY SPECIFICATIONS. (50' C-C TYP., 25' C-C ON TAPERS & CURVES) | TEMPORARY PAVEMENT WIDENING CONSTRUCTED CURRENT STAGE | TEMPORARY PAVEMENT MARKINGS |
| DRUM WITH STEADY-BURN LIGHT AS REQUIRED BY SPECIFICATIONS. (50' C-C TYP., 25' C-C ON TAPERS & CURVES) | TEMPORARY PAVEMENT WIDENING CONSTRUCTED PREVIOUS STAGE | ① 4" YELLOW (SOLID) |
| TYPE III BARRICADE WITH STEADY-BURN LIGHT AS REQUIRED BY SPECIFICATIONS. | COMPLETED PAVEMENT (TO TOP OF BINDER COURSE) | ② 4" WHITE (SOLID) |
| TEMPORARY CONCRETE BARRIER WITH TYPE C REFLECTOR | WORK ZONE | ③ 4" WHITE (SKIP-DASH) |
| DIRECTION OF TRAFFIC | PAVEMENT PATCHING CLASS D (SEE PVMT PATCH DETAIL SHEETS) | ④ 6" WHITE (2' DASH, 6' SKIP) |
| STORM SEWER CONSTRUCTED THIS STAGE | TEMPORARY ACCESS | ⑤ 6" WHITE (SOLID) |
| STORM SEWER CONSTRUCTED PREVIOUS STAGE | | ⑥ 12" YELLOW (DIAGONALS) 30' C-C @45° |
| | | ⑦ 12" WHITE (DIAGONALS) |
| | | ⑧ 24" WHITE (STOP BAR) |
| | | ⑨ 4" DOUBLE YELLOW (SOLID) @11" C-C |
| | | ⑩ LETTERS & SYMBOLS |



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PLOT DATE = 9/9/2022 - 12:16:41 PM	DATE - 09/09/2022	REVISED -

**STATE OF ILLINOIS
 DEPARTMENT OF TRANSPORTATION**

**SUGGESTED SEQUENCE OF CONSTRUCTION
 LARAWAY RD - STAGE 2D**



SCALE: 1"=20' SHEET 3 OF 4 SHEETS STA. 173+00 TO STA. 183+00

F.A.U. RTE.	SECTION	COUNTY	TOTAL SHEETS	SHEET NO.
0320	13-00138-37-PV	WILL	413	157
CONTRACT NO. 61H20				
ILLINOIS FED. AID PROJECT				



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PLOT DATE = 9/9/2022 (12:16:43 PM)

USER NAME = Mike Moses
DIRECTORY = L:\MILL\017204-01\Draw\CADD_Sheets

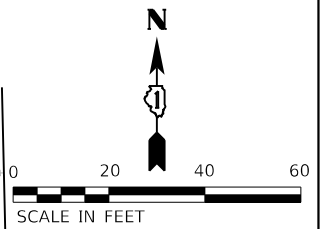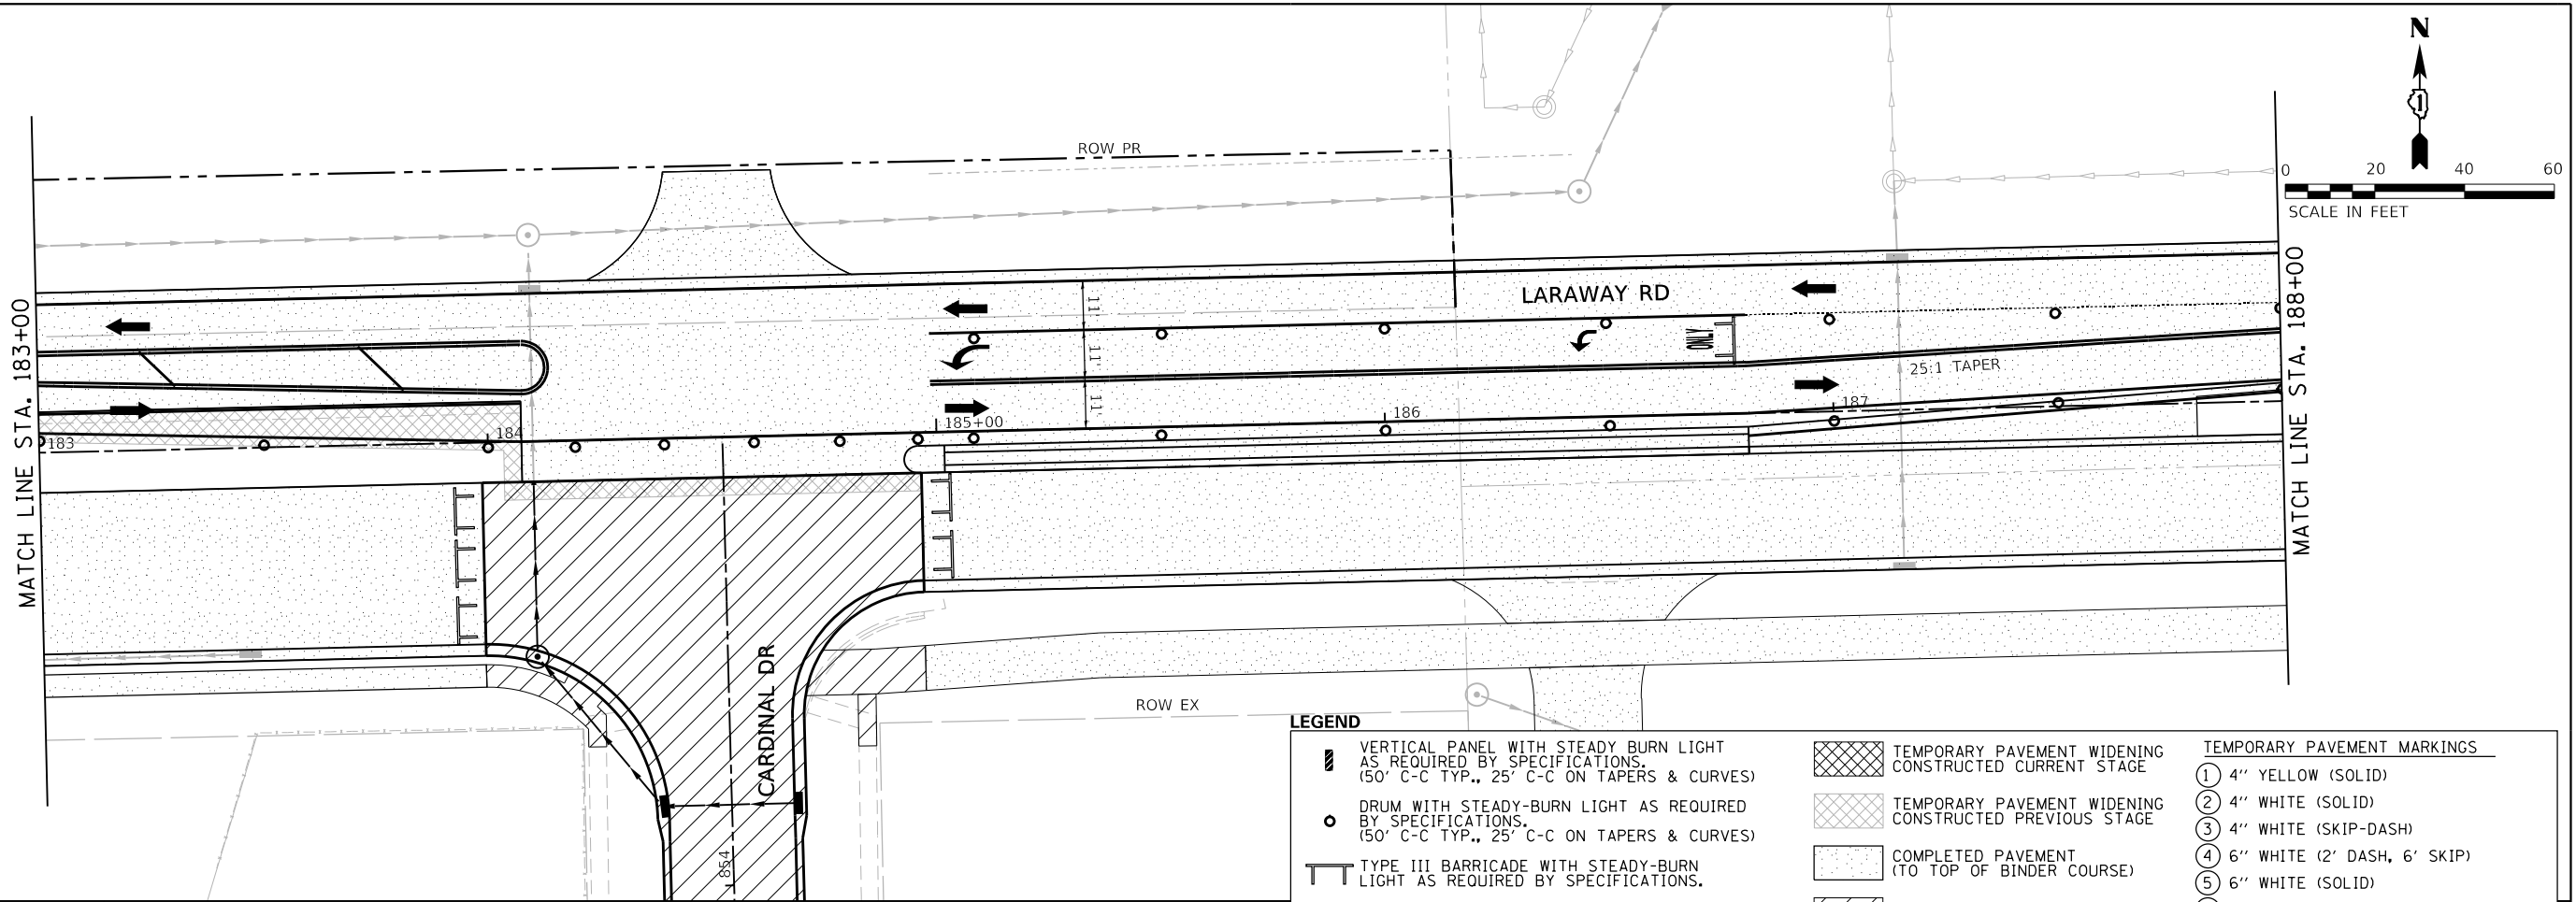

LEGEND		TEMPORARY PAVEMENT MARKINGS
	VERTICAL PANEL WITH STEADY BURN LIGHT AS REQUIRED BY SPECIFICATIONS. (50' C-C TYP., 25' C-C ON TAPERS & CURVES)	① 4" YELLOW (SOLID)
	DRUM WITH STEADY-BURN LIGHT AS REQUIRED BY SPECIFICATIONS. (50' C-C TYP., 25' C-C ON TAPERS & CURVES)	② 4" WHITE (SOLID)
	TYPE III BARRICADE WITH STEADY-BURN LIGHT AS REQUIRED BY SPECIFICATIONS.	③ 4" WHITE (SKIP-DASH)
	TEMPORARY CONCRETE BARRIER WITH TYPE C REFLECTOR	④ 6" WHITE (2' DASH, 6' SKIP)
	DIRECTION OF TRAFFIC	⑤ 6" WHITE (SOLID)
	STORM SEWER CONSTRUCTED THIS STAGE	⑥ 12" YELLOW (DIAGONALS) 30' C-C @45°
	STORM SEWER CONSTRUCTED PREVIOUS STAGE	⑦ 12" WHITE (DIAGONALS)
	TEMPORARY PAVEMENT WIDENING CONSTRUCTED CURRENT STAGE	⑧ 24" WHITE (STOP BAR)
	TEMPORARY PAVEMENT WIDENING CONSTRUCTED PREVIOUS STAGE	⑨ 4" DOUBLE YELLOW (SOLID) @11" C-C
	COMPLETED PAVEMENT (TO TOP OF BINDER COURSE)	⑩ LETTERS & SYMBOLS
	WORK ZONE	
	PAVEMENT PATCHING CLASS D (SEE PVMT PATCH DETAIL SHEETS)	
	TEMPORARY ACCESS	

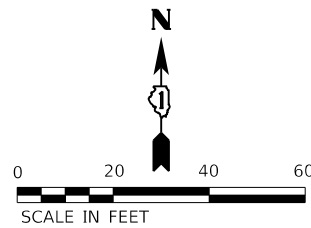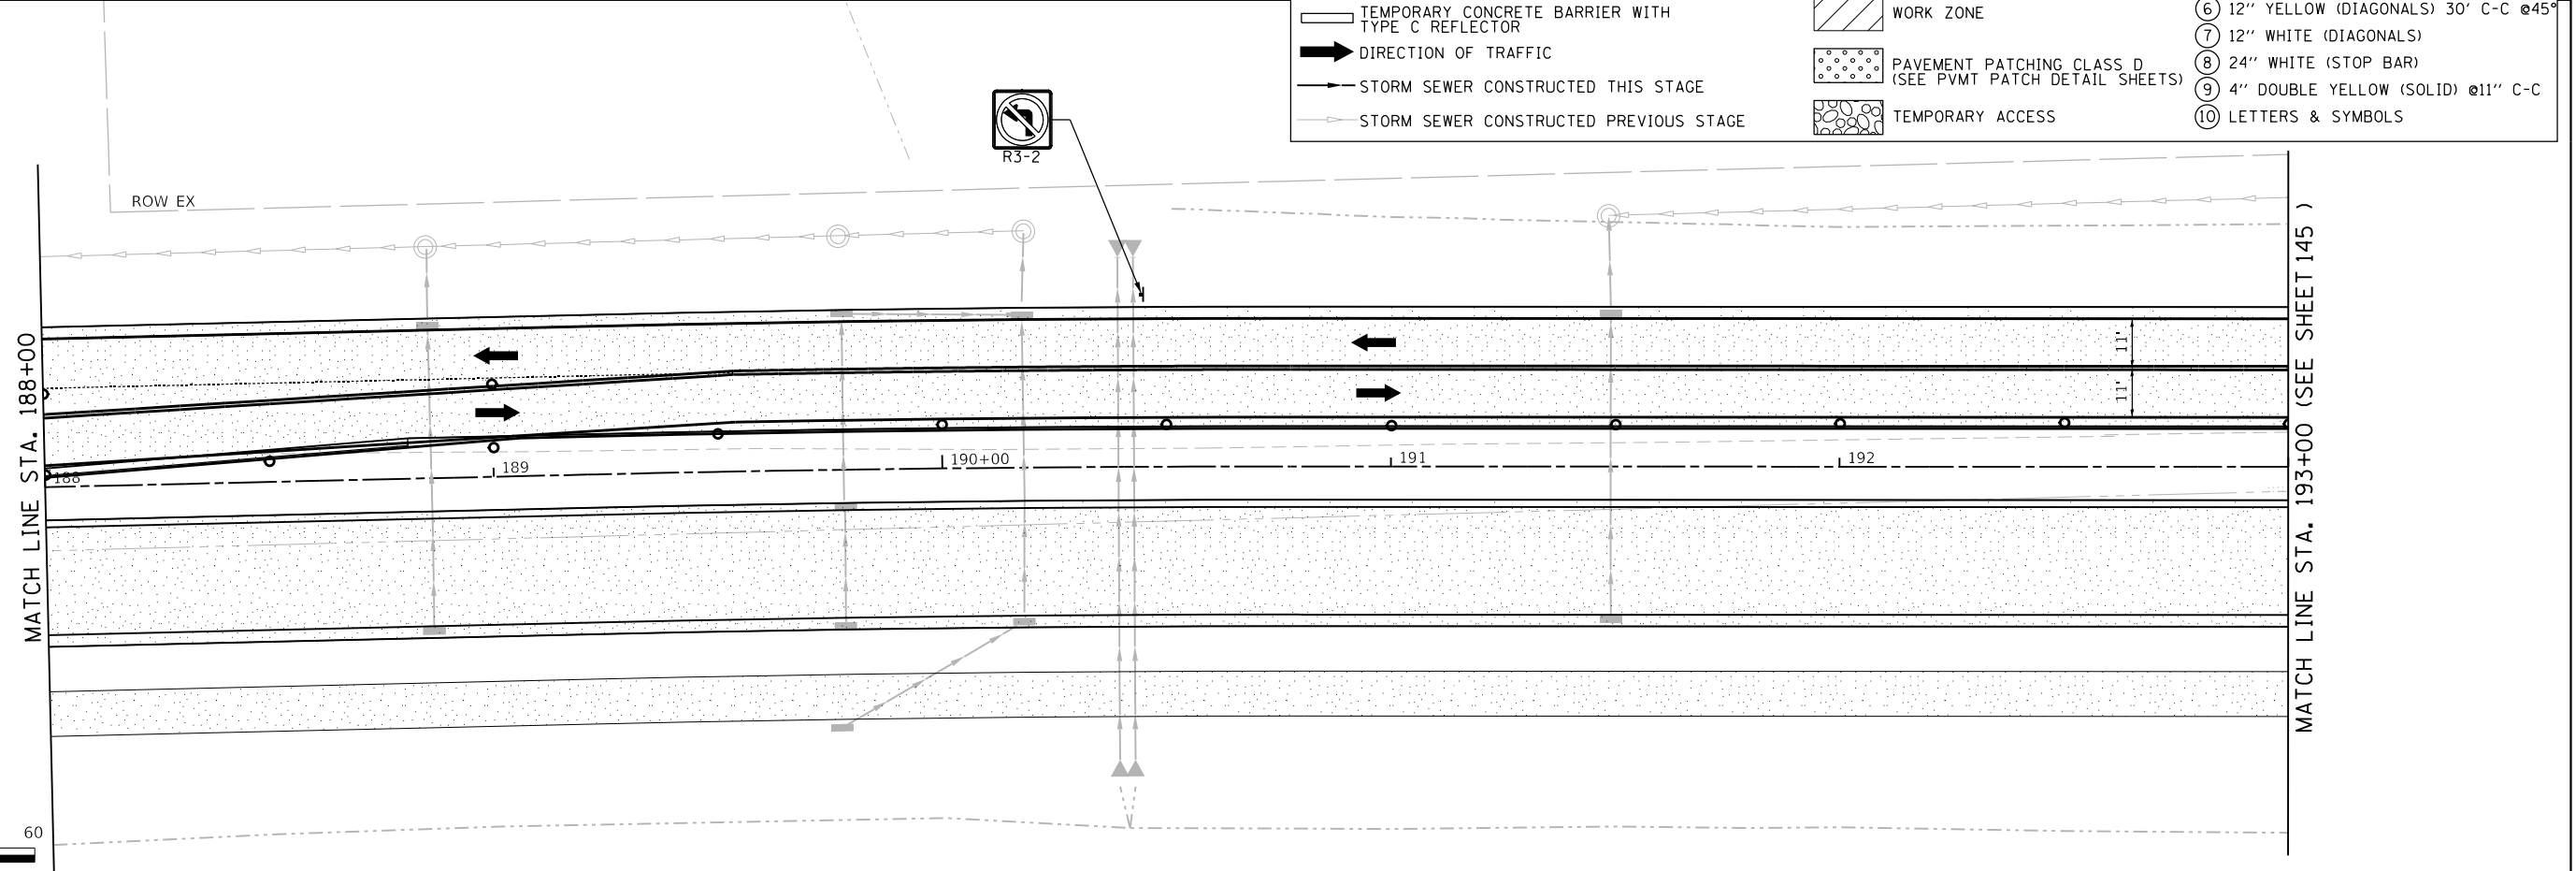

FILE NAME = sht-staging-stage02D-06.dgn	DESIGNED - PML	REVISED -
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PLOT DATE = 9/9/2022 - 12:16:43 PM	DATE - 09/09/2022	REVISED -

STATE OF ILLINOIS
DEPARTMENT OF TRANSPORTATION

SUGGESTED SEQUENCE OF CONSTRUCTION
LARAWAY RD - STAGE 2D




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F.A.U. RTE.	SECTION	COUNTY	TOTAL SHEETS	SHEET NO.
0320	13-00138-37-PV	WILL	413	158
CONTRACT NO. 61H20				
ILLINOIS FED. AID PROJECT				

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STATE OF ILLINOIS
DEPARTMENT OF TRANSPORTATION

SUGGESTED SEQUENCE OF CONSTRUCTION
NELSON RD - STAGE 2D

SCALE: 1"=20'

SHEET 1 OF 1 SHEETS STA. 751+00 TO STA. 765+00

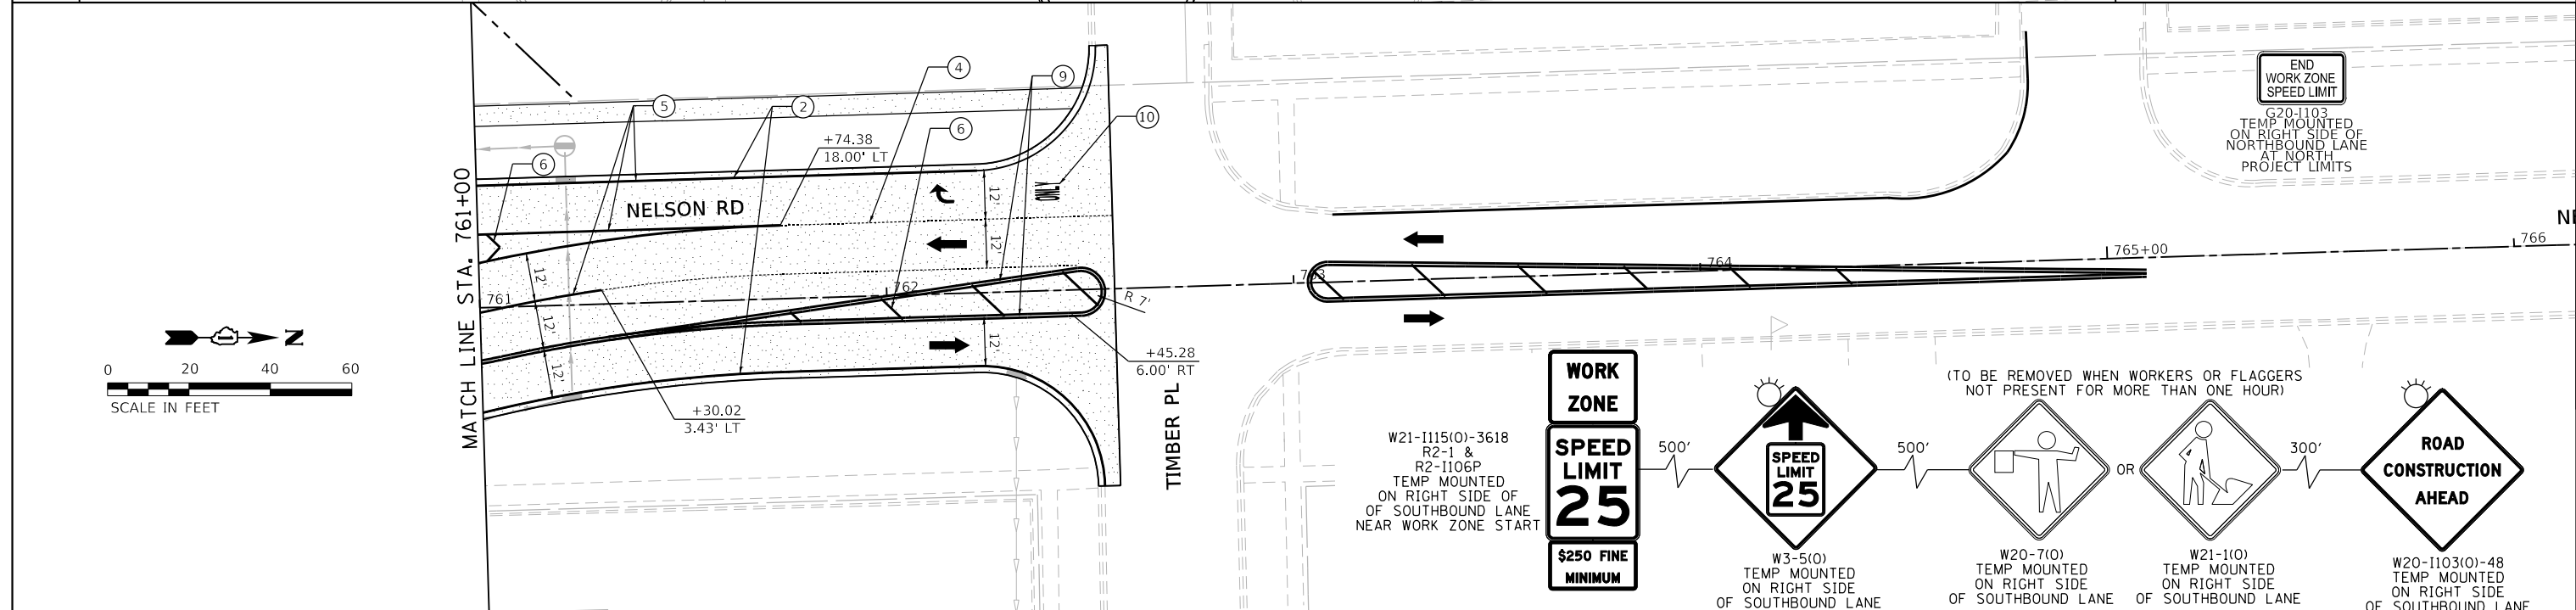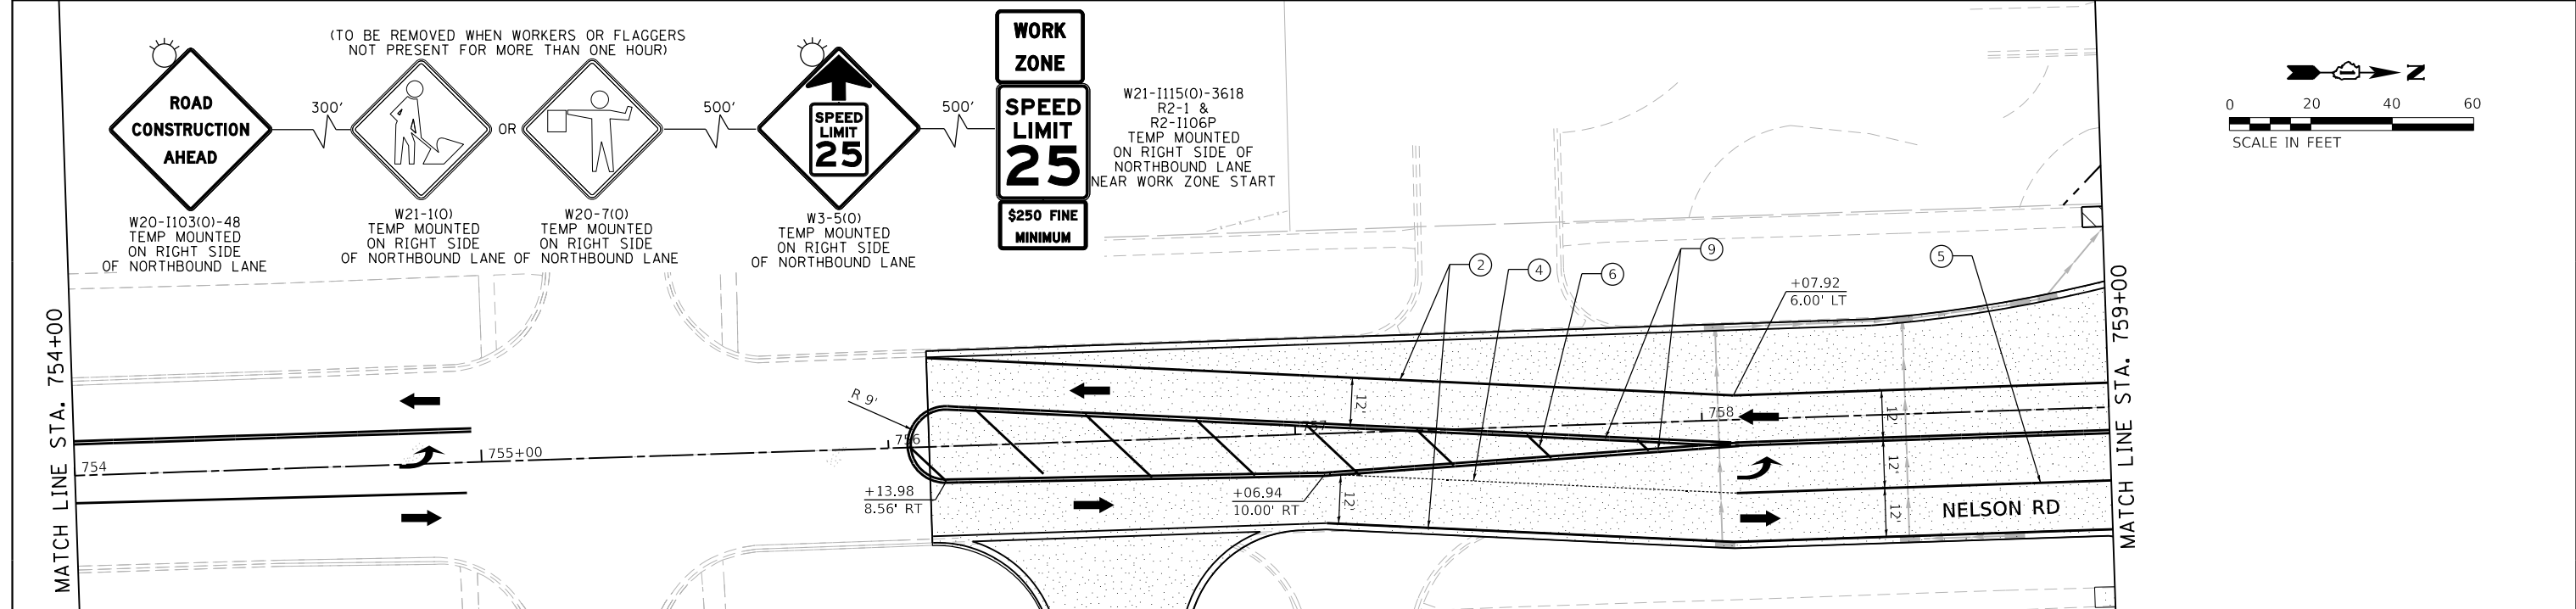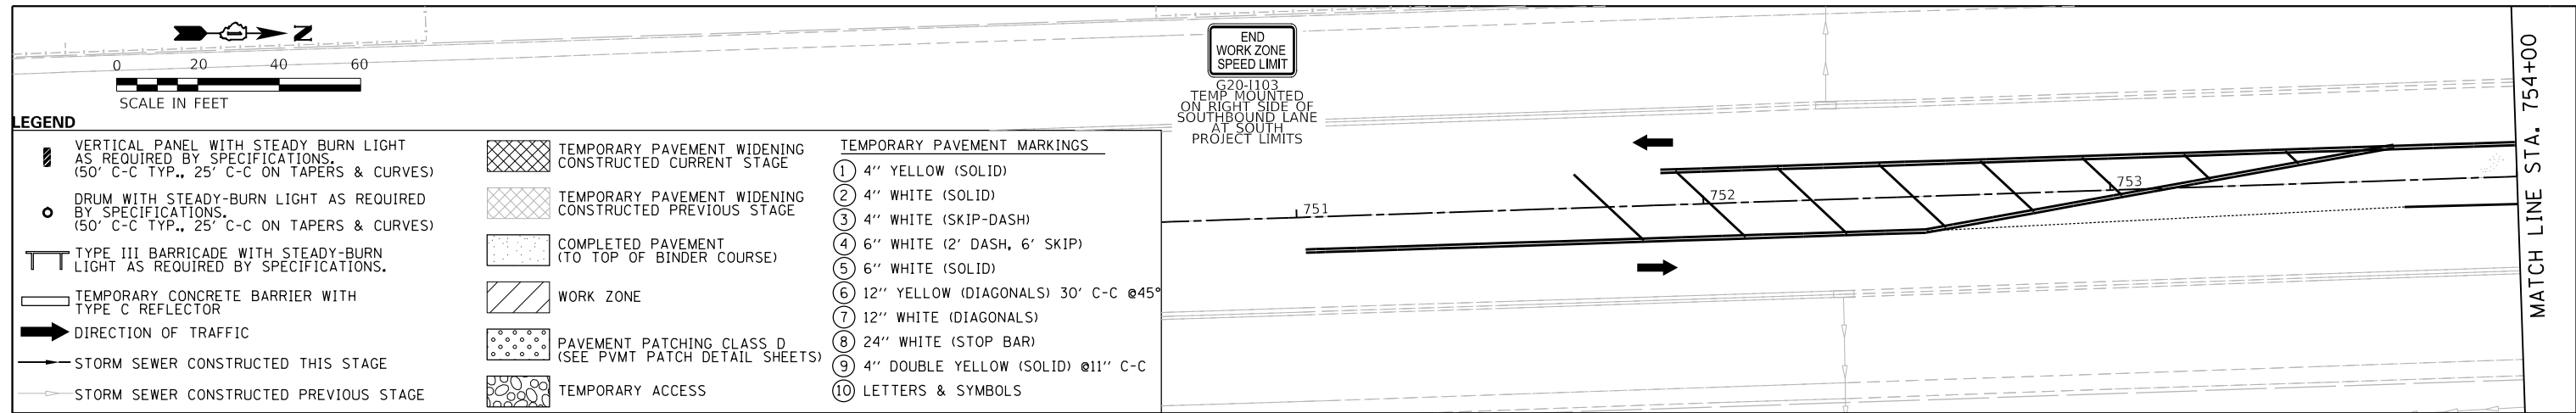
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0320	13-00138-37-PV	WILL	413	159

CONTRACT NO. 61H20


ILLINOIS FED. AID PROJECT




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STAGE 3 TYPICAL SECTION
STA 136+10 TO 142+12.80

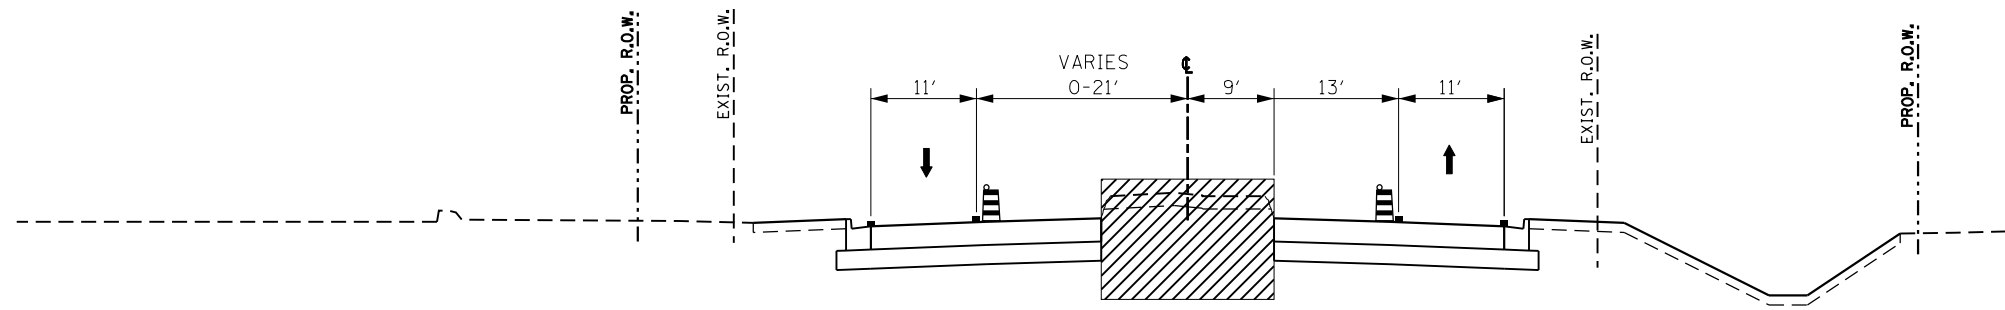

STAGE 3 TYPICAL SECTION
STA 142+12.80 TO 153+10.20

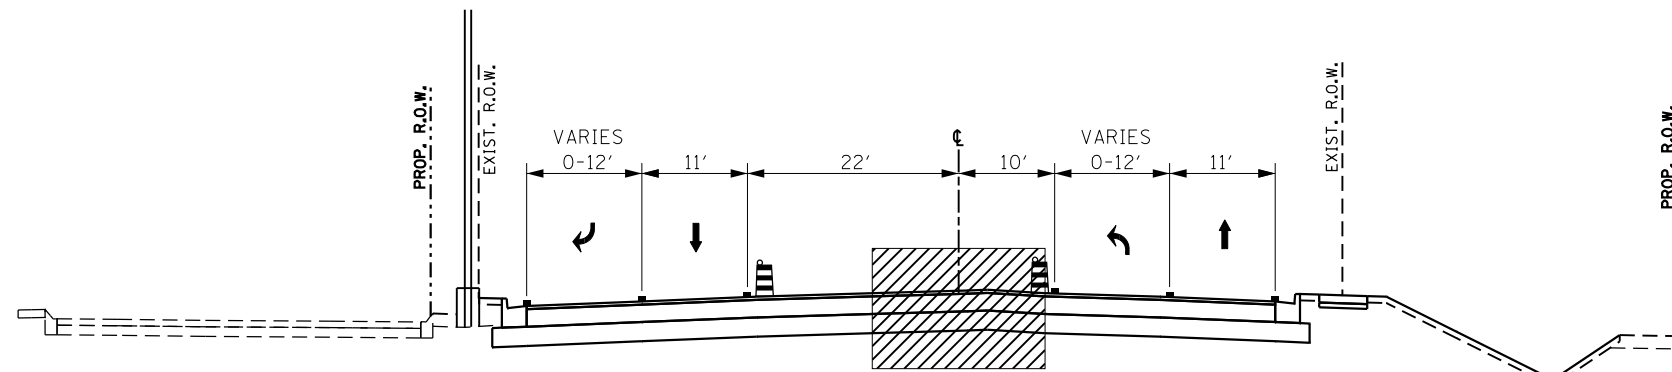

STAGE 3 TYPICAL SECTION
STA 156+75 TO 160+66.81

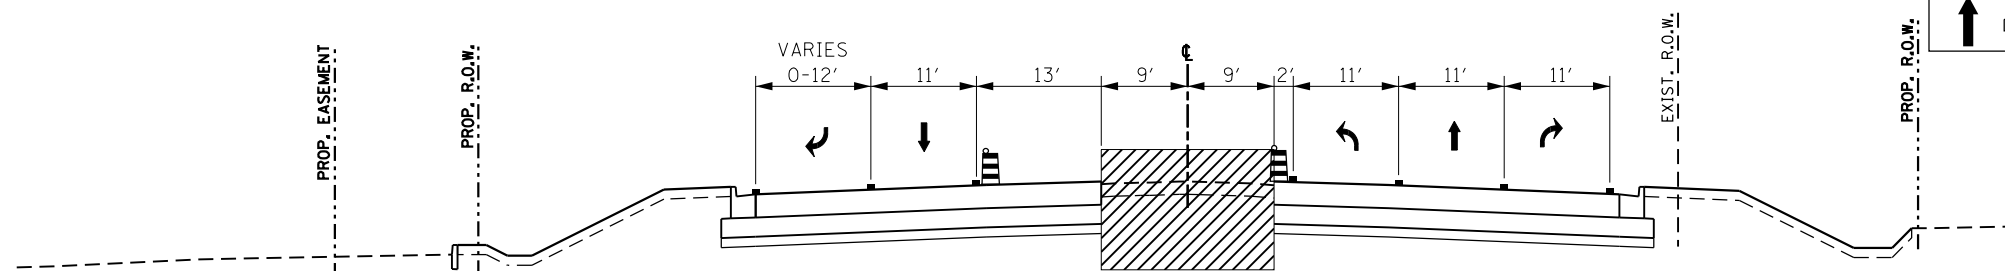LEGEND	
	TEMPORARY PAVEMENT MARKING LINE
	VERTICAL PANEL WITH STEADY BURN LIGHT AS REQUIRED BY SPECIFICATIONS, (50' C-C TYP., 25' C-C ON TAPERS & CURVES)
	DRUM WITH STEADY-BURN LIGHT AS REQUIRED BY SPECIFICATIONS, (50' C-C TYP., 25' C-C ON TAPERS & CURVES)
	TYPE II BARRICADE WITH STEADY-BURN LIGHT AS REQUIRED BY SPECIFICATIONS, (50' C-C TYP., 25' C-C ON TAPERS & CURVES)
	TEMPORARY CONCRETE BARRIER WITH TYPE C REFLECTORS
	DIRECTION OF TRAFFIC
	TEMPORARY PAVEMENT WIDENING CONSTRUCTED CURRENT STAGE
	TEMPORARY PAVEMENT WIDENING CONSTRUCTED PREVIOUS STAGE
	COMPLETED PAVEMENT
	WORK ZONE



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DESIGNED - PML
DRAWN - PML
CHECKED - JMS
DATE - 09/09/2022

REVISED -
REVISED -
REVISED -
REVISED -

STATE OF ILLINOIS
DEPARTMENT OF TRANSPORTATION

SUGGESTED SEQUENCE OF CONSTRUCTION
STAGE 3 TYPICAL SECTION - LARAWAY RD


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F.A.U. RTE.	SECTION	COUNTY	TOTAL SHEETS	SHEET NO.
0320	13-00138-37-PV	WILL	413	160
CONTRACT NO. 61H20				
ILLINOIS FED. AID PROJECT				


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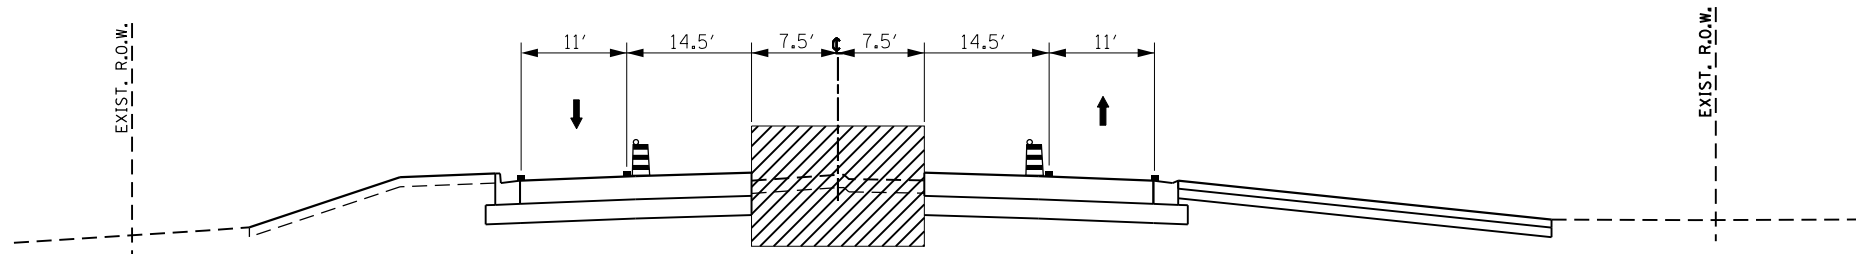
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DIRECTORY = L:\MILLCOIT\7204-01\Drawn\CADD_Sheets



STAGE 3 TYPICAL SECTION
STA 160+66.81 TO 174+44

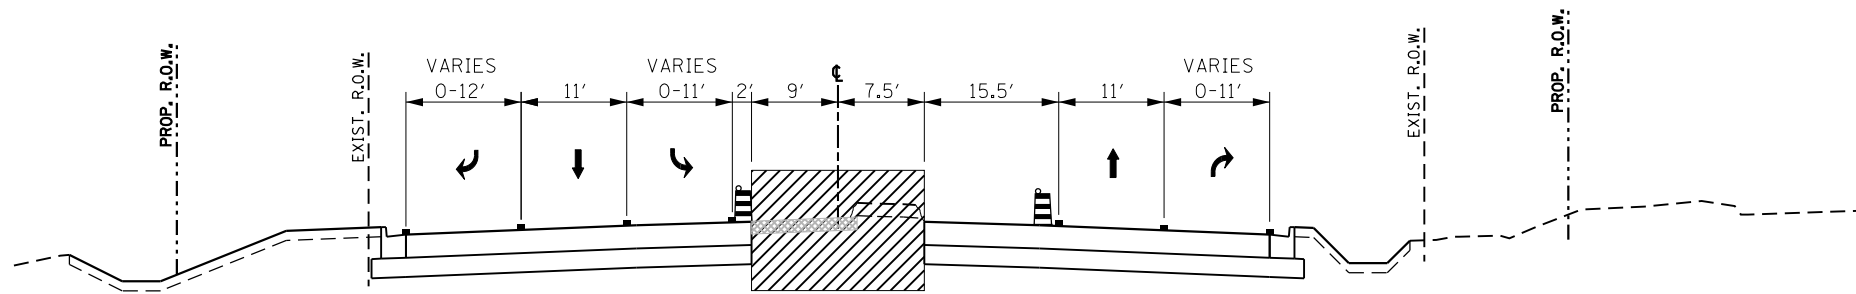

STAGE 3 TYPICAL SECTION
STA 174+44 TO 189+54

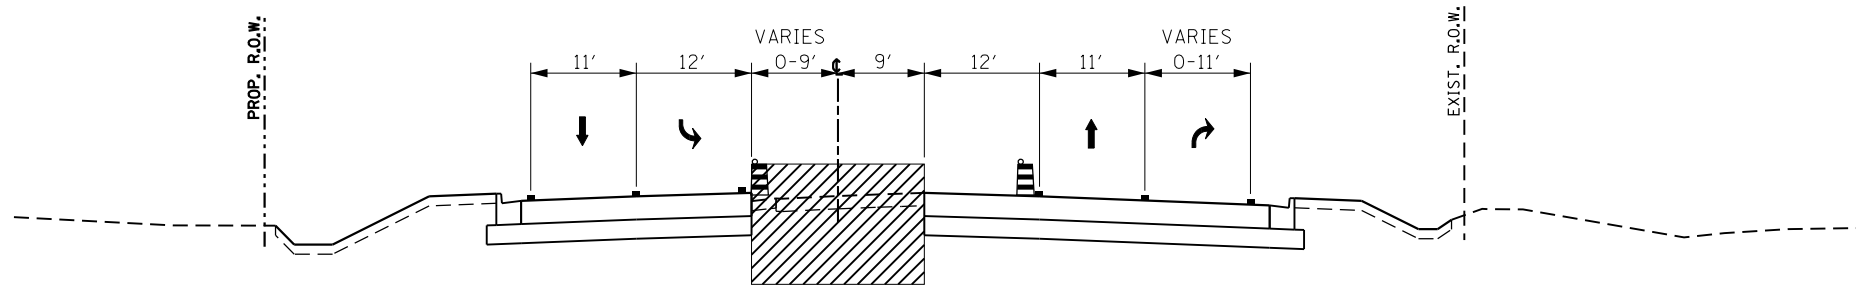

STAGE 3 TYPICAL SECTION
STA 189+54 TO 206+00

LEGEND

- TEMPORARY PAVEMENT MARKING LINE
- ⏏ VERTICAL PANEL WITH STEADY BURN LIGHT AS REQUIRED BY SPECIFICATIONS. (50' C-C TYP., 25' C-C ON TAPERS & CURVES)
- ⏏ DRUM WITH STEADY-BURN LIGHT AS REQUIRED BY SPECIFICATIONS. (50' C-C TYP., 25' C-C ON TAPERS & CURVES)
- ⏏ TYPE II BARRICADE WITH STEADY-BURN LIGHT AS REQUIRED BY SPECIFICATIONS. (50' C-C TYP., 25' C-C ON TAPERS & CURVES)
- ⏏ TEMPORARY CONCRETE BARRIER WITH TYPE C REFLECTORS
- ↑ DIRECTION OF TRAFFIC
- ▨ TEMPORARY PAVEMENT WIDENING CONSTRUCTED CURRENT STAGE
- ▨ TEMPORARY PAVEMENT WIDENING CONSTRUCTED PREVIOUS STAGE
- ▨ COMPLETED PAVEMENT
- ▨ WORK ZONE





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STATE OF ILLINOIS
DEPARTMENT OF TRANSPORTATION

SUGGESTED SEQUENCE OF CONSTRUCTION
STAGE 3 TYPICAL SECTION - LARAWAY RD

SCALE: SHEET 2 OF 4 SHEETS STA. TO STA.

F.A.U. RTE.	SECTION	COUNTY	TOTAL SHEETS	SHEET NO.
0320	13-00138-37-PV	WILL	413	161
CONTRACT NO. 61H20				
		ILLINOIS	FED. AID PROJECT	

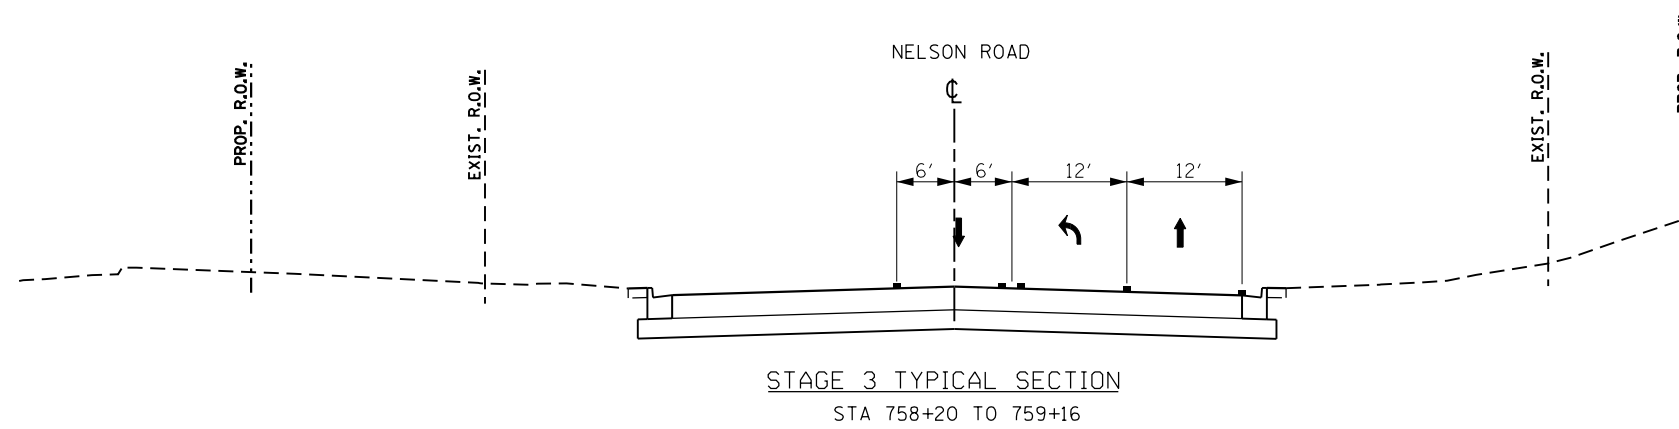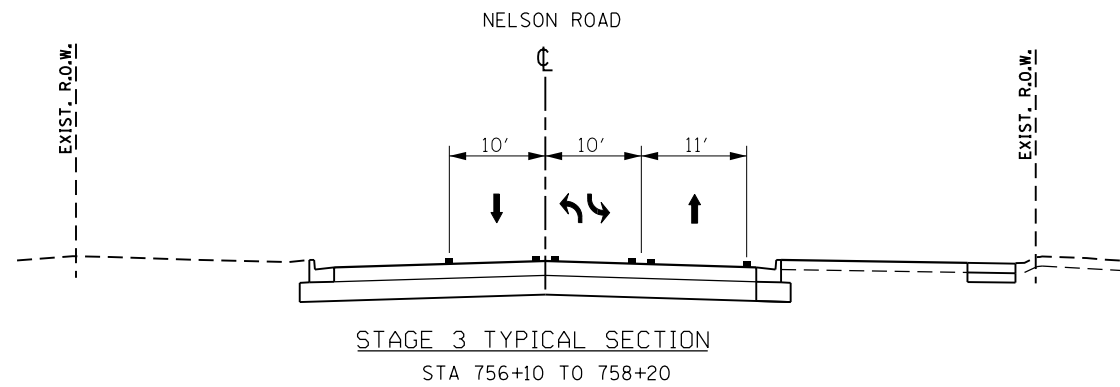

LEGEND

	TEMPORARY PAVEMENT MARKING LINE		TEMPORARY PAVEMENT WIDENING CONSTRUCTED CURRENT STAGE
	VERTICAL PANEL WITH STEADY BURN LIGHT AS REQUIRED BY SPECIFICATIONS. (50' C-C TYP., 25' C-C ON TAPERS & CURVES)		TEMPORARY PAVEMENT WIDENING CONSTRUCTED PREVIOUS STAGE
	DRUM WITH STEADY-BURN LIGHT AS REQUIRED BY SPECIFICATIONS. (50' C-C TYP., 25' C-C ON TAPERS & CURVES)		COMPLETED PAVEMENT
	TYPE II BARRICADE WITH STEADY-BURN LIGHT AS REQUIRED BY SPECIFICATIONS. (50' C-C TYP., 25' C-C ON TAPERS & CURVES)		WORK ZONE
	TEMPORARY CONCRETE BARRIER WITH TYPE C REFLECTORS		
	DIRECTION OF TRAFFIC		



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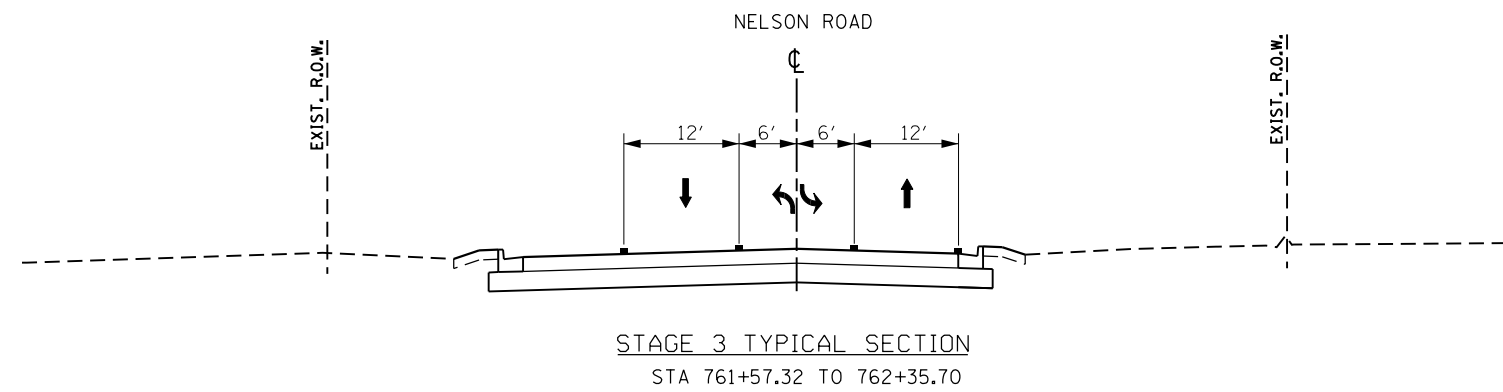
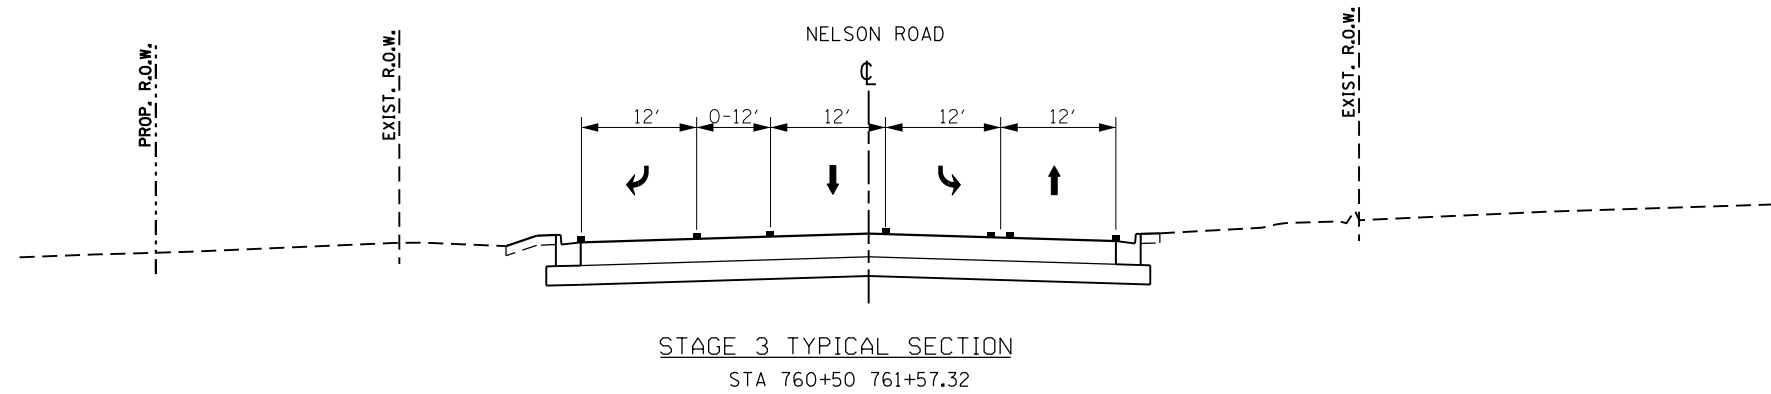
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PLOT DATE = 9/9/2022 12:16:47 PM	DATE - 09/09/2022	REVISED -

STATE OF ILLINOIS
DEPARTMENT OF TRANSPORTATION

SUGGESTED SEQUENCE OF CONSTRUCTION
STAGE 3 TYPICAL SECTION - NELSON RD

SCALE: SHEET 3 OF 4 SHEETS STA. TO STA.

F.A.U. RTE.	SECTION	COUNTY	TOTAL SHEETS	SHEET NO.
0320	13-00138-37-PV	WILL	413	162
CONTRACT NO. 61H20				
ILLINOIS		FED. AID PROJECT		



LEGEND

	TEMPORARY PAVEMENT MARKING LINE		TEMPORARY PAVEMENT WIDENING CONSTRUCTED CURRENT STAGE
	VERTICAL PANEL WITH STEADY BURN LIGHT AS REQUIRED BY SPECIFICATIONS. (50' C-C TYP., 25' C-C ON TAPERS & CURVES)		TEMPORARY PAVEMENT WIDENING CONSTRUCTED PREVIOUS STAGE
	DRUM WITH STEADY-BURN LIGHT AS REQUIRED BY SPECIFICATIONS. (50' C-C TYP., 25' C-C ON TAPERS & CURVES)		COMPLETED PAVEMENT
	TYPE II BARRICADE WITH STEADY-BURN LIGHT AS REQUIRED BY SPECIFICATIONS. (50' C-C TYP., 25' C-C ON TAPERS & CURVES)		WORK ZONE
	TEMPORARY CONCRETE BARRIER WITH TYPE C REFLECTORS		
	DIRECTION OF TRAFFIC		



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STATE OF ILLINOIS
DEPARTMENT OF TRANSPORTATION

**SUGGESTED SEQUENCE OF CONSTRUCTION
STAGE 3 TYPICAL SECTION - NELSON RD**

SCALE: SHEET 4 OF 4 SHEETS STA. TO STA.

F.A.U. RTE.	SECTION	COUNTY	TOTAL SHEETS	SHEET NO.
0320	13-00138-37-PV	WILL	413	163
CONTRACT NO. 61H20				
		ILLINOIS	FED. AID PROJECT	



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PLOT SCALE
PLOT DATE
= 40.0001' / in.
= 9/9/2022 (12:16:53 PM)

USER NAME
DIRECTORY
= Mike Moses
= L:\MILL\COIT\704-01\Drawn\CADD_Sheets\

LEGEND

	VERTICAL PANEL WITH STEADY BURN LIGHT AS REQUIRED BY SPECIFICATIONS. (50' C-C TYP., 25' C-C ON TAPERS & CURVES)		TEMPORARY PAVEMENT WIDENING CONSTRUCTED CURRENT STAGE	TEMPORARY PAVEMENT MARKINGS	
	DRUM WITH STEADY-BURN LIGHT AS REQUIRED BY SPECIFICATIONS. (50' C-C TYP., 25' C-C ON TAPERS & CURVES)		TEMPORARY PAVEMENT WIDENING CONSTRUCTED PREVIOUS STAGE	①	4" YELLOW (SOLID)
	TYPE III BARRICADE WITH STEADY-BURN LIGHT AS REQUIRED BY SPECIFICATIONS.		COMPLETED PAVEMENT (TO TOP OF BINDER COURSE)	②	4" WHITE (SOLID)
	TEMPORARY CONCRETE BARRIER WITH TYPE C REFLECTOR		WORK ZONE	③	4" WHITE (SKIP-DASH)
	DIRECTION OF TRAFFIC		PAVEMENT PATCHING CLASS D (SEE PVMT PATCH DETAIL SHEETS)	④	6" WHITE (2' DASH, 6' SKIP)
	STORM SEWER CONSTRUCTED THIS STAGE		TEMPORARY ACCESS	⑤	6" WHITE (SOLID)
	STORM SEWER CONSTRUCTED PREVIOUS STAGE			⑥	12" YELLOW (DIAGONALS) 30' C-C @45°
				⑦	12" WHITE (DIAGONALS)
				⑧	24" WHITE (STOP BAR)
				⑨	4" DOUBLE YELLOW (SOLID) @11" C-C
				⑩	LETTERS & SYMBOLS

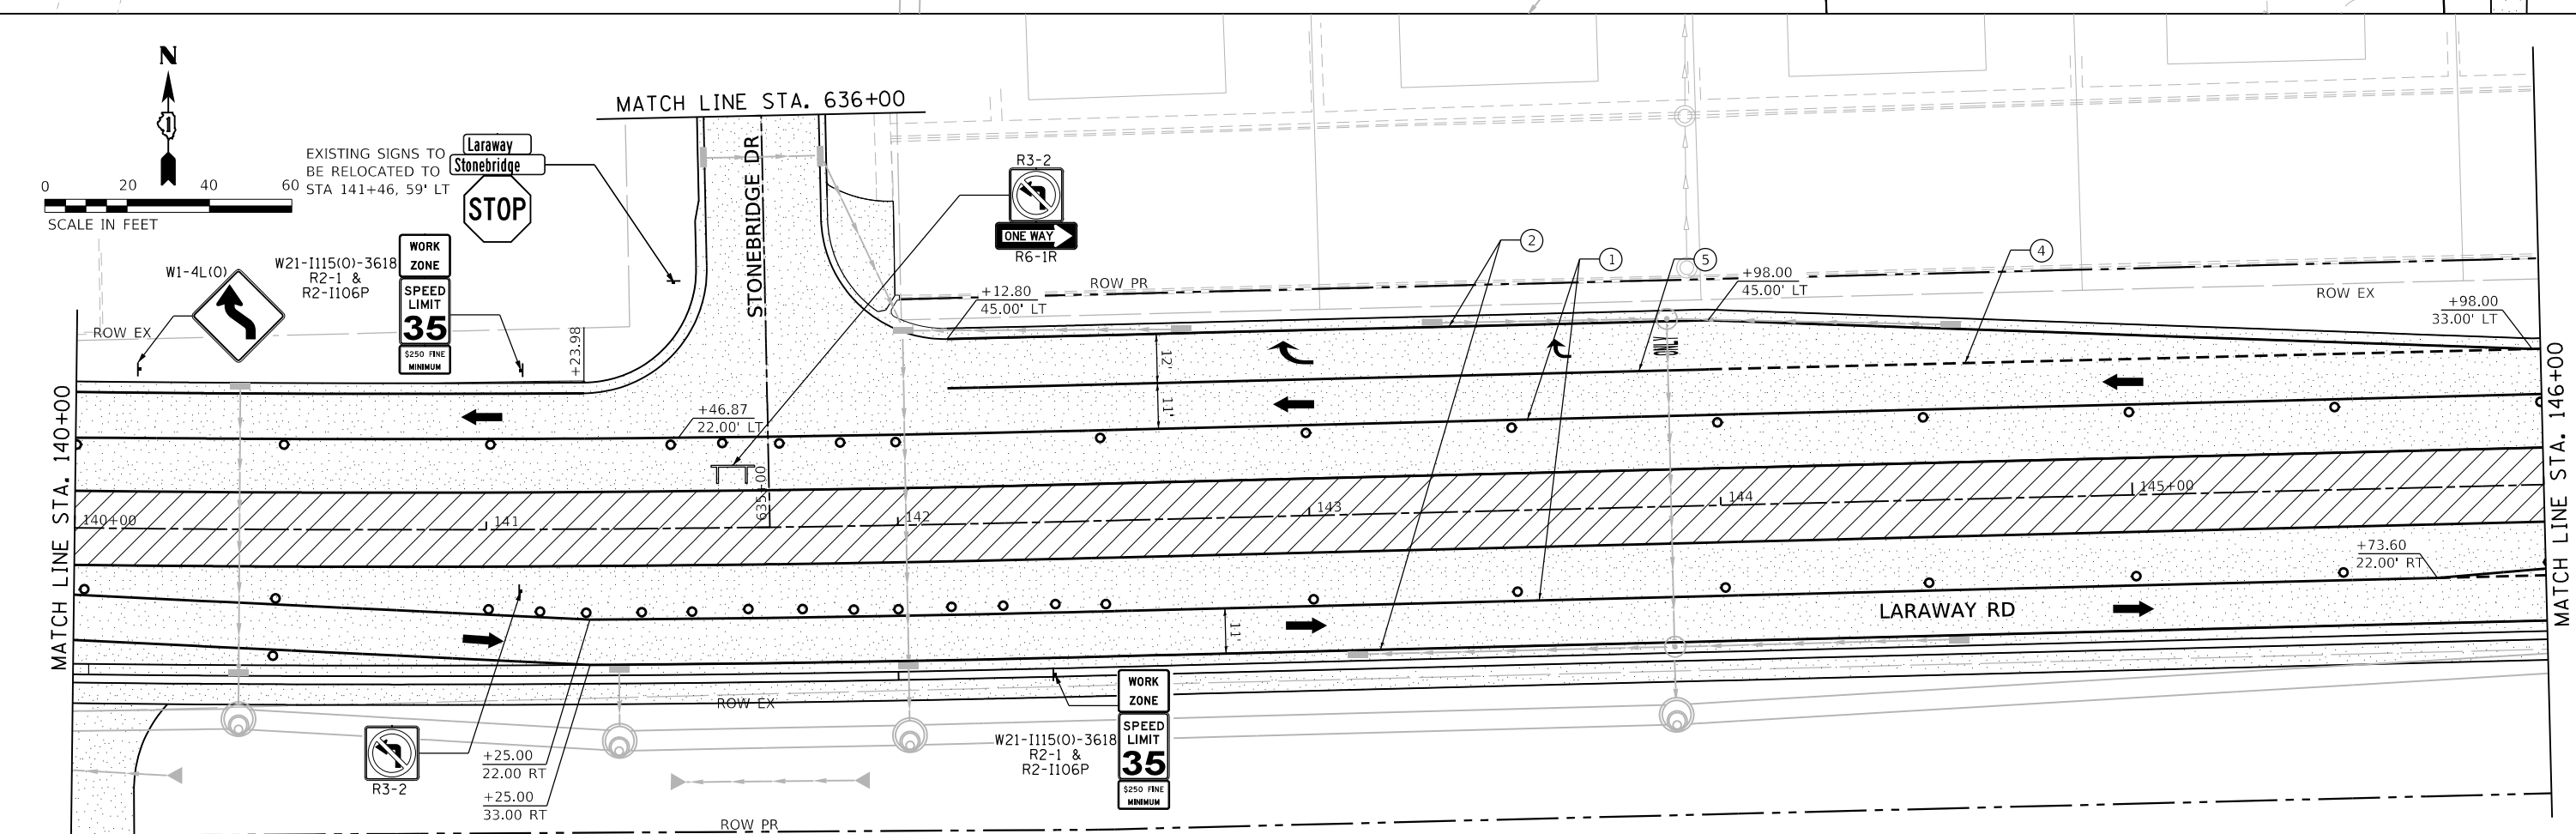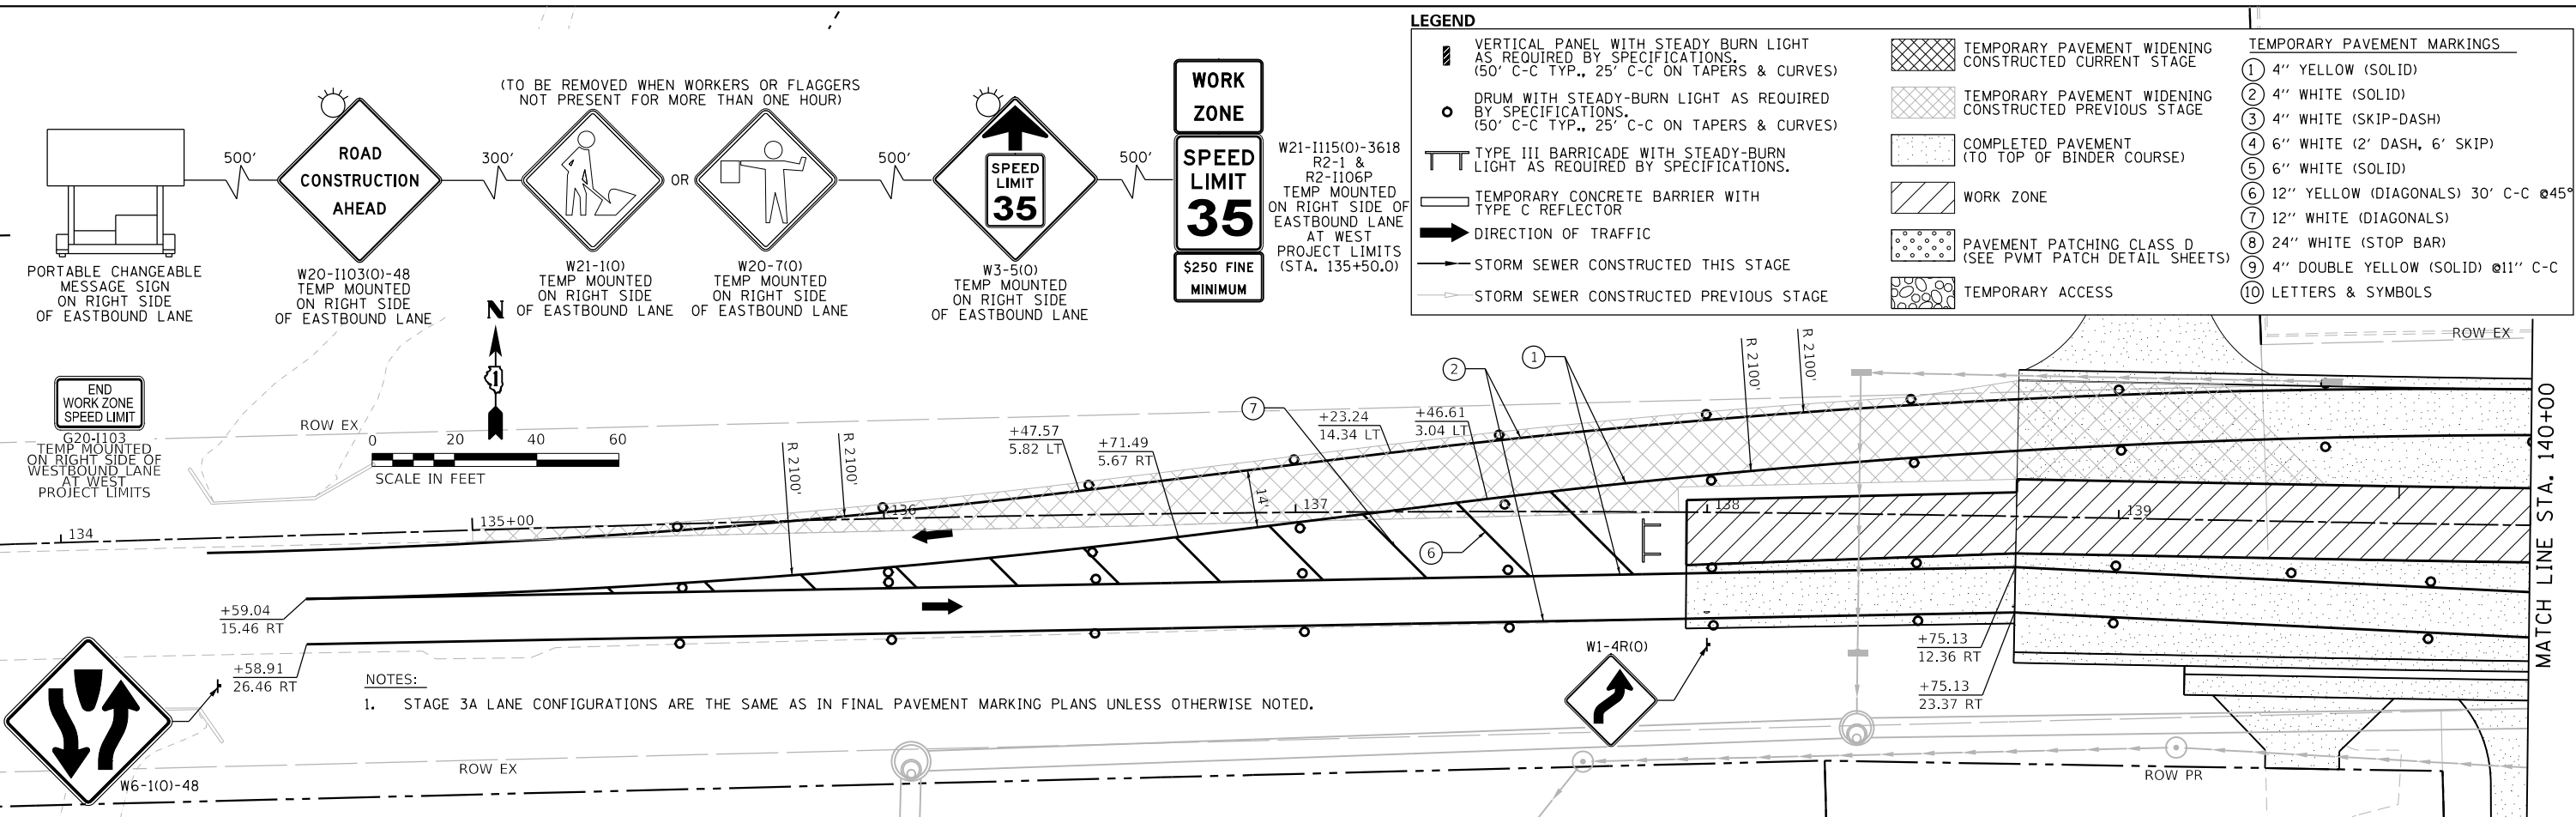


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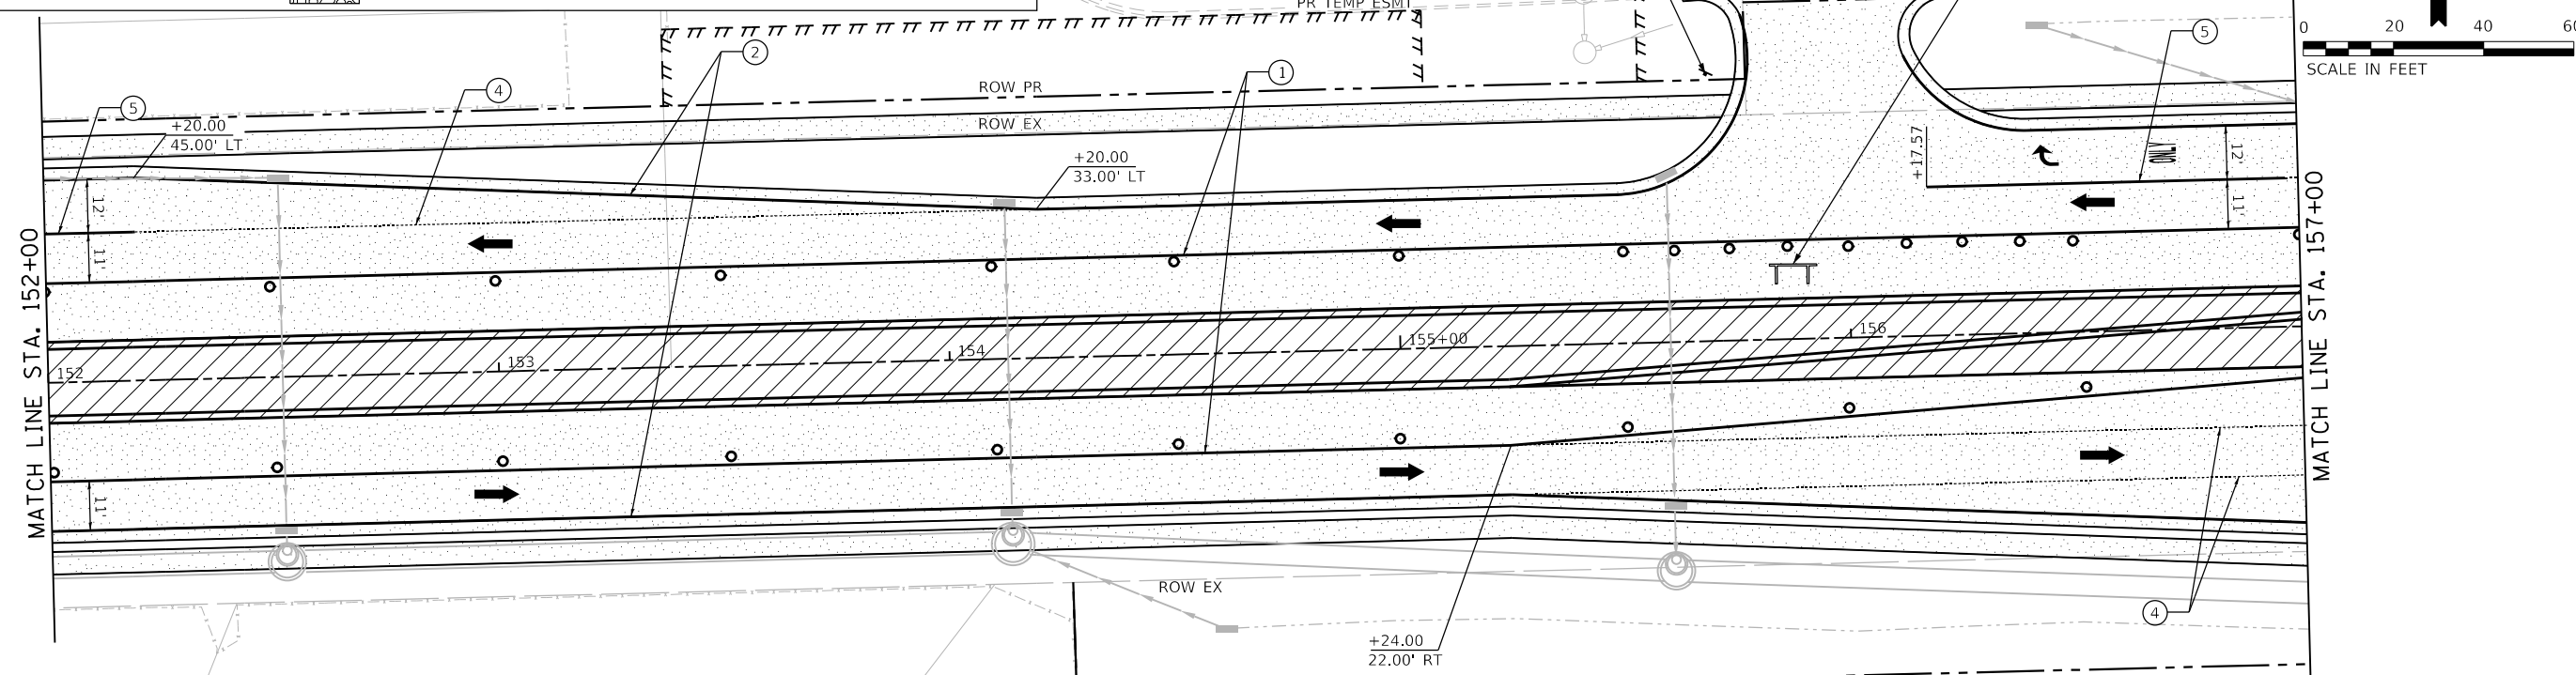
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PLOT DATE = 9/9/2022 (12:16:55 PM)

USER NAME = Mike Moses
DIRECTORY = L:\MILL\COIT\7204-01\Draw\CADD_Sheets\



LEGEND

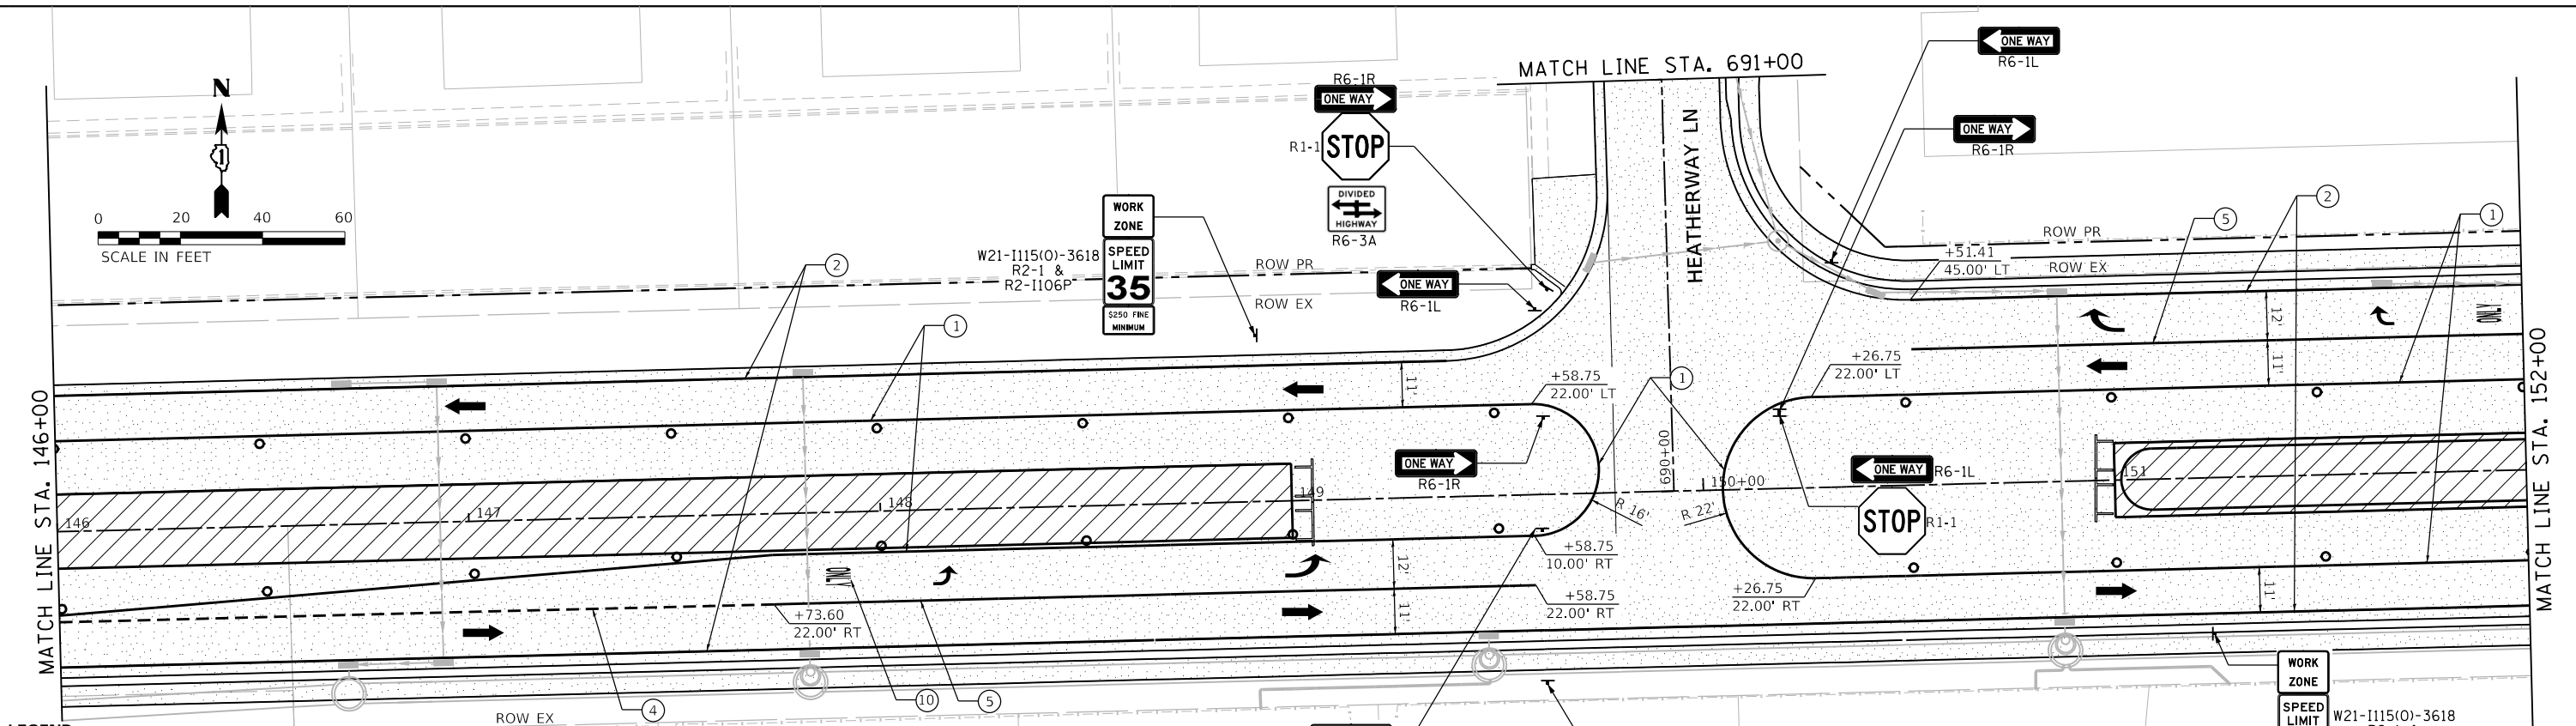	VERTICAL PANEL WITH STEADY BURN LIGHT AS REQUIRED BY SPECIFICATIONS. (50' C-C TYP., 25' C-C ON TAPERS & CURVES)		TEMPORARY PAVEMENT WIDENING CONSTRUCTED CURRENT STAGE	TEMPORARY PAVEMENT MARKINGS
	DRUM WITH STEADY-BURN LIGHT AS REQUIRED BY SPECIFICATIONS. (50' C-C TYP., 25' C-C ON TAPERS & CURVES)		TEMPORARY PAVEMENT WIDENING CONSTRUCTED PREVIOUS STAGE	① 4" YELLOW (SOLID)
	TYPE III BARRICADE WITH STEADY-BURN LIGHT AS REQUIRED BY SPECIFICATIONS.		COMPLETED PAVEMENT (TO TOP OF BINDER COURSE)	② 4" WHITE (SOLID)
	TEMPORARY CONCRETE BARRIER WITH TYPE C REFLECTOR		WORK ZONE	③ 4" WHITE (SKIP-DASH)
	DIRECTION OF TRAFFIC		PAVEMENT PATCHING CLASS D (SEE PVMT PATCH DETAIL SHEETS)	④ 6" WHITE (2' DASH, 6' SKIP)
	STORM SEWER CONSTRUCTED THIS STAGE		TEMPORARY ACCESS	⑤ 6" WHITE (SOLID)
	STORM SEWER CONSTRUCTED PREVIOUS STAGE			⑥ 12" YELLOW (DIAGONALS) 30' C-C @45°
				⑦ 12" WHITE (DIAGONALS)
				⑧ 24" WHITE (STOP BAR)
				⑨ 4" DOUBLE YELLOW (SOLID) @11" C-C
				⑩ LETTERS & SYMBOLS



FILE NAME =	sht-staging-stage03A-02.dgn	DESIGNED -	BRF	REVISED -	
MODEL NAME =	Default	DRAWN -	BRF	REVISED -	
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STATE OF ILLINOIS
DEPARTMENT OF TRANSPORTATION


SUGGESTED SEQUENCE OF CONSTRUCTION
LARAWAY RD - STAGE 3A
SCALE: 1"=20'
SHEET 2 OF 7 SHEETS
STA. 146+00 TO STA. 157+00

F.A.U. RTE.	SECTION	COUNTY	TOTAL SHEETS	SHEET NO.
0320	13-00138-37-PV	WILL	413	165
CONTRACT NO. 61H20				
ILLINOIS FED. AID PROJECT				

PLOT DRIVER
PENTABLE
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= L:\M\LAYERS\Bw\pnt

PLOT SCALE
PLOT DATE
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= 9/9/2022 (12:16:57 PM)


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- PIPELINE STAGING NOTES:**
- CONTRACTOR MUST CONTACT PIPELINE COMPANIES TO COORDINATE ALL WORK IN THE VICINITY OF THE PIPELINES. CONTRACTOR MUST FOLLOW ALL REQUIREMENTS OF THESE PLANS, SPECIFICATIONS, PIPELINE ENCROACHMENT GUIDELINES, AND ANY OTHER REQUIREMENTS COMMUNICATED BY PIPELINE COMPANY REPRESENTATIVES REGARDING WORK AROUND THE PIPELINES.
 - TEMPORARY FENCE SHALL BE REPOSITIONED TO A LOCATION APPROVED BY THE ENGINEER AND THE PIPELINE REPRESENTATIVES TO LIMIT EQUIPMENT CROSSING TO A 15' WIDE OPENING PERPENDICULAR TO PIPELINES. 5' GAP IN FENCE IS PERMITTED TO ALLOW PEDESTRAIN PASSAGE.
 - SEE SHEET 217 FOR ADDITIONAL INFORMATION ON ENTERPRISE PRODUCTS PIPELINE AND SHEET 218 FOR ADDITIONAL INFORMATION OF BP PIPELINES OF AMERICA PIPELINE.

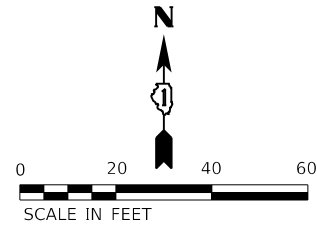BP PIPELINES OF AMERICA
STEVE ADAMS
OFFICE: 779.801.4969
EMAIL: steve.adams@bp.com





ENTERPRISE PRODUCTS
BLAKE HAMILTON
OFFICE: 815.277.7286
CELL: 217.508.2991
EMAIL: bdhamilton@eprod.com



- NOTES:**
- WORK THAT INTERFERES WITH THE NELSON ROAD INTERSECTION WILL NOT COMMENCE UNTIL ALL OTHER STAGE CONSTRUCTION IS COMPLETE. AT THAT TIME, NELSON ROAD SHALL BE CLOSED AND CONFLICTING PAVEMENT SHALL BE CONSTRUCTED IN ONE SINGLE OFF-PEAK ROAD CLOSURE.
 - SEE TEMPORARY TRAFFIC SIGNAL PLANS FOR CROSSWALK CONFIGURATIONS.

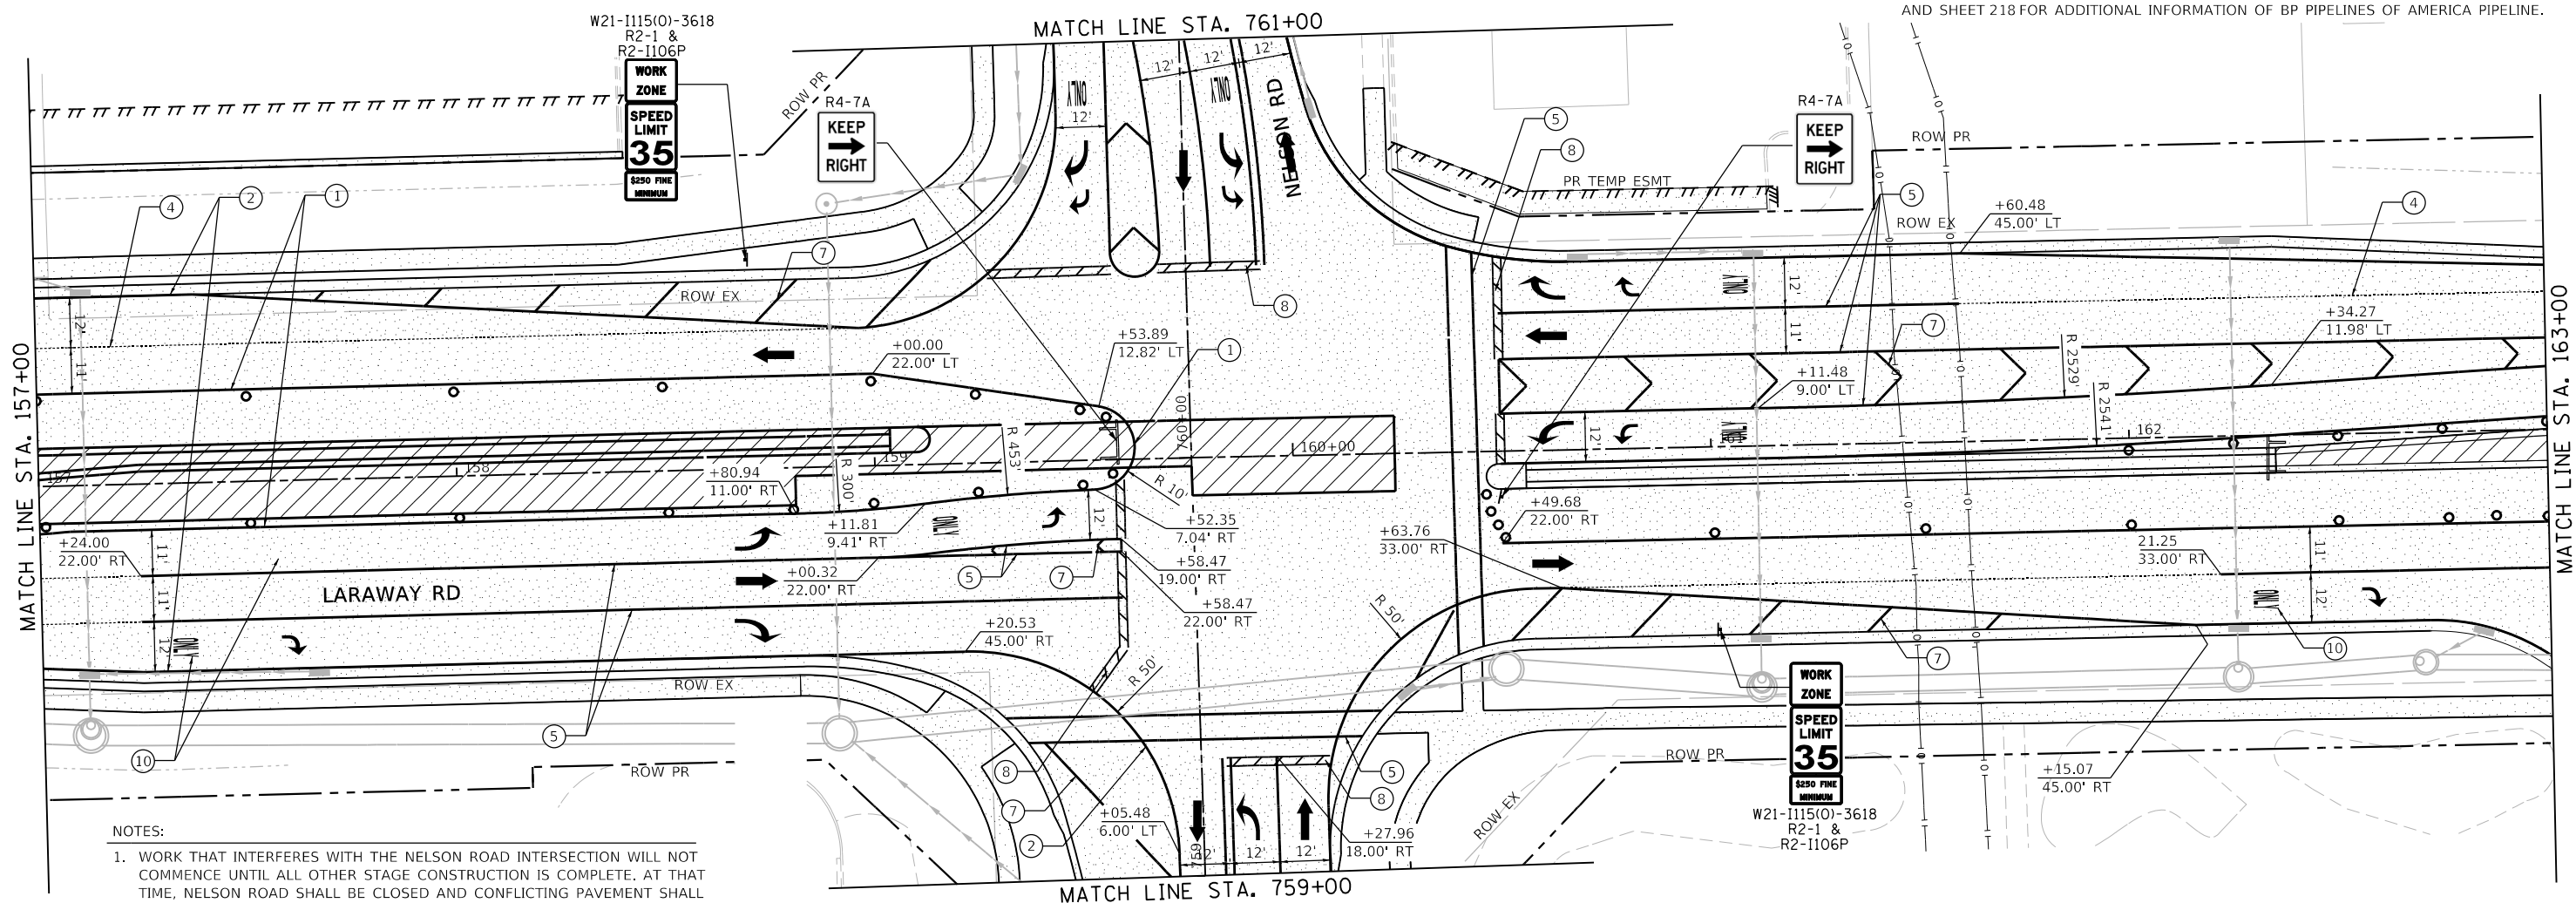LEGEND

	VERTICAL PANEL WITH STEADY BURN LIGHT AS REQUIRED BY SPECIFICATIONS. (50' C-C TYP., 25' C-C ON TAPERS & CURVES)		TEMPORARY PAVEMENT WIDENING CONSTRUCTED CURRENT STAGE	TEMPORARY PAVEMENT MARKINGS
	DRUM WITH STEADY-BURN LIGHT AS REQUIRED BY SPECIFICATIONS. (50' C-C TYP., 25' C-C ON TAPERS & CURVES)		TEMPORARY PAVEMENT WIDENING CONSTRUCTED PREVIOUS STAGE	① 4" YELLOW (SOLID)
	TYPE III BARRICADE WITH STEADY-BURN LIGHT AS REQUIRED BY SPECIFICATIONS.		COMPLETED PAVEMENT (TO TOP OF BINDER COURSE)	② 4" WHITE (SOLID)
	TEMPORARY CONCRETE BARRIER WITH TYPE C REFLECTOR		WORK ZONE	③ 4" WHITE (SKIP-DASH)
	DIRECTION OF TRAFFIC		PAVEMENT PATCHING CLASS D (SEE PVMT PATCH DETAIL SHEETS)	④ 6" WHITE (2' DASH, 6' SKIP)
	STORM SEWER CONSTRUCTED THIS STAGE		TEMPORARY ACCESS	⑤ 6" WHITE (SOLID)
	STORM SEWER CONSTRUCTED PREVIOUS STAGE			⑥ 12" YELLOW (DIAGONALS) 30' C-C @45°
				⑦ 12" WHITE (DIAGONALS)
				⑧ 24" WHITE (STOP BAR)
				⑨ 4" DOUBLE YELLOW (SOLID) @11" C-C
				⑩ LETTERS & SYMBOLS

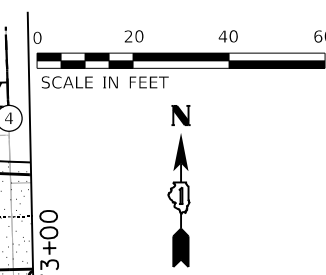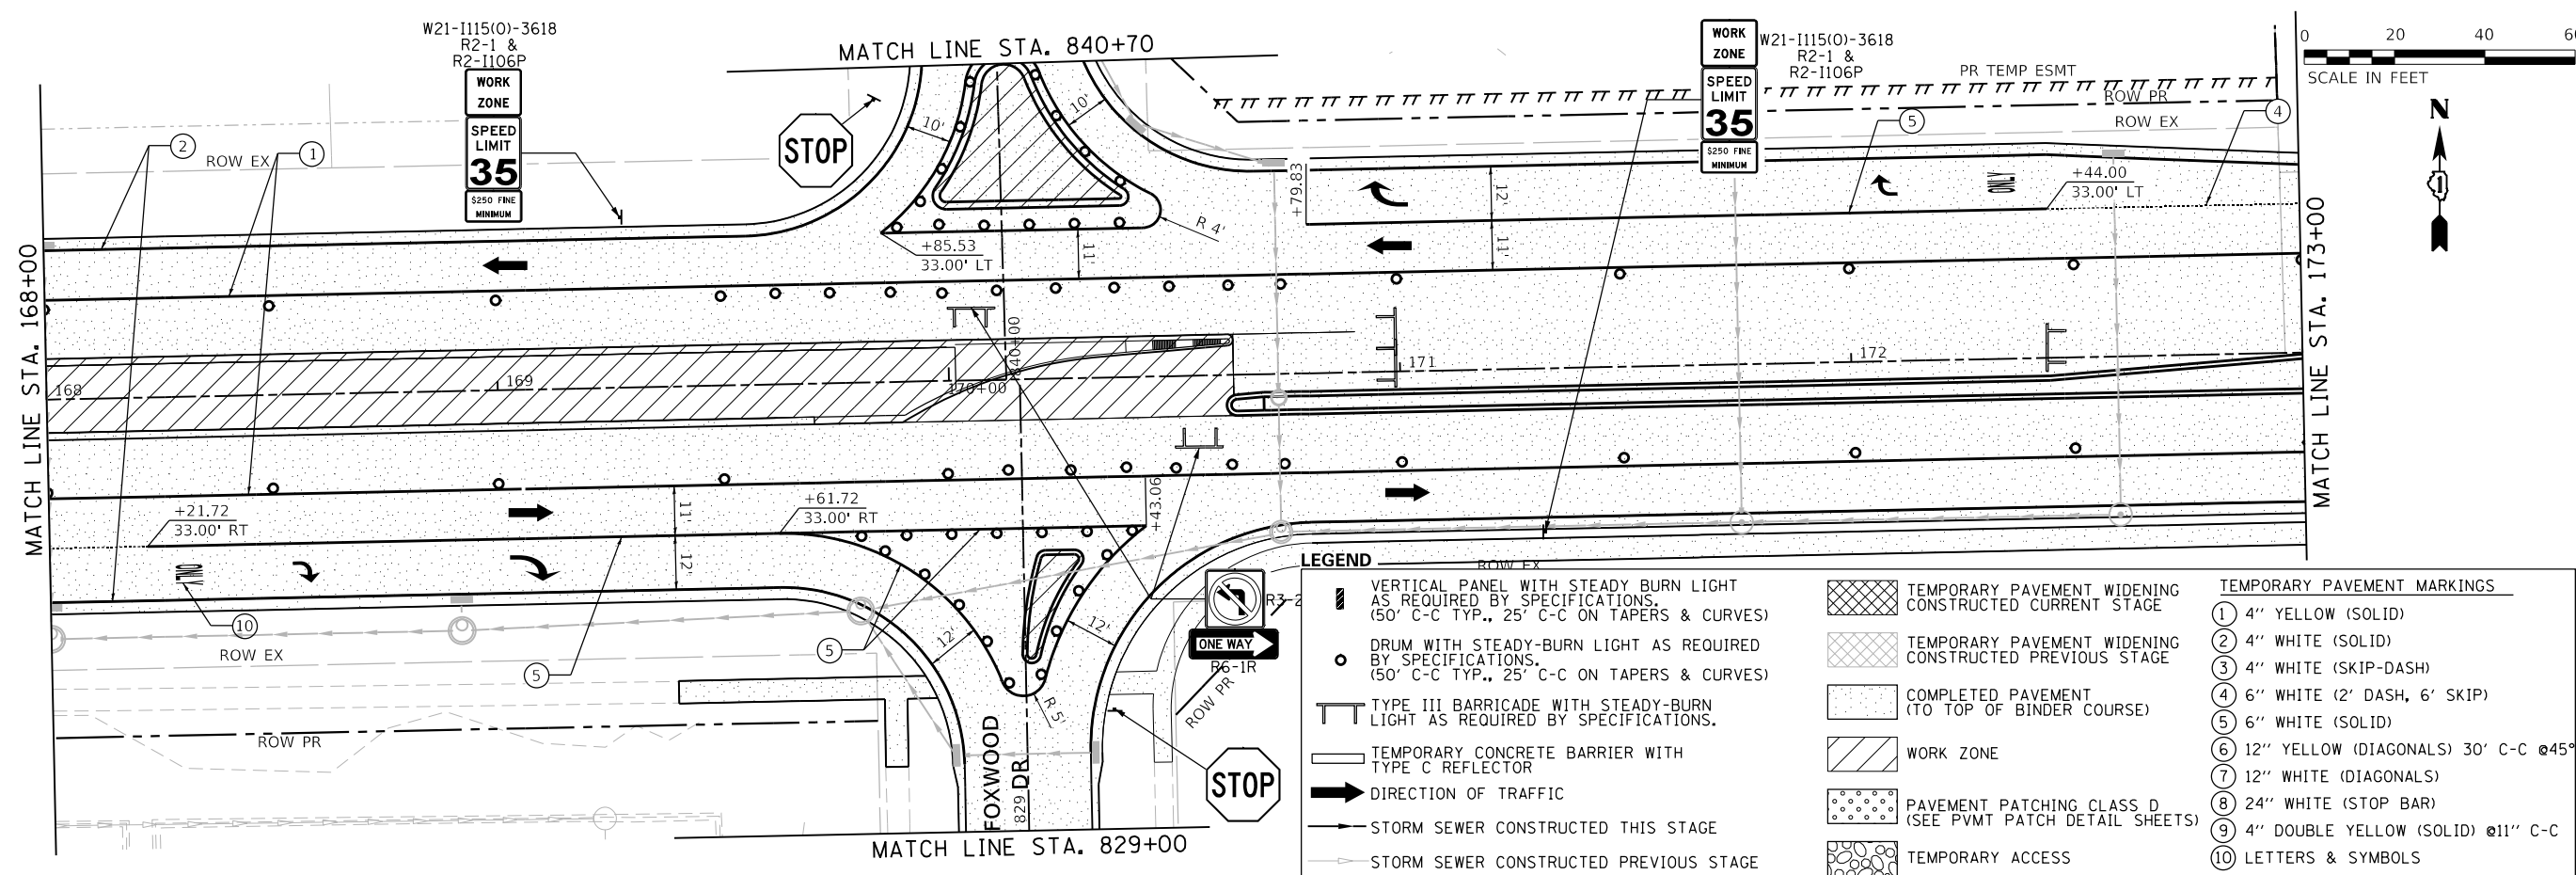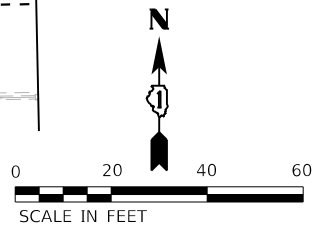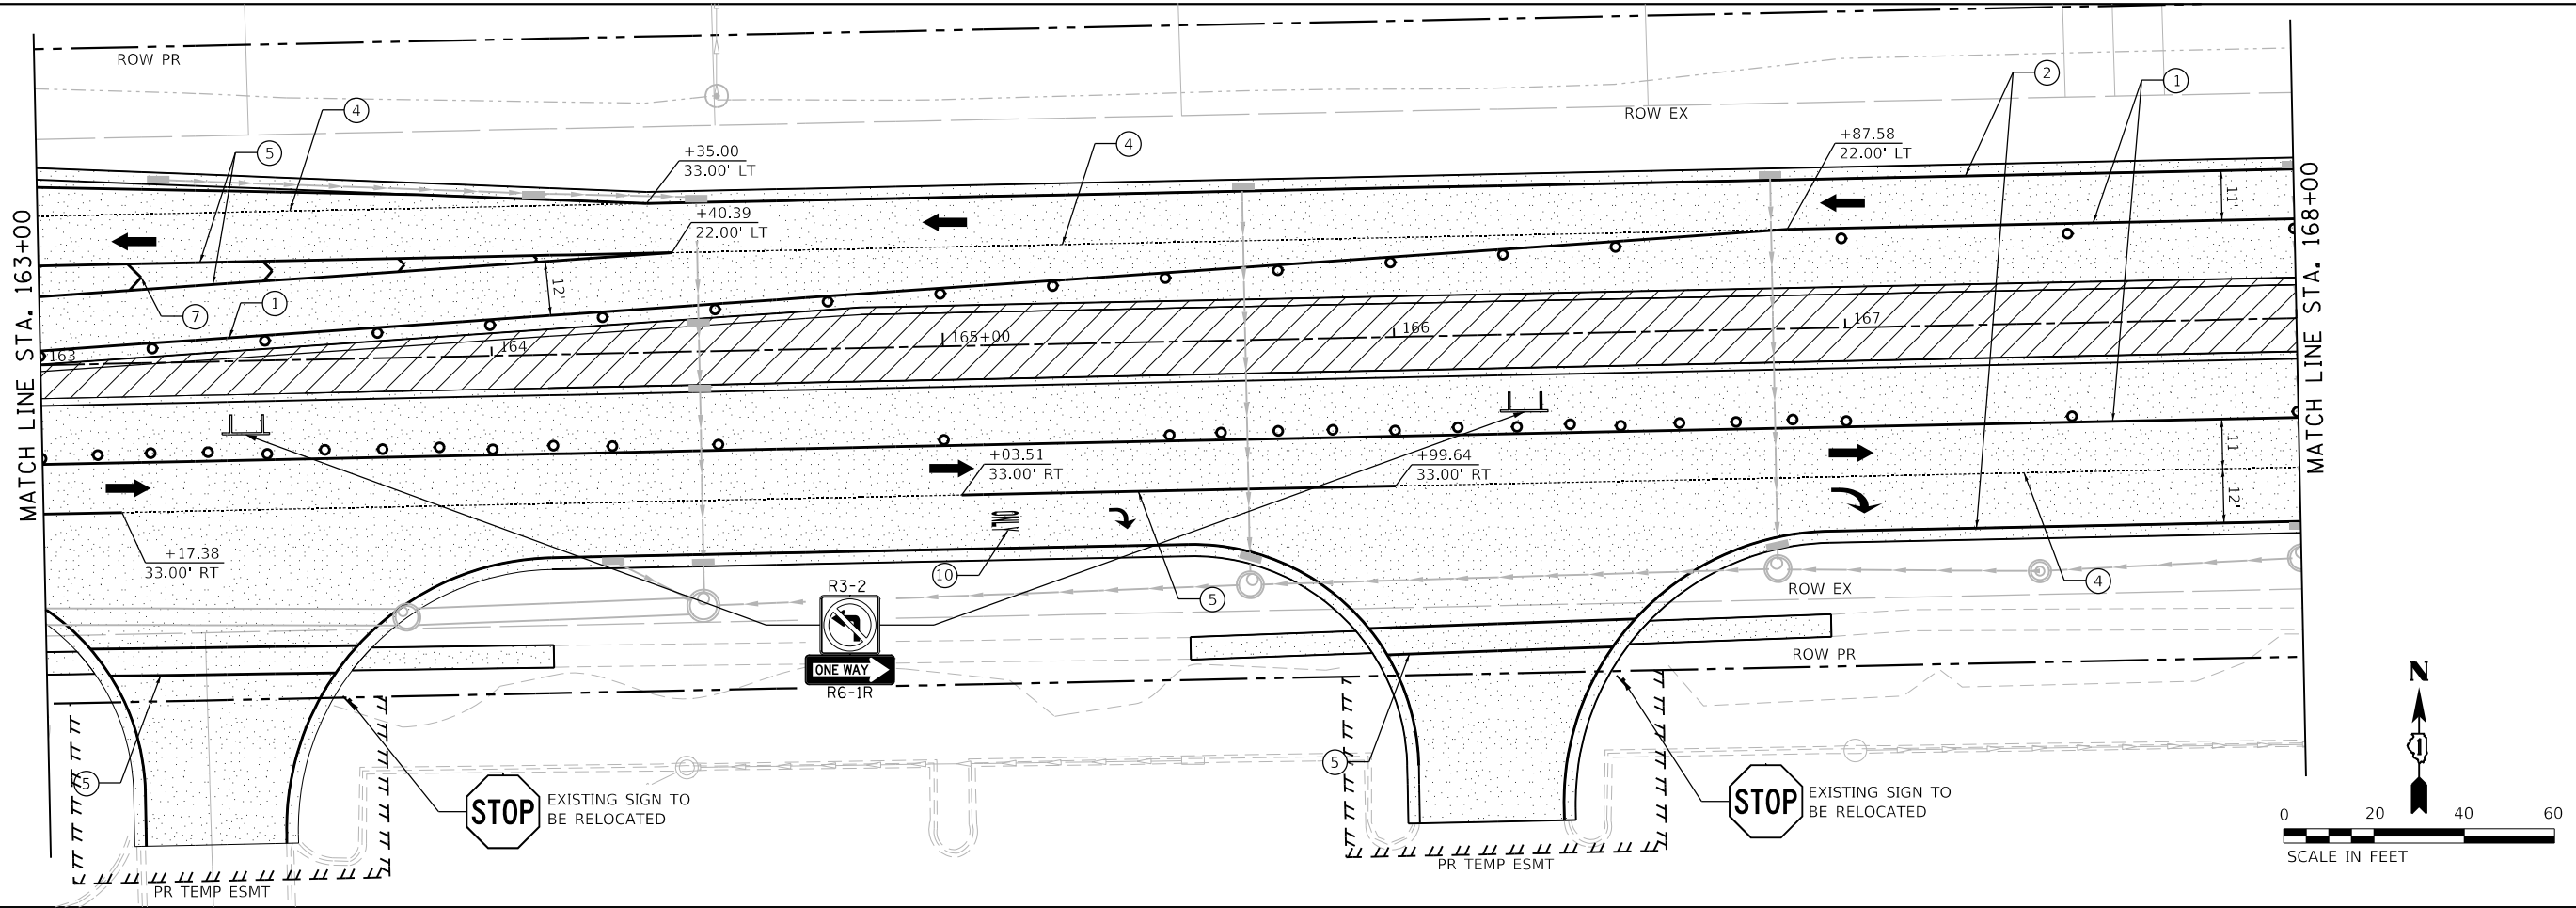

LEGEND

VERTICAL PANEL WITH STEADY BURN LIGHT AS REQUIRED BY SPECIFICATIONS. (50' C-C TYP., 25' C-C ON TAPERS & CURVES)	TEMPORARY PAVEMENT WIDENING CONSTRUCTED CURRENT STAGE	TEMPORARY PAVEMENT MARKINGS
DRUM WITH STEADY-BURN LIGHT AS REQUIRED BY SPECIFICATIONS. (50' C-C TYP., 25' C-C ON TAPERS & CURVES)	TEMPORARY PAVEMENT WIDENING CONSTRUCTED PREVIOUS STAGE	
TYPE III BARRICADE WITH STEADY-BURN LIGHT AS REQUIRED BY SPECIFICATIONS.	COMPLETED PAVEMENT (TO TOP OF BINDER COURSE)	① 4" YELLOW (SOLID)
TEMPORARY CONCRETE BARRIER WITH TYPE C REFLECTOR	WORK ZONE	② 4" WHITE (SOLID)
DIRECTION OF TRAFFIC	PAVEMENT PATCHING CLASS D (SEE PVMT PATCH DETAIL SHEETS)	③ 4" WHITE (SKIP-DASH)
STORM SEWER CONSTRUCTED THIS STAGE	TEMPORARY ACCESS	④ 6" WHITE (2' DASH, 6' SKIP)
STORM SEWER CONSTRUCTED PREVIOUS STAGE		⑤ 6" WHITE (SOLID)
		⑥ 12" YELLOW (DIAGONALS) 30' C-C @45°
		⑦ 12" WHITE (DIAGONALS)
		⑧ 24" WHITE (STOP BAR)
		⑨ 4" DOUBLE YELLOW (SOLID) @11" C-C
		⑩ LETTERS & SYMBOLS



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**STATE OF ILLINOIS
DEPARTMENT OF TRANSPORTATION**

**SUGGESTED SEQUENCE OF CONSTRUCTION
LARAWAY RD - STAGE 3A**



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F.A.U. RTE. 0320	SECTION 13-00138-37-PV	COUNTY WILL	TOTAL SHEETS 413	SHEET NO. 167
CONTRACT NO. 61H20				
ILLINOIS FED. AID PROJECT				

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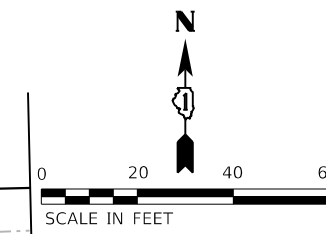
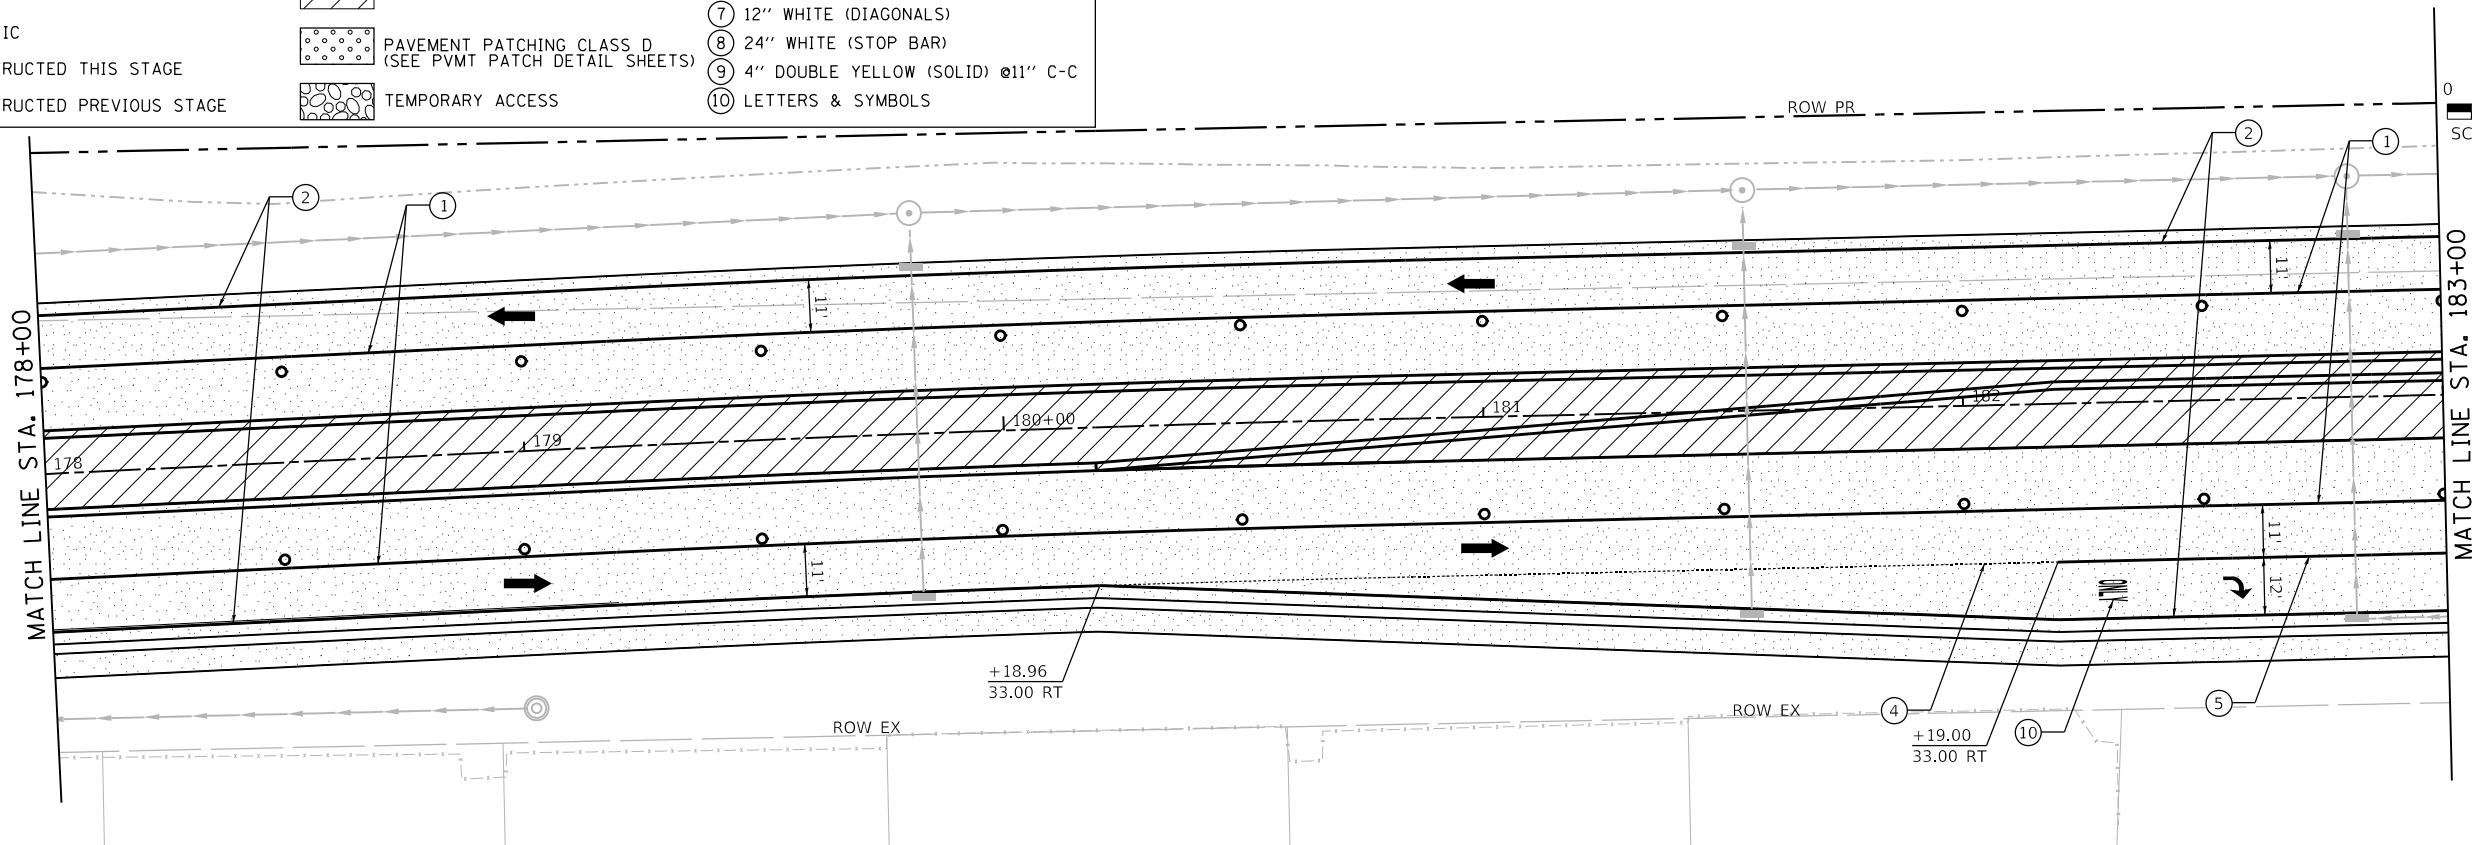
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DIRECTORY = L:\MILL\017204-01\Draw\CADD_Sheets\



LEGEND

	VERTICAL PANEL WITH STEADY BURN LIGHT AS REQUIRED BY SPECIFICATIONS. (50' C-C TYP., 25' C-C ON TAPERS & CURVES)		TEMPORARY PAVEMENT WIDENING CONSTRUCTED CURRENT STAGE	TEMPORARY PAVEMENT MARKINGS
	DRUM WITH STEADY-BURN LIGHT AS REQUIRED BY SPECIFICATIONS. (50' C-C TYP., 25' C-C ON TAPERS & CURVES)		TEMPORARY PAVEMENT WIDENING CONSTRUCTED PREVIOUS STAGE	① 4" YELLOW (SOLID)
	TYPE III BARRICADE WITH STEADY-BURN LIGHT AS REQUIRED BY SPECIFICATIONS.		COMPLETED PAVEMENT (TO TOP OF BINDER COURSE)	② 4" WHITE (SOLID)
	TEMPORARY CONCRETE BARRIER WITH TYPE C REFLECTOR		WORK ZONE	③ 4" WHITE (SKIP-DASH)
	DIRECTION OF TRAFFIC		PAVEMENT PATCHING CLASS D (SEE PVMT PATCH DETAIL SHEETS)	④ 6" WHITE (2' DASH, 6' SKIP)
	STORM SEWER CONSTRUCTED THIS STAGE		TEMPORARY ACCESS	⑤ 6" WHITE (SOLID)
	STORM SEWER CONSTRUCTED PREVIOUS STAGE			⑥ 12" YELLOW (DIAGONALS) 30' C-C @45°
				⑦ 12" WHITE (DIAGONALS)
				⑧ 24" WHITE (STOP BAR)
				⑨ 4" DOUBLE YELLOW (SOLID) @11" C-C
				⑩ LETTERS & SYMBOLS

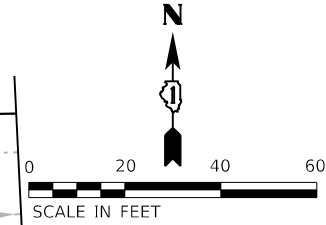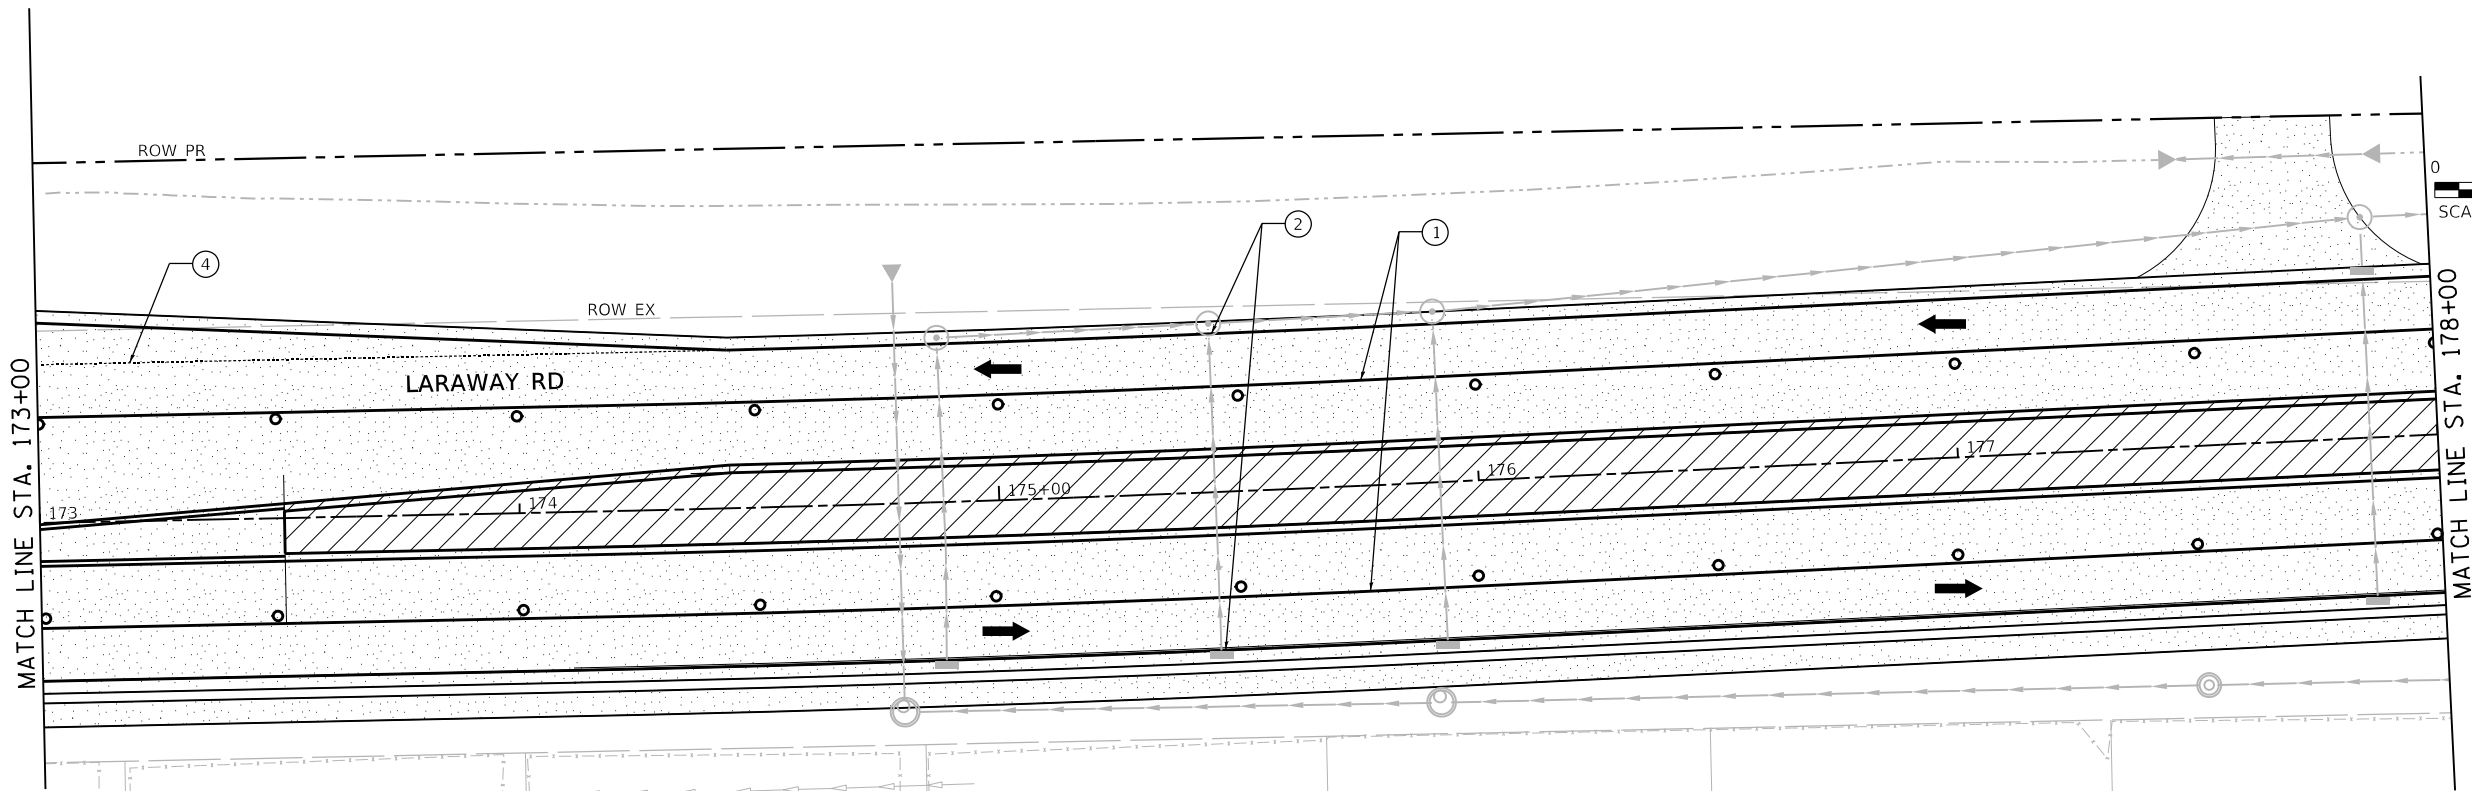

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**STATE OF ILLINOIS
DEPARTMENT OF TRANSPORTATION**

**SUGGESTED SEQUENCE OF CONSTRUCTION
LARAWAY RD - STAGE 3A**



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F.A.U. RTE.	SECTION	COUNTY	TOTAL SHEETS	SHEET NO.
0320	13-00138-37-PV	WILL	413	168
CONTRACT NO. 61H20				
ILLINOIS FED. AID PROJECT				

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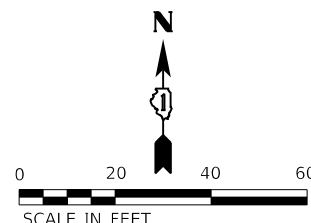
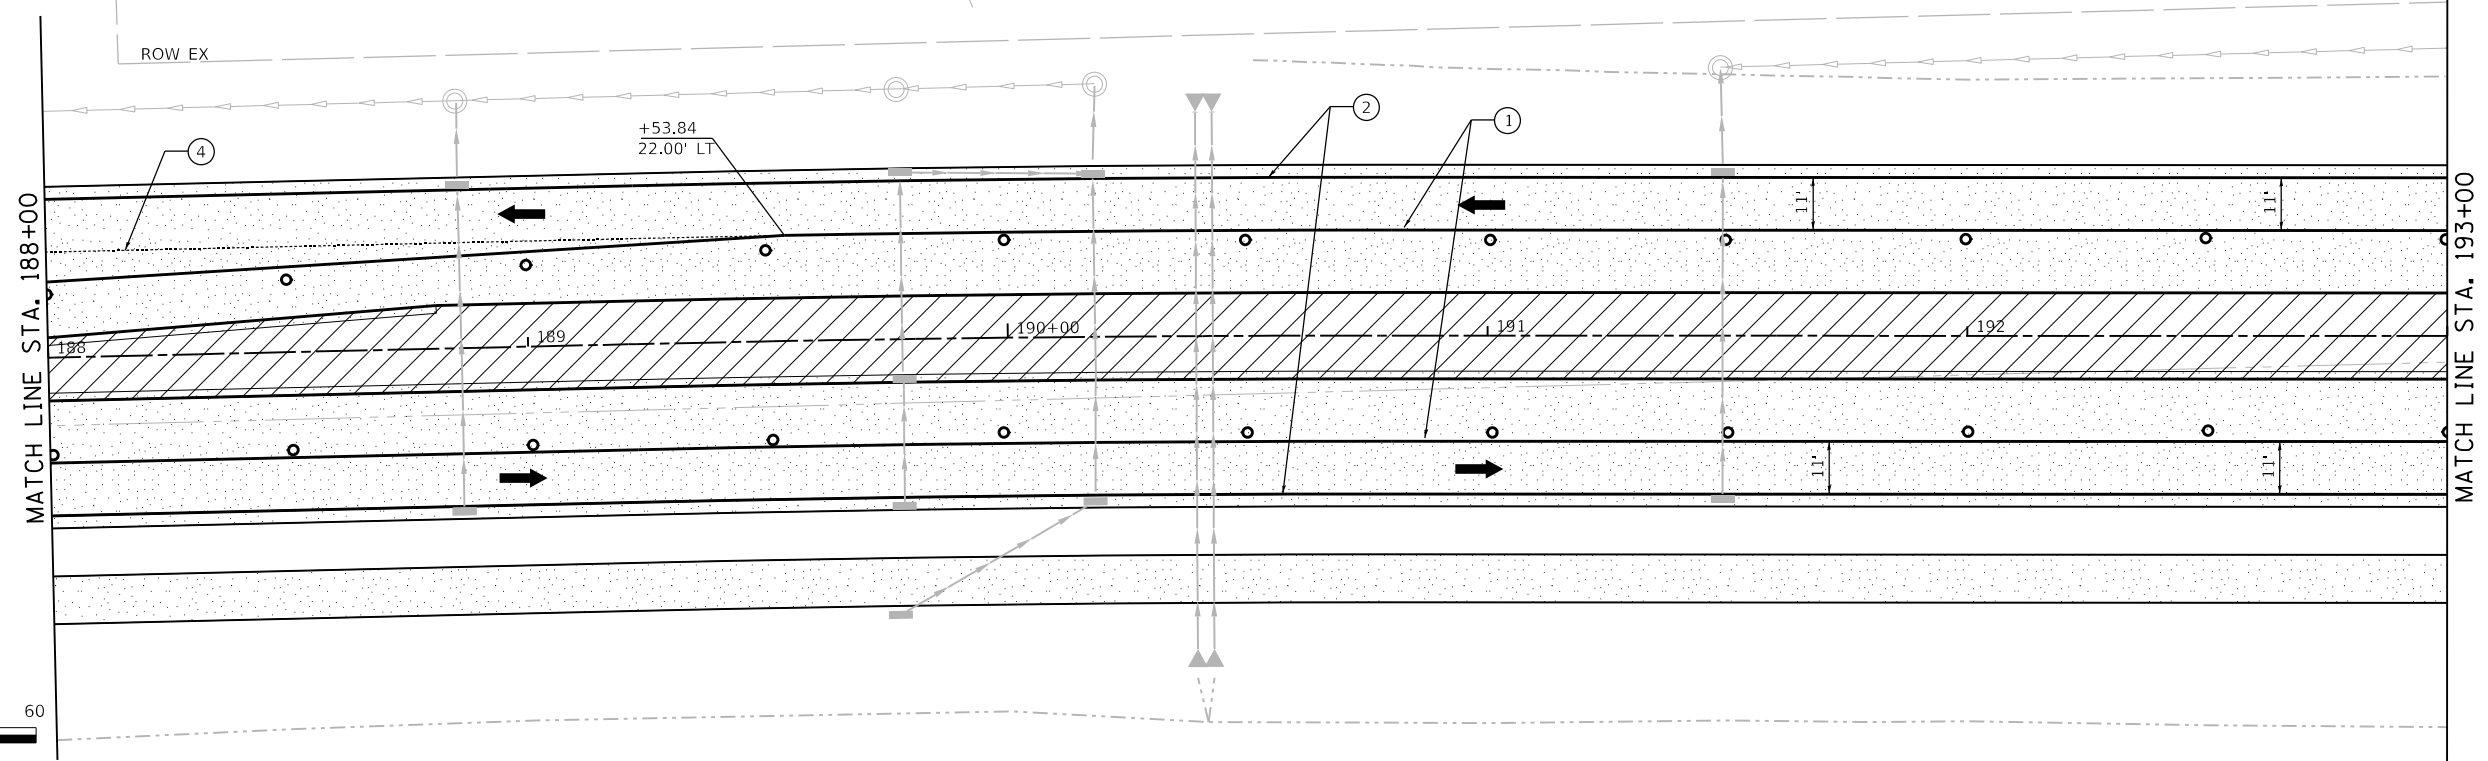
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USER NAME
DIRECTORY
= Mike Moss
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LEGEND

VERTICAL PANEL WITH STEADY BURN LIGHT AS REQUIRED BY SPECIFICATIONS. (50' C-C TYP., 25' C-C ON TAPERS & CURVES)	TEMPORARY PAVEMENT WIDENING CONSTRUCTED CURRENT STAGE	<p>TEMPORARY PAVEMENT MARKINGS</p> <p>① 4" YELLOW (SOLID)</p> <p>② 4" WHITE (SOLID)</p> <p>③ 4" WHITE (SKIP-DASH)</p> <p>④ 6" WHITE (2' DASH, 6' SKIP)</p> <p>⑤ 6" WHITE (SOLID)</p> <p>⑥ 12" YELLOW (DIAGONALS) 30' C-C @45°</p> <p>⑦ 12" WHITE (DIAGONALS)</p> <p>⑧ 24" WHITE (STOP BAR)</p> <p>⑨ 4" DOUBLE YELLOW (SOLID) @11' C-C</p> <p>⑩ LETTERS & SYMBOLS</p>
DRUM WITH STEADY-BURN LIGHT AS REQUIRED BY SPECIFICATIONS. (50' C-C TYP., 25' C-C ON TAPERS & CURVES)	TEMPORARY PAVEMENT WIDENING CONSTRUCTED PREVIOUS STAGE	
TYPE III BARRICADE WITH STEADY-BURN LIGHT AS REQUIRED BY SPECIFICATIONS.	COMPLETED PAVEMENT (TO TOP OF BINDER COURSE)	
TEMPORARY CONCRETE BARRIER WITH TYPE C REFLECTOR	WORK ZONE	
DIRECTION OF TRAFFIC	PAVEMENT PATCHING CLASS D (SEE PVMT PATCH DETAIL SHEETS)	
STORM SEWER CONSTRUCTED THIS STAGE	TEMPORARY ACCESS	
STORM SEWER CONSTRUCTED PREVIOUS STAGE		



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STATE OF ILLINOIS
DEPARTMENT OF TRANSPORTATION

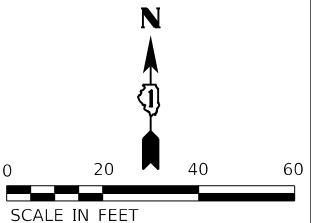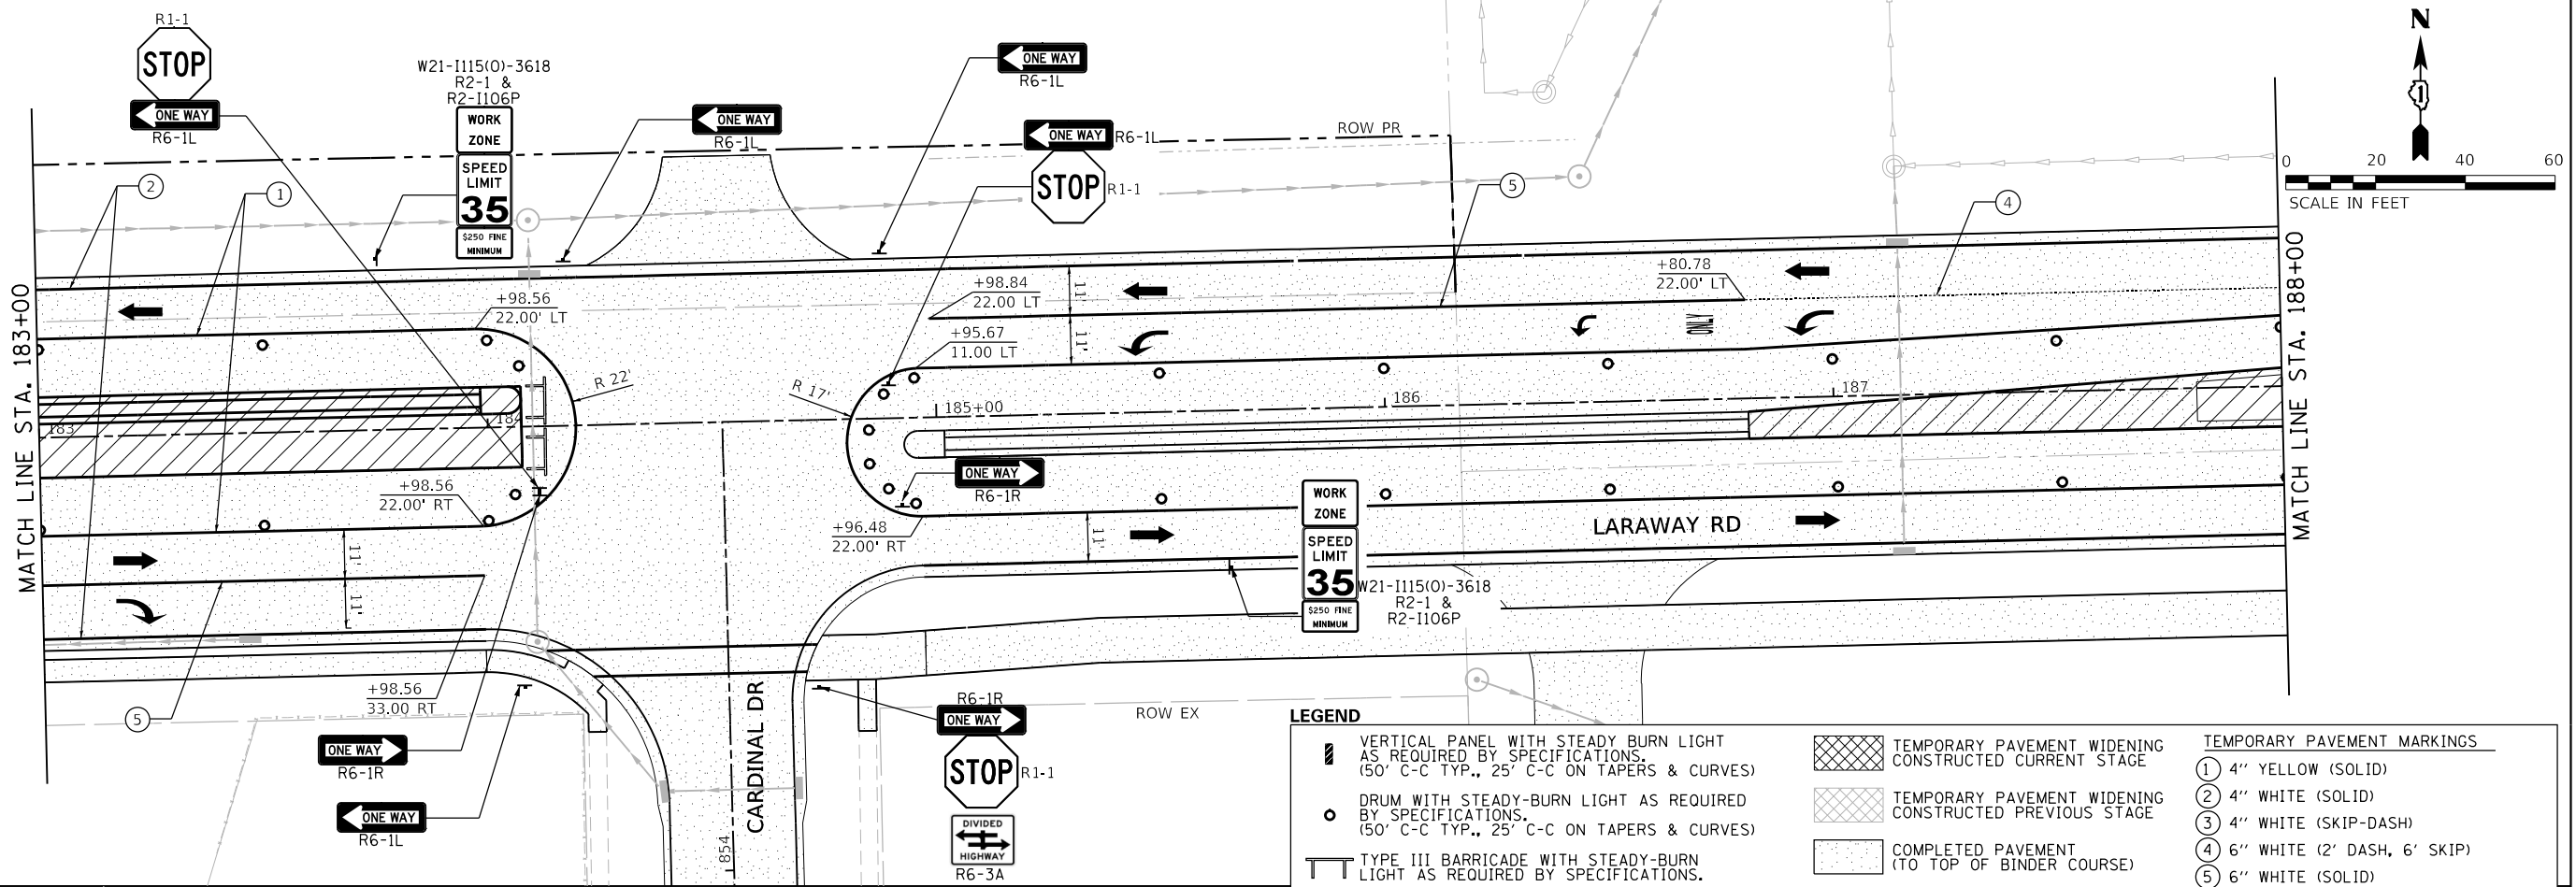SUGGESTED SEQUENCE OF CONSTRUCTION
LARAWAY RD - STAGE 3A


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F.A.U. RTE.	SECTION	COUNTY	TOTAL SHEETS	SHEET NO.
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CONTRACT NO. 61H20				
ILLINOIS FED. AID PROJECT				


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PLOT DATE = 9/9/2022 12:17:04 PM

USER NAME = Mike Moss
DIRECTORY = L:\MILL\017204-01\Draw\CADD_Sheets



LEGEND		TEMPORARY PAVEMENT MARKINGS
	VERTICAL PANEL WITH STEADY BURN LIGHT AS REQUIRED BY SPECIFICATIONS. (50' C-C TYP., 25' C-C ON TAPERS & CURVES)	① 4" YELLOW (SOLID)
	DRUM WITH STEADY-BURN LIGHT AS REQUIRED BY SPECIFICATIONS. (50' C-C TYP., 25' C-C ON TAPERS & CURVES)	② 4" WHITE (SOLID)
	TYPE III BARRICADE WITH STEADY-BURN LIGHT AS REQUIRED BY SPECIFICATIONS.	③ 4" WHITE (SKIP-DASH)
	TEMPORARY CONCRETE BARRIER WITH TYPE C REFLECTOR	④ 6" WHITE (2' DASH, 6' SKIP)
	DIRECTION OF TRAFFIC	⑤ 6" WHITE (SOLID)
	STORM SEWER CONSTRUCTED THIS STAGE	⑥ 12" YELLOW (DIAGONALS) 30' C-C @45°
	STORM SEWER CONSTRUCTED PREVIOUS STAGE	⑦ 12" WHITE (DIAGONALS)
	TEMPORARY PAVEMENT WIDENING CONSTRUCTED CURRENT STAGE	⑧ 24" WHITE (STOP BAR)
	TEMPORARY PAVEMENT WIDENING CONSTRUCTED PREVIOUS STAGE	⑨ 4" DOUBLE YELLOW (SOLID) @11" C-C
	COMPLETED PAVEMENT (TO TOP OF BINDER COURSE)	⑩ LETTERS & SYMBOLS
	WORK ZONE	
	PAVEMENT PATCHING CLASS D (SEE PVMT PATCH DETAIL SHEETS)	
	TEMPORARY ACCESS	

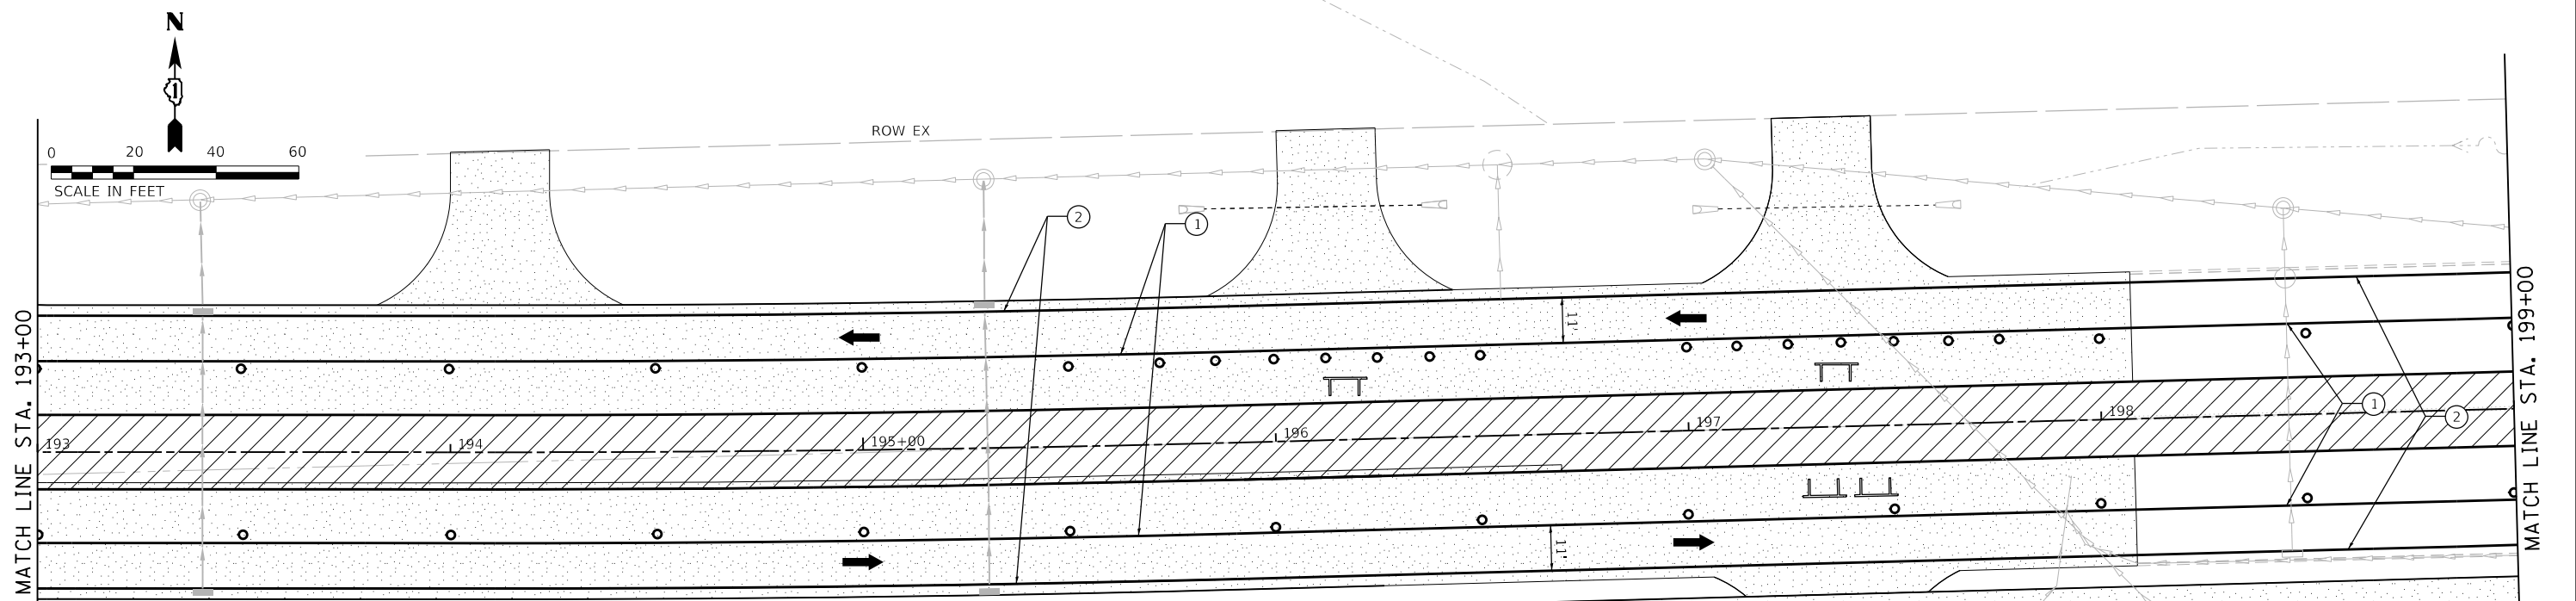
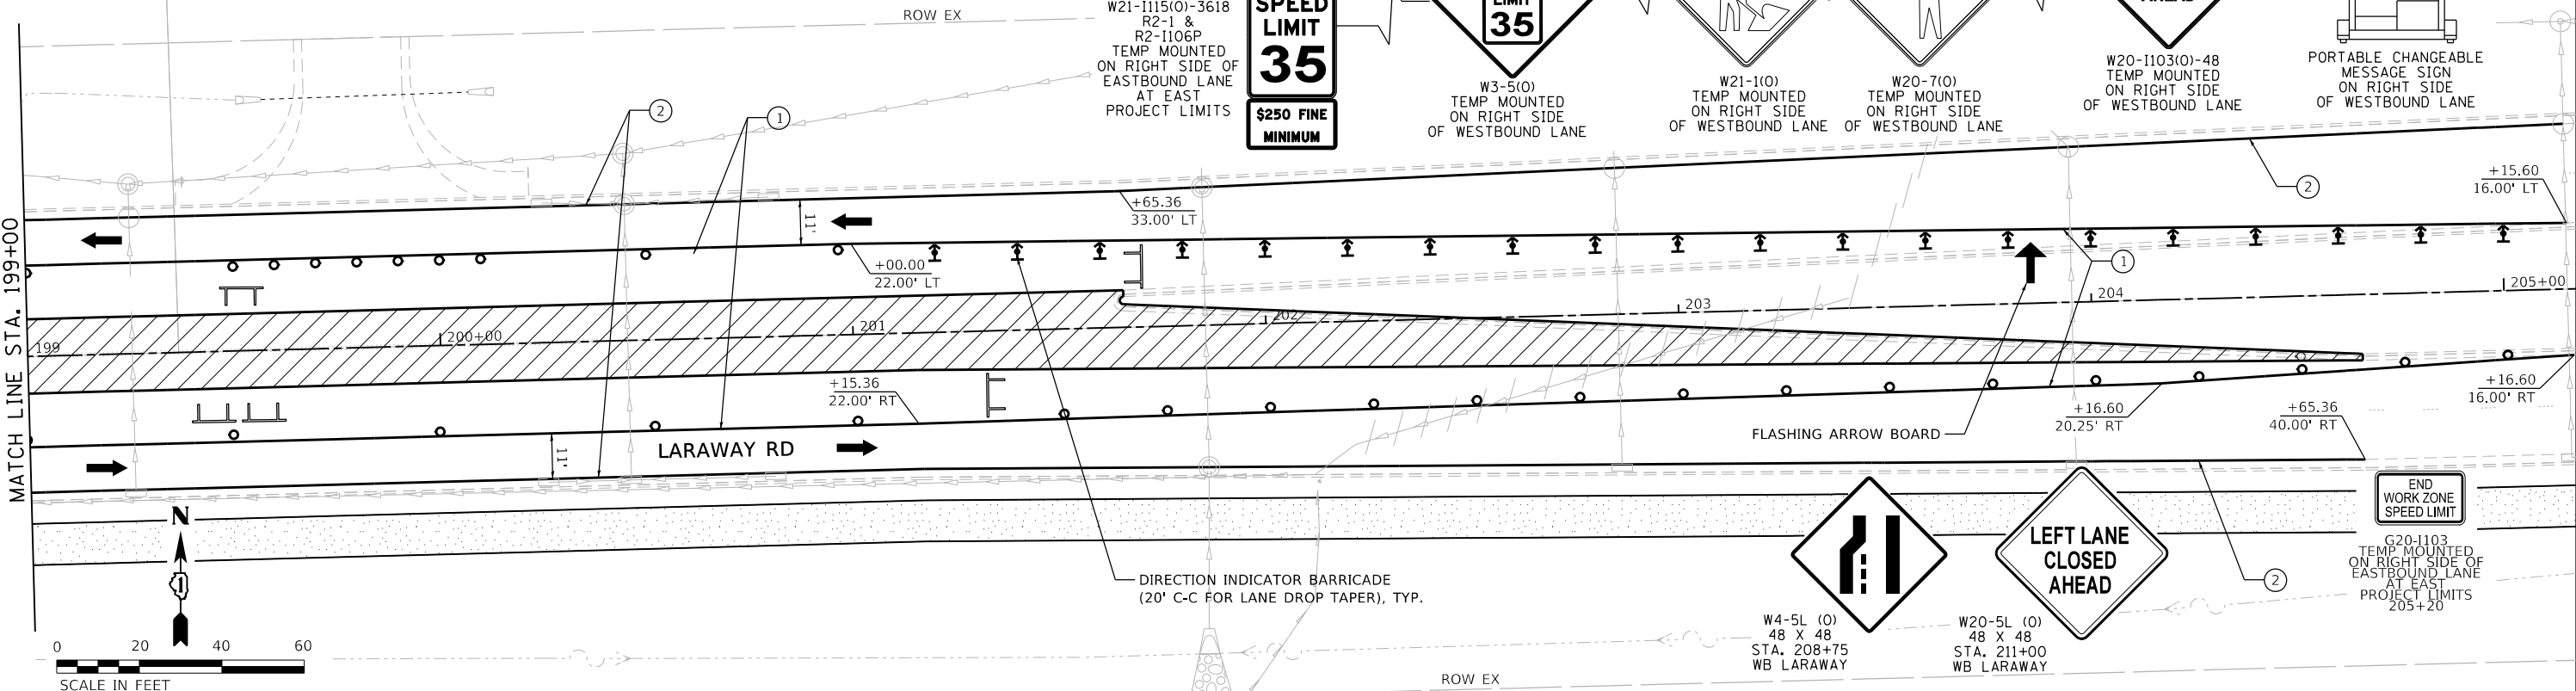
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STATE OF ILLINOIS
DEPARTMENT OF TRANSPORTATION


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LARAWAY RD - STAGE 3A
SCALE: 1"=20'
SHEET 7 OF 7 SHEETS
STA. 193+00 TO STA. 205+00

F.A.U. RTE.	SECTION	COUNTY	TOTAL SHEETS	SHEET NO.
0320	13-00138-37-PV	WILL	413	170
CONTRACT NO. 61H20				
ILLINOIS FED. AID PROJECT				

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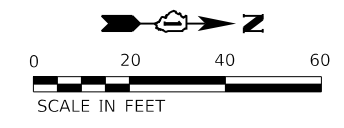
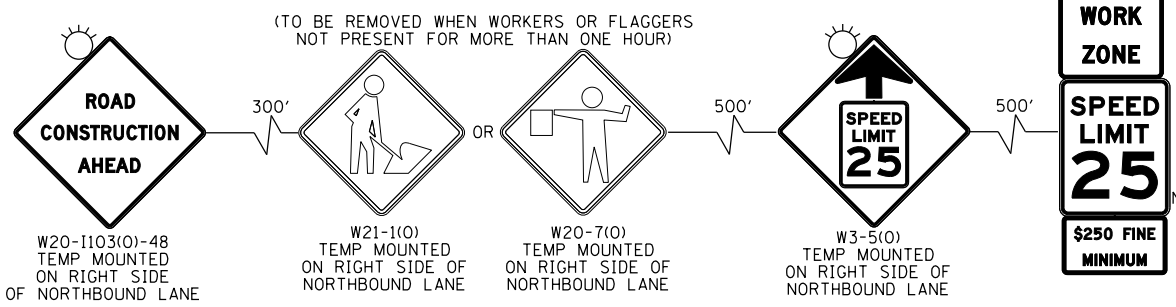
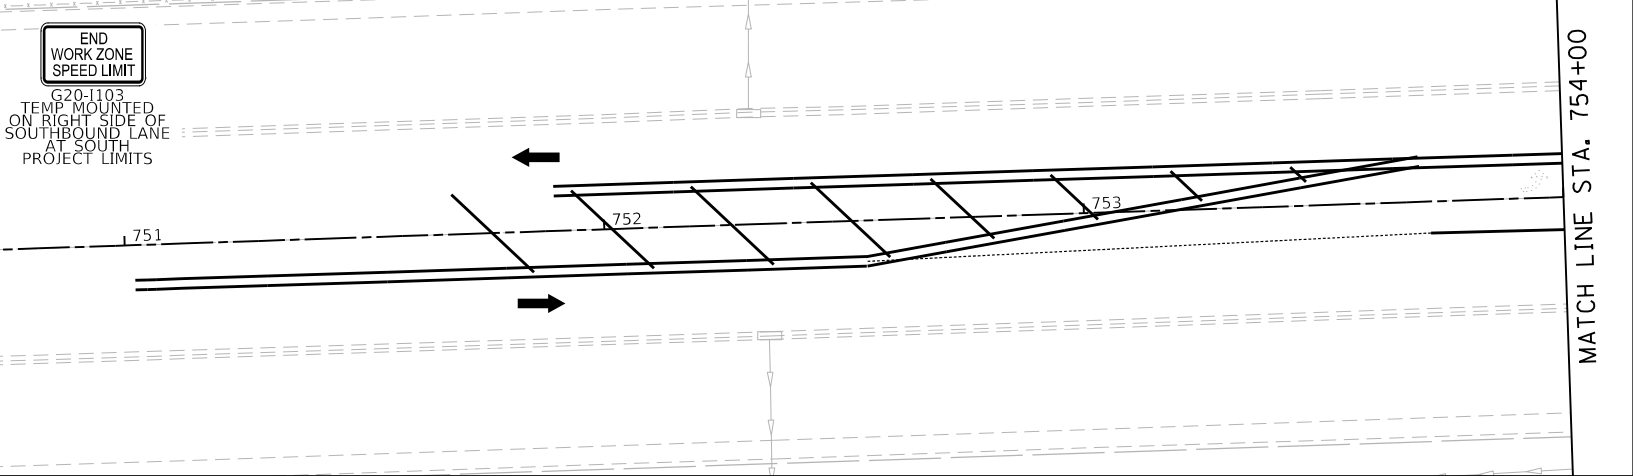
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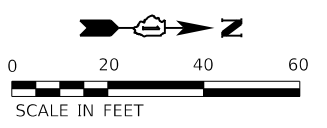
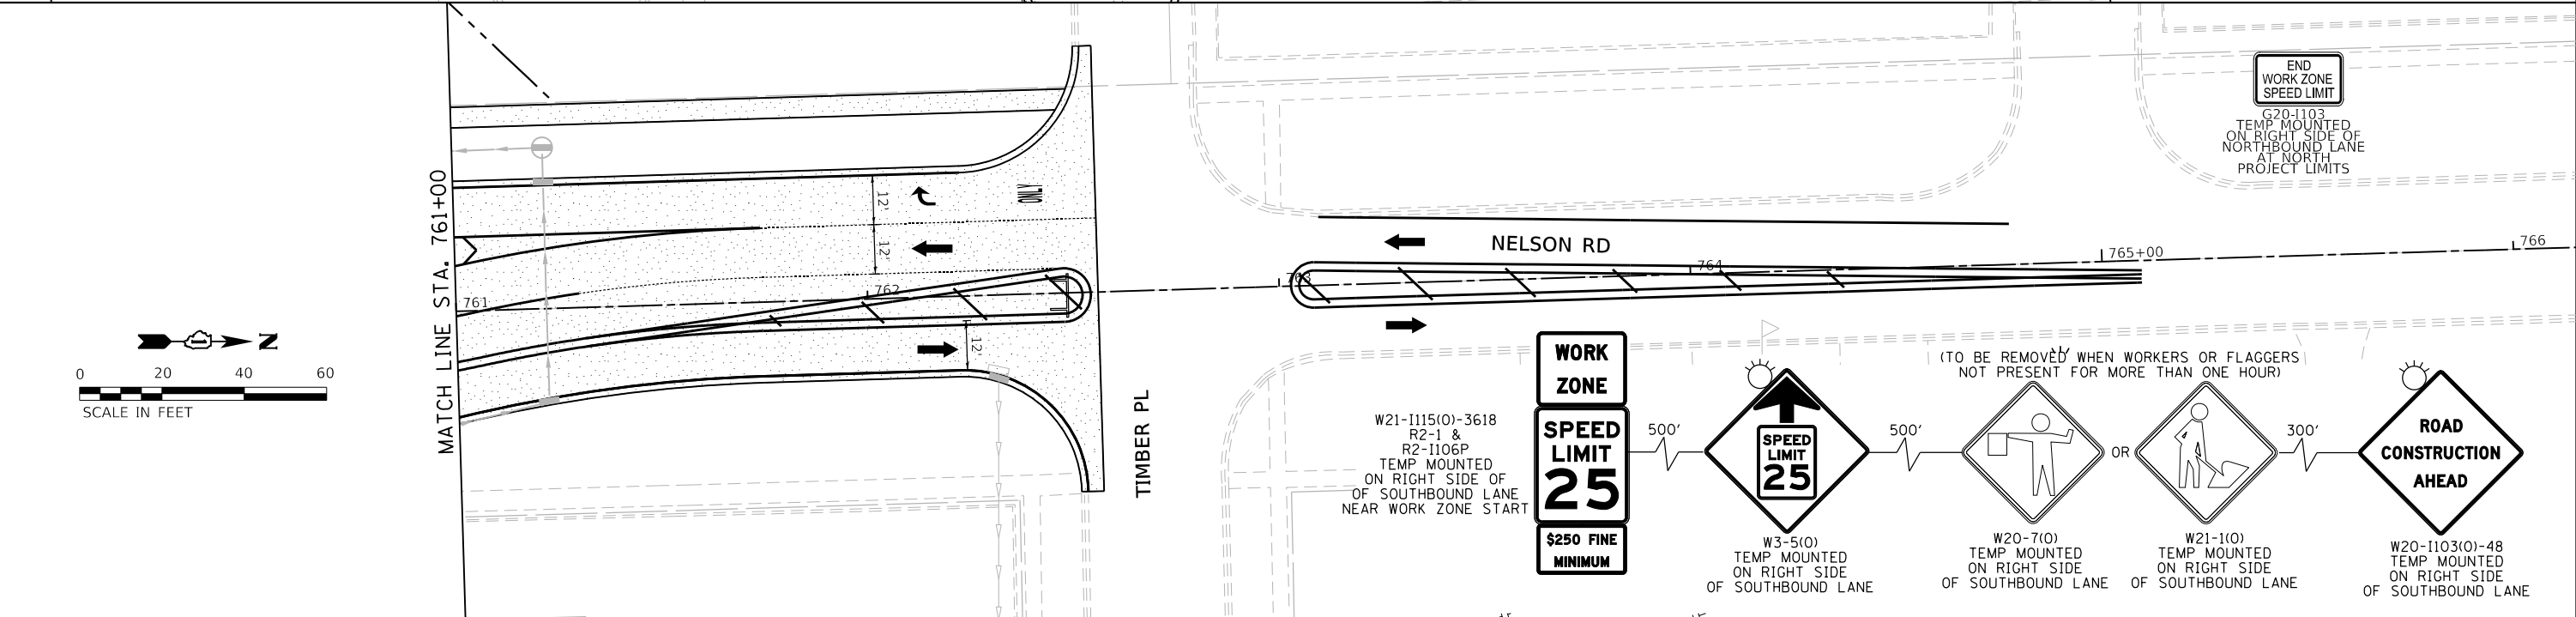
LEGEND

	VERTICAL PANEL WITH STEADY BURN LIGHT AS REQUIRED BY SPECIFICATIONS. (50' C-C TYP., 25' C-C ON TAPERS & CURVES)		TEMPORARY PAVEMENT WIDENING CONSTRUCTED CURRENT STAGE	TEMPORARY PAVEMENT MARKINGS	
	DRUM WITH STEADY-BURN LIGHT AS REQUIRED BY SPECIFICATIONS. (50' C-C TYP., 25' C-C ON TAPERS & CURVES)		TEMPORARY PAVEMENT WIDENING CONSTRUCTED PREVIOUS STAGE	① 4" YELLOW (SOLID)	
	TYPE III BARRICADE WITH STEADY-BURN LIGHT AS REQUIRED BY SPECIFICATIONS.		COMPLETED PAVEMENT (TO TOP OF BINDER COURSE)	② 4" WHITE (SOLID)	
	TEMPORARY CONCRETE BARRIER WITH TYPE C REFLECTOR		WORK ZONE	③ 4" WHITE (SKIP-DASH)	
	DIRECTION OF TRAFFIC		PAVEMENT PATCHING CLASS D (SEE PVMT PATCH DETAIL SHEETS)	④ 6" WHITE (2' DASH, 6' SKIP)	
	STORM SEWER CONSTRUCTED THIS STAGE		TEMPORARY ACCESS	⑤ 6" WHITE (SOLID)	
	STORM SEWER CONSTRUCTED PREVIOUS STAGE			⑥ 12" YELLOW (DIAGONALS) 30' C-C @45°	
				⑦ 12" WHITE (DIAGONALS)	
				⑧ 24" WHITE (STOP BAR)	
				⑨ 4" DOUBLE YELLOW (SOLID) @11" C-C	
				⑩ LETTERS & SYMBOLS	

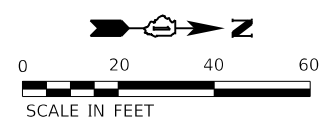

MATCH LINE STA. 754+00

MATCH LINE STA. 759+00



MATCH LINE STA. 761+00

TIMBER PL



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STATE OF ILLINOIS
DEPARTMENT OF TRANSPORTATION

SUGGESTED SEQUENCE OF CONSTRUCTION
NELSON RD - STAGE 3A

SCALE: 1"=20' SHEET 1 OF 1 SHEETS STA. 751+00 TO STA. 765+00

F.A.U. RTE.	SECTION	COUNTY	TOTAL SHEETS	SHEET NO.
0320	13-00138-37-PV	WILL	413	171
CONTRACT NO. 61H20				
ILLINOIS FED. AID PROJECT				

STORM WATER POLLUTION PREVENTION PLAN (SWPPP)/
EROSION CONTROL NOTES:
LARAWAY ROAD RECONSTRUCTION AND IMPROVEMENT

THESE NOTES SUPPLEMENT THE EROSION CONTROL PLAN AND SWPPP
TO COMPLY WITH THE PROVISIONS OF THE NPDES PERMIT ILR10 ISSUED
BY THE ILLINOIS ENVIRONMENTAL PROTECTION AGENCY FOR STORM
WATER DISCHARGES FROM CONSTRUCTION SITE ACTIVITIES.

A. SITE DESCRIPTION:

1. THE WORK UNDER THIS CONTRACT IS TO BE COMPLETED ON PROPERTY LOCATED IN NEW LENOX, ILLINOIS ALONG THE EXISTING LARAWAY ROAD FROM JACKSON BRANCH CREEK TO CEDAR ROAD. THE PROJECT INCLUDES THE CLEARING OF THE SITE, WIDENING OF THE EXISTING ROAD, NEW STORM SEWERS AND DETENTION BASINS, INTERSECTION IMPROVEMENTS, AND TRAFFIC SIGNALS.
2. THE FOLLOWING IS A DESCRIPTION OF THE INTENDED SEQUENCE OF THE MAJOR ACTIVITIES WHICH WILL DISTURB SOIL FOR MAJOR PORTIONS OF THE CONSTRUCTION SITE; EXCAVATION AND GRADING SEQUENCE OF THE CONSTRUCTION ACTIVITIES MAY BE AS FOLLOWS:
 - i) INSTALLATION OF CONSTRUCTION FENCING, SEDIMENT CONTROL, PERIMETER EROSION BARRIER, AND TEMPORARY VEGETATION.
 - ii) CLEARING OF THE PROJECT AS SHOWN IN THE REMOVAL PLANS AND STAGING PLANS.
 - iii) GRADING AND EARTHWORK AS SHOWN IN THE PLANS.
 - iv) INSTALLATION OF STORM SEWERS AND DRAINAGE FACILITIES
 - v) INSTALLATION OF TRAFFIC SIGNAL EQUIPMENT.
 - vi) TOPSOIL SPREADING WITH TEMPORARY OR PERMANENT SOIL STABILIZATION MEASURES AND THE CONSTRUCTION OF PERMANENT SOIL EROSION AND SEDIMENT CONTROL MEASURES.
 - vii) REMOVAL OF TEMPORARY SOIL EROSION AND SEDIMENT CONTROL MEASURES.
3. THE TOTAL AREA OF THE CONSTRUCTION SITE IS ESTIMATED TO BE 32 ACRES. THE TOTAL AREA OF THE SITE THAT IS ESTIMATED TO BE DISTURBED BY EXCAVATION, GRADING OR OTHER ACTIVITIES IS 32 ACRES.
4. WATERS OF THE U.S. INCLUDED WITHIN OR ADJACENT TO THE PROJECT SITE IS THE JACKSON BRANCH CREEK. JACKSON BRANCH CREEK IS WITHIN THE DES PLAINES RIVER WATERSHED.

B. SOIL EROSION AND SEDIMENT CONTROL NOTES:

1. EACH CONTRACTOR MUST SIGN THE REQUIRED CERTIFICATION ON FORMS WHICH ARE A PART OF THE SWPPP.
2. SOIL DISTURBANCE SHALL BE CONDUCTED IN SUCH A MANNER AS TO MINIMIZE EROSION. SOIL-STABILIZATION MEASURES SHALL CONSIDER THE TIME OF YEAR, SITE CONDITIONS, AND THE USE OF TEMPORARY OR PERMANENT MEASURES.
3. UNLESS OTHERWISE INDICATED, ALL VEGETATIVE AND STRUCTURAL EROSION AND SEDIMENT CONTROL PRACTICES WILL BE CONSTRUCTED TO THE STANDARDS AND SPECIFICATIONS IN THE ILLINOIS URBAN MANUAL, LATEST EDITION. THE PRACTICES SHALL ALSO MEET THE MINIMUM STANDARDS AND SPECIFICATIONS OF THE IDOT STANDARD SPECIFICATIONS FOR ROAD AND BRIDGE CONSTRUCTION, IDOT SUPPLEMENTAL SPECIFICATIONS AND RECURRING SPECIAL PROVISIONS (LATEST EDITION), THE SWPPP, AND THE DETAILS AND NOTES CONTAINED WITHIN THIS PLAN.
4. A COPY OF THE APPROVED SOIL EROSION AND SEDIMENT CONTROL PLAN SHALL BE MAINTAINED ON THE PROJECT SITE AT ALL TIMES.
5. THE WILL-SOUTH COOK SOIL AND WATER CONSERVATION DISTRICT (WCSWCD) MUST BE NOTIFIED ONE WEEK PRIOR TO THE PRE-CONSTRUCTION MEETING, ONE WEEK PRIOR TO THE COMMENCEMENT OF LAND DISTURBING ACTIVITIES, AND ONE WEEK PRIOR TO THE FINAL INSPECTION.
6. SOIL EROSION AND SEDIMENT CONTROL MEASURES SHALL BE IN PLACE AND FUNCTIONAL PRIOR TO COMMENCING LAND DISTURBING ACTIVITIES.
7. SOIL DISTURBANCE SHALL BE CONDUCTED IN A MANNER SUCH AS TO MINIMIZE EROSION. AREAS OF THE DEVELOPMENT SITE THAT ARE NOT TO BE DISTURBED SHALL BE PROTECTED FROM CONSTRUCTION TRAFFIC OR OTHER DISTURBANCE.
8. OFF SITE PROPERTY SHALL BE PROTECTED FROM EROSION AND SEDIMENTATION.
9. PRIOR TO COMMENCING LAND-DISTURBING ACTIVITIES IN AREAS OTHER THAN INDICATED ON THESE PLANS, A SUPPLEMENTARY EROSION CONTROL PLAN SHALL BE SUBMITTED FOR REVIEW BY THE WCSWCD.

10. DEWATERING FOR ANY AND ALL PORTIONS OF WORK SHALL NOT BE MEASURED SEPARATELY FOR PAYMENT, BUT SHALL BE CONSIDERED INCLUDED IN THE CONTRACT UNIT PRICE FOR THE VARIOUS ITEMS AS BID.
11. DURING DEWATERING OPERATIONS, WATER WILL BE FILTERED, OR PUMPED INTO SEDIMENT BASINS OR SILT TRAPS. DEWATERING DIRECTLY INTO STREAMS, WETLANDS, FIELD TILES, STORMWATER STRUCTURES, OR ADJACENT PROPERTIES IS PROHIBITED. SILT TRAPS OR SEDIMENT BASINS SHALL NOT BE MEASURED SEPARATELY FOR PAYMENT, BUT SHALL BE CONSIDERED PART OF DEWATERING AND INCLUDED IN THE CONTRACT UNIT PRICE FOR THE VARIOUS ITEMS AS BID.
12. CONCRETE WASHOUT LOCATIONS SHALL BE APPROVED BY THE ENGINEER PRIOR TO PLACEMENT OF THE CONCRETE. WASHOUTS SHALL NOT BE LOCATED IN WETLANDS, AREAS OF CONCENTRATED FLOW, AND NEAR AREAS OF CONCERN. WASHOUTS SHALL BE CONSTRUCTED ACCORDING TO THE DETAILS IN THE PLANS, OR IN A MANNER MEETING THE APPROVAL OF THE ENGINEER.
13. CLEANING OF VEHICLES AND EQUIPMENT, INCLUDING CONCRETE MIXERS, SHALL BE PERFORMED IN A MANNER TO REDUCE THE AMOUNT OF POLLUTANTS LEAVING THE PROJECT AREA, STORM SEWERS, AND OPEN WATERS TO THE MAXIMUM EXTENT PRACTICAL AND TO THE SATISFACTION OF THE ENGINEER.
14. STABILIZED CONSTRUCTION ENTRANCES SHALL BE INSTALLED AS SHOWN IN THE PLANS OR AS DIRECTED BY THE ENGINEER. ALL ADJACENT STREETS SHALL BE MONITORED AND KEPT FREE OF DIRT AND DEBRIS. THE CONTRACTOR SHALL CLEAN THE ADJACENT PAVEMENT OF ALL DIRT AND DEBRIS AT THE END OF EACH DAY'S OPERATION AND AS DIRECTED BY THE ENGINEER (ART. 107.15).
15. NO WORK SHALL BE PERMITTED IN WATERS OF THE US UNLESS PERMITTED BY A SECTION 404 PERMIT.
16. STOCKPILES THAT ARE TO REMAIN IN PLACE FOR MORE THAN THREE DAYS SHALL HAVE SOIL EROSION AND SEDIMENT CONTROL PROVIDED. AT A MINIMUM, PERIMETER EROSION BARRIER SHALL BE PLACED AROUND THE BOTTOM OF THE STOCKPILE. STOCKPILES TO REMAIN IN PLACE FOR MORE THAN 14 DAYS SHALL RECEIVE TEMPORARY SEEDING.
17. SOIL STOCKPILES SHALL NOT BE LOCATED IN FLOOD PRONE AREAS OR A DESIGNATED BUFFER PROTECTING WATERS OF THE UNITED STATES OR ISOLATED WATERS OF WILL COUNTY.
18. THE CONTRACTOR SHALL PROVIDE ADEQUATE CLOSED RECEPTACLES FOR THE DEPOSITION OF ALL CONSTRUCTION MATERIAL DEBRIS GENERATED DURING THE CONSTRUCTION PROJECT. THE CONTRACTOR SHALL NOT CAUSE OR PERMIT DUMPING, DEPOSITING, THROWING, DISCHARGING, DROPPING, OR LEAVING CONSTRUCTION MATERIAL DEBRIS UPON OR INTO ANY PRIVATE PROPERTY, CHANNEL, OR ISOLATED WATERS. THE SITE SHALL BE MAINTAINED FREE OF CONSTRUCTION MATERIAL DEBRIS.
19. THE CONTRACTOR IS RESPONSIBLE FOR THE INSTALLATION OF ANY ADDITIONAL EROSION CONTROL MEASURES NECESSARY TO PREVENT EROSION AND SEDIMENTATION AS DETERMINED BY THE WCSWCD.
20. THE SOIL EROSION AND SEDIMENT CONTROL PLANS AND DETAILS DEFINE THE SIZE AND LOCATION OF THE MEASURES TO BE INSTALLED DURING THE CONSTRUCTION OF THIS PROJECT.
21. STABILIZATION OF DISTURBED AREAS SHALL, AT A MINIMUM, BE INITIATED IMMEDIATELY WHENEVER ANY CLEARING, GRADING, EXCAVATING, OR OTHER EARTH MOVING ACTIVITIES HAVE PERMANENTLY CEASED ON ANY PORTION OF THE SITE, OR TEMPORARILY CEASED ON ANY PORTION OF THE SITE AND WILL NOT RESUME FOR A PERIOD EXCEEDING 14 CALENDAR DAYS. STABILIZATION OF DISTURBED AREAS MUST BE INITIATED WITHIN ONE WORKING DAY OF CESSATION OF EARTH DISTURBING ACTIVITIES AND SHALL BE COMPLETED AS SOON AS POSSIBLE, BUT NOT LATER THAN 14 CALENDAR DAYS FROM THE INITIATION OF STABILIZATION WORK IN AN AREA.
22. COMPLETED AREAS SHALL BE PERMANENTLY STABILIZED AS THE WORK PROGRESSES TO THE EXTENT CONSIDERED PRACTICAL. UNDER NO CIRCUMSTANCE SHALL THE CONTRACTOR PROLONG FINAL GRADING AND SHAPING SUCH THAT THE ENTIRE PROJECT CAN BE PERMANENTLY STABILIZED AT ONE TIME.
23. THE CONDITION OF THE CONSTRUCTION SITE FOR WINTER SHUTDOWN SHALL BE ADDRESSED EARLY IN THE FALL GROWING SEASON TO THAT SLOPES AND OTHER BARE EARTH AREAS MAY BE STABILIZED WITH THE PROPER VEGETATIVE COVER. ALL OPEN AREAS THAT ARE TO REMAIN IDLE THROUGHOUT THE WINTER SHALL RECEIVE TEMPORARY EROSION CONTROL MEASURES PRIOR TO THE END OF THE FALL GROWING SEASON. AREAS TO BE WORKED AFTER THE GROWING SEASON MUST INCORPORATE STABILIZATION MEASURES THAT DO NOT RELY ON VEGETATIVE COVER.

24. CRITICAL AREAS SHALL BE PERMANENTLY STABILIZED IMMEDIATELY UPON CONCLUSION OF WORK. CRITICAL AREAS SHALL BE DETERMINED BY THE ENGINEER INCLUDING, BUT NOT LIMITED TO THE FOLLOWING:
 - i. STREAMS
 - ii. CREEKS
 - iii. DRAINAGE SWALES
 - iv. STORM SEWER OUTFALLS
25. IT IS THE RESPONSIBILITY OF GENERAL CONTRACTOR TO INFORM ANY SUB-CONTRACTOR(S), WHO MAY PERFORM WORK ON THIS SITE/PROJECT, OF THE REQUIREMENTS IN IMPLEMENTING AND MAINTAINING THESE EROSION CONTROL PLANS AND ENSURE COMPLIANCE WITH ALL APPLICABLE LOCAL, STATE, AND FEDERAL REGULATIONS.
26. ALL DISTURBED AREAS SHALL BE STABILIZED WITH EROSION CONTROL BLANKET (SPECIAL) AS SHOWN ON THE PLANS.
27. EROSION CONTROL BLANKET (SPECIAL) SHALL BE REQUIRED ON ALL INTERIOR DETENTION BASIN SIDE SLOPES BETWEEN NORMAL WATER LEVEL AND HIGH-WATER LEVEL.
28. ALL TEMPORARY EROSION AND SEDIMENT CONTROL MEASURES SHALL BE REMOVED WITHIN 30 DAYS AFTER FINAL SITE STABILIZATION IS ACHIEVED OR AFTER THE TEMPORARY MEASURES ARE NO LONGER NEEDED.
29. DUST CONTROL SHALL BE ACCOMPLISHED USING WATERING TRUCKS AS DIRECTED BY THE ENGINEER. SEE SPECIAL PROVISIONS.
30. TEMPORARY STABILIZATION WITH EROSION CONTROL BLANKET (SPECIAL) SHALL BE USED TO STABILIZE CONSTRUCTION AREAS WHERE CONSTRUCTION ACTIVITY IS HALTED FOR MORE THAN 14 DAYS OR AREAS WHERE THE FINAL GRADE HAS BEEN REACHED BUT CANNOT BE PERMANENTLY STABILIZED DUE TO PLANTING SEASON RESTRICTIONS OF THE PERMANENT STABILIZATION.
31. TEMPORARY FENCING, PERIMETER EROSION BARRIER, AND/OR ROLLED EXCELSIOR SHALL BE PLACED ALONG TREE STANDS TO BE PRESERVED AND TO PREVENT THE BUILD UP OF SEDIMENT ON TOP OF THE TREE ROOTS.
32. WATERS OF THE U.S. AND WETLANDS WITHIN OR ADJACENT TO THE PROJECT SHALL BE PROTECTED WITH PERIMETER EROSION BARRIER.
33. SHEET FLOWS EXITING THE SITE SHALL ENCOUNTER PERIMETER EROSION BARRIER.
34. STABILIZED CONSTRUCTION ENTRANCES SHALL BE CONSTRUCTED AT ALL LOCATIONS WHERE CONSTRUCTION TRAFFIC ENTERS OR EXITS THE SITE AS NEEDED OR DETERMINED BY THE ENGINEER.
35. TEMPORARY STREAM CROSSINGS WILL NOT BE ALLOWED, EXCEPT AS PROVIDED FOR IN THE U.S. ARMY CORPS OF ENGINEERS 404 PERMIT.
36. ALL SESC MEASURES PROTECTING AQUATIC RESOURCES SHALL BE IN PLACE AND PROPERLY FUNCTIONAL AT THE END OF EACH WORK DAY.

C. MAINTENANCE

THE FOLLOWING IS A DESCRIPTION OF PROCEDURES THAT SHALL BE USED TO MAINTAIN, IN GOOD AND EFFECTIVE OPERATING CONDITIONS, VEGETATION, SOIL EROSION AND SEDIMENT CONTROL MEASURES, AND OTHER PROTECTIVE MEASURES IDENTIFIED IN THIS PLAN AND STANDARD SPECIFICATIONS:

THE CONTRACTOR SHALL ASSIGN A SOIL EROSION AND SEDIMENT CONTROL MANAGER (SESCM) TO THE PROJECT. HIS DUTIES WILL BE TO SUPERVISE THE MAINTENANCE OF THE SOIL EROSION AND SEDIMENT CONTROL MEASURES AND IMPLEMENTATION OF THIS PLAN.

THE FOLLOWING SHALL BE THE MINIMUM MAINTENANCE REQUIRED:

1. VEGETATION SOIL EROSION MEASURES - THE VEGETATIVE GROWTH OF TEMPORARY AND PERMANENT SEEDING, VEGETATIVE FILTERS, ETC. SHALL BE MAINTAINED PERIODICALLY AND SUPPLIED ADEQUATE WATERING AND FERTILIZER. THE VEGETATIVE COVER SHALL BE REMOVED AND RESEEDED AS NECESSARY.
2. PUMPING BASINS, IF REQUIRED SHALL BE CLEANED OF SEDIMENT WHEN THE SEDIMENT HAS REACHED A DEPTH OF 50% OF THE HEIGHT/DEPTH OF THE BASIN.
3. PERIMETER EROSION BARRIER (SILT FENCE) - MAINTAIN AND REPAIR TEARS, GAPS, UNDERMINING, REPLACE BROKEN OR MISPLACED STAKES, SEDIMENT ACCUMULATION SHALL BE REMOVED WHEN IT HAS REACHED 1/3 THE HEIGHT OF THE BARRIER.
4. TEMPORARY SEEDING FOR EROSION CONTROL SHALL BE REPAIRED WHEN BARE SPOTS AND WASHOUT OCCUR.
5. STABILIZED CONSTRUCTION ENTRANCES SHALL HAVE SEDIMENT BUILD UP REMOVED AS NECESSARY.
6. EROSION CONTROL BLANKET (SPECIAL) - MAINTAIN AND REPAIR DAMAGE DUE TO WATER, SOIL DISPLACEMENT, AND/OR IMPROPER INSTALLATION.
7. CONCRETE WASHOUT - ALL CONTAINED MATERIALS SHALL BE REMOVED AND DISPOSED OF AT LEGAL OFF-SITE LOCATION WHEN THE WASHOUT HAS REACHED 50% CAPACITY.
8. DITCH CHECKS - SEDIMENT ACCUMULATION SHALL BE REMOVED WHEN IT HAS REACHED 50% OF THE HEIGHT OF THE STRUCTURE OR AS RECOMMENDED BY THE MANUFACTURER, WHICHEVER IS LESS.
9. MAINTENANCE, REPAIR, REPLACEMENT OF EROSION AND SEDIMENT CONTROL MEASURES, AND DISPOSAL OF SEDIMENT SHALL NOT BE MEASURED SEPARATELY FOR PAYMENT, BUT SHALL BE CONSIDERED INCLUDED IN THE CONTRACT UNIT PRICE OF THE VARIOUS ITEMS AS BID.

D. INSPECTIONS

1. ALL EROSION AND SEDIMENT CONTROL MEASURES SHALL BE INSPECTED BY A QUALIFIED PERSON. A QUALIFIED PERSON SHALL BE IDENTIFIED AS A PERSON KNOWLEDGABLE IN THE PRINCIPLES AND PRACTICES OF EROSION AND SEDIMENT CONTROL MEASURES, SUCH AS A LICENSED PROFESSIONAL ENGINEER (P.E.), A CERTIFIED PROFESSIONAL IN EROSION AND SEDIMENT CONTROL (CPESC), A CERTIFIED EROSION SEDIMENT AND STORM WATER INSPECTOR (CESSWI), OR OTHER KNOWLEDGABLE PERSON.
2. ALL SESC MEASURES AND AQUATIC RESOURCES WITHING THE SITE SHALL BE INSPECTED A MINIMUM OF ONCE EVERY SEVEN (7) CALENDAR DAYS AND WITHIN 24 HOURS (OR BY THE FOLLOWING WORKING DAY) OF THE END OF A RAIN EVENT OF 0.5 INCHES OR GREATER.
3. THE CONTRACTOR SHALL PERMIT SITE ACCESS TO REPRESENTATIVE OF THE ENGINEER, OWNER, SOIL AND WATER CONSERVATION DISTRICT, ENVIRONMENTAL PROTECTION AGENCY, U.S. ARMY CORPS OF ENGINEERS.
4. THE PROJECT WILL BE ELIGIBLE FOR A NOTICE OF TERMINATION WITH THE IEPA ONCE FULL SITE STABILIZATION IS MET. THE PROJECT WILL BE ELIGIBLE FOR WCSWCD CLOSEOUT ONCE 70% UNIFORM PERENNIAL VEGETATION COVERAGE IS ESTABLISHED.

SEEDING AND STABILIZATION SCHEDULE

STABILIZATION TYPE	JAN.	FEB.	MAR.	APR.	MAY	JUNE	JULY	AUG.	SEPT.	OCT.	NOV.	DEC.
PERMANENT SEEDING				A				A				
TEMPORARY SEEDING			B									
TEMPORARY STABILIZATION	C											

- A. PERMANENT SEEDING (PER PLANTING PLAN) APRIL 1 TO JUNE 15 & AUGUST 1 TO NOVEMBER 1
- B. TEMPORARY SEEDING PERENNIAL RYE GRASS, SPRING OATS (50 LB/ACRE MIN.)
- C. EROSION CONTROL BLANKET (SPECIAL)



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STATE OF ILLINOIS
DEPARTMENT OF TRANSPORTATION

SOIL EROSION AND SEDIMENT CONTROL PLAN
GENERAL NOTES AND LEGEND




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F.A.U. RTE.	SECTION	COUNTY	TOTAL SHEETS	SHEET NO.
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CONTRACT NO. 61H20				
ILLINOIS		FED. AID PROJECT		

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	INLET PROTECTION, SPECIAL (X2800500) (EACH)		PERIMETER EROSION BARRIER (28000400) (FOOT)		STONE RIPRAP W/FILTER FABRIC (SEE TABLE ON SHEET 185 FOR RIPRAP DETAILS INCLUDING CLASS, DEPTH, AND OTHER DIMENSIONS)
	INLET FILTERS (28000510) (EACH)		EROSION CONTROL BLANKET (SPECIAL) / TEMPORARY SEEDING		
	TEMPORARY DITCH CHECKS (28000305) (FOOT)		WORK ZONE / TEMP PAVEMENT (SEE MOT PLANS)		

NOTES:
 1. STAGE OF INSTALLATION IS REPRESENTED NEXT TO THE CORRESPONDING SYMBOL. (i.e. "P" FOR PRE-STAGE, "1" FOR STAGE 1, AND "2" FOR STAGE 2.)
 2. THE CONTRACTOR SHALL FINALIZE GRADING OPERATIONS AND INSTALL PERMANENT STABILIZATION MEASURES (SEE LANDSCAPING PLANS) AS SOON AS POSSIBLE. A CONTRACT QUANTITY REPRESENTING 25% OF THE TOTAL DISTURBED AREA IS PROVIDED FOR EROSION CONTROL BLANKET (SPECIAL) AND TEMPORARY SEEDING FOR TEMPORARY STABILIZATION.






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**STATE OF ILLINOIS
 DEPARTMENT OF TRANSPORTATION**

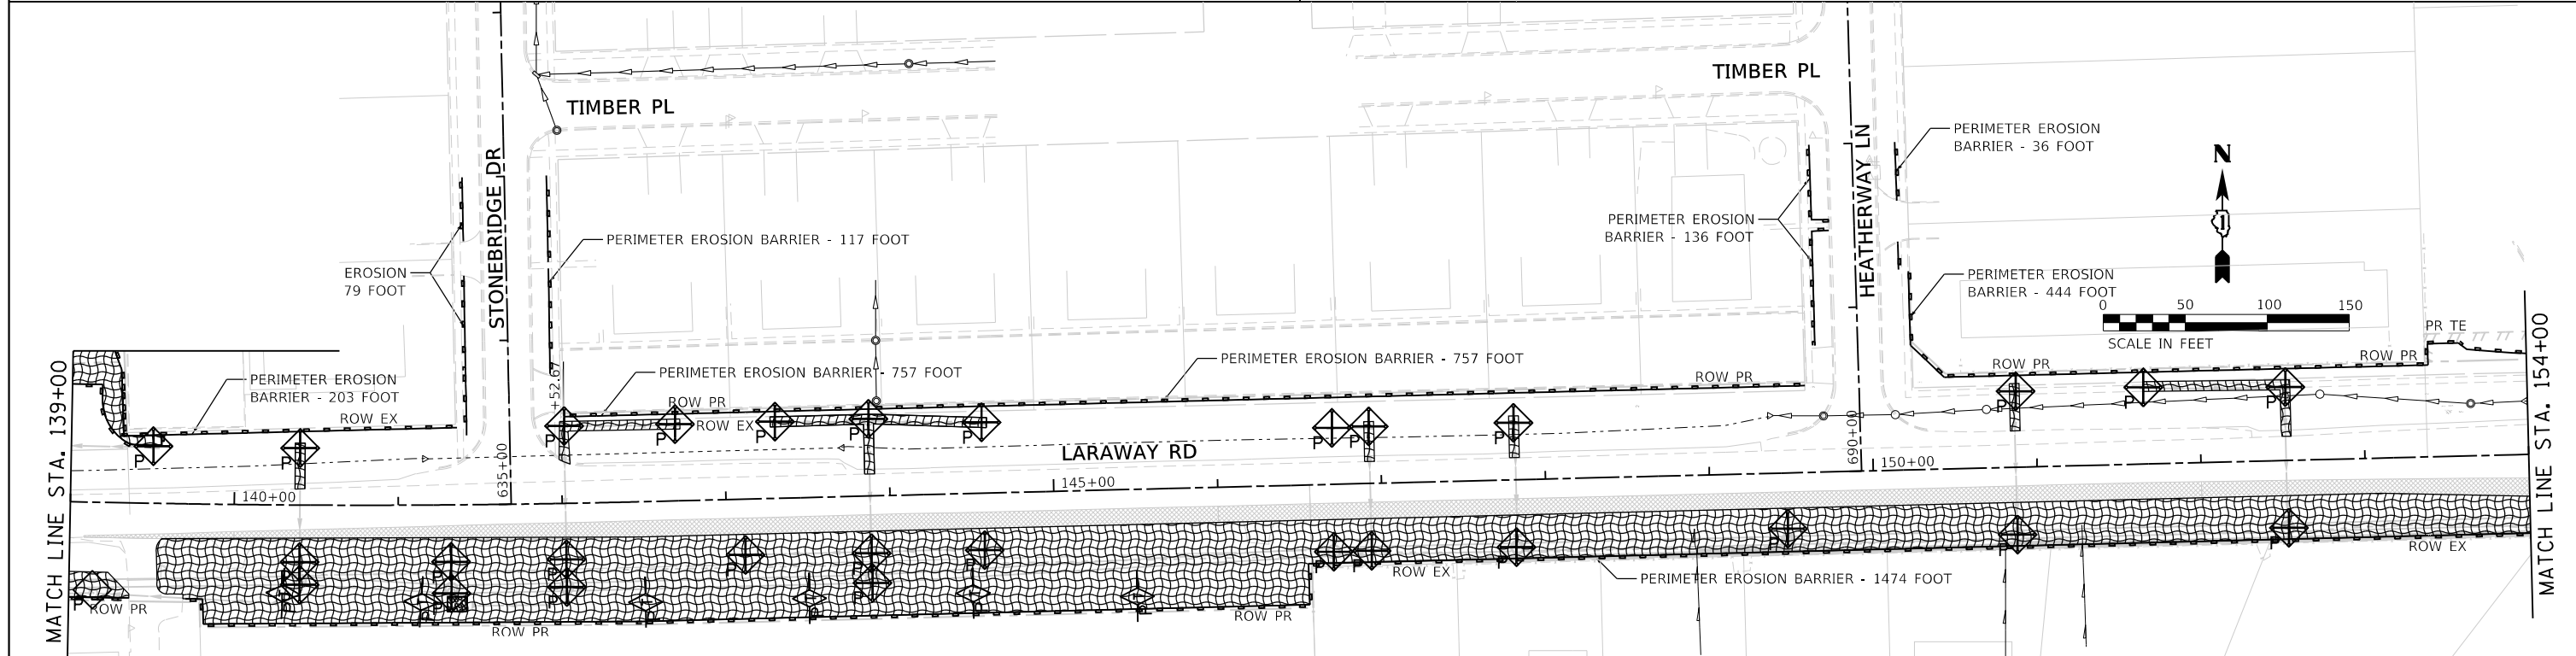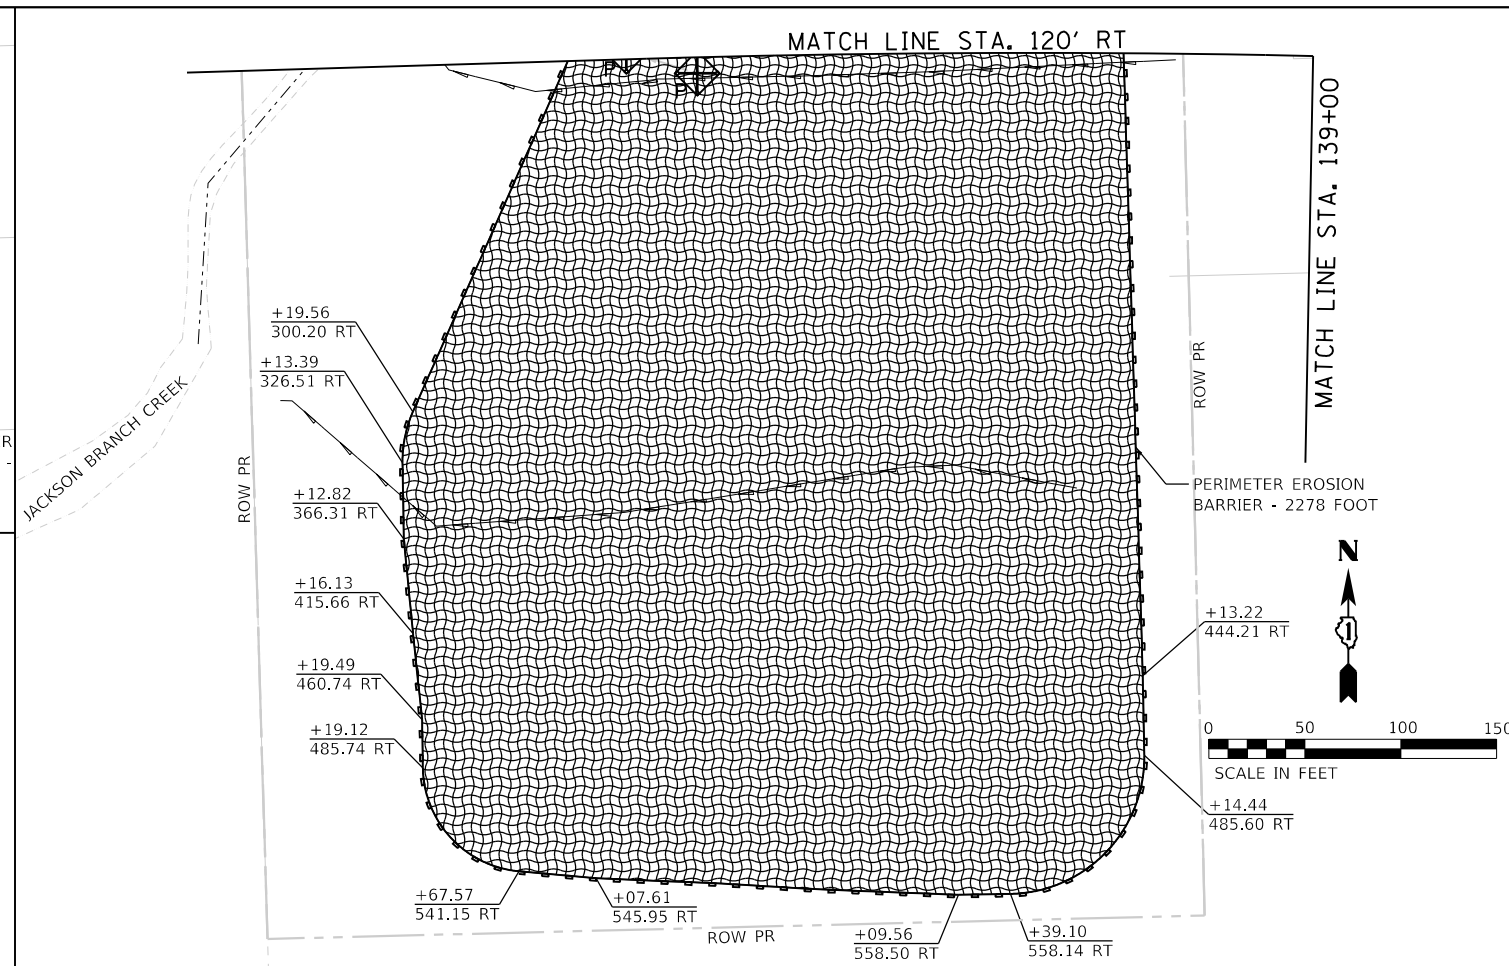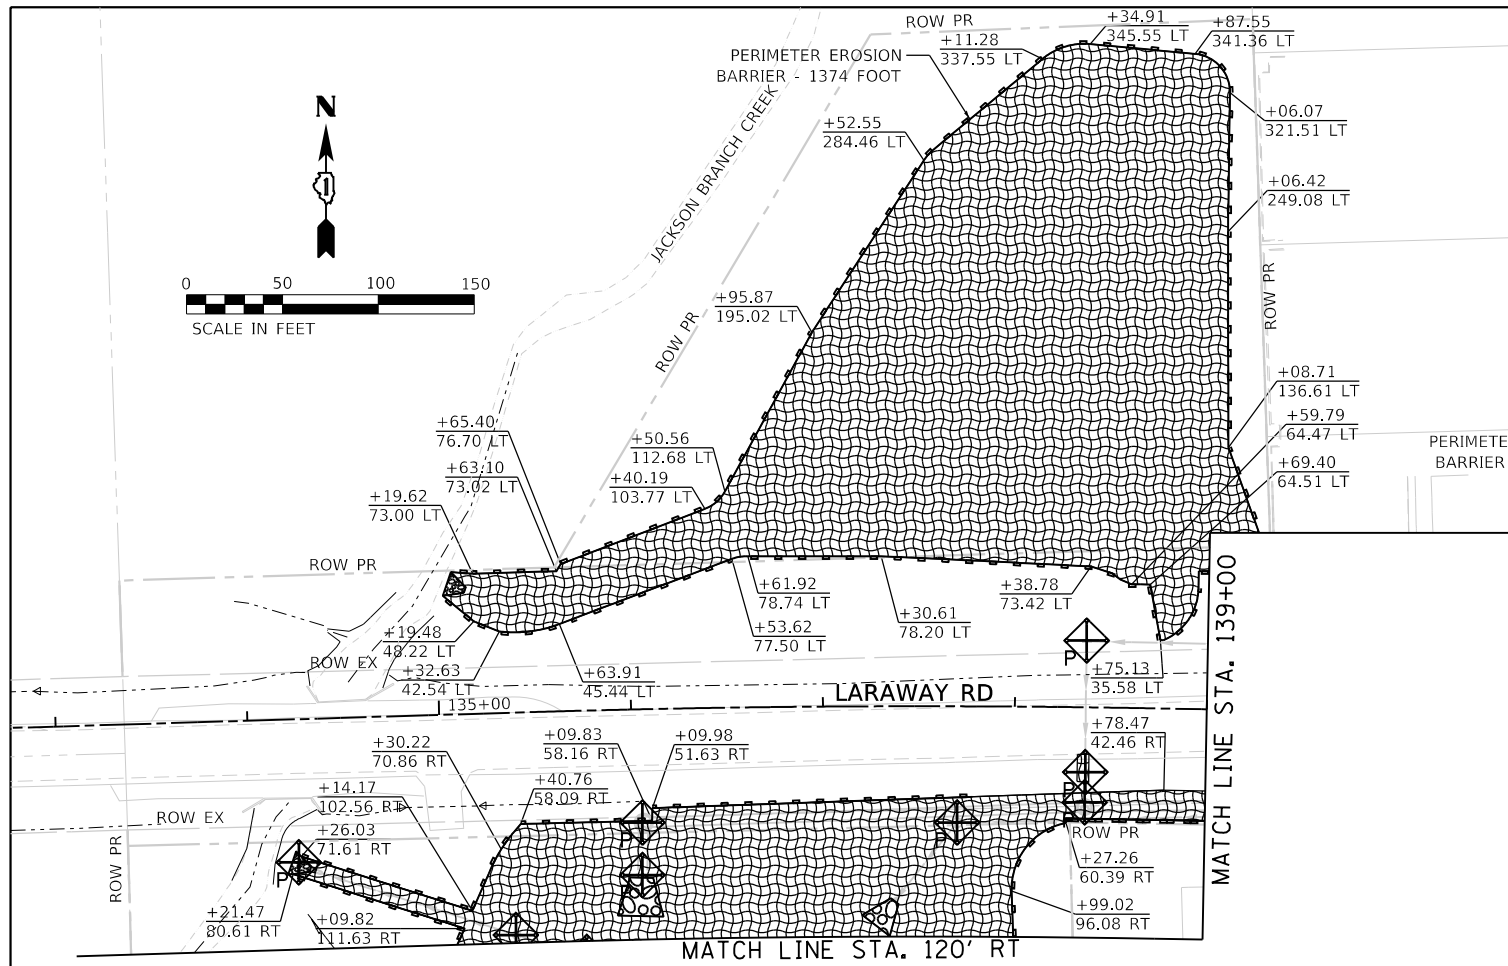**SOIL EROSION AND SEDIMENT CONTROL PLAN
 LARAWAY RD - PRE STAGE**
 SCALE: 1"=50'
 SHEET 1 OF 4 SHEETS
 STA. 13400 TO STA. 15400

F.A.U. RTE. = 0320	SECTION = 13-00138-37-PV	COUNTY = WILL	TOTAL SHEETS = 413	SHEET NO. = 173
CONTRACT NO. 61H20				
ILLINOIS FED. AID PROJECT				

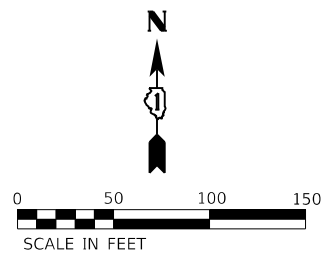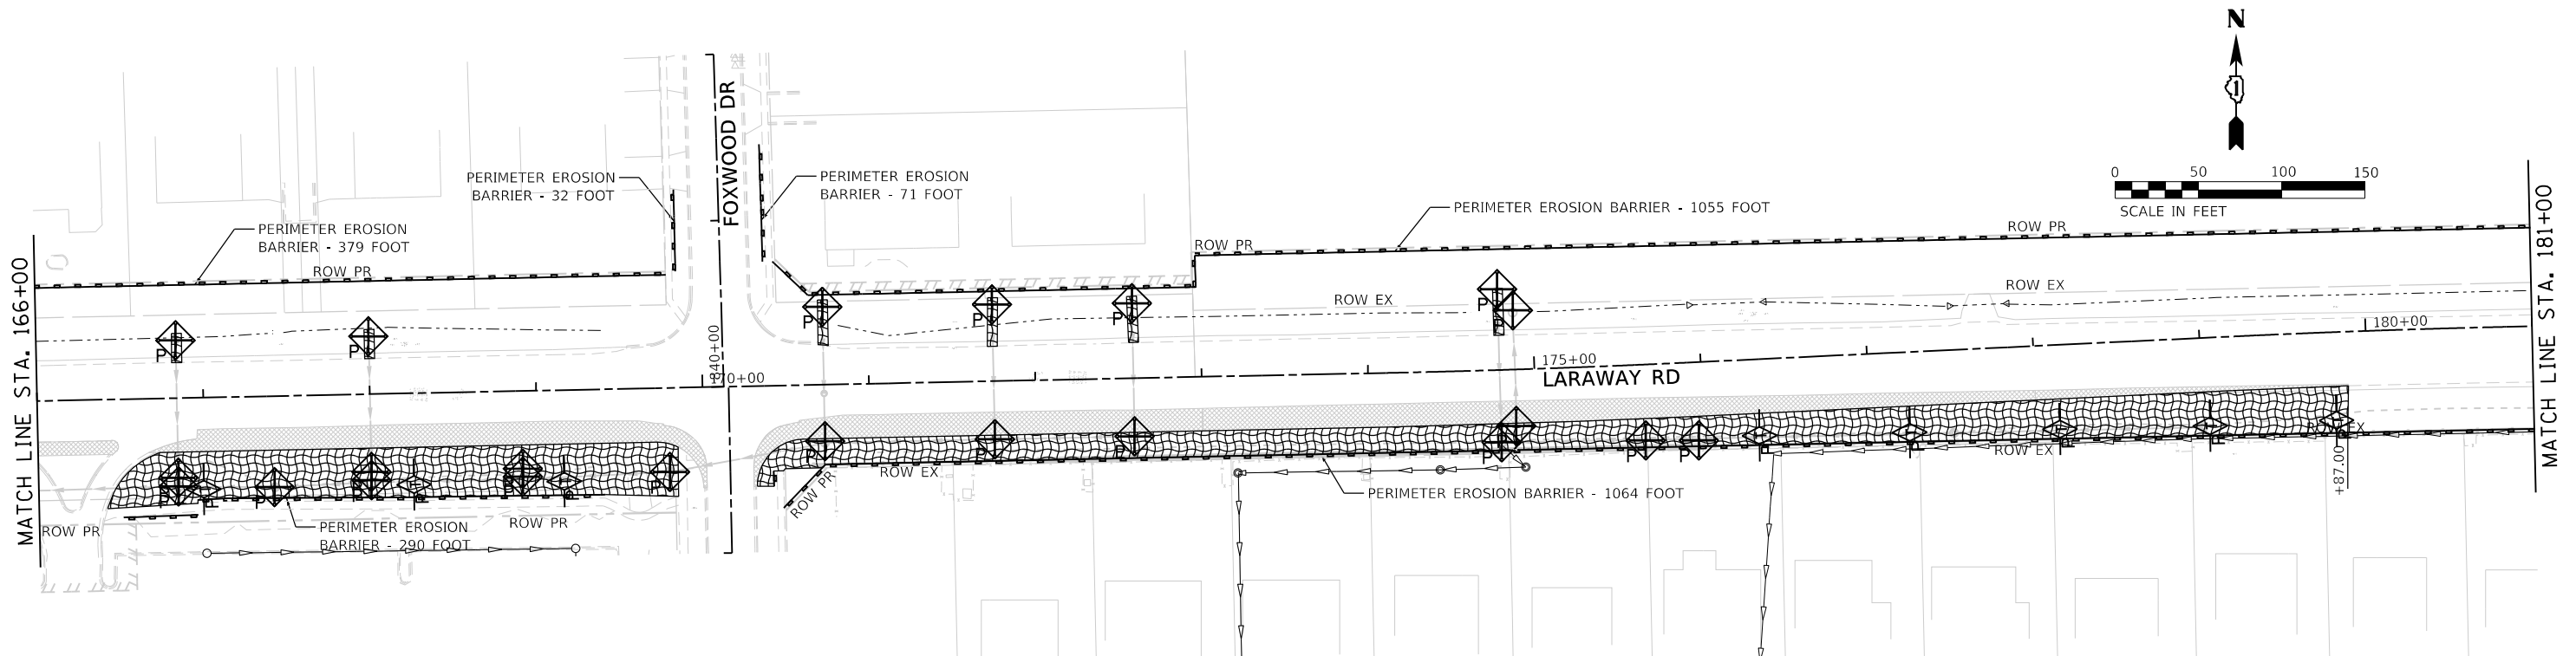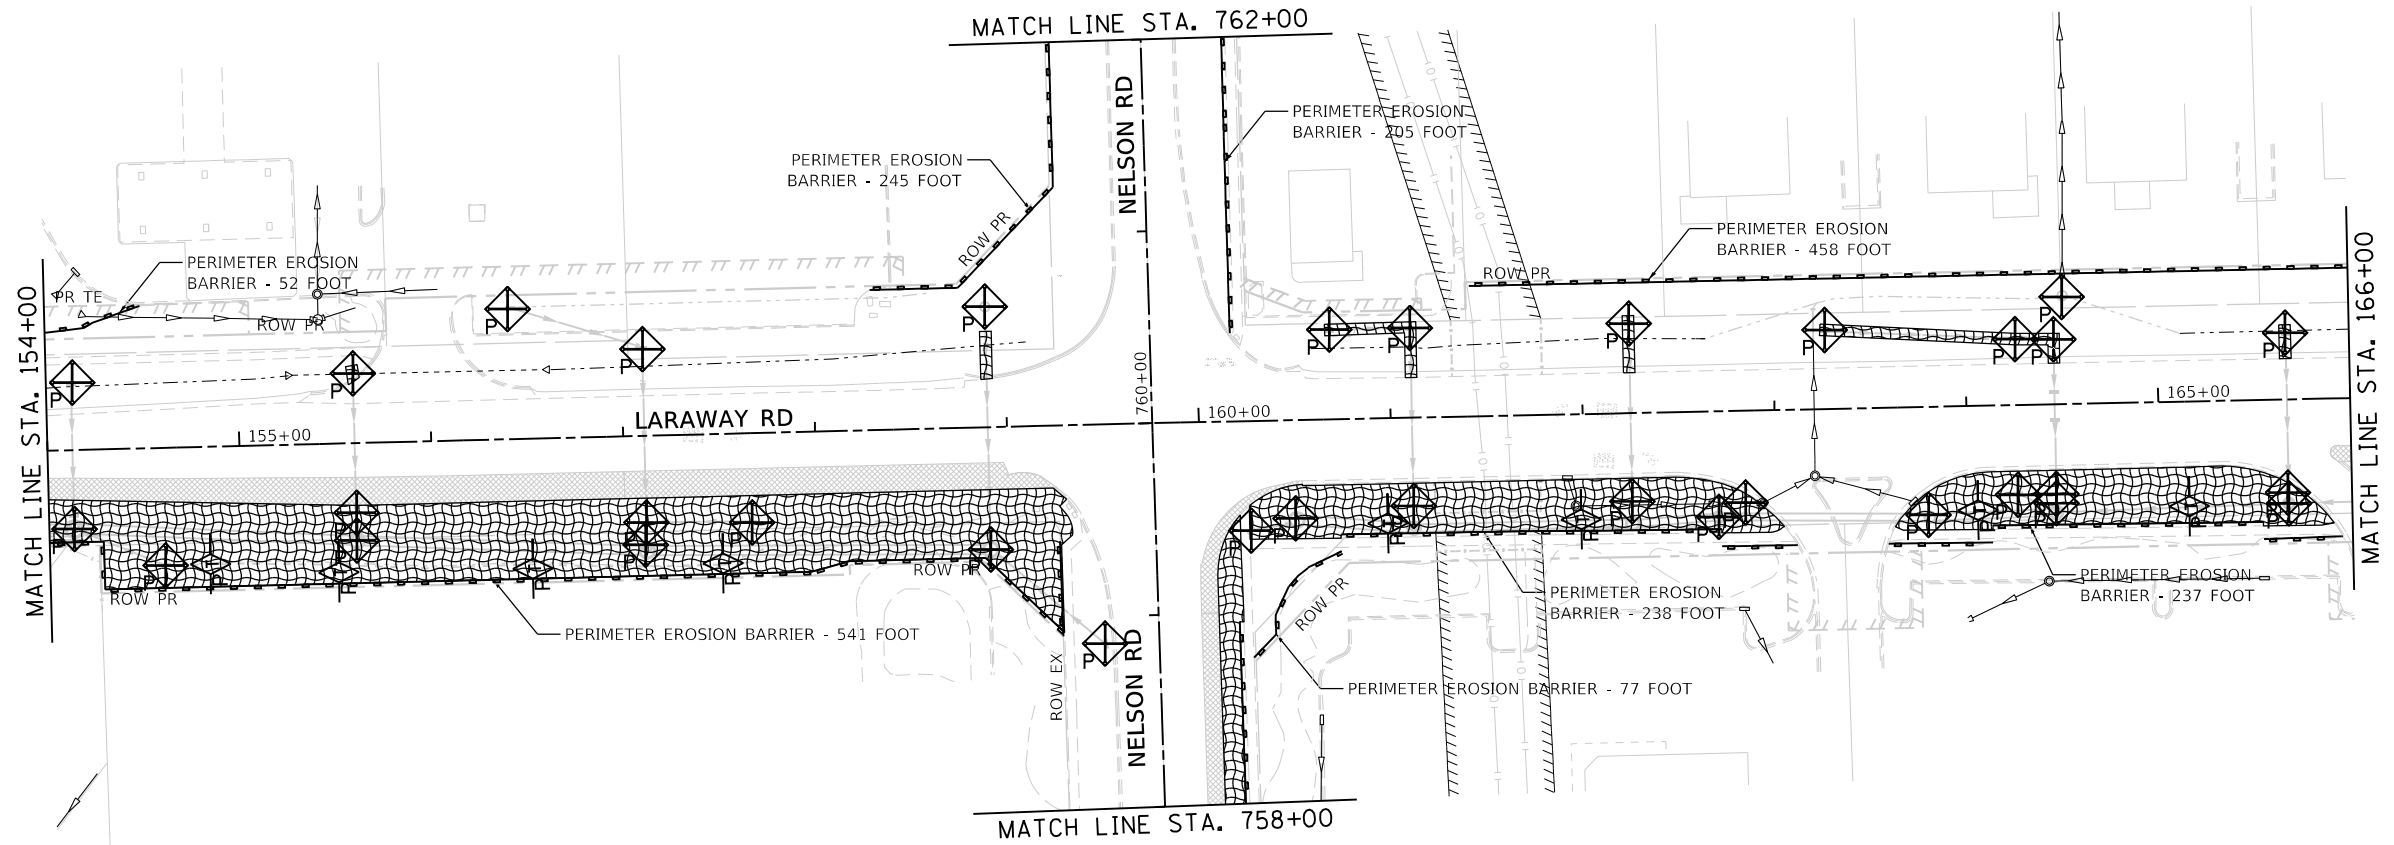

	INLET PROTECTION, SPECIAL (X2800500) (EACH)		PERIMETER EROSION BARRIER (28000400) (FOOT)		STONE RIPRAP W/FILTER FABRIC (SEE TABLE ON SHEET 185 FOR RIPRAP DETAILS INCLUDING CLASS, DEPTH, AND OTHER DIMENSIONS)
	INLET FILTERS (28000510) (EACH)		EROSION CONTROL BLANKET (SPECIAL) / TEMPORARY SEEDING		
	TEMPORARY DITCH CHECKS (28000305) (FOOT)		WORK ZONE / TEMP PAVEMENT (SEE MOT PLANS)		

NOTES:
 1. STAGE OF INSTALLATION IS REPRESENTED NEXT TO THE CORRESPONDING SYMBOL. (i.e. "P" FOR PRE-STAGE, "1" FOR STAGE 1, AND "2" FOR STAGE 2.)
 2. THE CONTRACTOR SHALL FINALIZE GRADING OPERATIONS AND INSTALL PERMANENT STABILIZATION MEASURES (SEE LANDSCAPING PLANS) AS SOON AS POSSIBLE. A CONTRACT QUANTITY REPRESENTING 25% OF THE TOTAL DISTURBED AREA IS PROVIDED FOR EROSION CONTROL BLANKET (SPECIAL) AND TEMPORARY SEEDING FOR TEMPORARY STABILIZATION.



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**STATE OF ILLINOIS
DEPARTMENT OF TRANSPORTATION**



**SOIL EROSION AND SEDIMENT CONTROL PLAN
LARAWAY RD - PRE STAGE**
 SCALE: 1"=50' SHEET 2 OF 4 SHEETS STA. 15400 TO STA. 18100

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CONTRACT NO. 61H20				
ILLINOIS FED. AID PROJECT				

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	INLET PROTECTION, SPECIAL (X2800500) (EACH)		PERIMETER EROSION BARRIER (28000400) (FOOT)		STONE RIPRAP W/FILTER FABRIC (SEE TABLE ON SHEET 185 FOR RIPRAP DETAILS INCLUDING CLASS, DEPTH, AND OTHER DIMENSIONS)
	INLET FILTERS (28000510) (EACH)		EROSION CONTROL BLANKET (SPECIAL) / TEMPORARY SEEDING		WORK ZONE / TEMP PAVEMENT (SEE MOT PLANS)
	TEMPORARY DITCH CHECKS (28000305) (FOOT)				

NOTES:
 1. STAGE OF INSTALLATION IS REPRESENTED NEXT TO THE CORRESPONDING SYMBOL. (i.e. "P" FOR PRE-STAGE, "1" FOR STAGE 1, AND "2" FOR STAGE 2.)
 2. THE CONTRACTOR SHALL FINALIZE GRADING OPERATIONS AND INSTALL PERMANENT STABILIZATION MEASURES (SEE LANDSCAPING PLANS) AS SOON AS POSSIBLE. A CONTRACT QUANTITY REPRESENTING 25% OF THE TOTAL DISTURBED AREA IS PROVIDED FOR EROSION CONTROL BLANKET (SPECIAL) AND TEMPORARY SEEDING FOR TEMPORARY STABILIZATION.



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**STATE OF ILLINOIS
 DEPARTMENT OF TRANSPORTATION**

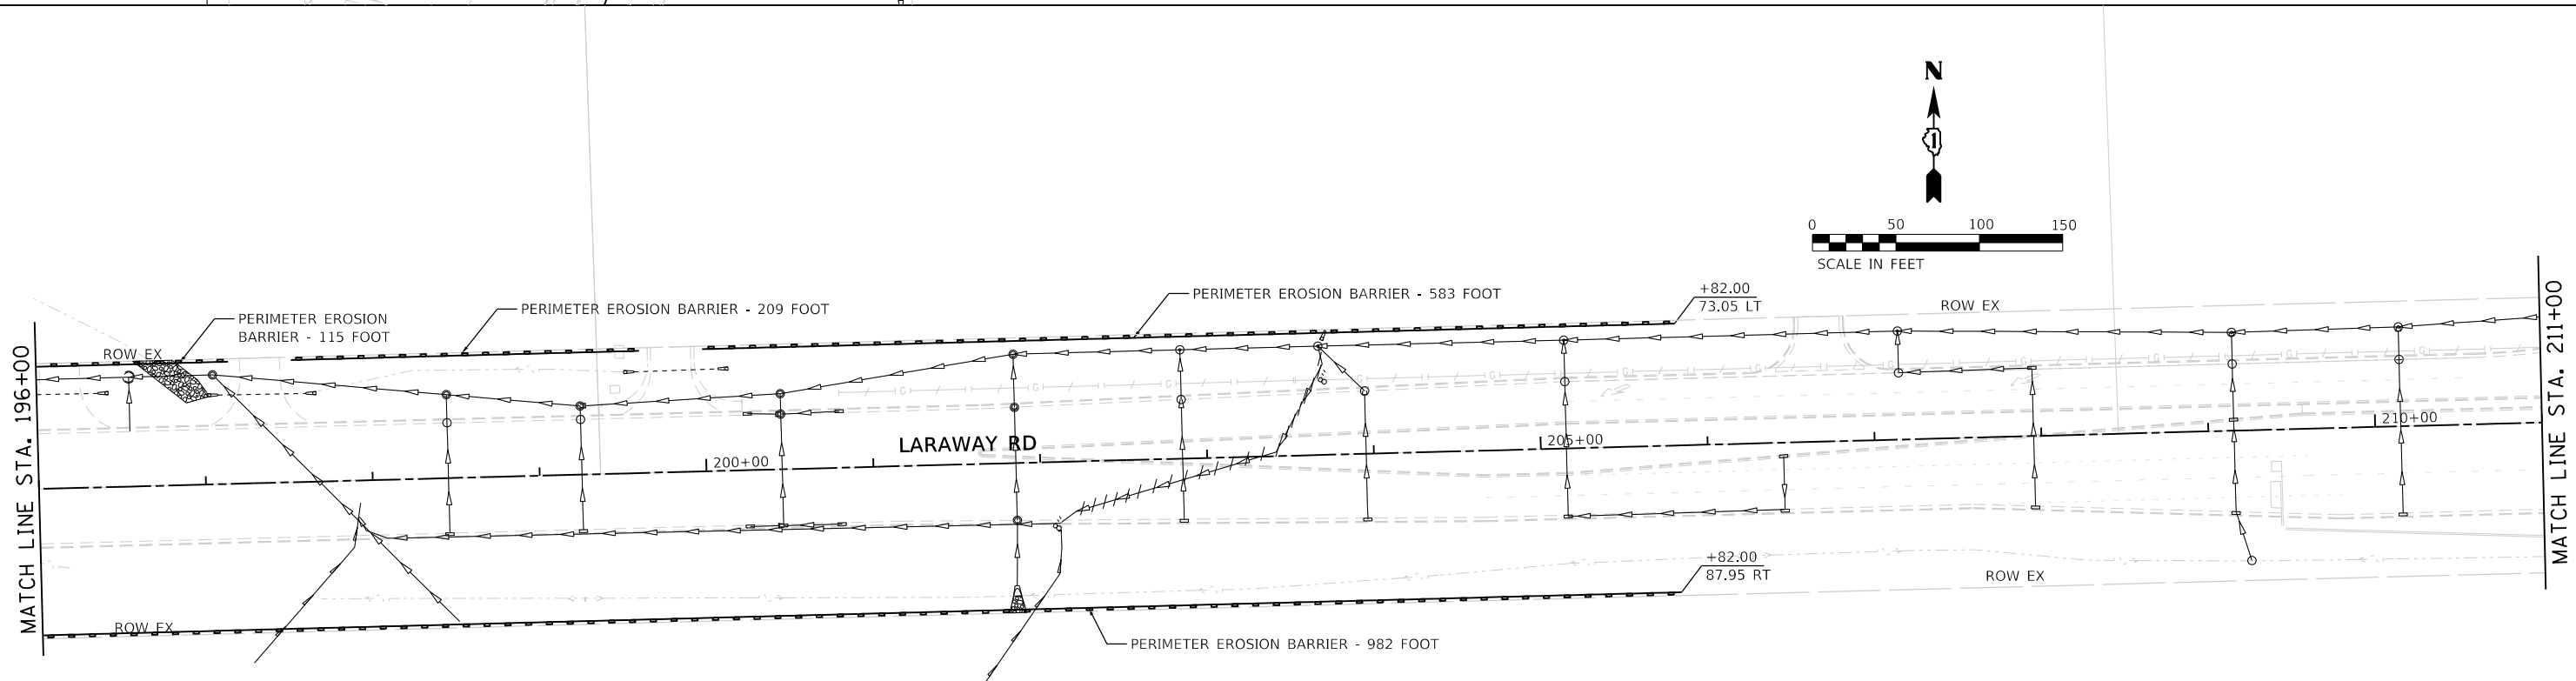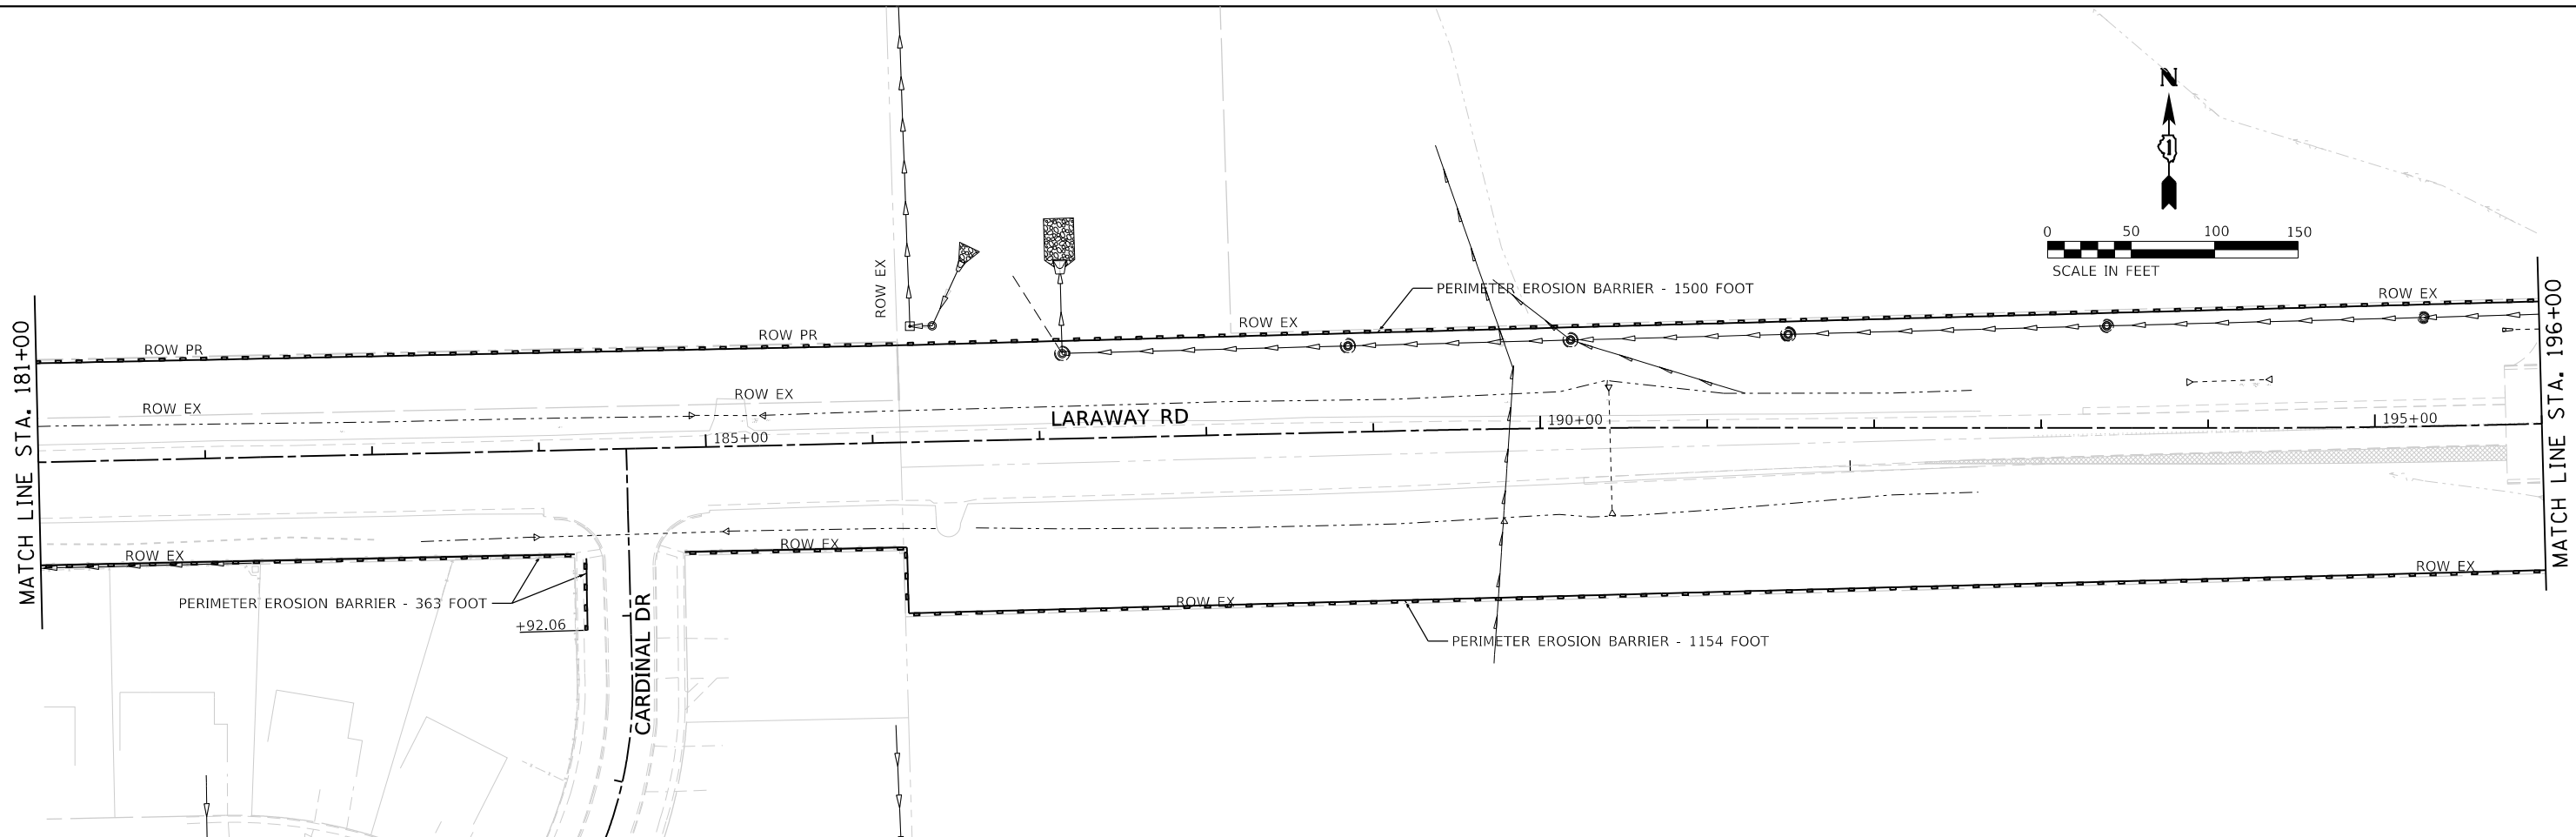**SOIL EROSION AND SEDIMENT CONTROL PLAN
 LARAWAY RD - PRE STAGE**



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F.A.U. RTE.	SECTION	COUNTY	TOTAL SHEETS	SHEET NO.
0320	13-00138-37-PV	WILL	413	175
CONTRACT NO. 61H20				
ILLINOIS FED. AID PROJECT				



	INLET PROTECTION, SPECIAL (X2800500) (EACH)		PERIMETER EROSION BARRIER (28000400) (FOOT)		STONE RIPRAP W/FILTER FABRIC (SEE TABLE ON SHEET 185 FOR RIPRAP DETAILS INCLUDING CLASS, DEPTH, AND OTHER DIMENSIONS)
	INLET FILTERS (28000510) (EACH)		EROSION CONTROL BLANKET (SPECIAL) / TEMPORARY SEEDING		
	TEMPORARY DITCH CHECKS (28000305) (FOOT)		WORK ZONE / TEMP PAVEMENT (SEE MOT PLANS)		

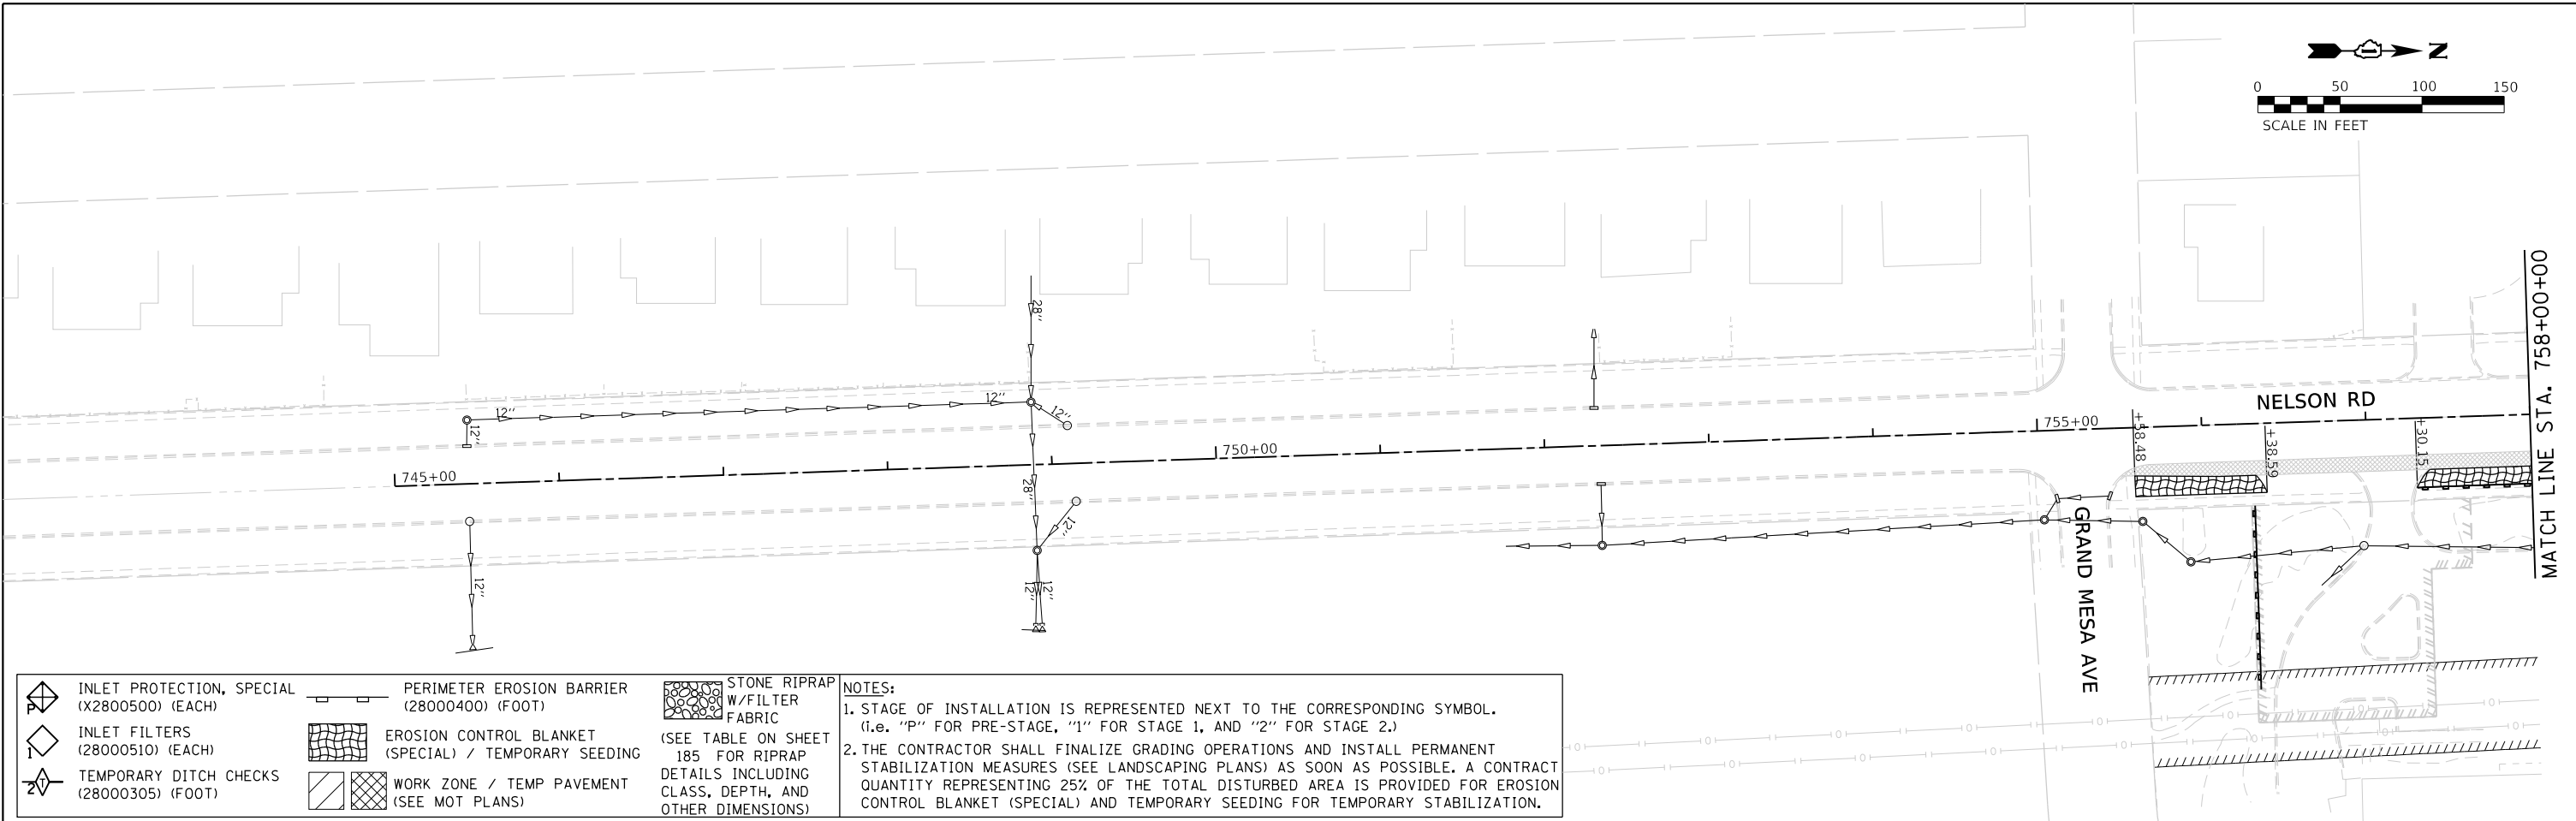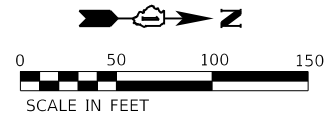NOTES:
 1. STAGE OF INSTALLATION IS REPRESENTED NEXT TO THE CORRESPONDING SYMBOL. (i.e. "P" FOR PRE-STAGE, "1" FOR STAGE 1, AND "2" FOR STAGE 2.)
 2. THE CONTRACTOR SHALL FINALIZE GRADING OPERATIONS AND INSTALL PERMANENT STABILIZATION MEASURES (SEE LANDSCAPING PLANS) AS SOON AS POSSIBLE. A CONTRACT QUANTITY REPRESENTING 25% OF THE TOTAL DISTURBED AREA IS PROVIDED FOR EROSION CONTROL BLANKET (SPECIAL) AND TEMPORARY SEEDING FOR TEMPORARY STABILIZATION.

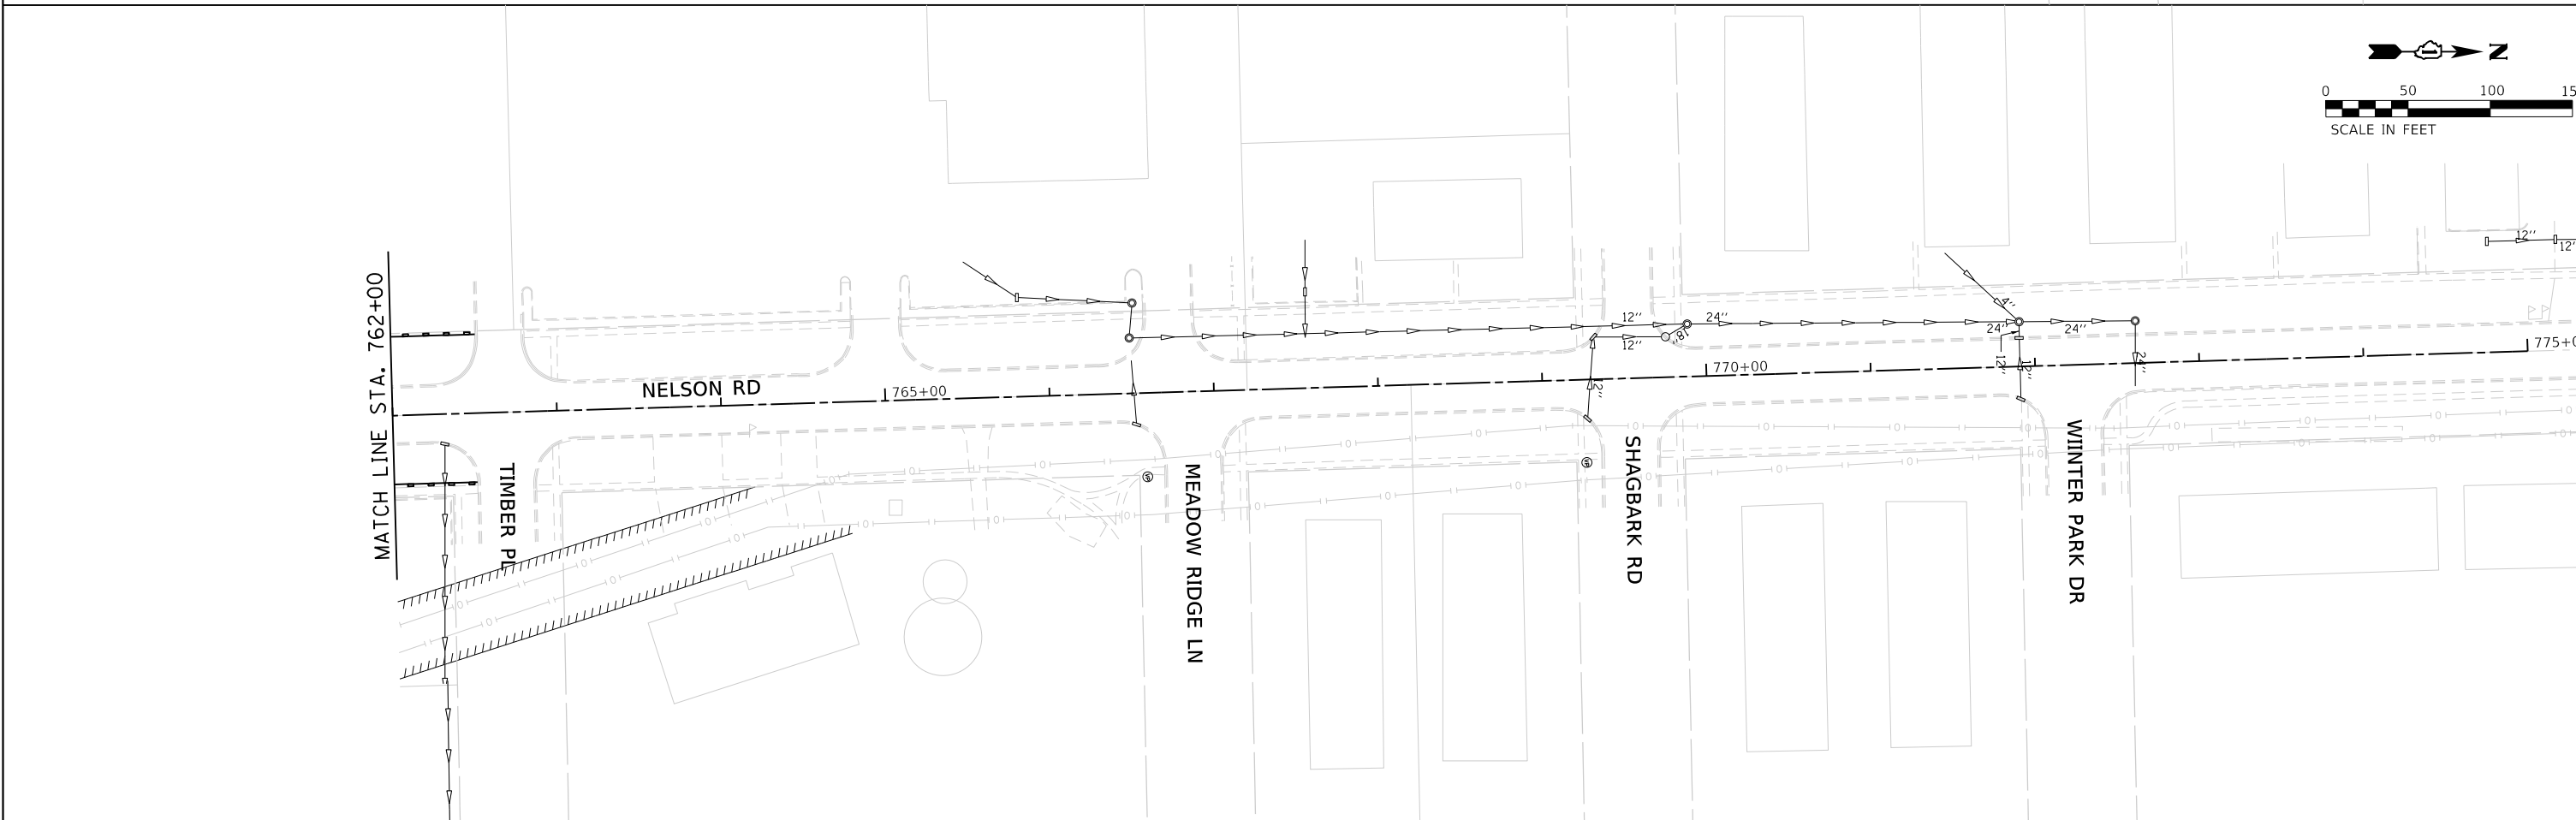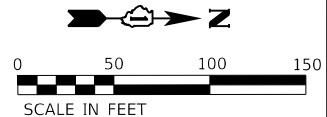

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**STATE OF ILLINOIS
DEPARTMENT OF TRANSPORTATION**

**SOIL EROSION AND SEDIMENT CONTROL PLAN
NELSON RD - PRE STAGE**

SCALE: 1"=50' SHEET 4 OF 4 SHEETS STA. 74500 TO STA. 77500

F.A.U. RTE.	SECTION	COUNTY	TOTAL SHEETS	SHEET NO.
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CONTRACT NO. 61H20				
ILLINOIS FED. AID PROJECT				









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NOTE:
 SEE PRE-STAGE SOIL EROSION AND SEDIMENT CONTROL PLAN SHEETS FOR PERIMETER EROSION BARRIER LAYOUT INFO



	INLET PROTECTION, SPECIAL (X2800500) (EACH)		PERIMETER EROSION BARRIER (28000400) (FOOT)		STONE RIPRAP W/FILTER FABRIC (SEE TABLE ON SHEET 185 FOR RIPRAP DETAILS INCLUDING CLASS, DEPTH, AND OTHER DIMENSIONS)
	INLET FILTERS (28000510) (EACH)		EROSION CONTROL BLANKET (SPECIAL) / TEMPORARY SEEDING		WORK ZONE / TEMP PAVEMENT (SEE MOT PLANS)
	TEMPORARY DITCH CHECKS (28000305) (FOOT)				

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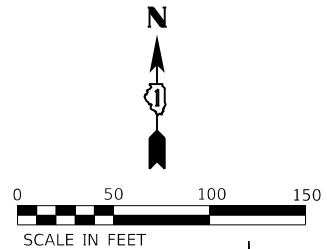
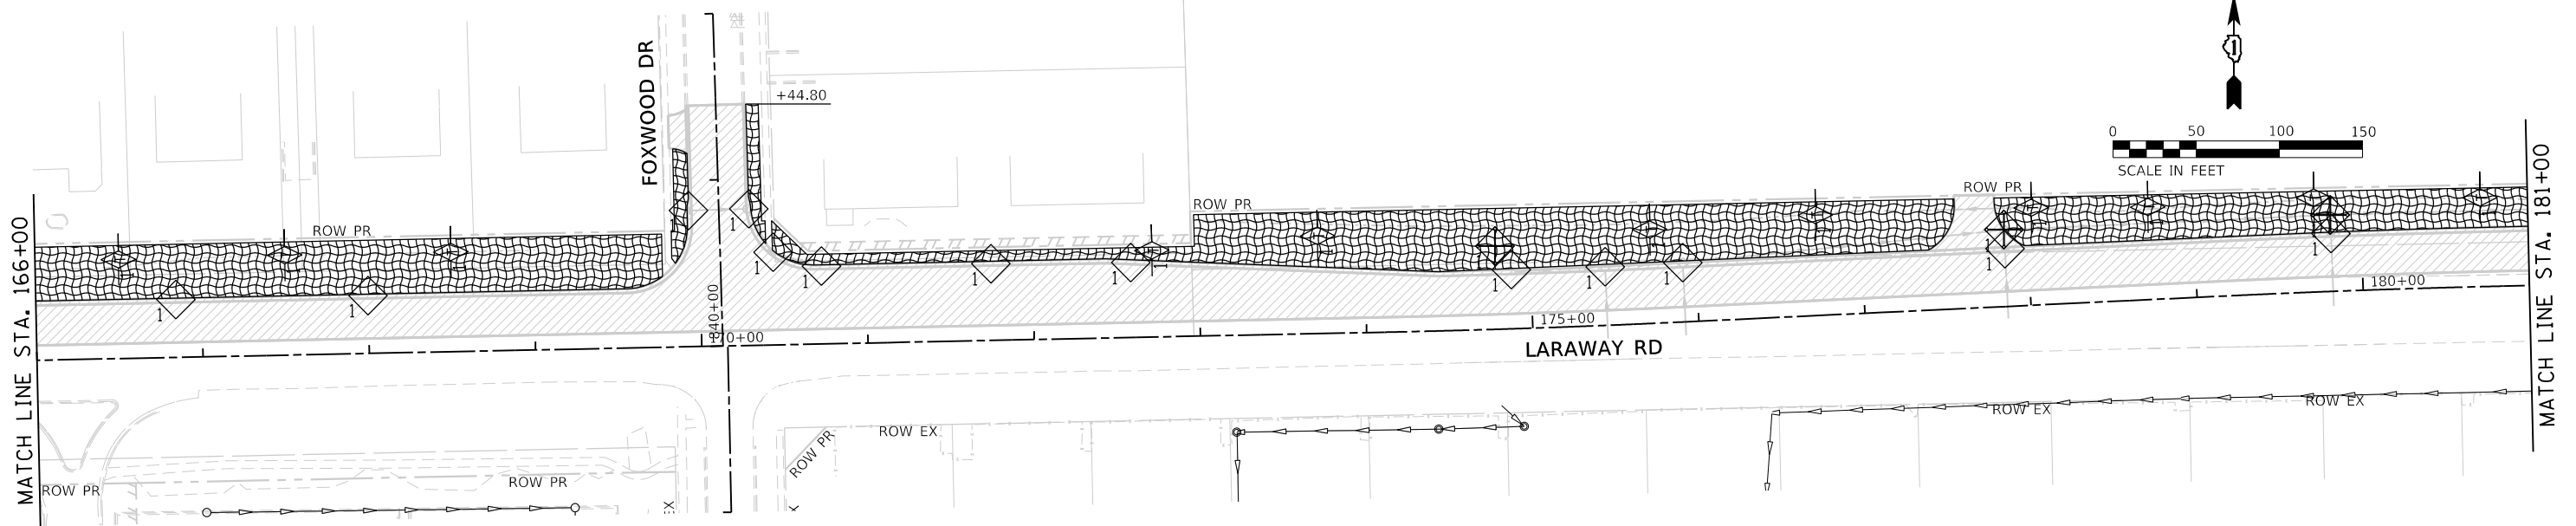
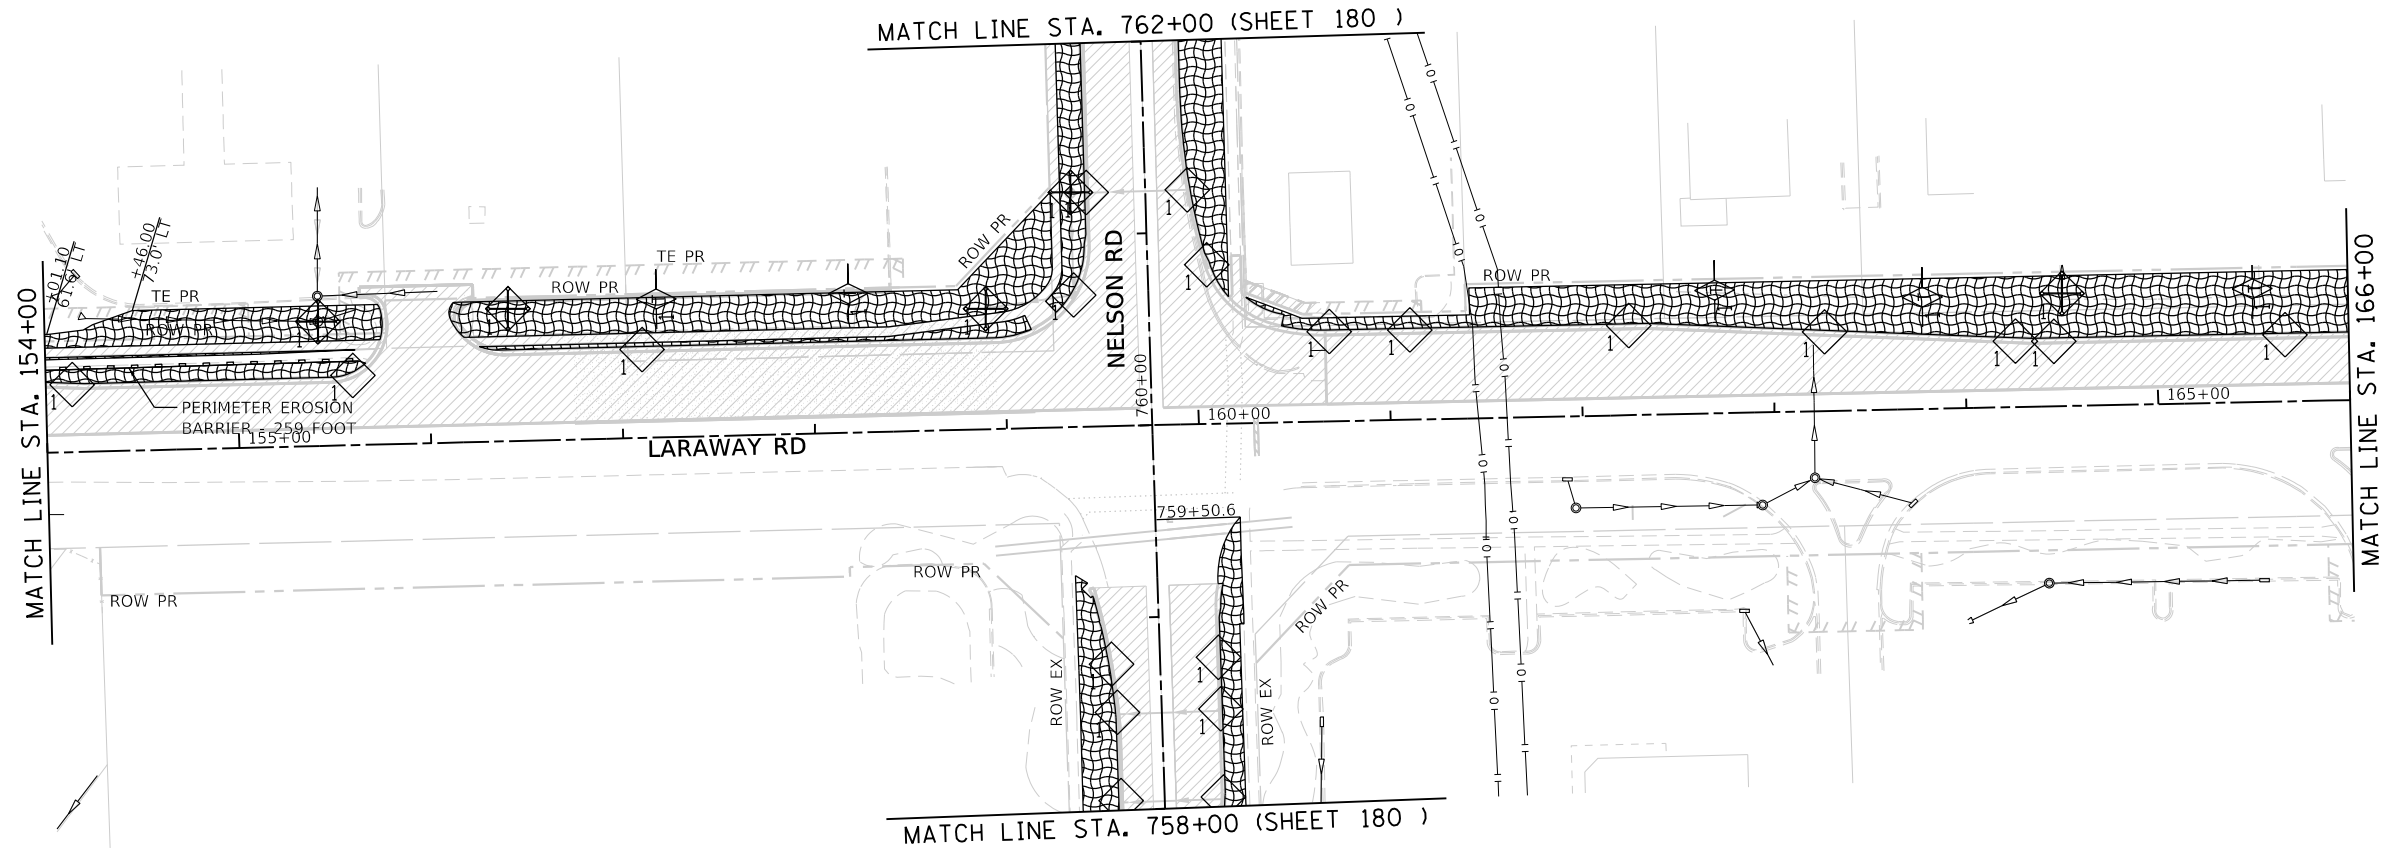
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STATE OF ILLINOIS
 DEPARTMENT OF TRANSPORTATION

SOIL EROSION AND SEDIMENT CONTROL PLAN
 LARAWAY RD - STAGE 1

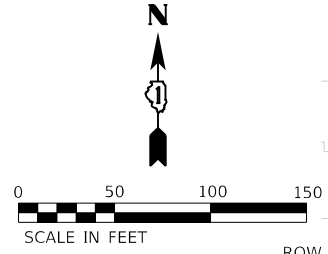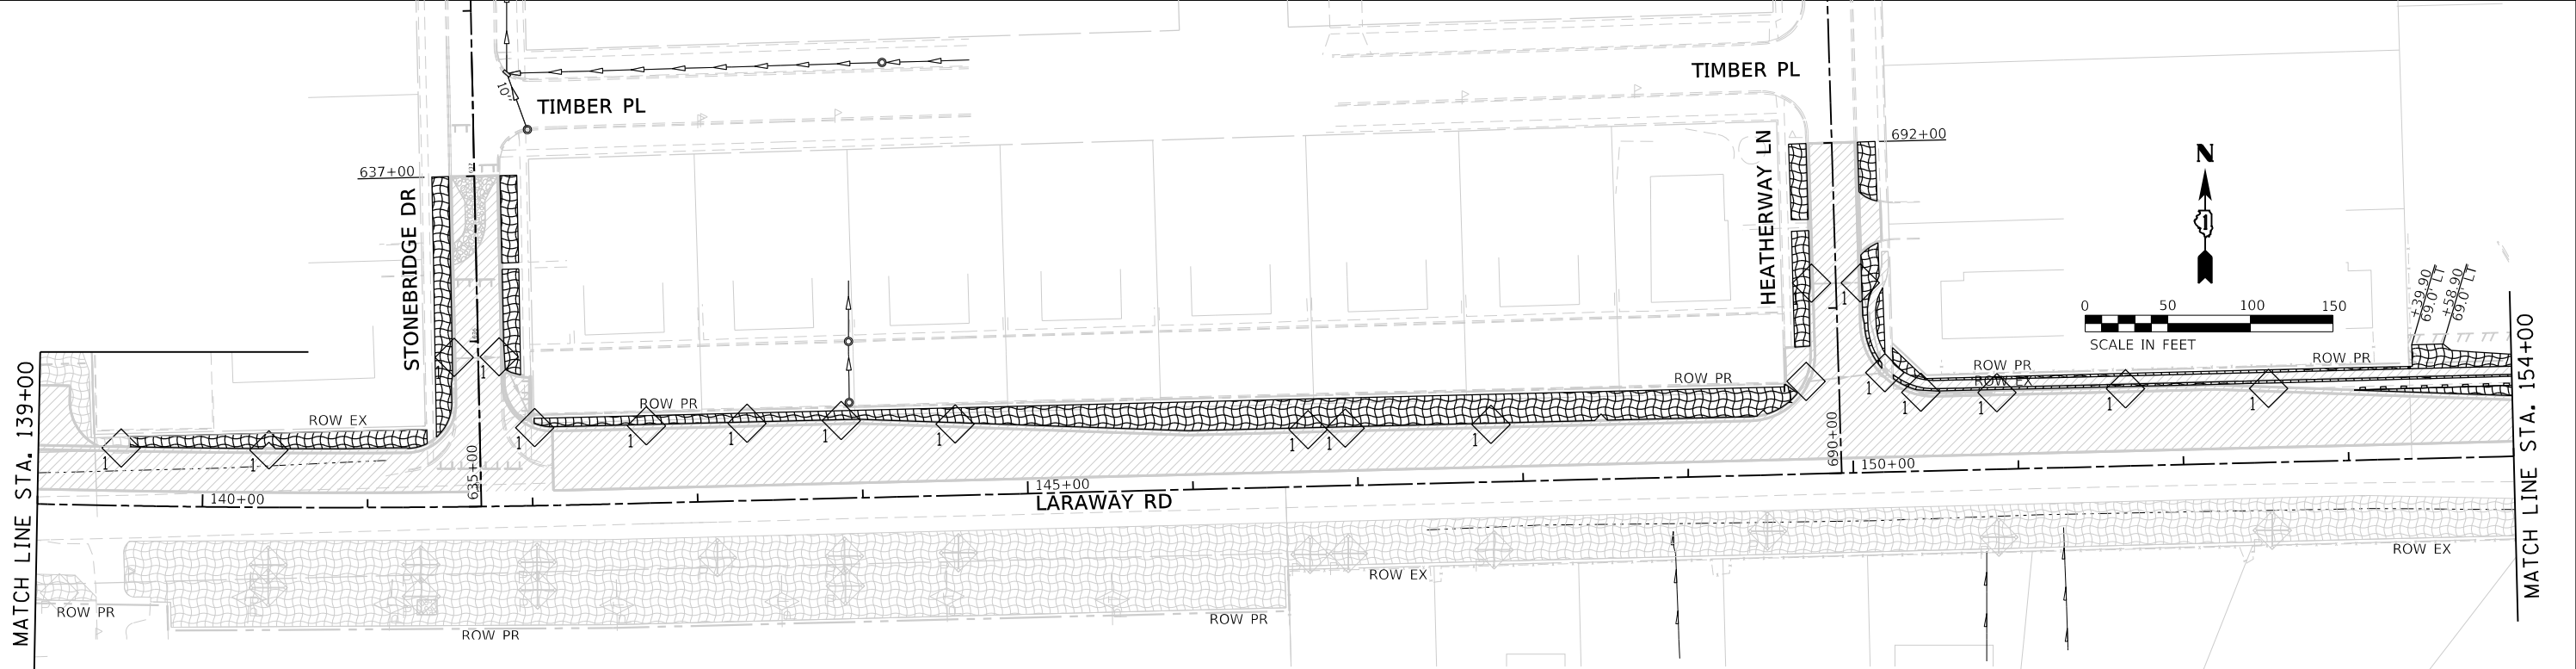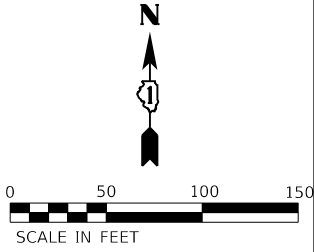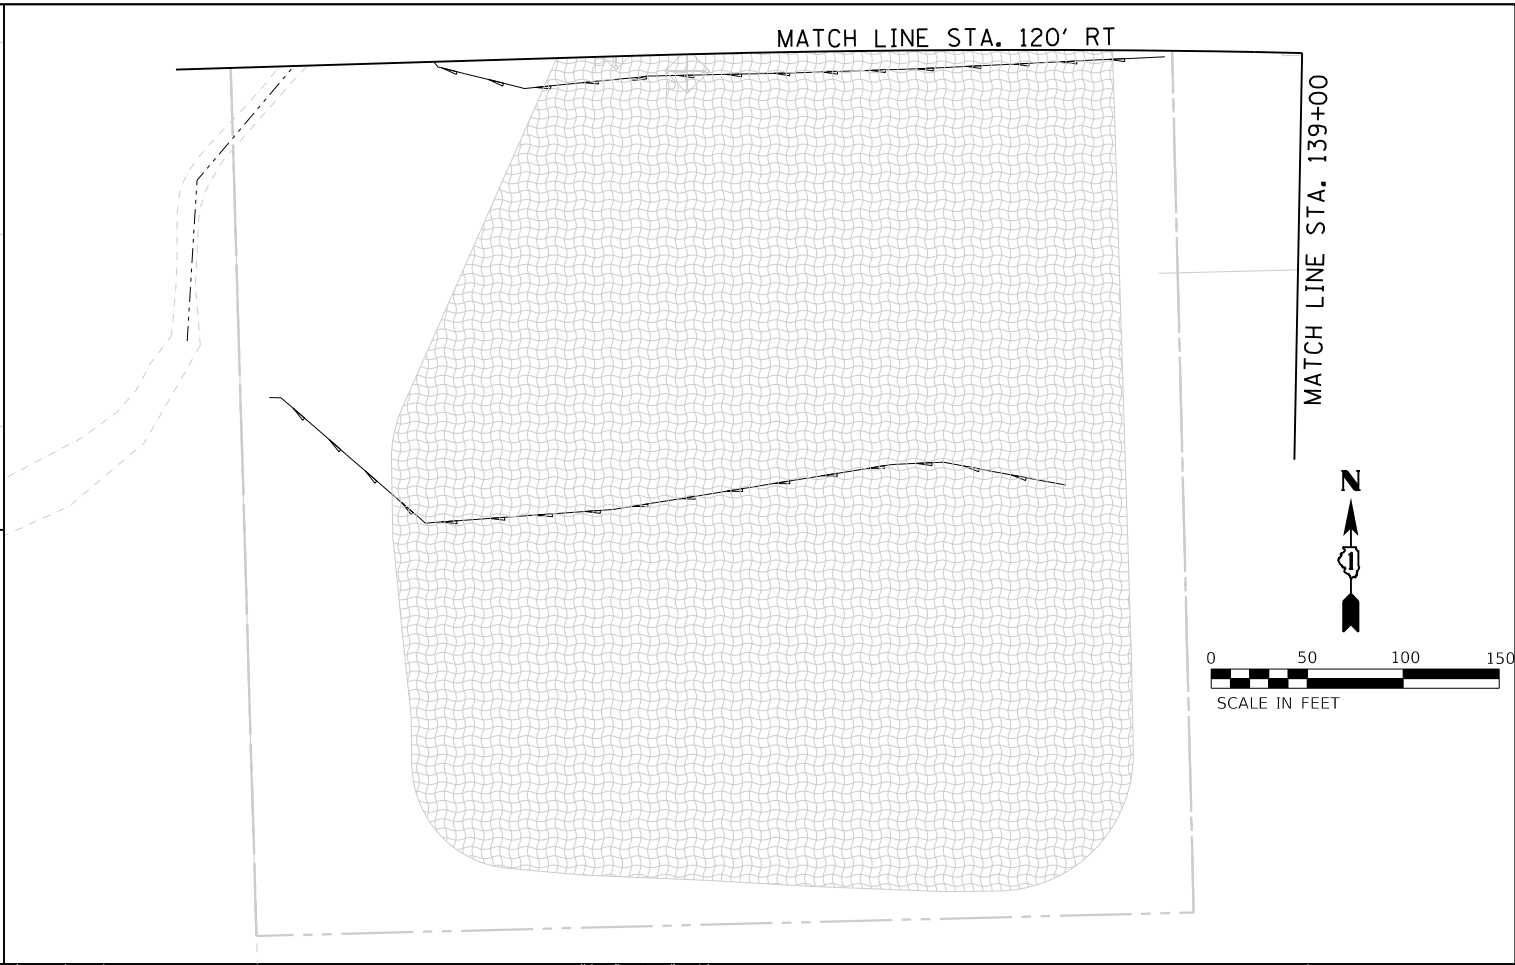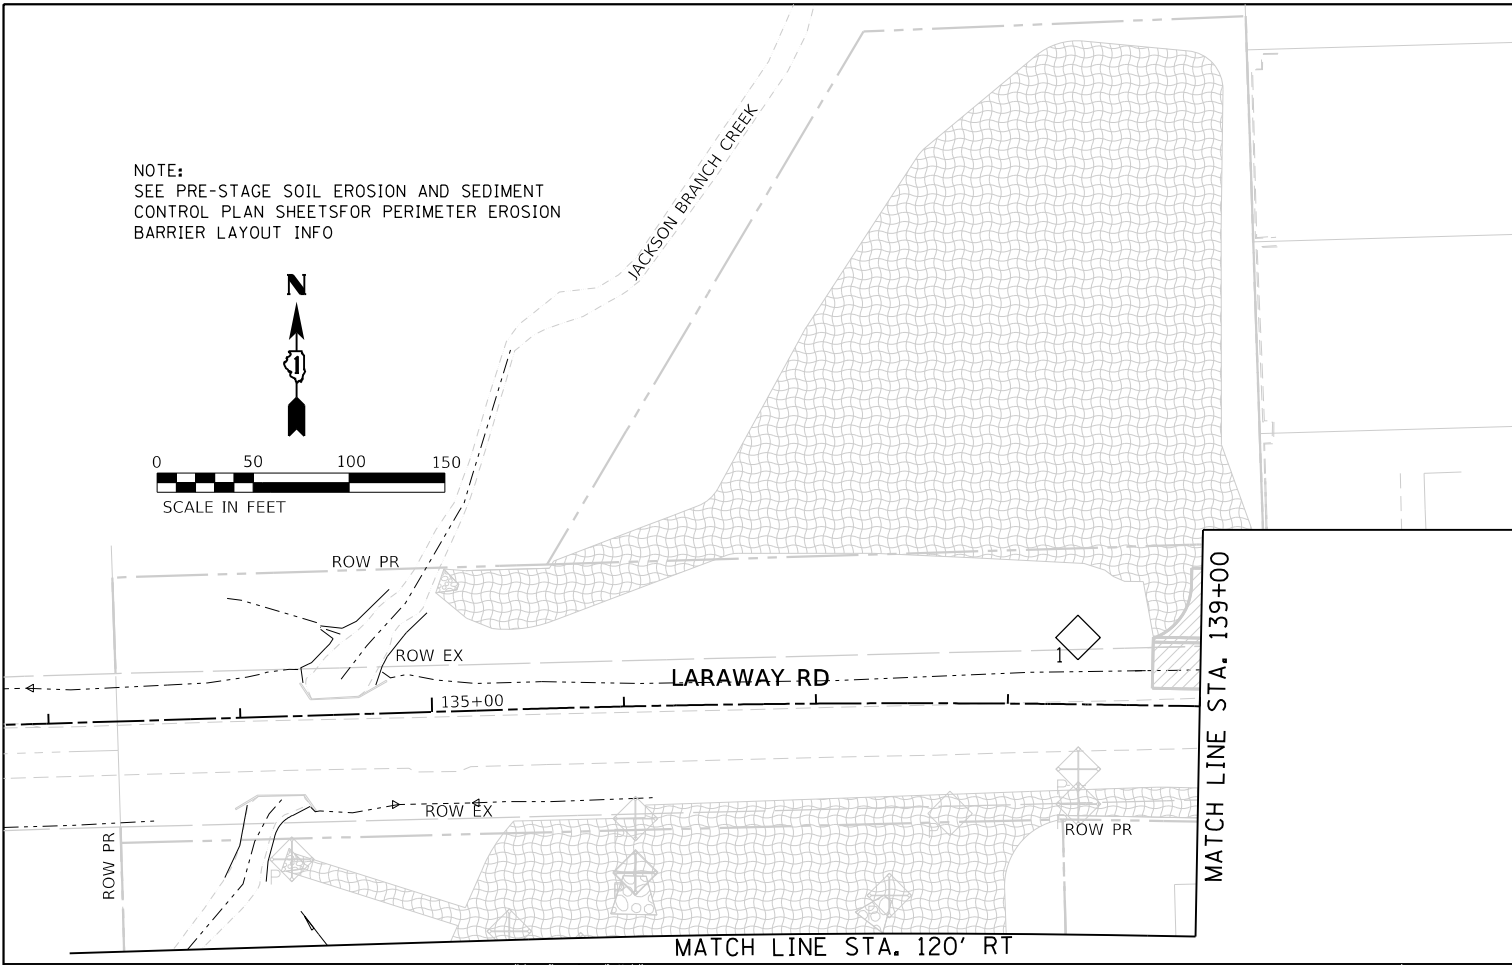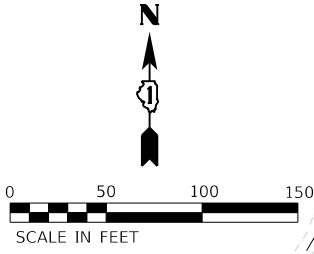SCALE: 1"=50' SHEET 1 OF 4 SHEETS STA. 13400 TO STA. 15400

F.A.U. RTE.	SECTION	COUNTY	TOTAL SHEETS	SHEET NO.
0320	13-00138-37-PV	WILL	413	177
CONTRACT NO. 61H20				
ILLINOIS FED. AID PROJECT				



	INLET PROTECTION, SPECIAL (X2800500) (EACH)		PERIMETER EROSION BARRIER (28000400) (FOOT)		STONE RIPRAP W/FILTER FABRIC (SEE TABLE ON SHEET 185 FOR RIPRAP DETAILS INCLUDING CLASS, DEPTH, AND OTHER DIMENSIONS)
	INLET FILTERS (28000510) (EACH)		EROSION CONTROL BLANKET (SPECIAL) / TEMPORARY SEEDING		
	TEMPORARY DITCH CHECKS (28000305) (FOOT)		WORK ZONE / TEMP PAVEMENT (SEE MOT PLANS)		

NOTES:

1. STAGE OF INSTALLATION IS REPRESENTED NEXT TO THE CORRESPONDING SYMBOL. (i.e. "P" FOR PRE-STAGE, "1" FOR STAGE 1, AND "2" FOR STAGE 2.)
2. THE CONTRACTOR SHALL FINALIZE GRADING OPERATIONS AND INSTALL PERMANENT STABILIZATION MEASURES (SEE LANDSCAPING PLANS) AS SOON AS POSSIBLE. A CONTRACT QUANTITY REPRESENTING 25% OF THE TOTAL DISTURBED AREA IS PROVIDED FOR EROSION CONTROL BLANKET (SPECIAL) AND TEMPORARY SEEDING FOR TEMPORARY STABILIZATION.



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**STATE OF ILLINOIS
 DEPARTMENT OF TRANSPORTATION**

**SOIL EROSION AND SEDIMENT CONTROL PLAN
 LARAWAY RD - STAGE 1**

SCALE: 1"=50' SHEET 2 OF 4 SHEETS STA. 15400 TO STA. 18100

F.A.U. RTE.	SECTION	COUNTY	TOTAL SHEETS	SHEET NO.
0320	13-00138-37-PV	WILL	413	178
CONTRACT NO. 61H20				
ILLINOIS FED. AID PROJECT				

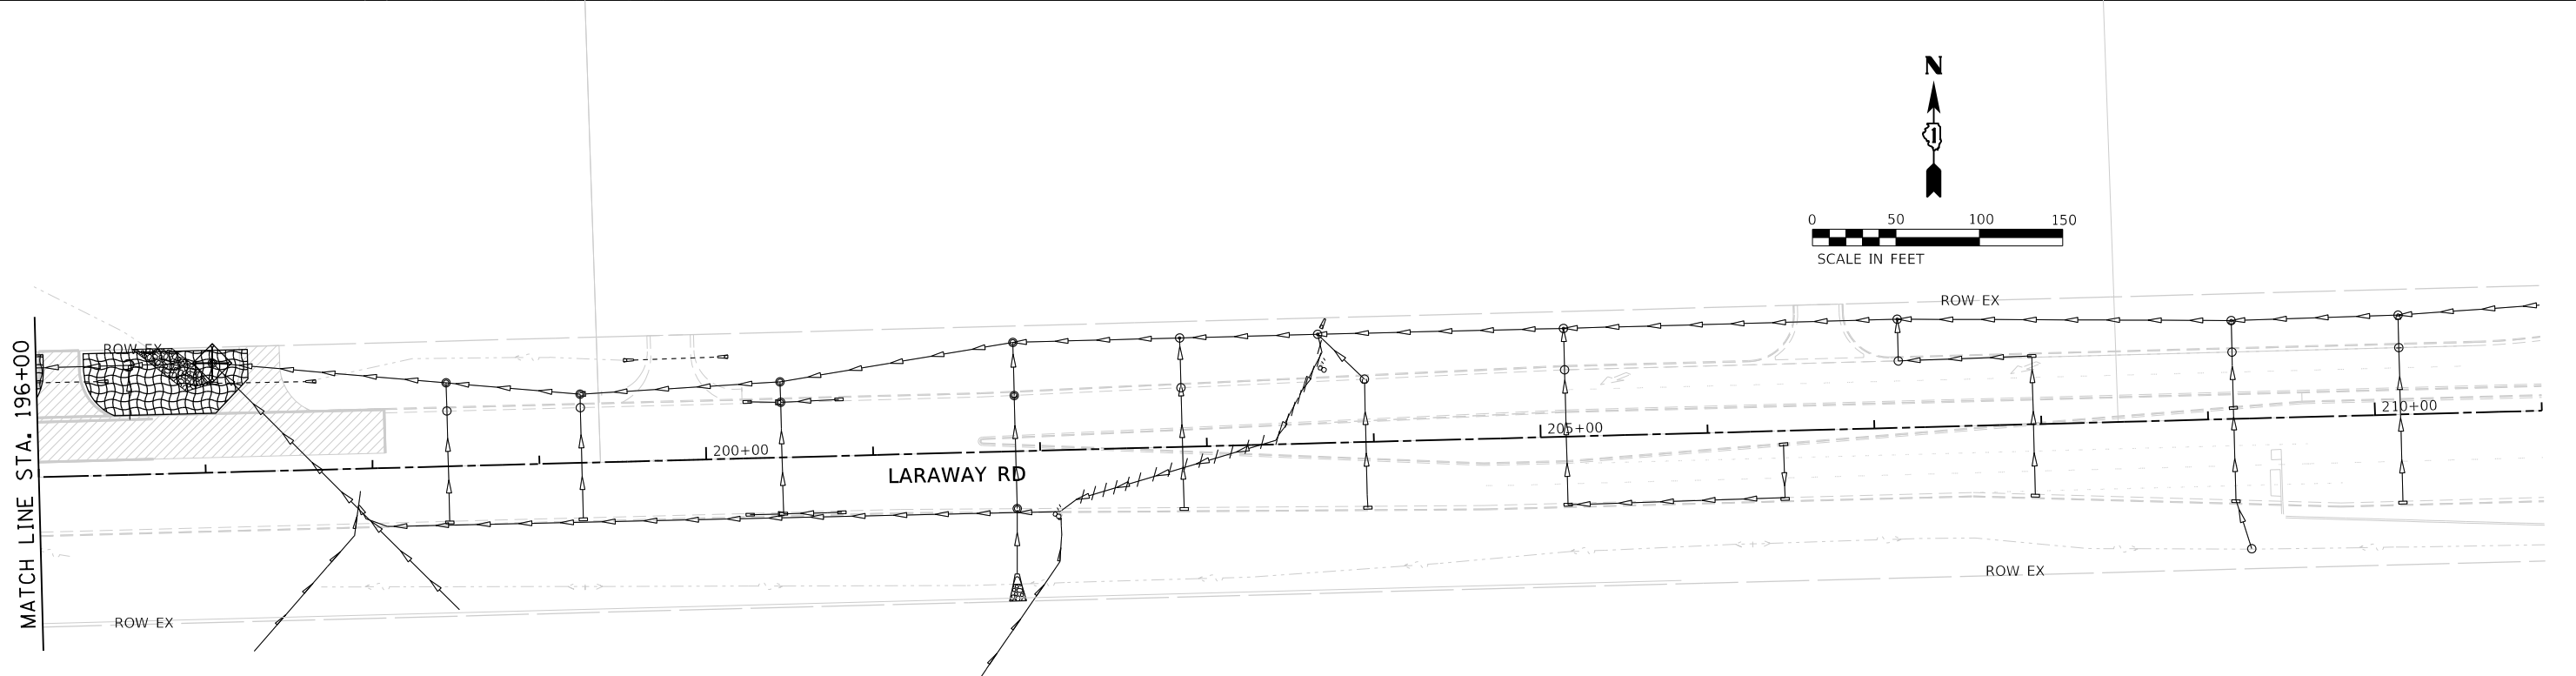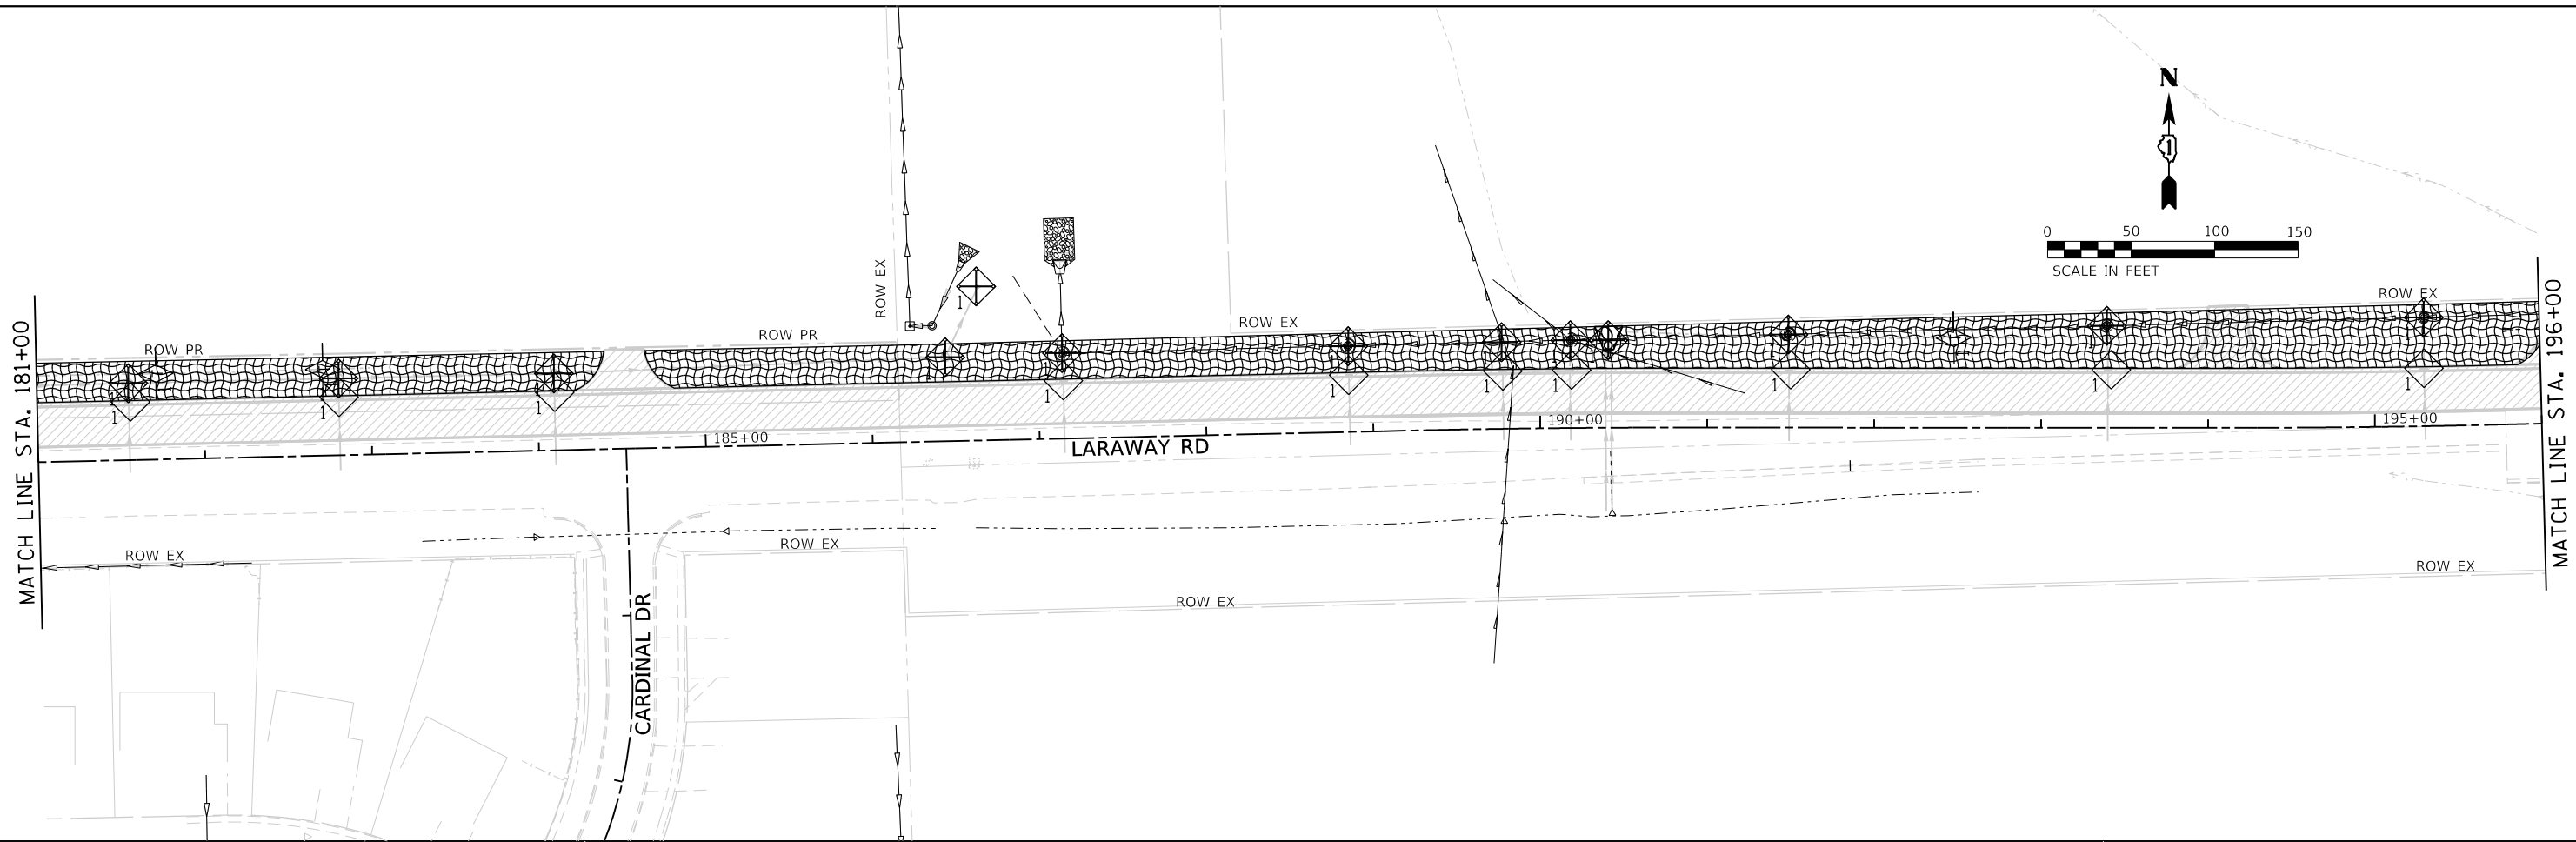

	INLET PROTECTION, SPECIAL (X2800500) (EACH)		PERIMETER EROSION BARRIER (28000400) (FOOT)		STONE RIPRAP W/FILTER FABRIC (SEE TABLE ON SHEET 185 FOR RIPRAP DETAILS INCLUDING CLASS, DEPTH, AND OTHER DIMENSIONS)
	INLET FILTERS (28000510) (EACH)		EROSION CONTROL BLANKET (SPECIAL) / TEMPORARY SEEDING		WORK ZONE / TEMP PAVEMENT (SEE MOT PLANS)
	TEMPORARY DITCH CHECKS (28000305) (FOOT)				

NOTES:
 1. STAGE OF INSTALLATION IS REPRESENTED NEXT TO THE CORRESPONDING SYMBOL. (i.e. "P" FOR PRE-STAGE, "1" FOR STAGE 1, AND "2" FOR STAGE 2.)
 2. THE CONTRACTOR SHALL FINALIZE GRADING OPERATIONS AND INSTALL PERMANENT STABILIZATION MEASURES (SEE LANDSCAPING PLANS) AS SOON AS POSSIBLE. A CONTRACT QUANTITY REPRESENTING 25% OF THE TOTAL DISTURBED AREA IS PROVIDED FOR EROSION CONTROL BLANKET (SPECIAL) AND TEMPORARY SEEDING FOR TEMPORARY STABILIZATION.





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**STATE OF ILLINOIS
DEPARTMENT OF TRANSPORTATION**

**SOIL EROSION AND SEDIMENT CONTROL PLAN
LARAWAY RD - STAGE 1**



SCALE: 1"=50' SHEET 3 OF 4 SHEETS STA. 18100 TO STA. 21100

F.A.U. RTE.	SECTION	COUNTY	TOTAL SHEETS	SHEET NO.
0320	13-00138-37-PV	WILL	413	179
CONTRACT NO. 61H20				
ILLINOIS FED. AID PROJECT				

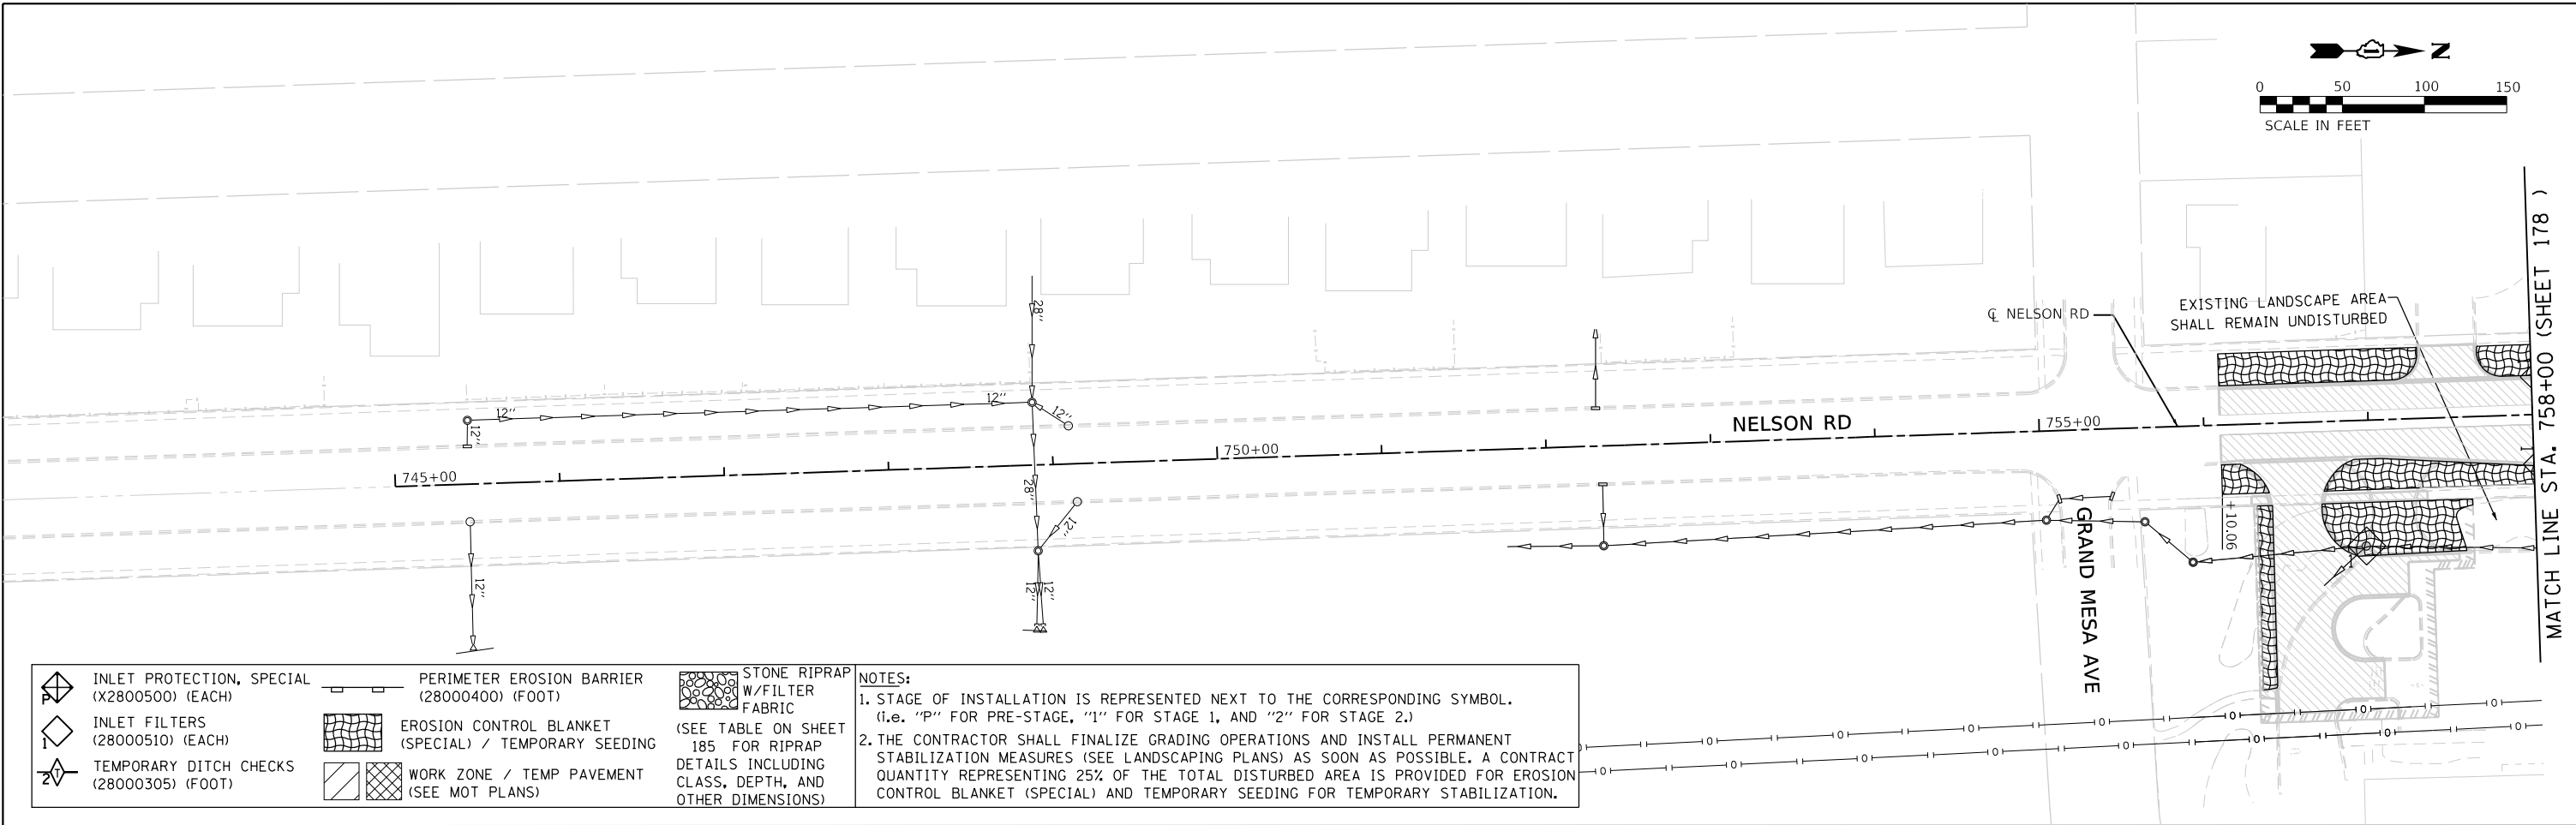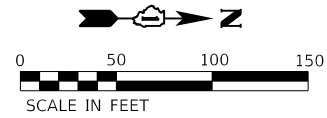

	INLET PROTECTION, SPECIAL (X2800500) (EACH)		PERIMETER EROSION BARRIER (28000400) (FOOT)		STONE RIPRAP W/FILTER FABRIC (SEE TABLE ON SHEET 185 FOR RIPRAP DETAILS INCLUDING CLASS, DEPTH, AND OTHER DIMENSIONS)
	INLET FILTERS (28000510) (EACH)		EROSION CONTROL BLANKET (SPECIAL) / TEMPORARY SEEDING		WORK ZONE / TEMP PAVEMENT (SEE MOT PLANS)
	TEMPORARY DITCH CHECKS (28000305) (FOOT)				

NOTES:
 1. STAGE OF INSTALLATION IS REPRESENTED NEXT TO THE CORRESPONDING SYMBOL. (i.e. "P" FOR PRE-STAGE, "1" FOR STAGE 1, AND "2" FOR STAGE 2.)
 2. THE CONTRACTOR SHALL FINALIZE GRADING OPERATIONS AND INSTALL PERMANENT STABILIZATION MEASURES (SEE LANDSCAPING PLANS) AS SOON AS POSSIBLE. A CONTRACT QUANTITY REPRESENTING 25% OF THE TOTAL DISTURBED AREA IS PROVIDED FOR EROSION CONTROL BLANKET (SPECIAL) AND TEMPORARY SEEDING FOR TEMPORARY STABILIZATION.


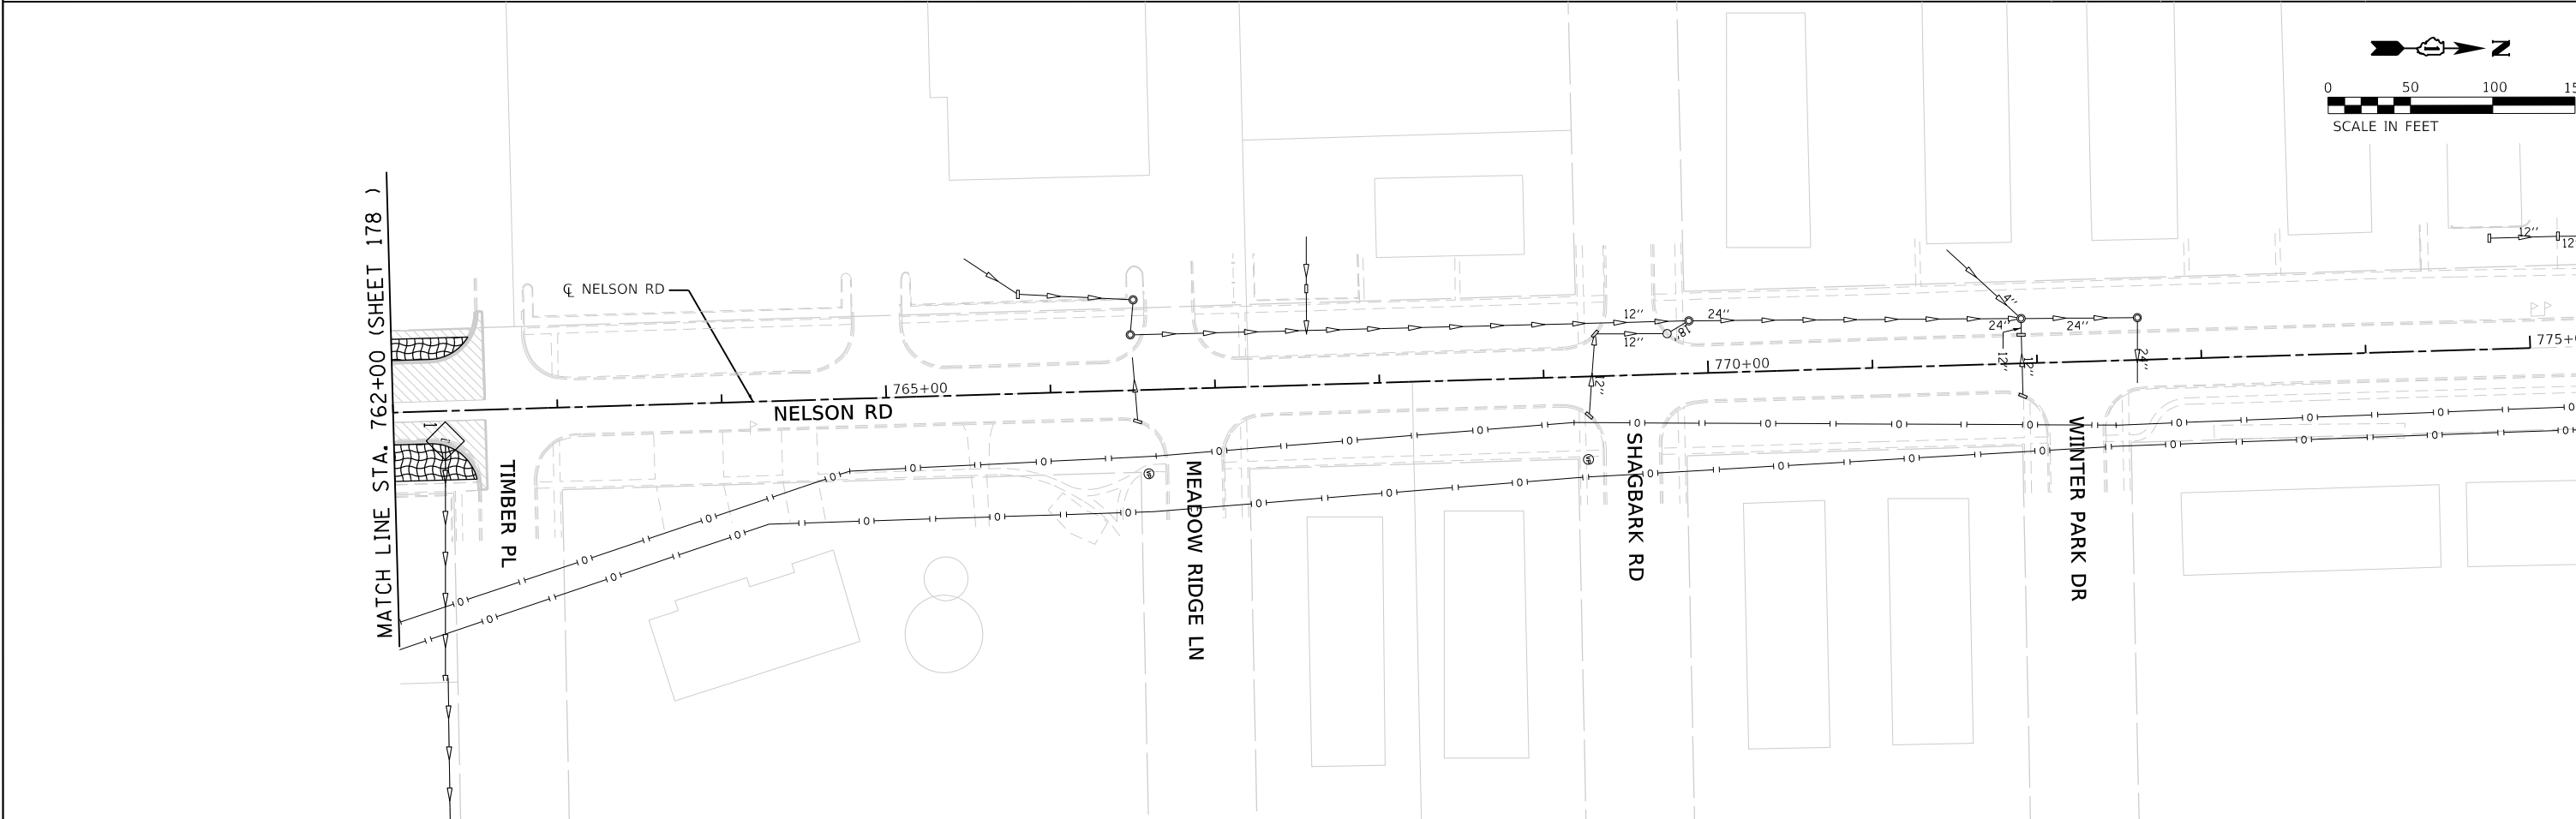
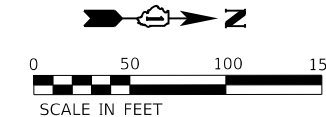


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STATE OF ILLINOIS
DEPARTMENT OF TRANSPORTATION

SCALE: 1"=50'
SHEET 4 OF 4 SHEETS
SOIL EROSION AND SEDIMENT CONTROL PLAN
NELSON RD - STAGE 1
STA. 74500 TO STA. 77500

F.A.U. RTE.	SECTION	COUNTY	TOTAL SHEETS	SHEET NO.
0320	13-00138-37-PV	WILL	413	180
CONTRACT NO. 61H20				
ILLINOIS FED. AID PROJECT				

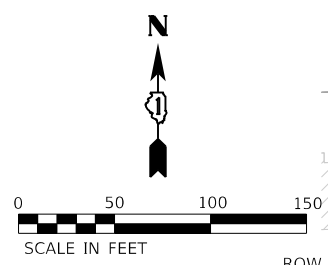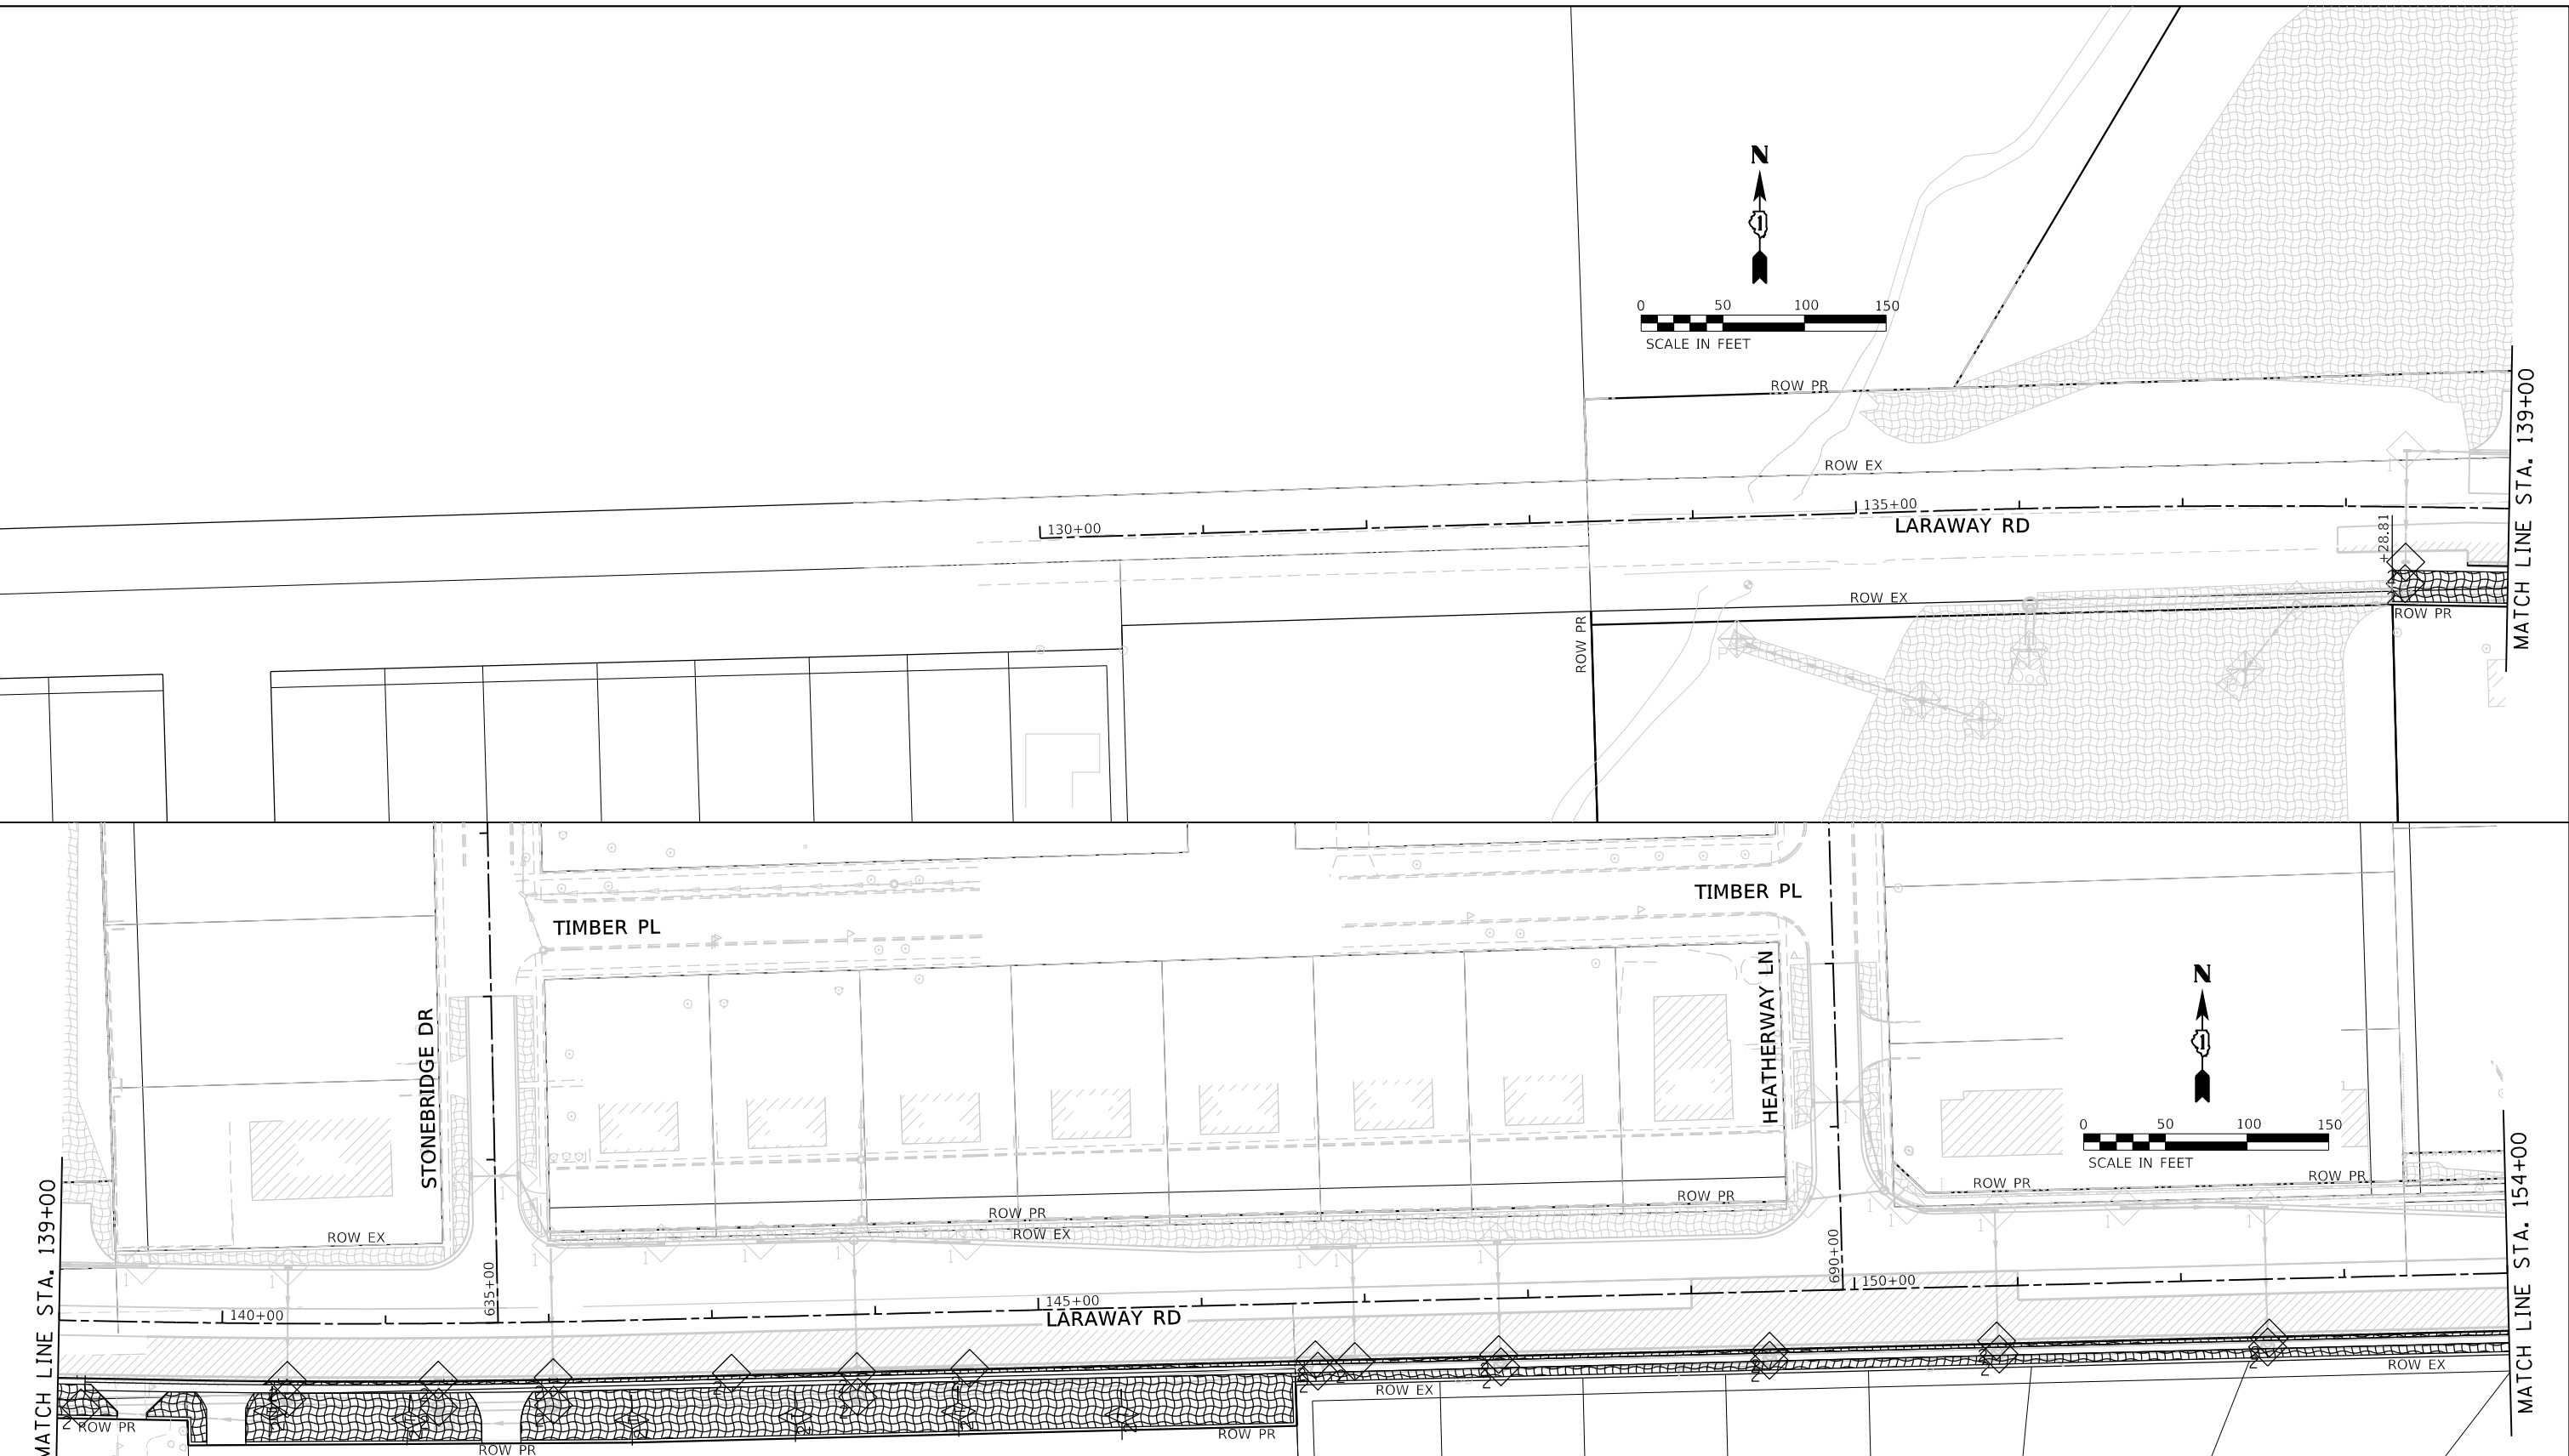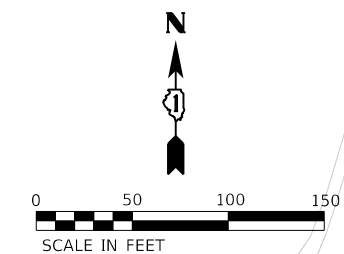

	INLET PROTECTION, SPECIAL (X2800500) (EACH)		PERIMETER EROSION BARRIER (28000400) (FOOT)		STONE RIPRAP W/FILTER FABRIC (SEE TABLE ON SHEET 185 FOR RIPRAP DETAILS INCLUDING CLASS, DEPTH, AND OTHER DIMENSIONS)
	INLET FILTERS (28000510) (EACH)		EROSION CONTROL BLANKET (SPECIAL) / TEMPORARY SEEDING		WORK ZONE / TEMP PAVEMENT (SEE MOT PLANS)
	TEMPORARY DITCH CHECKS (28000305) (FOOT)				

NOTES:
 1. STAGE OF INSTALLATION IS REPRESENTED NEXT TO THE CORRESPONDING SYMBOL. (i.e. "P" FOR PRE-STAGE, "1" FOR STAGE 1, AND "2" FOR STAGE 2.)
 2. THE CONTRACTOR SHALL FINALIZE GRADING OPERATIONS AND INSTALL PERMANENT STABILIZATION MEASURES (SEE LANDSCAPING PLANS) AS SOON AS POSSIBLE. A CONTRACT QUANTITY REPRESENTING 25% OF THE TOTAL DISTURBED AREA IS PROVIDED FOR EROSION CONTROL BLANKET (SPECIAL) AND TEMPORARY SEEDING FOR TEMPORARY STABILIZATION.



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**STATE OF ILLINOIS
DEPARTMENT OF TRANSPORTATION**

**SOIL EROSION AND SEDIMENT CONTROL PLAN
LARAWAY RD - STAGE 2**

SCALE: 1"=50' SHEET 1 OF 5 SHEETS STA. 13400 TO STA. 15400

F.A.U. RTE.	SECTION	COUNTY	TOTAL SHEETS	SHEET NO.
0320	13-00138-37-PV	WILL	413	181
CONTRACT NO. 61H20				
ILLINOIS FED. AID PROJECT				

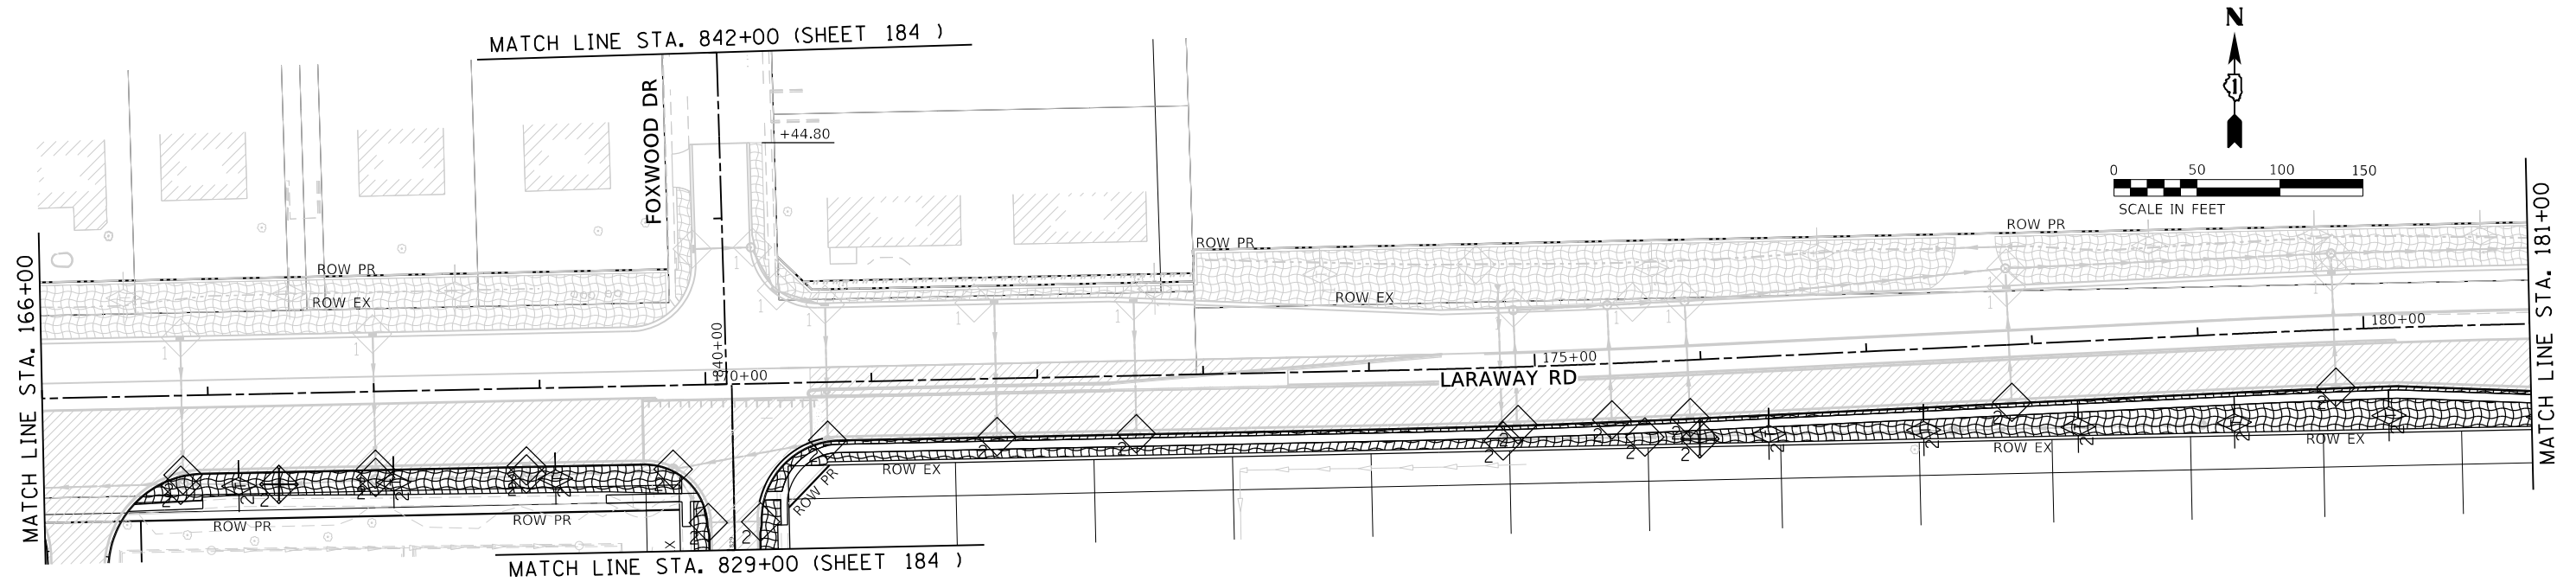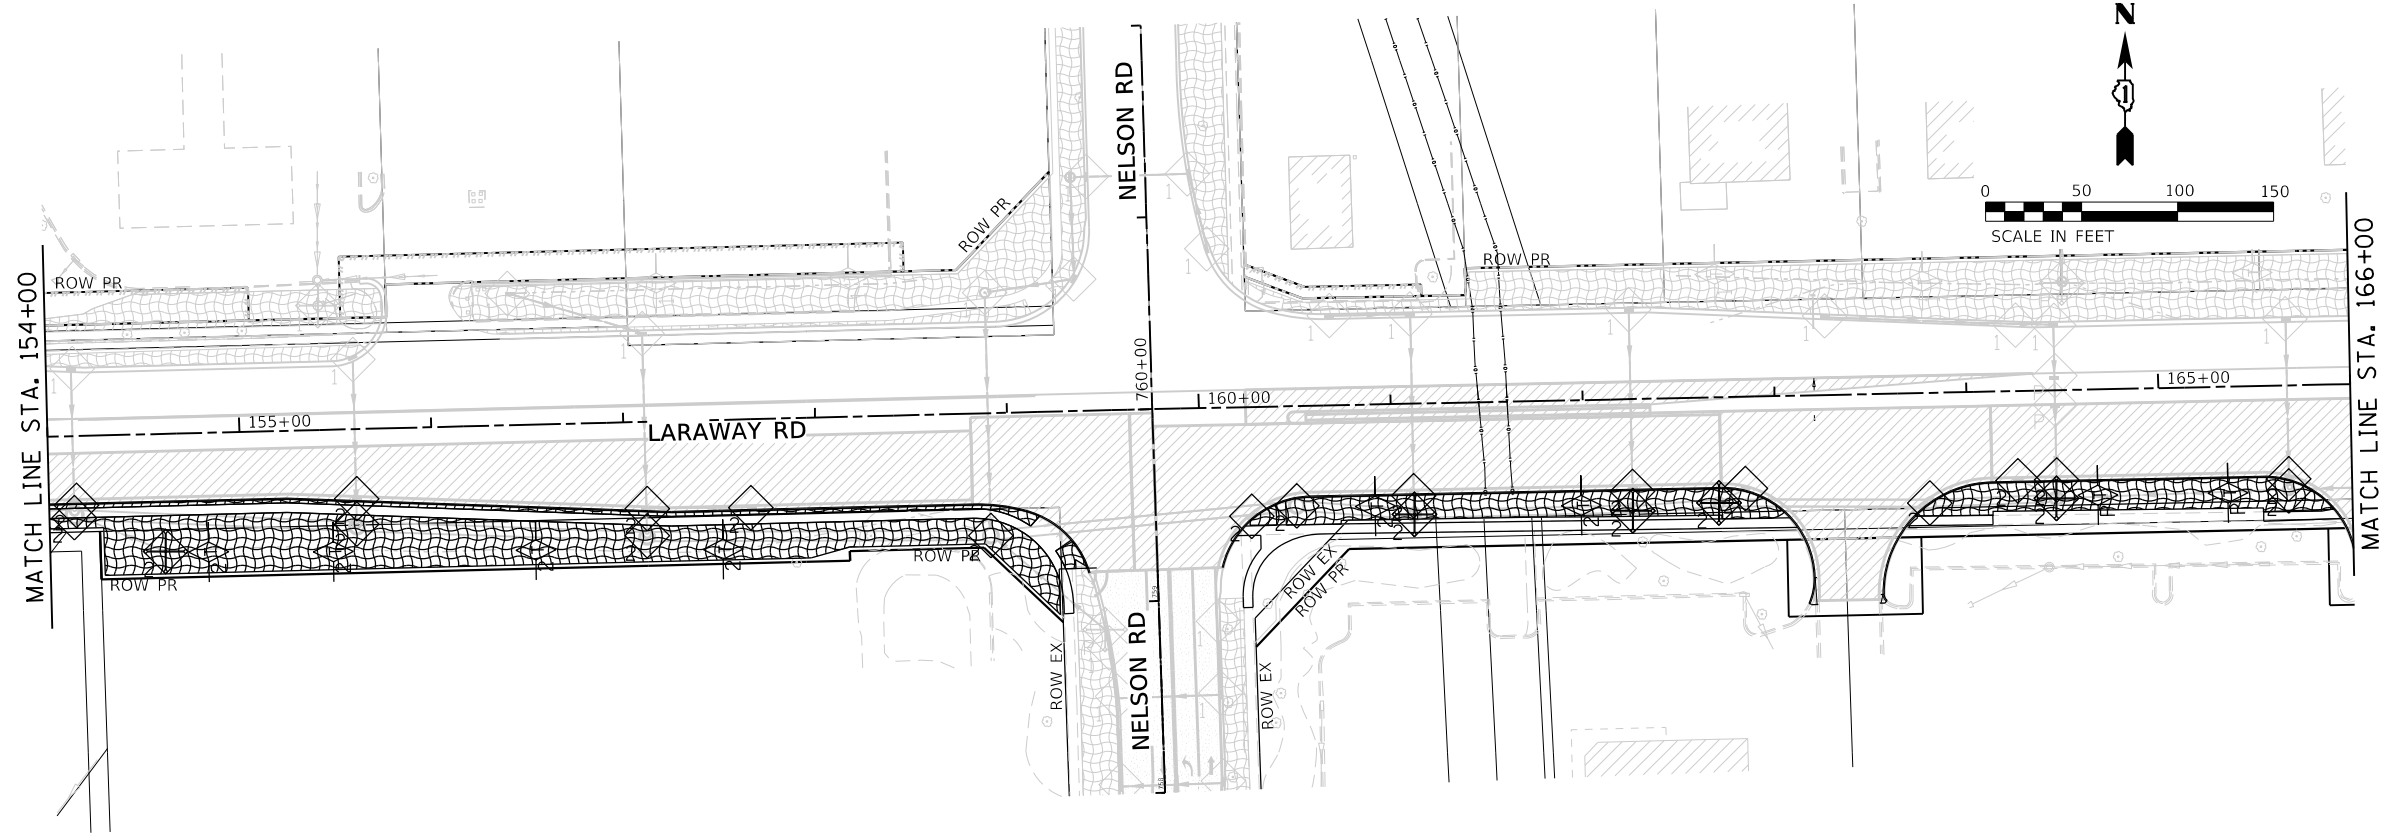

	INLET PROTECTION, SPECIAL (X2800500) (EACH)		PERIMETER EROSION BARRIER (28000400) (FOOT)		STONE RIPRAP W/FILTER FABRIC (SEE TABLE ON SHEET 185 FOR RIPRAP DETAILS INCLUDING CLASS, DEPTH, AND OTHER DIMENSIONS)
	INLET FILTERS (28000510) (EACH)		EROSION CONTROL BLANKET (SPECIAL) / TEMPORARY SEEDING		WORK ZONE / TEMP PAVEMENT (SEE MOT PLANS)
	TEMPORARY DITCH CHECKS (28000305) (FOOT)				

NOTES:

- STAGE OF INSTALLATION IS REPRESENTED NEXT TO THE CORRESPONDING SYMBOL. (i.e. "P" FOR PRE-STAGE, "1" FOR STAGE 1, AND "2" FOR STAGE 2.)
- THE CONTRACTOR SHALL FINALIZE GRADING OPERATIONS AND INSTALL PERMANENT STABILIZATION MEASURES (SEE LANDSCAPING PLANS) AS SOON AS POSSIBLE. A CONTRACT QUANTITY REPRESENTING 25% OF THE TOTAL DISTURBED AREA IS PROVIDED FOR EROSION CONTROL BLANKET (SPECIAL) AND TEMPORARY SEEDING FOR TEMPORARY STABILIZATION.



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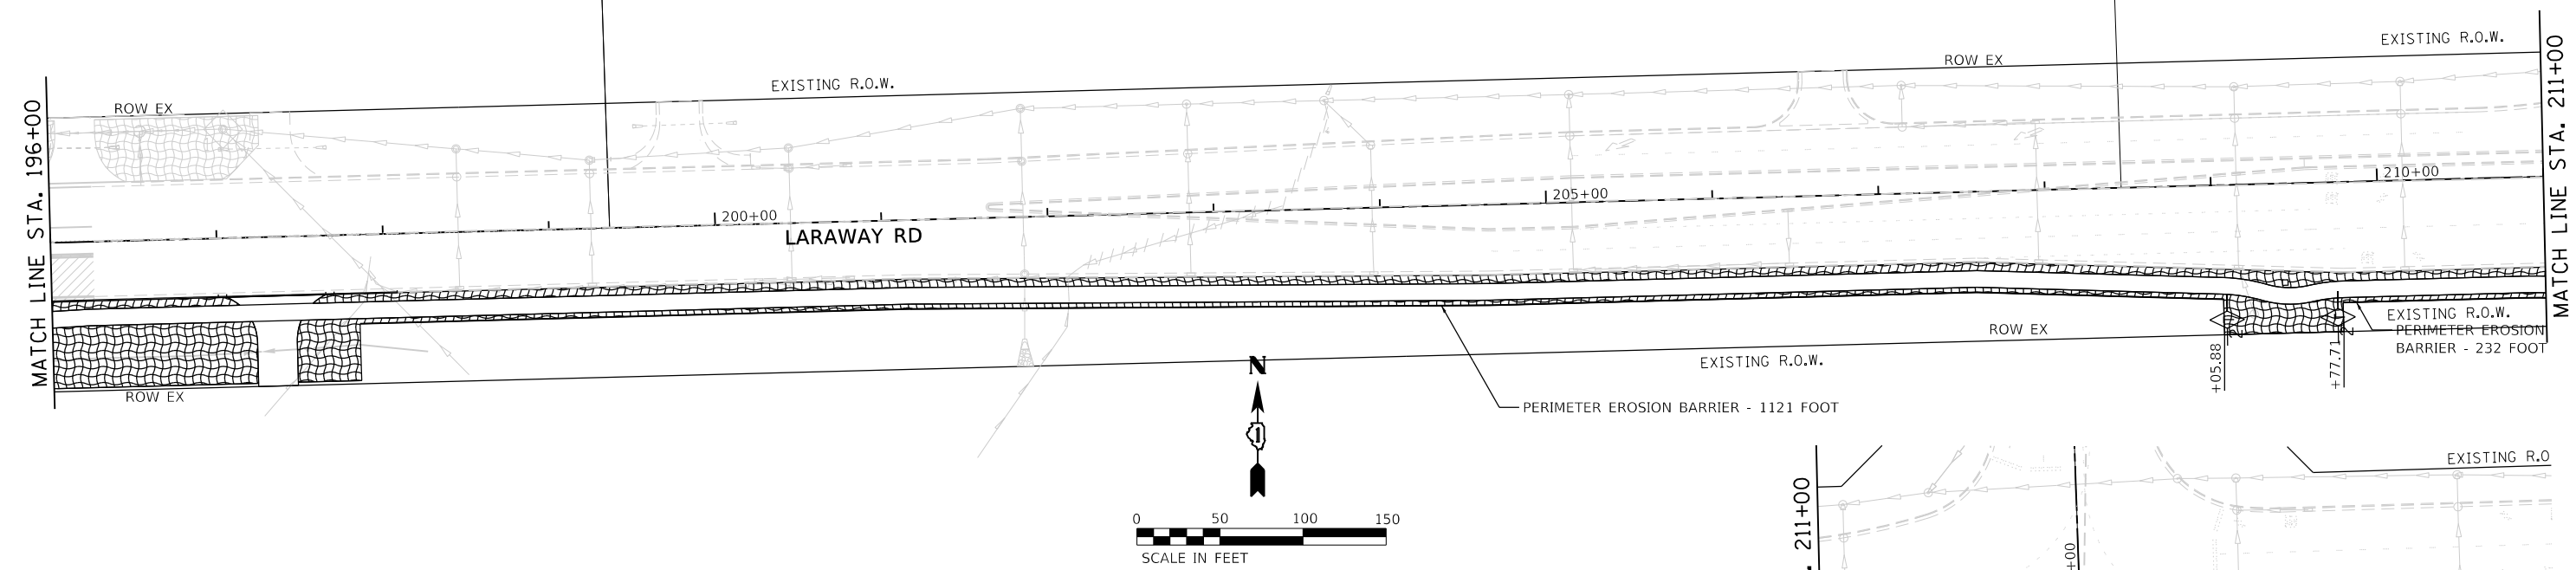
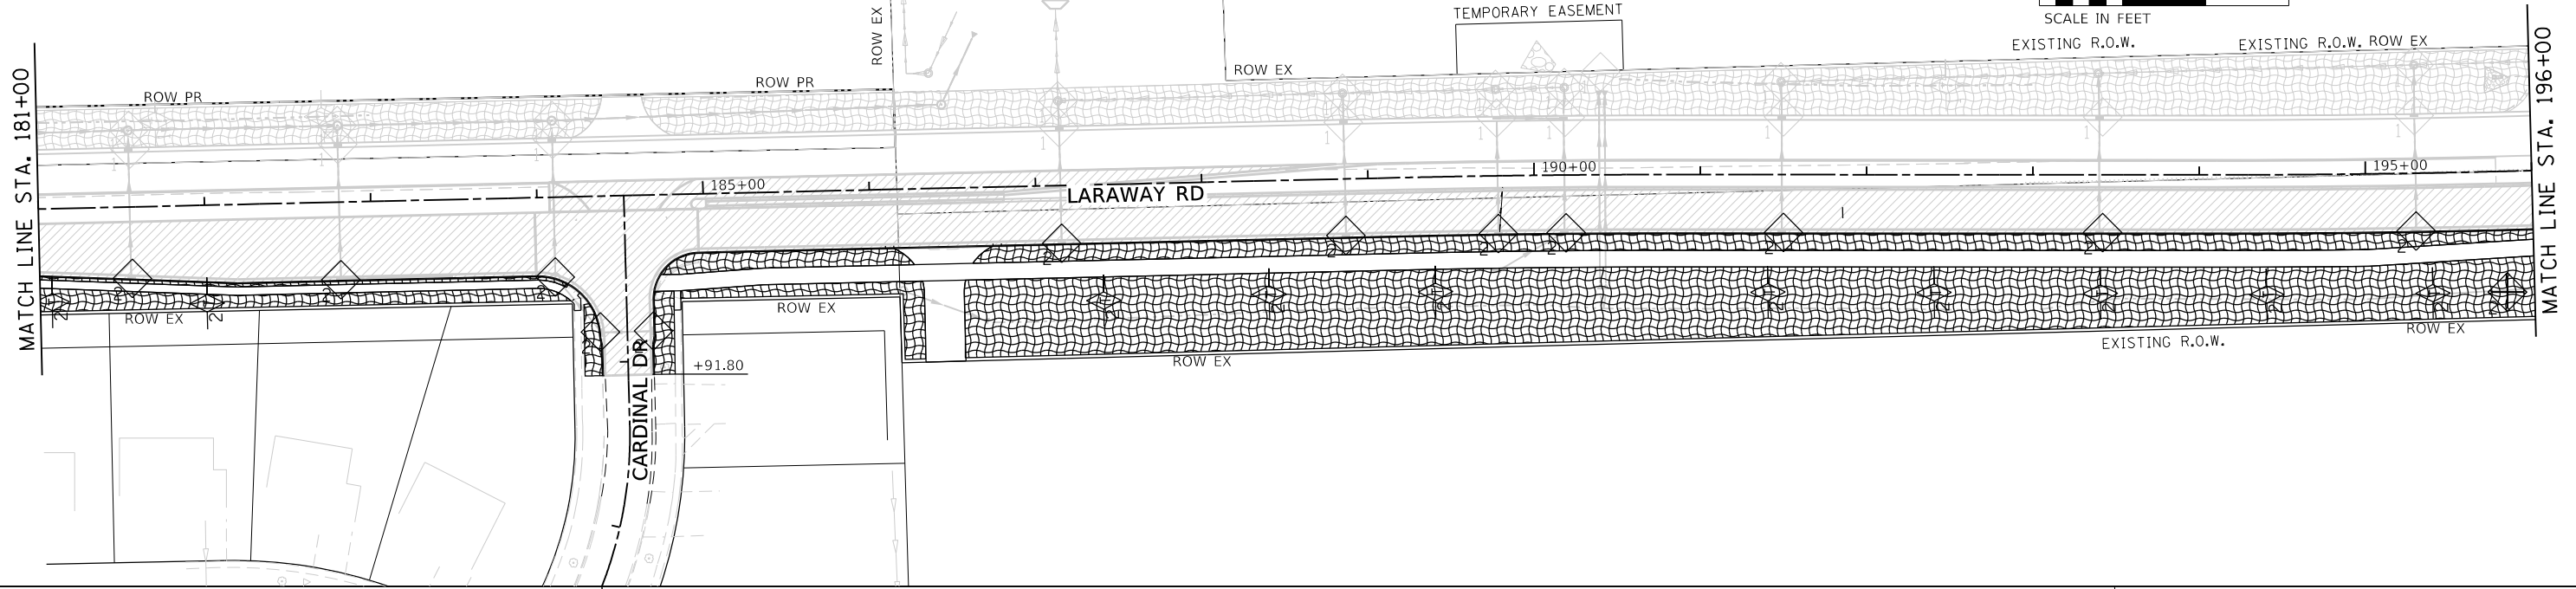
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STATE OF ILLINOIS
 DEPARTMENT OF TRANSPORTATION

SOIL EROSION AND SEDIMENT CONTROL PLAN
 LARAWAY RD - STAGE 2

SCALE: 1"=50' SHEET 2 OF 5 SHEETS STA. 15400 TO STA. 18100

F.A.U. RTE.	SECTION	COUNTY	TOTAL SHEETS	SHEET NO.
0320	13-00138-37-PV	WILL	413	182
CONTRACT NO. 61H20				
ILLINOIS FED. AID PROJECT				



	INLET PROTECTION, SPECIAL (X2800500) (EACH)		PERIMETER EROSION BARRIER (28000400) (FOOT)		STONE RIPRAP W/FILTER FABRIC (SEE TABLE ON SHEET 185 FOR RIPRAP DETAILS INCLUDING CLASS, DEPTH, AND OTHER DIMENSIONS)
	INLET FILTERS (28000510) (EACH)		EROSION CONTROL BLANKET (SPECIAL) / TEMPORARY SEEDING		WORK ZONE / TEMP PAVEMENT (SEE MOT PLANS)
	TEMPORARY DITCH CHECKS (28000305) (FOOT)				

NOTES:
 1. STAGE OF INSTALLATION IS REPRESENTED NEXT TO THE CORRESPONDING SYMBOL. (i.e. "P" FOR PRE-STAGE, "1" FOR STAGE 1, AND "2" FOR STAGE 2.)
 2. THE CONTRACTOR SHALL FINALIZE GRADING OPERATIONS AND INSTALL PERMANENT STABILIZATION MEASURES (SEE LANDSCAPING PLANS) AS SOON AS POSSIBLE. A CONTRACT QUANTITY REPRESENTING 25% OF THE TOTAL DISTURBED AREA IS PROVIDED FOR EROSION CONTROL BLANKET (SPECIAL) AND TEMPORARY SEEDING FOR TEMPORARY STABILIZATION.


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**STATE OF ILLINOIS
 DEPARTMENT OF TRANSPORTATION**

**SOIL EROSION AND SEDIMENT CONTROL PLAN
 LARAWAY RD - STAGE 2**

SCALE: 1"=50' SHEET 3 OF 5 SHEETS STA. 18100 TO STA. 21100

F.A.U. RTE.	SECTION	COUNTY	TOTAL SHEETS	SHEET NO.
0320	13-00138-37-PV	WILL	413	183
CONTRACT NO. 61H20				
ILLINOIS FED. AID PROJECT				

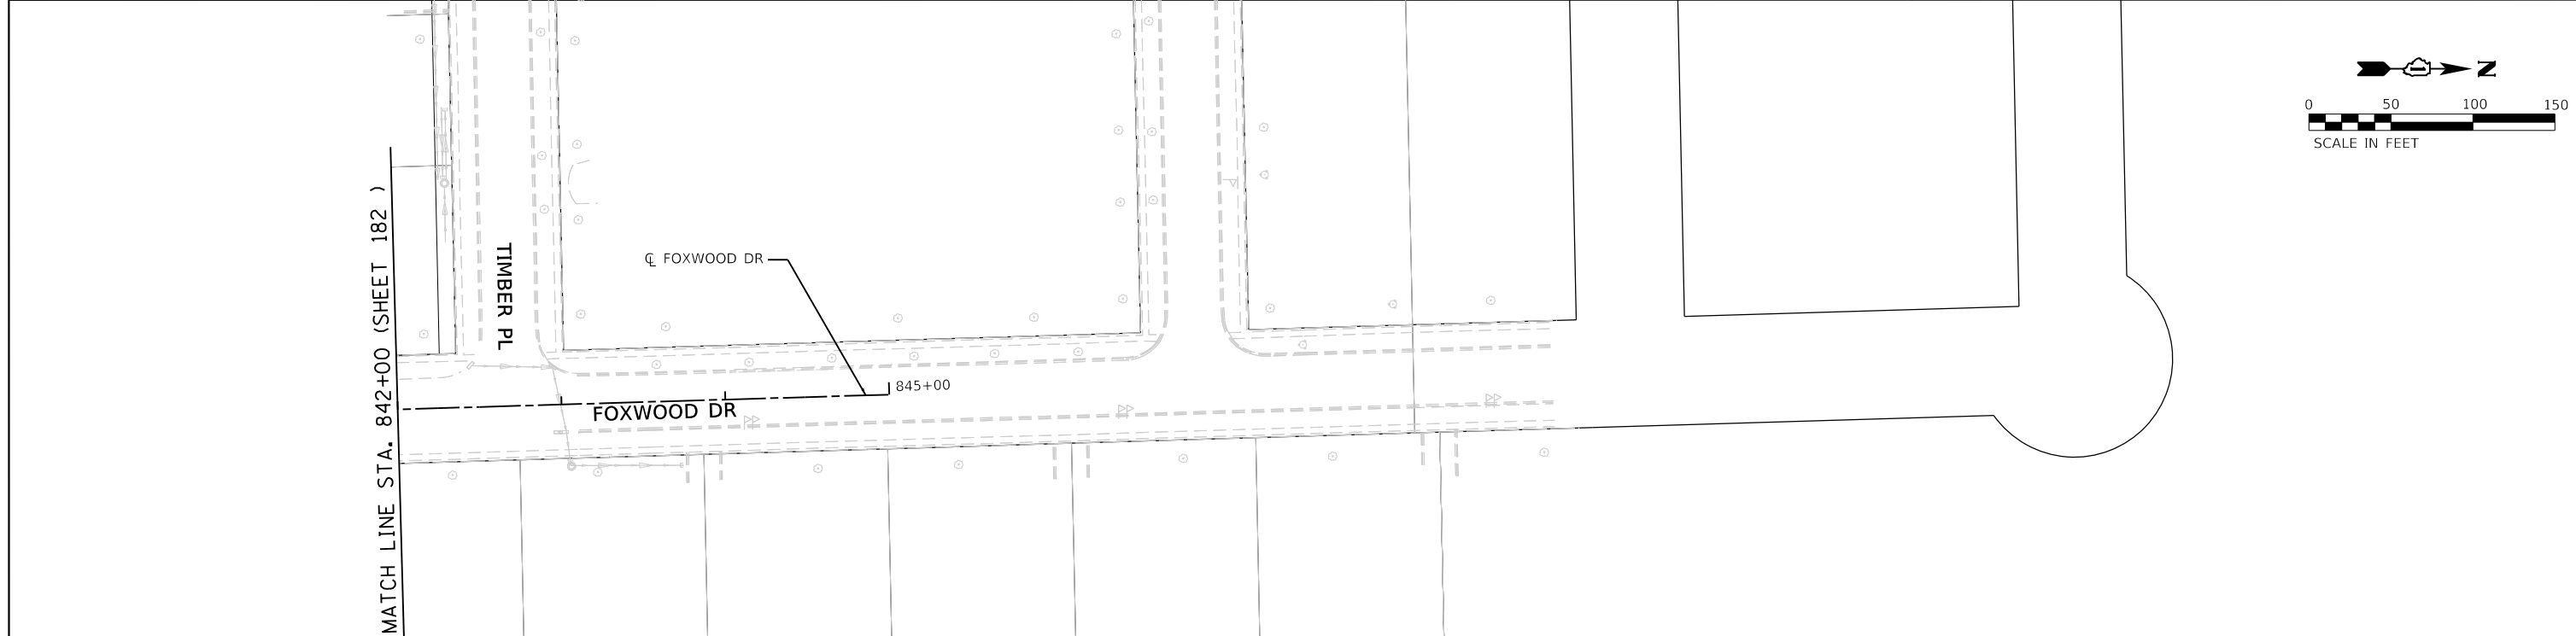

	INLET PROTECTION, SPECIAL (X2800500) (EACH)		PERIMETER EROSION BARRIER (28000400) (FOOT)		STONE RIPRAP W/FILTER FABRIC (SEE TABLE ON SHEET 185 FOR RIPRAP DETAILS INCLUDING CLASS, DEPTH, AND OTHER DIMENSIONS)
	INLET FILTERS (28000510) (EACH)		EROSION CONTROL BLANKET (SPECIAL) / TEMPORARY SEEDING		
	TEMPORARY DITCH CHECKS (28000305) (FOOT)		WORK ZONE / TEMP PAVEMENT (SEE MOT PLANS)		

NOTES:
 1. STAGE OF INSTALLATION IS REPRESENTED NEXT TO THE CORRESPONDING SYMBOL. (i.e. "P" FOR PRE-STAGE, "1" FOR STAGE 1, AND "2" FOR STAGE 2.)
 2. THE CONTRACTOR SHALL FINALIZE GRADING OPERATIONS AND INSTALL PERMANENT STABILIZATION MEASURES (SEE LANDSCAPING PLANS) AS SOON AS POSSIBLE. A CONTRACT QUANTITY REPRESENTING 25% OF THE TOTAL DISTURBED AREA IS PROVIDED FOR EROSION CONTROL BLANKET (SPECIAL) AND TEMPORARY SEEDING FOR TEMPORARY STABILIZATION.


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**STATE OF ILLINOIS
DEPARTMENT OF TRANSPORTATION**

**SOIL EROSION AND SEDIMENT CONTROL PLAN
FOXWOOD DR - STAGE 2**


SCALE: 1"=50' SHEET 5 OF 5 SHEETS STA. 82500 TO STA. 84500

F.A.U. RTE.	SECTION	COUNTY	TOTAL SHEETS	SHEET NO.
0320	13-00138-37-PV	WILL	413	184
CONTRACT NO. 61H20				
ILLINOIS FED. AID PROJECT				

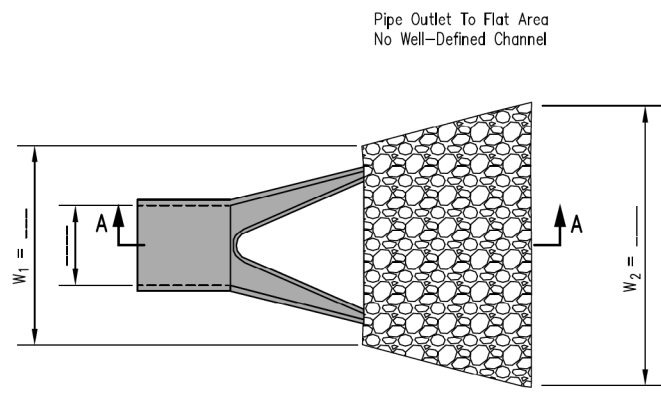

PLAN

Pipe Outlet To Flat Area
No Well-Defined Channel

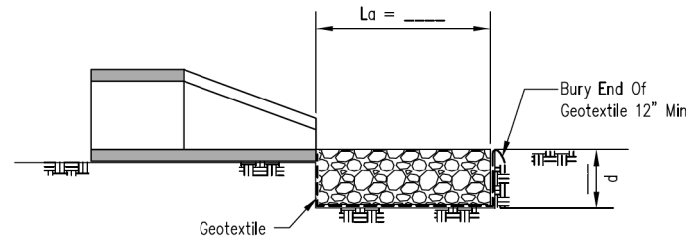


SECTION A-A

NOTES:


- The rock riprap shall meet IDOT requirements for Gradation No. SEE TABLE Quality Designation "A" or as designated by engineer.
- Geotextile (non-woven, needle punched) Minimum criteria:
Grab tensile strength (lb) ASTM D 4632 _____ 202
Elongation at failure (%) ASTM D 4632 _____ ≥ 50
Trapezoidal tear strength (lb) ASTM D 4533 _____ 79
Puncture strength (lb) ASTM D 6241 _____ 433
Ultraviolet light (% retained strength) ASTM D 4355 _____ min 50
Apparent opening size (AOS) ASTM D 4751 _____
_____ max 0.22 mm (US sieve size 70)
Permittivity sec⁻¹/ ASTM D 4491 _____ min 0.70
- Any geotextile splices shall overlap a minimum of 18 inches, with upstream or upslope geotextile overlapping the abutting downslope geotextile.
- Apron width W_1 shall be at least 3 times the culvert pipe diameter. Apron width W_2 shall be at least to L_a plus the pipe diameter.
- Rock thickness d shall be at least 1.5 times the riprap D_{100} size.
- Apron length L_a and rock riprap shall be sized according to Illinois Urban Manual Rock Outlet Protection standard 910 minimum $L_a = 10$ ft.

DESIGNED: _____ DATE: 4/22/24
DRAWN: _____ CHECKED: _____ APPROVED: _____
UNITED STATES DEPARTMENT OF AGRICULTURE
NATURAL RESOURCES CONSERVATION SERVICE
PIPE OUTLET TO FLAT AREA
SHEET 1 OF 1

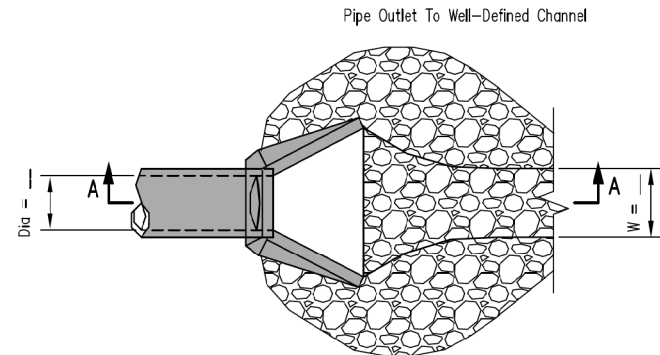

PLAN

Pipe Outlet To Well-Defined Channel

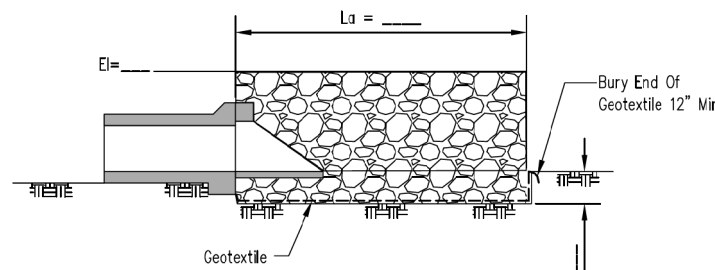

SECTION A-A

NOTES:

- The rock riprap shall meet IDOT requirements for Gradation No. SEE TABLE Quality Designation "A" or as designated by engineer.
- Geotextile (non-woven, needle punched) Minimum criteria:
Grab tensile strength (lb) ASTM D 4632 _____ 202
Elongation at failure (%) ASTM D 4632 _____ ≥ 50
Trapezoidal tear strength (lb) ASTM D 4533 _____ 79
Puncture strength (lb) ASTM D 6241 _____ 433
Ultraviolet light (% retained strength) ASTM D 4355 _____ min 50
Apparent opening size (AOS) ASTM D 4751 _____
_____ max 0.22 mm (US sieve size 70)
Permittivity sec⁻¹/ ASTM D 4491 _____ min 0.70
- Any geotextile splices shall overlap a minimum of 18 inches, with upstream or upslope geotextile overlapping the abutting downslope geotextile.
- Apron shall extend across the channel bottom and up the channel banks to an elevation one foot above the maximum tailwater depth or to the top of bank.
- Rock thickness d shall be at least 1.5 times the riprap D_{100} size.
- Apron length L_a and rock riprap shall be sized according to Illinois Urban Manual Rock Outlet Protection standard 910 minimum $L_a = 10$ ft.

DESIGNED: _____ DATE: 4/22/24
DRAWN: _____ CHECKED: _____ APPROVED: _____
UNITED STATES DEPARTMENT OF AGRICULTURE
NATURAL RESOURCES CONSERVATION SERVICE
PIPE OUTLET TO CHANNEL
SHEET 1 OF 1

STR #	L _a (FT)	W ₁ (FT)	W ₂ (FT)	d (IN)	IDOT GRAD.	PIPE SLOPE (%)	Q (cfs)	VELOCITY (fps)	TOP ELEV OF RIPRAP	BEDDING THICKNESS	RIPRAP THICKNESS	DETAIL
FE1	12	-	-	12	RR-3	LOW	< 1	2.83			8	CHANNEL
FE2	20	12	24	48	RR-4	0.09	46.51	3.73		6	16	FLAT AREA
FE3	16	5	18	18	RR-4	2.58	6.39	8.89		6	16	FLAT AREA
FE5	12	-	-	18	RR-3	0.44	5.36	4.37			8	CHANNEL
FE8	16	-	-	24E	RR-3	2.46	9.02	2.84			8	CHANNEL
FE9	12	-	-	15	RR-3	0.26	< 1	4.74			8	CHANNEL
FE10	24	12	27	48	RR-4	0.26	< 1	1.80		6	16	FLAT AREA
FE12	16	6	19	18	RR-4	0.36	24.73	43.72		6	16	FLAT AREA
FE14	16	6	19	18	RR-4	0.34	22.22	39.29		6	8	FLAT AREA
FE15	14	-	-	18	RR-3	0.58	1.66	3.61			8	CHANNEL
FE17	14	-	-	18	RR-3	1.10	0.64	2.58			8	CHANNEL




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STATE OF ILLINOIS
DEPARTMENT OF TRANSPORTATION


SOIL EROSION AND SEDIMENT CONTROL DETAILS
RIP RAP DETAILS

SCALE: SHEET 1 OF 1 SHEETS STA. TO STA.


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0320	13-00138-37-PV	WILL	413	185
CONTRACT NO. 61H20				
ILLINOIS / FED. AID PROJECT				

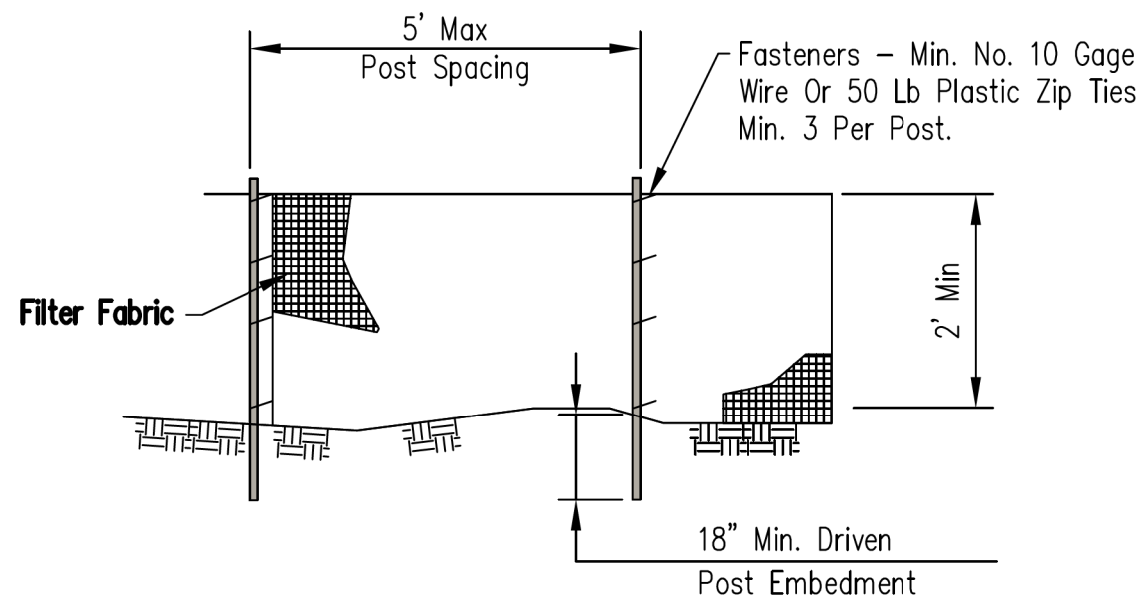

ELEVATION

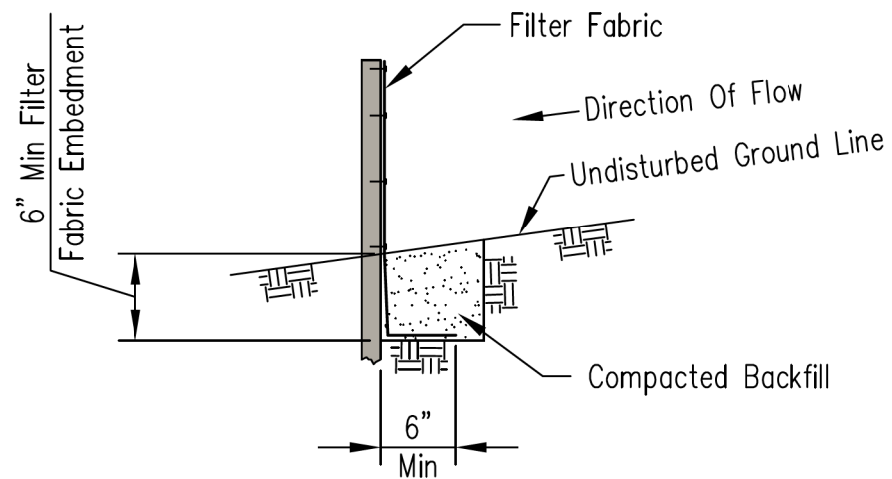

FABRIC ANCHOR DETAIL

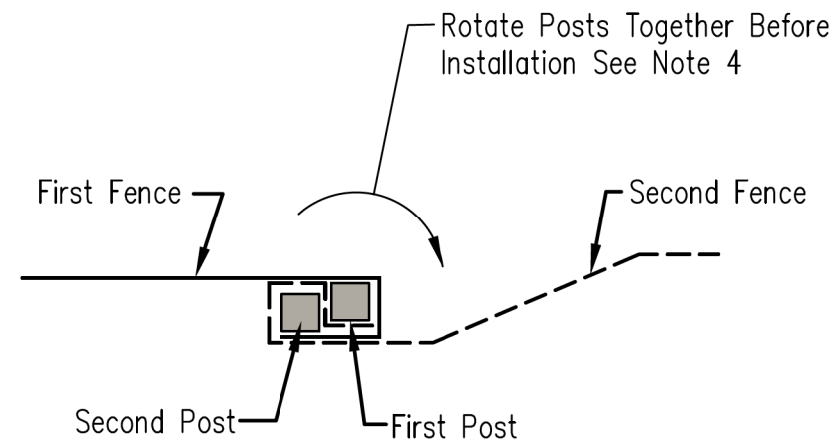

SPLICE DETAIL—PLAN VIEW

NOTES:

1. Temporary silt fence shall be installed prior to any grading work in the area to be protected. Fence shall be maintained throughout the construction period and removed in conjunction with the final grading and site stabilization.
2. Filter fabric shall meet the requirements of material specification 592 Geotextile Table 1 or 2, Class I with equivalent opening size of at least 30 for nonwoven and 50 for woven.
3. Fence posts shall be either wood post with a minimum cross-sectional area of 1.5" X 1.5" or a standard steel post.
4. When splices are necessary make splice at post according to splice detail. Place the end post of the second fence inside the end post of the first fence. Rotate both posts together at least 180 degrees to create a tight seal with the fabric material. Cut the fabric near the bottom of the posts to accommodate the 6 inch flap. Then drive both posts and bury the flap. Compact backfill well.

Designed	Date
Drawn	8/1/14
Checked	
Approved	

SILT FENCE

United States Department of Agriculture
USDA
 Natural Resources Conservation Service

File No.	IL-ENG-49
Drawing No.	
Page	1 of 1
Sheet	of



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**STATE OF ILLINOIS
 DEPARTMENT OF TRANSPORTATION**


**SOIL EROSION AND SEDIMENT CONTROL DETAILS
 PERIMETER EROSION BARRIER DETAILS**

SCALE: SHEET 1 OF 1 SHEETS STA. TO STA.

F.A.U. RTE.	SECTION	COUNTY	TOTAL SHEETS	SHEET NO.
0320	13-00138-37-PV	WILL	413	186
CONTRACT NO. 61H20				
ILLINOIS		FED. AID PROJECT		

FOR BARE EARTH APPLICATION ONLY

TEMPORARY DITCH CHECK,
(1) ONE EACH (7 FOOT LONG).
[ON THE RIGHT SIDE OF THE DITCH]

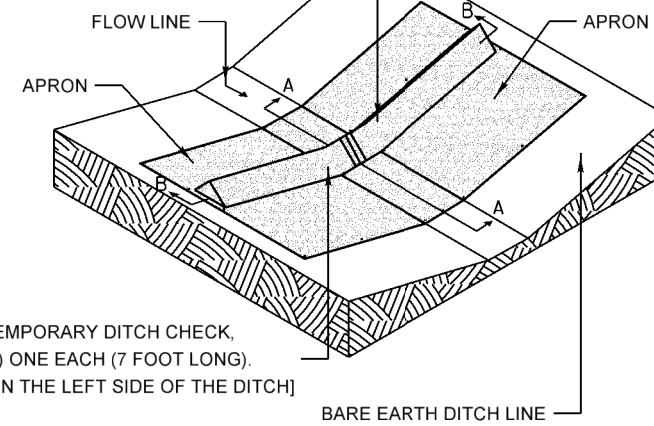

TEMPORARY DITCH CHECK,
(1) ONE EACH (7 FOOT LONG).
[ON THE LEFT SIDE OF THE DITCH]



SILT DIKE UNIT ISOMETRIC

NOTES:
THE TEMPORARY DITCH CHECK SHALL BE USED IN BARE EARTH DITCH LINES AND SHALL BE REMOVED JUST PRIOR TO THE INSTALLATION OF EROSION CONTROL BLANKET AND SEEDING.

THE INSTALLATION SHOWN WILL BE MEASURED AND PAID FOR AS A TEMPORARY DITCH CHECK 14 FEET IN LENGTH.


STAPLES SHALL BE PLACED WHERE THE UNITS OVERLAP AND IN THE CENTER OF THE 7' UNIT AS SHOWN ON THE DIAGRAM.

POINT 1 MUST BE HIGHER THAN POINT 2 TO INSURE THAT WATER FLOWS OVER THE DIKE AND NOT AROUND THE ENDS.

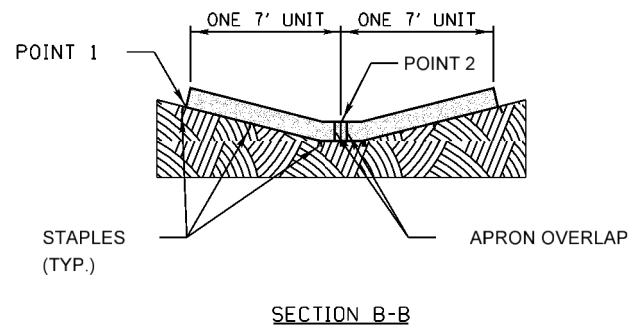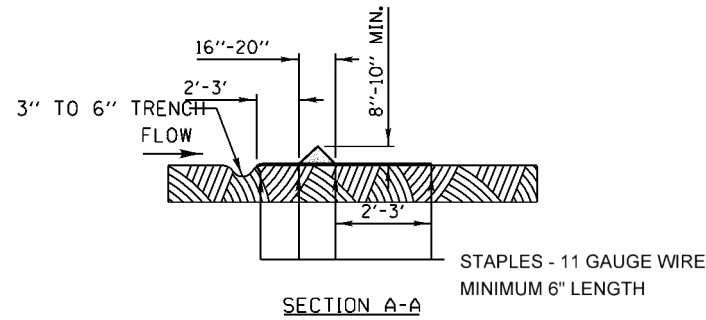

FOR USE WHILE ESTABLISHING FINAL LANDSCAPING

PERMEABLE PLASTIC BERM
ONE EACH (3.3 FOOT LONG)

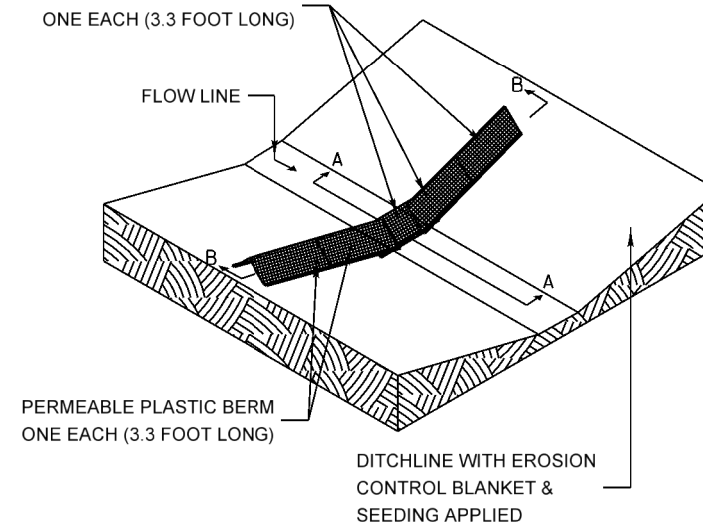



PERMEABLE PLASTIC BERM ISOMETRIC

NOTES:
THE PERMEABLE PLASTIC BERM SHALL REPLACE THE TEMPORARY DITCH CHECK AFTER THE INSTALLATION OF EROSION CONTROL BLANKET AND SEEDING.

EACH PERMEABLE PLASTIC BERM IS 3.3 FEET IN LENGTH. THE MINIMUM INSTALLATION IN A DITCH SHALL BE THREE UNITS. THE INSTALLATION SHOWN WILL BE MEASURED AND PAID FOR AS A PERMEABLE PLASTIC BERM 16.5 FEET IN LENGTH (5 UNITS).

STAPLES SHALL BE PLACED WHERE THE UNITS OVERLAP AND ACCORDING TO THE MANUFACTURER'S INSTALLATION INSTRUCTIONS.

POINT 1 MUST BE HIGHER THAN POINT 2 TO INSURE THAT WATER FLOWS THROUGH OR OVER THE BERM AND NOT AROUND THE ENDS.

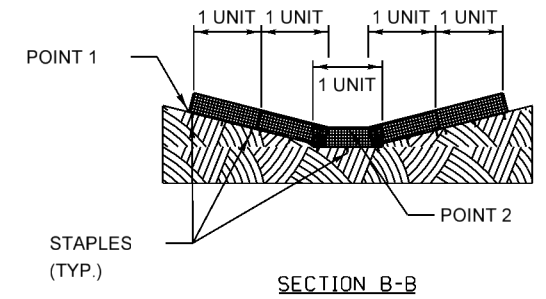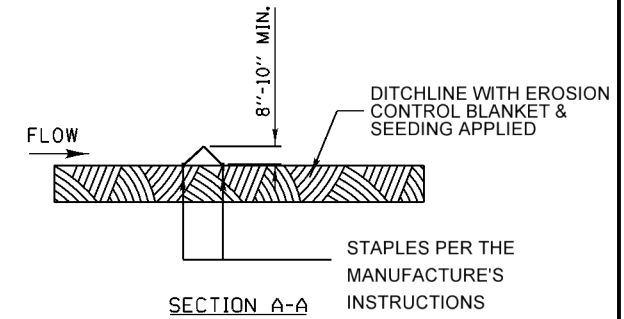


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STATE OF ILLINOIS
DEPARTMENT OF TRANSPORTATION


SOIL EROSION AND SEDIMENT CONTROL DETAILS
DITCH CHECK DETAILS

SCALE: SHEET 1 OF 1 SHEETS STA. TO STA.

F.A.U. RTE.	SECTION	COUNTY	TOTAL SHEETS	SHEET NO.
0320	13-00138-37-PV	WILL	413	187
CONTRACT NO. 61H20				
ILLINOIS FED. AID PROJECT				

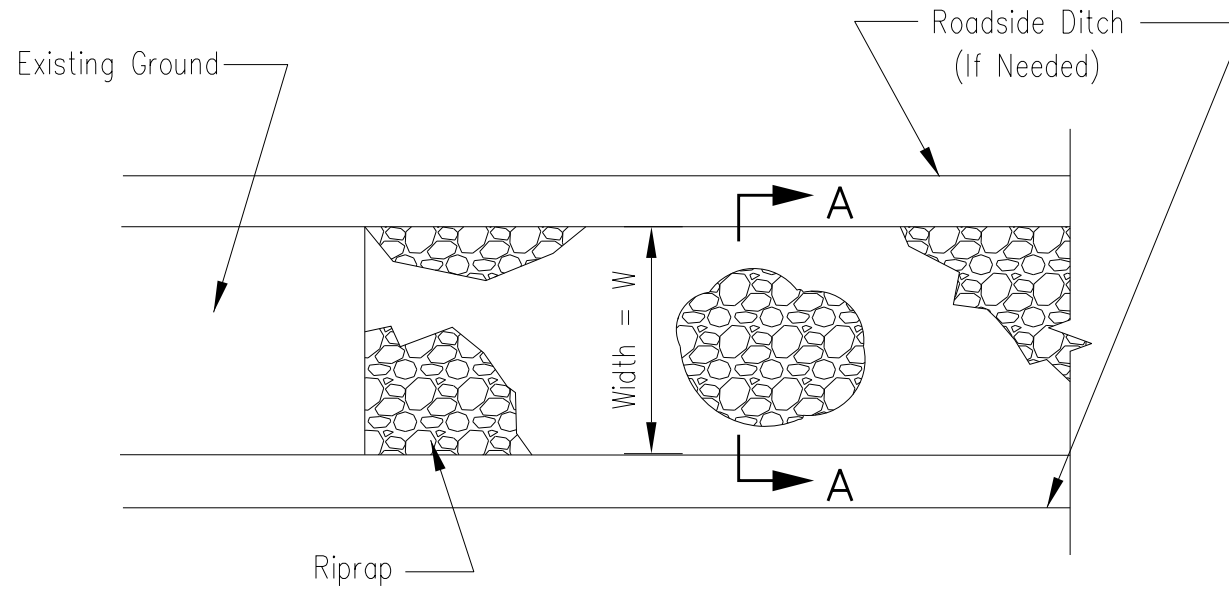

PLAN VIEW

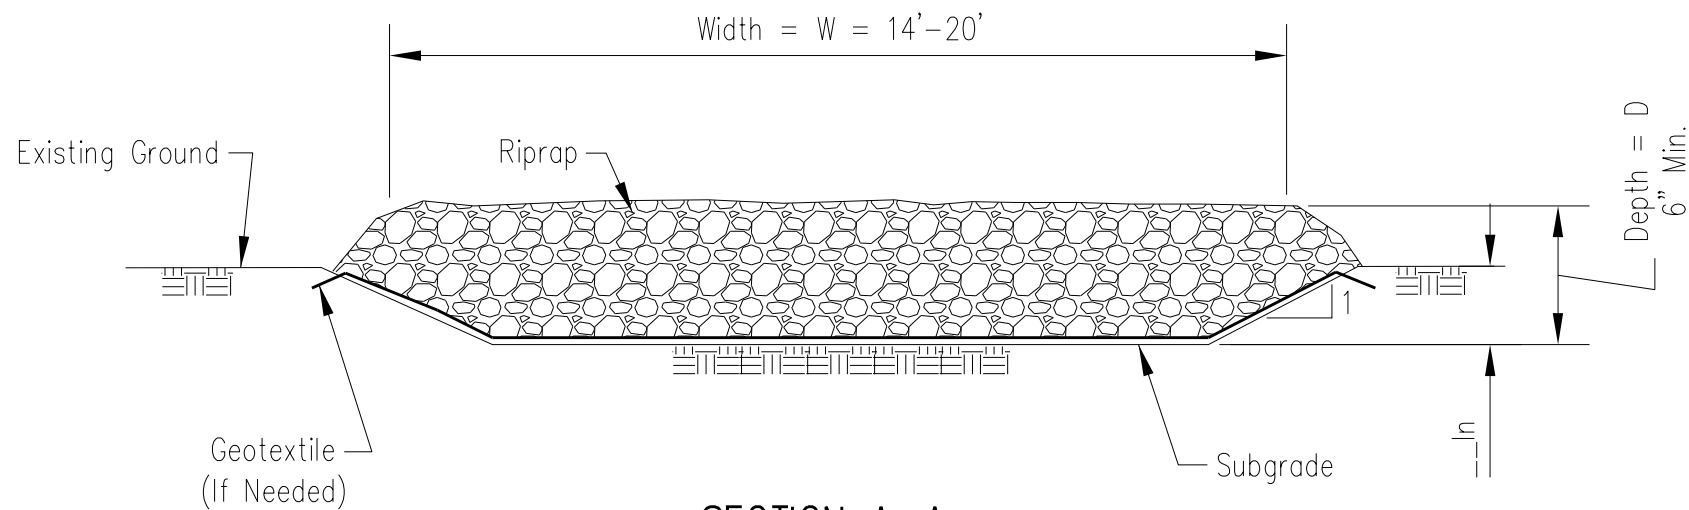

SECTION A-A

**SEDIMENT CONTROL, STABILIZED
CONSTRUCTION ENTRANCE**

NOTES:

1. Rock shall meet one of the following IDOT coarse aggregate gradations, CA-1, CA-2, CA-3 or CA-4.
2. See plans for stabilized construction entrance locations and special provisions for additional information.
3. Minimum width is 14 feet for one-way traffic and 20 feet for two-way traffic. Two-way traffic widths shall be increased a minimum of 4 feet for trailer traffic. Depending on the type of vehicle or equipment, speed, loads, climatic and other conditions under which vehicles and equipment operate an increase in the minimum widths may be required.
4. Roadway shall follow the contour of the natural terrain to the extent possible.
5. Filter Fabric: The filter fabric shall be made of synthetic polymers composed of at least 85 percent by weight polypropylene, polyesters, polyamides, polyethylene, polyolefins, or polyvinylidene-chlorides. The geotextile shall be free of any chemical treatment or coating that significantly reduces its porosity. Fibers shall contain stabilizers and/or inhibitors to enhance resistance to ultraviolet lights.
6. Any geotextile splices shall overlap a minimum of 18 inches, with upstream or upslope geotextile overlapping the abutting downslope geotextile.



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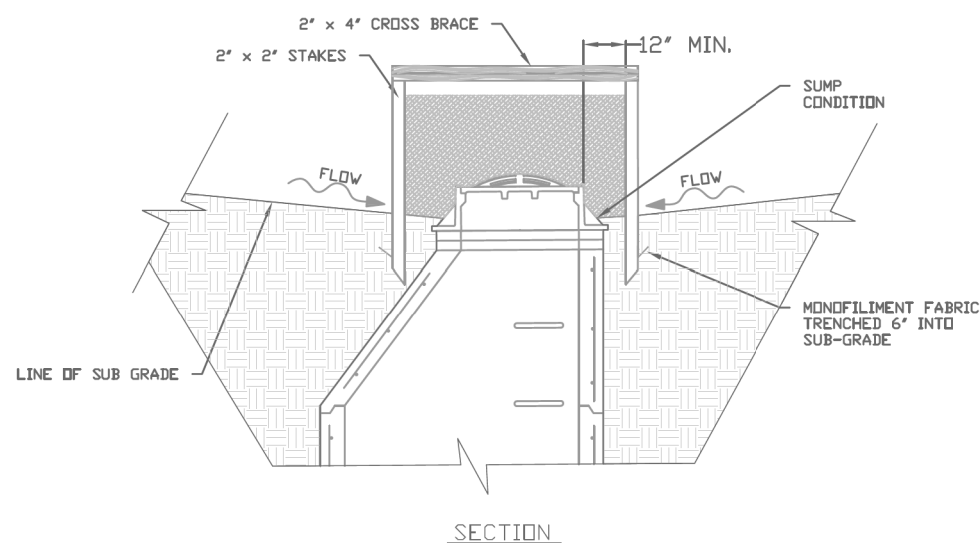
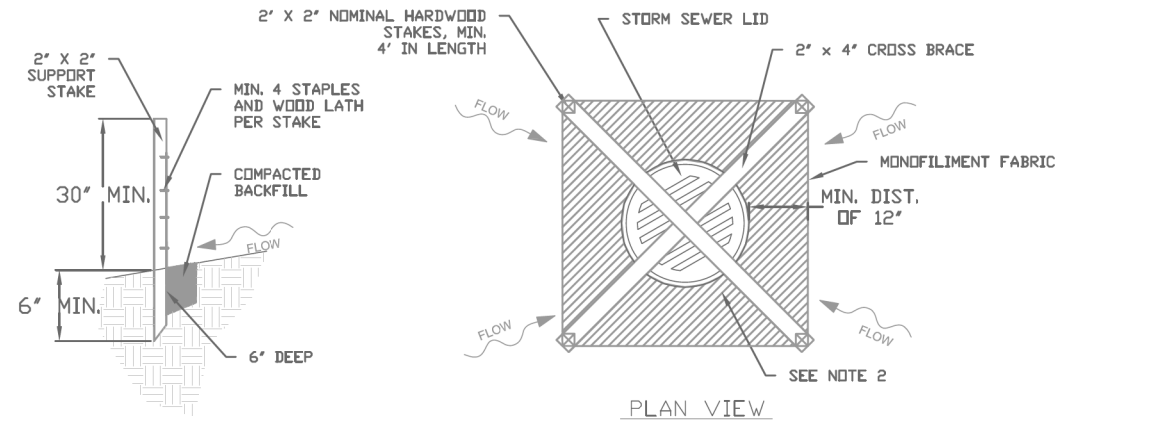
**STATE OF ILLINOIS
DEPARTMENT OF TRANSPORTATION**

**SOIL EROSION AND SEDIMENT CONTROL DETAILS
STABILIZED CONSTRUCTION ENTRANCE**

SCALE: SHEET 1 OF 1 SHEETS STA. TO STA.

F.A. U. RTE.	SECTION	COUNTY	TOTAL SHEETS	SHEET NO.
0320	13-00138-37-PV	WILL	413	188
CONTRACT NO. 61H20				
ILLINOIS FED. AID PROJECT				



INLET PROTECTION - MONOFILAMENT FABRIC BARRIER FENCE



- NOTES:**
- 2 x 2 nominal hardwood stakes, 4 foot minimum length, driven into ground approximately 18 inches, stakes driven a minimum width of 12 inches away from the drop inlet.
 - Area inside the fence, from edge of fabric to structure, must be stabilized with Erosion Control Blanket, Turf Reinforcement Mat, Geotextile 592 Table 2 Class 2 or CA-7 stone
 - Maximum height of the fabric above the crest of the drop inlet shall be 30". Place the bottom 6 inches of the fabric in a trench and backfill with 6 inches of 95% compacted soil.
 - Stakes must be a maximum of 4 feet apart.
 - A maintenance schedule must maintain a sediment accumulation of less than 50% of the height of the monofilament fabric.
 - Monofilament fabric shall meet the requirement of Material Specification 592 Geotextile Table 1, Class 4.
 - Monofilament fabric shall be secured to each 2" x 2" nominal hardwood stake with a minimum of 4 steel staple fasteners and wood lath. Wood lath shall be a minimum length of 10 inches. Wire fasteners should be used if metal T-Posts are installed in place of hardwood stakes.

REFERENCE	STANDARD DWG. NO.
Project _____	IUM-531
Designed _____ Date _____	SHEET 1 OF 1
Checked _____ Date _____	DATE 04-6-15
Approved _____ Date _____	

INLET PROTECTION - PAVED AREAS DROP-IN PROTECTION

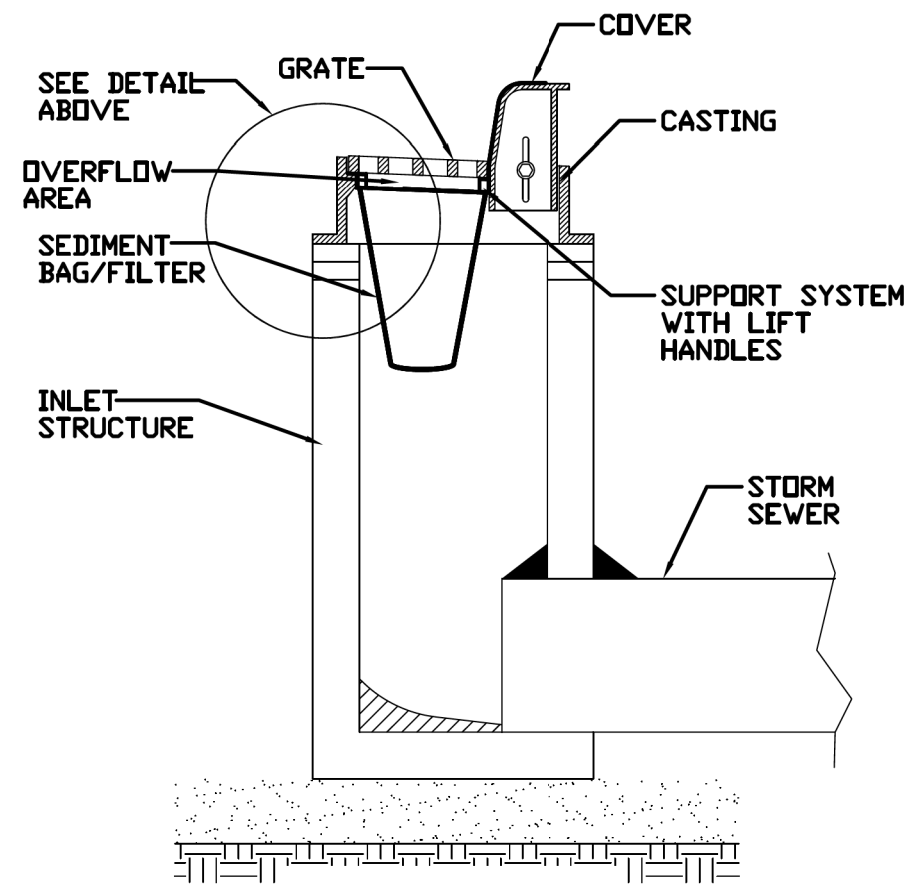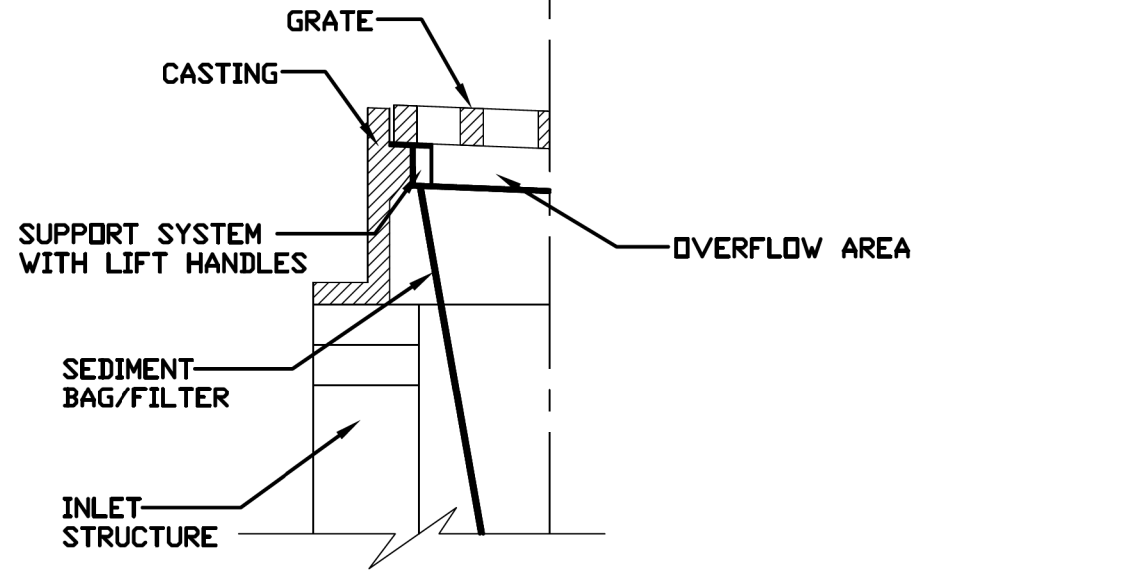

REFERENCE	STANDARD DWG. NO.
Project _____	IUM-561D
Designed _____ Date _____	SHEET 1 OF 1
Checked _____ Date _____	DATE 01-11-11
Approved _____ Date _____	




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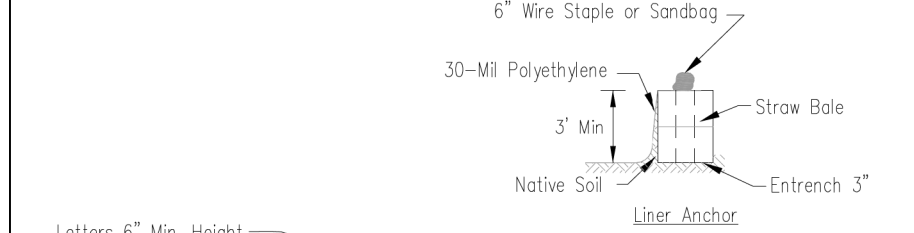
STATE OF ILLINOIS
DEPARTMENT OF TRANSPORTATION

SOIL EROSION AND SEDIMENT CONTROL DETAILS
INLET AND PIPE PROTECTION DETAILS


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0320	13-00138-37-PV	WILL	413	189
CONTRACT NO. 61H20				
SCALE:		SHEET 1 OF 1 SHEETS		STA. TO STA.
		ILLINOIS		FED. AID PROJECT

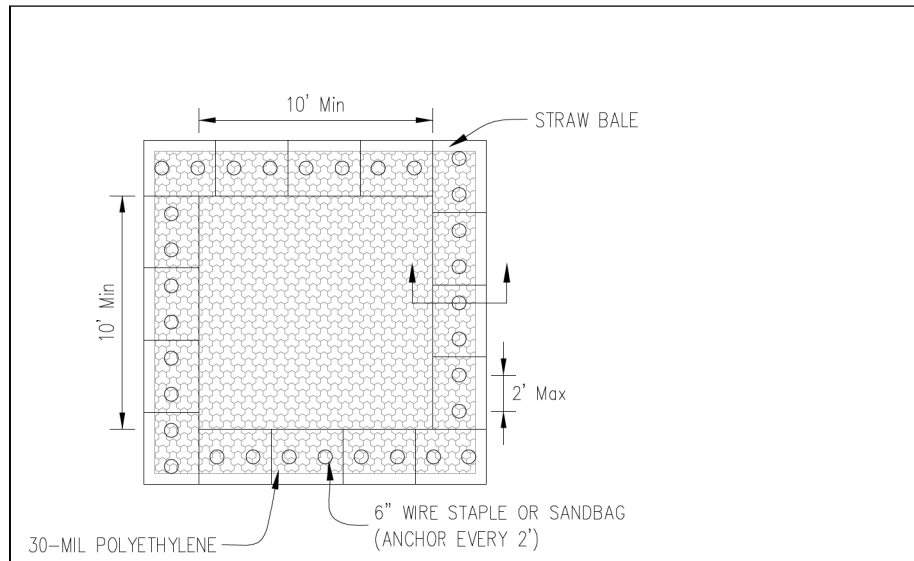

PLAN VIEW



STRAW BALE ANCHOR SECTIONS

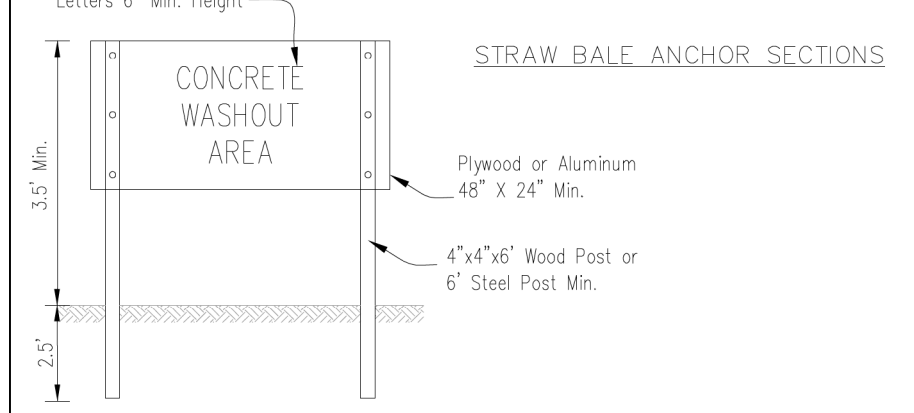


SIGN DETAIL

NOTES:

- Maintaining temporary concrete washout facilities shall include removing and disposing of hardened concrete and/or slurry and returning the facilities to a functional condition.
- Facility shall be cleaned or reconstructed in a new area once washout becomes two-thirds full.
- Each straw bale is to be staked in place using (2) 2"x2"x4' wooden stakes.


Sheet 1 of 3	File No. IUM-627	Drawn B. JOHNSON	6/08
	Design No. 654518	Checked	
		Approved	

TEMPORARY CONCRETE WASHOUT FACILITY - STRAW BALE

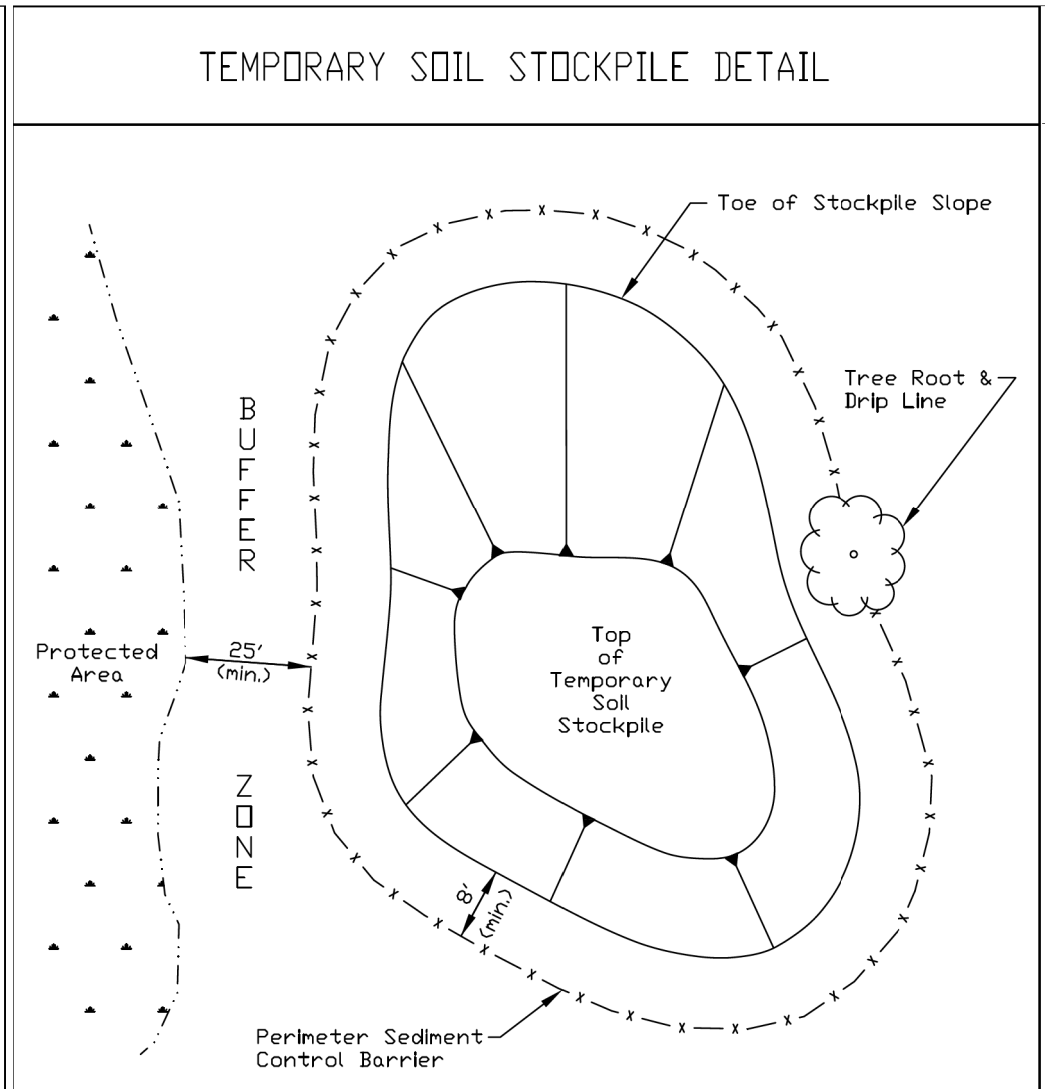

- NOTES:
- Stockpile slopes should be based on angle of repose of the soil material to avoid potential sloughing of the slope.
 - Soil stockpile to be stabilized in accordance with practical standards.
 - Do not locate stockpile within overland drainage flow path, designated floodways, drip line or over the root crown of adjacent trees.
 - Provisions for sediment control practices may be required along haul roads and entrance/exit locations for access the soil stockpile that can create flow path for stormwater runoff.
 - Installation of benches, terraces, or slope interrupters should be considered.
 - Avoid building soil stockpiles on impervious surfaces.
 - Linear sediment trap surrounding the stockpile base may be used to control sediment.

REFERENCE Project _____ Date _____		STANDARD DWG. NO. IUM-627
Designed _____ Date _____		SHEET 1 OF 1
Checked _____ Date _____		DATE JANUARY 2017
Approved _____ Date _____		

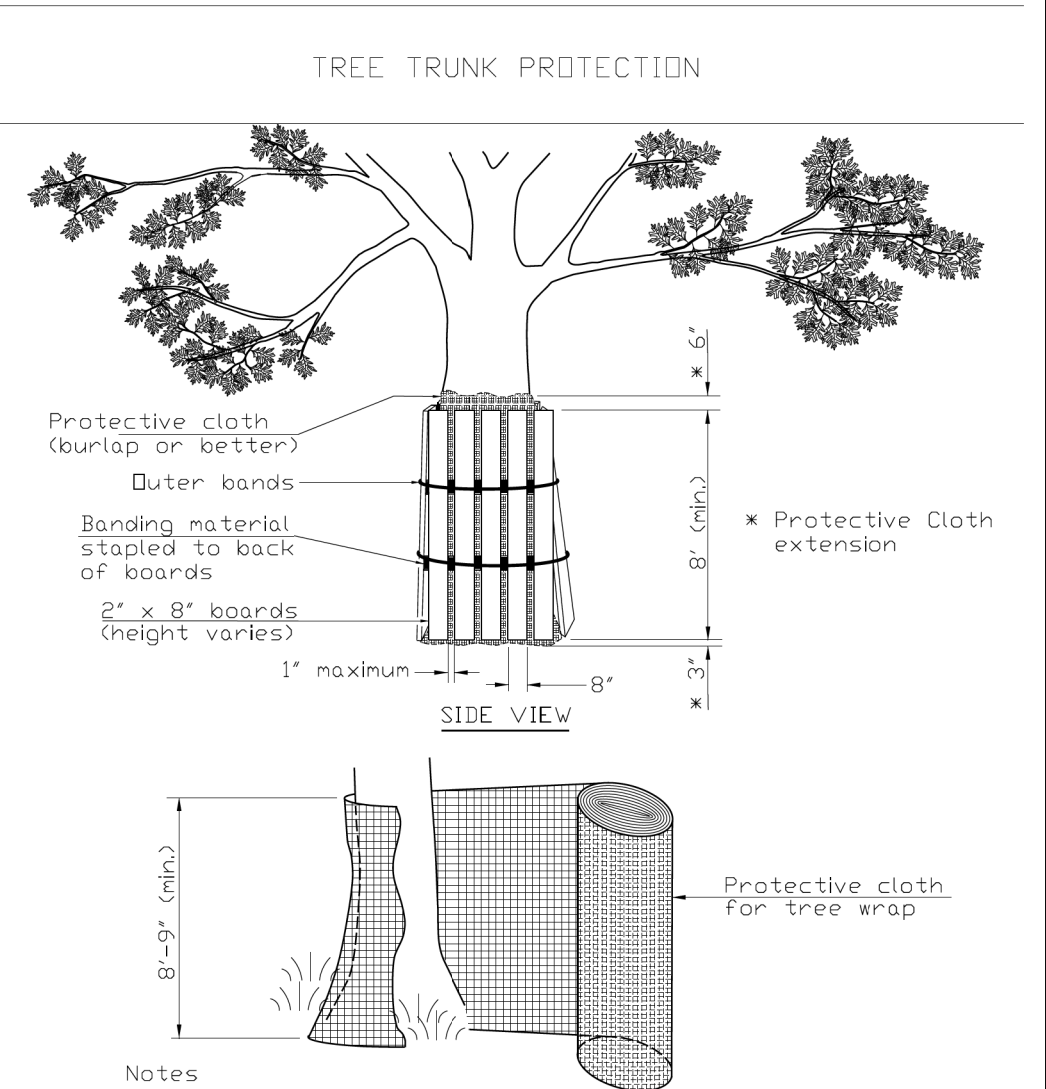

- Notes
- The contractor shall provide 2" x 8" boards banded continuously around each trunk with a protective cloth (such as burlap or better) placed between the boards and the tree to prevent scarring of the tree being protected. The height of the boards is variable due to height of tree being protected. Trees to be protected shall be shown in the plans or designated by the Professional Forester or Certified Arborist.
 - The protective cloth shall extend past both the top and bottom of the boards as shown in the detail. Width of wrap material varies. For fabric that does not meet the required height, fabric shall overlap a minimum of 6" and shall be spliced to avoid slippage.

REFERENCE Project _____ Date _____		STANDARD DWG. NO. IUM-690-C
Designed _____ Date _____		SHEET 1 OF 1
Checked _____ Date _____		DATE 09-14-2017
Approved _____ Date _____		


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BY	
PLAN	
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PROFILE	
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DATE	
BY	
PROFILE	
NO.	

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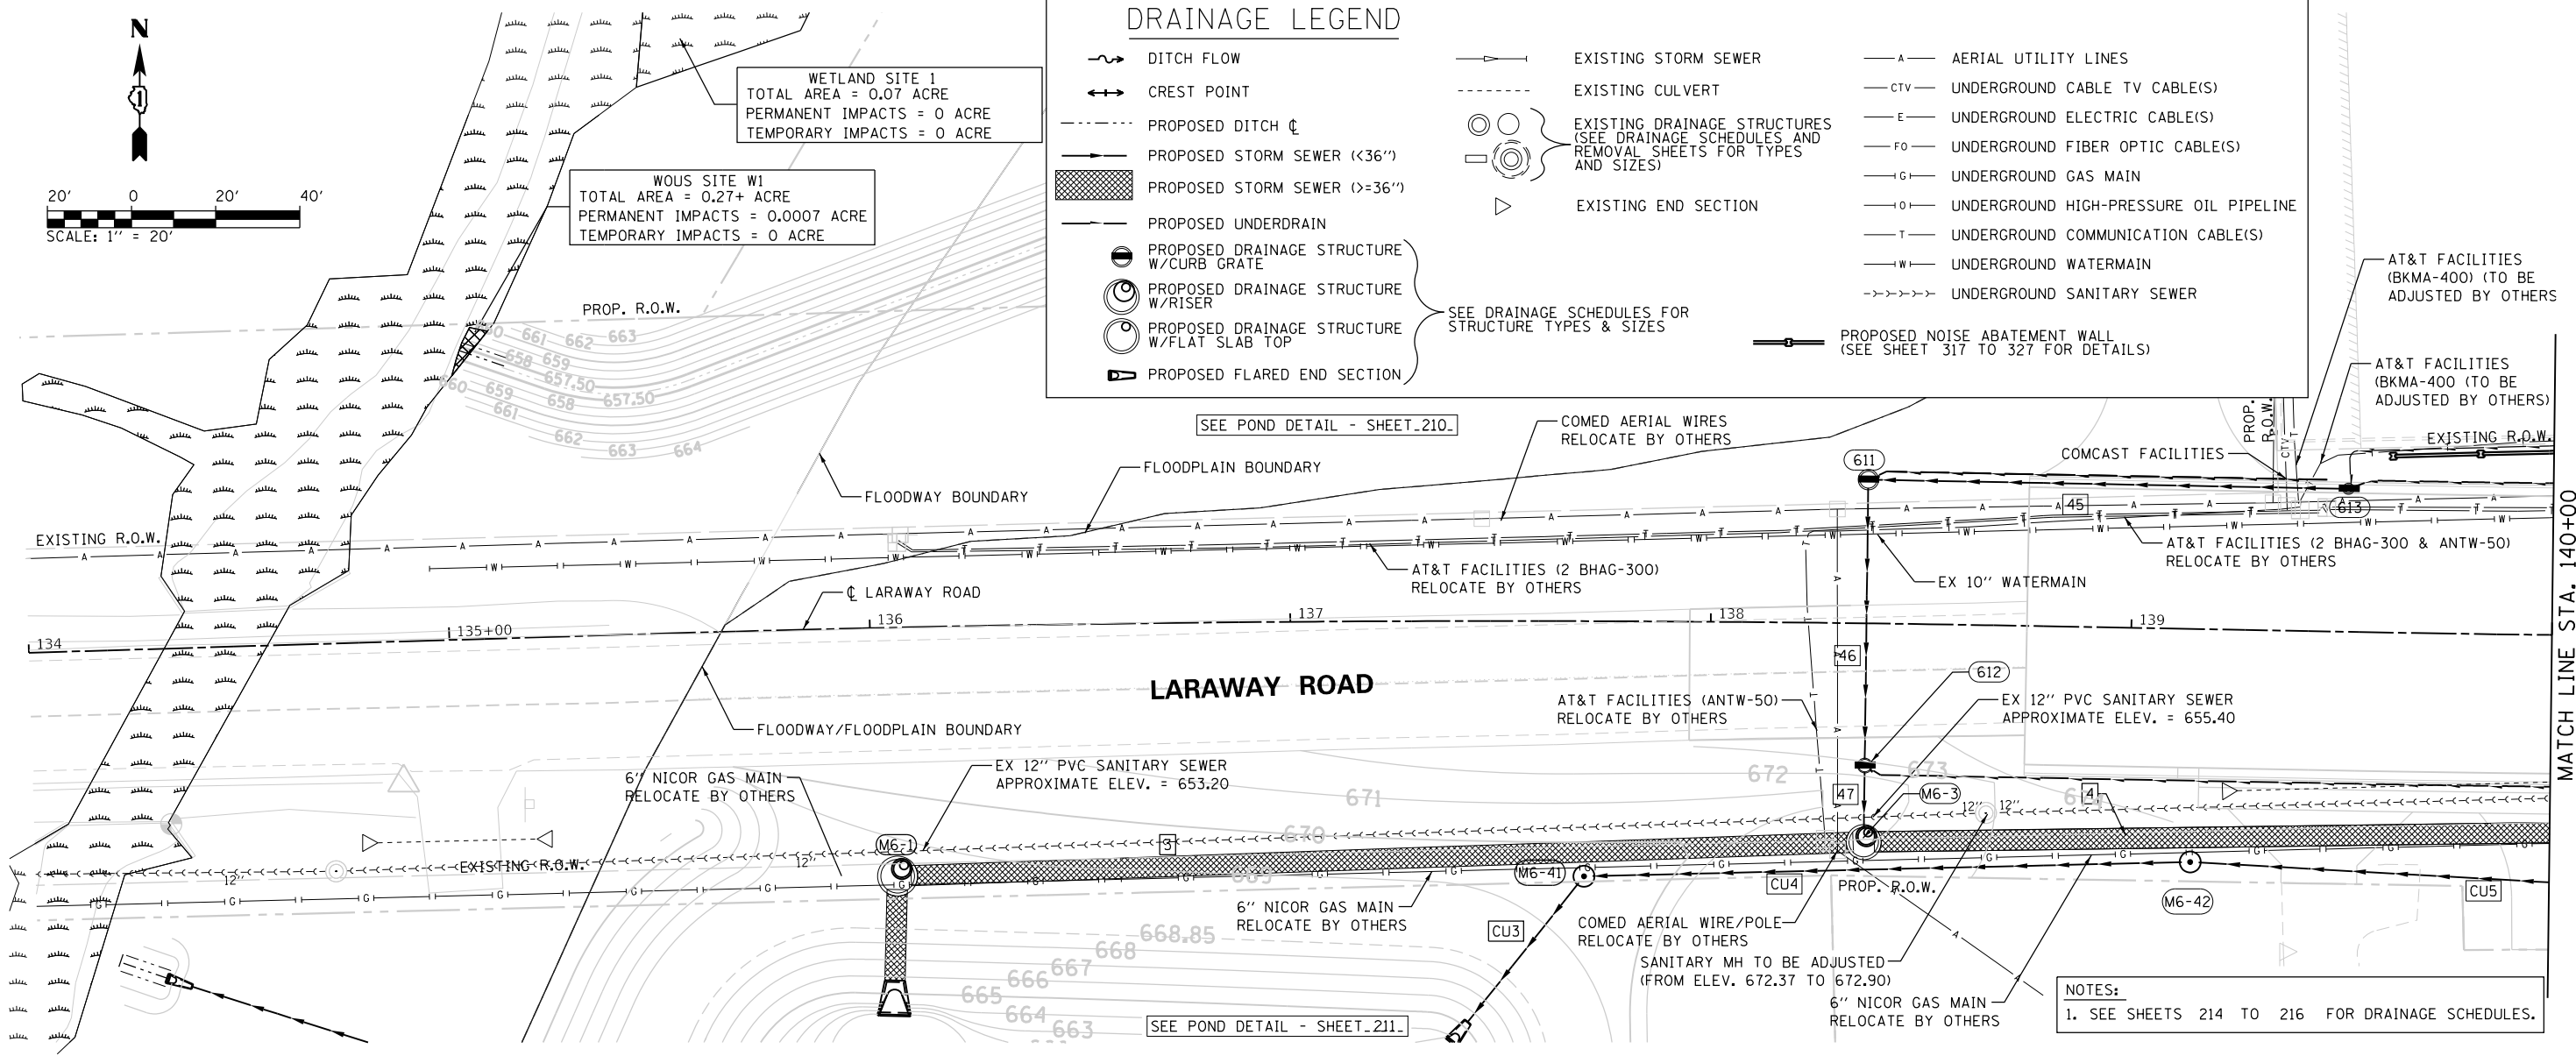


DRAINAGE LEGEND


- DITCH FLOW
- CREST POINT
- PROPOSED DITCH
- PROPOSED STORM SEWER (<36")
- PROPOSED STORM SEWER (>=36")
- PROPOSED UNDERDRAIN
- PROPOSED DRAINAGE STRUCTURE W/CURB GRATE
- PROPOSED DRAINAGE STRUCTURE W/RISER
- PROPOSED DRAINAGE STRUCTURE W/FLAT SLAB TOP
- PROPOSED FLARED END SECTION
- EXISTING STORM SEWER
- EXISTING CULVERT
- EXISTING DRAINAGE STRUCTURES (SEE DRAINAGE SCHEDULES AND REMOVAL SHEETS FOR TYPES AND SIZES)
- EXISTING END SECTION
- AERIAL UTILITY LINES
- UNDERGROUND CABLE TV CABLE(S)
- UNDERGROUND ELECTRIC CABLE(S)
- UNDERGROUND FIBER OPTIC CABLE(S)
- UNDERGROUND GAS MAIN
- UNDERGROUND HIGH-PRESSURE OIL PIPELINE
- UNDERGROUND COMMUNICATION CABLE(S)
- UNDERGROUND WATERMAIN
- UNDERGROUND SANITARY SEWER
- PROPOSED NOISE ABATEMENT WALL (SEE SHEET 317 TO 327 FOR DETAILS)

WETLAND SITE 1
 TOTAL AREA = 0.07 ACRE
 PERMANENT IMPACTS = 0 ACRE
 TEMPORARY IMPACTS = 0 ACRE

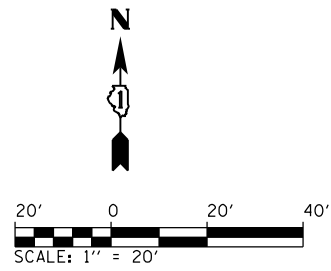WOUS SITE W1
 TOTAL AREA = 0.27+ ACRE
 PERMANENT IMPACTS = 0.0007 ACRE
 TEMPORARY IMPACTS = 0 ACRE



RIGHT DITCH (SOUTH) PROFILE

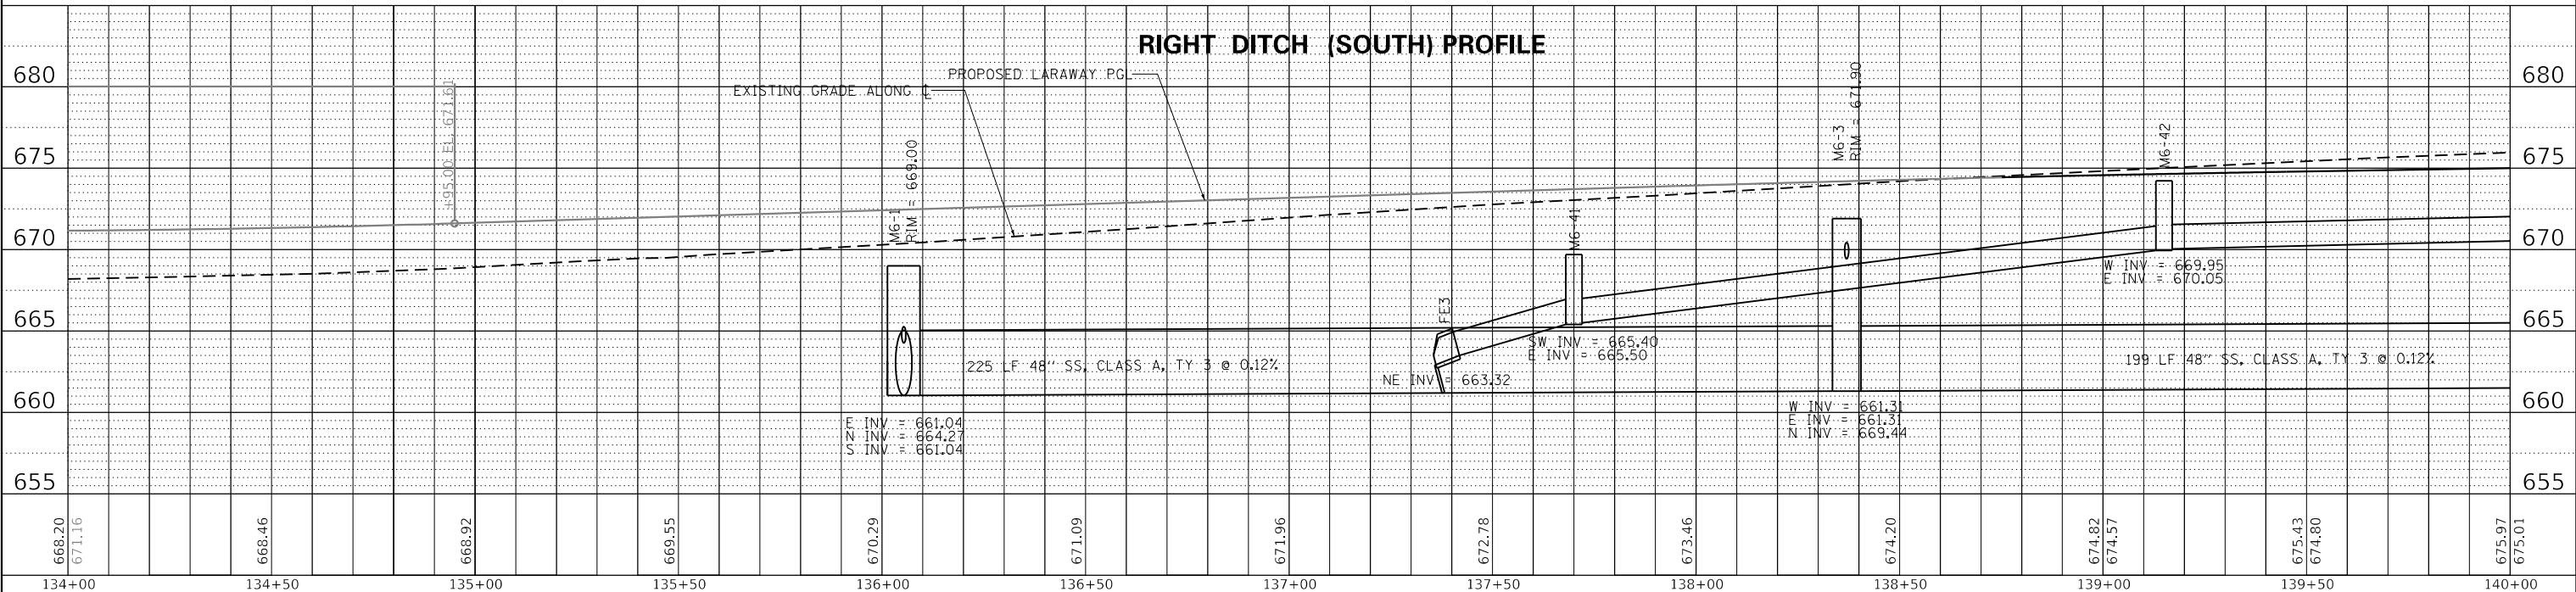

NOTES:
 1. SEE SHEETS 214 TO 216 FOR DRAINAGE SCHEDULES.



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DRAWN -	ECW
CHECKED -	
DATE -	09/09/2022

REVISED -	
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REVISED -	
REVISED -	

STATE OF ILLINOIS
DEPARTMENT OF TRANSPORTATION

DRAINAGE PLAN AND PROFILE			
LARAWAY ROAD			
SCALE: 1" = 20'	SHEET 1	OF 14 SHEETS	STA. 134+00 TO STA. 140+00

F.A.U. RTE.	SECTION	COUNTY	TOTAL SHEETS	SHEET NO.
0320	13-00138-37-PV	WILL	413	192
CONTRACT NO. 61H20				
ILLINOIS FED. AID PROJECT				

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	PLOTTED	
	ALIGNED	
	CHECKED	
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	PLOTTED	
	GRADES CHECKED	
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PROFILE	SURVEYED	DATE
	PLOTTED	
	GRADES CHECKED	
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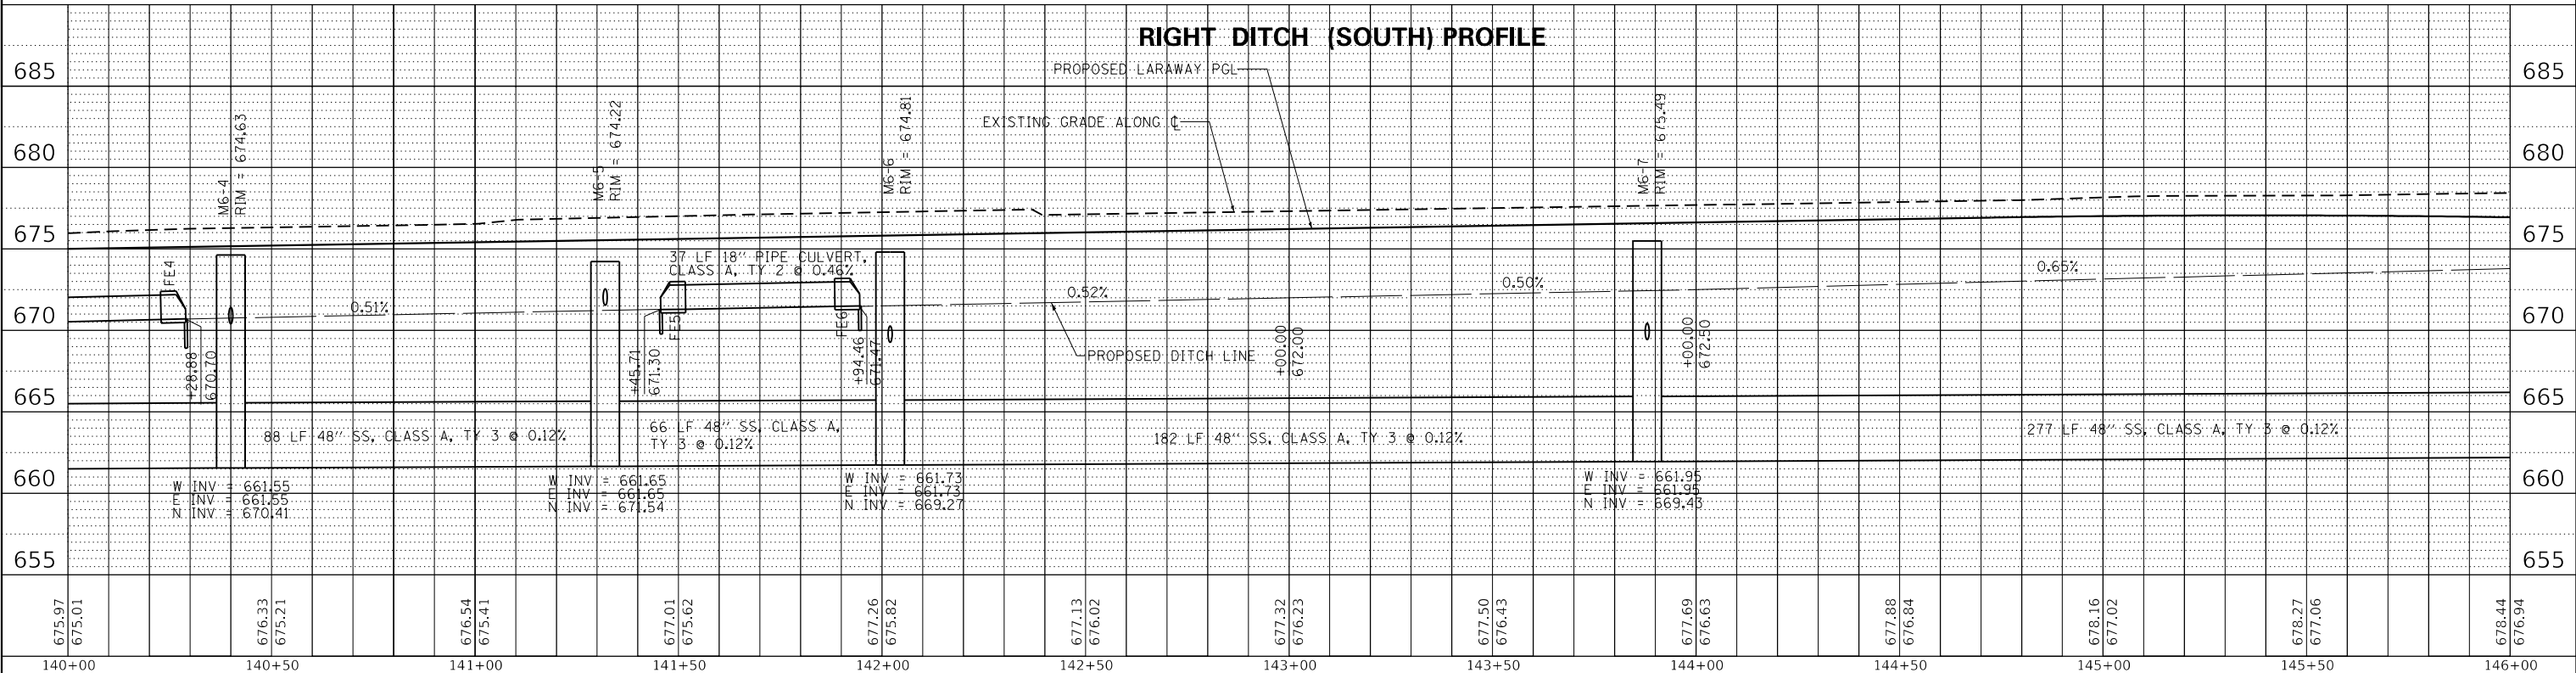
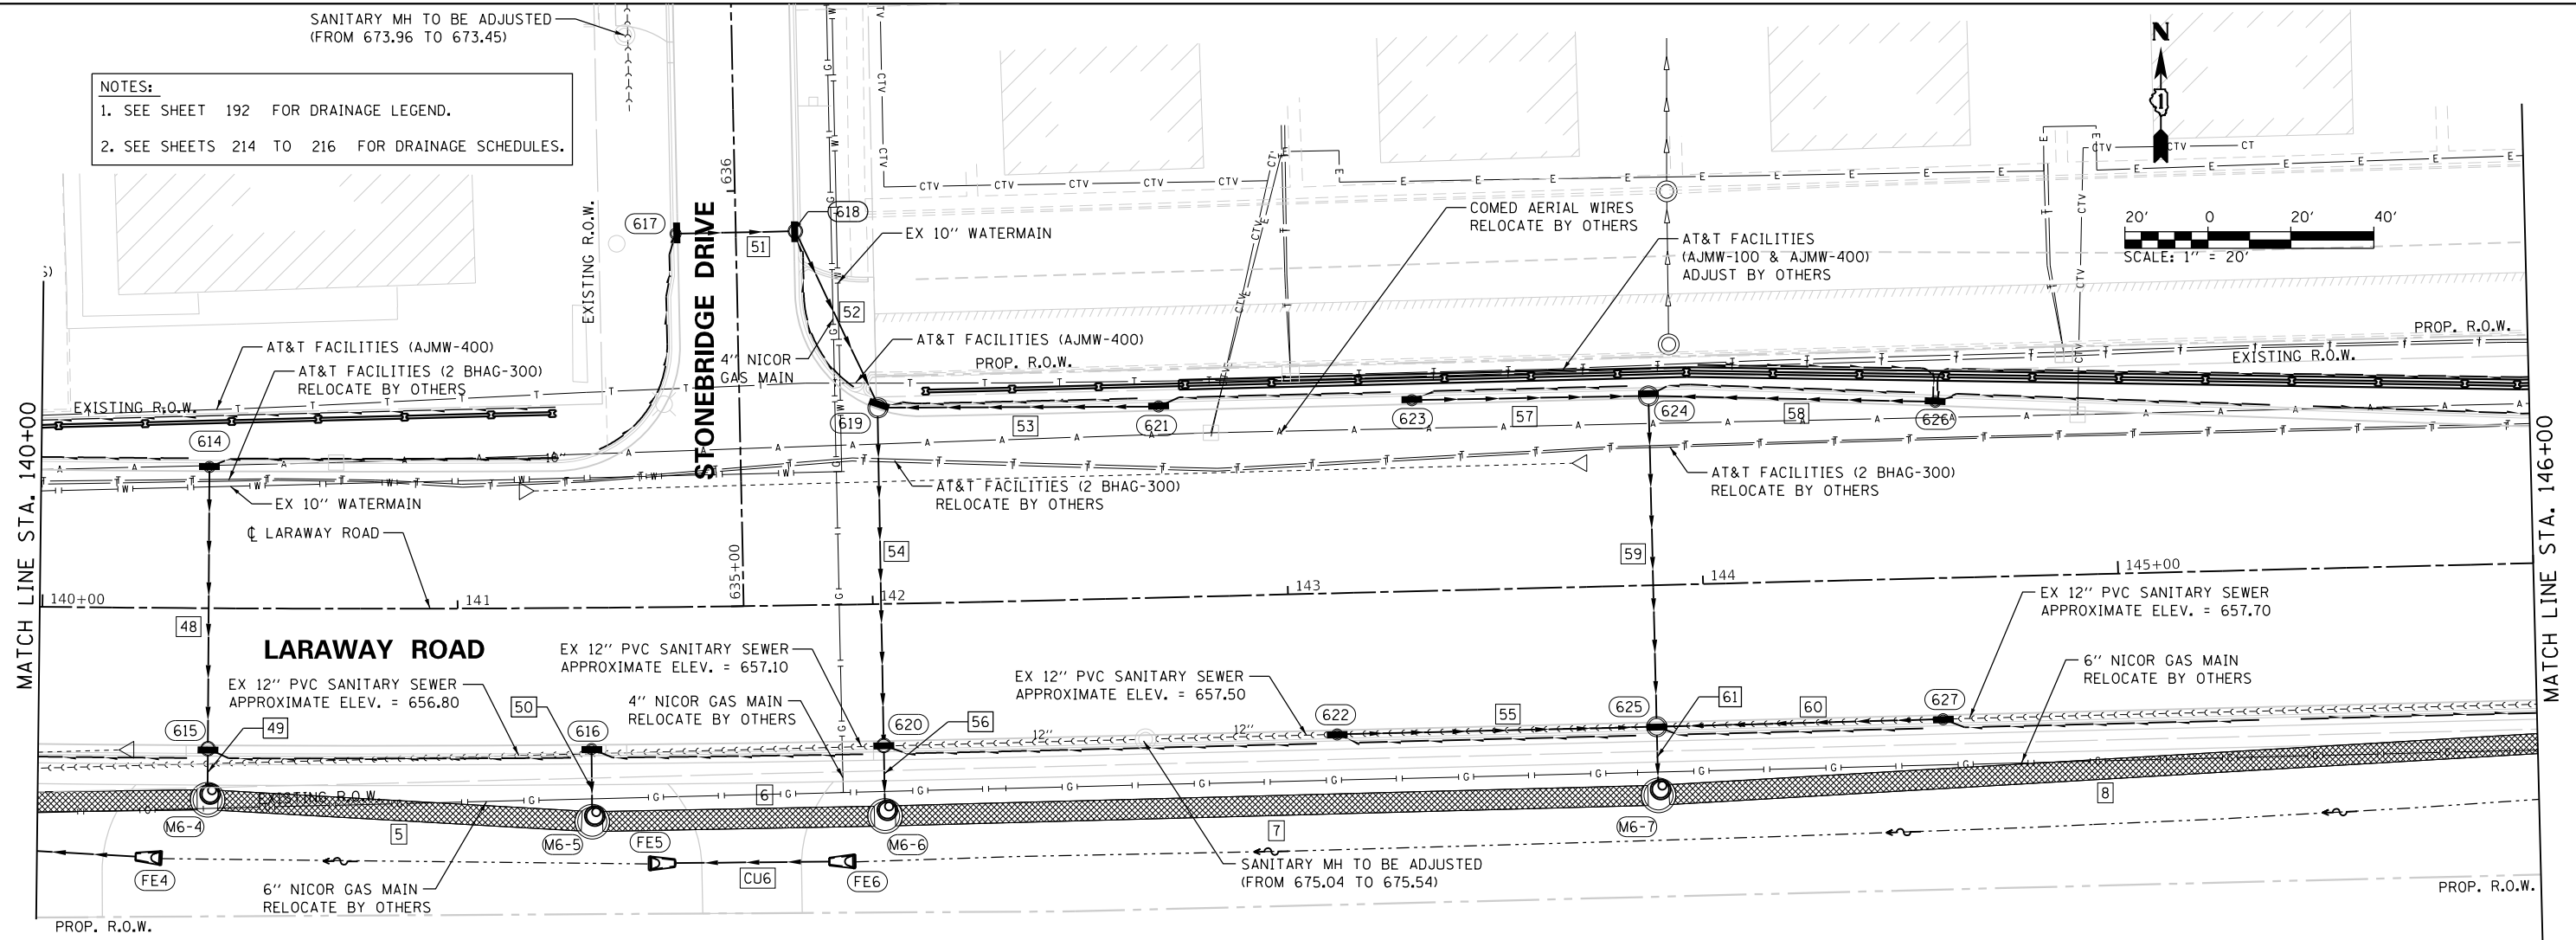
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 DIRECTORY = L:\MILLCO17204\01Draw\CADD_Sheets\

- NOTES:**
- SEE SHEET 192 FOR DRAINAGE LEGEND.
 - SEE SHEETS 214 TO 216 FOR DRAINAGE SCHEDULES.



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 PLOT DATE = 9/9/2022 - 12:19:07 PM

DESIGNED - ECW
 DRAWN - ECW
 CHECKED -
 DATE - 09/09/2022

REVISED -
 REVISED -
 REVISED -
 REVISED -

**STATE OF ILLINOIS
 DEPARTMENT OF TRANSPORTATION**

**DRAINAGE PLAN AND PROFILE
 LARAWAY ROAD**

SCALE: 1" = 20' SHEET 2 OF 14 SHEETS STA. 140+00 TO STA. 146+00

F.A.U. RTE.	SECTION	COUNTY	TOTAL SHEETS	SHEET NO.
0320	13-00138-37-PV	WILL	413	193
CONTRACT NO. 61H20				
ILLINOIS FED. AID PROJECT				


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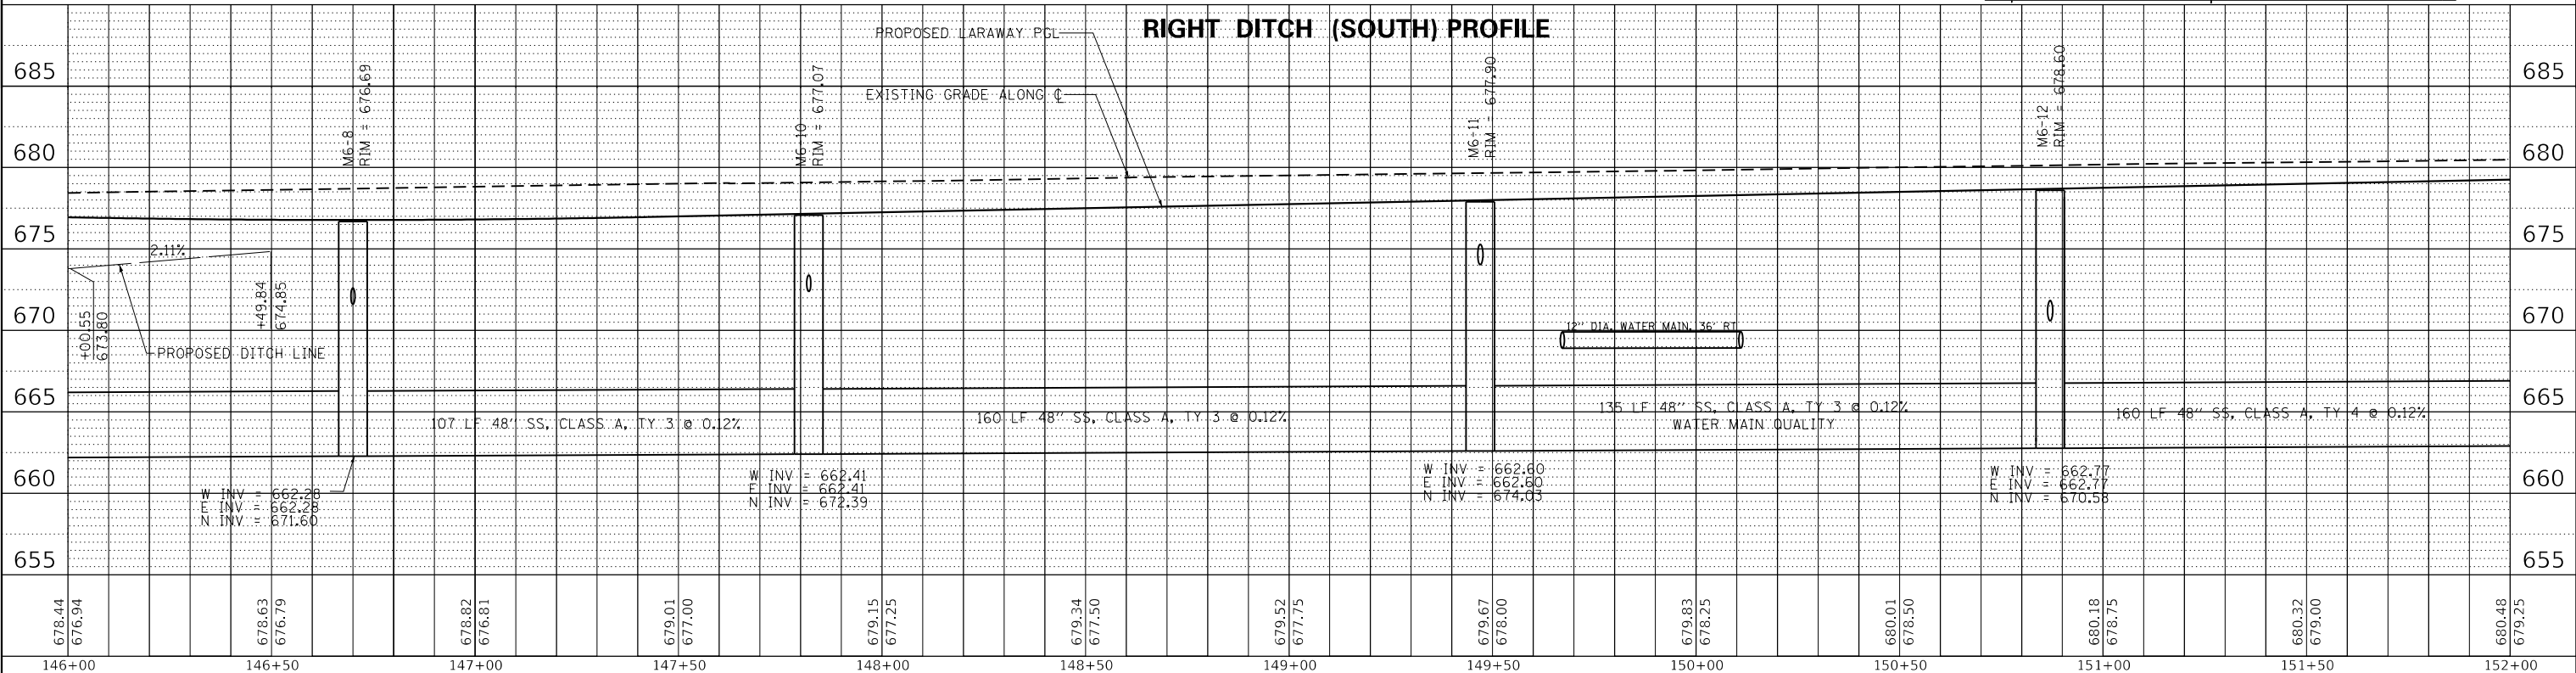
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PLOT DRIVER = pdfplotlayerbwtidg
 PEN TABLE = Laraway_Drainage.tbl



- NOTES:**
- SEE SHEET 192 FOR DRAINAGE LEGEND.
 - SEE SHEETS 214 TO 216 FOR DRAINAGE SCHEDULES.
 - 4" PVC SUMP PUMP DISCHARGE PIPES SHALL BE ROUTED INTO THE PROPOSED STORM SEWER WITH NEW PVC PIPE AS SHOWN.



678.44	676.94	678.63	676.79	678.82	676.81	679.01	677.00	679.15	677.25	679.34	677.50	679.52	677.75	679.67	678.00	679.83	678.25	680.01	678.50	680.18	678.75	680.32	679.00	680.48	679.25
146+00		146+50		147+00		147+50		148+00		148+50		149+00		149+50		150+00		150+50		151+00		151+50		152+00	

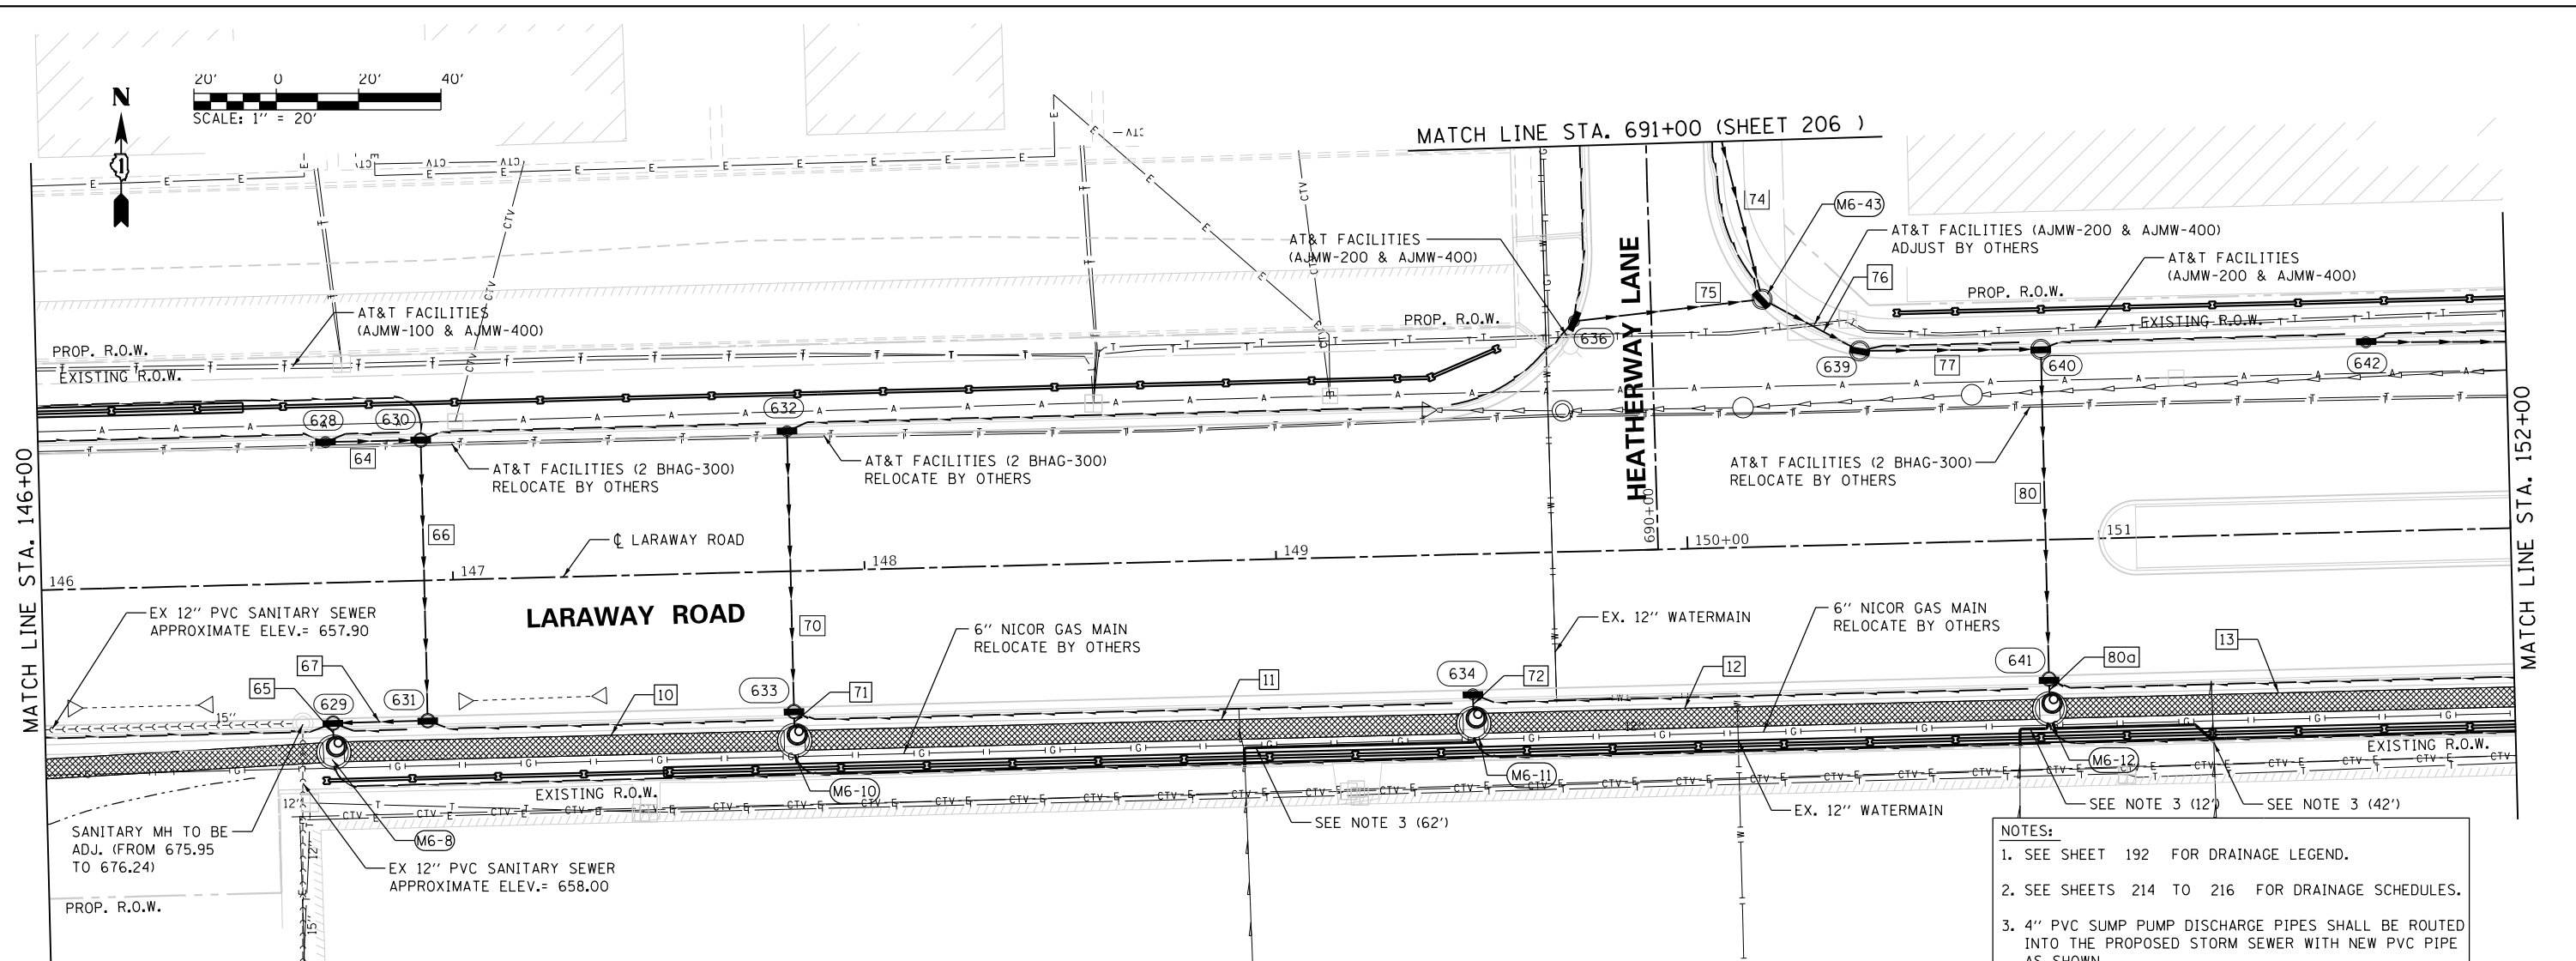

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 DATE - 09/09/2022

REVISED -
 REVISED -
 REVISED -
 REVISED -

STATE OF ILLINOIS
 DEPARTMENT OF TRANSPORTATION

DRAINAGE PLAN AND PROFILE
 LARAWAY ROAD

SCALE: 1" = 20' SHEET 3 OF 14 SHEETS STA. 146+00 TO STA. 152+00

F.A.U. RTE.	SECTION	COUNTY	TOTAL SHEETS	SHEET NO.
0320	13-00138-37-PV	WILL	413	194
CONTRACT NO. 61H20				
ILLINOIS FED. AID PROJECT				




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NOTES:
1. SEE SHEET 192 FOR DRAINAGE LEGEND.
2. SEE SHEETS 214 TO 216 FOR DRAINAGE SCHEDULES.



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PLOT DATE =	9/9/2022 - 12:19:13 PM	DATE -	09/09/2022	REVISED -	

STATE OF ILLINOIS
DEPARTMENT OF TRANSPORTATION

DRAINAGE PLAN AND PROFILE LARAWAY ROAD			
SCALE: 1" = 20'	SHEET 4	OF 14 SHEETS	STA. 152+00 TO STA. 157+00

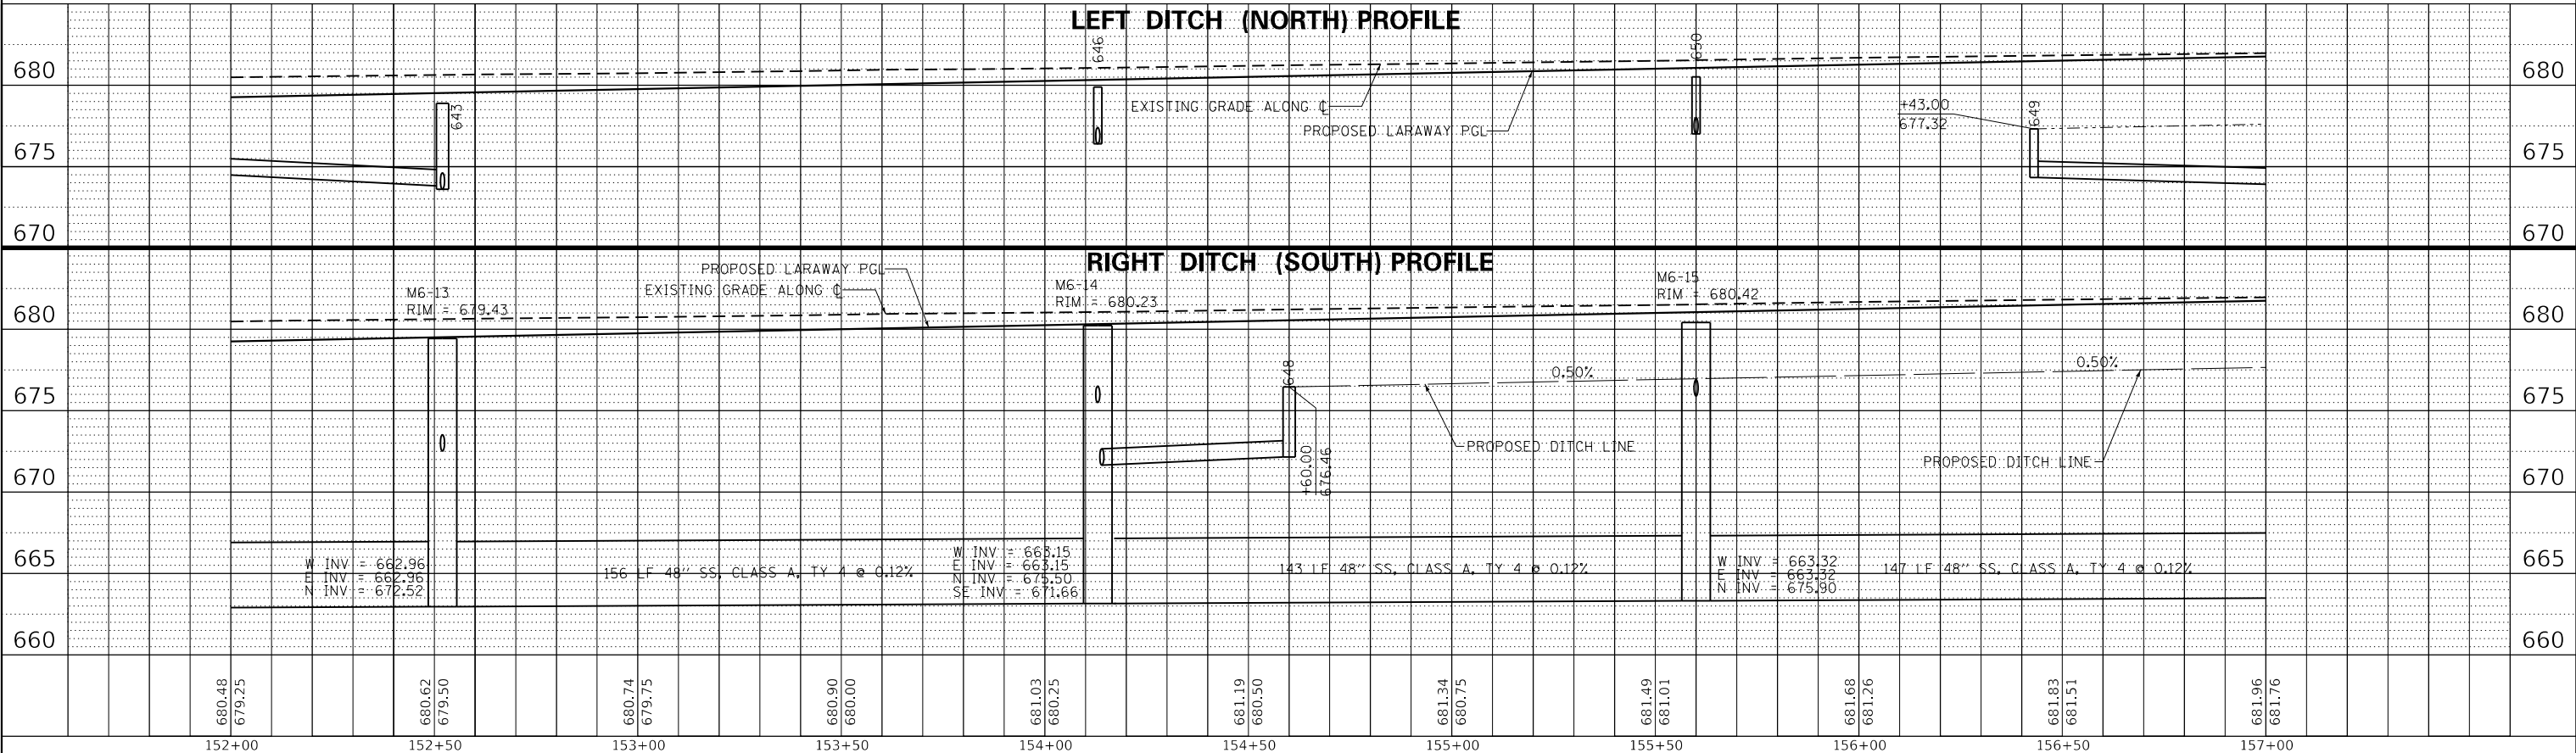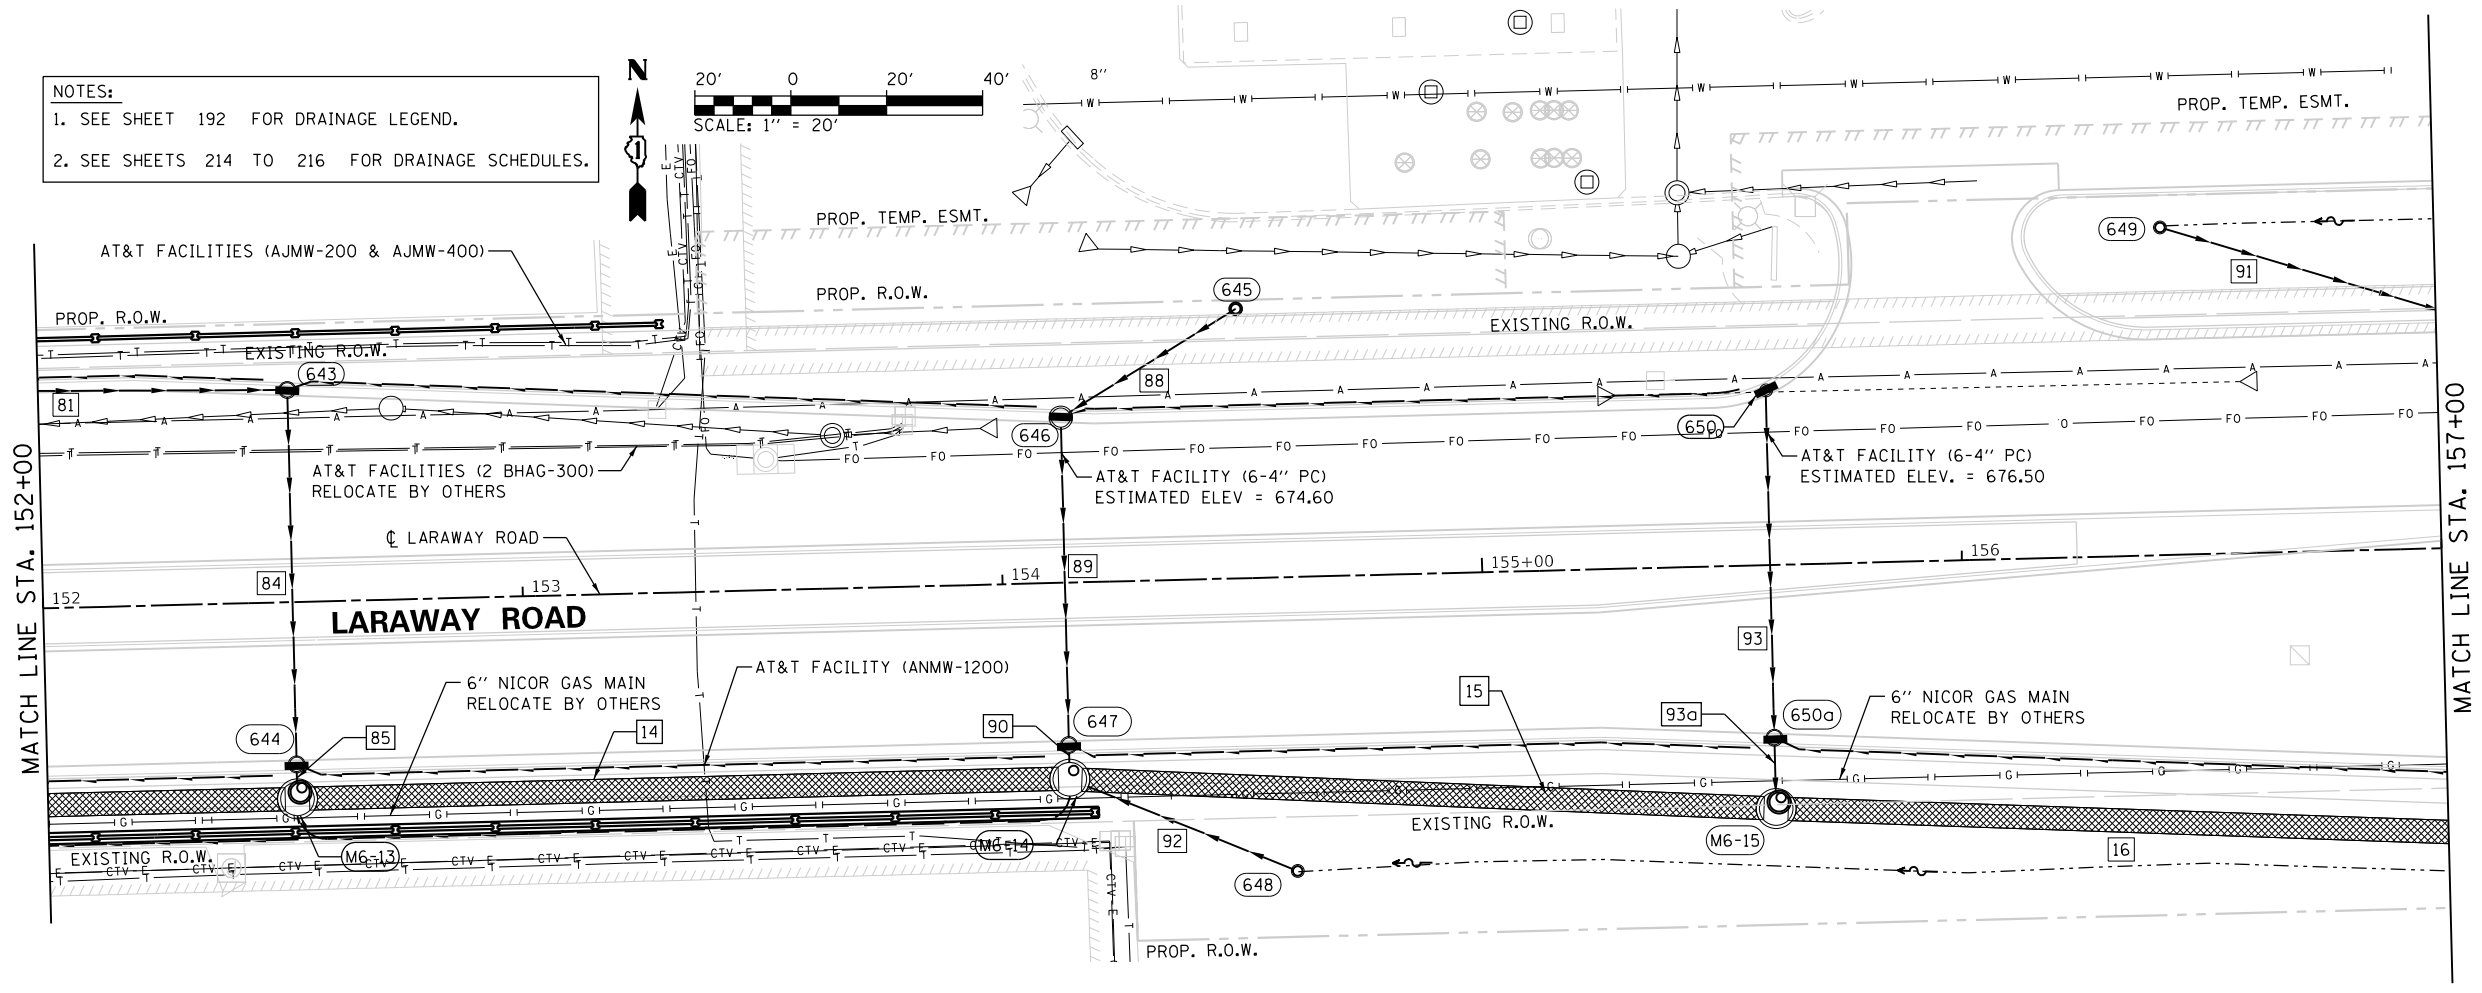
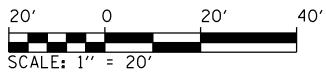
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CONTRACT NO. 61H20				
ILLINOIS FED. AID PROJECT				

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	CHECKED	
	FILED	
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	NO.	
	NO.	
	NO.	

PLOT SCALE =
PLOT DATE =

PROFILE	SURVEYED	DATE
	PLOTTED	
	GRADES	
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PLOT DATE = 9/9/2022 (12:12:15 PM) PM

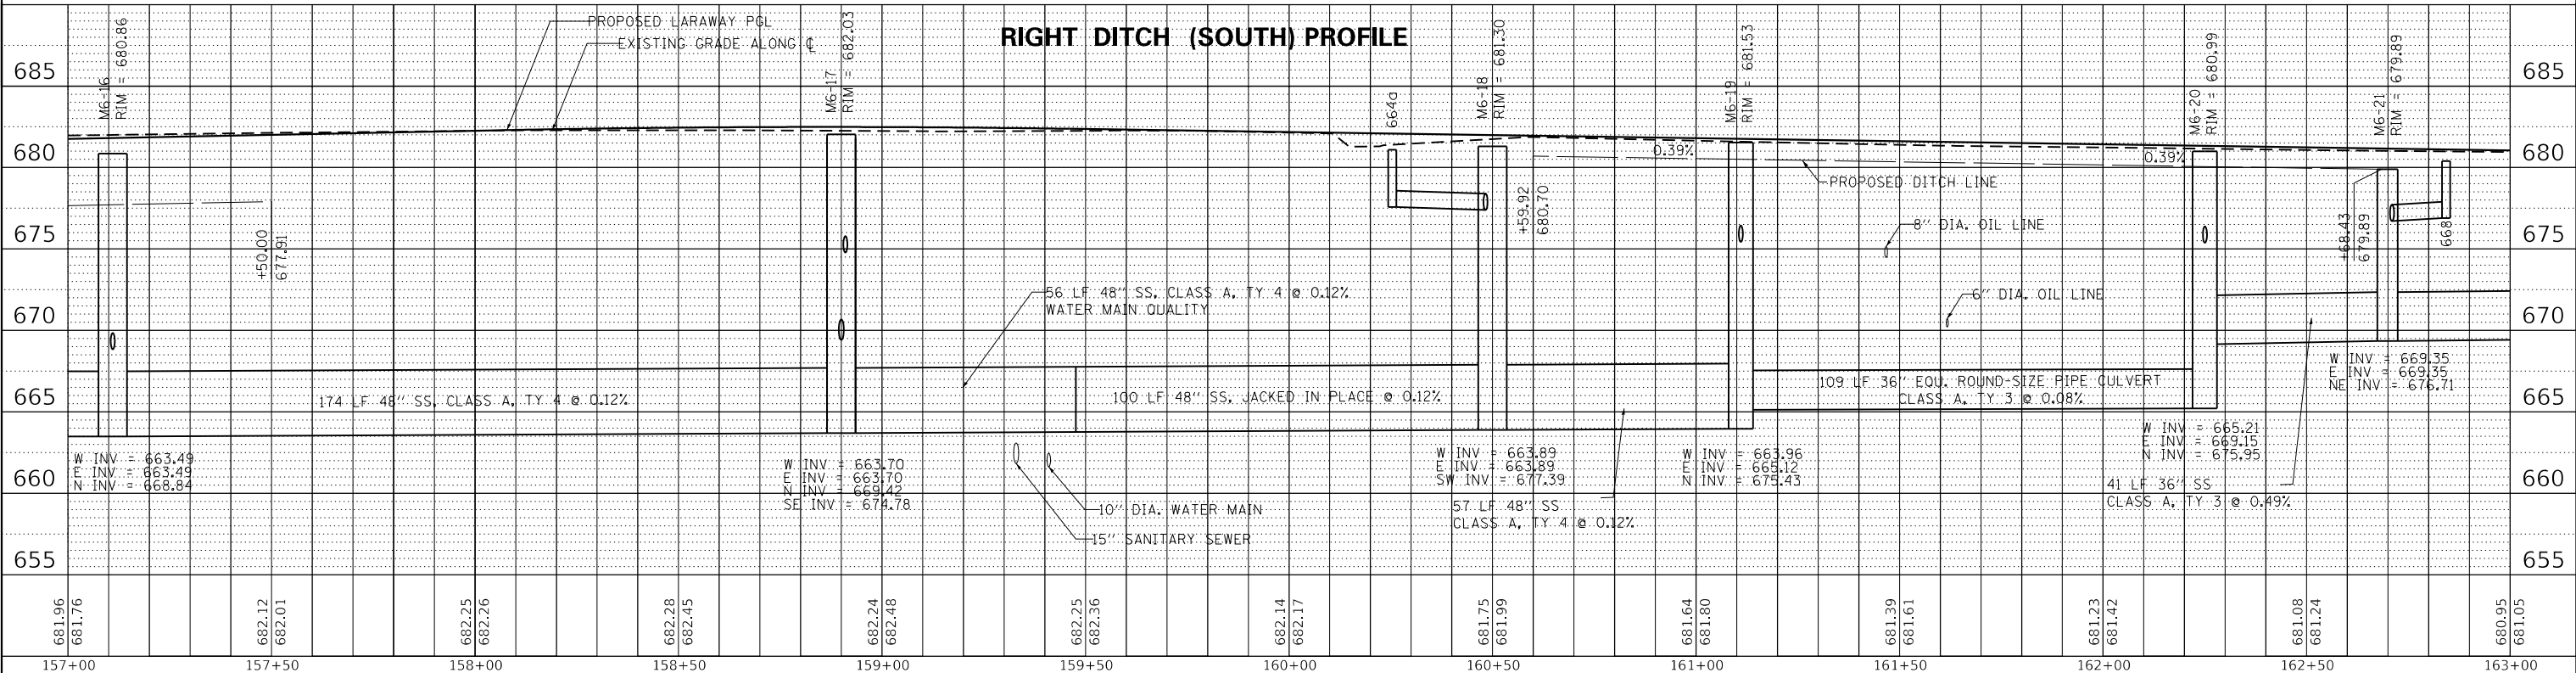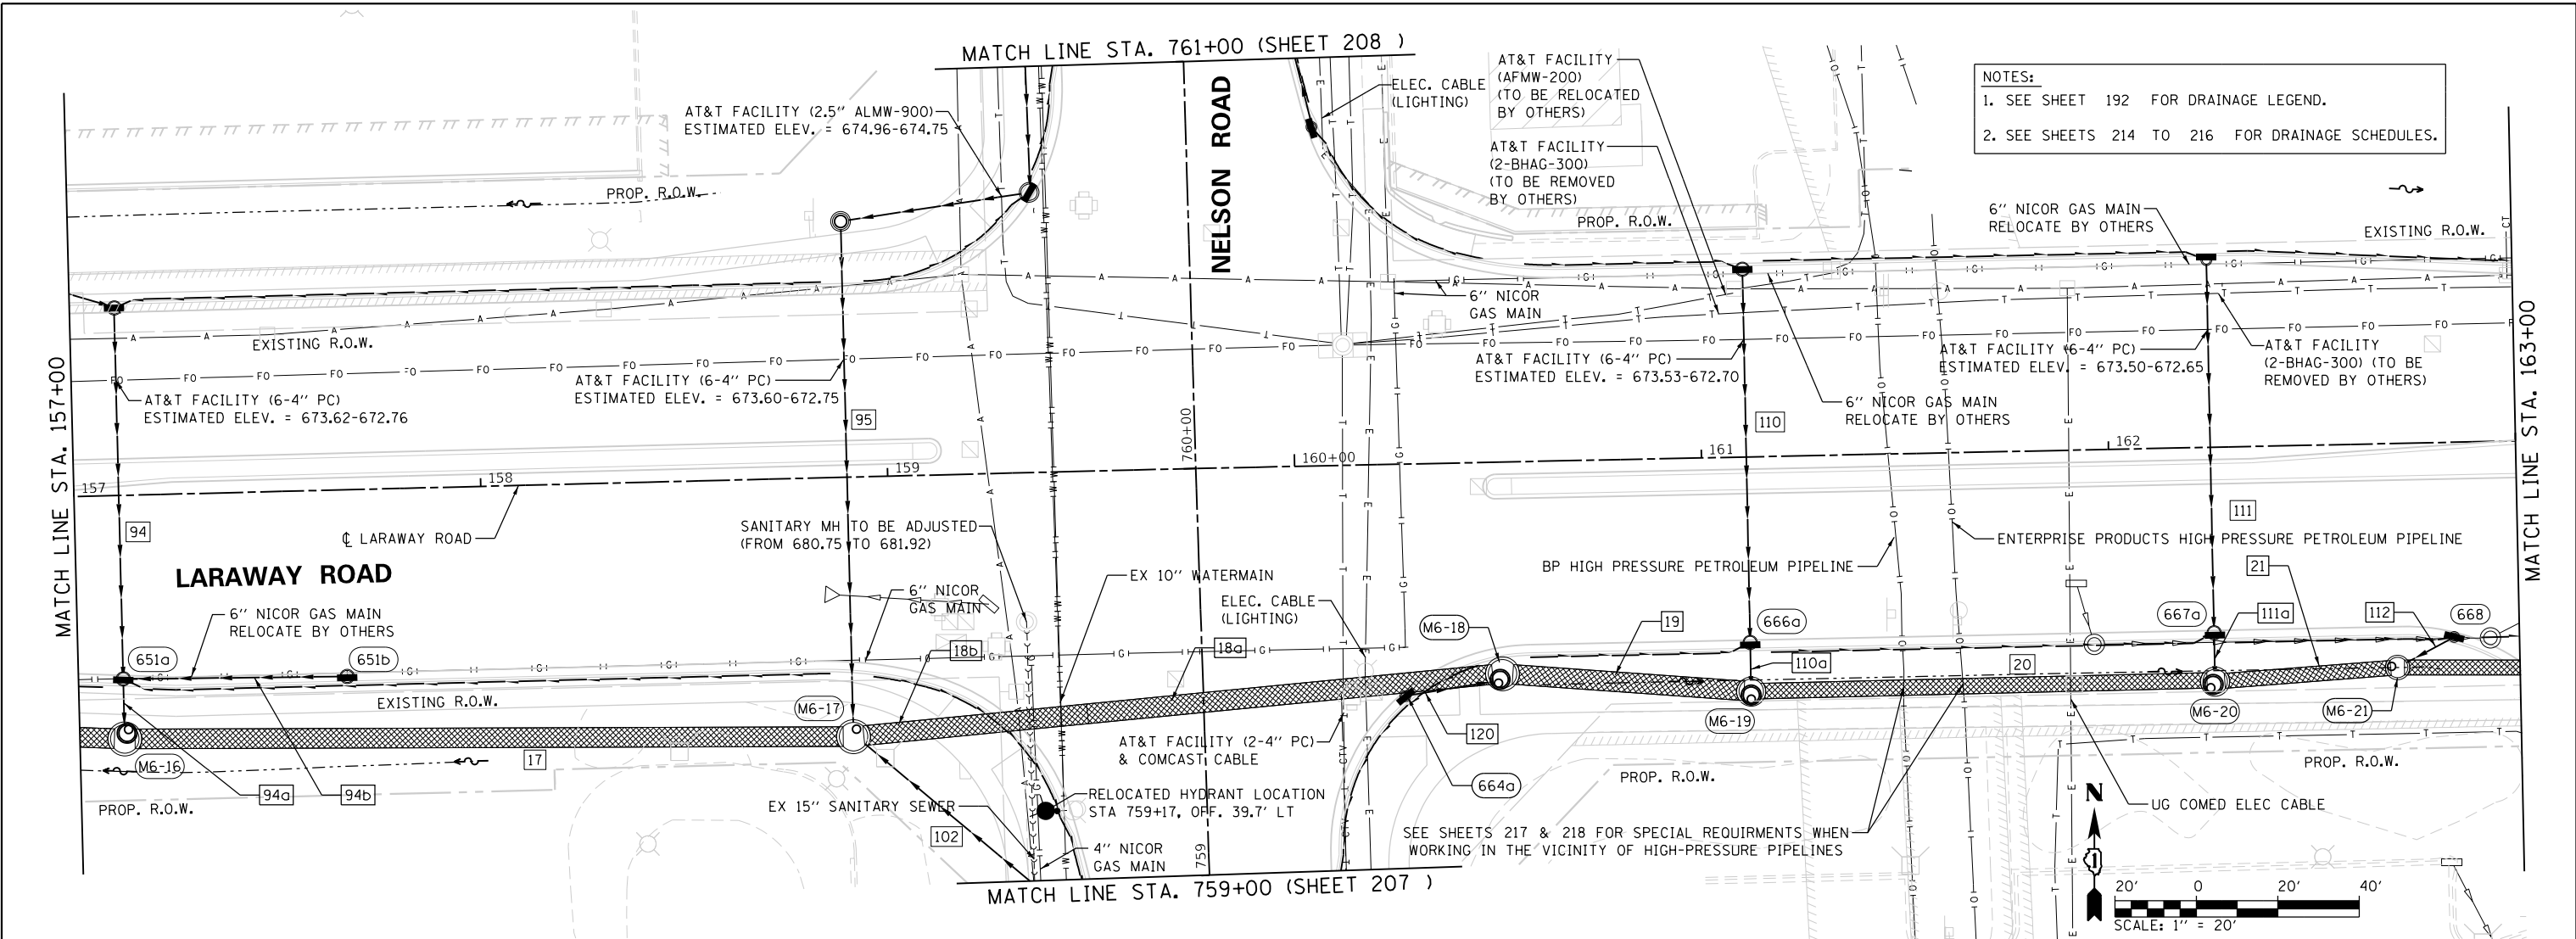

681.96	681.76	682.12	682.01	682.25	682.26	682.28	682.45	682.24	682.48	682.25	682.36	682.14	682.17	681.75	681.99	681.64	681.80	681.39	681.61	681.23	681.42	681.08	681.24	680.95	681.05
157+00		157+50		158+00		158+50		159+00		159+50		160+00		160+50		161+00		161+50		162+00		162+50		163+00	



FILE NAME = sht-drainage-05.dgn
MODEL NAME = Default
PLOT SCALE = 40.000000 / in. in.
PLOT DATE = 9/9/2022 (12:12:15 PM) PM

DESIGNED - ECW
DRAWN - ECW
CHECKED -
DATE - 09/09/2022

REVISED -
REVISED -
REVISED -
REVISED -

STATE OF ILLINOIS
DEPARTMENT OF TRANSPORTATION

DRAINAGE PLAN AND PROFILE
LARAWAY RD
SCALE: 1"=20'
SHEET 5 OF 14 SHEETS
STA. 157+00 TO STA. 163+00


F.A.U. RTE.	SECTION	COUNTY	TOTAL SHEETS	SHEET NO.
0320	13-00138-37-PV	WILL	413	196
CONTRACT NO. 61H20				
ILLINOIS FED. AID PROJECT				

PLAN	SURVEYED	DATE
	PLOTTED	
	ALIGNED	
	CHECKED	
	CADD FILE NAME	
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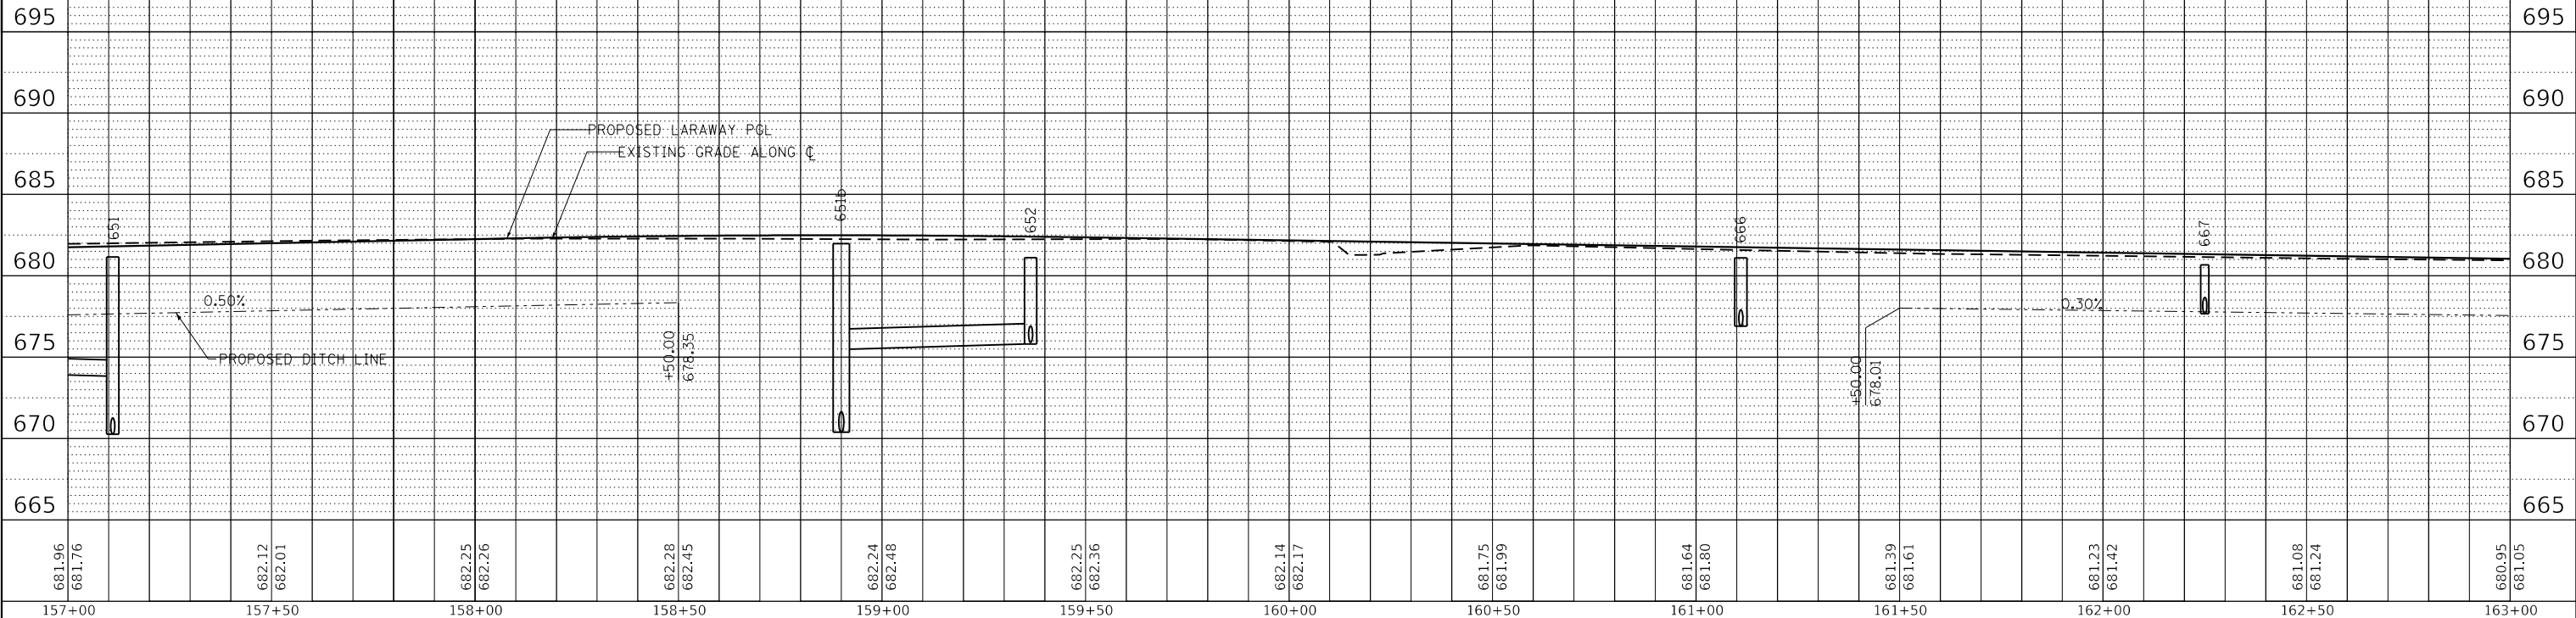
PLOT SCALE =
PLOT DATE =

PROFILE	SURVEYED	DATE
	PLOTTED	
	GRADES CHECKED	
	STRUCTURE NOTATIONS CHECKED	
	NO.	

PROJECT NO. = 13-00138-37-PV
DRAWN BY = Mike Moss

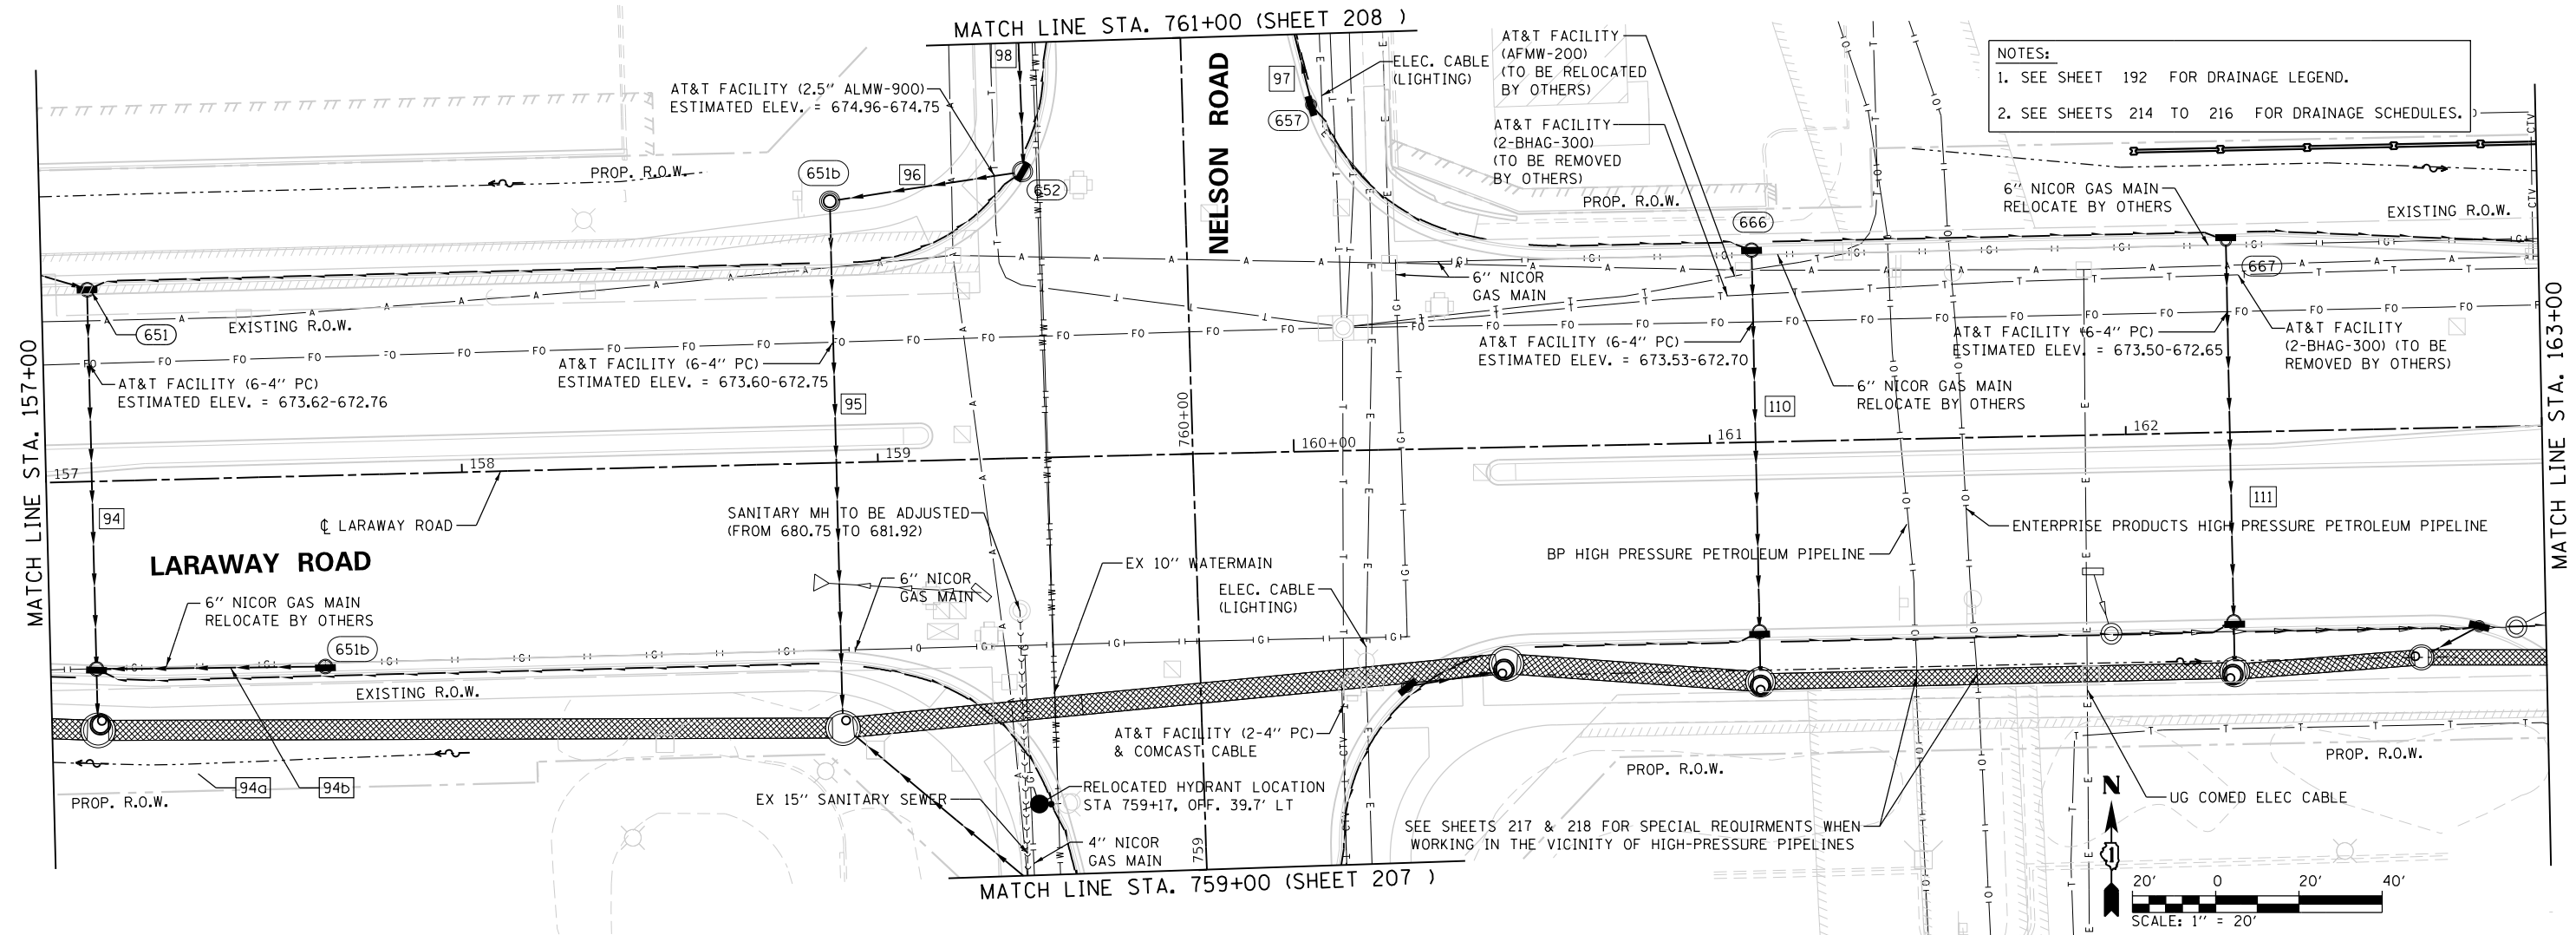

LEFT DITCH (NORTH) PROFILE



FILE NAME = sht-drainage-06.dgn
MODEL NAME = Default
PLOT SCALE = 40,000.00 / in.
PLOT DATE = 9/9/2022 12:12:13 PM

DESIGNED - ECW
DRAWN - ECW
CHECKED -
DATE - 09/09/2022

REVISED -
REVISED -
REVISED -
REVISED -

STATE OF ILLINOIS
DEPARTMENT OF TRANSPORTATION

DRAINAGE PLAN AND PROFILE
LARAWAY RD

SCALE: 1"=20' SHEET 6 OF 14 SHEETS STA. 157+00 TO STA. 163+00

F.A.U. RTE.	SECTION	COUNTY	TOTAL SHEETS	SHEET NO.
0320	13-00138-37-PV	WILL	413	197
CONTRACT NO. 61H20			ILLINOIS FED. AID PROJECT	


PLAN	SURVEYED	DATE
	PLOTTED	
	ALIGNED	
	CHECKED	
	FILED	
	FILE NAME	
	NO.	

PROFILE	SURVEYED	DATE
	PLOTTED	
	GRADES	
	CHECKED	
	STRUCTURE	
	NOTATION	
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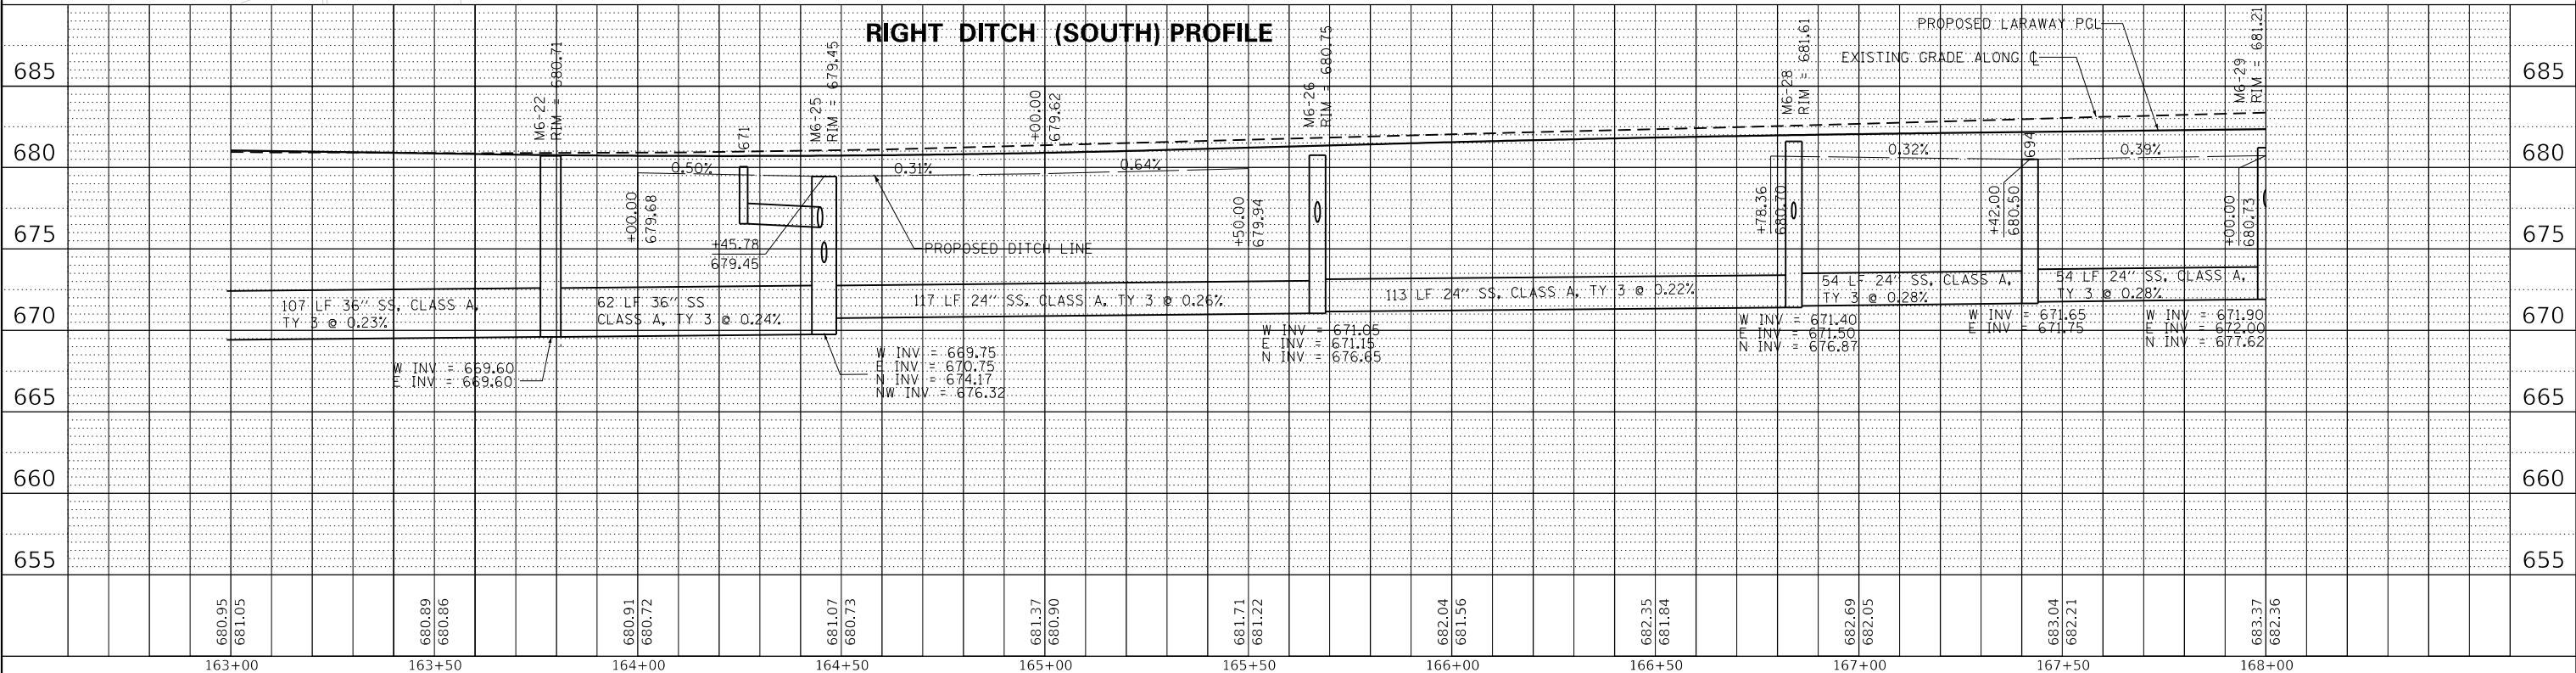
PLAN	SURVEYED	DATE
	PLOTTED	
	ALIGNED	
	CHECKED	
	FILED	
	FILE NAME	
	NO.	

PROFILE	SURVEYED	DATE
	PLOTTED	
	GRADES	
	CHECKED	
	STRUCTURE	
	NOTATION	
	NO.	

PLOT DRIVER = pdfplotlayerbwhidg
PEN TABLE = Laraway_drainage.tbl
PLOT SCALE =
PLOT DATE =
USER NAME =
DIRECTORY =
Rike Moss

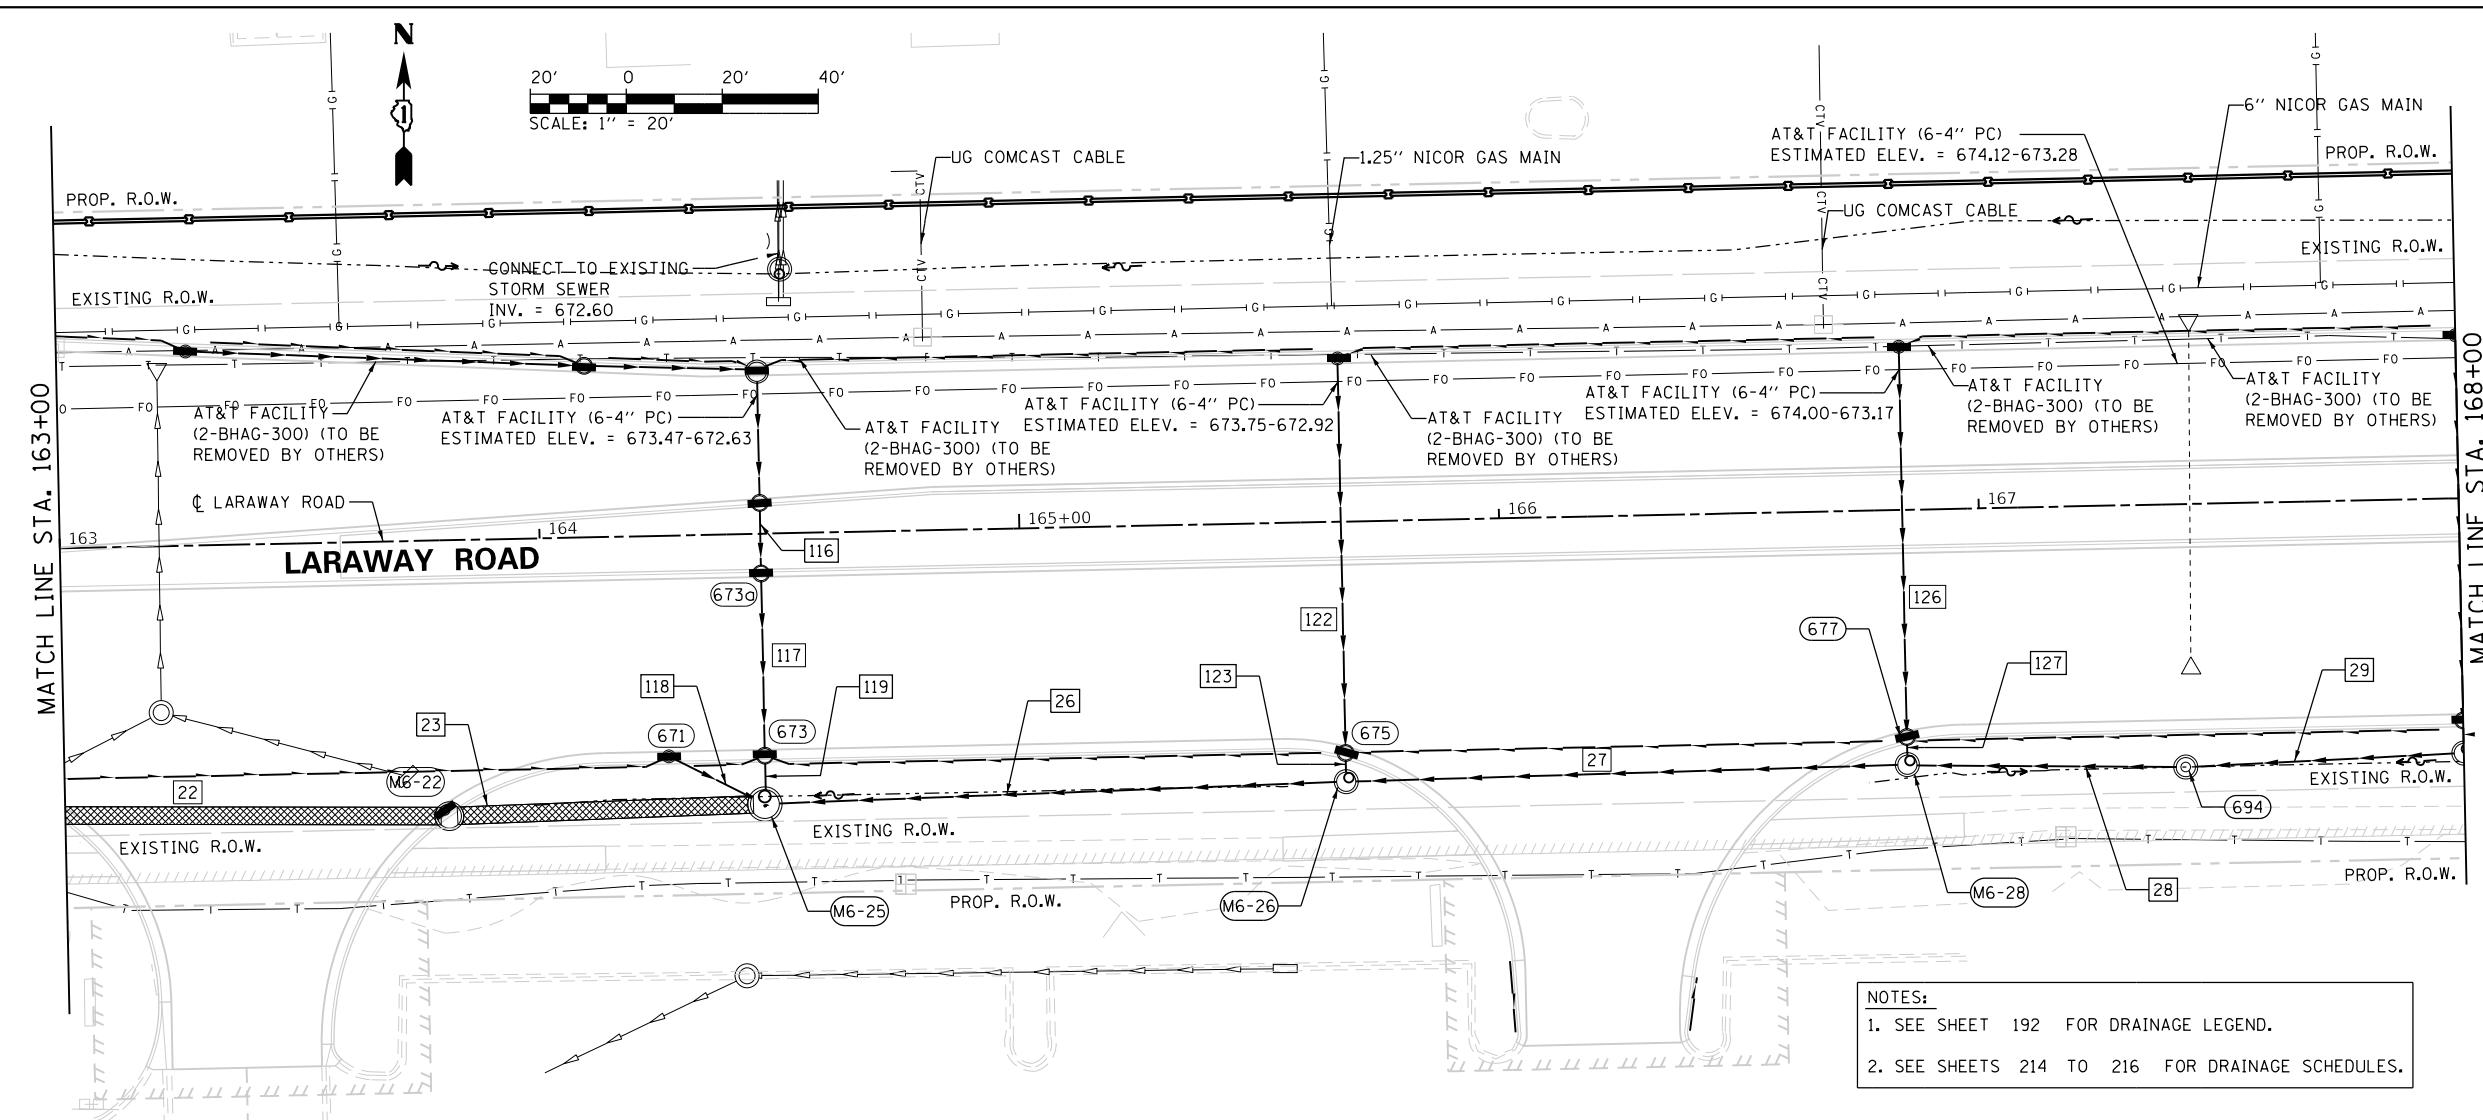

NOTES:
1. SEE SHEET 192 FOR DRAINAGE LEGEND.
2. SEE SHEETS 214 TO 216 FOR DRAINAGE SCHEDULES.



CMT <small>License No. 184-000813</small>	FILE NAME = sht-drainage-07.dgn	DESIGNED - ECW	REVISED -	STATE OF ILLINOIS DEPARTMENT OF TRANSPORTATION	DRAINAGE PLAN AND PROFILE LARAWAY RD		F.A.U. RTE. = 0320	SECTION = 13-00138-37-PV	COUNTY = WILL	TOTAL SHEETS = 413	SHEET NO. = 198
	MODEL NAME = Default	DRAWN - ECW	REVISED -		SCALE: 1"=20'		SHEET 7 OF 14 SHEETS	STA. 163+00 TO STA. 168+00	CONTRACT NO. 61H20		
PLOT SCALE = 40.00000 / in.	CHECKED -	REVISED -			ILLINOIS FED. AID PROJECT						
PLOT DATE = 9/9/2022 (12:19:23 PM)	DATE = 09/09/2022	REVISED -									


PLAN	SURVEYED	DATE
	PLOTTED	
	ALIGNED	
	CHECKED	
	FILE NAME	
	NO.	

PROFILE	SURVEYED	DATE
	PLOTTED	
	GRADES CHECKED	
	STRUCTURE NOTATION CHECKED	
	NO.	


PLOT DRIVER = pdfnolayerbwtdlg
PEN TABLE = Laraway_draingab.tbl

PLOT SCALE =
PLOT DATE =

USER NAME =
DIRECTORY =
File Name =

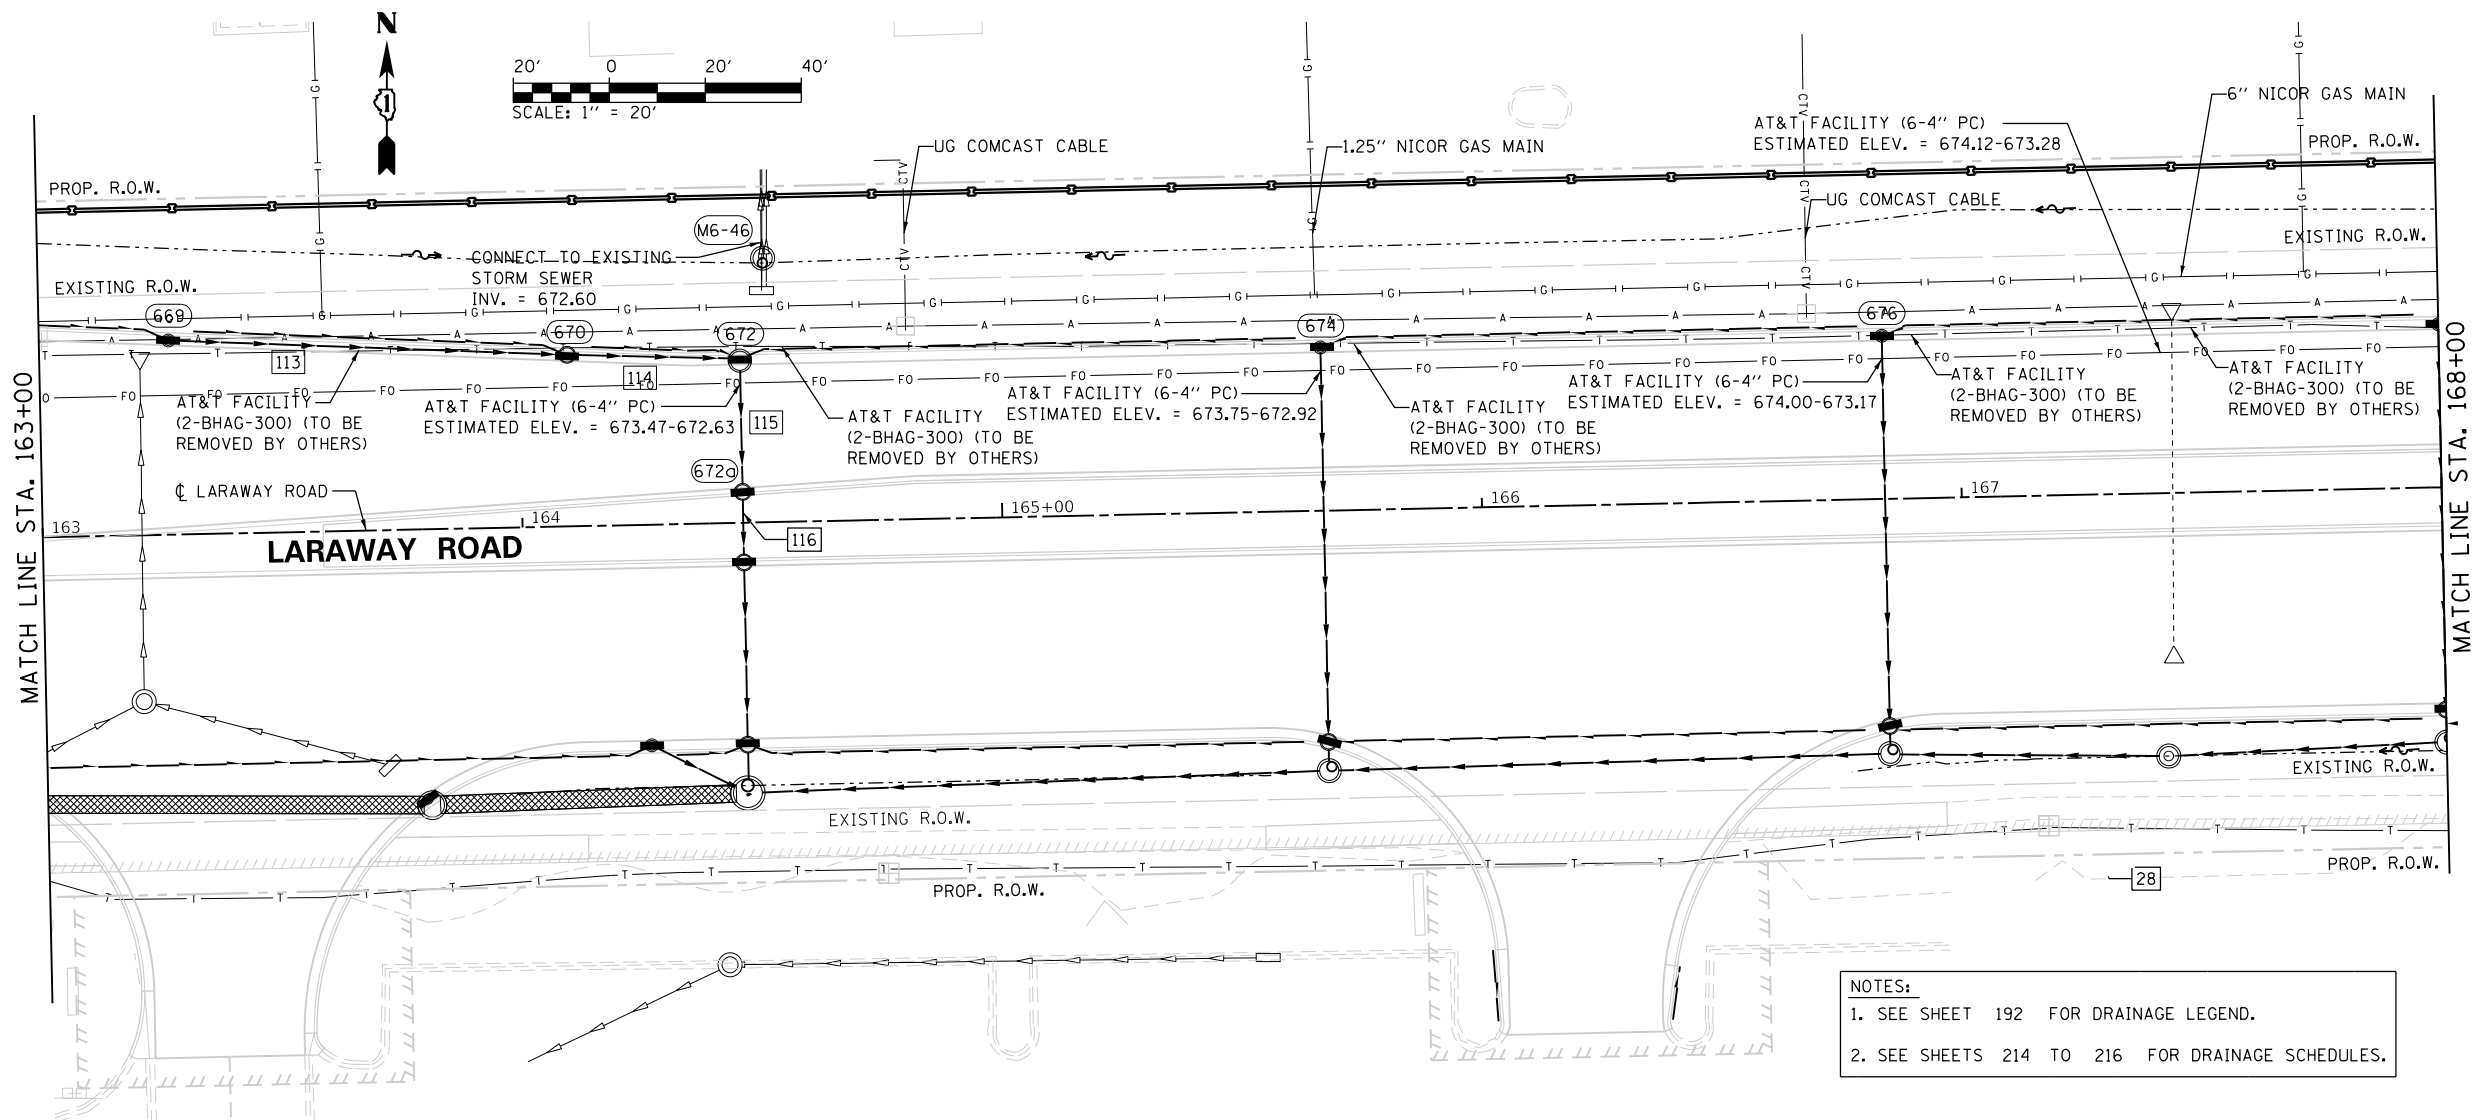

NOTES:
1. SEE SHEET 192 FOR DRAINAGE LEGEND.
2. SEE SHEETS 214 TO 216 FOR DRAINAGE SCHEDULES.

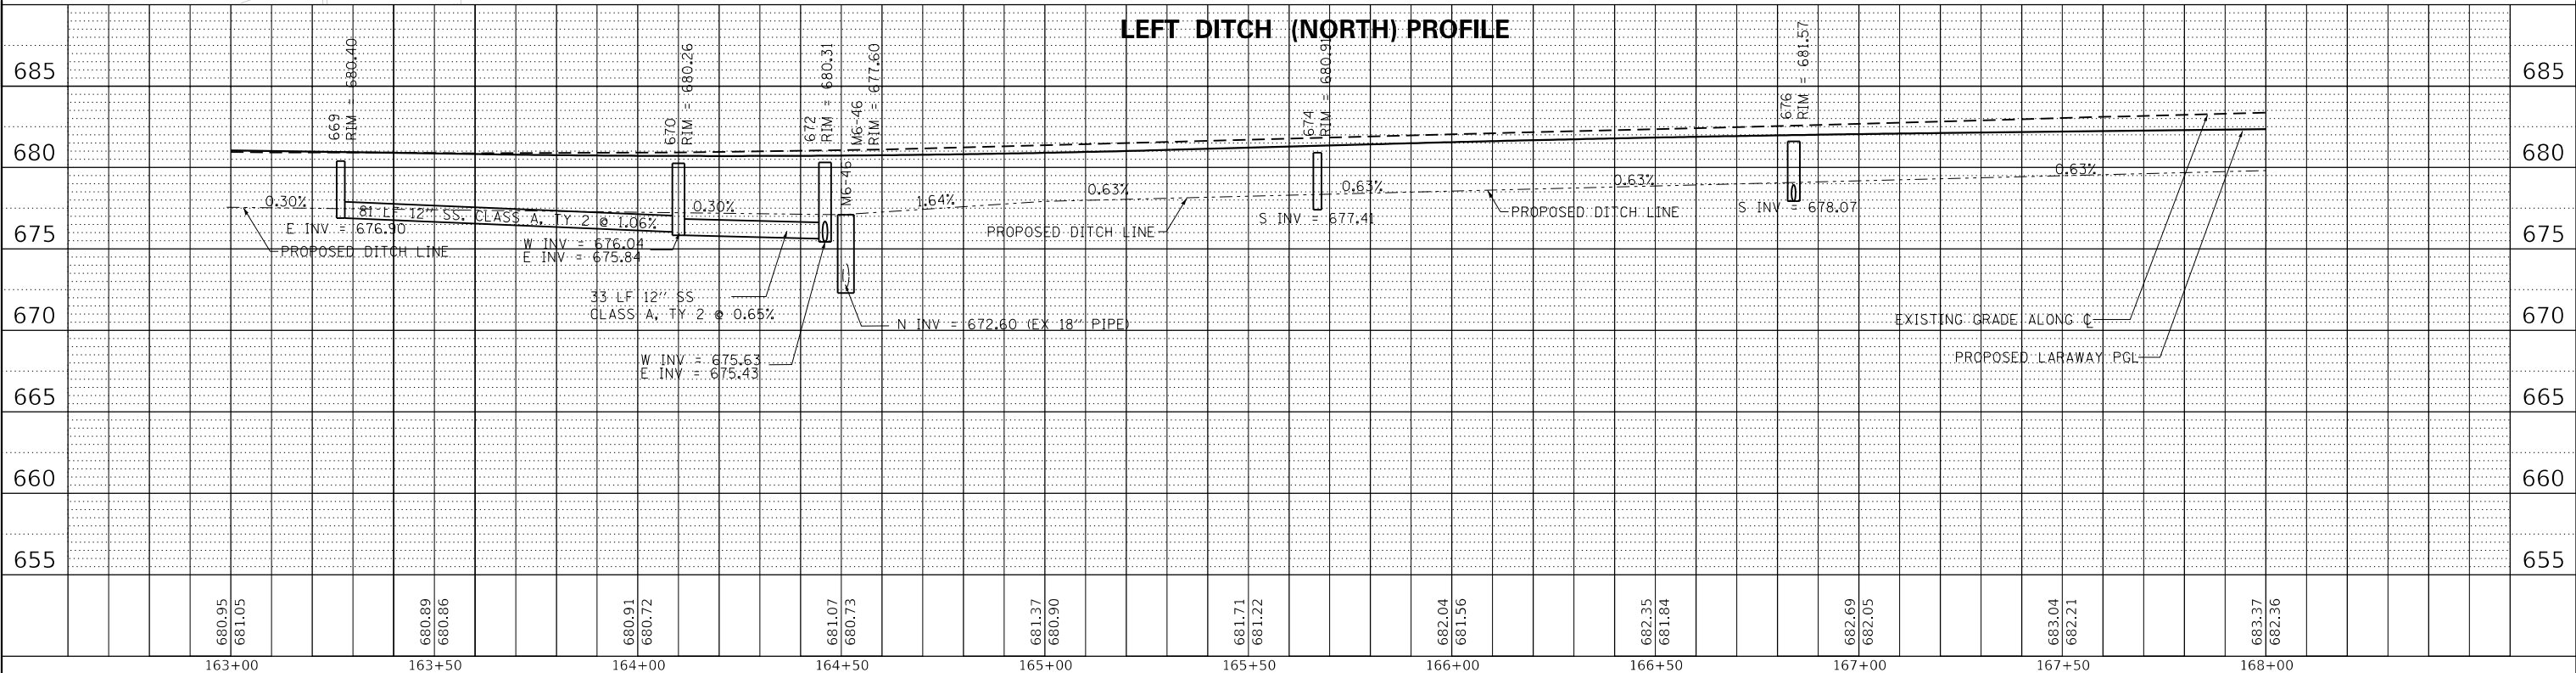

680.95	681.05	680.89	680.86	680.91	680.72	681.07	680.73	681.37	680.90	681.71	681.22	682.04	681.56	682.35	681.84	682.69	682.05	683.04	682.21	683.37	682.36
163+00	163+50	164+00	164+50	165+00	165+50	166+00	166+50	167+00	167+50	168+00											



FILE NAME = sh-draingage-08.dgn
MODEL NAME = Default
PLOT SCALE = 4000000/144 in.
PLOT DATE = 09/09/2022 12:13:27 PM

DESIGNED - ECW
DRAWN - ECW
CHECKED -
DATE - 09/09/2022

REVISED -
REVISED -
REVISED -
REVISED -

STATE OF ILLINOIS
DEPARTMENT OF TRANSPORTATION

DRAINAGE PLAN AND PROFILE
LARAWAY RD
SCALE: 1"=20'
SHEET 8 OF 14 SHEETS
STA. 163+00 TO STA. 168+00



F.A.U. RTE.	SECTION	COUNTY	TOTAL SHEETS	SHEET NO.
0320	13-00138-37-PV	WILL	413	199
CONTRACT NO. 61H20				
ILLINOIS FED. AID PROJECT				

PLAN	SURVEYED	DATE
	PLOTTED	
	ALIGNED	
	CHECKED	
	CADD FILE NAME	
	NO.	


PROFILE	SURVEYED	DATE
	PLOTTED	
	GRADES	
	CHECKED	
	STRUCTURE	
	NOTATION	
	NO.	

PLOT DRIVER = pdfnolayer\$wtdlg
PEN TABLE = Laraway_Drainage.tbl

USER NAME = Mike Moses
DIRECTORY = L:\MILLCO\17204\01\Draw\CADD_Sheets

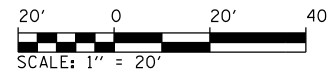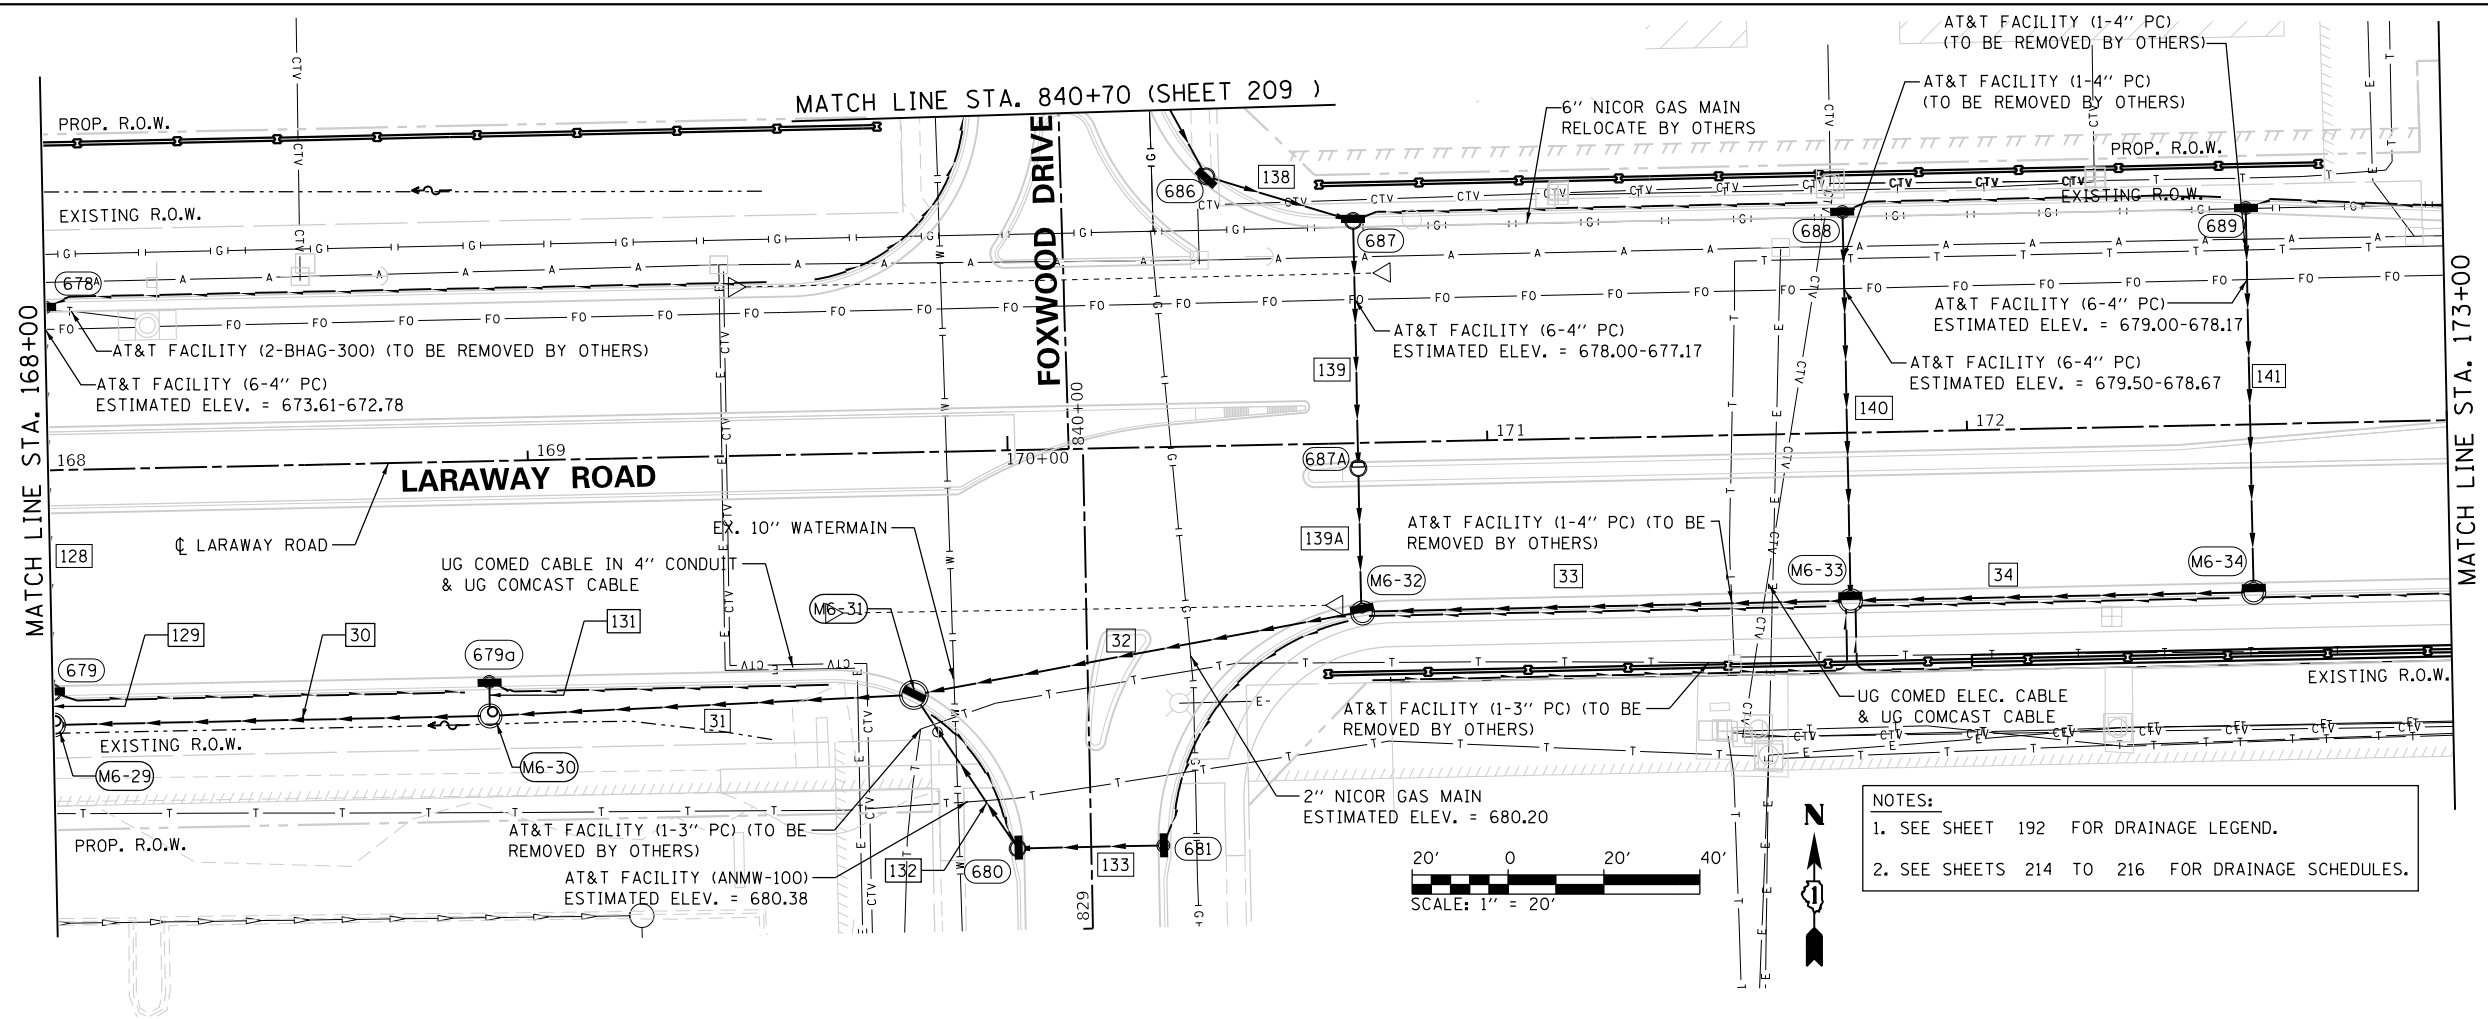

- NOTES:**
- SEE SHEET 192 FOR DRAINAGE LEGEND.
 - SEE SHEETS 214 TO 216 FOR DRAINAGE SCHEDULES.

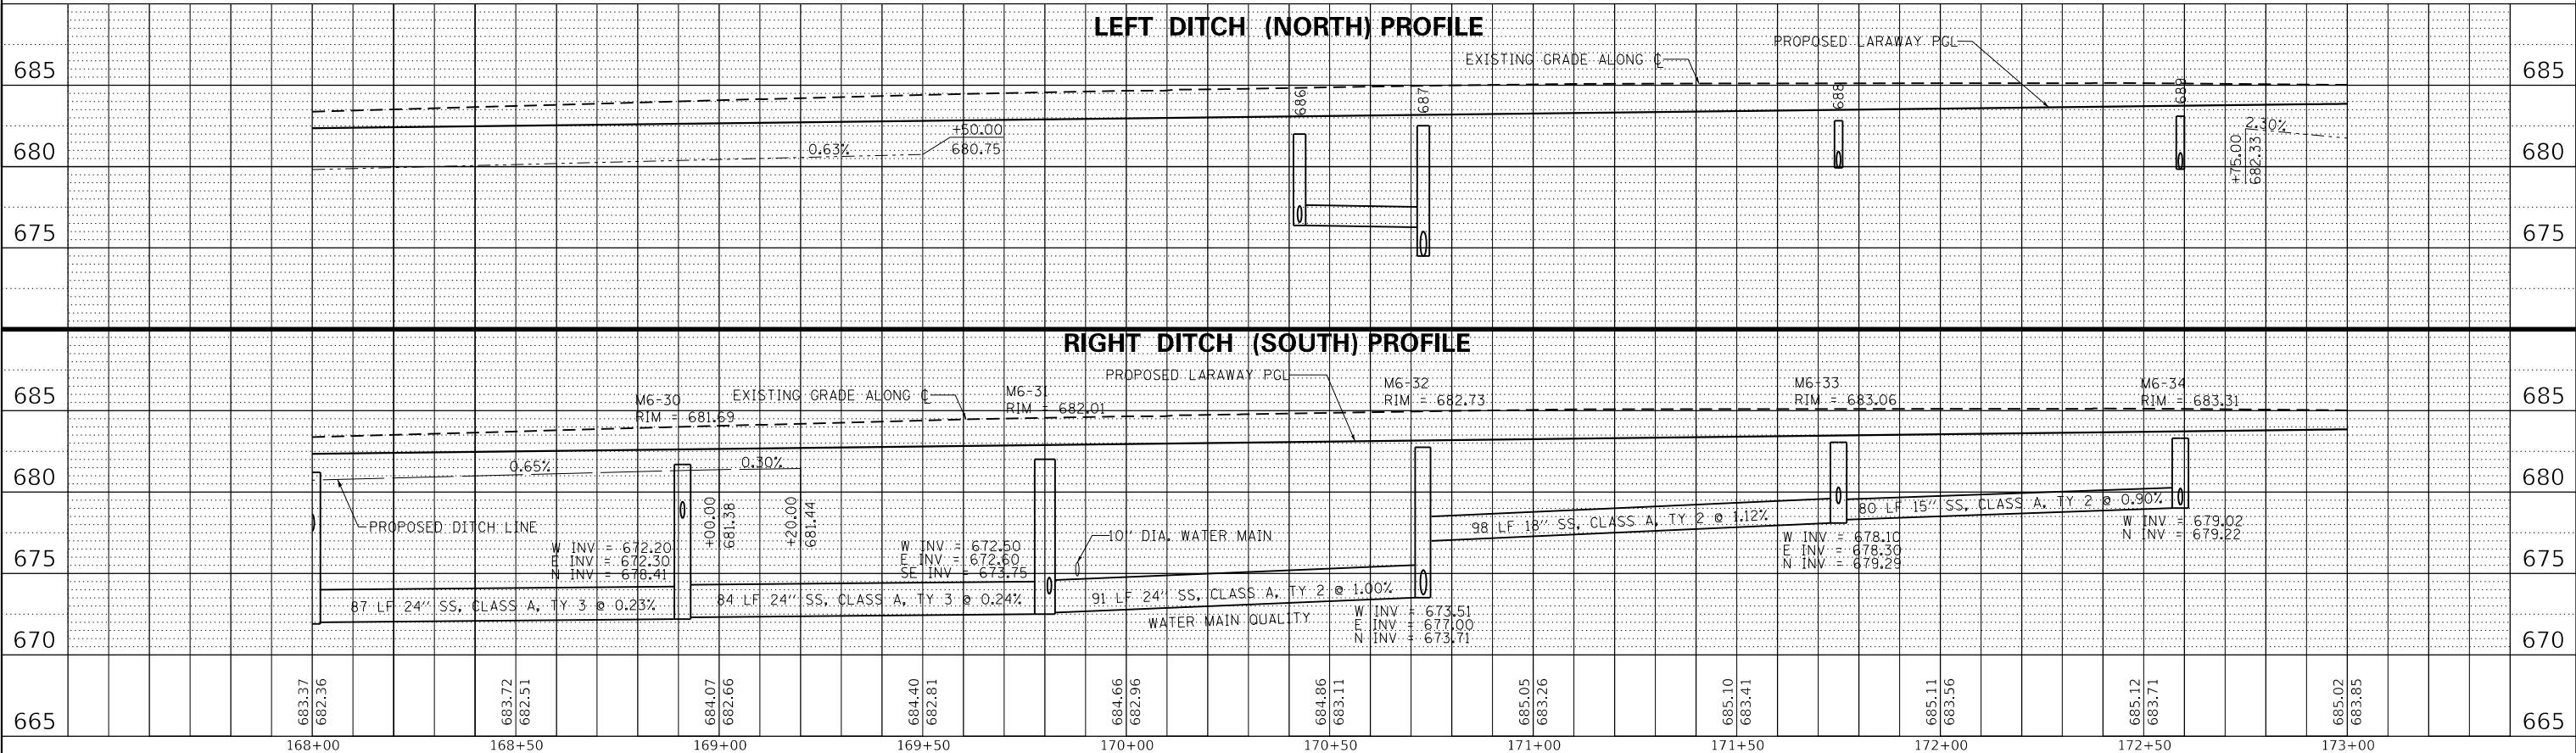

665	683.37	682.36	683.72	682.51	684.07	682.66	684.40	682.81	684.66	682.96	684.86	683.11	685.05	683.26	685.10	683.41	685.11	683.56	685.12	683.71	685.02	683.85	665
	168+00		168+50		169+00		169+50		170+00		170+50		171+00		171+50		172+00		172+50		173+00		



FILE NAME = shd-drahdage-08.dgn	DESIGNED - ECW	REVISED -
MODEL NAME = Default	DRAWN - ECW	REVISED -
PLOT SCALE = 40.0000' / in.	CHECKED -	REVISED -
PLOT DATE = 9/9/2022 - 12:19:30 PM	DATE - 09/09/2022	REVISED -

STATE OF ILLINOIS
DEPARTMENT OF TRANSPORTATION

DRAINAGE PLAN AND PROFILE
LARAWAY ROAD

SCALE: 1" = 20' SHEET 9 OF 14 SHEETS STA. 168+00 TO STA. 173+00

F.A.U. RTE. 0320	SECTION 13-00138-37-PV	COUNTY WILL	TOTAL SHEETS 413	SHEET NO. 200
CONTRACT NO. 61H20				
ILLINOIS FED. AID PROJECT				