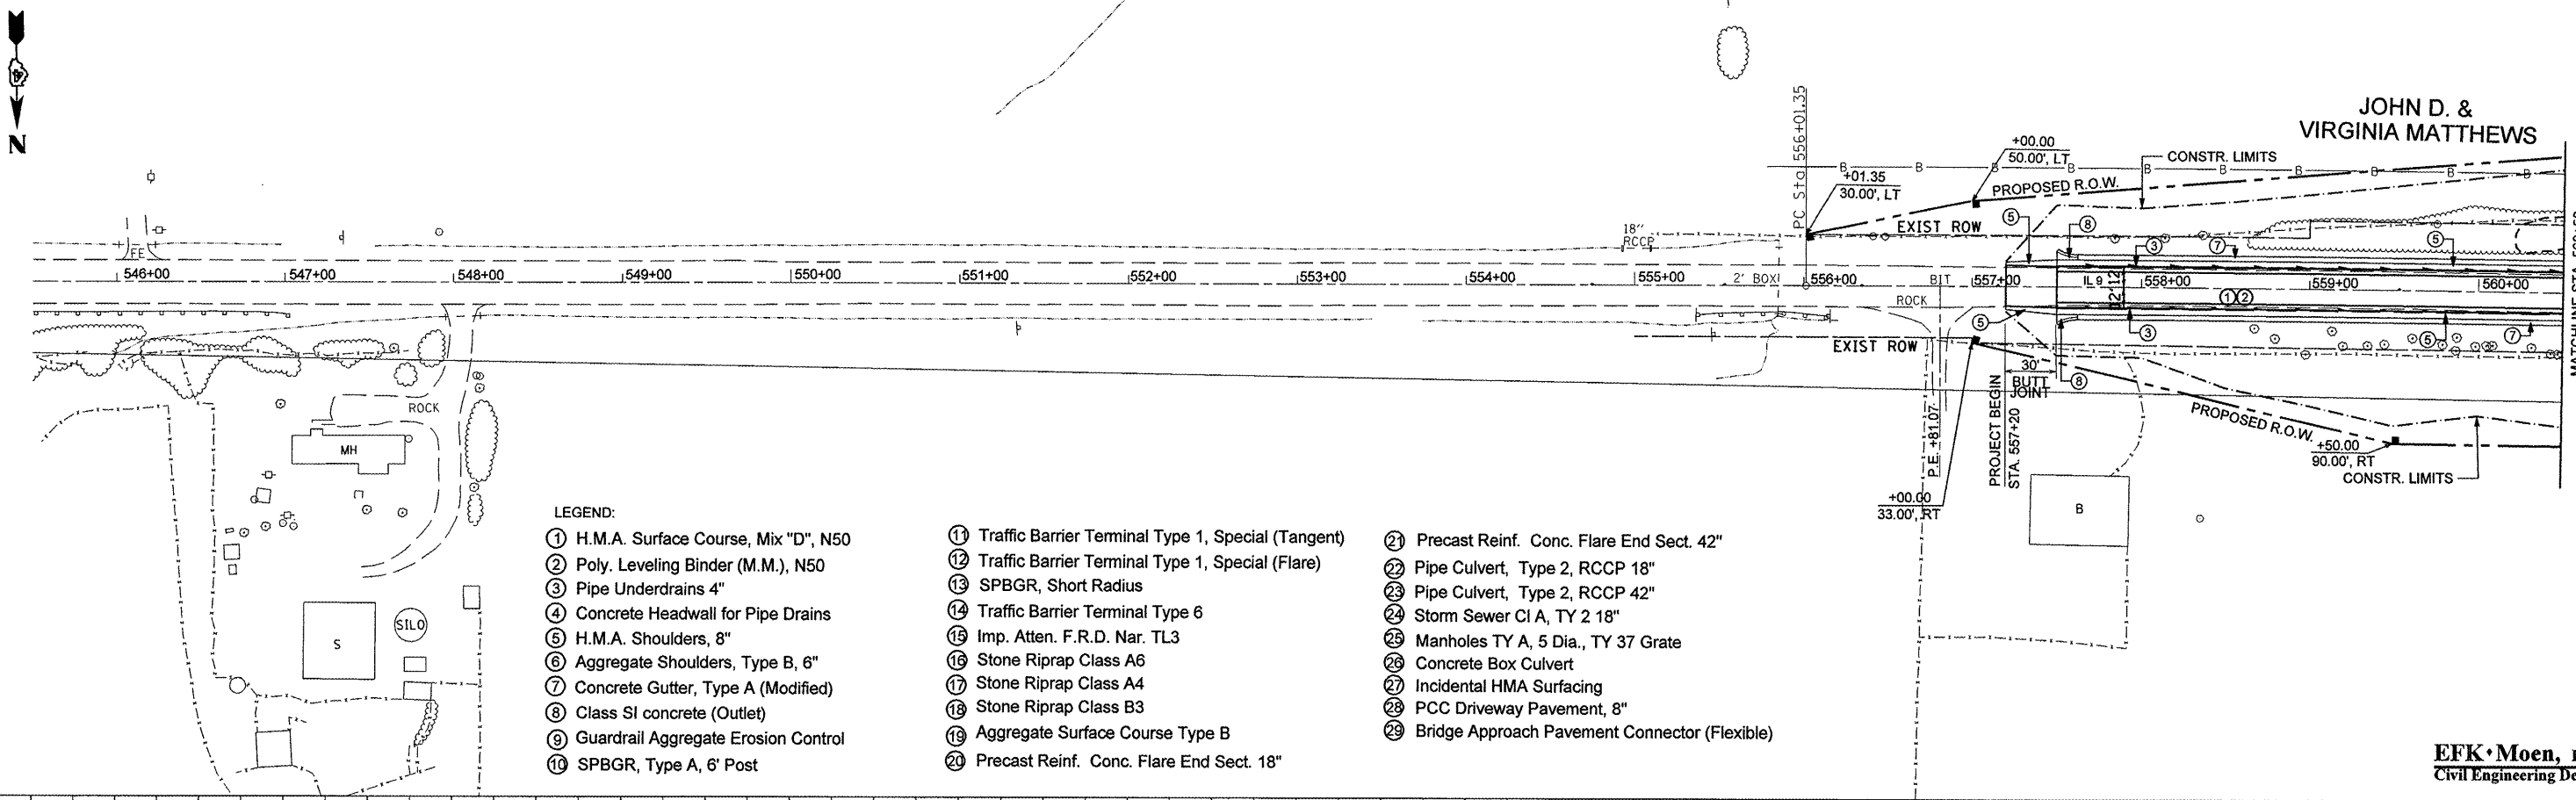


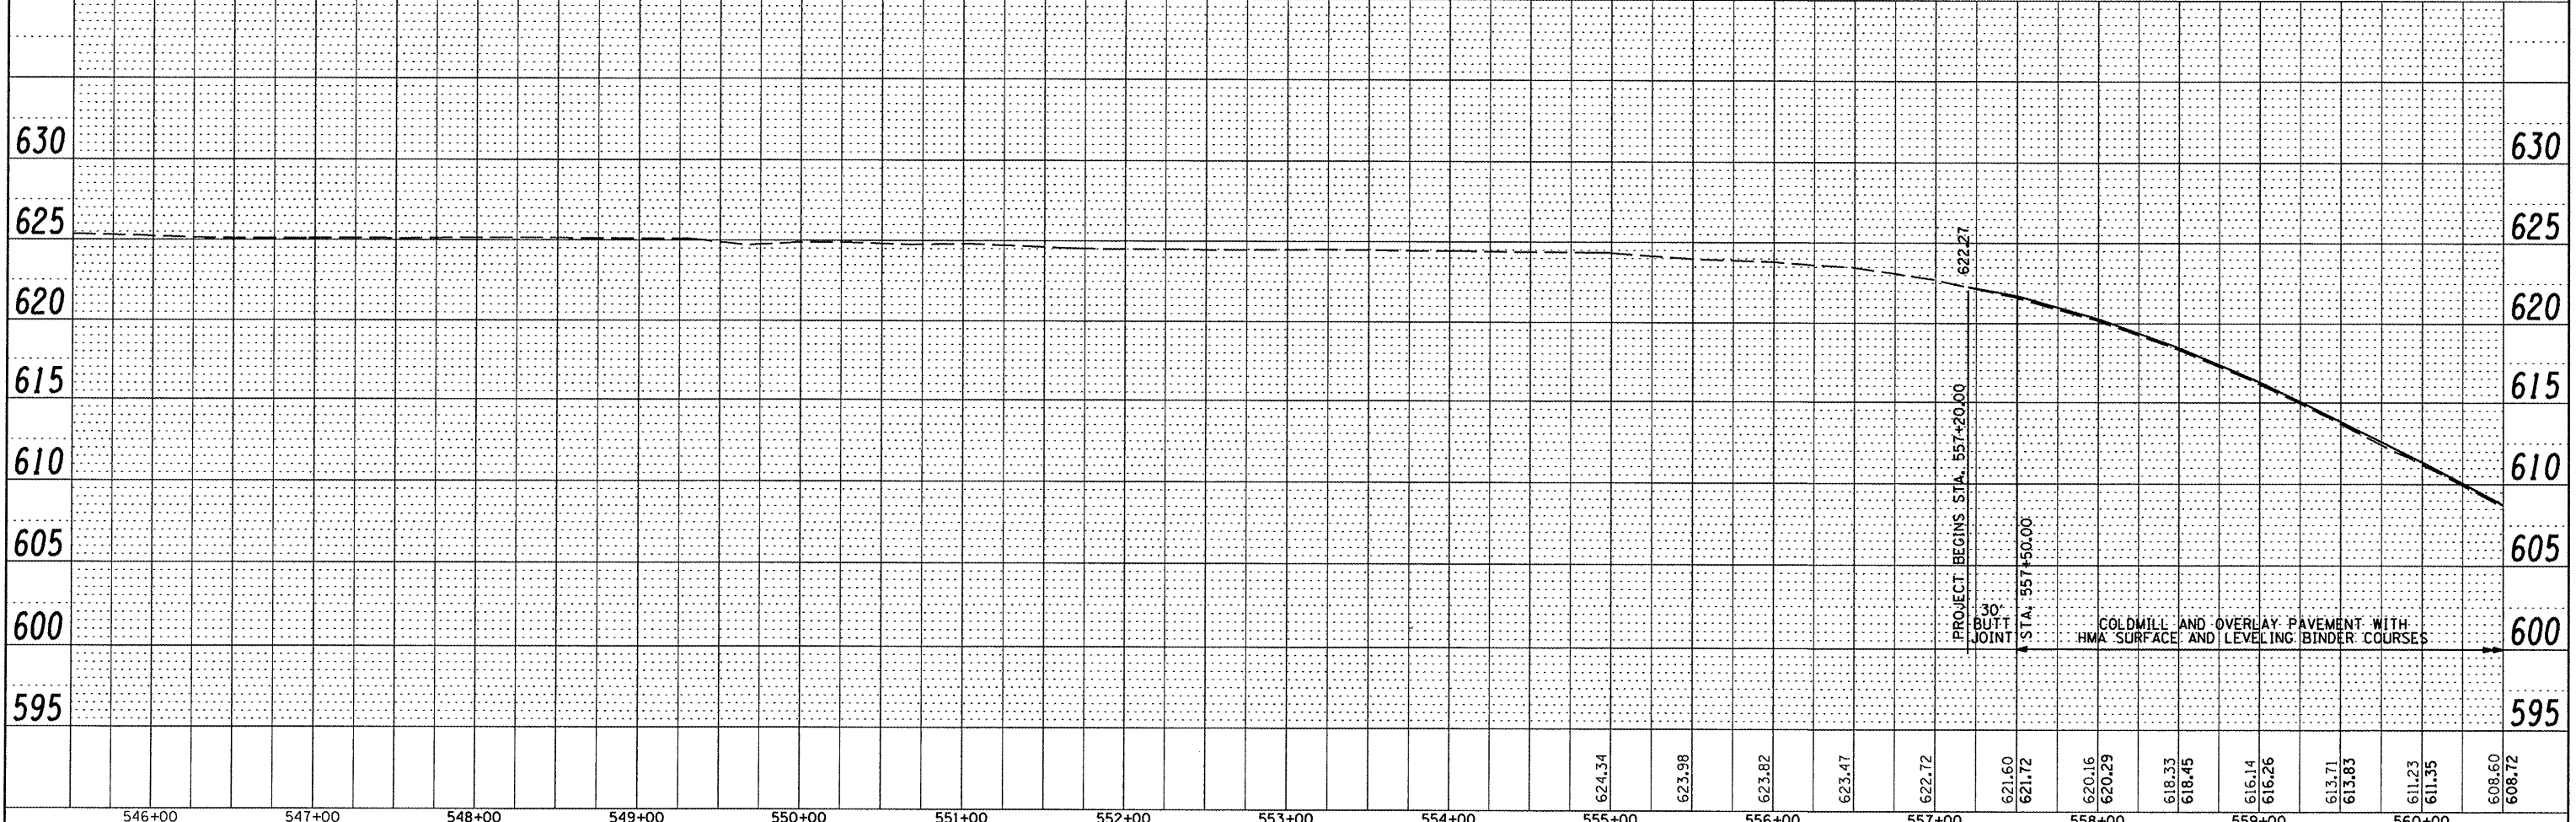
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- LEGEND:**
- ① H.M.A. Surface Course, Mix "D", N50
 - ② Poly. Leveling Binder (M.M.), N50
 - ③ Pipe Underdrains 4"
 - ④ Concrete Headwall for Pipe Drains
 - ⑤ H.M.A. Shoulders, 8"
 - ⑥ Aggregate Shoulders, Type B, 6"
 - ⑦ Concrete Gutter, Type A (Modified)
 - ⑧ Class SI concrete (Outlet)
 - ⑨ Guardrail Aggregate Erosion Control
 - ⑩ SPBGR, Type A, 6' Post
 - ⑪ Traffic Barrier Terminal Type 1, Special (Tangent)
 - ⑫ Traffic Barrier Terminal Type 1, Special (Flare)
 - ⑬ SPBGR, Short Radius
 - ⑭ Traffic Barrier Terminal Type 6
 - ⑮ Imp. Atten. F.R.D. Nar. TL3
 - ⑯ Stone Riprap Class A6
 - ⑰ Stone Riprap Class A4
 - ⑱ Stone Riprap Class B3
 - ⑲ Aggregate Surface Course Type B
 - ⑳ Precast Reinf. Conc. Flare End Sect. 18"
 - ㉑ Precast Reinf. Conc. Flare End Sect. 42"
 - ㉒ Pipe Culvert, Type 2, RCCP 18"
 - ㉓ Pipe Culvert, Type 2, RCCP 42"
 - ㉔ Storm Sewer CI A, TY 2 18"
 - ㉕ Manholes TY A, 5 Dia., TY 37 Grate
 - ㉖ Concrete Box Culvert
 - ㉗ Incidental HMA Surfacing
 - ㉘ PCC Driveway Pavement, 8"
 - ㉙ Bridge Approach Pavement Connector (Flexible)

EFK Moen, LLC
Civil Engineering Design



FILE NAME =	USER NAME = jd	DESIGNED -	REVISED -	STATE OF ILLINOIS DEPARTMENT OF TRANSPORTATION	DESIGN PLAN AND PROFILE	F.A.P. R.T.E. =	SECTION =	COUNTY =	TOTAL SHEETS =	SHEET NO. =
Z:\08096.Shaw.Creek\dgn\Design\Final\Plotsheets\15-D468352-sht-plnprfl.dgn	DRAWN - JD	CHECKED - SD	REVISED -			685	37BR-1	MC DONOUGH/EDLTON	138	15
PLOT SCALE = 100.0000 / IN.	CHECKED - SD	DATE - 10/15/09	REVISED -			CONTRACT NO. 68352				
PLOT DATE = 10/16/2009	DATE - 10/15/09	REVISED -	SCALE: 1" = 50'			SHEET NO. 1 OF 3 SHEETS		STA. 545+50.00 TO STA. 560+50.00		FED. ROAD DIST. NO. [ILLINOIS] FED. AID PROJECT