FOR INDEX OF SHEETS, SEE SHEET NO. 2

01-15-2016 LETTING ITEM 003

STATE OF ILLINOIS

DEPARTMENT OF TRANSPORTATION

DIVISION OF HIGHWAYS

PLANS FOR PROPOSED FEDERAL AID HIGHWAY

FAU ROUTE 1343 (STATE STREET)
WATER STREET TO RIVER STREET
BRIDGE REHABILITATION
SECTION NO.: 13-00043-00-BR
PROJECT NO.: TE-00DI(927)
VILLAGE OF SOUTH ELGIN
KANE COUNTY
C-91-286-13

GROSS & NET LENGTH = 757 FT. = 0.14 MILE

TRAFFIC DATA


STATE STREET

ADT (2015) = 2050

SPEED LIMIT = 30 MPH

ADT (2032) = 2616

MINOR ARTERIAL

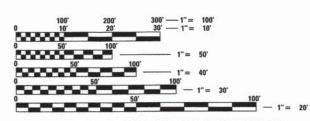


FULL SIZE PLANS HAVE BEEN PREPARED USING STANDARD ENGINEERING SCALES. REDUCED SIZED PLANS WILL NOT CONFORM TO STANDARD SCALES. IN MAKING MEASUREMENTS ON REDUCED PLANS, THE ABOVE SCALES MAY BE USED.


J.U.L.I.E.
JOINT UTILITY LOCATION INFORMATION FOR EXCAVATION
1-800-892-0123
OR 811


PLANS PREPARED BY:


Michael Baker

INTERNATIONAL CONTRACT NO. 61C17

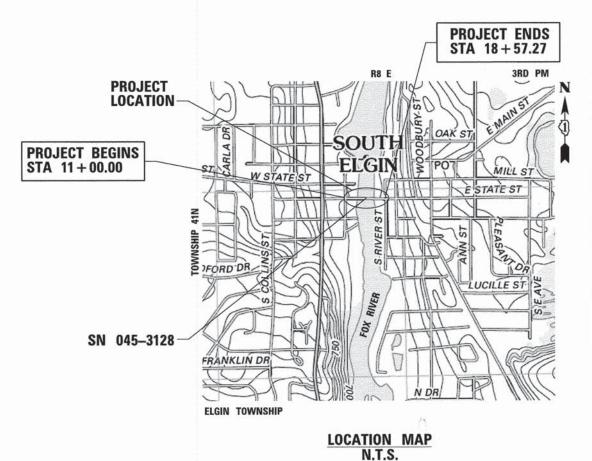

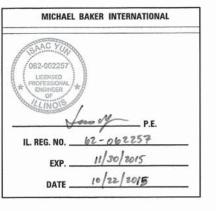

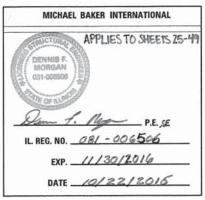

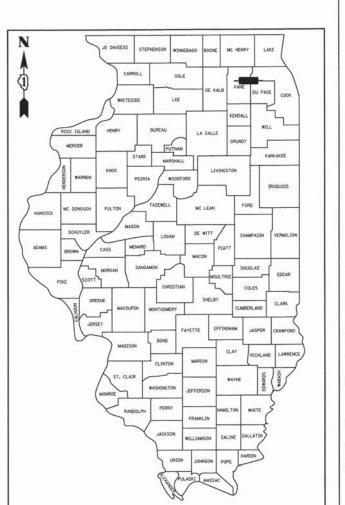


13-00043-00-BR

1343

KANE

FED. ROAD DIST. NO. 1 ILLINOIS CONTRACT NO. 61C17

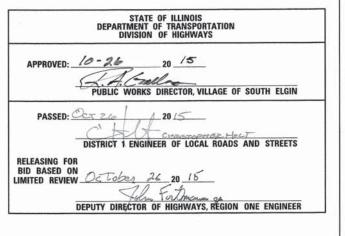

LOCATION OF SECTION INDICATED THUS: - -

PRINTED BY THE AUTHORITY OF THE STATE OF ILLINOIS

PROGRAM ENGINEER: FAWAD AQUEEL, PE, PTOE 847-705-4021 SCHAUMBUF

0

0

INDEX OF SHEETS

1	COVER SHEET
2	GENERAL NOTES
3-4	SUMMARY OF QUANTITIES
5-6	TYPICAL SECTIONS
7	SCHEDULE OF QUANTITIES
8-9	ALIGNMENT, TIES AND BENCHMARKS
10	BORING LOGS
11	EXISTING CONDITION & REMOVAL PL
12	PROPOSED PLAN
13-14	MAINTENENCE OF TRAFFIC
15	EROSION CONTROL
16	SIGNING AND PAVEMENT MARKINGS
17	ROADWAY GRADING DETAIL
18	CONSTRUCTION DETAILS
19-24	LIGHTING PLANS
25-49	STRUCTURAL PLANS
50-53	DISTRICT 1 DETAILS
54-65	CRITICAL CROSS SECTIONS

IDOT HIGHWAY STANDARDS

000001-06	STANDARD SYMBOLS, ABBREVIATIONS AND PATTERNS
001001-02	AREAS OF REINFORCEMENT BARS
001006	DECIMAL OF AN INCH AND OF A FOOT
280001-07	TEMPORARY EROSION CONTROL SYSTEMS
424026-01	ENTRANCE/ALLEY PEDESTRAIN CROSSING
701006-05	OFF-RD OPERATIONS, 2L, 2W, 15' TO 24" FROM PAVEMENT EDGE
701301-04	LANE CLOSURE, 2L, 2W, SHORT TIME OPERATIONS
701311-03	LANE CLOSURE 2L, 2W MOVING OPERATIONS - DAY ONLY
701501-06	URBAN LANE CLOSURE, 2L, 2W, UNDIVIDED
701801-05	SIDEWALK, CORNER OR CROSSWALK CLOSURE
701901-04	TRAFFIC CONTROL DEVICES
704001-07	TEMPORARY CONSTRUCTION BARRIER
720001-01	SIGN PANEL MOUNTING DETAILS
720006-04	SIGN PANEL ERECTION DETAILS
729001-01	APPLICATIONS OF TYPE A&B METALPOSTS (FOR SIGNS & MARKERS)
780001-05	TYPICAL PAVEMENT MARKINGS
812001	RACEWAY EMBEDDED IN STRUCTURE (SHT 2 OF 3)
814001-03	HANDHOLES (CONCRETE COMPOSITE)
825011-03	LIGHTING CONTROLLER PEDESTAL MOUNTED, 240V
836001-02	LIGHT POLE FOUNDATION

POINTS OF CONTACT

AT&T CORP. MR. HECTOR GARCIA 1000 COMMERCE DRIVE OAK BROOK, IL 60523 847-888-6799 (OFFICE) 630-639-8372 (DIRECT) HG2929@ATT.COM

COMMONWEALTH EDISON COMPANY MRS. DARLENE CRAMMER 860 OAK CREEK DRIVE LOMBARD, IL 60148 630-396-8220 EXT. 4524

COMCAST CABLE
MR. THOMAS MUNAR
688 INDUSTRIAL DRIVE
ELMHURST, IL 60126
630-600-6316
THOMAS.MUNAR@CABLE.COMCAST.COM

NICOR GAS CONSTANCE LANE 1844 FERRY ROAD NAPERVILLE, IL 60563 630-388-3830 CLANE@AGIRESOURCES.COM

VILLAGE OF SOUTH ELGIN DAN MANN 10 N. WATER STREET SOUTH ELGIN, IL 60177 847-695-2742 DMANN@SOUTHELGIN.COM

VILLAGE OF SOUTH ELGIN PUBLIC WORKS RICHARD GALLAS 735 MARTIN DRIVE SOUTH ELGIN, IL 60177 847-695-2742 RGALLAS@SOUTHELGIN.COM

GENERAL NOTES

- 1. ALL CONSTRUCTION SHALL BE DONE IN ACCORDANCE WITH THE DETAILS IN THE PLANS, THE SPECIAL PROVISIONS INCLUDED IN THE CONTRACT DOCUMENTS, AND THE LATEST EDITION OF THE FOLLOWING STATE OF ILLINOIS SPECIFICATIONS: "THE STANDARD SPECIFICATIONS FOR ROAD AND BRIDGE CONSTRUCTION" (REFERED TO AS THE "STANDARD SPECIFICATIONS"), THE "SUPPLEMENTAL SPECIFICATIONS AND RECURRING SPECIAL PROVISIONS", "THE STANDARD SPECIFICATIONS FOR TRAFFIC CONTROL ITEMS", THE "MANUAL ON UNIFORM TRAFFIC CONTROL DEVICES FOR STREETS AND HIGHWAYS", THE "MANUAL OF TEST PROCEDURES FOR MATERIALS", AND THE "STANDARD SPECIFICATION FOR WATER AND SEWER MAIN CONSTRUCTION IN ILLINOIS". ANY REFERENCE TO "STANDARDS" THROUGHOUT THE PLANS OR SPECIAL PROVISIONS SHALL BE INTERPRETED AS THE LATEST I.D.O.T. STANDARD.
- 2. THE CONTRACTOR SHALL NOT BEGIN THE WORK TO BE PERFORMED UNDER THE CONTRACT WITHOUT WRITTEN AUTHORIZATION FROM THE ENGINEER TO PROCEED WITH THE WORK AND SHALL COMMENCE WORK NOT LATER THAN TEN (10) DAYS AFTER RECEIVING THE AUTHORIZATION TO PROCEED.
- 3. ALL ELEVATIONS ARE BASED ON NGV 29 DATUM.
- 4. DIMENSIONS: IT SHALL BE THE CONTRACTOR'S RESPONSIBILITY TO VERIFY ALL DIMENSIONS AND CONDITIONS EXISTING IN THE FIELD PRIOR TO ORDERING MATERIAL AND BEGINNING THE CONSTRUCTION.
- 5. NO WORK SHALL COMMENCE UNTIL TRAFFIC CONTROL REQUIREMENTS ARE MET TO THE
- UNLESS AUTHORIZED BY THE ENGINEER, ALL EXISTING ACCESS POINTS SHALL BE MAINTAINED AT ALL TIMES BY THE CONTRACTOR.
- 7. THE CONTRACTOR SHALL OBTAIN, ERECT, MAINTAIN AND REMOVE ALL SIGNS, BARRICADES, FLAGGERS AND OTHER TRAFFIC CONTROL DEVICES AS MAY BE NECESSARY FOR THE PURPOSE OF REGULATING, WARNING, OR GUIDING TRAFFIC. PLACEMENT AND MAINTENANCE OF ALL TRAFFIC CONTROL DEVICES SHALL BE IN ACCORDANCE WITH THE APPLICABLE PARTS OF ARTICLE 107.14 OF THE STANDARD SPECIFICATIONS AND THE ILLINOIS MANUAL ON UNIFORM TRAFFIC CONTROL DEVICES FOR STREETS AND HIGHWAYS.
- B. DURING CONSTRUCTION, THE CONTRACTOR WILL BE REQUIRED, AT THE CONTRACTOR'S EXPENSE, TO HAVE A WATER TRUCK OR SIMILAR EQUIPMENT AVAILABLE TO CONTROL DUST. IF NECESSARY, THE CONTRACTOR SHALL BE REQUIRED TO CONTROL DUST DURING NON-WORKING HOURS. THIS WORK WILL BE IN ACCORDANCE WITH ARTICLE 107.36 OF THE STANDARD SPECIFCATIONS.
- 9. THE UNIT PRICE FOR ALL REMOVAL PAY ITEMS SHALL INCLUDE ALL REQUIRED SAW CUTS.
- 10. ALL EXCESS MATERIAL (BROKEN CONCRETE, CULVERT PIPE, WASTE ROADWAY EXCAVATION, SURPLUS MATERIAL FROM SEWER TRENCHES) SHALL BE LEGALLY DISPOSED OF OUTSIDE THE LIMITS OF THE RIGHT OF WAY. IT SHALL BE THE CONTRACTOR'S RESPONSIBILITY TO SELECT DUMP SITES AND OBTAIN PERMISSION AND ALL NECESSARY PERMITS TO USE SUCH DUMP SITES. PAYMENT FOR THE WORK SHALL BE INCLUDED IN THE CONTRACT UNIT PRICE FOR EARTH EXCAVATION AND WILL NOT BE PAID FOR SEPARATELY.
- 11. TOPSOIL SHALL NOT BE STOCKPILED WITHIN THE LIMITS OF CONSTRUCTION. THE LOCATIONS OF TOPSOIL STOCKPILES WITHIN THE RIGHT OF WAY MUST BE APPROVED BY THE FACTORER.
- 12. TEMPORARY TOILET THE CONTRACTOR SHALL PROVIDE A TEMPORARY TOILET FACILITY FOR THE USE OF ALL CONTRACTORS' PERSONNEL EMPLOYED ON THE WORK, AND SHALL MAINTAIN SAME IN PROPER SANITARY CONDITIONS. THIS FACILITY MAY NOT BE LOCATED NEAR THE FOX RIVER. AT COMPLETION, THE FACILITY SHALL BE REMOVED AND THE PREMISES LEFT CLEAN. THE ENGINEER SHALL APPROVE THE LOCATION OF THE TEMPORARY TOILET. THE COST OF THIS WORK SHALL BE INCLUDED IN THE COST OF ITEM 67000400 ENGINEER'S FIELD OFFICE, TYPE A.
- 13. CONCRETE WASHOUT FACILITY SHOULD BE PROVIDED IN THE FIELD BY THE CONTRACTOR. THE COST OF THIS FACILITY SHALL BE INCLUDED IN THE UNIT PRICE FOR ITEM 50300225 CONCRETE STRUCTURES. ALL PROVISIONS WILL NOT BE PAID FOR SEPARATELY, BUT SHALL BE INCLUDED IN THE UNIT PRICE FOR ITEM 50300225 CONCRETE STRUCTURES.
- 14. THE CONTRACTOR WILL BE REQUIRED TO PROVIDE AN ACCESSIBLE ALTERNATIVE TEMPORARY PATH OPEN AT ALL TIMES WITH THE USE OF IDOT STANDARD ROAD PLAN 701801-05.
- 15. ALL SIDEWALK REMOVAL AND REPLACEMENT SHALL BE DONE IN FULL SECTIONS TO MATCH PROPOSED SIDEWALK TO EXISTING. THE COST OF THE TRANSITION SHALL BE INCLUDED IN THE COST OF THE SIDEWALK PAY ITEMS AND NO ADDITIONAL COMPENSATION WILL BE ALLOWED.
- 16. DURING CONSTRUCTION OPERATIONS, WHEN ANY LOOSE MATERIAL IS DEPOSITED IN THE FLOW LINE OF DRAINAGE STRUCTURES SUCH THAT THE NATURAL FLOW OF WATER IS OBSTRUCTED, IT SHALL BE REMOVED AT THE CLOSE OF EACH WORKING DAY. AT THE CONCLUSION OF CONSTRUCTION OPERATIONS, ALL DRAINAGE STRUCTURES SHALL BE FREE FROM DIRT AND DEBRIS. THE WORK SPECIFIED ABOVE WILL NOT BE PAID FOR SEPARATELY, BUT SHALL BE CONSIDERED AS INCLUDED IN THE UNIT PRICE FOR ITEM 28000500 INLET AND PIPE PROTECTION AND NO ADDITIONAL COMPENSATION WILL BE ALLOWED.

- 17. THE CONTRACTOR SHALL MAINTAIN CONVEYANCE OF ALL FLOWS DURING CONSTRUCTION OF THIS PROJECT. WHEN EXISTING DRAINAGE FACILITIES ARE DISTURBED. THE CONTRACTOR SHALL PROVIDE AND MAINTAIN TEMPORARY OUTLET AND CONNECTIONS FOR ALL PRIVATE AND PUBLIC DRAINS, SEWERS, CULVERTS, AND OTHER DRAINAGE FACILITIES. THE CONTRACTOR SHALL PROVIDE FACILITIES TO TAKE IN ALL STORM WATER WHICH WILL BE RECEIVED BY THESE DRAINS AND SEWERS, AND DISCHARGE THE SAME. THE CONTRACTOR SHALL PROVIDE AND MAINTAIN A TEMPORARY OUTLET AND BE PREPARED AT ALL TIMES TO DISPOSE OF WATER RECEIVED FROM THESE TEMPORARY CONNECTIONS UNTIL SUCH TIME THAT THE PERMANENT DRAINAGE FACILITIES ARE IN SERVICE. THIS WORK WILL NOT BE PAID FOR SEPARATELY BUT INCLUDED IN THE UNIT PRICE FOR ITEM 28000500 INLET AND PIPE PROTECTION.
- 18. WHEN DIRECTED BY THE ENGINEER, SUPPLEMENTAL WATERING SHALL BE APPLIED TO ALL SEEDED AREAS PRIOR TO THE FINAL ACCEPTANCE AT A RATE SPECIFIED BY THE ENGINEER AND IN ACCORDANCE WITH THE "STANDARD SPECIFICATIONS" AND SPECIAL PROVISIONS.
- 19. THE CONTRACTOR SHALL ADHERE TO LIMITS OF RESTORATION SHOWN, AREAS OUTSIDE THESE LIMITS THAT ARE DAMAGED OR DISTURBED BY THE CONTRACTOR SHALL BE RESTORED BY THE CONTRACTOR AT THEIR EXPENSE, AND NO ADDITIONAL COMPENSATION WILL BE ALLOWED.
- 20. THE CONTRACTOR SHALL PROVIDE AS-BUILT DATA TO DOCUMENT THE FLOOD PLAIN FILL. THE CONTRACTOR SHALL COORDINATE WITH THE RESIDENT ENGINEER TO COLLECT DATA AND DOCUMENT WITH PLANS AND CROSS-SECTIONS THE RELATED FLOODPLAIN IMPACTS (FILL) TO THE VILLAGE OF SOUTH ELGIN. THE COST OF ALL MATERIALS REQUIRED AND ALL LABOR NECESSARY TO COMPLY WITH THE ABOVE PROVISIONS WILL NOT BE PAID FOR SEPARATELY, BUT SHALL BE CONSIDERED AS INCLUDED IN THE COST OF MOBILIZATION.
- 21. ALL TREES ARE DESIGNATED TO BE SAVED UNLESS OTHERWISE NOTED ON THE PLANS, AND SHALL BE PROTECTED IN ACCORDANCE WITH THE PROVISIONS OF ARTICLE 201 OF THE STANDARD SPECIFICATIONS
- 22. TEMPORARY FENCE SHALL BE PLACED AROUND ALL TREES THAT ARE TO BE PROTECTED UNLESS OTHERWISE DIRECTED BY THE ENGINEER. SEE SPECIAL PROVISION PERIMETER EROSION BARRIER FOR MORE DETAIL.
- 23. ALL WORK PERFORMED RELATIVE TO THIS IMPROVEMENT SHALL COMPLY WITH ALL APPLICABLE RULES AND REGULATIONS OF O.S.H.A.
- 24. BEFORE STARTING ANY EXCAVATION, THE CONTRACTOR SHALL CALL J.U.L.I.E. AT 800-892-0123 FOR FIELD LOCATIONS OF ALL UTILITIES. (48 HOUR NOTIFICATION IS BEOLURED).
- 25. THE CONTRACTOR SHALL COORDINATE CONSTRUCTION ACTIVITIES WITH UTILITY COMAPNIES AND THE VILLAGE OF SOUTH ELGIN (72 HOUR NOTIFICATION IS REQUIRED).
- 26. EXISTING PUBLIC AND PRIVATE UTILITIES ARE SHOWN ON THE PLANS ACCORDING TO INFORMATION OBTAINED FROM UTILITY COMPANIES, MUNICIPALITIES, AND SURVEYS. IN ACCORDANCE WITH ARTICLES 105.07 AND 107.31 OF STANDARD SPECIFICATIONS, THE CONTRACTOR SHALL BE FAMILIARIZED WITH THE LOCATION OF ALL UTILITIES AND STRUCTURES THAT MAY BE FOUND IN THE VICINITY OF THE CONSTRUCTION. THE CONTRACTOR WILL ALSO ASSUME RESPONSIBILITY FOR ALL UTILITIES WHETHER SHOWN OR NOT, AND MUST REALIZE THAT THE ACTUAL LOCATIONS AND/OR ELEVATIONS OF THE UTILITIES MAY BE DIFFERENT THAN INDICATED.
- 27. SHOULD ANY DAMAGES OCCUR DUE TO THE CONTRACTOR'S NEGLIGENCE, THE CONTRACTOR SHALL MAKE REPAIRS IN A MANNER ACCEPTABLE TO THE ENGINEER, AT THE CONTRACTOR'S EXPENSE. THE CONTRACTOR SHALL NOTIFY ALL UTILITY COMPANIES OF THEIR CONSTRUCTION SCHEDULE AND COORDINATE CONSTRUCTION OPERATIONS WITH THE UTILITY COMPANIES SO THAT RELOCATION OF UTILITY LINES AND STRUCTURES MAY PROCEED IN AN ORDERLY MANNER, IN ACCORDANCE WITH ARTICLES 105.07 AMD 107.31 OF THE STANDARD SPECIFICATIONS.
- 28. ALL UTILITIES, LOCAL POLICE, AND FIRE DEPARTMENTS SHALL BE NOTIFIED BY THE CONTRACTOR PRIOR TO THE START OF CONSTRUCTION.
- 29. WHEN WORKING IN THE VICINITY OF ELECTRIC LINES, THE CONTRACTOR SHALL MAINTAIN A MINIMUM WORKING CLEARANCE DISTANCE BETWEEN THE EQUIPMENT USED AND THE ELECTRIC TRANSMISSION (138KV AND 345 KV) AND ELECTRIC DISTRIBUTION (12KV AND 34KV) CONDUCTORS EQUAL TO THE GREATER OF TEN (10) FEET OR THE DISTANCE REQUIRED BY 0.5.H.A. REGULATIONS.
- 31. THE CONTRACTOR SHALL BE RESPONSIBLE FOR CONTACTING LOCAL AGENCIES MAINTAINING SANITARY SEWERS, WATERMAINS, AND STREET LIGHTS TO VERIFY THE MATERIALS AND METHODS ALLOWED FOR THE ADJUSTMENT, RELOCATION, OR EXTENSION OF THE UTILITY INVOLVED.

	USER NAME = Jrooke	DESIGNED JBR	REVISED -	
Michael Baker		DRAWN AJV	REVISED -	
PORTS CALL THE VIOLENCE CONT. TO SERVICE CONTROL OF THE	PLOT SCALE = 1.000 '/ in.	CHECKED ITY	REVISED -	
NTERNATIONAL	PLOT DATE = 10/19/2015	DATE 10/21/2015	REVISED -	

STATE OF ILLINOIS
DEPARTMENT OF TRANSPORTATION

SCALE: N/A

STATE STREET BRIDGE ENHANCEMENT PROJECT	F.A.U. RTE.	SECTION	COUNTY	TOTAL	SHEE NO.
GENERAL NOTES	1343	13-00043-00-BR	KANE	65	2
GENERAL NOTES	JOB NO.	C -91-286-13	CONTRA	CT NO.	61C1
SHEET NO 1 OF 1 SHEETS STA N/A TO STA N/A	FFO BOAD	DIET NO 1 THE THOTE EED	ATO BRO IECT. TE	0001/0271	

			SUMMARY OF QUANTITIES			
SI	SP	PAY ITEM CODE	DESCRIPTION	UNIT	TOTAL QUANTITY 80% FED 20% LOCAL*	CONSTRUCTION CODE
		20200100	EARTH EXCAVATION	CUYD	19	0028
		21101505	TOPSOIL EXCAVATION AND PLACEMENT	CU YD	100	0028
		21101625	TOPSOIL FURNISH AND PLACE 6"	SQ YD	600	0028
		25000210	SEEDING, CLASS 2A	ACRE	0.12	0028
		25000400	NITROGEN FERTILIZER NUTRIENT	POUND	17	0028
		25000500	PHOSPHOROUS FERTILIZER NUTRIENT	POUND	14	0028
		25000600	POTASSIUM FERTILIZER NUTRIENT	POUND	33	0028
		25100630	EROSION CONTROL BLANKET	SQYD	600	0028
		28000400	PERIMETER EROSION BARRIER	FOOT	930	0028
		28000500	INLET AND PIPE PROTECTION	EACH	3	0028
		28000510	INLET FILTERS	EACH	40	0028
		31101180	SUBBASE GRANULAR MATERIAL, TYPE B 2"	SQ YD	169	0028
		42001300	PROTECTIVE COAT	SQ YD	169	0028
		42400100	PORTLAND CEMENT CONCRETE SIDEWALK 4 INCH	SQ FT	981	0028
		42400300	PORTLAND CEMENT CONCRETE SIDEWALK 6 INCH	SQFT	538	0028
		44000600	SIDEWALK REMOVAL	SQFT	600	0028
		50102400	CONCRETE REMOVAL	CUYD	140	0028
		50300225	CONCRETE STRUCTURES	CUYD	28	0028
		50300255	CONCRETE SUPERSTRUCTURE	CUYD	338	0028
	Х	50300285	FORM LINER TEXTURED SURFACE	SQFT	1491	0028
		50300300	PROTECTIVE COAT	SQYD	660	0028
		50800205	REINFORCEMENT BARS, EPOXY COATED	POUND	97660	0028
X		50901720	BICYCLE RAILING	FOOT	970	0028
X		50901750	PARAPET RAILING	FOOT	703	0028
		52000110	PREFORMED JOINT STRIP SEAL	FOOT	45	0028

SI	SP	PAY ITEM CODE	DESCRIPTION	UNIT	TOTAL QUANTITY 80% FED 20% LOCAL*	CONSTRUCTION CODE
		67000400	ENGINEER'S FIELD OFFICE, TYPE A	CAL MO	6	0028
		67100100	MOBILIZATION	LSUM	1	0028
		70106800	CHANGEABLE MESSAGE SIGN	CALMO	6	0028
		70300220	TEMPORARY PAVEMENT MARKING - LINE 4"	FOOT	5,000	0028
		70301000	WORK ZONE PAVEMENT MARKING REMOVAL	SQFT	1,670	0028
		70400100	TEMPORARY CONCRETE BARRIER	FOOT	515	0028
		70400200	RELOCATE TEMPORARY CONCRETE BARRIER	FOOT	515	0028
		70600240	IMPACT ATTENUATORS, TEMPORARY(NON-REDIRECTIVE), TEST LEVEL 2	EACH	2	0028
		72000100	SIGN PANEL - TYPE 1	SQ FT	45	0028
		72900200	METAL POST - TYPE B	FOOT	45	0028
Х		78000200	THERMOPLASTIC PAVEMENT MARKING - LINE 4"	FOOT	400	0028
Х		78005110	EPOXY PAVEMENT MARKING - LINE 4"	FOOT	800	0028
Х	Х	80400100	ELECTRIC SERVICE INSTALLATION	EACH	1	0028
Х		80400200	ELECTRIC UTILITY SERVICE CONNECTION	LSUM	1	0028
Х		81028200	UNDERGROUND CONDUIT, GALVANIZED STEEL. 2" DIA.	FOOT	70	0028
Х	1,47	81028350	UNDERGROUND CONDUIT, PVC, 2" DIA.	FOOT	555	0028
Х		81100605	CONDUIT ATTACHED TO STRUCTURE, 2" DIA PVC COATED GALVANIZED STEEL	FOOT	470	0028
Х		81300550	JUNCTION BOX, STAINLESS STEEL, ATTACHED TO STRUCTURE, 12"X12"X6"	EACH	4	0028
Х		81300980	JUNCTION BOX, STAINLESS STEEL, EMBEDDED IN STRUCTURE, 8"X8"X6"	EACH	6	0028
Х		81400730	HANDHOLE, COMPOSITE CONCRETE	EACH	1	0028
Х		81702140	ELECTRIC CABLE IN CONDUIT, 600V (XLP-TYPE USE) 1/C NO 4	FOOT	4,925	0028
Х		82500330	LIGHTING CONTROLLER, PEDESTAL MOUNTED, 240 VOLT, 60 AMP	EACH	1	0028
Х		83600200	LIGHT POLE FOUNDATION 24" DIAMETER	FOOT	42	0028
Х		84200600	REMOVAL OF LIGHTING UNIT, NO SALVAGE	EACH	5	0028
	X	LR430050	CONCRETE PAVER SIDEWALK	SQ YD	358	0028

	USER NAME = Jrooke	DESIGNED JBR	REVISED -	
Michael Baker		DRAWN AJV	REVISED -	
	PLOT SCALE = 0.862 '/ in.	CHECKED ITY	REVISED -	\neg
INTERNATIONAL	PLOT DATE = 10/20/2015	DATE 10/21/2015	REVISED -	

	i similar	STATE STREET BRIDG	F FNHA	NCFMI	FNT PR	OJECT	F.A.U. RTE.	SECTION	COUNTY	TOTAL	SHEET NO.
			ARY OF		1343	13-00043-00-BR	KANE	65	3		
		SOMM	ANT OF	JOB N	IO. C-91-286-13	CONTRA	CT NO.	61C17			
SCALE:	N/A	SHEET NO. 1 OF 2	SHEETS	STA.	N/A	TO STA. N/	A FED. RO	AD DIST. NO. 1 ILLINOIS FED. A	ID PROJECT: TE	-0001(927)	

SI = SPECIALTY ITEMS

SP = SPECIAL PROVISION

	_		SUMMARY OF QUANTITIES		,	
SI	SP	PAY ITEM CODE	DESCRIPTION	UNIT	TOTAL QUANTITY 80% FED 20% LOCAL*	CONSTRUCTION CODE
	Х	X5150110	NAME PLATES (SPECIAL)	EACH	2	0028
	х	X7010216	TRAFFIC CONTROL AND PROTECTION (SPECIAL)	LSUM	1	0028
X	Х	X8360215	LIGHT POLE FOUNDATION, 24" DIAMETER, OFFSET	FOOT	9	0028
	Х	XX003056	RAIL REMOVAL	FOOT	703	0028
	Х	X5030290	STAINING CONCRETE STRUCTURES	SQFT	1,384	0028
	Х	XX004688	BRICK PAVER SIDEWALK	SQFT	555	0028
X	Х	XX008477	STREET LIGHT ASSEMBLY, COMPLETE	EACH	20	0028
	Х	XX009076	ARCHITECTURAL PRECAST CONCRETE PANEL	SQFT	2,780	0028
	Х	Z0004002	BOLLARDS	EACH	22	0028
	Х	Z0013798	CONSTRUCTION LAYOUT	LSUM	1	0028
	Х	Z0030850	TEMPORARY INFORMATION SIGNING	SQFT	51	0028
	Х	Z0076600	TRAINEES	HOUR	500	0042
_	Х	Z0076604	TRAINEES TRAINING PROGRAM GRADUATE	HOUR	500	0042
_						
_						
						4

REVISED

REVISED -

REVISED


SI = SPECIALTY ITEMS

SP = SPECIAL PROVISION

	USER NAME = Jrooke	DESIGNED JBR
Michael Baker		DRAWN AJV
	PLOT SCALE = 0.862 1/ 10-	CHECKED ITY
INTERNATIONAL	PLOT DATE = 10/19/2015	DATE 10/21/2015

STATE OF ILLINOIS
DEPARTMENT OF TRANSPORTATION

٦		ST	TE STREET	RRI	DGE ENHA	NCEMENT	PROJECT		F.A.U. RTE.	SECTION	COUNTY	TOTAL	SHEET NO.
- 1		317				TO A THE RESIDENCE OF T	HOULUI		1343	13-00043-00-BR	KANE	65	4
-	SUMMARY OF QUANTITIES									C-91-286-13	CONTRA	CT NO.	61C17
	SCALE:	N/A	SHEET NO. 2	OF	2 SHEETS	STA. N/A	TO STA.	N/A	FED. ROAD	DIST. NO. 1 ILLINOIS FED. A	ID PROJECT: TE-	-00D1(927)	

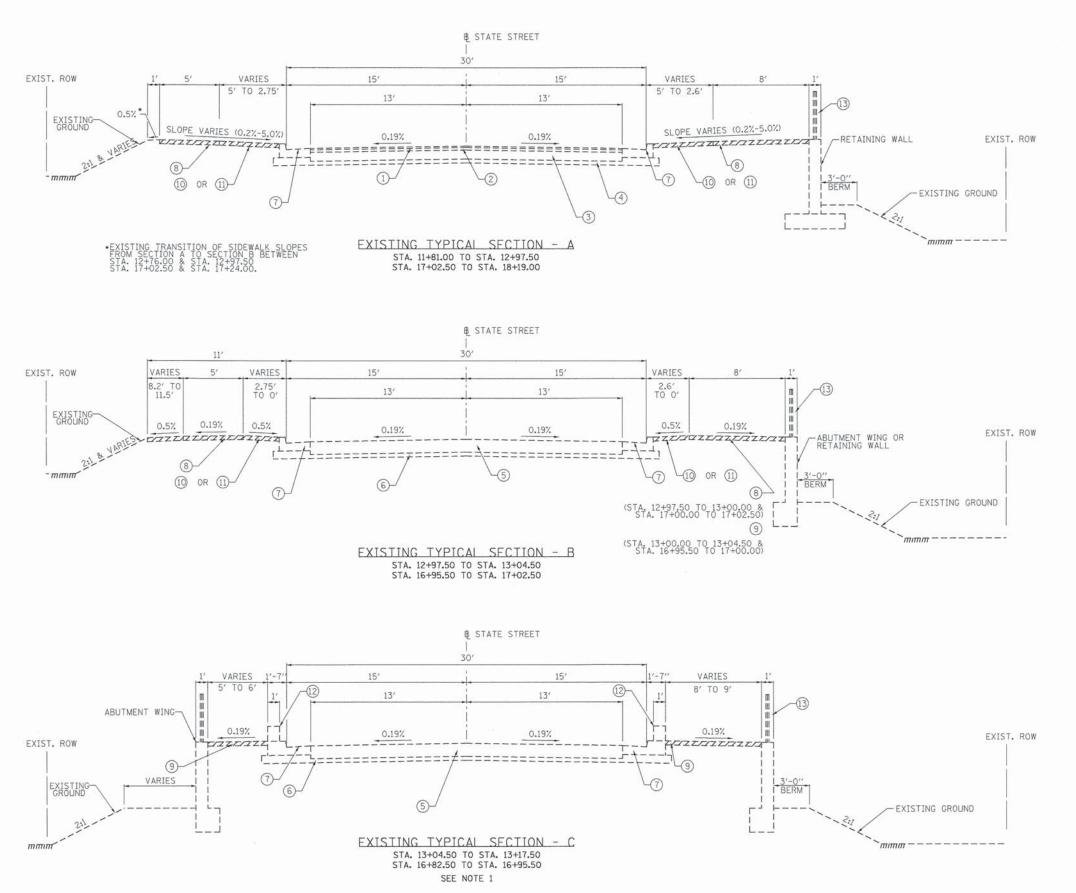

EXISTING LEGEND

- 1) 1-1/2" BITUMINOUS CONCRETE SURFACE COURSE, MIX D, CLASS I
- 2 2-1/2" BITUMINOUS CONCRETE BINDER COURSE
- (3) 9" BITUMINOUS BASE COURSE
- 4 SUBBASE GRANULAR MATERIAL, TYPE B, 4"
- 5 PCC BRIDGE APPROACH PAVEMENT
- 6 BRIDGE APPROACH SUBBASE, 4"
- (7) COMBINATION CONCRETE CURB AND GUTTER, TYPE B-6.24
- (8) PCC SIDEWALK, 4"
- 9 PCC SIDEWALK, 6"
- 10 STONE PAVERS
- 11) PARKWAY
- 12) EXISTING PARAPET
- (13) EXISTING BICYCLE RAILING



ITEMS TO BE REMOVED

NOTES

- 1. REFER TO STRUCTURAL PLANS FOR BRIDGE SECTIONS FROM STA. 13+17.50 TO STA.
- REFER TO THE STRUCTURAL TYPICAL SECTIONS FOR MORE INFORMATION


Michael Baker

USER NAME = jrooke	DESIGNED JBR	REVISED -	
	DRAWN AJV	REVISED -	
PLOT SCALE = 1.0000 '/ in.	CHECKED ITY	REVISED -	
PLOT DATE = 10/19/2015	DATE 10/21/2015	REVISED -	

STATE OF ILLINOIS
DEPARTMENT OF TRANSPORTATION

STATE STREET BRIDGE ENHANCEMENT PROJECT EXISTING TYPICAL SECTIONS

SCALE: N.T.S. SHEET NO. 1 OF 1 SHEETS STA. N/A TO STA. N/A

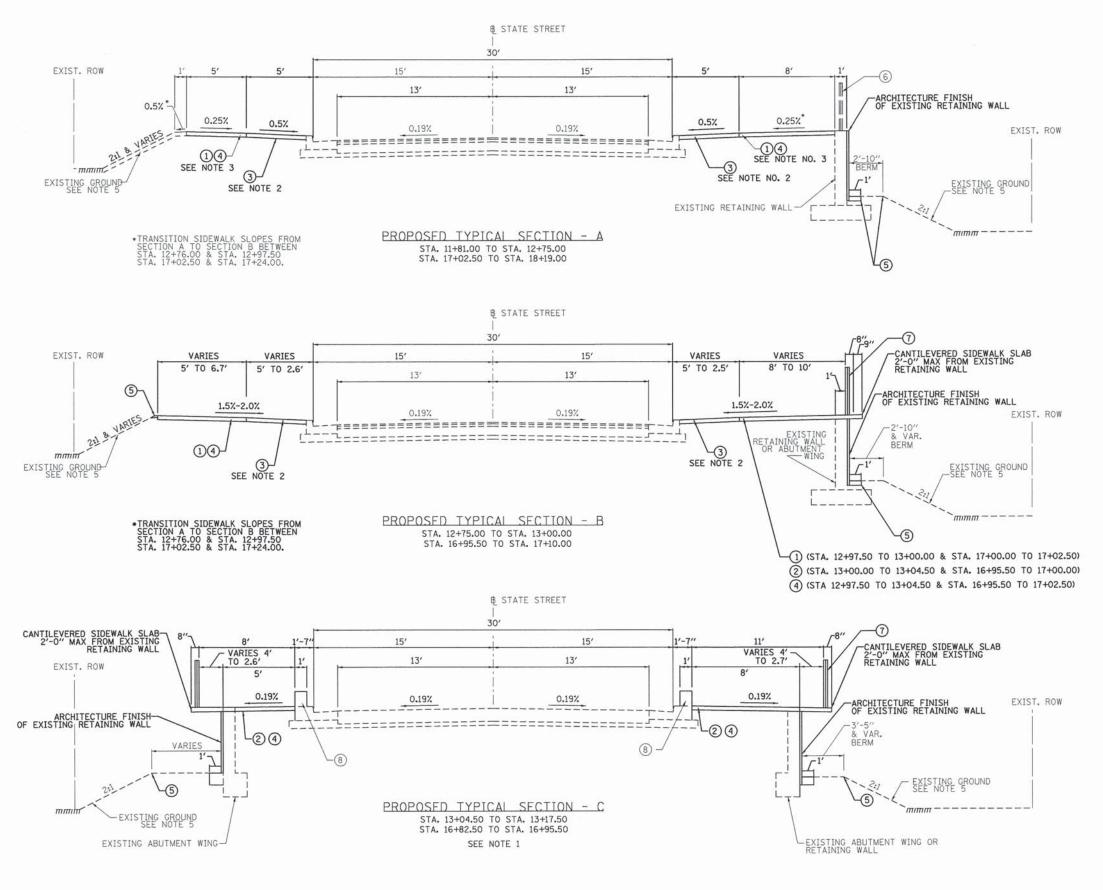

PROPOSED LEGEND

- 1 PORTLAND CEMENT CONCRETE SIDEWALK, 4"
- 2 PORTLAND CEMENT CONCRETE SIDEWALK, 6"
- 3 CONCRETE PAVER SIDEWALK
- 4) SUBBASE GRANULAR MATERIAL, TYPE B, 2"
- SEEDING, CLASS 2A TOPSOIL FURNISH AND PLACE, 6" FERTILIZER NUTRIENTS
- 6 EXISTING BICYCLE RAILING
- 7 PROPOSED BICYCLE RAILING
- 8 EXISTING PARAPET

NOTES:

TO STA. N/A

- REFER TO STRUCTURAL PLANS FOR BRIDGE SECTIONS FROM STA. 13+17.50 TO STA. 16+82.50.
- PROPOSED CONCRETE PAVER SIDEWALK FROM STA. 112+00.00 TO STA. 12+75.00 (R&L) SHALL BE INSTALLED UTILIZING THE EXISTING SLOPES AND FLUSH WITH THE BACK OF CURB AND EDGE OF SIDEWALK.
- EXISTING CONCRETE PAVER SIDEWALK FROM STA. 16+95.24 (R&L) TO STA. 18+00.24 (L) AND 18+18 (R) SHALL BE REMOVED, SALVAGED, AND REPLACED TO THEIR EXISTING STATE FOR THE INSTALLATION OF LIGHTING ITEMS.
- EXISTING BRICK PAVERS FROM STA. 11+81.11 TO 12+00.00 (R) SHALL BE REMOVED, SALVAGED, AND REPLACED TO THEIR EXISTING STATE FOR THE INSTALLATION OF LIGHTING ITEMS.
- REFER TO CRITICAL CROSS SECTIONS FOR PROPOSED GRADING OF SIDE SLOPES.

USER N	USER NAME = Jrooke	DESIGNED JBR	REVISED -			CTA	TE OTDER	T DD	IDCE	ENILA	NCEMENT P	DO IECT
Michael Baker		DRAWN AJV	REVISED -	STATE OF ILLINOIS		SIA						
2 MOSTONICA PARTICIONAL PROPERTIES	PLOT SCALE = 1.0000 ' / in.	CHECKED ITY	REVISED -	DEPARTMENT OF TRANSPORTATION			PK	DPU5	בט וז	PICAL	. SECTIONS	
INTERNATIONAL	PLOT DATE = 10/19/2015	DATE 10/21/2015	REVISED -		SCALE: N.	T.S.	SHEET NO.	1 OF	1 S	HEETS	STA. N/A	TO STA.

RTE.	SEC	TION		COUNTY	SHEETS	NO.
1343	13-000	43-00-BR	1	KANE	65	6
JOB N	0. C-91-2	86-13		CONTRA	ACT NO.	61C17
FED. ROA	D DIST. NO. 1	ILLINOIS	FED. AID	PROJECT: T	E-00D1(927)	

STATION	DISTANCE	EARTH EXCAVATION	EARTH EXCAVATION
(XX+XX)	(FT)	(SQFT)	(CUFT)
	S	IDEWALK	
12+75		0	
	5		1.23
12+80		0.49	
	5		4.85
12+85		1.45	
	5		8.65
12+90		2.01	
	5	4.00	17.10
12+95	-	4.83	22.62
13+00	5	4.62	23.63
13+00	5	4.02	11.55
13+05		0	22.00
16+85		0.00	
	5		4.35
16+90		1.74	
	5		8.70
16+95		1.74	
	5		41.65
17+00		14.92	55.50
47.05	5	7.22	55.60
17+05	5	7.32	29.73
17+10		4.57	25.73
17710	5	4.57	22.25
17+15		4.33	ELILO
	5		27.55
17+20		6.69	
	5		38.28
17+25		8.62	
	5		33.30
17+30		4.70	
	5		24.75
17+35		5.20	26.72
17.40	5	E 44	26.53
17+40	r	5.41	27.50
17+45	5	5.59	27.50
1/+45	5	3.33	13.98
17+50		0.00	23.30
Additional		United to the second	404.45
		UBTOTAL (CUYD)	
	PROJECT S	UBTOTAL (CUYD)	15.60

SHRINKAGE FACTOR ADJUSTMENT(X%)

PROJECT TOTAL (CUYD)

SC	CHEDULE OF TOP	SOIL QUANTITI	ES
STATION		TOPSOIL EXCAVATION AND PLACEMENT	TOPSOIL EXCAVATION AND PLACEMENT
FROM	ТО	(SQFT)	(CUFT)
12+00	13+40	1818.7	909.35
16+61	18+00	3549.3	1774.65
PRO	JECT SUBTOTAL	5368	2684
PROJECT TOTAL (SQ YD)		600	
PROJECT	TOTAL (CU YD)		100

HALL MIN	D PIPE PR
	2800050
STATION	OFFSET
16+48.23	36.54' R
16+49.44	30.20' L
18+59.95	16.67' L
PROII	ECT TOTA

STATION	OFFSET	EACH
11+56.25	51.37' R	1
12+02.47	13.81' R	1
12+03.97	13.61' L	1
13+30.45	13.69' R	1
13.+30.59	13.83' L	1
13+54.68	13.64' R	1
13+54.93	14.67' L	1
13+78.92	13.76' R	1
13+79.07	13.85' L	1
14+03.22	13.76' R / 13.85' L	2
14+27.45	13.64' R / 13.88' L	2
14+51.66	13.72' R / 13.87' L	2
14+75.98	13.77' R / 13.85' L	2
14+91.94	13.84' R / 13.84' L	2
15+08.00	13.63' R / 13.89' L	2
15+23.76	13.70' R / 13.90' L	2
15+47.77	13.62' R	1
15+48.21	13.84' R	1
15+72.49	13.75' R / 13.85' L	2
15+96.60	13.95' R / 13.88' L	2
16+20.85	13.79' R	1
16+21.01	13.84' L	1
16+44.98	13.90' R	1
16+45.23	14.66′ L	1
16+69.39	13.92' R / 13.82' L	2
18+25.12	20.95' R	1
18+35.86	11.26' R	1
18+42.10	45.96' R	1
18+51.94	16.54' L	1
18+66.76	16.65′ L	1
	PROJECT TOTAL	40

SCHEDULE OF EROSION CONTROL ITEMS

INLET FILTERS 28000510

	BAF	R EROSION RRIER	
	2800	00400	
STAT	TION	OFFSET	FT
FROM	ТО	OFFSEI	Et
11+96	13+35	R	234
11+87	13+40	L	215
16+65	18+24	R	238
16+60	18+19	L	243
	PROJ	ECT TOTAL	930

		SCHED	ULE OF SEEDIN	IG ITEMS	
STATION		SEEDING, CLASS 2A	NITROGEN FERTILIZER NUTRIENT	PHOSPHOROUS FERTILIZER NUTRIENT	POTASSIUM FERTILIZER NUTRIENT
FROM	TO	25000210	25000400	25000500	25000600
(XX+XX)		ACRES	POUND	POUND	POUND
OFFSE	TLEFT				
12+71	13+40	0.018	3	2	5
16+60	17+46	0.028	4	3	8
OFFSET	RIGHT				
11+96	13+20	0.024	3	3	6
16+65	18+00	0.053	7	6	14
PROJE	CT TOTALS	0.123	17	14	33

	ULE OF RO		
	STATION		
FROM	TO	44000600	
(XX+	XX)	SQFT	
12+75	18+00	600	
PROJEC	T TOTALS	600	

STATION TO		PORTLAND CEMENT CONCRETE SIDEWALK 4 INCH	PORTLAND CEMENT CONCRETE SIDEWALK 6 INCH	PROTECTIV COAT	
		42400100	42400300	42001300	
		SQ FT	SQ FT	SQ YD	
12+75	13+20	325	274	67	
16+81	17+50	656	264	102	
PROJECT TOTAL		981	538	169	


	CONTINGENCY AND ESTIMATED ITEMS		
PAYCODE	DESCRIPTION	UNITS	QUANTITY
67100100	MOBILIZATION	LSUM	1
70106800	CHANGEABLE MESSAGE SIGN	CAL MO	6
78000200	THERMOPLASTIC PAVEMENT MARKING - LINE 4"	FOOT	400
78005110	EPOXY PAVEMENT MARKING - LINE 4"	FOOT	800
67000400	ENGINEER'S FIELD OFFICE, TYPE A	CAL MO	6
X7010216	TRAFFIC CONTROL AND PROTECTION (SPECIAL)	LSUM	1
Z0013798	CONSTRUCTION LAYOUT	LSUM	1
Z0076600	TRAINEES	HOUR	500
70076604	TRAINEES TRAINING PROGRAM GRADUATE	HOUR	500


	USER NAME = Jrooke	DESIGNED JBR	REVISED -	
Michael Baker		DRAWN AJV	REVISED -	
	PLOT SCALE = 1,000 '/ in-	CHECKED ITY	REVISED -	
NTERNATIONAL	PLOT DATE = 10/19/2015	DATE 10/21/2015	REVISED -	

3.12

19

		TATE STREET	RRID	GE ENHA	NCFMI	FNT PR	O.IECT		F.A.U. RTE.	SECTION	COUNTY	TOTAL	SHEET NO.
	100			E OF QU			0020.		1343	13-00043-00-BR	KANE	65	7
		30	חבטטו	E OF UU	ANTIII	IE9			JOB NO.	c-91-286-13	CONTRA	CT NO.	61C17
SCALE:	N/A	SHEET NO. 1	OF	SHEETS	STA.	N/A	TO STA.	N/A	FED. ROAD	DIST. NO. 1 ILLINOIS FED.	AID PROJECT: TE	-0001(927)	

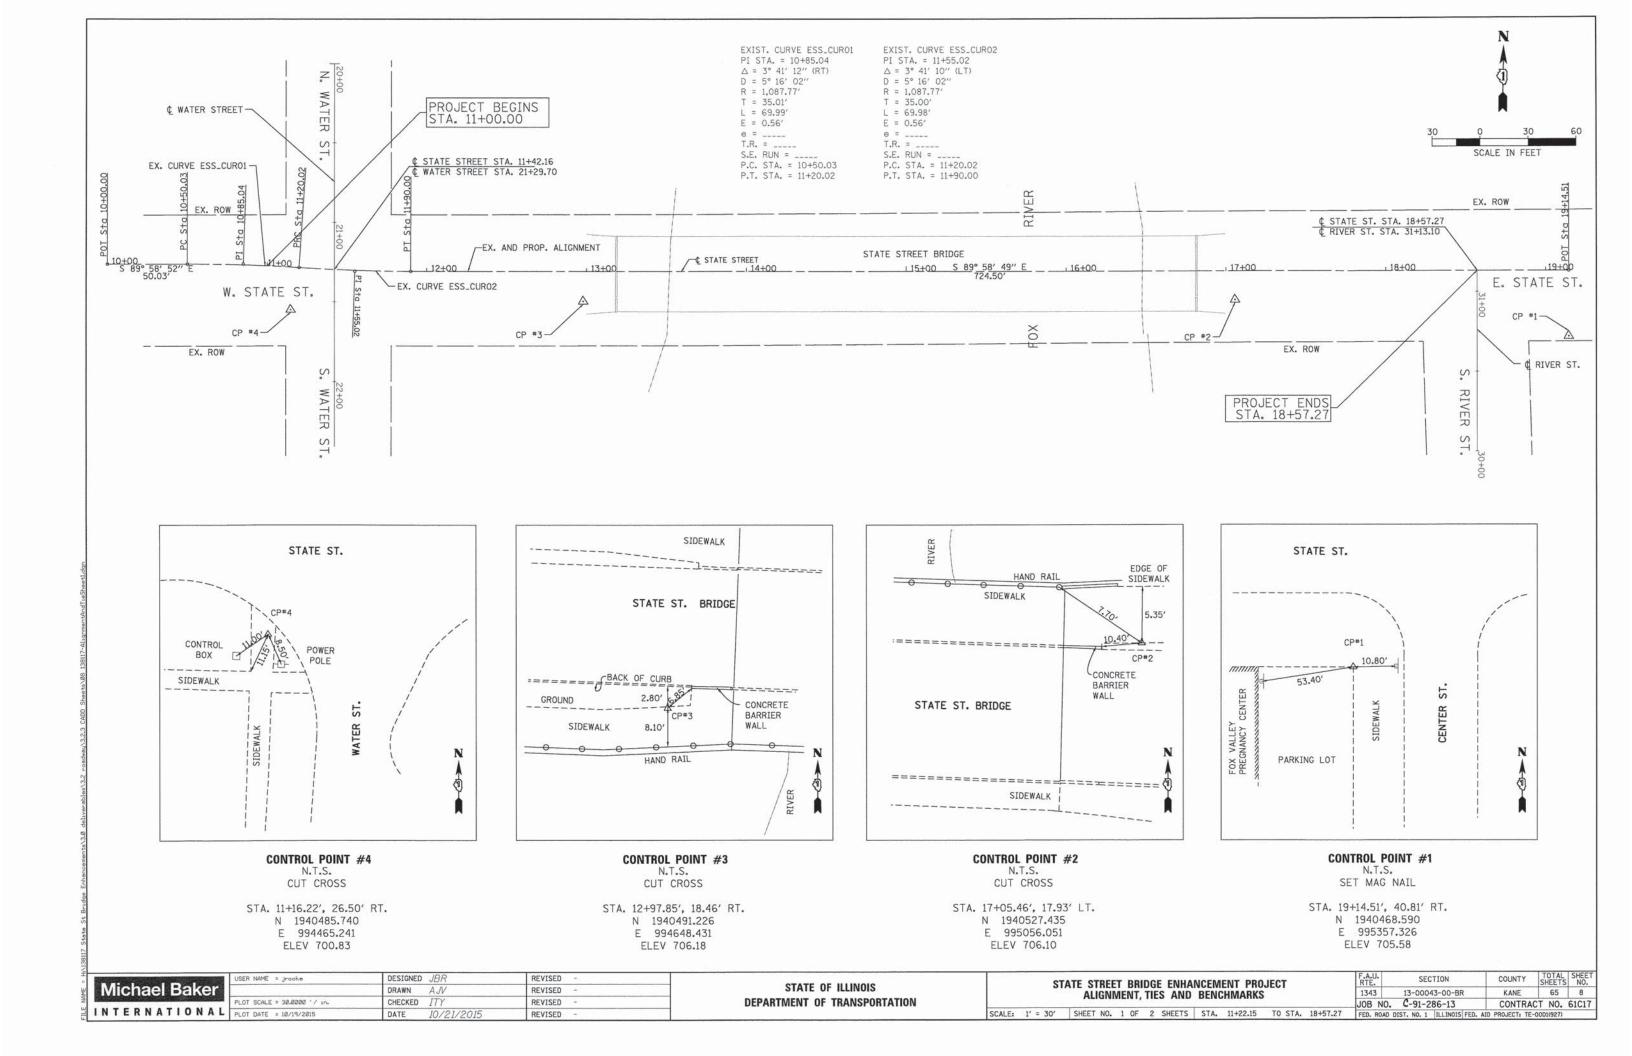


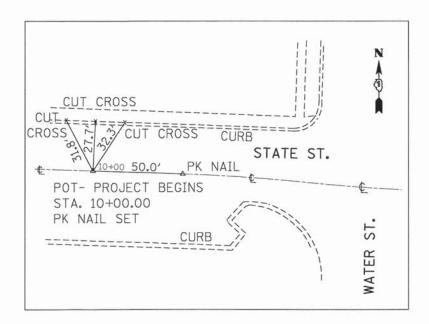

STA. 10 + 00STATE ST. **PROJECT BEGINS**


N.T.S. SET PK NAIL

N 1940514.249 E 994350.670

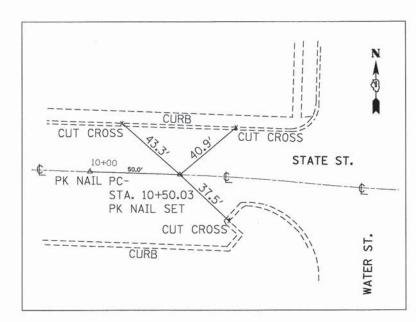


STA. 10 + 50.03PC - STATE ST. N.T.S. SET PK NAIL

N 1940514.232 E 994400.727

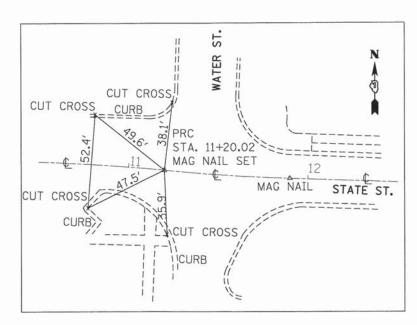


STA. 11 + 20.02 PRC - STATE ST. N.T.S. SET MAG NAIL

N 1940511.924 E 994470.664

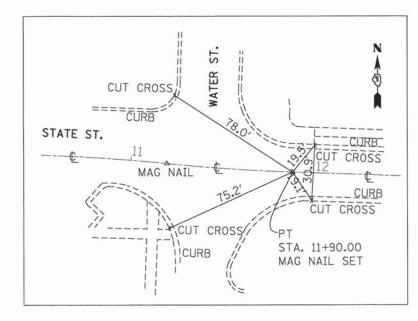

STA. 11 + 90.00 PT - STATE ST. N.T.S. SET MAG NAIL

N 1940509.665 E 994540.579

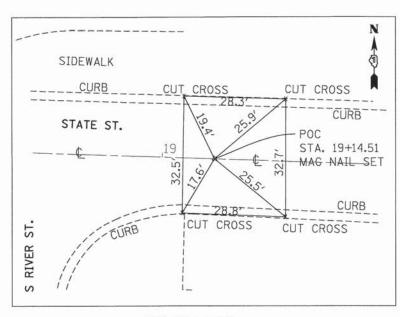

STA. 19 + 14.51 POT - STATE ST. PROJECT ENDS N.T.S. SET MAG NAIL

N 1940509.441

SCALE:

E 995265.108


US	Michael Baker												
PI		G	L	a		L	7	٥	1	C	Щ	7	
-	L	A I		0		-		-	n	-	-		
PI		N H		v			А	IA	ĸ	_		N	


USER NAME = Jrooke	DESIGNED JBR	REVISED -	
	DRAWN AJV	REVISED -	
PLOT SCALE = 1.0000 '/ in.	CHECKED ITY	REVISED -	
PLOT DATE = 10/19/2015	DATE 10/21/2015	REVISED -	


STATE OF ILLINOIS DEPARTMENT OF TRANSPORTATION

STA	TE STREET BRIDG	E ENHA	NCEME	NT PRO	JECT		F.A.U. RTE.	SECTION	COUNTY	TOTAL SHEETS	SHEET NO.
0171	ALIGNMENT, TIE				71.775.30.70		1343	13-00043-00-BR	KANE	65	9
	ALIGHMENT, THE	o, Alto	DENOM	iiAiiito			JOB NO	. C-91-286-13	CONTRA	CT NO.	61C17
N.T.S.	SHEET NO. 2 OF 2	SHEETS	STA.	N/A	TO STA.	N/A	FED. ROAD	DIST. NO. 1 ILLINOIS FED. A	ID PROJECT: TE-	·00D1(927)	



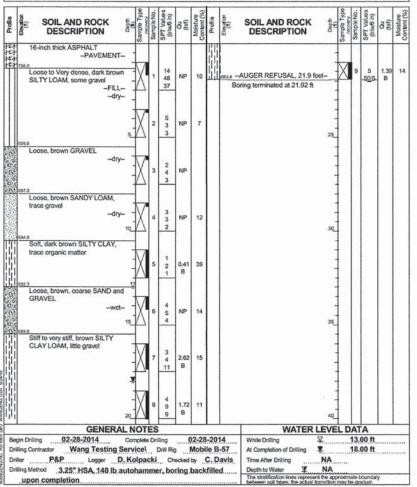

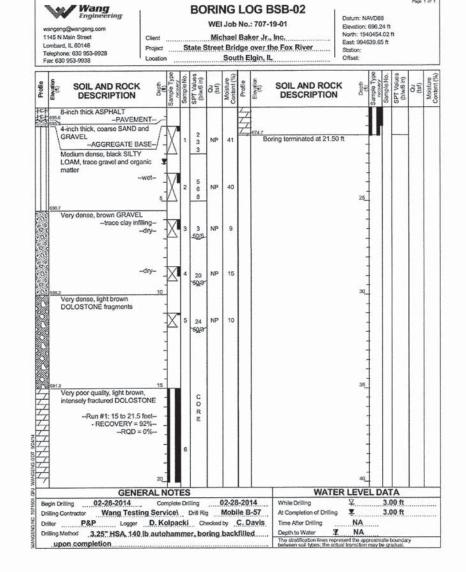

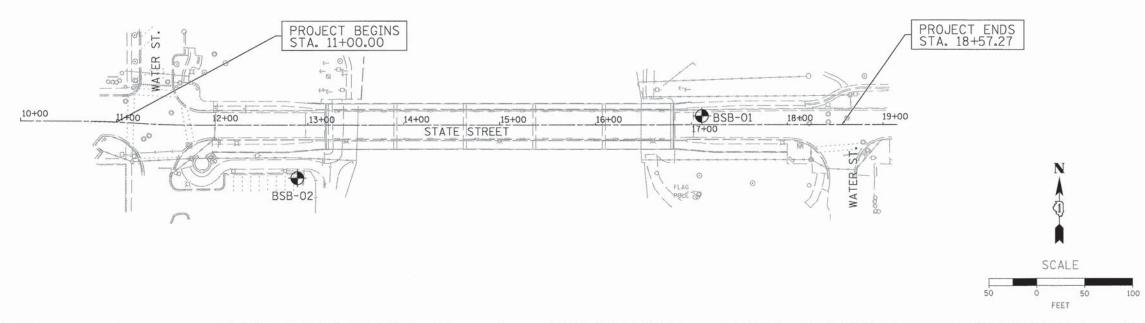

SCALE:


	USE
Michael Baker	PLO
INTEDNATIONAL	-
INIEKNATIONAL	PL0

	USER NAME = Jrooke	DESIGNED JBR	REVISED -	
		DRAWN AJV	REVISED -	
•	PLOT SCALE = 50.000 '/ in.	CHECKED ITY	REVISED -	
-	PLOT DATE = 10/19/2015	DATE 10/21/2015	REVISED -	


STATE OF ILLINOIS								
DEPARTMENT OF	TRANSPORTATION							

ST	ATE STREE	ET	BRI	DG	E ENHA	NCEM	ENT PR	OJECT		F.A.U. RTE.	SECTION
٠.										1343	13-00043-00
		DI	UNIII	WG.	LOGS					JOB NO	. C-91-286-13
1" = 50'	SHEET NO.	1	OF	1	SHEETS	STA.	N/A	TO STA.	N/A	FED. ROAD	DIST. NO. 1 ILLIN

	F.A.U. RTE. 1343	SECTION	COUNTY	TOTAL	SHEET NO.
ı	1343	13-00043-00-BR	KANE	65	10
	JOB N	IO. C-91-286-13	CONTRAC	T NO.	61C17
	FED. RO	AD DIST. NO. 1 ILLINOIS FED. A	AID PROJECT: TE-	0001(927)	

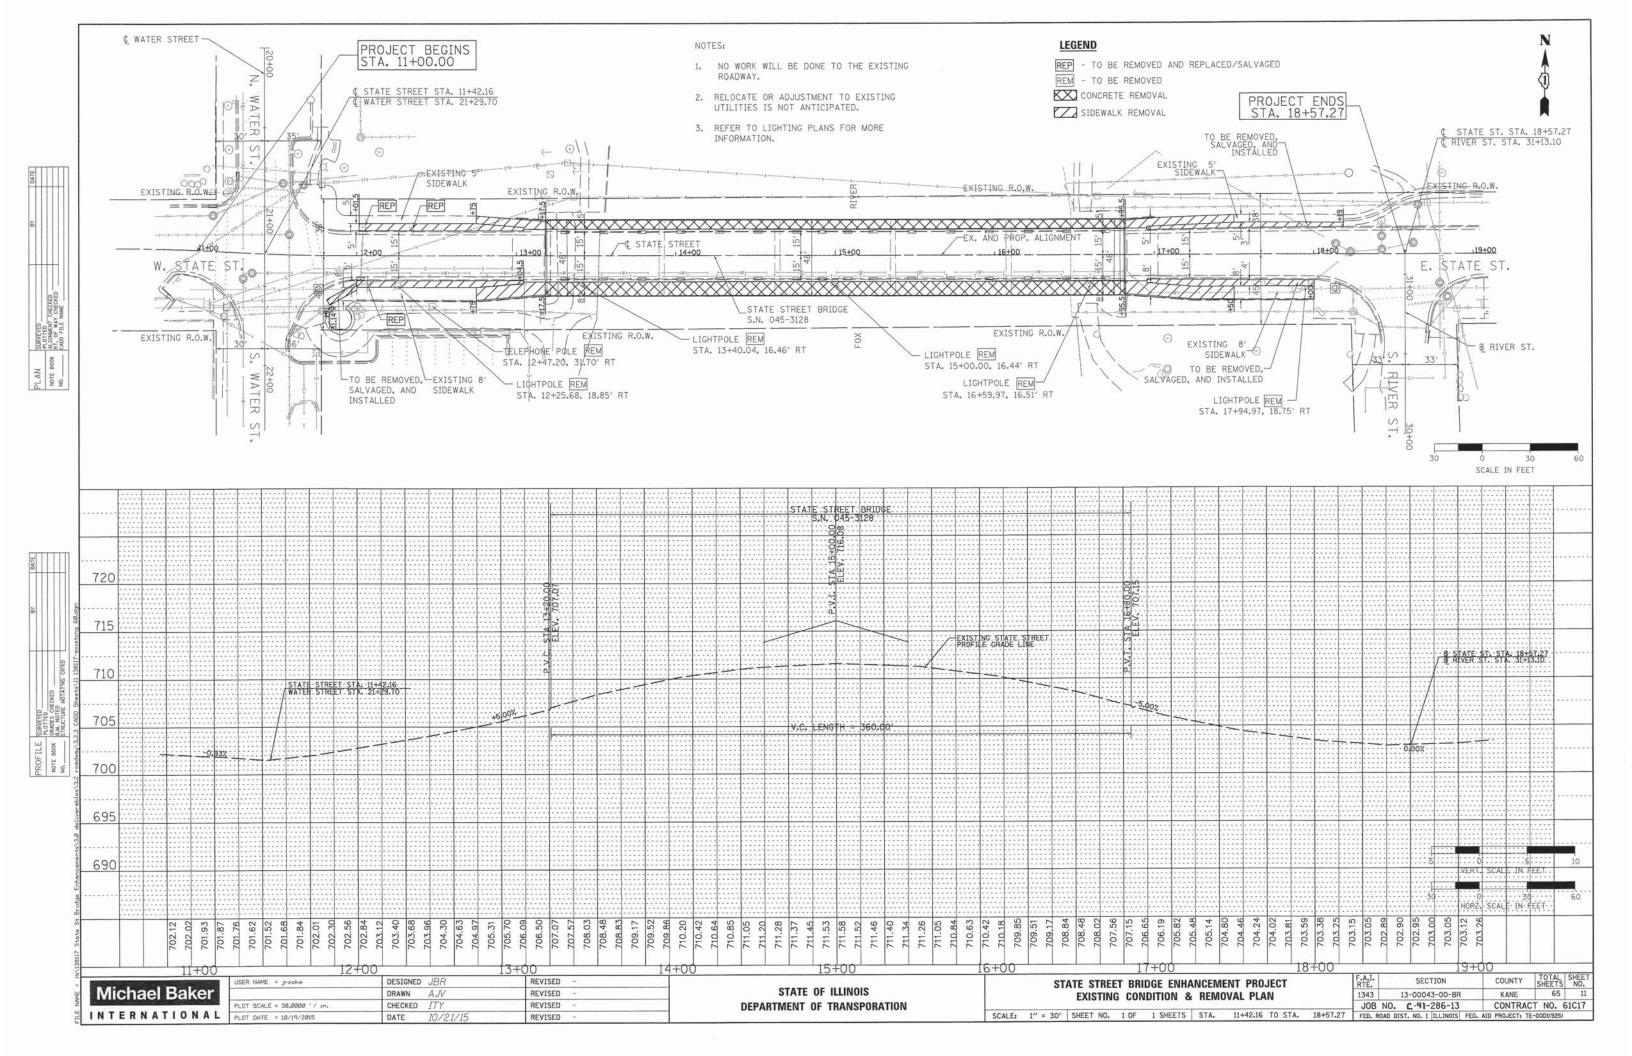



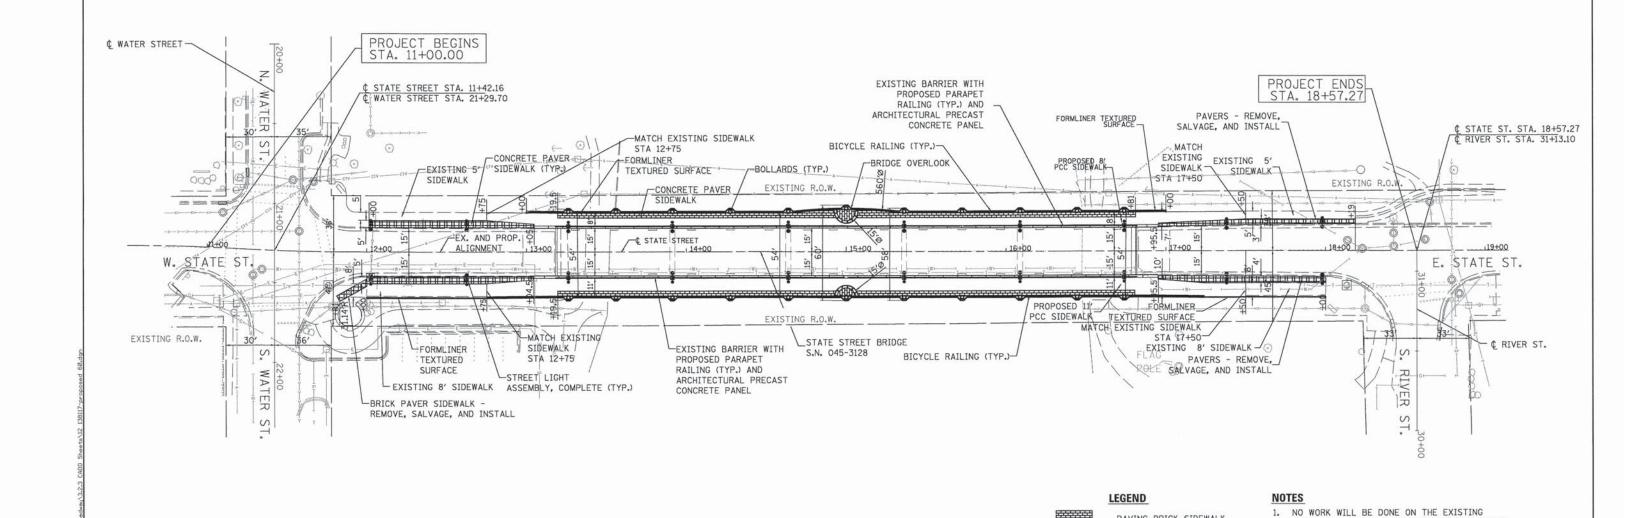

30 0 30 60 SCALE IN FEET

ROADWAY. REFER TO THE EXISTING CONDITIONS PLAN FOR EXISTING PROFILE INFORMATION.

2. REFER TO STRUCTURAL PLANS FOR BRIDGE

 REFER TO ELECTRICAL PLANS FOR LIGHTING LAYOUT AND DETAILS.

4. REFER TO ROADWAY GRADING DETAIL FOR MORE

DETAILS.

INFORMATION.

PAVING BRICK SIDEWALK

CONCRETE PAVER SIDEWALK

STREET LIGHT ASSEMBLY

EXISTING BARRIER WITH


CONCRETE PANEL

PROPOSED PARAPET RAILING

AND ARCHITECTURAL PRECAST


BOLLARDS

- 1		USER NAME = Jrooke	DESIGNED JBR	REVISED -	OTATE OF HUMOIO	57	TATE STREET BRIDGE ENHANC	CEMENT PROJECT	RTE.	SECTION	COUNTY	SHEETS	NO.
5	Michael Baker		DRAWN AJV	REVISED -	STATE OF ILLINOIS		PROPOSED PLA		1343	13-00043-00-BR	KANE	65	12
- 1	2	PLOT SCALE = 30.0000 ' / in.	CHECKED ITY	REVISED -	DEPARTMENT OF TRANSPORTATION		Company of the same of the sam		JOB NO			ACT NO. 6	
	INTERNATIONAL	PLOT DATE = 10/19/2015	DATE 10/21/2015	REVISED -		SCALE: 1' = 30'	SHEET NO. 1 OF 1 SHEETS S	STA. 11+22.15 TO STA. 18+57.27	FED. ROAD	DIST. NO. 1 ILLINOIS FED.	AID PROJECT: TE	2-00D1(927)	

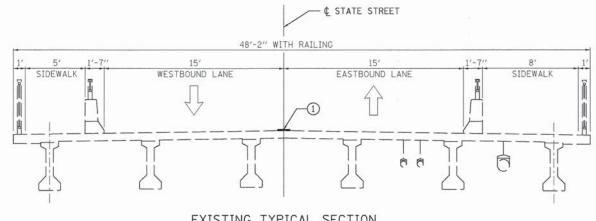



EXISTING TYPICAL SECTION

- ¢ STATE STREET

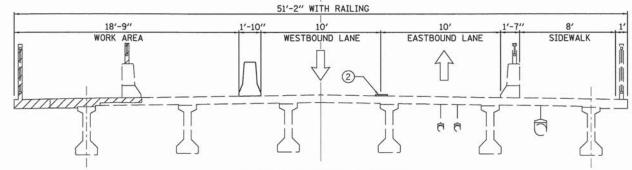

STAGE I TYPICAL SECTION

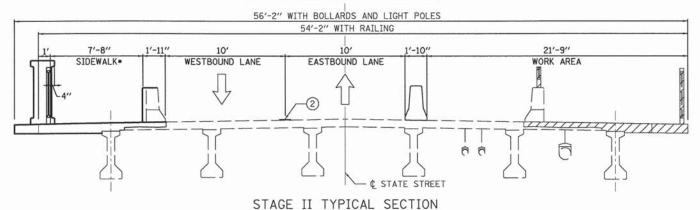

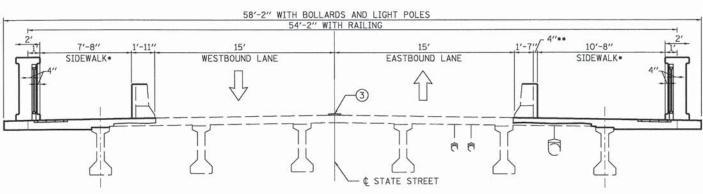

PROPOSED TYPICAL SECTION

- . AT SECTIONS WHERE ONLY RAILING IS PROPOSED, THE SIDEWALKS ARE 8'-0" ON THE NORTH SIDE AND 11'-0" ON THE SOUTH SIDE OF THE BRIDGE.
- •• 4" ADDITIONAL CONCRETE FOR LIGHT POLE FOUNDATION

LEGEND

TEMPORARY CONCRETE BARRIER



TRAFFIC FLOW DIRECTION



REMOVAL

- 1
- EXISTING PAVEMENT MARKING
- 2 TEMPORARY PAVEMENT MARKING LINE -4" DOUBLE YELLOW
- 3 PROPOSED PAVEMENT MARKING

MAINTENANCE OF TRAFFIC NOTES

- THE CONTRACTOR MUST MAINTAIN ONE LANE OF TRAFFIC IN EACH DIRECTION AT ALL TIMES WITH MINIMUM LANE WIDTHS AS SHOWN ON THIS SHEET AND THE MAINTENANCE OF TRAFFIC PLAN.
- 2. THE CONTRACTOR IS REQUIRED TO NOTIFY THE ENGINEER OF ANY DAMAGE TO TRAFFIC CONTROL
- 3. PORTLAND CEMENT CONCRETE PAVEMENT SHALL NOT BE OPEN TO PEDESTRIAN TRAFFIC UNTIL AFTER THE SPECIFIED CURING PERIOD AS DEFINED IN ARTICLE 701.17(C)(5) OF THE "STANDARD SPECIFICATIONS" AND UNTIL THE JOINTS HAVE BEEN SEALED.
- 4. ACCESS TO EXISTING CROSS ROADS AND DRIVES MUST BE MAINTAINED AT ALL TIMES DURING CONSTRUCTION.
- 5. ADEQUATE PROVISIONS FOR PEDESTRIAN TRAFFIC MUST BE PROVIDED AT ALL TIMES.
- 6. SEE MAINTENANCE OF TRAFFIC PLAN (SHEET 2 OF 2) FOR ADDITIONAL NOTES.
- 7. REFER TO STRUCTURAL STAGE CONSTRUCTION AND REMOVAL SEQUENCE PLAN FOR A DETAILED SEQUENCE OF CONSTRUCTION.
- 8. BEFORE ANY CONSTRUCTION ACTIVITES ARE STARTED ALL NECESSARY TEMPORARY TRAFFIC CONTROL SIGNS AND MARKINGS SHALL BE IN PLACE. ALL CONFLICTING SIGNS SHALL BE COVERED.
- 9. ALL TEMPORARY TRAFFIC CONTROL DEVICES SHALL BE REMOVED AS SOON AS PRACTICAL WHEN THEY ARE NO LONGER NEEDED.
- 10. SIGN LAYOUT AND SPACING SHALL BE IN ACCORDANCE WITH THE CURRENT IDOT STANDARD DRAWINGS AND THE "MANUAL OF UNIFORM TRAFFIC CONTROL DEVICES." SEE HIGHWAY STANDARDS FOR ADDITIONAL INFORMATION.
- 11. THIS WORK SHALL BE INCLUDED IN THE LUMP SUM COST FOR TRAFFIC CONTROL AND PROTECTION (SPECIAL).
- 12. ALL EXISTING TRAFFIC SIGNS SHALL BE MAINTAINED THROUGHOUT THE DURATION OF THE PROJECT.

SEQUENCE OF CONSTRUCTION

- 1. REMOVE EXISTING MARKINGS AND INSTALL TEMPORARY MARKINGS AND TEMPORARY CONCRETE BARRICADES TO PROVIDE 18'-9" OF WORK AREA ON THE NORTH SIDE OF THE BRIDGE AND 10' LANES OF TRAFFIC AS SHOWN IN THE STAGE I TYPICAL SECTION ON THIS SHEET.
- 2. CONSTRUCT SIDEWALK EXPANSION ON THE NORTH SIDE OF THE BRIDE.
- 3. REMOVE TEMPORARY MARKINGS INSTALLED IN STAGE I AND INSTALL TEMPORARY MARKINGS AND TEMPORARY CONCRETE BARRICADES TO PROVIDE 21'-9" OF WORK AREA ON THE SOUTH SIDE OF THE BRIDGE AND 10' LANES OF TRAFFIC AS SHOWN IN THE STAGE II TYPICAL SECTION ON THIS SHEET.
- 4. CONSTRUCT SIDEWALK EXPANSION ON THE SOUTH SIDE
- 5. REMOVE TEMPORARY MARKINGS AND TEMPORARY CONCRETE BARRICADES AND INSTALL FINAL PROPOSED MARKINGS AS SHOWN ON THE PLANS AND RE-ESTABLISH ORIGINAL TRAFFIC PATTERN WITH 15' LANES OF EASTBOUND AND WESTBOUND TRAFFIC.


25360000	N	1	c	h	a	el		3	a	k	er	Salves
1	N	Т	E	R	N	A	Т	1	0	N	A	L


USER NAME = Jrooke	DESIGNED JBR	REVISED -	
	DRAWN WME	REVISED -	
PLOT SCALE = 4.0000 ' / in.	CHECKED ITY	REVISED -	
PLOT DATE = 10/20/2015	DATE 10/21/2015	REVISED -	

STATE OF ILLINOIS DEPARTMENT OF TRANSPORTATION

	:	STATE ST					ENHA			ROJECT	
SCALE:	N.T.S.	SHEET	NO.	1 0	F	2	SHEETS	STA.	N/A	TO STA.	

F.A.U. RTE.		SEC	TION			COUNT	Y S	HEETS	SHEE NO.
1343	13-0	0004	3-00-BF	t	Т	KANE		65	13
JOB N	0. C-9	1-2	86-13			CONT	RACT	NO.	61C1
FED. RO	AD DIST. NO	0. 1	ILLINOIS	FED.	AID	PROJECT:	TE-000	1(927)	

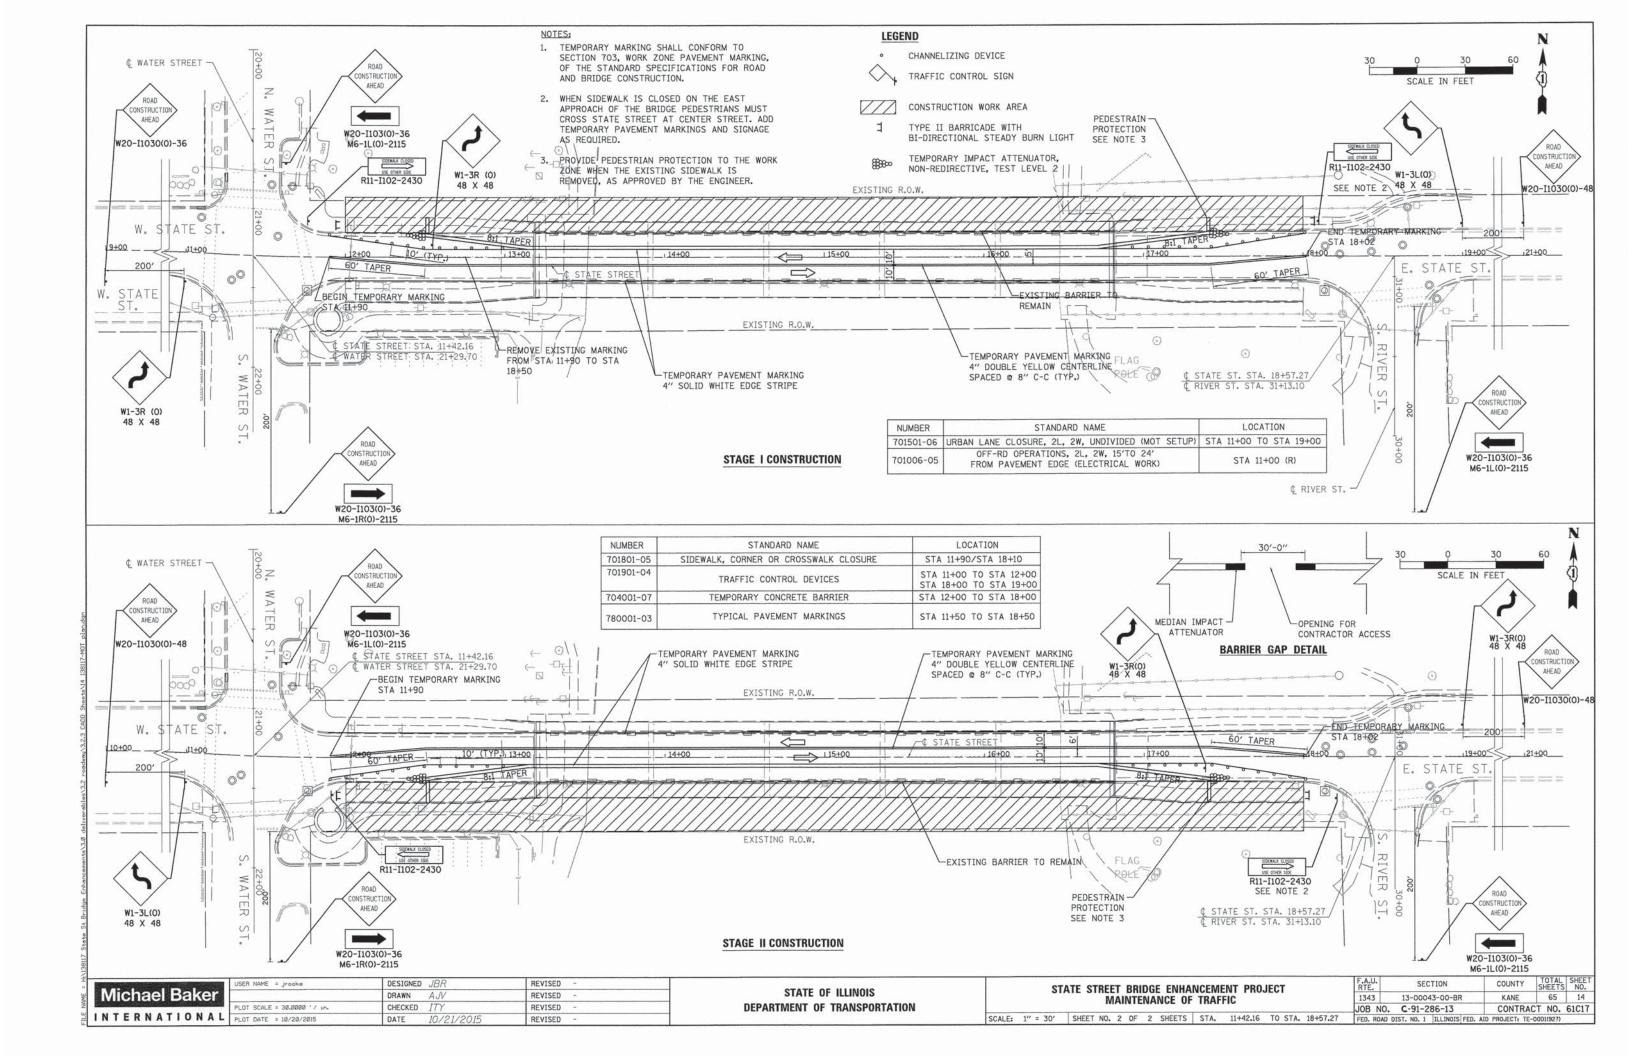

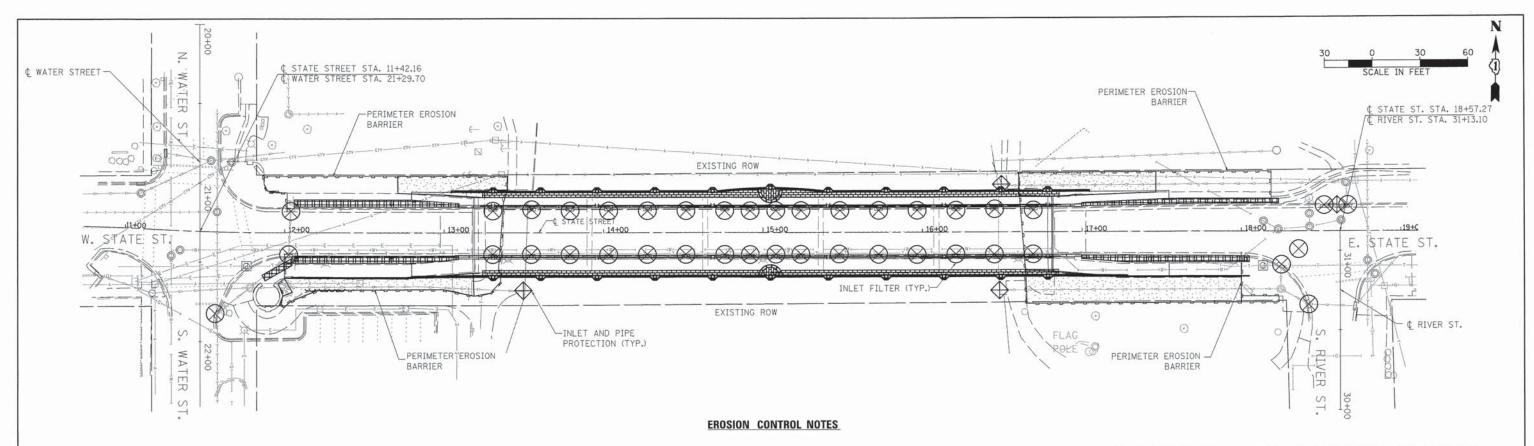

- ALL WORK SHALL BE DONE IN ACCORDANCE WITH THE KANE COUNTY STORMWATER AND FLOODPLAIN ORDINANCE, AND ALL SUBSEQUENT REVISIONS. ALL SEDIMENT AND EROSION CONTROL MEASURES WILL BE INSTALLED PER IDOT STANDARD 280001 OR AS SPECIFIED HEREIN AND PAID FOR IN ACCORDANCE WITH SECTION 280 OF THE STANDARD SPECIFICATIONS.
- 2. EROSION CONTROL SHALL BE PROVIDED IN ACCORDANCE WITH THE SEQUENCE OF STAGE CONSTRUCTION. ALL EROSION CONTROL MEASURES SHALL BE INSTALLED PRIOR TO BEGINNING ANY CONSTRUCTION ACTIVITIES WHICH WILL POTENTIALLY CREATE ERODIBLE CONDITIONS. THE CONTRACTOR SHALL SUBMIT A DETAILED SCHEDULE FOR APPROVAL. SEDIMENT AND EROSION CONTROL DEVICES SHALL BE FUNCTIONAL BEFORE THE PROJECT SITE IS OTHERWISE DISTURBED.
- 3. ALL DISTURBED AREAS SHALL BE SEEDED OR SODDED AS SOON AS PRACTICAL AFTER CONSTRUCTION ACTIVITIES IN THAT AREA HAVE CONCLUDED. STABILIZATION OF DISTURBED AREAS MUST BE INITIATED WITHIN 1 WORKING DAY OF PERMANENT OR TEMPORARY CESSATION OF EARTH DISTURBING ACTIVITIES AND SHALL BE COMPLETED AS SOON AS POSSIBLE BUT NO LATER THAN 14 DAYS FROM THE INITIATION OF STABILIZATION WORK IN AN AREA. EXCEPTIONS TO THESE TIME FRAMES ARE SPECIFIED AS FOLLOWS: WHERE THE INITIATION OF STABILIZATION MEASURES IS PRECLUDED BY SNOW COVER. STABILIZATION MEASURES SHALL BE INITIATED AS SOON AS PRACTICABLE; ON AREAS WHERE CONSTRUCTION ACTIVITY CEASED AND WILL RESUME AFTER 14 DAYS, A TEMPORARY STABILIZATION METHOD CAN BE USED. TEMPORARY SEDIMENT AND EROSION CONTROL MEASURES SHALL BE MAINTAINED CONTINUOUSLY UNTIL PERMANENT COVER IS ESTABLISHED.
- 4. IF A TOPSOIL STOCKPILE IS TO REMAIN IN PLACE FOR MORE THAN 3 DAYS, EROSION CONTROL MEASURES WILL BE PROVIDED, SOIL STOCKPILES MUST NOT BE LOCATED WITHIN ANY SPECIAL MANAGEMENT AREAS. MINOR TEMPORARY STOCKPILING OF MATERIALS OR FILLS WITHIN THE FLOODPLAIN MAY BE ALLOWED IF NECESSARY. THE VILLAGE OF SOUTH ELGIN AND THE ENGINEER SHALL APPROVE LIMITS ON THE DURATION AND WHERE THE TEMPORARY STOCKPILING CAN TAKE PLACE.
- 5. THE CONTRACTOR SHALL TAKE ALL PRECAUTIONS TO PROTECT THE FOX RIVER AND THE FLOODPLAIN TO REMAIN FROM DAMAGE BY SEDIMENT, CONSTRUCTION EQUIPMENT, OR BY HIS WORK CREWS. THE CONTRACTOR SHALL ASSURE THAT DEBRIS OR ANY CONSTRUCTION MATERIAL IS NOT DISPOSED OF IN THE FOX RIVER OR FLOODPLAIN.
- 6. WATER PUMPED OR OTHERWISE DISCHARGED FROM THE SITE DURING CONSTRUCTION DEWATERING SHALL BE FILTERED.
- 7. ACCESS DRIVES, PARKING AREAS OF SUFFICIENT WIDTH AND LENGTH, AND VEHICLE WASH DOWN FACILITIES IF NECESSARY, SHALL BE PROVIDED TO PREVENT SOIL FROM BEING TRACKED ONTO PUBLIC OR PRIVATE AREAS. ANY SOIL REACHING A PUBLIC OR PRIVATE ROADWAY SHALL BE REMOVED BEFORE THE END OF EACH WORKDAY AS NEEDED.

- 8. CLEANING OF VEHICLES AND EQUIPMENT, INCLUDING CONCRETE MIXERS, SHALL BE PERFORMED IN A MANNER TO REDUCE THE AMOUNT OF POLLUTANTS TRIBUTARY TO STORM SEWERS AND OPEN WATERS TO THE MAXIMUM EXTENT PRACTICAL. CONCRETE WASH AREAS SHALL NOT BE LOCATED WITHIN ANY SPECIAL MANAGEMENT AREAS. LOCATION OF WASH AREAS SHALL BE APPROVED BY THE ENGINEER.
- 9. ALL NECESSARY MEASURES SHALL BE TAKEN TO CONTAIN ANY FUEL OR POLLUTION RUNOFF.
 LEAKING EQUIPMENT OR SUPPLIES SHALL BE IMMEDIATELY REPAIRED OR REMOVED FROM THE SITE.
- 10. SEDIMENT COLLECTED DURING CONSTRUCTION BY THE VARIOUS TEMPORARY EROSION CONTROL SYSTEMS SHALL BE DISPOSED OF ON THE SITE ON A REGULAR BASIS. SEDIMENT SHALL BE REMOVED FROM EROSION CONTROL SYSTEMS WHEN THE HEIGHT OF THE SEDIMENT EXCEEDS ONE-HALF OF THE HEIGHT OF THE FILTER DEVICE.
- 11. THE ENGINEER SHALL INSPECT EROSION CONTROL MEASURES AT LEAST ONCE EVERY 7 DAYS AND WITHIN 24 HOURS OF ANY STORM EXCEEDING 1/2 INCH PRECIPITATION. DAMAGED AND INEFFECTIVE EROSION CONTROL MEASURES SHALL BE REPLACED OR REPAIRED WITHIN 72 HOURS. EROSION CONTROL SYSTEMS REPLACED DUE TO SEDIMENT LOADING WILL BE PAID FOR AT THE CONTRACT UNIT PRICE FOR THE APPLICABLE EROSION CONTROL ITEM.
- 12. THE COST OF REPAIRING OR REMOVING SEDIMENT FROM EROSION CONTROL SYSTEMS SHALL BE INCLUDED IN THE CONTRACT UNIT PRICE FOR INLET AND PIPE PROTECTION (28000400).
- 13. ALL EROSION CONTROL MEASURES SHALL BE KEPT OPERATIONAL AND MAINTAINED CONTINUOUSLY THROUGHOUT THE PERIOD OF LAND DISTURBANCE UNTIL PERMANENT SEDIMENT AND EROSION CONTROL MEASURES ARE OPERATIONAL.
- 14. A COPY OF THE APPROVED EROSION AND SEDIMENT CONTROL PLAN SHALL BE MAINTAINED ON THE SITE AT ALL TIMES.
- 15. IT IS THE RESPONSIBILITY OF THE GENERAL CONTRACTOR TO INFORM ANY SUBCONTRACTORS WHO MAY PERFORM WORK ON THIS PROJECT, OF THE REQUIREMENTS IN IMPLEMENTATION AND MAINTAINING THESE EROSION CONTROL PLANS.
- 16. THE CONSTRUCTION LIMIT WILL BE STAKED/APPROVED BY THE ENGINEER PRIOR TO COMMENCING CONSTRUCTION. THE CONSTRUCTION LIMITS MAY BE ADJUSTED BY THE ENGINEER TO PRESERVE VEGETATION. NO ADDITIONAL COMPENSATION WILL BE PAID TO THE CONTRACTOR FOR CHANGES IN THE CONSTRUCTION LIMIT.
- 17. DEVIATIONS FROM THIS PLAN ARE TO BE EXPECTED PENDING A JOB SITE INSPECTION BETWEEN THE CONTRACTOR AND THE DEPARTMENT.
- 18. IN ANY AREA WHERE THERE IS NO PROPOSED GRADING, THE EXISTING GROUND SHALL REMAIN UNDISTURBED. SEED MIX AND/OR TEMPORARY COVER CROP WILL BE SOWN ON ALL DISTURBED AREAS UPON COMPLETION OF THE FINAL GRADING. A 100% BIODEGRADABLE EROSION BLANKET WILL BE INSTALLED TO PREVENT EROSION FOR SEEDED AREAS.

- 19. ALL INLET AND PIPE PROTECTION SHALL BE PROVIDED AT ALL FLARED END SECTION INFLOW AND OUTFALLS WITHIN THE PROJECT LIMITS.21.TREE REMOVAL, TREE PROTECTION, OR TREE ROOT PRUNING IS NOT ANTICIPATED FOR THIS PROJECT DUE TO NO ESTABLISHED TREES WITHIN THE CONSTRUCTION LIMITS.
- 20. TREE REMOVAL, TREE PROTECTION, OR TREE ROOT PRUNING IS NOT ANTICIPATED FOR THIS PROJECT DUE TO NO ESTABLISHED TREES WITHIN THE CONSTRUCTION LIMITS.
- 21. TEMPORARY VERTICAL SHIELDING AND CATCHES SHALL BE PROVIDED ON THE STATE STREET BRIDGE TO ELIMINATE DEBRIS IN THE FOX RIVER DURING CONSTRUCTION. ALL TEMPORARY CATCHES SHALL MAINTAIN EXISTING VERTICAL UNDER CLEARANCE. TEMPORARY CATCHES SHALL BE CONTINUOUSLY INSPECTED AND CLEANED ON A DAILY BASIS. ANY DEBRIS SHALL BE IMMEDIATELY REMOVED. THE CONTRACTOR SHALL SUBMIT SIGNED AND SEALED CALCULATIONS AND SHOP DRAWINGS OF THE TEMPORARY VERTICAL SHIELDING TO THE ENGINEER FOR APPROVAL IN ACCORDANCE WITH THE SPECIFICATIONS.
- 22. SLOPES STEEPER THAN 3H:1V SHALL BE STABILIZED WITH APPROPRIATE MEASURES AS APPROVED BY THE ENGINEER.
- 23. EROSION CONTROL SHEET REFLECTS FINAL LANDSCAPING.
- 24. PERIMETER EROSION CONTROL BARRIER SHALL BE INSTALLED 1 FOOT FROM RIGHT-OF-WAY.

LEGEND

EROSION CONTROL BLANKET SEEDING CLASS 2A TOPSOIL EXCAVATION AND PLACEMENT (6" MINIMUM)



CONCRETE PAVER SIDEWALK



INLET AND PIPE PROTECTION
PERIMETER EROSION BARRIER

■ BOLLARDS

=

EXISTING BARRIER WITH
PROPOSED ORNAMENTAL RAILING
AND ARCHITECTURAL PRECAST
CONCRETE PANEL

SHRUBS

PAVING BRICK SIDEWALK

INLET FILTER

Michael Baker


	USER NAME = Jrooke	DESIGNED JBR	REVISED	
ı		DRAWN AJV	REVISED -	
ı	PLOT SCALE = 30.00000 ' / in-	CHECKED ITY	REVISED	
	PLOT DATE = 10/20/2015	DATE 10/21/2015	REVISED	


STATE OF ILLINOIS
DEPARTMENT OF TRANSPORTATION


STATE STREET BRIDGE ENHANCEMENT PROJECT EROSION CONTROL PLAN

SCALE: 1" = 30' | SHEET NO. 1 OF 1 SHEETS | STA. 11+42.16 TO STA. 18+57.27


F.A.U. RTE. 1343	SEC	TION		COUNT	Y	TOTAL	SHE
1343	13-0004	13-00-BF	3	KANE		65	15
JOB N	O. C-91-2	86-13		CONT	RACT	NO.	61C1
FED. RO	AD DIST. NO. 1	ILLINOIS	FED. AID	PROJECT:	TE-00	01(927)	

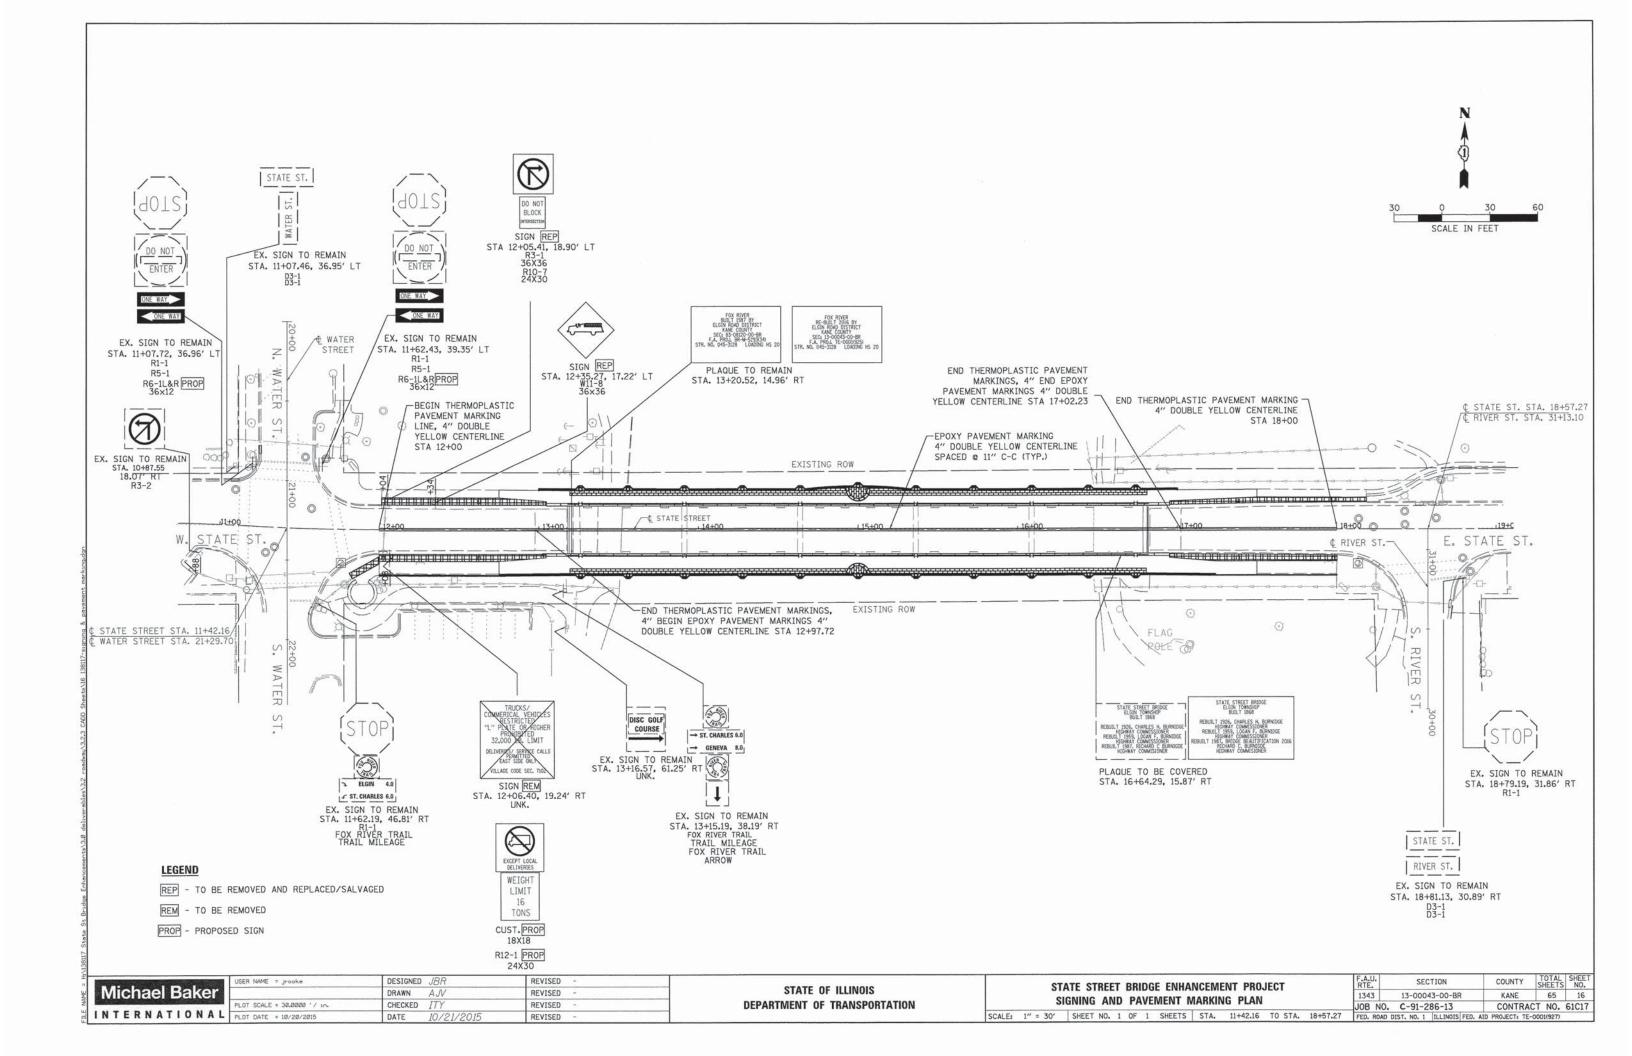

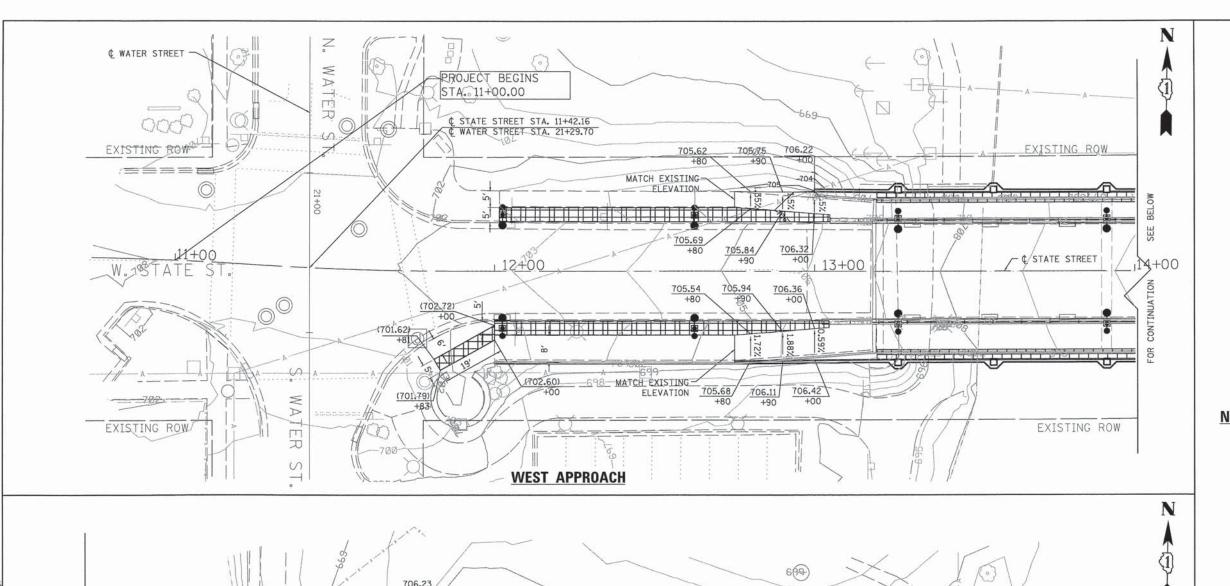

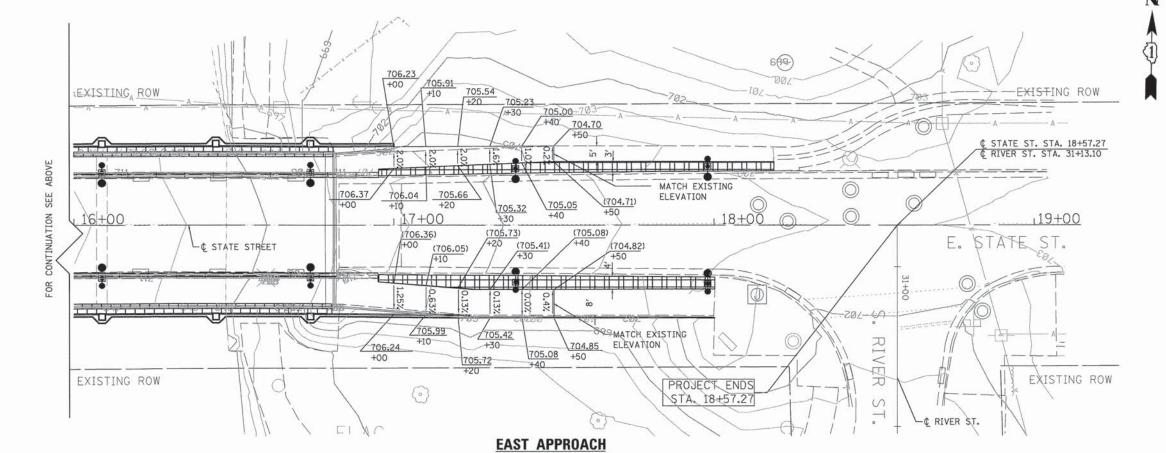

ROADWAY GRADING LEGEND

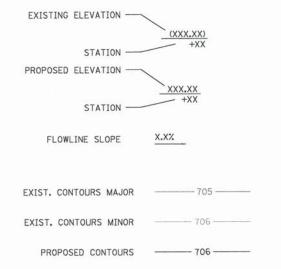


NOTES

- CONTRACTOR SHALL VERIFY EXISTING ELEVATIONS PRIOR TO CONSTRUCTION.
- 2. THE HIGH POINT IS LOCATED AT STA 15+00. THE LOW POINT IS LOCATED AT STA 11+40 AND 18+40.
- REFER TO PROPOSED PLAN FOR MORE INFORMATION.
- REFER TO CROSS SECTIONS FOR SIDEWALK AND PAVER SLOPES.


0 15 30 SCALE IN FEET

W. In Indian	USER NAME = Jrooke	DESIGNED JBR	REVISED -	CTATE OF ILLINOIS	STATE STREET BRIDGE ENHANCEMENT PROJECT	F.A.U. RTE.	SECTION	COUNTY	TOTAL	SHEET NO.
Michael Baker		DRAWN AJV	REVISED -	STATE OF ILLINOIS	ROADWAY GRADING DETAIL	1343	13-00043-00-BR	KANE	65	17
	PLOT SCALE = 15.0000 '/ in.	CHECKED ITY	REVISED -	DEPARTMENT OF TRANSPORTATION	IIOADWAT GIIADIIG DETAIL	JOB NO	. C-91-286-13	CONTRA	ACT NO. 6	61C17
INTERNATIONAL	PLOT DATE = 10/20/2015	DATE 10/21/2015	REVISED -		SCALE: 1" = 15' SHEET NO. 1 OF 1 SHEETS STA. 11+42-16 TO STA. 18+57.27	FED. ROAD	DIST. NO. 1 ILLINOIS FED.	AID PROJECT: TF	E-00D1(927)	

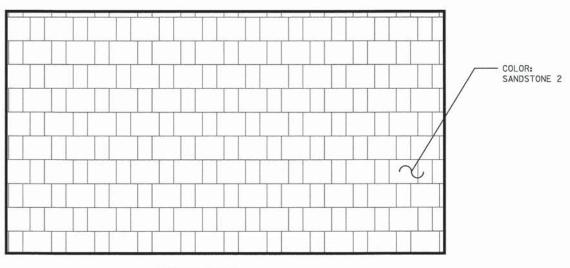

33% HALF STONE 67% STANDARD

CONCRETE PAVER SIDEWALK DETAIL LAYING PATTERN

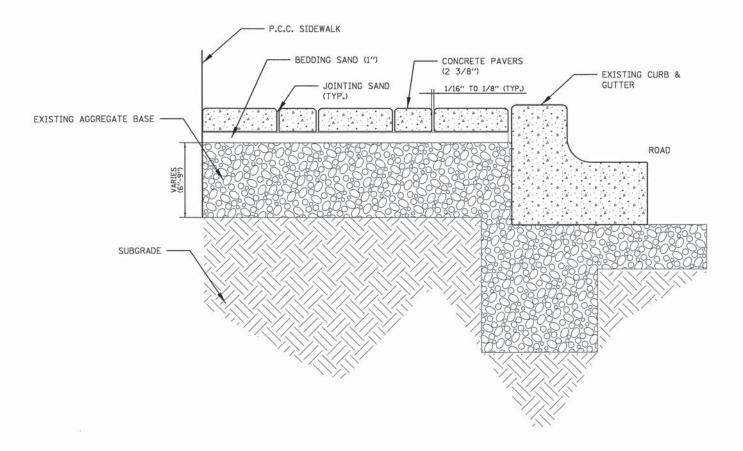

CONCRETE PAVER SIDEWALK DETAIL CROSS SECTION

STATE OF ILLINOIS DEPARTMENT OF TRANSPORTATION

COUNTY TOTAL SHEETS NO.

KANE 65 18

CONTRACT NO. 61C17

NOTES:

- CONCRETE PAVER LAYING PATTERN SHALL MATCH THE EXISTING PAVERS FROM THE EAST APPROACH OF THE STATE STREET BRIDGE.
- ALL MATERIAL LAYERS AND INSTALLATION FOR "CONCRETE PAVERS SIDEWALK" SHALL BE INCLUDED IN THE ITEM. THE PAVERS SHALL BE INSTALLED PER THE MANUFACTURER AT THE APPROVAL OF THE ENGINEER.
- 3. SEE SPECIAL PROVISION CONCRETE PAVERS SIDEWALK FOR MORE DETAILS.

INDEX OF DRAWINGS

DWG. NO.	SHEET NAME						
E-01	INDEX, LIGHTING NOTES AND LEGEND						
E-02	ROADWAY LIGHTING AND REMOVAL PLAN						
E-03	LIGHTING FOUNDATION AND CONDUIT PLAN						
E-04	ROADWAY LIGHTING AND CABLE PLAN						
E-05	LIGHTING DETAILS						
E-06	WIRING DIAGRAM						

GENERAL FLECTRICAL NOTES

- ELECTRICAL WORK MUST CONFORM TO THE LATEST NATIONAL, STATE, AND LOCAL CODES.
- CONTRACTOR WILL FIELD VERIFY EXACT LOCATIONS, QUANTITIES, AND TYPE OF UTILITIES IN AREAS TO BE EXCAVATED PRIOR TO COMMENCEMENT OF ANY WORK AND WILL HAND EXCAVATE AS REQUIRED IN ORDER TO NOT INTERRUPT ANY EXISTING UTILITIES (PUBLIC OR PRIVATE) OCCURS. CONTRACTOR WILL NOTIFY UTILITY IMMEDIATELY AND PAY ANY COST INCURRED FOR REPAIR OR REPLACEMENT OF SUCH DAMAGE.
- 3. ELECTRICAL EQUIPMENT, RACEWAY, ETC. ARE SHOWN IN APPROXIMATE LOCATIONS ONLY, CONTRACTOR WILL INSTALL ELECTRICAL EQUIPMENT, RACEWAYS, ETC. WHERE DIRECTED BY THE ENGINEER IN ORDER TO BEST SUIT JOB CONDITIONS.
- 4. CONDUIT MUST BE PUSHED UNDER ROADWAYS, DRIVEWAYS AND SIDEWALKS AS DIRECTED BY THE ENGINEER, CONDUIT MUST BE PUSHED PAST TREES IF THE ENGINEER DETERMINES THAT TRENCHING MAY HARM THE TREES. ALL OTHER CONDUIT MAY BE INSTALLED BY ANY METHOD APPROVED BY THE ENGINEER, AT NO ADDITIONAL COST TO THE CONTRACT.
- 5. THE CONTRACTOR SHALL CONTACT THE CITY OF SOUTH ELGIN PUBLIC WORKS AND ELECTRICAL UTILITY DEPARTMENTS AT LEAST 5 WORKING DAYS PRIOR TO COMMENCING ANY WORK.
- 6. ALL POLE BASES SHALL BE FRANGIBLE WITH AASHTO AND FHWA BREAKAWAY COUPLINGS WITH ALUMINUM SKIRTS. POLE BASE REQUIREMENTS SHALL BE IN ACCORDANCE WITH IDOT BUREAU OF DESIGN AND ENVIRONMENTAL MANUAL, CHAPTER FIFTY-SIX, HIGHWAY LIGHTING, LATEST EDITION.
- 7. ALL ELECTRICAL WORK PREFORMED AND INSTALLED ON STATE RIGHT-OF-WAY SHALL COMPLY WITH THE APPLICABLE REQUIREMENTS OF ILLINOIS DEPARTMENT OF TRANSPORTATION. DISTRICT 1. GENERAL GUIDELINES FOR LIGHTING DESIGN.
- 8. THE CONTRACTOR SHALL COORDINATE ALL ELECTRICAL SERVICE WITH COMMONWEALTH EDISON COMPANY, MRS, DARLENE CRAMMER, 860 OAK CREEK DRIVE, ELMHURST, IL 60126, 630-396-8220

SUMMARY OF QUANTITIES

CODE NO.	ITEM	UNIT	TOTAL QUANTITIES
80400100	ELECTRIC SERVICE INSTALLATION	EACH	1
80400200	ELECTRIC UTILITY SERVICE CONNECTION	LSUM	1
81028200	UNDERGROUND CONDUIT, GALVANIZED STEEL, 2" DIA.	FOOT	70
81028350	UNDERGROUND CONDUIT, PVC, 2" DIA.	FOOT	555
81100605	CONDUIT ATTACHED TO STRUCTURE, 2" DIA PVC COATED GALVANIZED STEEL	FOOT	470
81300550	JUNCTION BOX, STAINLESS STEEL, ATTACHED TO STRUCTURE,12" X 12" X 6"	EACH	4
81300980	JUNCTION BOX, STAINLESS STEEL, EMBEDDED IN STRUCTURE, 8" X 8" X 6"	EACH	6
81400730	HANDHOLE, COMPOSITE CONCRETE	EACH	1
81702140	ELECTRIC CABLE IN CONDUIT, 600V (XLP-TYPE USE) 1/C NO 4	FOOT	4,925
82500330	LIGHTING CONTROLLER, PEDESTAL MOUNTED, 240VOLT, 60AMP	EACH	1
83600200	LIGHT POLE FOUNDATION, 24" DIAMETER	FOOT	42
X8360215	LIGHT POLE FOUNDATION, 24" DIAMETER, OFFSET	FOOT	9
84200600	REMOVAL OF LIGHTING UNIT, NO SALVAGE	EACH	5
XX008477	STREET LIGHT ASSEMBLY, COMPLETE	EACH	20

CONSTRUCTION NOTES

- 1. ALL UNDERGROUND CONDUIT SHALL BE A MINIMUM 30" BELOW GRADE TO TOP OF DUCT.
- 2. ALL CONDUIT CROSSING DRIVEWAYS OR ROADWAYS WILL BE RIGID GALVANIZED STEEL. ALL OTHER CONDUIT SHALL BE EPC-40 PVC.
- 3. THE GROUND CONDUCTOR WILL HAVE NO SPLICE OR KINKS BELOW GRADE, IT SHALL BE SOLIDLY CONNECTED TO TO THE GROUNDING LUG OF EACH POLE AND TO THE GROUND AT THE SERVICE INSTALLATION.
- 4. ALL GROUND CONDUCTOR CONNECTIONS TO GROUND RODS SHALL BE MADE WITH AN EXOTHERMIC WELD.
- 5. ALL POLES, AESTHETIC LIGHTING UNITS AND THE STREET LIGHT CONTROLLERS WILL BE CONNECTED TO A CONTINUOS GROUND CONSISTING OF A GREEN INSULATED ELECTRICAL CONDUCTOR 600V. XLP (SIZE AS INDICATED ON THE PLANS). THIS CONDUCTOR WILL BE PLACED INSIDE THE CONDUIT DUCT ALONG WITH THE INSULATED CABLES.
- 6. SUFFICIENT LENGTH OF ELECTRICAL CONDUCTOR WILL BE COILED IN LIGHT STANDARDS TO PROVIDED ADEQUATE SLACK SO THAT ELECTRICAL CONDUCTOR MAY BE PULLED OUT 18" FOR THE INSPECTION. SAID SLACK WILL BE NEATLY COILED AND PLACED IN LIGHT STANDARDS.
- ALL CIRCUITS WILL BE 2-1/C *4 AND 1-1/C *4 GROUND (GREEN) INSULATED IN 2" PVC AND 2" RGS CONDUIT, UNLESS OTHERWISE NOTED.
- 8. ALL POLE STANDARD STATIONS AND OFFSETS SHOWN ARE FROM THE
- 9. ALL OF THE LUMINAIRES FOR THE PROPOSED LIGHTING SHALL BE INSTALLED AT THE MOUNTING HEIGHT OF 18'-0" (ROADWAY) AND 12'-0" (SIDEWALK).
- 10. ALL LUMINAIRES ARE 40 WATT, 120 VOLT, TYPE III, 4000 K, LED, ORNAMENTAL SOUTH ELGIN VILLAGE STANDARD PENDANT STYLE, UNLESS OTHERWISE NOTED ON THE PLANS.
- 11. COORDINATE THE LIGHT POLE FOUNDATION, 24" DIAMETER, OFFSET WITH THE GROUND MOUNT LIGHTING ASSEMBLY BASE PLATE BOLT CIRCLE


IDOT STANDARD DETAILS

DWG. NO.	SHEET NAME
812001	RACEWAY EMBEDDED IN STRUCTURE (SHT. 2 OF 3)
814001-03	HANDHOLES (CONCRETE COMPOSITE)
325011-03	LIGHTING CONTROLLER PEDESTAL MOUNTED, 240V
336001-02	LIGHT POLE FOUNDATION

DISTRICT 1 STANDARDS DETAILS

DWG. NO.	SHEET NAME
BE-310	LIGHT POLE FOUNDATION OFFSET

SYMBOL LEGEND

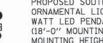

PROPOSED SOUTH ELGIN VILLAGE OF (47589) ORNAMENTAL LIGHTING STANDARD WITH 2-40 WATT LED PENDANT STYLE LUMINAIRES
(18'-0" MOUNTING HT.-ROADWAY AND 12'-0" MOUNTING HEIGHT-SIDEWALK), WITH GFCI RECEPTACLE AND BANNER ATTACHMENTS.



ORNAMENTAL LIGHTING STANDARD ID

- 1 DENOTES LIGHT POLE NO. A - DENOTES LIGHTING CIRCUIT
- E1 DENOTES LIGHTING CONTROLLER

EXISTING LIGHT POLE WITH 6' DAVIT STYLE MAST ARM AND COBRAHEAD LUMINAIRE. TO BE REMOVED

- PROPOSED 12" X 8" X 6" STAINLESS STEEL J JUNCTION BOX, SURFACE MOUNTED AT ABUTMENT WALLS.
- EXISTING 12" X 8" X 6" JUNCTION BOX, SURFACE MOUNTED AT ABUTMENT WALLS. TO BE REMOVED
- PROPOSED 24" X 30" COMPOSITE CONCRETE H



PROPOSED PEDESTAL MOUNTED SINGLE PHASE, 120/240V, 3W, 60A LIGHTING CONTROLLER

- PROPOSED 2" SCHEDULE 40 CONDUIT IN TRENCH
- PROPOSED 2" RIGID GALVANIZED STEEL CONDUIT MOUNTED TO STRUCTURE
- PROPOSED 2" RIGID GALVANIZED STEEL CONDUIT PUSHED UNDER ROADWAY
- ---- PROPOSED 2" SCHEDULE 40 CONDUIT IN TRENCH
- ---- EXISTING CONDUIT TO BE ABANDONED
- EXISTING DUCT CABLE TO BE REMOVED


Michael Baker INTERNATIONAL

JSER NAME = Jrooke DESIGNED DF REVISED DRAWN REVISED CHECKED ITY LOT SCALE = 20.0000 '/ in REVISED PLOT DATE = 10/20/2015 DATE 10/21/2015 REVISED

STATE OF ILLINOIS DEPARTMENT OF TRANSPORTATION

STATE STREET BRIDGE ENHANCEMENT PROJECT LIGHTING NOTES AND LEGEND SHEET NO. 1 OF 5 SHEETS STA. N/A TO STA. N/A SCALE: N/A

COUNTY TOTAL SHEET NO. SECTION KANE 65 19 1343 13-00043-00-BR CONTRACT NO. 61C17 JOB NO. C-91-286-13 FED. ROAD DIST. NO. 1 ILLINOIS FED. AID PROJECT: TE-00D1(927)

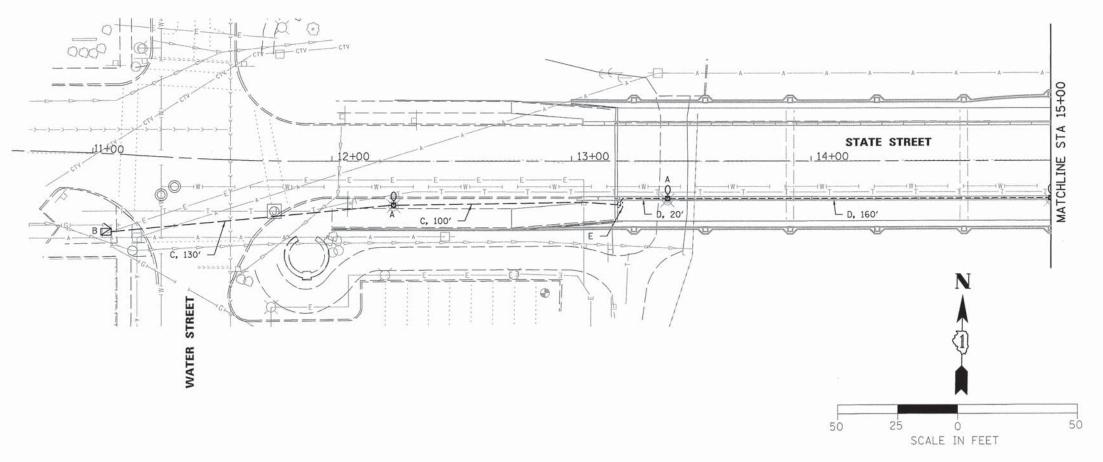


LEGEND

- "A" REMOVE EXISTING LIGHT POLE WITH DAVIT STYLE MAST ARM AND COBRAHEAD LUMINAIRE.
- "B" REMOVE EXISTING LIGHTING CONTROLLER, CONTROLLER FOUNDATION TO BE RE-USED.
- "C" REMOVE EXISTING UNIT DUCT CABLE.
- "D" REMOVE EXISTING CABLE, ABANDON CONDUIT IN BRIDGE PARAPET.
- "E" REMOVE EXISTING JUNCTION BOX AT ABUTMENT WALL.

NOTES:


 ALL EXISTING LIGHTING EQUIPMENT (LIGHT POLES, LUMINAIRES, BRACKET ARMS, WIRE, ETC.) WILL NOT BE SALVAGED.

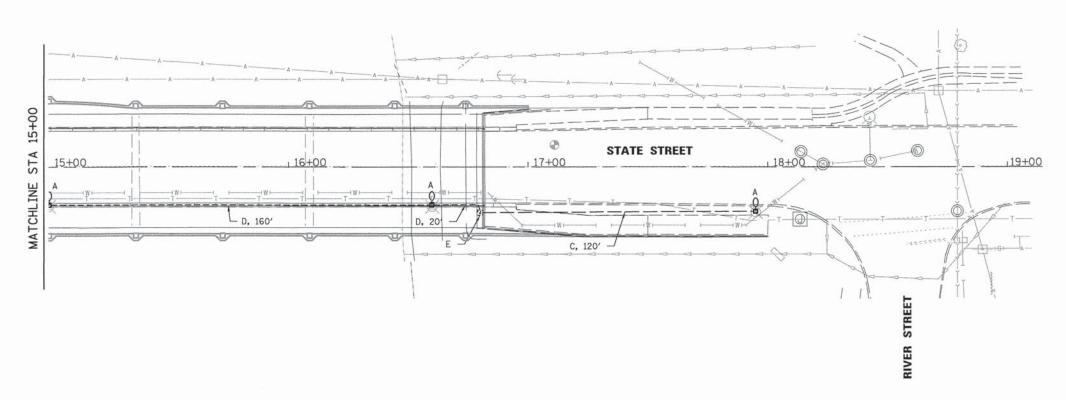

	USER NAME = Jrooke	DESIGNED DP	REVISED -	
Michael Baker		DRAWN AJV	REVISED -	
	PLOT SCALE = 20.0000 '/ in.	CHECKED ITY	REVISED -	
INTERNATIONAL	PLOT DATE = 10/20/2015	DATE 10/21/2015	REVISED -	

STATE OF ILLINOIS
DEPARTMENT OF TRANSPORTATION

	STATE STREET BRIDGE ENHANCEMENT PROJECT												
	ROADWAY LIGHTING REMOVAL PLAN												
SCALE:	1"	=	40'	SHEET	NO.	2	OF	5	SHEETS	STA.	11+42.16	TO STA.	18+57.27

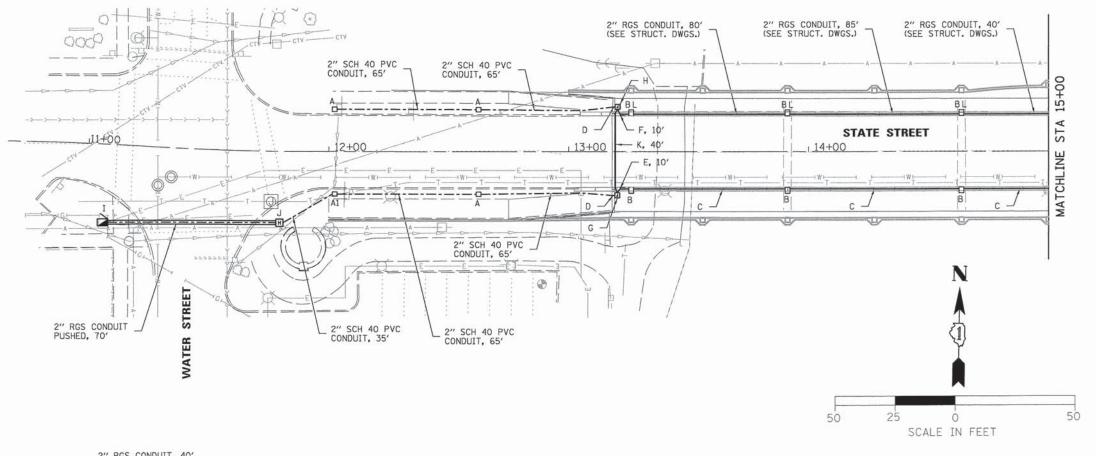

2" RGS CONDUIT, 40' (SEE STRUCT. DWGS.) 2" RGS CONDUIT, 80' (SEE STRUCT, DWGS.) 2" SCH 40 PVC 2" RGS CONDUIT, 85' 2" SCH 40 PVC (SEE STRUCT. DWGS.) CONDUIT, 65' CONDUIT, 65' 0 STATE STREET V 17+00 18+00 19+00 5+00 16+00 2" SCH 40 PVC 2" SCH 40 PVC CONDUIT, 65' CONDUIT, 65'

LEGEND

- "A" INSTALL IDOT STANDARD 836001-02 LIGHT POLE FOUNDATION FOR THE VILLAGE OF SOUTH ELGIN (47589) GROUND MOUNTED LIGHTING STANDARD. 3'-0" OFFSET FROM FACE OF CURB, UNLESS OTHERWISE NOTED.
- "A1" INSTALL IDOT DISTRICT 1 STANDARD BE-310 LIGHT POLE FOUNDATION OFFSET FOR THE VILLAGE OF SOUTH ELGIN (47589) GROUND MOUNTED LIGHTING STANDARD. 3'-0" OFFSET FROM FACE OF CURB, UNLESS OTHERWISE NOTED.
- "B" LIGHTING FOUNDATION FOR THE VILLAGE OF SOUTH ELGIN (47589) BRIDGE MOUNTED LIGHTING STANDARD. SEE STRUCTURAL DRAWINGS FOR LIGHTING FOUNDATION DETAILS.
- "C" EXISTING LIGHTING CONDUIT IN BRIDGE PARAPET TO REMAIN. REMOVE EXISTING WIRES, CLEAN CONDUIT AND INSTALL NEW WIRES AS SHOWN ON LIGHTING AND CABLE PLAN. SEE STRUCTURAL DRAWINGS FOR NEW JUNCTION BOX INSTALLATION AT EACH LIGHTING BLISTER LOCATION.
- "D" INSTALL 10' X 2" STAINLESS STEEL CONDUIT THROUGH EXISTING ABUTMENT WALL, EXTEND CONDUIT INTO NEW JUNCTION BOX AT BRIDGE ABUTMENT WALL, SEE STANDARD DETAIL 812001.
- "E" INSTALL 2" RGS CONDUIT FROM JUNCTION BOX AT ABUTMENT WALL TO EXISTING JUNCTION BOX IN BRIDGE PARAPET (SEE STRUCTURAL DRAWINGS). SEE STANDARD DETAIL 812001, SIMILAR.
- "F" INSTALL 2" RGS CONDUIT FROM JUNCTION BOX AT ABUTMENT WALL, ACROSS UNDERSIDE OF BRIDGE, ROUTED TO JUNCTION BOX IN BRIDGE BARRIER AT EACH LIGHTING BLISTER LOCATION. SEE ITEM "L", SEE STANDARD DETAIL 812001, SIMILAR.
- "G" REMOVE EXISTING JUNCTION BOX AT ABUTMENT WALL, INSTALL NEW 12" X 12" X 6" STAINLESS STEEL JUNCTION BOX, RE-ROUTE CONDUIT AND MAINTAIN EXISTING CIRCUITRY AS REQUIRED. SEE ITEMS "D", "E" AND "L".
- "H" INSTALL NEW 12" X 12" X 6" STAINLESS STEEL JUNCTION BOX, ROUTE CONDUIT AS REQUIRED. SEE ITEMS "D". "E" AND "L".
- "I" EXISTING CONCRETE LIGHTING CONTROLLER FOUNDATION TO REMAIN.
- "J" INSTALL 24" COMPOSITE CONCRETE HANDHOLE
 AS PER IDOT STANDARD DRAWING NO. 8140 PVC01-03.
- "K" INSTALL 2" RIGID GALVANIZED STEEL CONDUIT AT ABUTMENT WALL. SEE ITEMS "G" AND "H".
- "L" INSTALL NEW 8" X 8" X 6" STAINLESS STEEL JUNCTION BOX IN BRIDGE BARRIER AT EACH LIGHTING BLISTER LOCATION, ROUTE 2" RGS CONDUIT INTO BOX TO ACCOMMODATE LIGHTING CIRCUIT CONNECTIONS.


STATE OF ILLINOIS
DEPARTMENT OF TRANSPORTATION

STATE STREET BRIDGE ENHANCEMENT PROJECT LIGHTING FOUNDATION AND CONDUIT PLAN


F.A.U. SECTION COUNTY TOTAL SHEETS NO. 1343 13-00043-00-BR KANE 65 21 JOB NO. C-91-286-13 CONTRACT NO. 61C17


Michael Baker

SCALE: 1" = 40' SHEET NO. 3 OF 5 SHEETS STA. 11+42.16 TO STA. 18+57.27 FED. ROAD DIST. NO. 1 | ILLINOIS FED. AID PROJECT: TE-ODDI927)

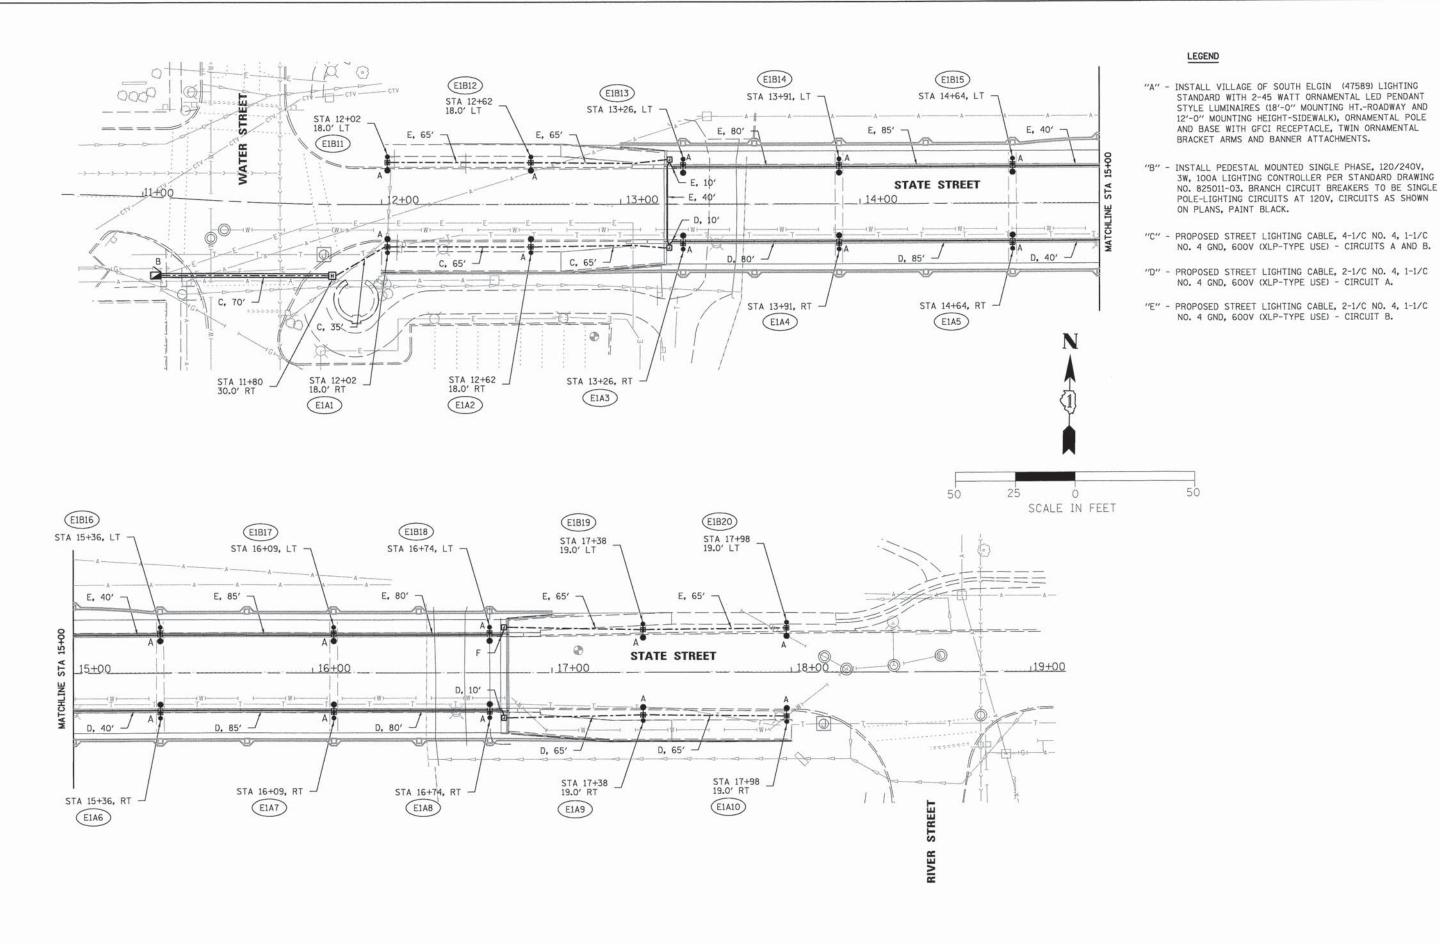

SECTION COUNTY DESIGNED/DF REVISED STATE STREET BRIDGE ENHANCEMENT PROJECT Michael Baker STATE OF ILLINOIS DRAWN AJV REVISED 1343 13-00043-00-BR KANE 65 22 ROADWAY LIGHTING AND CABLE PLAN CHECKED ITY REVISED DEPARTMENT OF TRANSPORTATION CONTRACT NO. 61C17 JOB NO. C-91-286-13 LOT SCALE = 20.0000 '/ in INTERNATIONAL PLOT DATE = 10/20/2015 SCALE: 1" = 50' SHEET NO. 4 OF 5 SHEETS STA. 11+42.16 TO STA. 18+57.27 FED. ROAD DIST. NO. 1 | ILLINOIS FED. AID PROJECT: TE-OOD1/927 DATE 10/21/20 REVISED

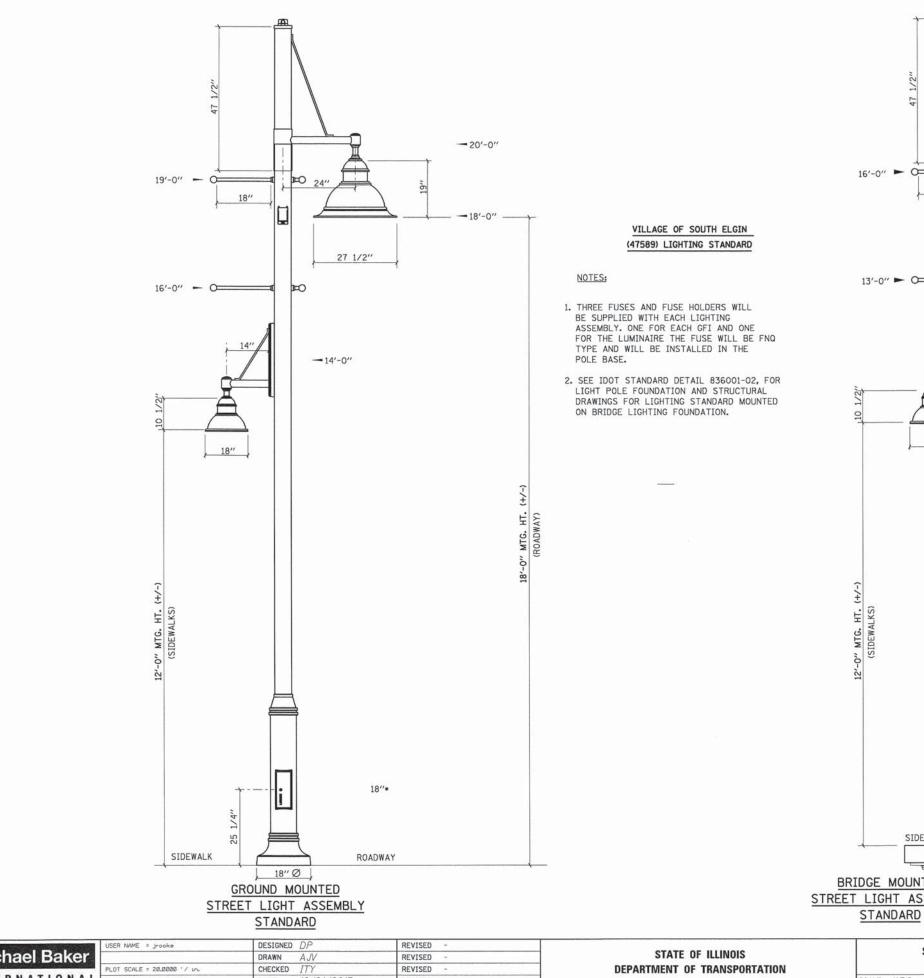

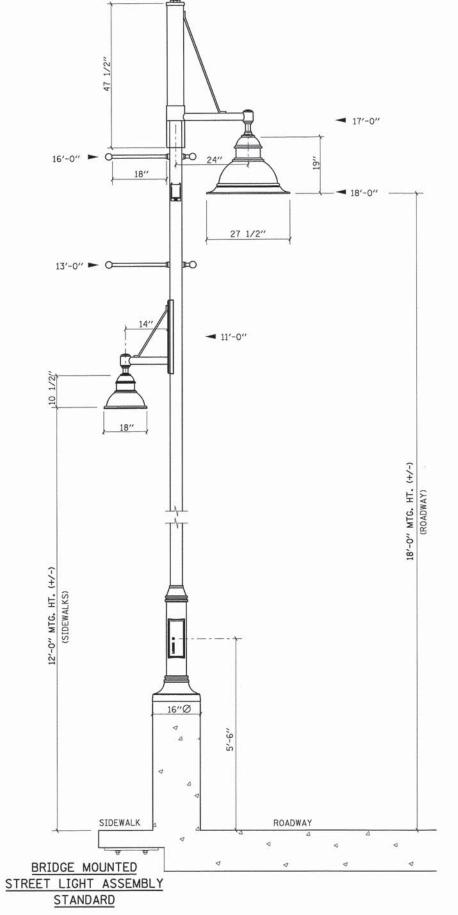


Michael Baker INTERNATIONAL PLOT DATE = 10/20/2015

DATE 10/21/2015 REVISED

STATE STREET BRIDGE ENHANCEMENT PROJECT LIGHTING DETAILS SHEET NO. 5 OF 5 SHEETS STA. N/A TO STA. N/A

COUNTY TOTAL SHEET NO. KANE 65 23 SECTION COUNTY 1343 13-00043-00-BR JOB NO. C-91-286-13 CONTRACT NO. FED. ROAD DIST. NO. 1 ILLINOIS FED. AID PROJECT: TE-00D1(927) CONTRACT NO. 61C17

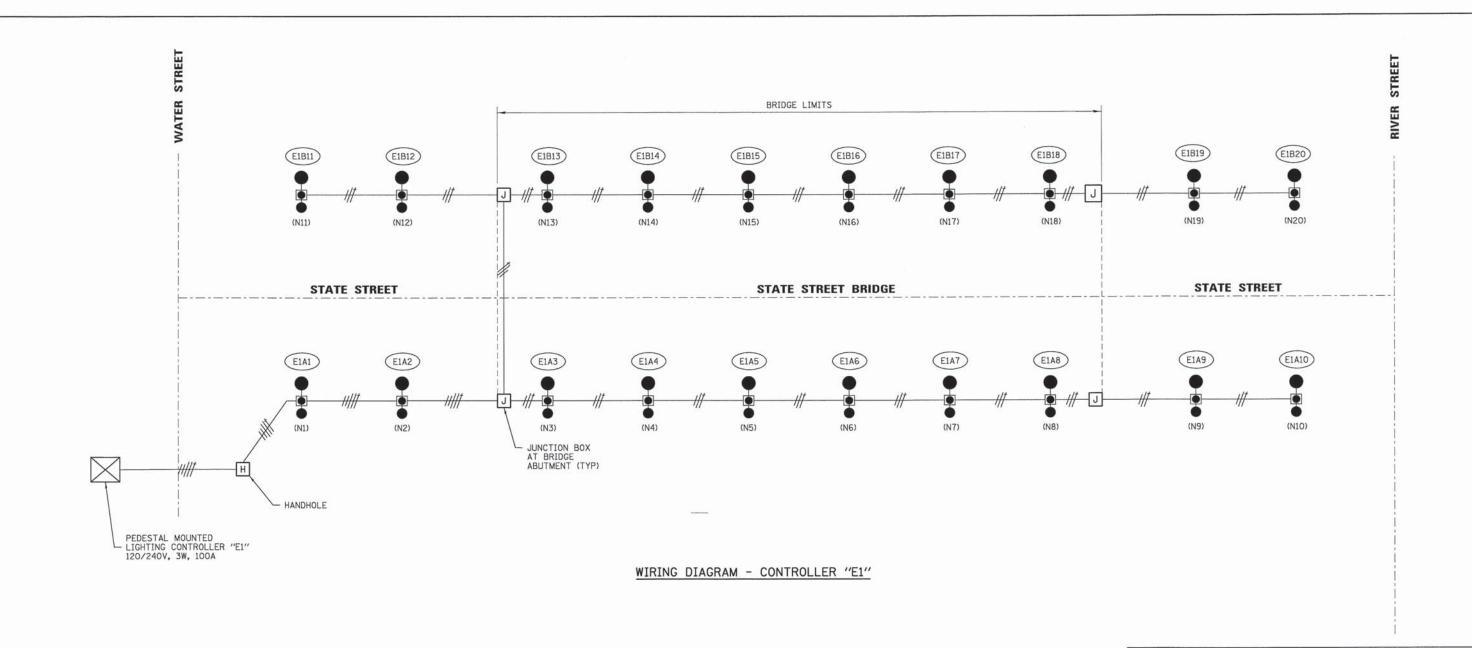



ELECTRICAL SYMBOL LEGEND

DESIGNED DP REVISED STATE STREET BRIDGE ENHANCEMENT PROJECT STATE OF ILLINOIS Michael Baker DRAWN AJV REVISED 13-00043-00-BR KANE 65 24 WIRING DIAGRAM CONTRACT NO. 61C17 DEPARTMENT OF TRANSPORTATION CHECKED ITY REVISED JOB NO. C-91-286-13 INTERNATIONAL SHEET NO. 5 OF 5 SHEETS STA. N/A TO STA. N/A PLOT DATE = 10/20/2015 DATE 10/21/2015 REVISED FED. ROAD DIST. NO. 1 | ILLINOIS FED. AID PROJECT: TE-OOD1(92

Benchmark: Chiseled "SO" on the Northwest corner of the West approach slab of the State Street Bridge.

Existing Structure: S.N. 045-3128 was built in 1988 as F.A. Urban Route 1343 County Section 83-01820-00 BR at Sta. 15+00

Existing structure consists of a five span reinforced concrete deck with span lengths of $71' - 5^1_2$ " for the outer most spans and 72' - 6" inner three spans. The 7^1_2 " thick reinforced concrete deck with no overlay is supported on six lines of 48" deep prestressed concrete I-beams spaced 8' - 5" on center. The substructure consists of four hammerhead type piers supported on spread footings and stub abutments supported on steel piles. The structure is 366' - 0" from back to back of abutments with an out-to-out deck width of 48' - 2" with no skew. The bridge deck consists of two 12' - 0" traffic lanes and two 3' - 0" shoulders flanked by two 1' - 7" wide concrete parapets. The deck consists of 5' - 0" and 8' - 0" sidewalks with metal railing along the north edge and south edge of bridge, respectively. The bridge deck will be widened to increase the width of the sidewalks. Traffic will be maintained using staged construction.

71'-51/2"

Trucks are restricted from traveling on sidewalk. Sidewalk overhangs are designed for pedestrian traffic only.

- & W. Abut.

FOX RIVER
RE-BUILT 2016 BY
ELGIN ROAD DISTRICT
KANE COUNTY
SEC. 13-00043-00-BR
F.A. PROJ. TE-00D(927)
STR. NO. 045-3128 LOADING HS 20

NAME PLATE

71'-51/2"

- C Pier 4

See Std. 515001

STATE STREET BRIDGE ELGIN TOWNSHIP BUILT 1868

REBUILT 1926, CHARLES H. BURNIDGE HIGHWAY COMMISSIONER REBUILT 1959, LOGAN F. BURNIDGE HIGHWAY COMMISSIONER REBUILT 1987, BRIDGE BEAUTIFICATION 2016 RICHARD C. BURNIDGE HIGHWAY COMMISSIONER

NAME PLATE

See Std. 515001

LOADING HS20-44

Allow 25#/Sq. ft. for future wearing surface.

DESIGN SPECIFICATIONS

2002 AASHTO Standard Specifications For Highway Bridges, 17th Edition

DESIGN STRESSES

FIELD UNITS (NEW CONSTRUCTION)

f'c = 3,500 psi

fy = 60,000 psi (Reinforcement)

FIELD UNITS (EXIST. CONSTRUCTION)


f'c = 3,500 psi

fy = 60,000 psi (Reinforcement)

f'c = 5,000 psi (Prestressed Beams)

f'ci = 4,000 psi (Prestressed Beams) f'si = 189,000 psi (Prestressed Strands)

fs = 270,000 psi (Prestressed Strands)

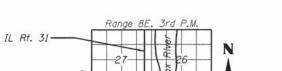





Proposed Location

PROFILE GRADE

DENNIS F. MORGAN MORGAN EXPIRES 11/2016

GENERAL PLAN AND ELEVATION STATE ST. OVER FOX RIVER "PUBLIC WATER"

F.A. URBAN ROUTE 1343 COUNTY SECTION 13-00043-00 BR FOR RIVER BRIDGE - MAIN

KANE COUNTY

STATION 15+00

<u>STRUCTURE NO. 045-3128</u>

Proposed Concrete Bollards between Railing (typ.)	Design H.W. — (50 Yr.) Elev. 698.94	Proposed Parape Steel Railing on Exist, Conc. Parapet	Parapet Mount Lig 22' Ht., 10'2" Boh Place at Abuts. & at & Piers —3'-4" min.		Low Chord Elev. 702.
Elev. 695.5 Berm Elev. 700.7 Proposed Architectural Rustil Elev. 698.19		d Elev. 691.00± GENERAL EL		Elev. 695.5 Berm Elev. 700.7 Elev. 698.19	

72'-6"

- © Pier 3

72'-6"

- @ Pier 2

72'-6"

← @ Pier 1

10'-(ewalk		I - \\	366	6'-0" Back-to-Back of Abutm	ents		4	Å	
sid	2'-91/2"	71'-51/2"	72'-6"	72'-6"	72'-6"	71'-51/2" :		Ÿ	
8'-0		Span 1	Span 2	Span 3	Span 4	Span 5			
Propose	NW Wingwall —		1'-7" Existing Conc. Pa	rapet -	→	→	E		
Vari	Trier		h .	I A	B 12" Railing		D_NE Wingwall		
	SNI 3			5 0			=-1=	5	
I5' WB Rdwy;	Lane	2" 1-to-0	92." -0ut	2" 2" E Pollar Pollar Bollar	← Ç Roadway	© Brg. E. Abut. Sta. 16+80.21 Elev. 707.15	♦ BSB-01 10 BBB		
15' EB Rdwy.	12' Lane	© Brg. W. Abut. 70 Sta. 13+19.79 'S Elev. 707.06	© Pier 1 Sta. 13+91.25 99 Elev. 709.91	£ Pier 2 + 50 of - 50	© Pier 3 Sta. 15+36.25 -> Elev. 711.36	© Pier 4 Sta. 16+08.75 Elev. 709.89	26 Pave		
	£ 2	2					8		+5
Jewalk S	SW Retaining Wall —	Proposed Lighting (typ.)		L ^A	∑ L ^B	L _s	D E	SE Retaining	
"0".	SW Wing Wall — BSB-02.	₹ (typ.) ₹	ارد بر	PLAN 6	اند ا	Abu	SE Wing Wall	Wall	
II pose		Ġi .			(an (ca)	JE mily man		
Pro									
						1			

WATERWAY INFORMATION

Drainage Area = 153	ainage Area = 1532 sq. mi.							Proposed Overtopping Elev. = 701.5 at Sta. 11+35				
Flood Event	Freq. Yr	. Discharge	Waterway Opening - ft²		Natural	Head - ft.		Headwater Elevation - ft.				
////1000 TONESTY	-	ft³/s	Existing	Proposed	H.W.E. ft.	Existing	Proposed	Existing	Proposed			
Design	30	9790	5594.5	5594.5	699.48	0.02	0.02	699.43	699.43			
Standard	50	11225	1196.8	5594.5	698.94	0.03	0.03	698.97	698.97			
Base	100	12250	5594.5	5594.5	699.38	0.03	0.03	699.31	699.31			
Scour Design Check												
Overtop Existing												
Overtop Proposed												
Max. Calc.	500	16875	5594.5	5594.5	700.72	0.27	0.27	700.81	700.81			

Michael Baker	B. Alte	1	Delen
	IVIIC	nae	i Baker

0

USER NAME =	DESIGNED - JMK	REVISED -	
	CHECKED - DFM	REVISED -	
PLOT SCALE =	DRAWN - EML	REVISED -	
PLOT DATE =	CHECKED - DFM	REVISED -	

STATE OF ILLINOIS
DEPARTMENT OF TRANSPORTATION

GENERAL PLAN AND ELEVATION
STATE STREET OVER FOX RIVER
STRUCTURE NO. 045–3128
SHEET NO. 1 OF 25 SHEETS

I	F.A.U. RTE. 1343	SECTION	COUNTY	TOTAL	SHEE NO.
I	1343	13-00043-00-BR	KANE	65	25
1	JOB NO. C-91-286-13		CONTRAC	T NO. 6	IC17
Ì	-0-4	ILLINOIS FED.	AID PROJECT: TE	-000(927)	

GENERAL NOTES

- 1. Reinforcement bars designated (E) shall be epoxy coated.
- 2. Plan dimensions and details relative to existing plans are subject to nominal construction variations. The Contractor shall field verify existing dimensions and details affecting new construction and make necessary approved adjustments prior to construction or ordering of materials. Such variations shall not be cause for additional compensation for a change in scope of the work, however, the Contractor will be paid for the quantity actually furnished at the unit price bid for the work. Existing Name Plate shall be cleaned and relocated next to new Name Plate. Cost included with Name Plates (Special) pay item.
- 3. Existing reinforcement shall be cleaned and incorporated into the new construction. Cost included with Concrete Removal pay item.
- 4. Any reinforcement bars that are damaged during concrete removal operations shall be repaired or replaced using approved bar splicer or anchorage system. Cost included in Concrete Removal
- 5. Lightweight aggregate shall be used in Concrete Superstructure.
- 6. The Illinois Department of Transportation is not the owner of record for this bridge. Those seeking historic as-built or other record plans should contact the owner of record. To make arrangements for access to this information please contact:

Megan Golden, Deputy Village Administrator Village of South Elgin 847-741-3894

INDEX OF SHEETS

S-01 General Plan and Elevation

S-02 General Notes, Sheet Index & Bill of Material

S-03 Cross Sections

S-04 Stage Construction and Removal Sequence I

S-05 Stage Construction and Removal Sequence II

S-06 Stage Construction and Removal Sequence III S-07 Stage Construction and Removal Sequence IV

S-08 Top of Deck Elevations

S-09 Superstructure Plan and Cross Sections I

S-10 Superstructure Plan and Cross Sections II

S-11 Lighting Details

S-12 Bridge Railing Details I

S-13 Bridge Railing Details II

S-14 Bridge Railing Details III

S-15 Bridge Railing Details IV S-16 Intermediate Diaphragms

S-17 Superstructure Details

S-18 Expansion Joint Details

S-19 NW Wingwall Details

S-20 NE Wingwall Details

S-21 SE Wingwall Details S-22 SW Wingwall Details

S-23 Substructure Details


S-24 Rustication Details

S-25 Overhang Forming Alternative for Superstructure

BILL OF MATERIAL


ITEM	UNIT	SUPER	SUB	TOTAL
CONCRETE REMOVAL	CU YD	135	5	140
CONCRETE STRUCTURES	CU YD		28	28
CONCRETE SUPERSTRUCTURE	CU YD	328	13	338
FORM LINER TEXTURED SURFACE	SQ FT		1491	1491
PROTECTIVE COAT	SQ YD	660		660
REINFORCEMENT BARS, EPOXY COATED	POUND	95210	2450	97660
BICYCLE RAILING	FOOT	693	277	970
PARAPET RAILING	FOOT	703		703
PREFORMED JOINT STRIP SEAL	FOOT	45		45
CONCRETE PAVER SIDEWALK	SQ YD	258		258
NAME PLATES (SPECIAL)	EACH	2		2
RAIL REMOVAL	FOOT	703		703
STAINING CONCRETE STRUCTURES	SQ FT	1384		1384
ARCHITECTURAL PRECAST CONCRETE PANEL	SQ FT	2780		2780
BOLLARDS	EACH	22		22

USER NAME =	DESIGNED - JMK	REVISED -	
	CHECKED - JRB	REVISED -	
PLOT SCALE =	DRAWN - EML	REVISED -	
PLOT DATE =	CHECKED - DFM	REVISED -	1220113

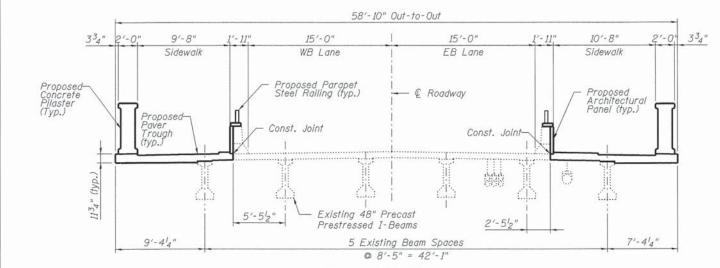


FINAL SECTION A-A

(Looking East)

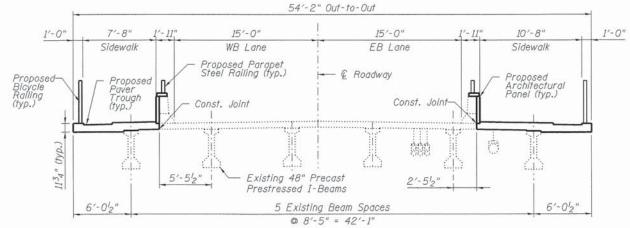

FINAL SECTION B-B


(Looking East)

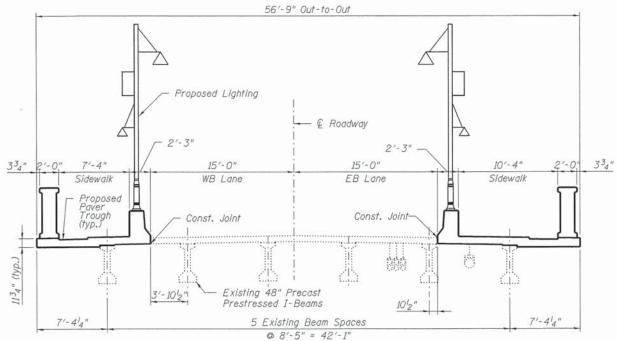

11'-0" 15'-0" 15'-0" 1'-0" 8'-0" Sidewalk EB Lane Sidewalk WB Lane Proposed Bicycle Railing (typ.) - © Roadway 0'-0" to 2'-5" max. 0'-0" to 2'-5" max. & Varies & Varies Proposed – Architectural Rustication Existing-Wingwall Existing Wingwall FINAL SECTION D-D (Looking East)

30'-0"

Clear Roadway Width

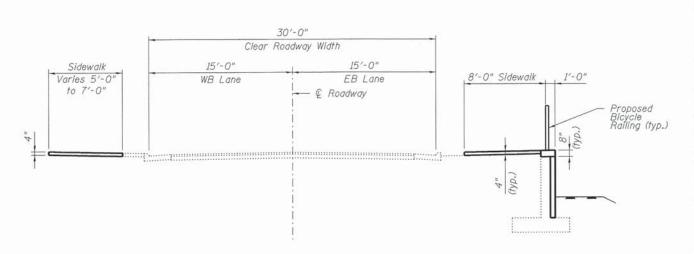

FINAL SECTION E-E

(Looking East)

FINAL SECTION C-C

	Looking	LUUII	
USER NAME =	DESIGNED - JMK	REVISED -	
	CHECKED - DFM	REVISED -	
PLOT SCALE =	DRAWN - EML	REVISED -	
PLOT DATE =	CHECKED - DFM	REVISED -	

Michael Baker

INTERNATIONAL

STATE OF ILLINOIS


DEPARTMENT OF TRANSPORTATION

CROSS SECTIONS
STATE STREET OVER FOX RIVER
STRUCTURE NO. 045–3128

SHEET NO. 3 OF 25 SHEETS


F.A.U. RTE.	SECTION	COUNTY	TOTAL	SHEET NO.
1343	13-00043-00-BR	KANE	65	27
JOB	NO. C-91-286-13	CONTRAC	T NO.	61C17
	ILLINOIS FED.	AID PROJECT: TE-	·00D(927)	

REVISED - STATE OF ILLINOIS

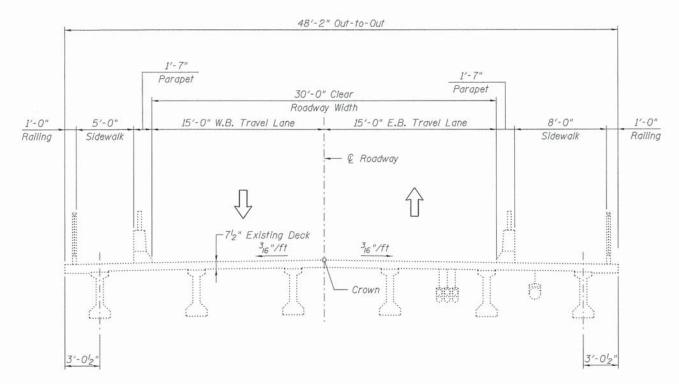


EXISTING SECTION

(Typical, Looking East)

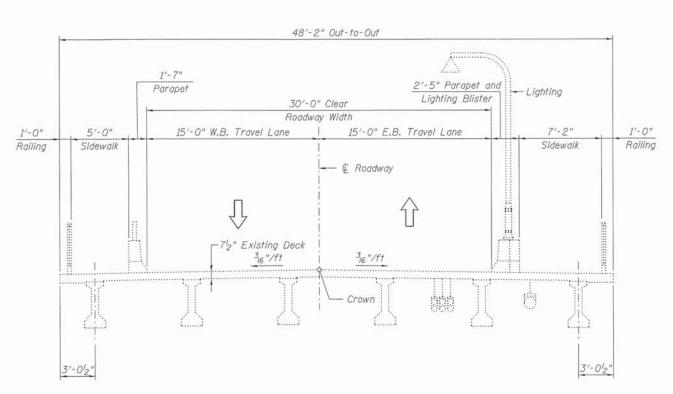


EXISTING SECTION

(At Lighting Detail, Looking East)

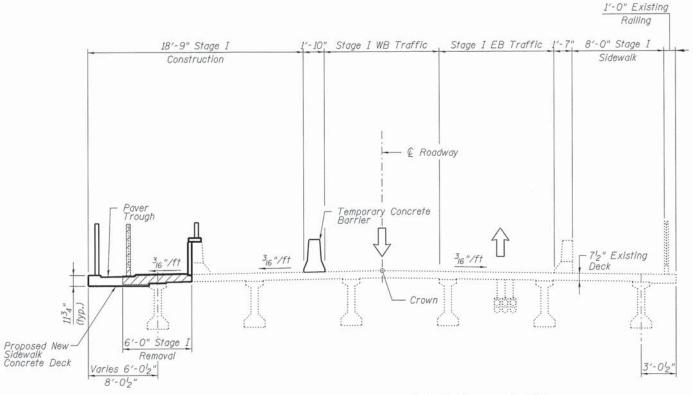

STAGE I CONSTRUCTION AND REMOVAL LIMITS

(Typical, Looking East)

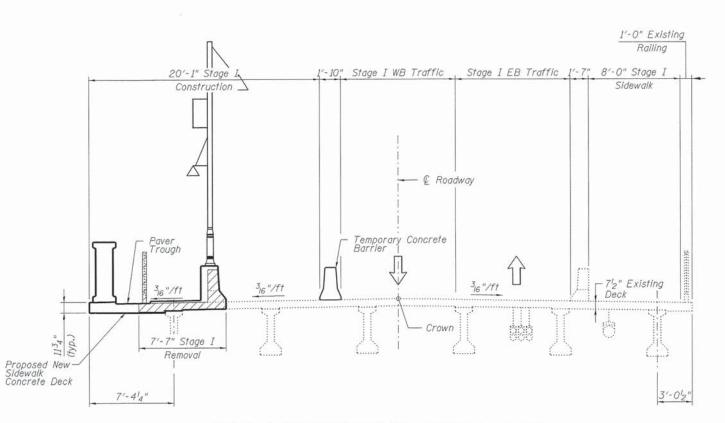

STAGE I CONSTRUCTION AND REMOVAL LIMITS

(At Proposed Lighting Detail, Looking East)

<u>Legend</u>

Removal


	USER NAME =
Michael Baker	
	PLOT SCALE =
INTERNATIONAL	PLOT DATE =

USER NAME =	DESIGNED - JMK	REVISED -	
	CHECKED - DFM	REVISED -	
PLOT SCALE =	DRAWN - EML	REVISED -	
PLOT DATE =	CHECKED - DFM	REVISED -	

STATE OF ILLINOIS DEPARTMENT OF TRANSPORTATION


STAGE	CONSTRUCTION AND REMOVAL SEQUENCE STATE STREET OVER FOX RIVER STRUCTURE NO. 045-3128	I
	SHEET NO. 4 OF 25 SHEETS	

.A.U.	SECTION	COUNTY	TOTAL	SHEET NO.	
343	13-00043-00-BR	KANE	65	28	
JOB	NO. C-91-286-13	CONTRAC	TRACT NO. 61C1		
	ILLINOIS FED.	AID PROJECT: TE	-00D(927)		

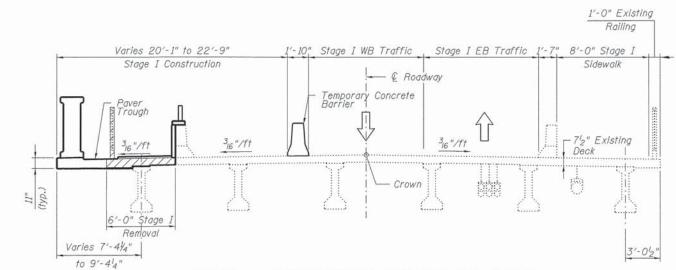


STAGE I - CONSTRUCTION AND REMOVAL LIMITS

(At Bollard, Looking East)

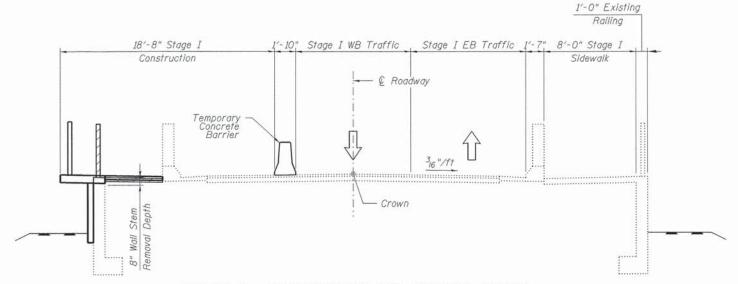


STAGE I - CONSTRUCTION AND REMOVAL LIMITS

(At NW Wingwall, Looking East)

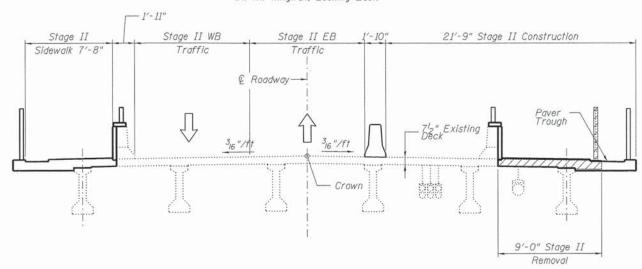


STAGE II - CONSTRUCTION AND REMOVAL LIMITS

(Typical, Looking East)

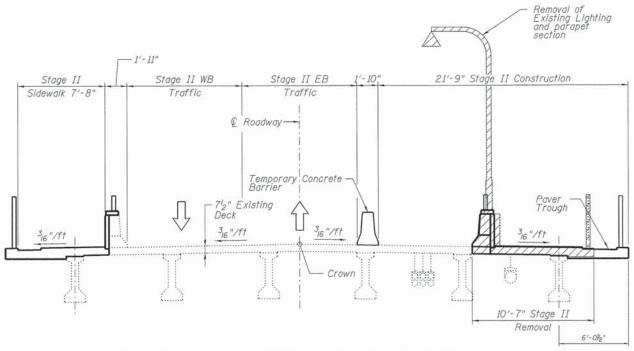

STAGE II - CONSTRUCTION AND REMOVAL LIMITS

(At Existing Lighting Detail, Looking East)

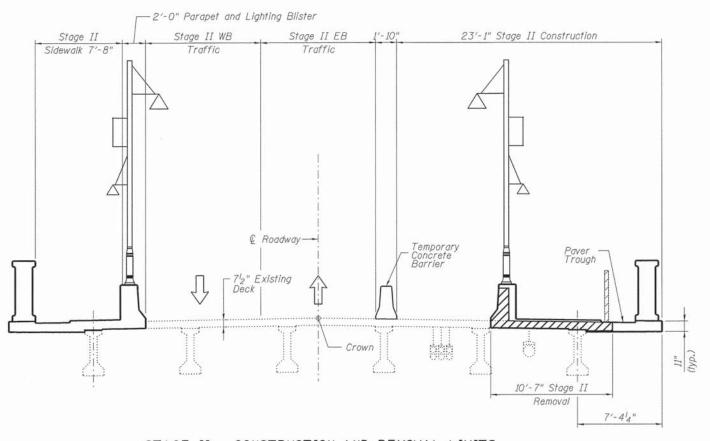

STAGE II - CONSTRUCTION AND REMOVAL LIMITS

(At Lighting Detail, Looking East)


Legend

| Removal

	USER NAME =	DESIGNED - JMK	REVISED -
Michael Baker		CHECKED - DFM	REVISED -
	PLOT SCALE =	DRAWN - EML	REVISED -
INTERNATIONAL	PLOT DATE =	CHECKED - DFM	REVISED -


STATE OF ILLINOIS
DEPARTMENT OF TRANSPORTATION

STAGE CONSTRUCTION AND REMOVAL SEQUENCE II STATE STREET OVER FOX RIVER STRUCTURE NO. 045–3128 SHEET NO. 5 OF 25 SHEETS F.A.U. SECTION COUNTY TOTAL SHEET'S NO. 1343 13-00043-00-BR KANE 65 29 JOB NO. C-91-286-13 CONTRACT NO. 61C17

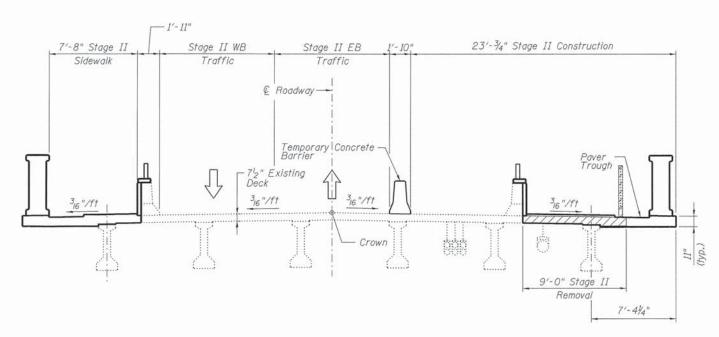


STAGE II - CONSTRUCTION AND REMOVAL LIMITS

(At Bollard, Looking East)

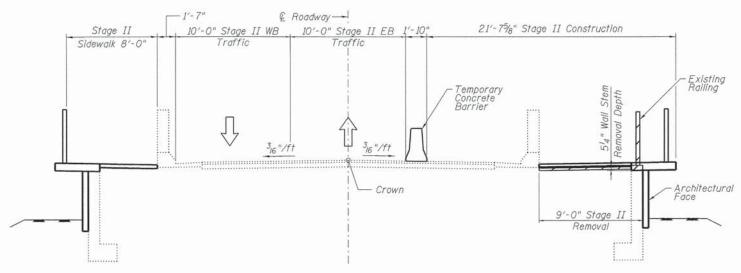

STAGE II - CONSTRUCTION AND REMOVAL LIMITS

(At SW Wingwall, Looking East)

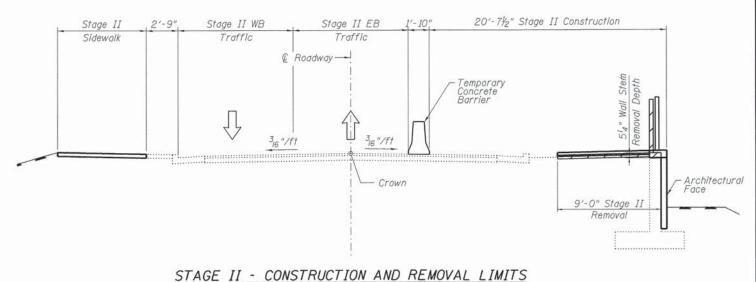

(At SW Retaining Wall, Looking East)

Legend Removal

NOTES

Existing roadway lighting is attached to the South concrete traffic barrier structure. Existing lighting should be removed and new proposed lighting will be installed at new locations.

Full height of concrete bridge parapet and deck shall be removed at the existing roadway lighting & proposed new lighting locations. New concrete deck and concrete barrier to be installed at these locations to support the new proposed lighting. New concrete bridge parapet to match the existing concrete railing in kind.

Traffic traveling in each direction will be maintained during construction at any given time. See roadway maintenance of traffic drawings for more details.

Utilities suspended from deck in proposed regions shall be temporarily supported during construction.

Temporary support of utilities is included in the cost of concrete removal.


١	Λi	c	h	a	el	I	3	a	k	ei	•
١N			-				-	-			+


USER NAME =	DESIGNED - JMK	REVISED -	Line and the second
	CHECKED - DFM	REVISED -	
PLOT SCALE =	DRAWN - EML	REVISED -	
PLOT DATE =	CHECKED - DFM	REVISED -	

STATE OF ILLINOIS DEPARTMENT OF TRANSPORTATION

STAGE	CONSTRUCTION A	ND REMOVAL	SEQUENCE III
	STATE STREET	OVER FOX RI	VER
	STRUCTURE	NO. 045-3128	
	CHEET NO C	OF 25 SHEETS	

JOB	NO. C-91-286-13	CONTRACT NO. 61C1			
1343	13-00043-00-BR	KANE	65	30	
F.A.U. RTE.	SECTION	COUNTY	TOTAL SHEETS	SHEET NO.	

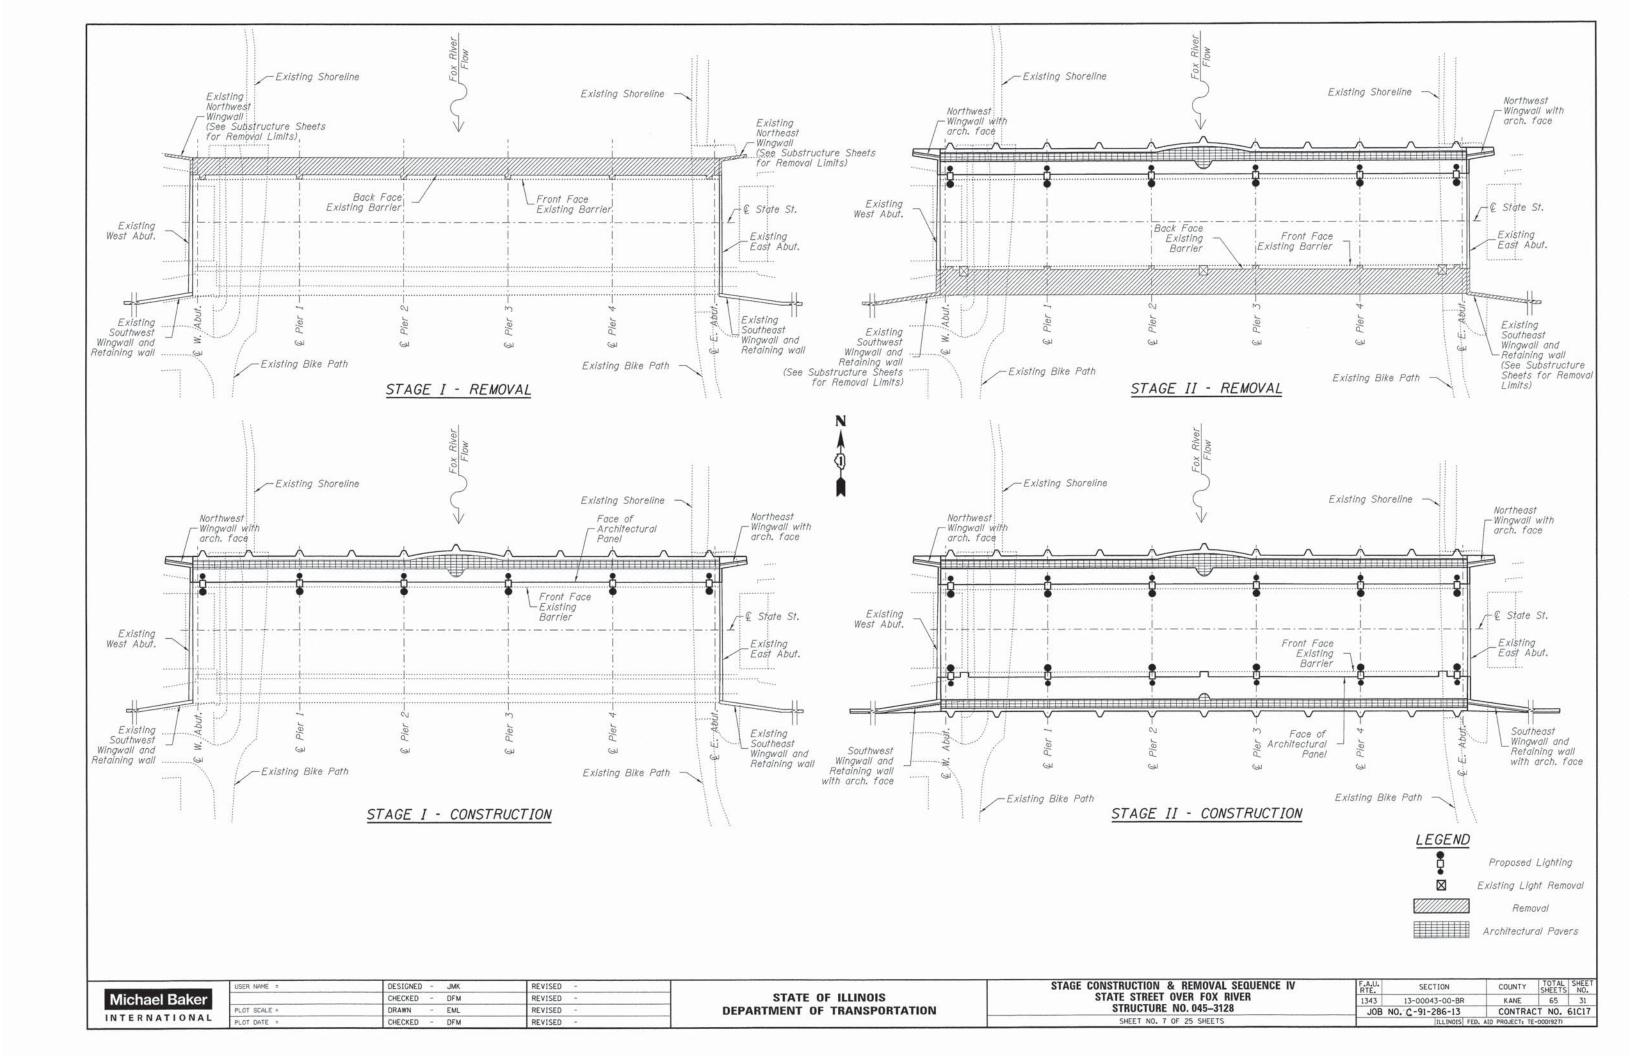

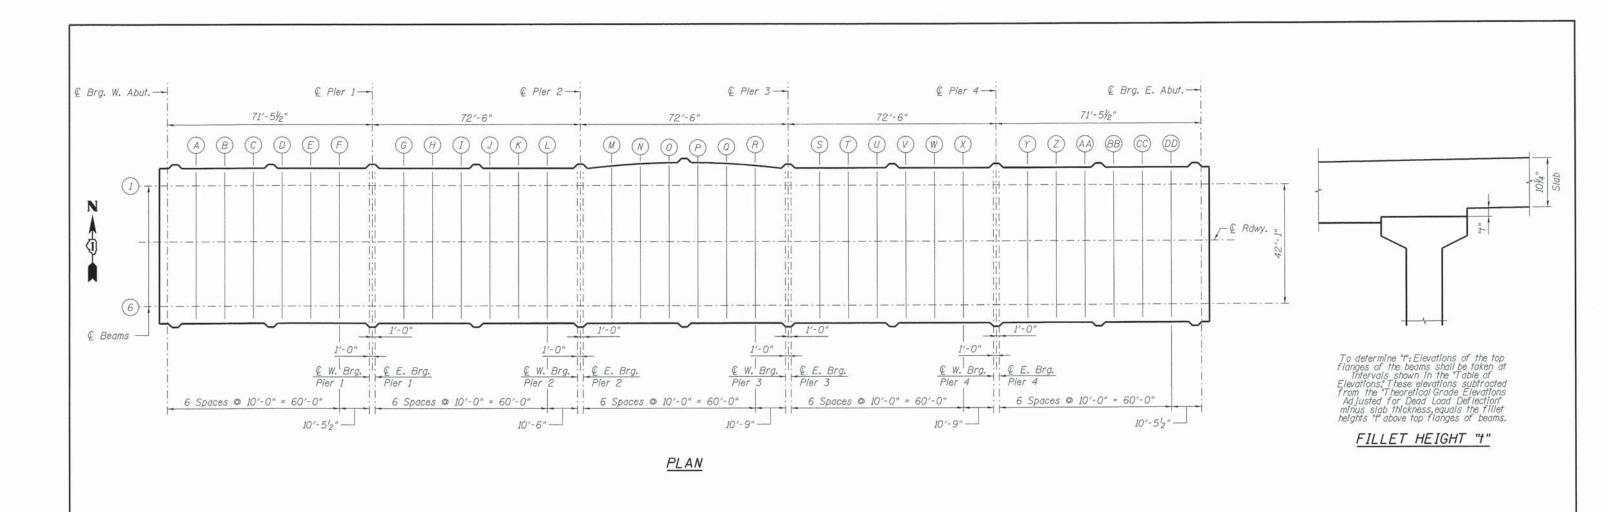

BEAM 1

BEAM 1 (Cont'd)

Location	Station	Offset	Theoretical Grade Elevations	Theoretical Grade Elevations Ad justed for Dead Load Deflection	Location	Station	Offset	Theoretical Grade Elevations	Theoretical Grade Elevations Adjusted for Dead Load Deflection
Back of W. Abut. CL BRG W. Abut.	1317,000 1319,792	-19.542 -19.542	707.274 707.414	707.274 707.414	CL W BRG Pler 3 CL E BRG Pler 3	1535.502 1537.002	-19.542 -19.542	711.749 711.734	711.749 711.734
ABCOEF	1329.792 1339.792 1349.792 1359.792 1369.792 1379.792	-19.542 -19.542 -19.542 -19.542 -19.542	707.900 708.359 708.790 709.194 709.569 709.917	707.868 708.288 708.696 709.001 709.498 709.885	S T U V W X	1547.002 1557.002 1567.002 1577.002 1587.002 1597.002	-19.542 -19.542 -19.542 -19.542 -19.542	711.617 711.473 711.301 711.01 710.873 710.617	711.589 711.407 711.213 711.012 710.805 710.586
W BRG Pier I E BRG Pier I	1390.252 1392.252	-19.542 -19.542	710.251 710.311	710.251 710.311	CL W BRG Pier 4 CL E BRG Pier 4	1607.752 1609.752	-19,542 -19,542	710.311 710.251	710.311 710.251
GH 1 J K L	1402.252 1412.252 1422.252 1432.252 1442.252 1452.252	-19.542 -19.542 -19.542 -19.542 -19.542	710.597 710.855 711.084 711.286 711.461 711.607	710.569 710.789 710.996 711.397 711.393 711.576	Y Z AA BB CC DD	1619.752 1629.752 1639.752 1649.752 1659.752 1669.752	-19.542 -19.542 -19.542 -19.542 -19.542	709.932 709.586 709.211 708.809 708.380 707.922	709.900 709.515 709.17 708.716 708.309 707.890
W BRG Pier 2 E BRG Pier 2	1462.752 1464.752	-19.542 -19.542	711.731 711.751	711.731 711.751	CL BRG E.Abut. Back of E.Abut.	1680,212 1683,004	-19.542 -19.542	707.414 707.274	707.414 707.274
MNOROR	1474.752 1484.752 1494.752 1504.752 1514.752 1524.752	-19.542 -19.542 -19.542 -19.542 -19.542 -19.542	711.835 711.892 711.920 711.921 711.894 711.839	711.791 711.798 711.798 711.798 711.797 711.791					

BEAM 6

Theoretical Grade Elevations Adjusted for Dead Load Deflection Theoretical Grade Elevations Adjusted for Dead Load Deflection Theoretical Grade Elevations Location Station Off set Offset Station Location 711.554 711.381 711.191 710.991 710.779 710.552 707.835 708.265 708.678 709.082 709.475 709.853 710,206 22.542 CL W BRG Pier CL E BRG Pier 22.542 22.542 711.686 711.706 22.542 22.542 CL W BRG Pier 2 CL E BRG Pier 2

N	lic	hae	l B	ak	er
IN	ΤE	RN	ATI	0 1	JAL


USER NAME =	DESIGNED - JMK	REVISED -	
	CHECKED - DFM	REVISED -	
PLOT SCALE =	DRAWN - EML	REVISED -	
PLOT DATE =	CHECKED - DFM	REVISED -	


STATE OF ILLINOIS
DEPARTMENT OF TRANSPORTATION

STATE STRE	ET	OVER		
STRUCTU	UNE	NO. U	43-3120	


F.A.U. RTE.	SECTION	COUNTY	TOTAL	SHEET NO.
1343	13-00043-00-BR	KANE	65	32
JOB	NO. C-91-286-13	CONTRAC	T NO. 6	51C17
	ILLINOIS FED. A	ID PROJECT: TE-	00D(927)	Target.

BEAM 6 (Cont'd)

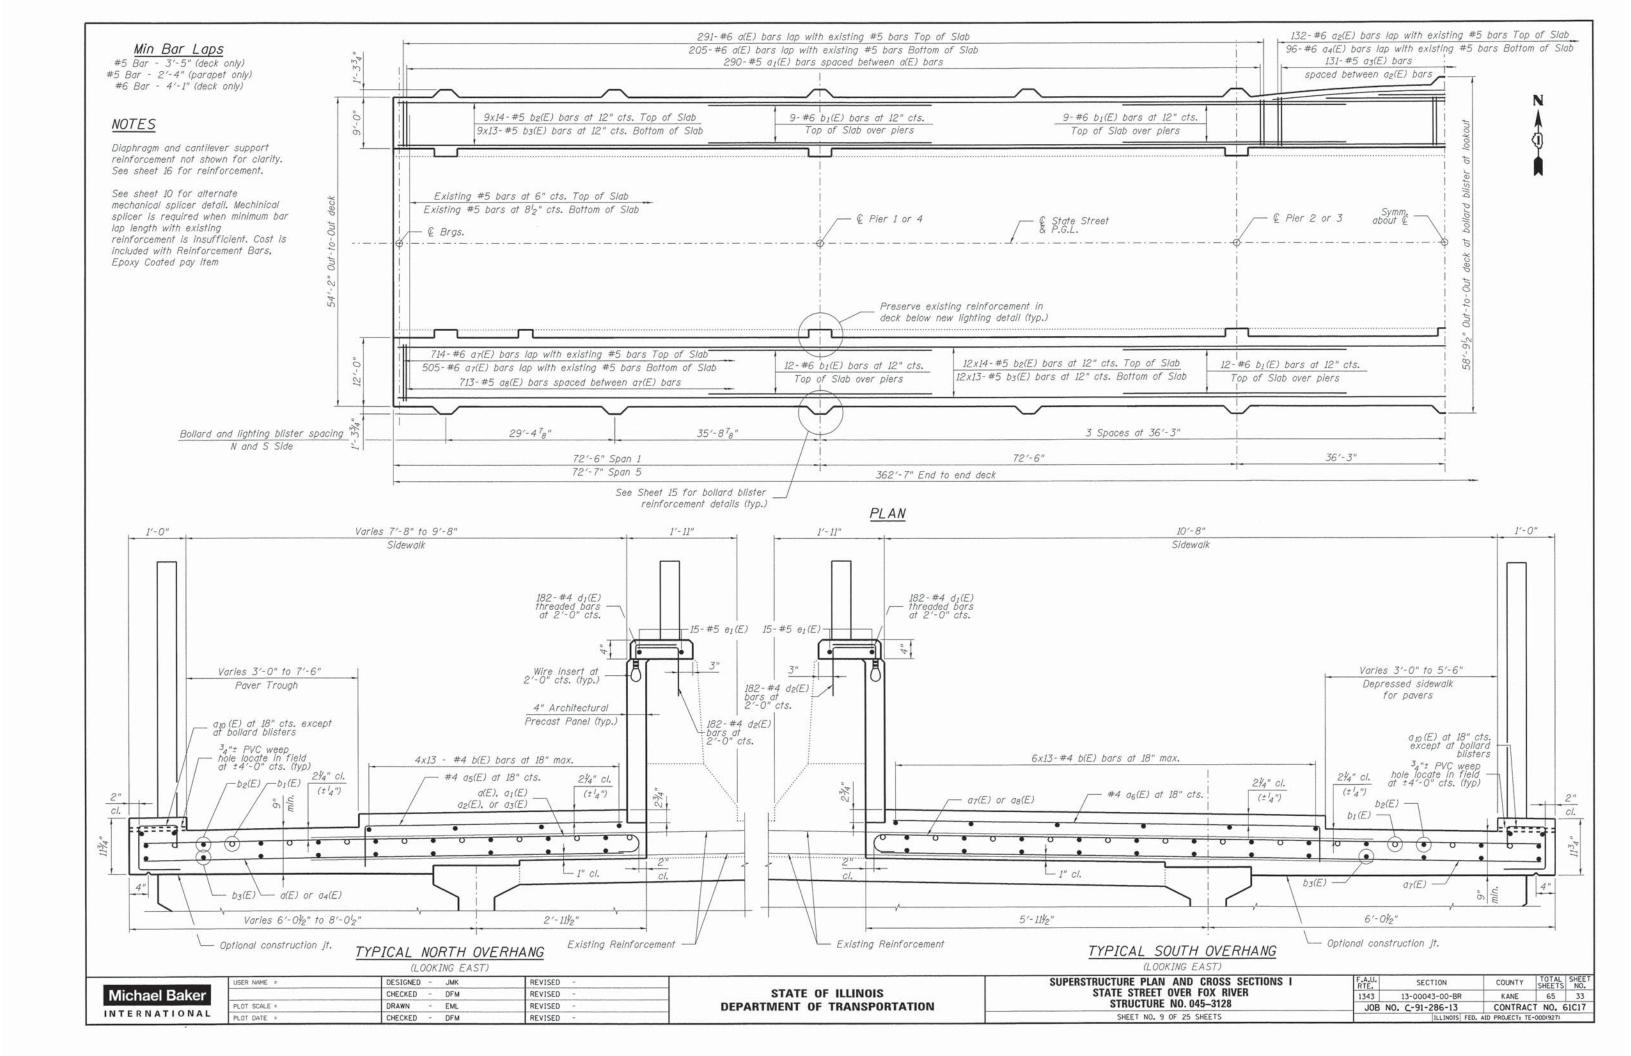

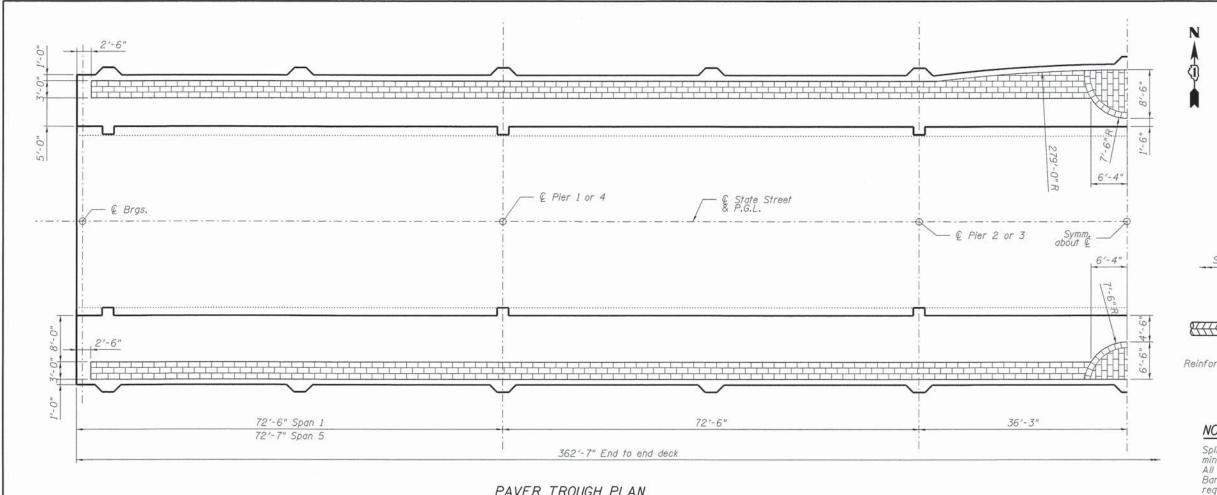

PAVER TROUGH PLAN

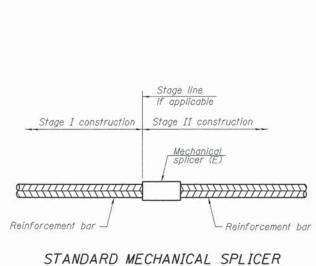


NOTES

Splicer bars shall be deformed with threaded ends and have a minimum 60 ksi yield strength.

All reinforcement shall be lapped and tied to the splicer bars.

Bar splicer assemblies shall be epoxy coated according to the requirements for reinforcement bars. See Section 508 of the Standard Specifications.

See approved list of bar splicer assemblies and mechanical splicers for alternatives.

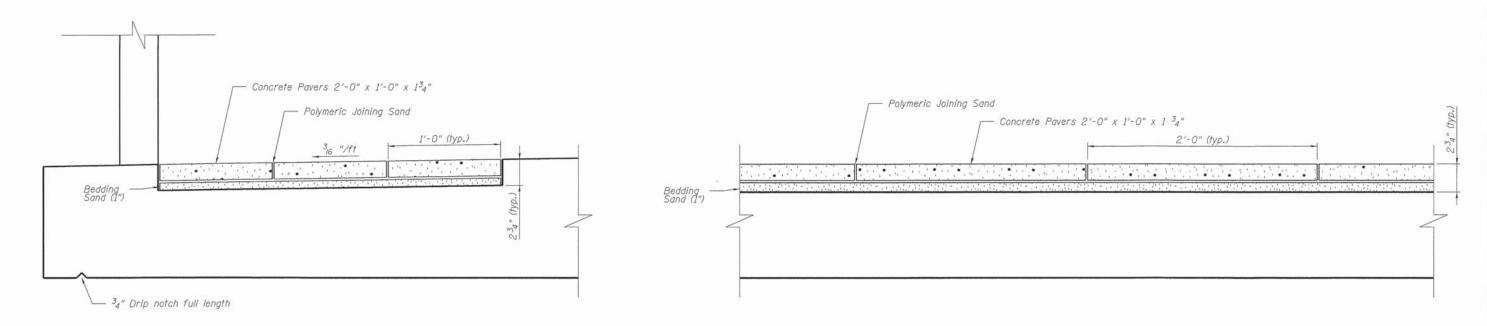


TYPICAL PAVER LONGITUDINAL SECTION

	USER NAME =	DESIGNED - JMK	REVISED -	
Michael Baker		CHECKED - DFM	REVISED -	
	PLOT SCALE =	DRAWN - EML	REVISED -	
INTERNATIONAL	PLOT DATE =	CHECKED - DFM	REVISED -	


TYPICAL PAVER TRANSVERSE SECTION

STATE OF ILLINOIS DEPARTMENT OF TRANSPORTATION SUPERSTRUCTURE PLAN AND CROSS SECTIONS II STATE STREET OVER FOX RIVER STRUCTURE NO. 045-3128 SHEET NO. 10 OF 25 SHEETS


COUNTY TOTAL SHEETS NO. KANE 65 34 SECTION COUNTY 1343 13-00043-00-BR CONTRACT NO. 61C17 JOB NO. C-91-286-13 ILLINOIS FED. AID PROJECT: TE-000(927)

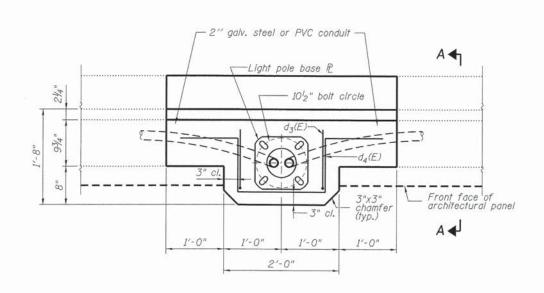


PLAN NORTH PARAPET AT LIGHT POLE

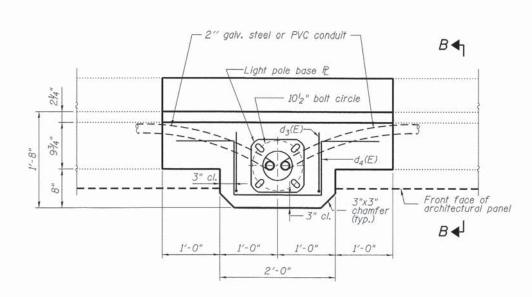

PLAN SOUTH PARAPET AT LIGHT POLE

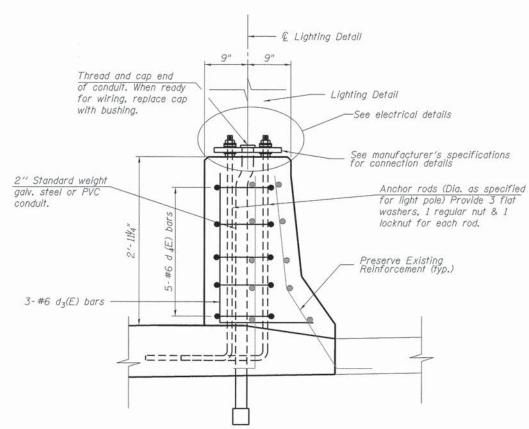

SECTION A-A

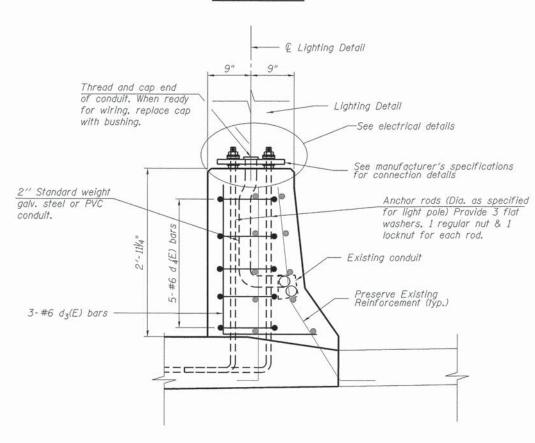

SECTION B-B

NOTES

Cost of anchor rods and conduit is included with Concrete Superstructure.

Michael Baker					
1/	III C	ııa	eı i	Ja	70
	T .	DN	A T	10	NAL

USER NAME =	DESIGNED - JMK	REVISED -	
	CHECKED - DFM	REVISED -	
PLOT SCALE =	DRAWN - EML	REVISED -	
PLOT DATE =	CHECKED - DFM	REVISED -	


STATE OF ILLINOIS
DEPARTMENT OF TRANSPORTATION


STATE STREET OVER FO	Y RIVER
	W HIAFH
STRUCTURE NO. 045	-3128

F.A.U. SECTION COUNTY TOTAL SHEETS NO.


1343 13-00043-00-BR KANE 65 35

JOB NO. C-91-286-13 CONTRACT NO. 61C17

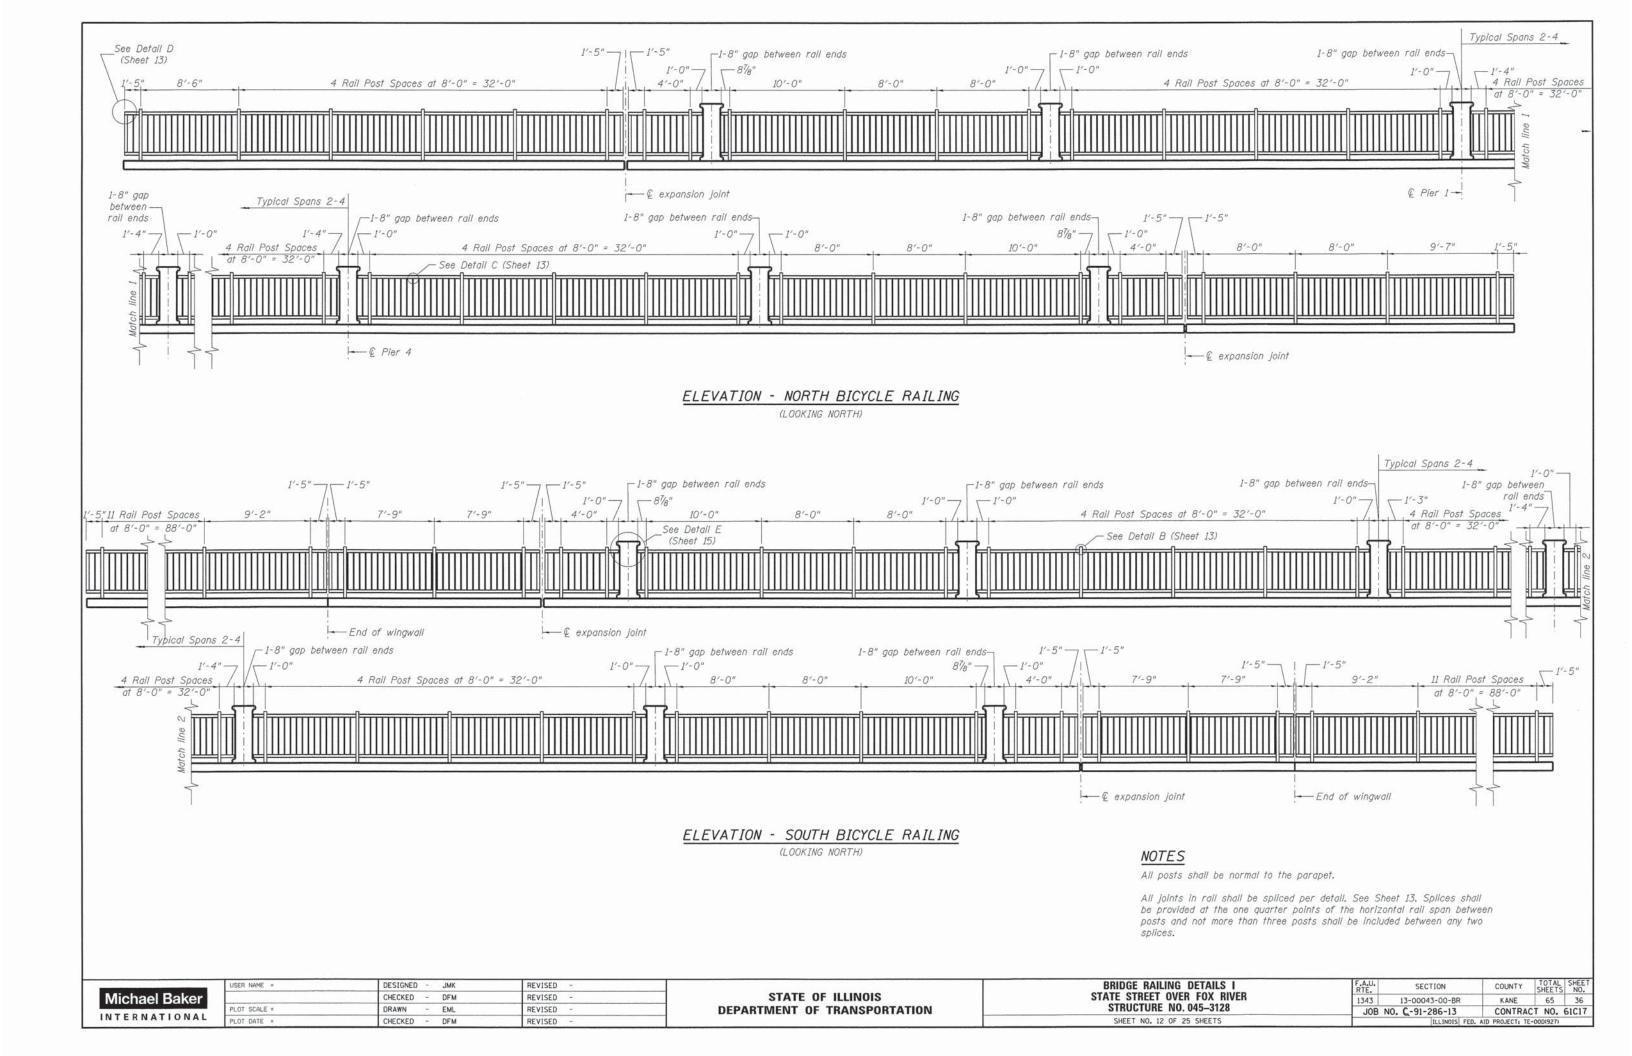

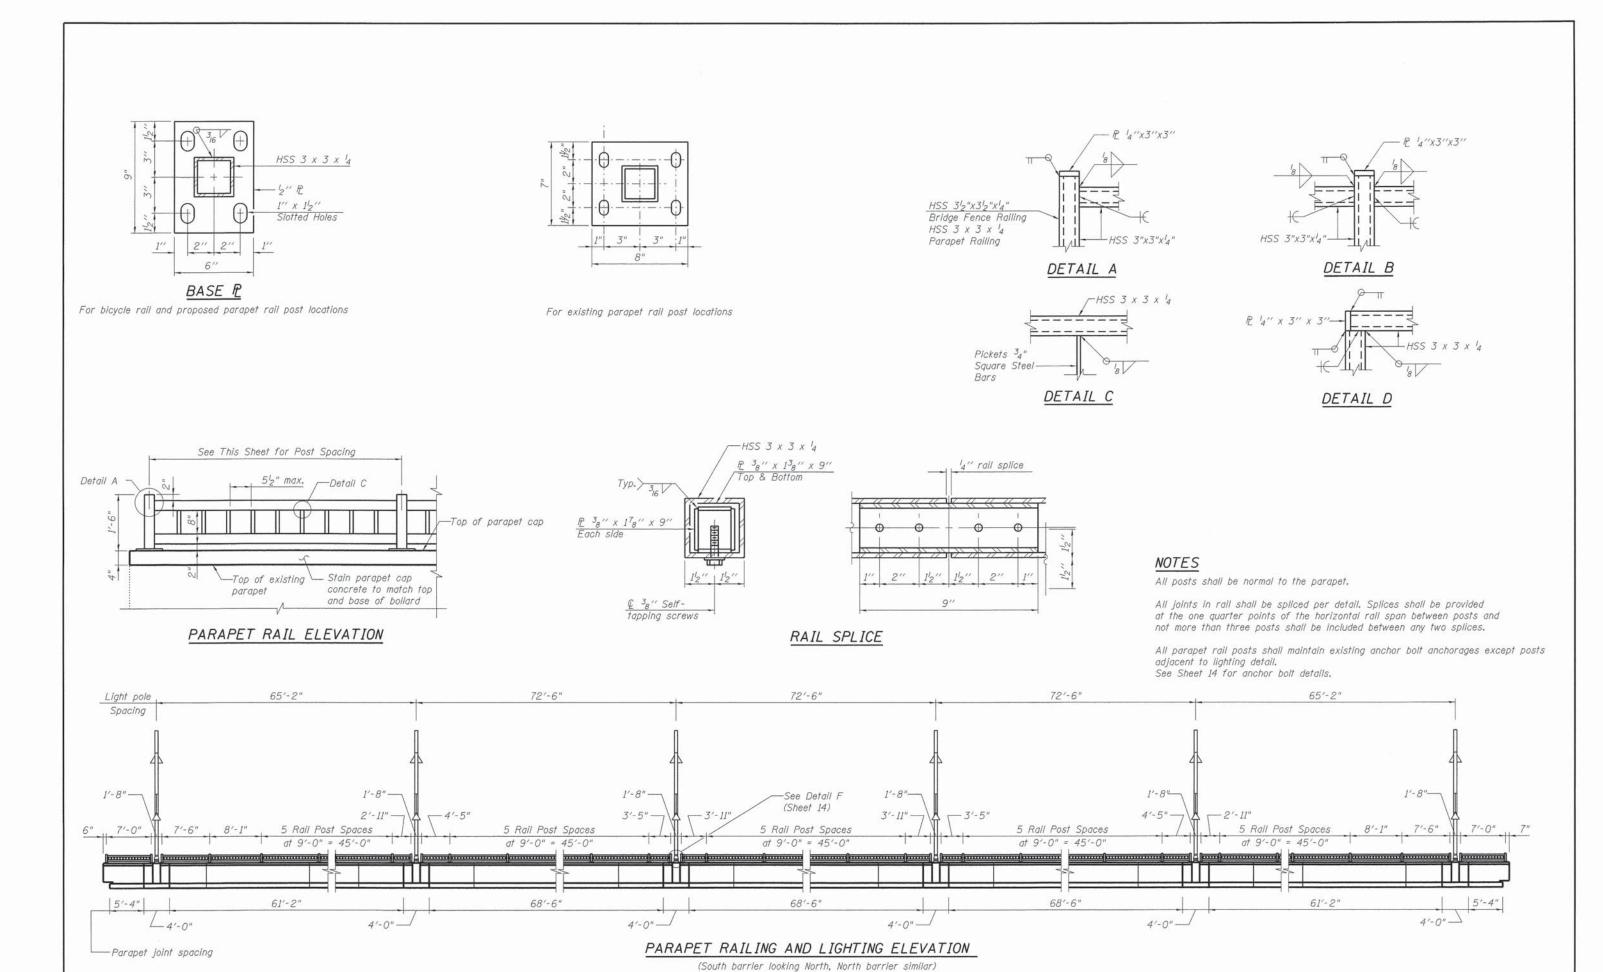


REVISED BRIDGE RAILING DETAILS II TOTAL SHEE NO. DESIGNED - JMK SECTION COUNTY STATE STREET OVER FOX RIVER STATE OF ILLINOIS Michael Baker CHECKED DFM REVISED 13-00043-00-BR 1343 KANE 65 37 LOT SCALE = DRAWN EML REVISED **DEPARTMENT OF TRANSPORTATION** STRUCTURE NO. 045-3128 JOB NO. C-91-286-13 CONTRACT NO. 61C17 INTERNATIONAL SHEET NO. 13 OF 25 SHEETS CHECKED -DFM REVISED ILLINOIS FED. AID PROJECT: TE-000(927)

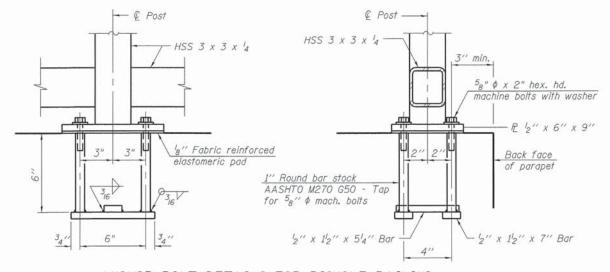


ANCHOR BOLT DETAILS FOR BICYCLE RAILING


In lieu of the cast-in-place anchor device shown, the Contractor has the option of drilling and setting ${}^58''$ ϕ anchor rods according to Article 509.06 of the Standard Specifications. Embedment shall be according to the manufacturer's specifications.

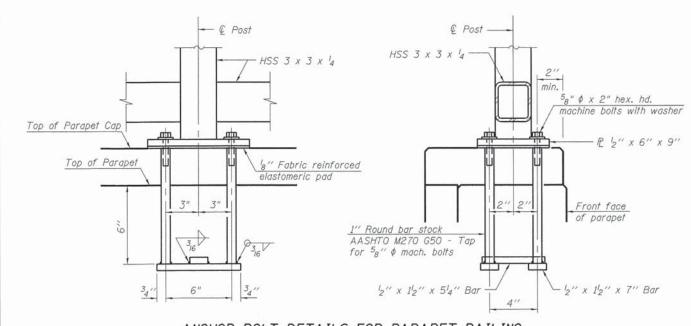

ANCHOR BOLT DETAILS FOR PARAPET RAILING

In lieu of the cast-in-place anchor device shown, the Contractor has the option of drilling and setting $^58''$ ϕ anchor rods according to Article 509.06 of the Standard Specifications. Embedment shall be according to the manufacturer's specifications.

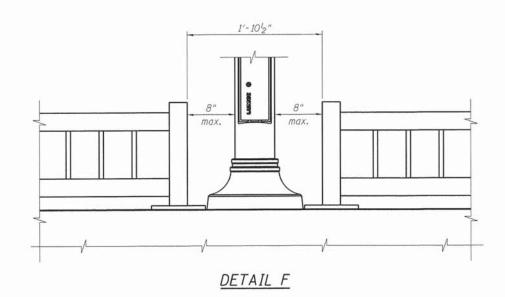

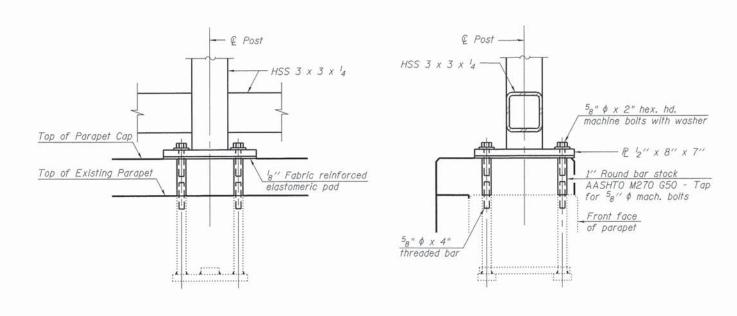

ANCHOR BOLT DETAILS UTILIZING EXISTING ANCHORAGE FOR PARAPET RAILING

Preserve existing parapet railing anchor bolts for use in installing new parapet railing. Install 58 " ϕ threaded bar and tapped 1" round bar stock prior to casting parapet cap.


Mi	chae	l Baker
INT	ERNA	ATIONAL


USER NAME =	DESIGNED - JMK	REVISED -	
	CHECKED - DFM	REVISED -	
PLOT SCALE =	DRAWN - EML	REVISED -	
PLOT DATE =	CHECKED - DFM	REVISED -	


STATE OF ILLINOIS
DEPARTMENT OF TRANSPORTATION

STATE ST	REET	OVER	ETAILS III FOX RIVER 045–3128	
SINUL	TONL	. 140. 0	10 0120	

F.A.U. RTE.	SECTION	COUNTY	TOTAL	SHEET NO.
1343	13-00043-00-BR	KANE	65	38
JOB	NO. C-91-286-13	CONTRAC	T NO. 6	51C17
	ILLINOIS FED.	AID PROJECT: TE-	·00D(927)	

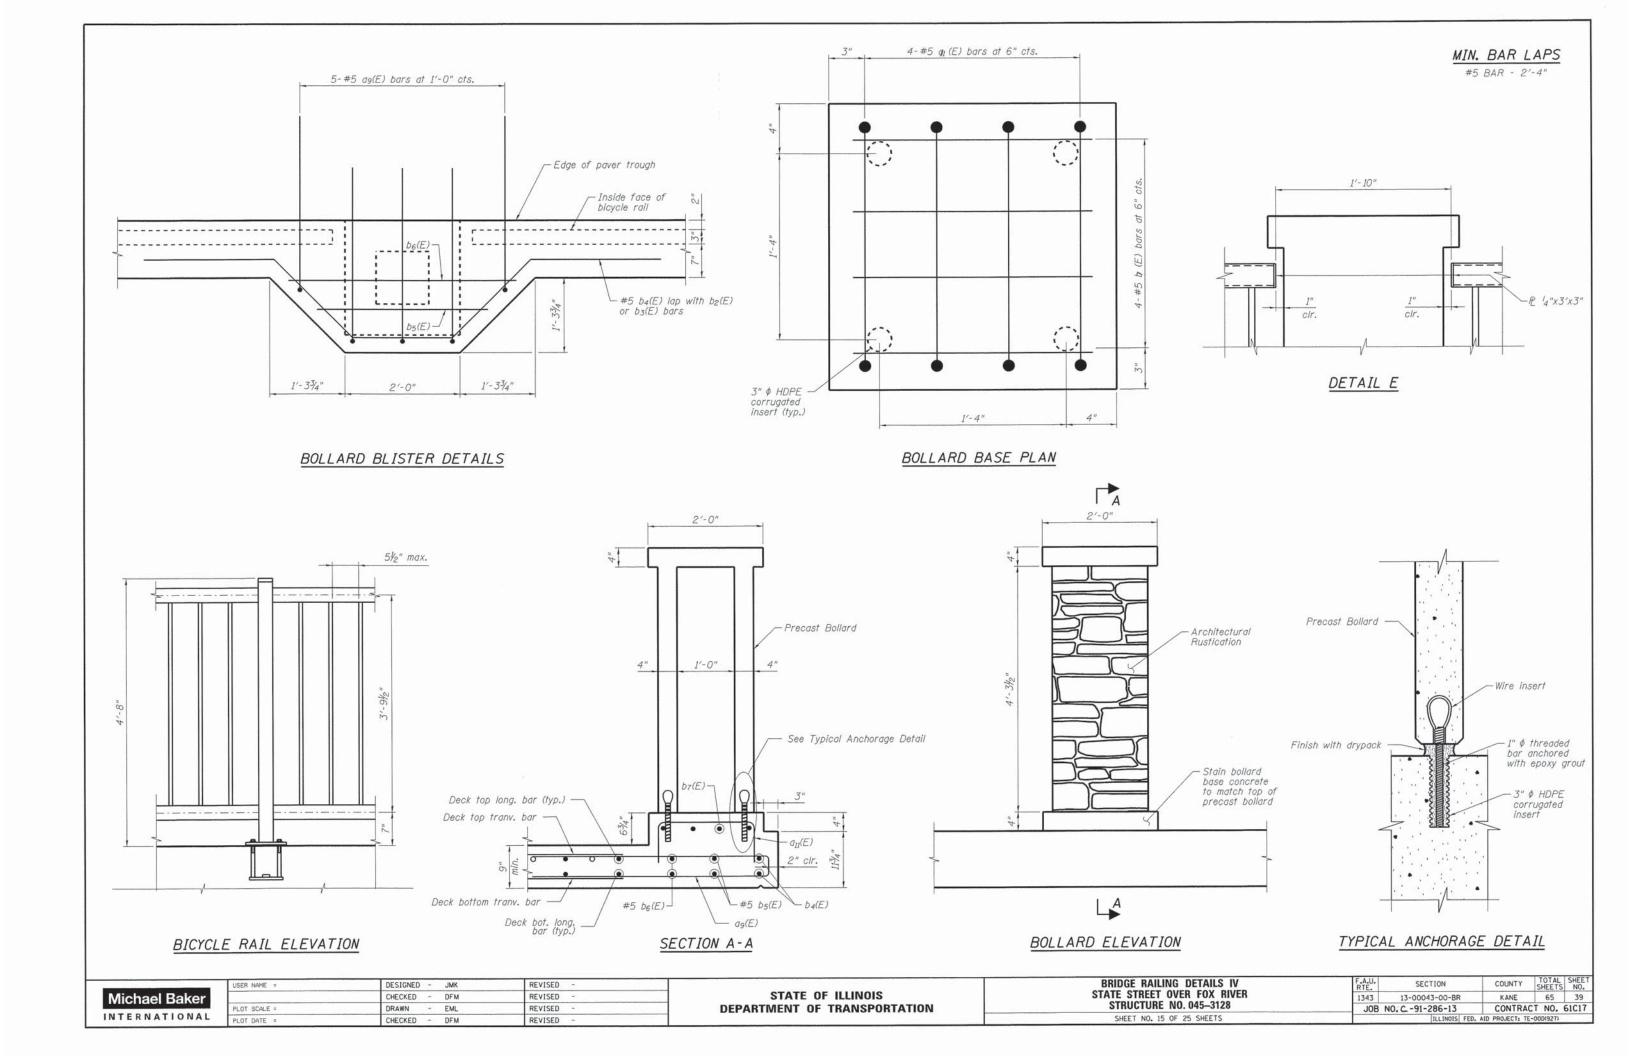

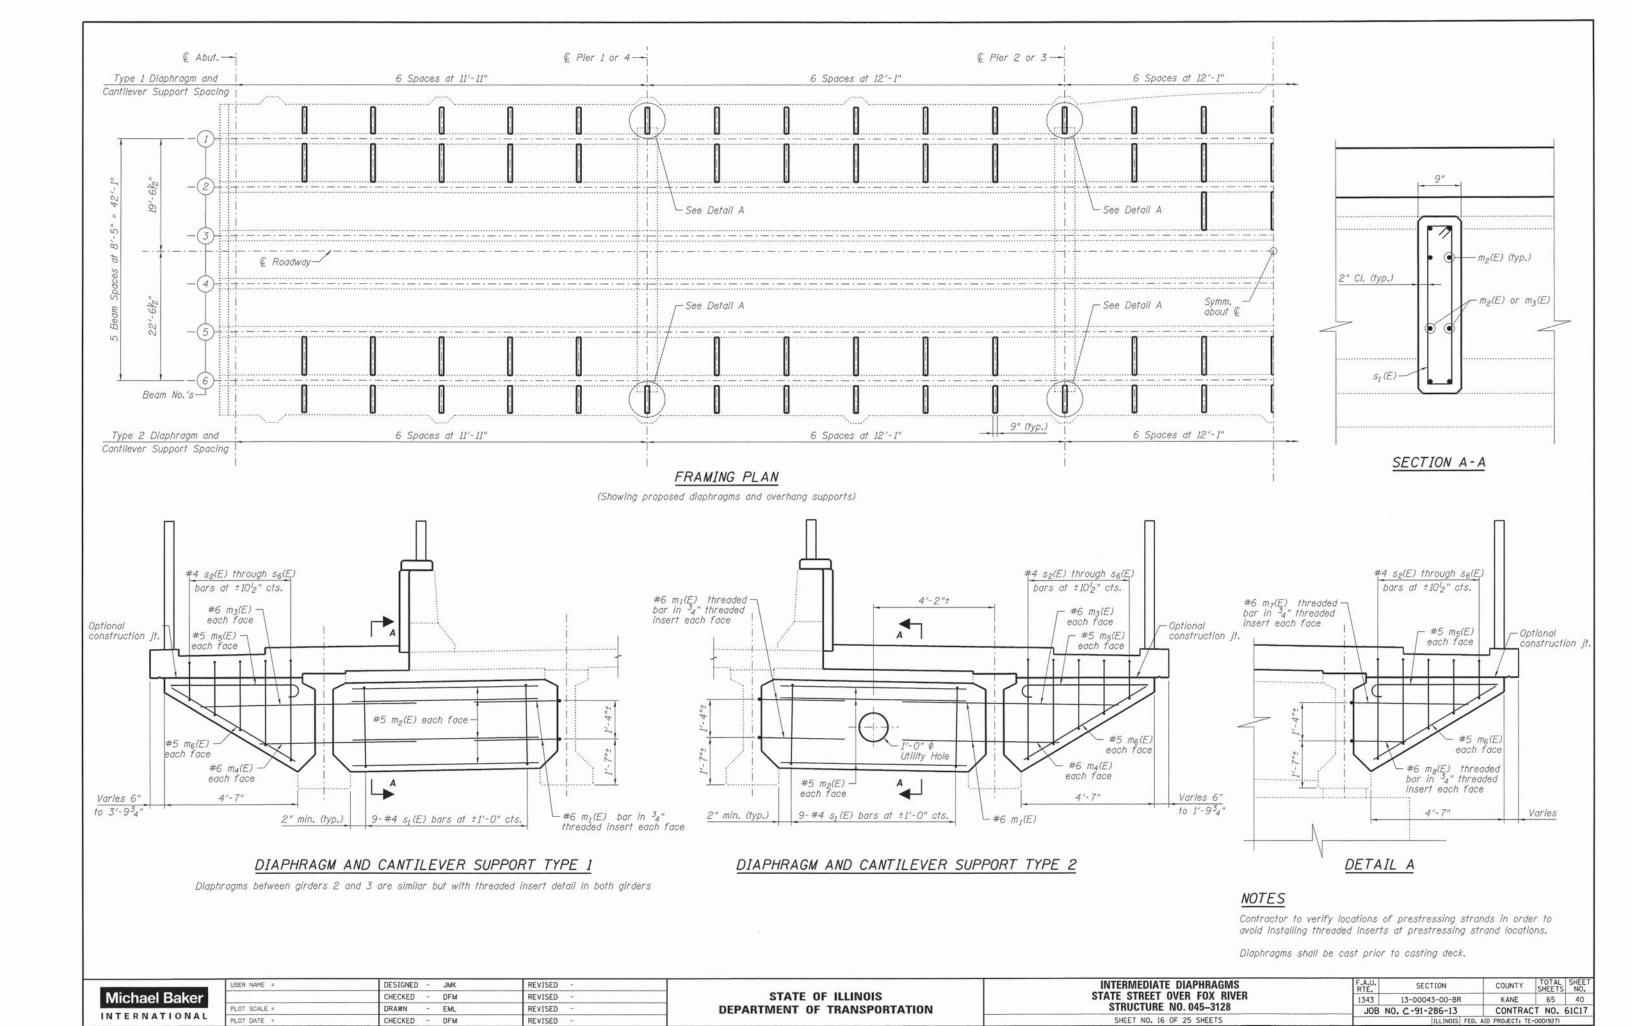

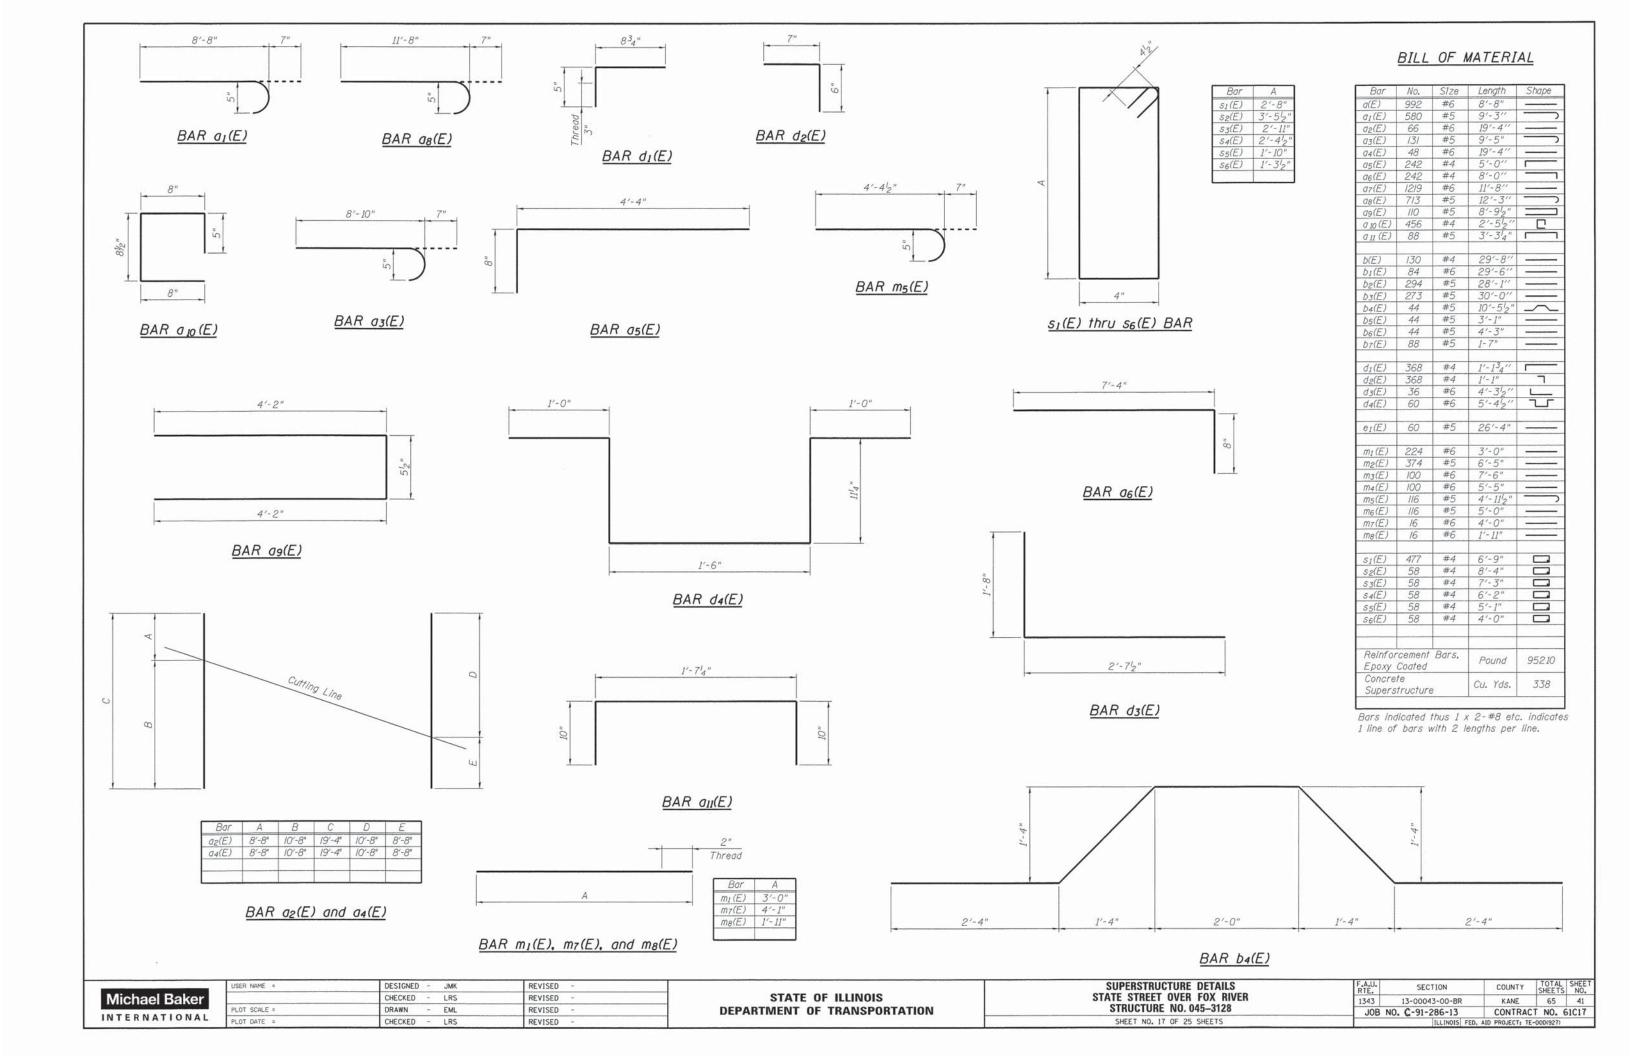


		Location
2"	1/2" min.	East Abut.
3"	21/2" min.	West Abut.
	2" 3"	

INSTALLATION NOTES


Use anchor blocks and preformed joint seal as anchor bolt location templates.

- 1. Install continuous preformed joint seal in sidewalk.
- 2. Splice with existing seal at parapet.
- 3. Install anchor blocks as indicated.

NOTE A - Maximum spacing of anchor bolts shall be 12" centers

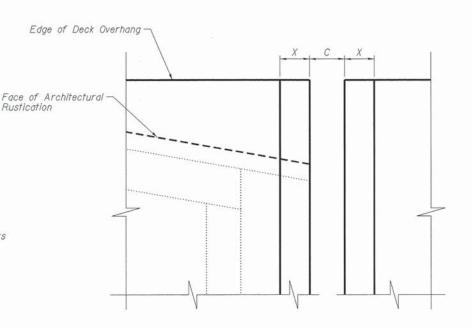


FORMING BLOCKOUT SKETCH

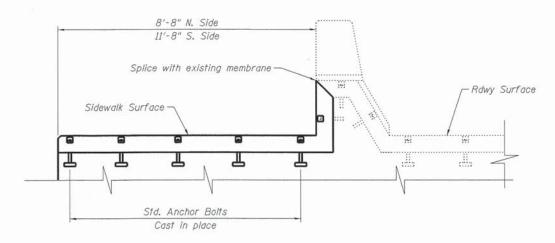


TYPICAL END TREATMENT

BILL OF MATERIAL

ITEM	UNIT	QUANTITY
Neoprene Expansion Joint 2"	Lin.Ft.	22.5
Neoprene Expansion Joint 4"	Lin.Ft.	22.5

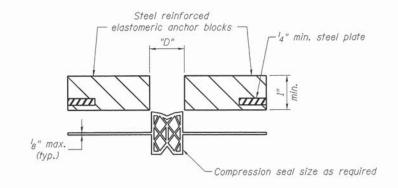

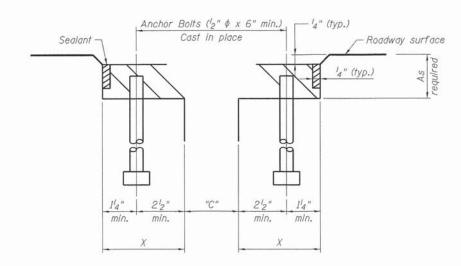

NOTES

Continuous Seal Neoprene Expansion Joint shall consist of modled anchor blocks of elastomer and steel, field assembled over continuous lengths of elastomeric membrane.

The elastomeric membrane shall be a premoided compression seal that will have a "memory" to return to its molded position upon joint closure.

The steel reinforcement must extend up the back face anchor blocks when asphalt surfaces are used but is optional in concrete blockout.

The convolution length shall be such that the extended length will not be greater than the manufactured length when the joint is fully expanded in its design range and will not protrude above the anchor blocks when the joint is fully compressed.

Joint openings shall be adjusted in accordance with Article 503.07(c) of the Standard Specifications when the deck is poured at an ambient temperature other than 50°F.

Anchor bolts, washers and nuts, to be plated against corrosion in accordance with the special provisions, shall be zinc-coated by the mechanical plating method conforming to ASTM B69, class 50 Zinc-coated nuts shall be topped oversize in accordance with the requirements of AASHTO M291 and shall meet the supplementary requirements S1.1 thru S1.2.1 of the same specifications for lubricant and testing.


Michael Baker			
	IVIICITE	acı De	IVE

USER NAME =	DESIGNED - JMK	REVISED -	
	CHECKED - DFM	REVISED -	
PLOT SCALE =	DRAWN - EML	REVISED -	
PLOT DATE =	CHECKED - DFM	REVISED -	

STATE OF ILLINOIS
DEPARTMENT OF TRANSPORTATION


EXP	ANSION	JOINT	DETAILS
STATE	STREET	OVER	FOX RIVER
ST	RUCTURE	NO. 0	45-3128
CL	EET NO 1	OF 25	CHEETE

F.A.U. RTE.	SECTION	COUNTY	TOTAL	SHEET NO.
1343	13-00043-00-BR	KANE	65	42
JOB	NO. C-91-286-13	CONTRAC	T NO. 6	1C17
	ILLINOIS F	ED. AID PROJECT: TE	-000(927)	

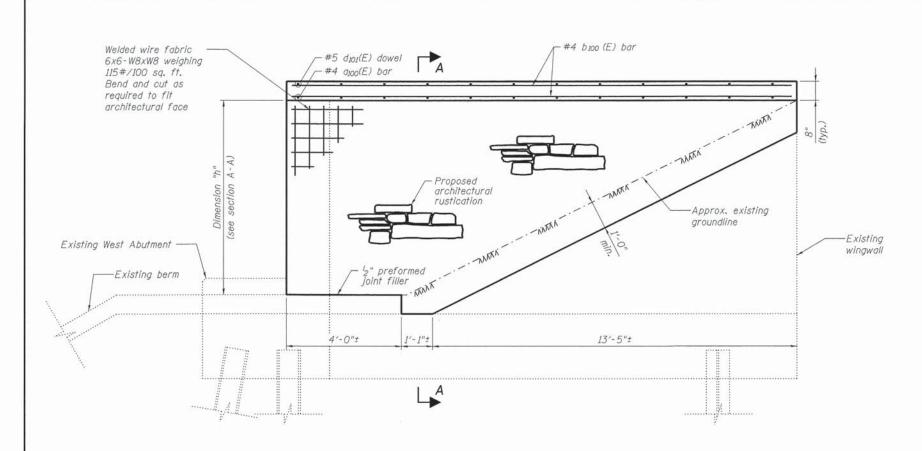

NW WINGWALL ELEVATION


(Looking South)

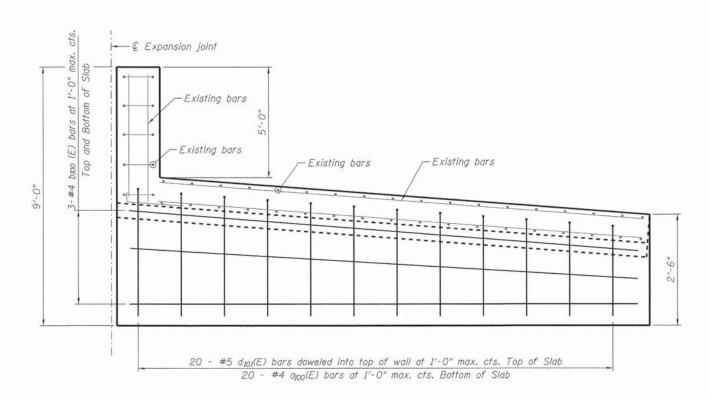


NW WINGWALL PLAN



STATE OF ILLINOIS
DEPARTMENT OF TRANSPORTATION

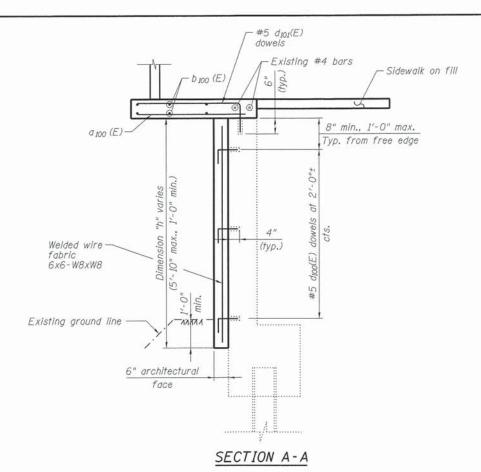

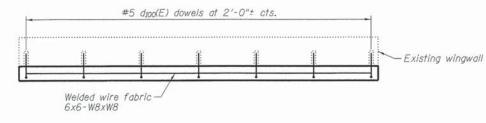

TYPICAL LONGITUDINAL SECTION THROUGH WALL


NOTES

Epoxy grout $d_{100}(E)$ and $d_{101}(E)$ bars according to Article 584 of the Standard Specifications. Drill to miss existing reinforcement. The epoxy grout and method of application shall be approved by the Engineer. All drilling and grouting of rebar to be included with the cost of "Reinforcement Bars, Epoxy Coated."

Preserve existing reinforcement in abutment and wingwall stems.


Ī	F.A.U. RTE.	SECTION	COUNTY	TOTAL	SHEET NO.
	1343	13-00043-00-BR	KANE	65	43
	JOB NO. C-91-286-13		CONTRACT NO. 61		1C17
		ILLINOIS FEI	D. AID PROJECT: TE-	-000(927)	

NW WINGWALL DETAILS
STATE STREET OVER FOX RIVER
STRUCTURE NO. 045–3128
SHEET NO. 19 OF 25 SHEETS

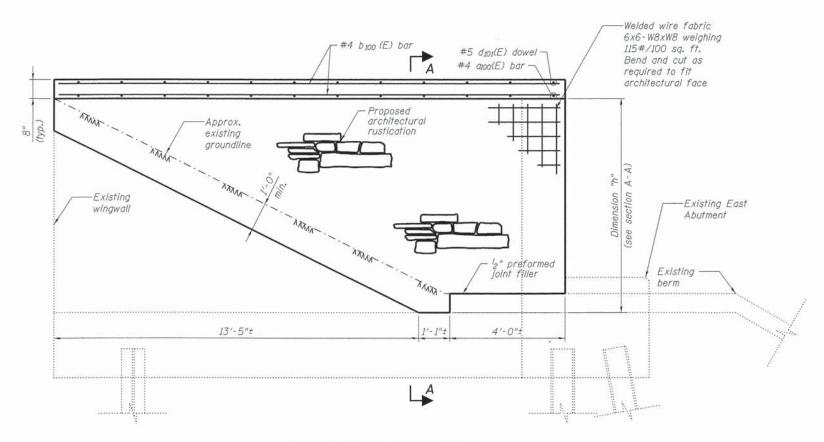

NE WINGWALL ELEVATION


(Looking South)

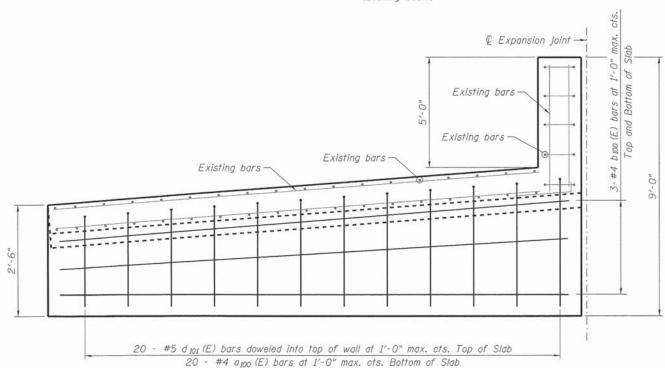


NE WINGWALL PLAN

	USER NAME =	DESIGNED - JMK	REVISED -	
Michael Baker		CHECKED - DFM	REVISED -	
	PLOT SCALE =	DRAWN - EML	REVISED -	
INTERNATIONAL	PLOT DATE =	CHECKED - DFM	REVISED -	

STATE OF ILLINOIS DEPARTMENT OF TRANSPORTATION

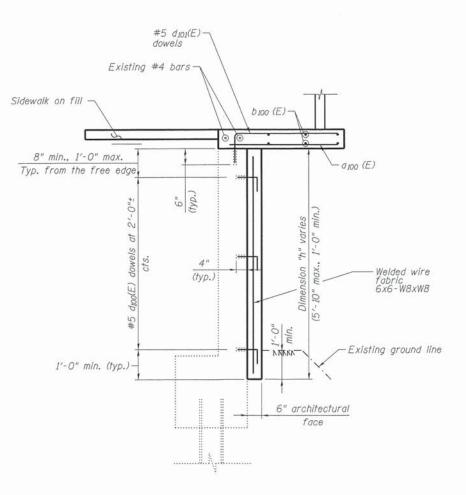

SECTION A-A

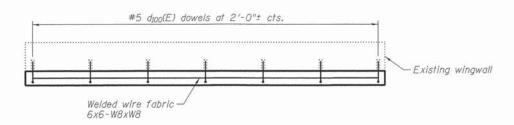

TYPICAL LONGITUDINAL SECTION THROUGH WALL

NE WINGWALL DETAILS

STATE STREET OVER FOX RIVER STRUCTURE NO. 045-3128


SHEET NO. 20 OF 25 SHEETS


NOTES


Epoxy grout dwa(E) and dwa(E) bars according to Article 584 of the Standard Specifications. Drill to miss existing reinforcement. The epoxy grout and method of application shall be approved by the Engineer. All drilling and grouting of rebar to be included with the cost of "Reinforcement Bars, Epoxy Coated."


Preserve existing reinforcement in abutment and wingwall stems.

F.A.U. RTE.	SECTION	COUNTY	TOTAL	SHEET NO.
1343	13-00043-00-BR	KANE	65	44
JOB	NO. C-91-286-13	CONTRAC	T NO. 6	1C17
	ILLINOIS FFD.	AID PROJECT: TE	-000(927)	

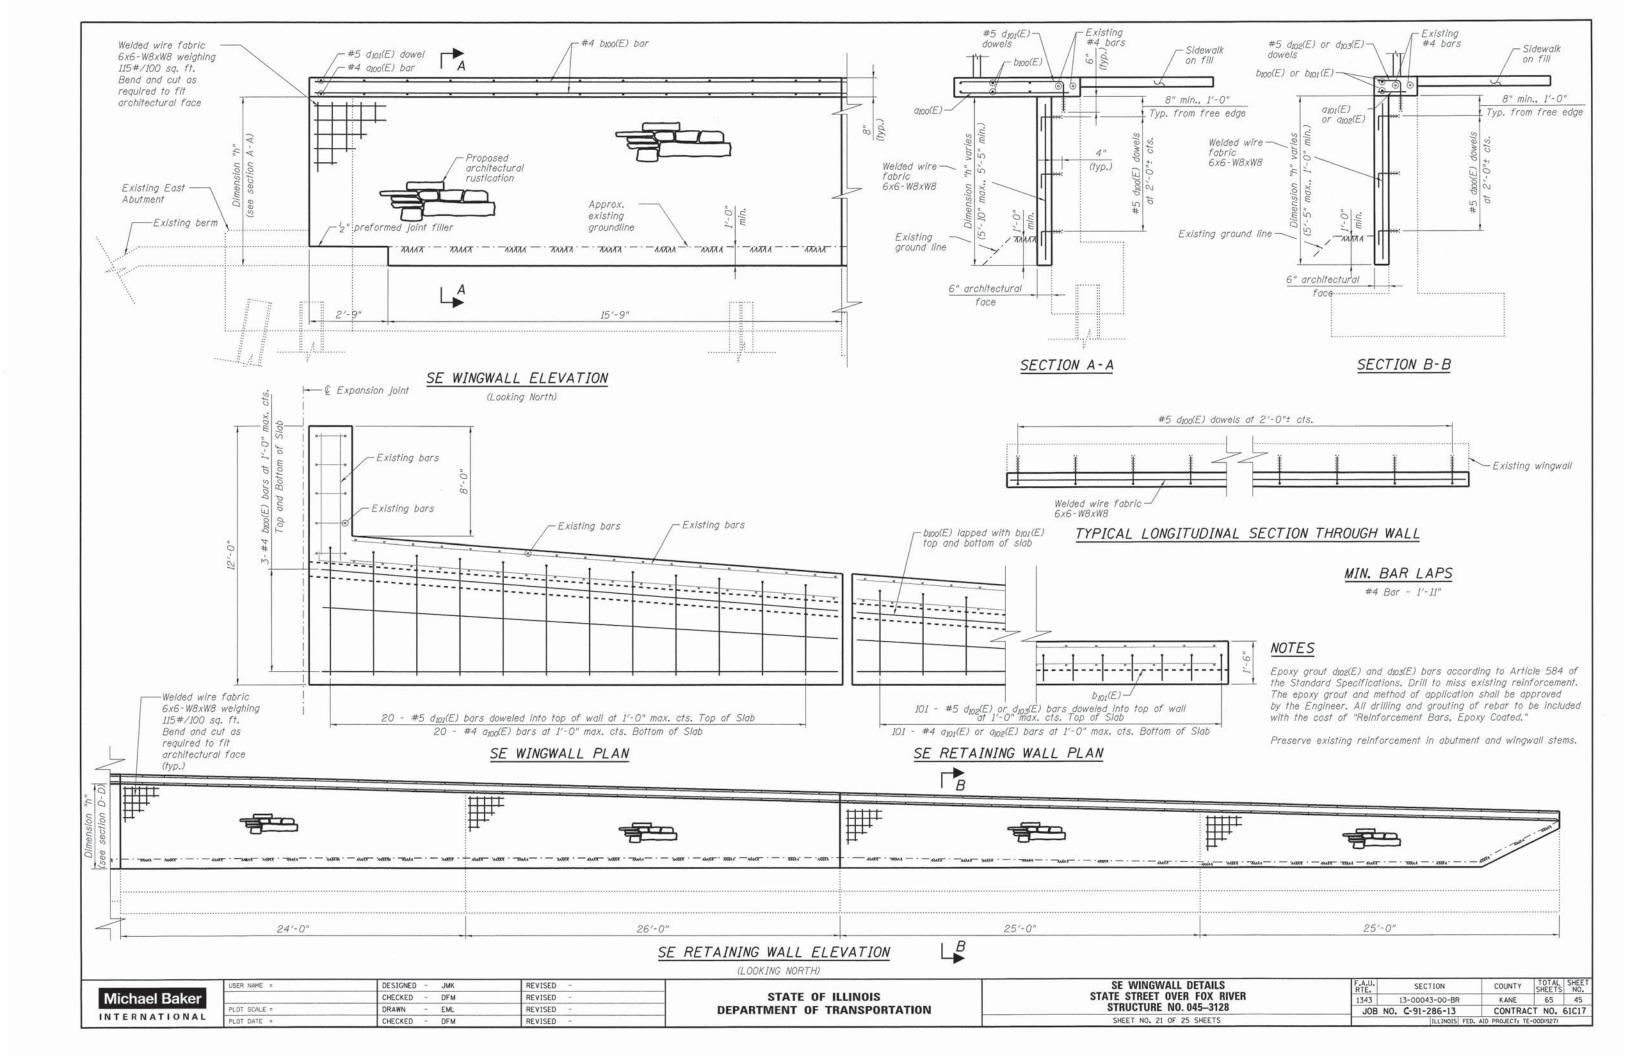

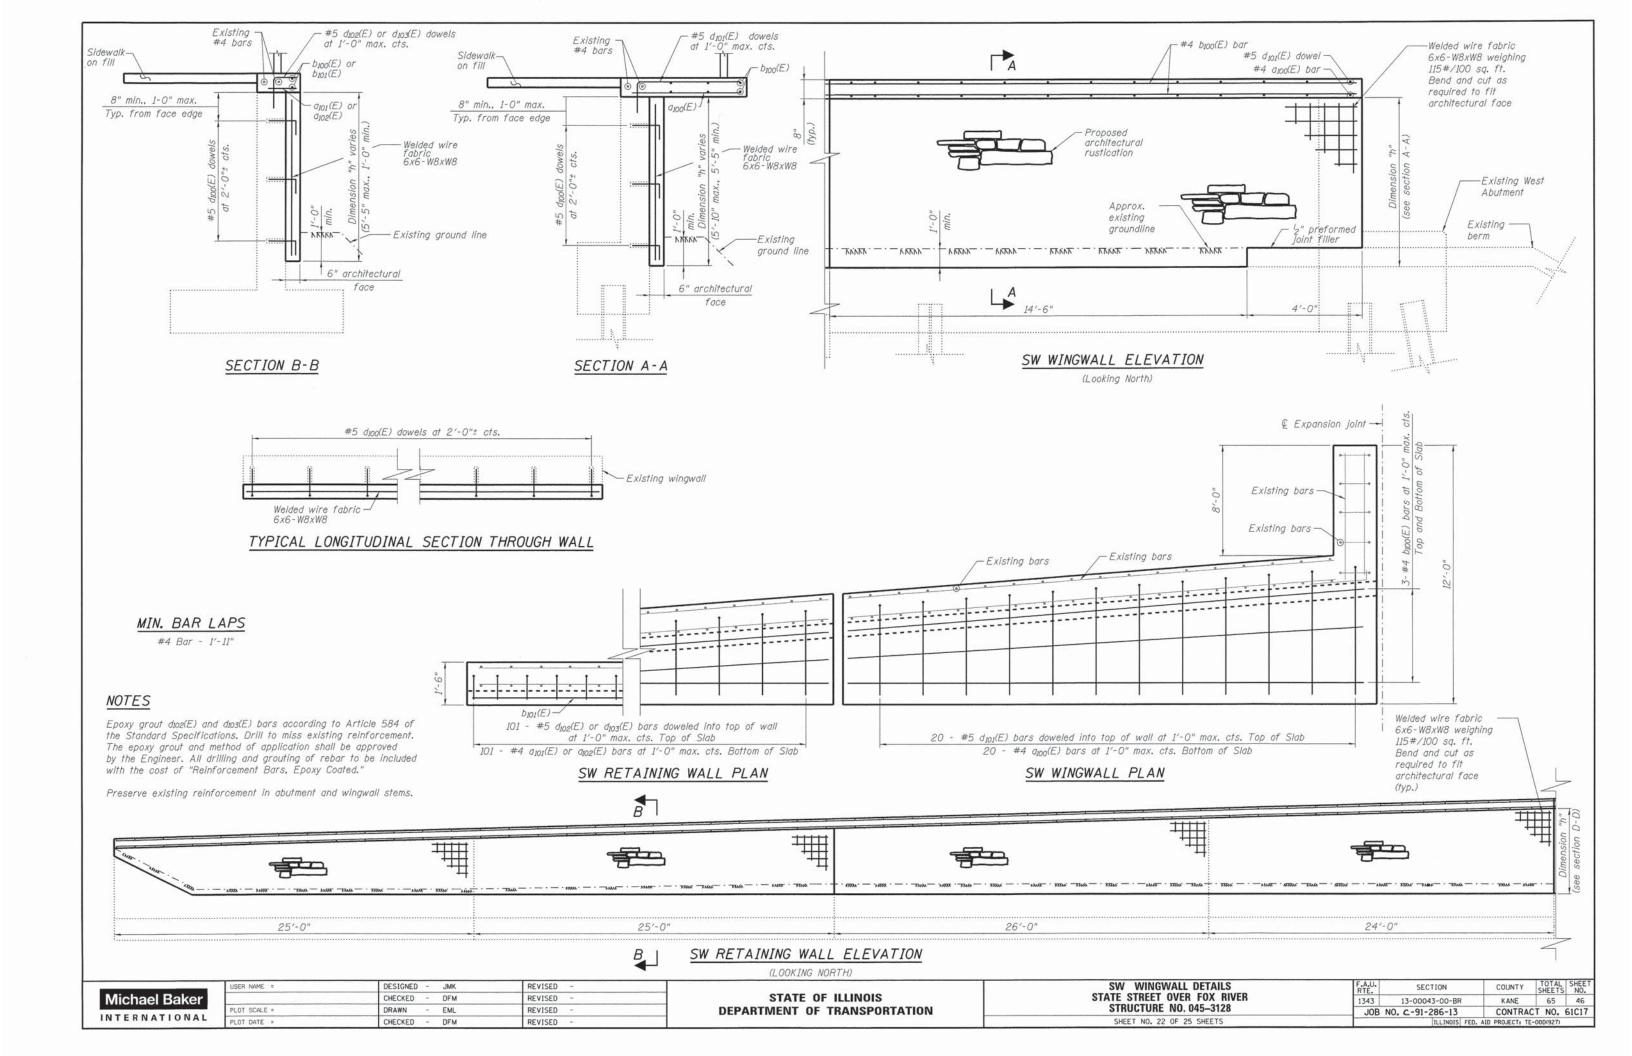


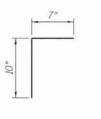

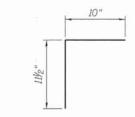


Bar dioo(E)

Bar d103(E)

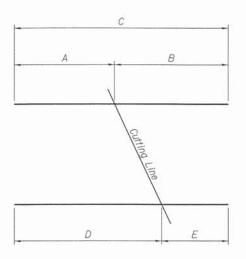

Bar	A	В	C	D	E
0100(E)	2'-2"	3'-8"	5'-10"	3'-8"	2'-2"
0101(E)	1'-2"	2'-2"	3'-4"	2'-2"	1'-2"

BAR CUTTING DIAGRAM

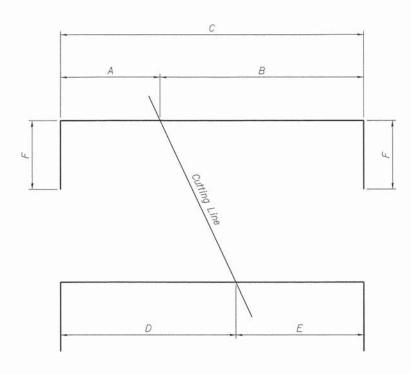

Bar	A	В	C	D	E	F
d101(E)	1'-101/2"	3'-3"	5'-1/2"	3'-3"	1'-101/2"	111/2"
d102(E)	10"	1'-10"	2'-8"	1'-10"	10"	111/2"

BAR CUTTING DIAGRAM

BILL OF MATERIAL

Bar	No.	Size	Length	Shape
a100(E)	40	#4	5'-10"	
a101(E)	25	#4	3'-4"	_
a ₁₀₂ (E)	152	#4	1'-2"	_
b100(E)	36	#4	18'-2"	_
b101(E)	20	#4	29'-1"	
d100(E)	400	#5	1'-5"	
d101(E)	40	#5	7'-02"	
d102(E)	25	#5	4'-7"	
d103(E)	152	#5	1'-9'2''	
Reinfor Epoxy		Bars.	Pound	2450
Concre	te Stru	ctures	Cu. Yds.	28


Bars indicated thus 1 x 2-#8 etc. indicates 1 line of bars with 2 lengths per line.




USER NAME =	DESIGNED - JMK	REVISED -	
	CHECKED - LRS	REVISED -	
PLOT SCALE =	DRAWN - EML	REVISED -	
PLOT DATE =	CHECKED - LRS	REVISED -	

SUBSTRUCTURE DETAILS	F.A.U. RTE.	SECTION	COUNTY	TOTAL
STATE STREET OVER FOX RIVER	1343 13-00043-00-BR		KANE	65
STRUCTURE NO. 045-3128	JOB	NO. C-91-286-13	CONTRA	CT NO. 6
SHEET NO. 23 OF 25 SHEETS		ILLINOIS FED.	AID PROJECT: T	E-000(927)



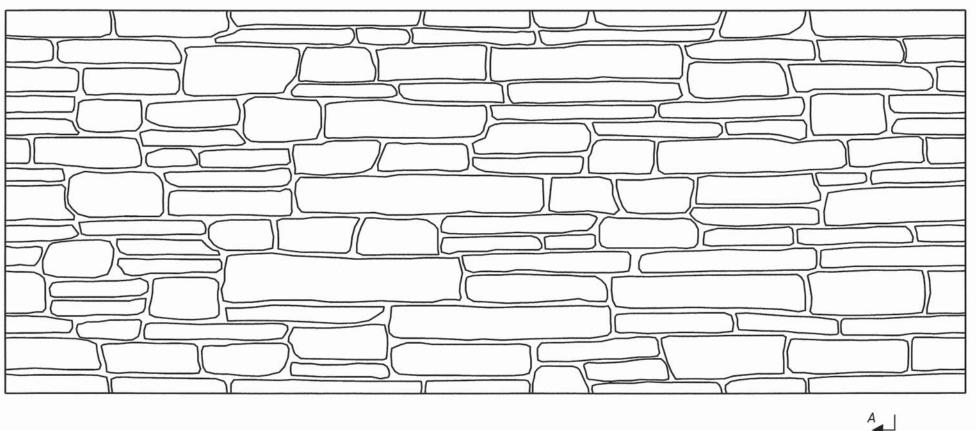

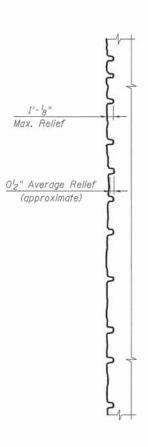

RUSTICATION PATTERN ELEVATION

SECTION A-A

NOTES

- Stones are pattern-matched right-to-left & top-to-bottom
 Stone heights: I¹₂" to 6¹₂"
 Stone widths: 6" to 32"
 Grout lines: Approx. I¹₂" wide by I¹₂" deep, varying
 Patterning shown is for reference only. Coordinate actual limits of form liner with structural information.
 Dimension provided are for reference only. Coordinate actual limits of form liner with structural information.


ı	٨	Λi	_	h	2	ما	ı	2	al	ce	r
	1	щ	٠	"	a	_		•	411	16	1
ı	N	T	F	R	N	Δ	T	1	0	N	A L

USER NAME =	DESIGNED - JMK	REVISED -	
	CHECKED - DFM	REVISED -	
PLOT SCALE =	DRAWN - EML	REVISED -	
PLOT DATE =	CHECKED - DFM	REVISED -	

STATI	E OF	ILLINOIS
DEPARTMENT	OF	TRANSPORTATION

RUSTICATION DETAILS							
STATE	STREE	T O	VER	FOX RIVER			
STF	RUCTU	RE I	NO. 0	45-3128			
CIT	CCT 110	0.4	05	SHEETS			

F.A.U. RTE.	SECTION	COUNTY	TOTAL	SHEET NO.
1343	13-00043-00-BR	KANE	65	48
JOB	NO. C-91-286-13	CONTRAC	T NO.	61C17
	ILLINOIS FED.	AID PROJECT: TE-	·00D(927)	

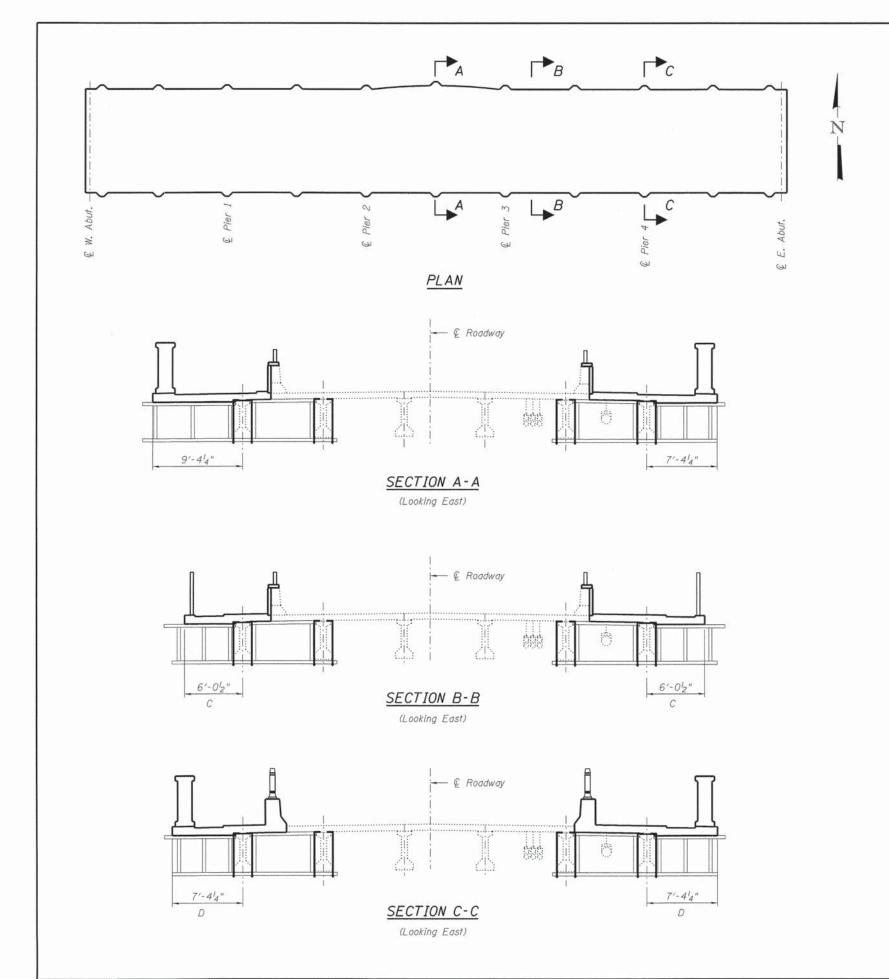

Michael Baker

USER NAME =	DESIGNED - JRB	REVISED -	
	CHECKED - DFM	REVISED -	
PLOT SCALE =	DRAWN - EML	REVISED -	
PLOT DATE =	CHECKED - DFM	REVISED -	

STATE OF ILLINOIS
DEPARTMENT OF TRANSPORTATION

OVERHANG FORMING ALTERNATIVE FOR SUPERSTRUCTURE STATE STREET OVER FOX RIVER STRUCTURE NO. 045-3128 SHEET NO. 25 OF 25 SHEETS

NOTES

required.

The deck overhang exceeds standard overhang lengths.
Forming brackets shall be designed to meet the requirements of Article 503.06(b) of the Standard Specifications. For

standard cantilever forming brackets, see Standard Drawing SB-1.

The beams or girders, supporting cantilever forming brackets, shall be tied together at required spacing.

Contractor shall verify stability of fascia beams from overturning. Contractor shall provide temporary bracing as


F.A.U. RTE.	SECTION	COUNTY	TOTAL	SHEET NO.
1343	13-00043-00-BR	KANE	65	49
JOB	NO. C-91-286-13	CONTRA	CT NO.	61C17
	ILLINOIS FED.	AID PROJECT: TE	-00D(927)	


FOUNDATION DESIGN TABLE

	DESIGN DEPTH OF	FOUNDATION	REINFORCEMENT IN FOUNDATION					
TYPE OF SOIL	SINGLE ARM	TWIN ARM	SINGLE	ARM	TWIN	TWIN ARM		
	D	D	VERT BARS	SPIRAL	VERT BARS	SPIRAL		
SOFT CLAY	13'-0''	15′-0″	8-#6X12'-6"	#3X122'	8-#6X14'-3''	#3X141′		
	(3.962 m)	(4.572 m)	(3.810 m)	(37.186 m)	(4.343 m)	(42.977 m)		
MEDIUM CLAY	9'-6''	10'-9"	8-#6X9'-0''	#3X90′	8-#6X10'-0''	#3X100′		
	(2.896 m)	(3.277 m)	(2.743 m)	(27.432 m)	(3.048 m)	(30.480 m)		
STIFF CLAY	7′-0′′	8'-0''	8-#6X6'-6''	#3X66′	8-#6X7'-6''	#3X76′		
	(2.134 m)	(2.438 m)	(1.981 m)	(20,112 m)	(2.286 m)	(23.165 m)		
LOOSE SAND 9'-0" (2.743 m)		10'-0''	8-#6X8'-6''	#3X85'	8-#6X9'-6''	#3X94'		
		(3.048 m)	(2.591 m)	(25.908 m)	(2.896 m)	(28.651 m)		
MEDIUM SAND	8'-3"	9'-0''	8-#6X8'-0''	#3X78'	8-#6X8'-6''	#3X85'		
	(2.515 m)	(2.743 m)	(2.438 m)	(23.774 m)	(2.591 m)	(25.908 m		
DENSE SAND	7′-9″	9'-0''	8-#6X7'-6"	#3X73′	8-#6X8'-6''	#3X85′		
	(2.362 m)	(2.743 m)	(2.286 m)	(22.250 m)	(2.591 m)	(25.908 m)		
ROCK OR SOLIDIFIED SLAG	5′-0′′ (1.524 m)	5'-0'' (1.524 m)	NONE	NONE	NONE	NONE		

NOTES

- 1. ALL DIMENSIONS ARE IN INCHES (MILLIMETERS) UNLESS OTHERWISE SHOWN.
- 2. THE ENGINEER SHALL DETERMINE THE CLASS OF SOIL DURING EXCAVATION AND SELECT THE DESIGN DEPTH OF FOUNDATION FROM THE DESIGN TABLE.
- 3. EXCAVATION OF THE POLE FOUNDATION SHALL BE MADE WITH AN AUGER. 24" (609.6 mm) OR 30" (762.0 mm) IN DIAMETER.
- 4. THE ANCHOR ROD SHALL BE A HOOK ROD TYPE, COLD BENDING OF THE ANCHOR ROD WILL NOT BE ALLOWED. THE RADIUS OF THE HOOK BEND SHALL NOT BE LESS THAN 4 TIMES THE NOMINAL DIAMETER OF THE ANCHOR ROD. A TACK WELDED ANCHOR ROD MAY BE SUBSTITUTED WITH THE APPROVAL OF THE ENGINEER.
- 5. THE ANCHOR BOLTS AND RACEWAYS SHALL BE PROPERLY SECURED IN PLACE BEFORE THE CONCRETE IS PLACED IN THE FORM.
- 6. THE ANCHOR RODS SHALL BE ACCORDING TO ASTM F1554 GRADE 725 (GRADE 105). NUTS SHALL BE HEXAGON NUTS ACCORDING TO ASTM A 194 2H OR ASTM A 563 DH, AND WASHERS SHALL BE ACCORDING TO ASTM F 436.
- 7. THE CONTRACTOR SHALL COORDINATE EXTENSION OF ANCHOR BOLTS ABOVE TOP OF FOUNDATION WITH THE BREAKAWAY DEVICE MANUFACTURER'S REQUIREMENTS. IF LIGHT POLE IS MOUNTED WITHOUT BREAKAWAY DEVICE, ANCHOR BOLTS SHALL PROJECT 23/4" (69.9 mm) ABOVE TOP OF THE FOUNDATION. THE CONTRACTOR SHALL CONFIRM ANCHOR BOLT EXTENTION WITH ENGINEER.
- 8. RACEWAYS SHALL PROJECT 1" (25.4 mm) ABOVE THE TOP OF THE FOUNDATION.
- 9. THE CABLE TRENCH SHALL BE BACKFILLED AND FIRMLY COMPACTED BEFORE THE LIGHT IS ERECTED.

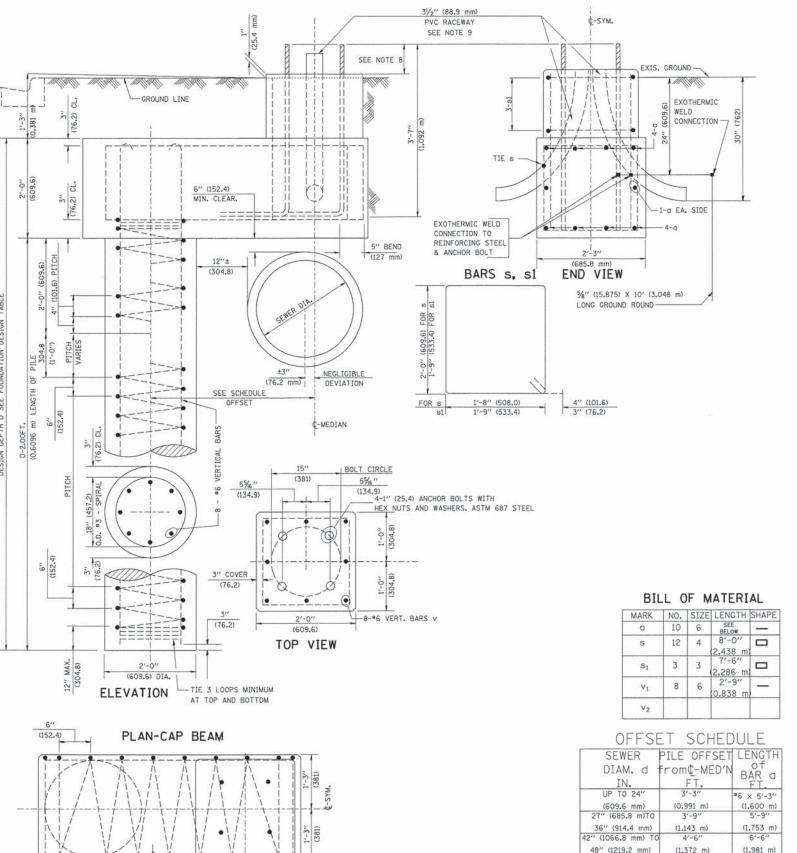

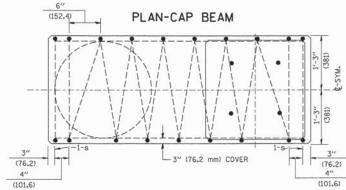


SCALE:

SEWER	PILE OFFSET	LENGTH
DIAM. d	from¢-MED'N	BAR a
IN.	FT.	FT.
UP TO 24"	3'-3"	*6 × 5'-3"
(609.6 mm)	(0.991 m)	(1.600 m)
27" (685.8 m)TO	3'-9"	5'-9"
36" (914.4 mm)	(1.143 m)	(1.753 m)
42" (1066.8 mm) TO	4'-6"	6'-6"
48" (1219.2 mm)	(1.372 m)	(1.981 m)
54" (1371.6 mm) TO	5'-0"	7'-0"
60" (1524.0 mm)	(1.524 m)	(2.134 m)
66" (1676.4 mm) TO	5′-6″	7'-6"
72" (1828.8 mm)	(1.676 m)	(2.286 m)

FILE NAME =	USER NAME = bauerdl	DESIGNED -	REVISED - 06-16-08 R. TOMSONS
K:\diststd22x34\be310.dgn		DRAWN -	REVISED -
	PLOT SCALE = 50.000 '/ IN.	CHECKED -	REVISED -
	PLOT DATE = 6/16/2008	DATE -	REVISED -

STATI	E OI	ILLINOIS
DEPARTMENT	0F	TRANSPORTATION

LIGHT POLE FOUNDATION OFFSET					F.A. RTE.	SECTION	COUNTY	TOTAL	SHEET NO.
40' (12.192 m) TO 47 1/2 ' (14.478 m) M.H. 15" (381 mm) BOLT CIRCLE		1343	13-00043-00-BR	KANE	65	50			
13 (301 IIIII) BOLT GINGLE			BE-310	CONTRAC	T NO. 61	C17			
SHEET NO.	1 OF	1 SHEETS	STA.	TO STA.	FED. ROAD	DIST. NO. 1 ILLINOIS FED.	AID PROJECT T	E-00D1(9)	27)

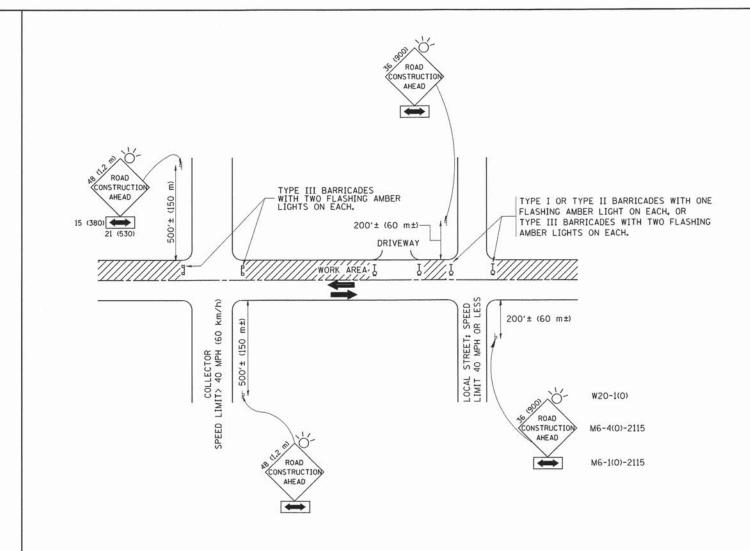

TRAFFIC CONTROL AND PROTECTION FOR SIDE ROADS, INTERSECTIONS, AND DRIVEWAYS

NOTES:

- A. FOR NO LANE RESTRICTION ON THE SIDE ROAD OR DRIVEWAYS
- SIDE ROAD WITH A SPEED LIMIT OF 40 MPH (60 km/h) OR LESS AS SHOWN ON THE DRAWING AND AS DIRECTED BY THE ENGINEER:
- O) ONE ROAD CONSTRUCTION AHEAD SIGN 36 x 36 (900x900) WITH A FLASHER AND FLAG MOUNTED ON IT APPROXIMATELY 200' (60 m) IN ADVANCE OF THE MAIN ROUTE.
- b) THE CLOSED PORTION OF THE MAIN ROUTE SHALL BE PROTECTED BY BLOCKING WITH TYPE I, TYPE II OR TYPE III BARRICADES, 1/3 OF THE CROSS SECTION OF THE CLOSED PORTION.
- 2. SIDE ROAD WITH A SPEED LIMIT GREATER THAN 40 MPH (60 km/h) AS SHOWN ON THE DRAWING AND AS DIRECTED BY THE ENGINEER:
- O) ONE ROAD CONSTRUCTION AHEAD SIGN 48 x 48 (1.2 m x 1.2 m) WITH A FLASHER MOUNTED ON IT APPROXIMATELY 500' (150 m) IN ADVANCE OF THE MAIN ROUTE.
- b) THE CLOSED PORTION OF THE MAIN ROUTE SHALL BE PROTECTED BY BLOCKING WITH TYPE III BARRICADES, 1/2 OF THE CROSS SECTION OF THE CLOSED PORTION.

SCALE: NONE

3. WHEN THE SIDE ROAD LIES BETWEEN THE BEGINNING OF THE MAINLINE SIGNING AND THE WORK ZONE, A SINGLE HEADED ARROW (MG-1) SHALL BE USED IN LIEU OF THE DOUBLE HEADED ARROW (MG-4).


- B. FOR A LANE CLOSURE ON A SIDE ROAD OR DRIVEWAY:
- USE APPLICABLE PORTIONS OF THE TYPICAL APPLICATION OF TRAFFIC CONTROL DEVICES (STD. 701501, STD. 701606 OR THE APPROPRIATE STANDARD), THE SPACING OF SIGNS AND BARRICADES SHALL BE ADJUSTED FOR FIELD CONDITIONS AS DIRECTED BY THE ENGINEER. THE DIRECTIONAL ARROW SHALL BE COVERED OR REMOVED WHEN NO LONGER CONSISTENT WITH THE SIDE ROAD LANE CLOSURE.
- C. ADVANCE WARNING SIGNS ARE TO BE OMITTED ON DRIVEWAY UNLESS OTHERWISE NOTED.
- D. THE TRAFFIC CONTROL AND PROTECTION FOR SIDE ROADS, INTERSECTIONS, AND DRIVEWAYS SHALL BE INCIDENTAL TO THE COST OF SPECIFIED TRAFFIC CONTROL STANDARDS OR ITEMS.


All dimensions are in millimeters (inches) unless otherwise shown.

FILE NAME =	USER NAME = gaglianobt	DESIGNED - LHA	REVISED - J. OBERLE 10-18-95
W:\diststd\22x34\tc10.dgn		DRAWN -	REVISED - A. HOUSEH 03-06-96
	PLOT SCALE = 50.000 ' / IN.	CHECKED -	REVISED - A. HOUSEH 10-15-96
	PLOT DATE = 1/4/2008	DATE - 06-89	REVISED -T. RAMMACHER 01-06-00


STATE	OF	ILLINOIS
DEPARTMENT	OF	TRANSPORTATION

TRAFFIC CONTROL AND PROTECTION FOR				F.A RTÉ.	SECTION	COUNTY	TOTAL	SHEET NO.	
				EWAVE	1343	1343 13-00043-00-BR		65	51
SIDE ROADS, INTERSECTIONS, AND DRIVEWAYS				TC-10	CONTRACT	NO. 6	C17		
	SHEET NO. 1 OF 1	SHEETS	STA.	TO STA.	FED. ROAD	DIST. NO. 1 ILLINOIS FED. A	ID PROJECT TE	-00D1(9)	27)

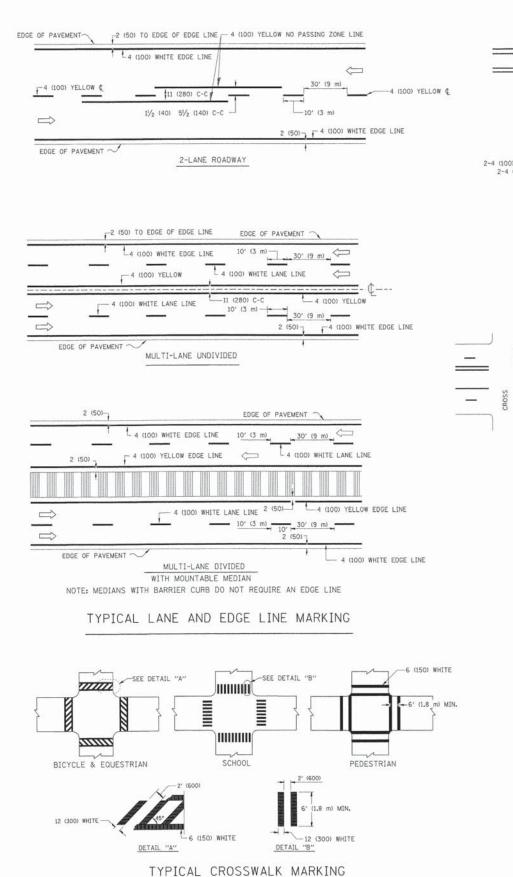

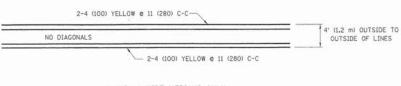


4' (1.2 m) WIDE MEDIANS ONLY

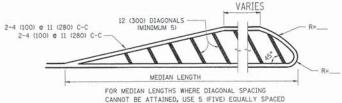

DIAGONAL LINE SPACING: 50' (15 m) C-C (LESS THAN 30MPH (50 km/h)) 75' (25 m) C-C 30MPH (50 km/h) TO 45MPH (70 km/h)) 150' (45 m) C-C (MORE THAN 45MPH (70 km/h))

MEDIANS OVER 4' (1.2 m) WIDE

DIAGONAL LINES.

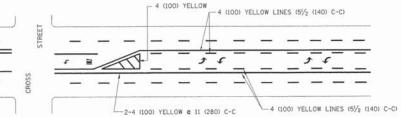


A MINIMUM OF TWO PAIRS OF TURN ARROWS SHALL BE USED, WHITE IN COLOR, ADDITIONAL PAIRS SHALL BE PLACED AT 200' (60 m) TO 300' (90 m) INTERVALS.



MEDIAN WITH TWO-WAY LEFT TURN LANE

TYPICAL PAINTED MEDIAN MARKING

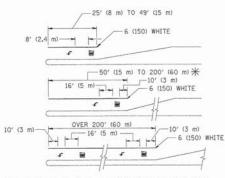


FULL SIZE LETTERS 8' (2.4 m) AND ARROWS SHALL BE USED. \P AREA = 15.6 SO, FT. (1.5 m²) \P AREA = 20.8 SO, FT. (1.9 m²)

** TURN LANES IN EXCESS OF 400' (120 m) IN LENGTH MAY HAVE AN ADDITIONAL SET OF ARROW - "ONLY" INSTALLED MIDWAY BETWEEN THE OTHER TWO SETS OF ARROW - "ONLY".

TYPICAL LEFT (OR RIGHT) TURN LANE

TYPICAL TURN LANE MARKING

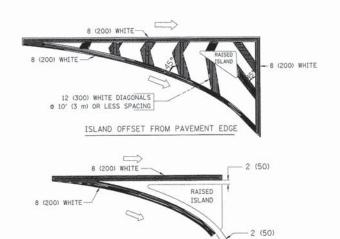

TYPICAL ISLAND MARKING

ISLAND AT PAVEMENT EDGE

TYPE OF MARKING	WIDTH OF LINE	PATTERN	COLOR	SPACING / REMARKS
CENTERLINE ON 2 LANE PAVEMENT	4 (100)	SKIP-DASH	YELLOW	10' (3 m) LINE WITH 30' (9 m) SPACE
CENTERLINE ON MULTI-LANE UNDIVIDED PAVEMENT	2 @ 4 (100)	SOLID	YELLOW	11 (280) C-C
NO PASSING ZONE LINES: FOR ONE DIRECTION FOR BOTH DIRECTIONS	4 (100) 2 @ 4 (100)	SOLID SOLID	YELLOW YELLOW	5½ (140) C-C FROM SKIP-DASH CENTERLINE 11 (280) C-C OMIT SKIP-DASH CENTERLINE BETWEEN
LANE LINES	4 (100) 5 (125) ON FREEWAYS	SKIP-DASH SKIP-DASH	WHITE WHITE	10' (3 m) LINE WITH 30' (9 m) SPACE
DOTTED LINES (EXTENSIONS OF CENTER, LANE OR TURN LANE MARKINGS)	SAME AS LINE BEING EXTENDED	SKIP-DASH	SAME AS LINE BEING EXTENDED	2' (600) LINE WITH 6' (1.8 m) SPACE
EDGE LINES	4 (100)	SOLID	YELLOW-LEFT WHITE-RIGHT	OUTLINE MOUNTABLE MEDIANS IN YELLOW: EDGE LINES ARE NOT USED NEXT TO BARRIER CURB
TURN LANE MARKINGS	6 (150) LINE: FULL SIZE LETTERS & SYMBOLS (8' (2.4m))	SOLID	WHITE	SEE TYPICAL TURN LANE MARKING DETAIL
TWO WAY LEFT TURN MARKING	2 @ 4 (100) EACH DIRECTION	SKIP-DASH AND SOLID	YELLOW	10' (3 m) LINE WITH 30' (9 m) SPACE FOR SKIP-DASH; 51/2 (140) C-C BETWEEN SOLID LINE AND SKIP-DASH LINE
	8' (2.4m) LEFT ARROW	IN PAIRS	WHITE	SEE TYPICAL TWO-WAY LEFT TURN MARKING DETAIL
CROSSWALK LINES (PEDESTRIAN) A. DIAGONALS (BIKE & EQUESTRIAN) B. LONGITUDINAL BARS (SCHOOL)	2 @ 6 (150) 12 (300) @ 45° 12 (300) @ 90°	SOLID SOLID	WHITE WHITE WHITE	NOT LESS THAN 6' (1.8 m) APART 2' (600) APART 2' (600) APART SEE TYPICAL CROSSWALK MARKING DETAILS.
STOP LINES	24 (600)	SOLID	WHITE	PLACE 4' (1.2 m) IN ADVANCE OF AND PARALLEL TO COSSMALK, IF PRESENT. OTHERWISE, PLACE AT DESIRED STOPPING POINT. PARALLEL TO CROSSROAD CENTERLINE, WHERE POSSIBLE
PAINTED MEDIANS	2 © 4 (100) WITH 12 (300) DIAGONALS © 45° NO DIAGONALS USED FOR 4' (1.2 m) WIDE MEDIANS	SOLID	YELLOW: TWO WAY TRAFFIC WHITE: ONE WAY TRAFFIC	11 (280) C-C FOR THE DOUBLE LINE SEE TYPICAL PAINTED MEDIAN MARKING.
GORE MARKING AND CHANNELIZING LINES	8 (200) WITH 12 (300) DIAGONALS @ 45°	SOLID	WHITE	DIAGONALS: 15' (4.5 m) C-C (LESS THAN 30MPH (50 km/h)) 20' (6 m) C-C 30MPH (50 km/h) TO 45MPH (70 km/h)) 30' (9 m) C-C (OVER 45MPH (70 km/h))
RAILROAD CROSSING	24 (600) TRANSVERSE LINES: "RR" IS 6' (1.8 m) LETTERS: 16 (400) LINE FOR "X"	SOLID	WHITE	SEE STATE STANDARD 780001 AREA 0F: "R"=3.6 SQ. FT. (0.33 m²) EACH "X"=54.0 SQ. FT. (5.0 m²)
SHOULDER DIAGONALS	12 (300) a 45°	SOLID	WHITE - RIGHT YELLOW - LEFT	50' (15 m) C-C (LESS THAN 30MPH (50 km/h)) 75' (25 m) C-C (30 MPH (50 km/h) TO 45MPH (70 km/h) 150' (45 m) C-C (OVER 45MPH (70 km/h))


FOR FURTHER DETAILS ON PAVEMENT MARKING REFER TO STANDARD SPECIFICATIONS FOR ROAD AND BRIDGE CONSTRUCTION AND STATE STANDARD 780001.

All dimensions are in inches (millimeters) unless otherwise shown.

FILE NAME =	USER NAME = drivakosgn	DESIGNED - EVERS	REVISED -T. RAMMACHER 10-27-94
c:\pw.work\pwidot\drivakosgn\	dØ108315\ta 3.dgn	DRAWN -	REVISED -C. JUCIUS 09-09-09
	PLOT SCALE = 50.000 ' / IN.	CHECKED -	REVISED -
	PLOT DATE = 9/9/2009	DATE - 03-19-90	REVISED -

STATE OF ILLINOIS DEPARTMENT OF TRANSPORTATION

				ISTRICT O	NF		F.A RTE.	SECTION	COUNTY	TOTAL	SHEET NO.
		77/17	_				1343	13-00043-00-BR	KANE	65	52
TYPICAL PAVEMENT MARKINGS						TC-13 CONTRACT NO. 61				IC17	
SCALE: NONE	SHEET N	10.1	OF 1	SHEETS	STA.	TO STA.	FED. ROAD	DIST. NO. 1 ILLINOIS FED.	AID PROJECT	TE-00D1(9	927)

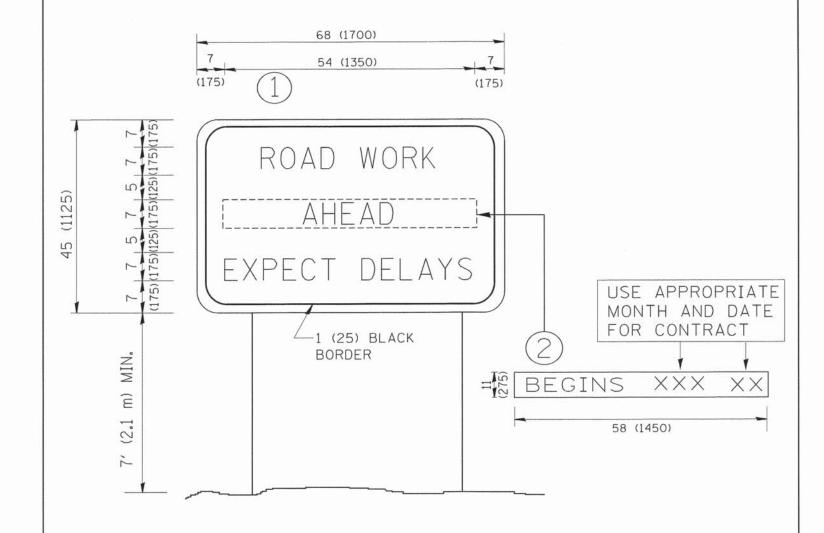

NOTES:

- 1. USE BLACK LETTERING ON ORANGE BACKGROUND.
- 2. ERECT SIGNS IN ADVANCE OF THE LOCATION FOR THE "ROAD CONSTRUCTION AHEAD" SIGN AT LOCATIONS AS DIRECTED BY THE ENGINEER.
- 3. ERECT SIGN (1) WITH INSTALLED PANEL (2) ONE WEEK PRIOR TO THE START OF CONSTRUCTION.
- 4. REMOVE PANEL (2) SOON AFTER THE START OF CONSTRUCTION.
- 5. SEE SPECIAL PROVISION FOR "TEMPORARY INFORMATION SIGNING" FOR ADDITIONAL INFORMATION.
- 6. ONE SIGN ASSEMBLY EQUALS 25.70 SQ. FT. (2.3 SQ. M.)
- 7. SHALL BE PAID FOR AS TEMPORARY INFORMATION SIGNING.

ALL DIMENSIONS ARE IN INCHES (MILLIMETERS) UNLESS OTHERWISE SHOWN.

FILE NAME =	USER NAME = gaglianobt	DESIGNED -	REVISED - R. MIRS 09-15-97		ARTERIAL ROAD		F.A RTE.	SECTION	COUNTY	TOTAL SHEET SHEETS NO.
W:\diststd\22x34\to22.dgn		DRAWN -	REVISED - R. MIRS 12-11-97	STATE OF ILLINOIS				13-00043-00-BR	KANE	65 53
	PLOT SCALE = 50.000 '/ IN.	CHECKED -	REVISED - T. RAMMACHER 02-02-99	DEPARTMENT OF TRANSPORTATION	INFORMATION SIGN			TC-22	CONTRACT NO. 61C17	
	PLOT DATE = 1/4/2008	DATE -	REVISED - C. JUCIUS 01-31-07		SCALE: NONE	SHEET NO. 1 OF 1 SHEETS STA. TO STA.	FED. ROA	FED. ROAD DIST. NO. 1 ILLINOIS FED. AID PROJECT T		E-00D1(927)

