INDEX OF SHEETS 01-15-2016 LETTING ITEM 015

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- HIGHWAY STANDARDS, GENERAL NOTES AND COMMITMENTS
- SUMMARY OF QUANTITIES
- TRAFFIC SIGNAL PLAN
- TRAFFIC SIGNAL CABLE PLAN AND QUANTITIES
- TRAFFIC SIGNAL SEQUENCE OF OPERATION
- RAILROAD PREEMPTION SEQUENCE OF OPERATION

STATE OF ILLINOIS **DEPARTMENT OF TRANSPORTATION DIVISION OF HIGHWAYS**

PROPOSED HIGHWAY PLANS

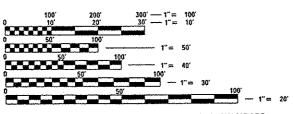
F.A.U. ROUTE 6405 (LINDEN ST) SECTION 03-00221-02-RP PROJECT HSR - 6405 (001) TRAFFIC SIGNAL AND RAILROAD INTERCONNECT MODIFICATIONS CH 37 (LINDEN STREET) AND COLLEGE AVENUE McLEAN COUNTY /TOWN OF NORMAL

C-95-036-15

URBAN MINOR ARTERIAL 2013 ADT = 11,400DESIGN SPEED = 40 MPH P.V. = NA S.U. = NA M.U. = NA

FUNCTIONAL CLASSIFICATION

LOCATION OF PROJECT



ENGINEERING SCALES, REDUCED SIZED PLANS WILL NOT CONFORM TO STANDARD SCALES. IN MAKING MEASUREMENTS ON REDUCED PLANS, THE ABOVE SCALES MAY BE USED.

J.U.L.I.E.

JOINT UTILITY LOCATION INFORMATION FOR EXCAVATION 1-800-892-0123

DISTRICT 5 NO. (217) 465-4181 PROJECT ENGINEER: **UNIT CHIEF: TOWNSHIP: NORMAL CONTRACT NO. 70B36**

SECTION 28 SECTION 27

TOWN OF NORMAL

AECOM TECHNICAL SERVICES
303 EAST WACKER DRIVE, SUITE 1400
CHICAGO, ILLINOIS 60601
PH. 312-373-7700

LOCATION MAP NOT TO SCALE

DATE: 08/21/2015

MATTHEW J. LETOURNEAU, P.E. LICENSE NO.: 062-055763

EXPIRES: NOVEMBER 30, 2015

COUNTY TOTAL SHEET NO.

Motean 7 1 03-00221-02-RP CONTRACT NO. 70B36

D-95-036-15

DOT# 290810P MP 123.98



STATE OF ILLINOIS DEPARTMENT OF TRANSPORTATION DIVISION OF HIGHWAYS SUBMITTED October 14 20 15 DEPUTY DIRECTOR OF HIGHWAYS, REGION ENGINEER De Caron and Environment be 20 15 amer asmon, PE. Ja

PRINTED BY THE AUTHORITY OF THE STATE OF ILLINOIS

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HIGHWAY STANDARDS

00000)-06	STANDARD SYMBOLS, ABBREVIATIONS AND PATTERNS
001006	DECIMAL OF AN INCH AND OF A FOOT
701011-04	OFF-ROAD MOVING OPERATIONS, 2L, 2W, DAY ONLY
701301-04	LANE CLOSURE. 2L, 2W, SHORT TIME OPERATIONS
701501-06	URBAN LANE CLOSURE, 2L, 2W, UNDIVIDED
701701-09	URBAN LANE CLOSURE, MULTILANE INTERSECTION
701801-05	SIDEWALK, CORNER OR CROSSWALK CLOSURE
701901-04	TRAFFIC CONTROL DEVICES
805001-01	ELECTRICAL SERVICE INSTALLATION DETAILS
814001-03	HANDHOLES
814006-02	DOUBLE HANDHOLES
857001-01	STANDARD PHASE DESIGNATION DIAGRAMS AND PHASE SEQUENCES
857006-01	SUPERVISED RAILROAD INTERCONNECT CIRCUIT
862001-01	UNINTERRUPTABLE POWER SUPPLY (UPS)

CONCRETE FOUNDATION DETAILS

COMMITMENTS

NONE. JULY 17, 2015

878001-10

GENERAL NOTES

NO WORK SHALL COMMENCE UNTIL TRAFFIC CONTROL REQUIREMENTS ARE MET. THE CONTRACTOR SHALL DEVELOP A PLAN TO ACCOMPLISH THIS WORK AND MINIMIZE DISRUPTION OF VEHICULAR, RAIL, AND PEDESTRIAN TRAFFIC. THIS PLAN SHALL BE SUBMITTED TO THE ENGINEER FOR APPROVAL.

ALL UTILITIES, SCHOOL DISTRICTS, LOCAL POLICE, AND FIRE DEPARTMENTS SHALL BE NOTIFIED BY THE CONTRACTOR A MINIMUM OF 48 HOURS PRIOR TO THE START OF CONSTRUCTION,

THE CONTRACTOR SHALL BE REQUIRED TO PROVIDE AND MAINTAIN ACCESS TO ABUTTING PROPERTIES AT ALL TIMES DURING CONSTRUCTION OF THE PROJECT.

THE CONTRACTOR SHALL BE REQUIRED TO COMPLY WITH STATE REGULATIONS REGARDING AIR, WATER. AND NOISE POLLUTION.

IT SHALL BE THE CONTRACTOR'S RESPONSIBILITY TO DETERMINE THE ACTUAL LOCATION OF ALL UNDERGROUND UTILITY FACILITIES. HE SHALL ALSO OBTAIN FROM THE RESPECTIVE UTILITY COMPANIES DETAILED INFORMATION RELATIVE TO THE LOCATION OF THEIR FACILITIES AND THE WORKING SCHEDULES OF THE UTILITY COMPANIES FOR THEIR MARKING OF THE EXACT LOCATION PRIOR TO CONSTRUCTION,

BEFORE STARTING ANY WORK, THE CONTRACTOR SHALL CALL "JULIE" AT 1-800-892-0123 OR 811 FOR FIELD LOCATIONS OF BURIED ELECTRIC, TELEPHONE, AND GAS FACILITIES (MINIMUM 48 HOURS NOTIFICATION IS REQUIRED). THE CONTRACTOR SHALL CALL THE UNION PACIFIC "CALL BEFORE YOU DIG" OPERATION AT 1-800-336-9193 FOR FIELD LOCATIONS OF UNION PACIFIC OWNED BURIED FIBER OPTIC CABLES IN UNION PACIFIC RIGHT OF WAY.

MEMBERS OF "JULIE" KNOWN TO BE WITHIN THE VICINITY OF THE IMPROVEMENT ARE:

- 1. SPRINT (FO)
- 2. LEVEL 3 COMMUNICATIONS (FD)
- 3. FRONTIER COMMUNICATIONS (FO)
- 4. AMEREN (G) (E)
- 5. CENTRAL ILLINOIS REGIONAL BROADBAND NETWORK (FO)
- 6. NICOR (G)
- 7. COMCAST (FO) (A)
- 8. WINDSTREAM (FD)
- 9. TOWN OF NORMAL (W) (STORM SEWER) (SANITARY SEWER) (FO) (A)
- 10. CITY OF BLOOMINGTON (W)
- 11. STATE OF ILLINOIS CMS (FQ)

NON-"JULIE" MEMBERS WITHIN THE VICINITY OF THE IMPROVEMENT ARE:

1. UNION PACIFIC RAILROAD COMPANY (U.P.R.R.)

THE CONTRACTOR SHALL COORDINATE WITH THE UPRR SIGNAL DEPARTMENT FOR ITEMS REMOVED OR INSTALLED BY THE UPRR SIGNAL DEPARTMENT.

U.P.R.R. FLAGGERS SHALL BE PRESENT WHEN WORKING WITHIN THE U.P.P.R. RIGHT-OF-WAY. THE CONTRACTOR SHALL COORDINATE DIRECTLY WITH THE THE U.P.P.R. TO ASSURE THAT FLAGGERS ARE PRESENT DURING CONSTRUCTION. NO ADDITIONAL COMPENSATION WILL BE ALLOWED.

FOR STABILIZATION, ALL TYPE III BARRICADES (WHERE NEEDED) SHALL REDUIRE A MINIMUM OF FOUR SAND BAGS PER BARRICADE.

SEEDING SHALL NOT BE PERMITTED AT ANY TIME WHEN THE GROUND IS FROZEN, WET OR IN AN UNTILLABLE CONDITION, THE AREAS TO BE SEEDED SHALL CONSIST OF ALL DISTURBED EARTH SURFACES WITHIN THE RIGHT-OF-WAY, LOCATIONS TO BE SEEDED WILL BE DETERMINED BY THE

ABANDONED UNDERGROUND UTILITIES THAT CONFLICT WITH CONSTRUCTION SHALL BE DISPOSED OF OUTSIDE THE LIMITS OF THE RIGHT OF WAY ACCORDING TO ARTICLE 202.03 OF THE STANDARD SPECIFICATIONS AND AS DIRECTED BY THE ENGINEER. THIS WORK WILL NOT BE PAID FOR SEPARATELY, BUT SHALL BE INCLUDED IN THE COST OF "MODIFY EXISTING CONTROLLER FOUNDATION".

ANY REFERENCE TO A STANDARD IN THESE PLANS SHALL BE INTERPRETED TO MEAN THE EDITION AS INDICATED BY THE SUB NUMBER SHOWN IN THE LIST OF HIGHWAY STANDARDS INCLUDED ON THIS SHEET OR REFERENCED IN THESE PLANS.

THE CONTRACTOR SHALL KEEP EXISTING ADJACENT STREETS CLEAN OF DIRT, MUD. AND OTHER DEBRIS AND, WHEN NECESSARY, CLEAN SAID PAVEMENTS ON A DAILY BASIS OR WHEN DIRECTED BY THE ENCINEER, NO EXTRA COMPENSATION SHALL BE ALLOWED THE CONTRACTOR FOR THIS WORK.

THE FURNISHING, INSTALLATION, RELOCATION AND REMOVAL OF ALL TRAFFIC CONTROL SIGNS, DETOUR SIGNS, AND TRAFFIC CONTROL DEVICES SHOWN ON THE APPLICABLE IDOT TRAFFIC CONTROL STANDARDS SHALL BE PAID FOR UNDER THE PAY ITEM "TRAFFIC CONTROL AND PROTECTION, (SPECIAL)". THE CONTRACTOR SHALL PROVIDE ANY ADDITIONAL SIGNS AS REQUIRED BY THE ENGINEER, THE COST OF WHICH WILL ALSO BE INCLUDED IN "TRAFFIC CONTROL AND PROTECTION, (SPECIAL)".

THE SCALE SHOWN ON THE DRAWINGS APPLIES ONLY TO FULL SIZE PLANS AND NOT TO THE REDUCED SIZE PLANS. REDUCED SIZED PLANS CAN BE PRINTED TO SCALE FOR USE IN THE FIELD.

WHERE ENCOUNTERED, THE ENGINEER SHALL BE NOTIFIED OF ANY SECTION OR SUB-SECTION MONUMENTS, BEFORE SUCH MONUMENTS ARE REMOVED. THE CONTRACTOR SHALL PROTECT AND CAREFULLY PRESERVE ALL PROPERTY MARKERS AND MONUMENTS UNTIL THE DWNER OR AN AUTHORIZED SURVEYOR OR AGENT HAS WITNESSED OR OTHERWISE REFERENCED THEIR LOCATION.

*		
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STATE OF ILLINOIS DEPARTMENT OF TRANSPORTATION

HIGHWAY STANDARDS, GENERAL							AL		
			NOT	ES	AND	COMM	IITMENTS	•	
SCALE:	NTS	SHEET	1	0F	i	SHEETS	STA.	τo	STA.

F.A.U. RTE,	SECTION	COUNTY	TOTAL SHEETS	SHEET NQ.				
6405	03-00221-02-RP	MCLEAN	7	2				
CONTRACT NO. 70836								
	THE INDIS FED. A	ID PROJECT						

SUMMARY OF QUANTITIES

FAU 6405 URBAN MCLEAN CO. TRAFFIC SIGNALS

CODE	17711	1 1 1 1 1 1	TOTAL	
NO.	I TEM	UNIT	QUANTITY	0021
42400200	PORTLAND CEMENT CONCRETE SIDEWALK 5"	SO.FT.	436	436
44000600	SIDEWALK REMOVAL	SO. FT.	436	436
67100100	MOBILIZATION	L SUM	1	The state of the s
72000100	SIGN PANEL - TYPE 1	SO FT	10	10
81028350	UNDERGROUND CONDUIT, PVC, 2" DIA.	FOOT	203	203
81400700	HANDHOLE, PORTLAND CEMENT CONCRETE	EACH	1	1
87301750	ELECTRIC CABLE IN CONDUIT, RAILROAD, NO. 14 3C	FOOT	396	396
87900200	DRILL EXISTING HANDHOLE	EACH	1	1
89502215	MODIFY EXISTING CONTROLLER FOUNDATION	EACH	1	1
89502300	REMOVE ELECTRIC CABLE FROM CONDUIT	FOOT	396	396
X7010216	TRAFFIC CONTROL AND PROTECTION. (SPECIAL)	L SUM	1	1
			- ·	
X8571215	RAILROAD, FULL ACTUATED CONTROLLER AND TYPE IV CABINET, SPECIAL	EACH	1	1
X8620200	UNINTERRUPTIBLE POWER SUPPLY, SPECIAL	EACH	1	1
X8950105	REMOVE EXISTING TRAFFIC CONTROLLER AND CABINET	EACH	1	1
Z0048665	RAILROAD PROTECTIVE LIABILITY INSURANCE	L SUM	1	1

DESIGNED MRF
DRAWN MRF REVISED -USER NAME = #USER# PLOT SCALE * *SCALE*
PLOT DATE * *DATE* CHECKED MUL REVISED -DATE REVISED -08/21/2015

STATE OF ILLINOIS DEPARTMENT OF TRANSPORTATION

SUMMARY OF QUANTITIES SHEET 1 OF 1 SHEETS STA.

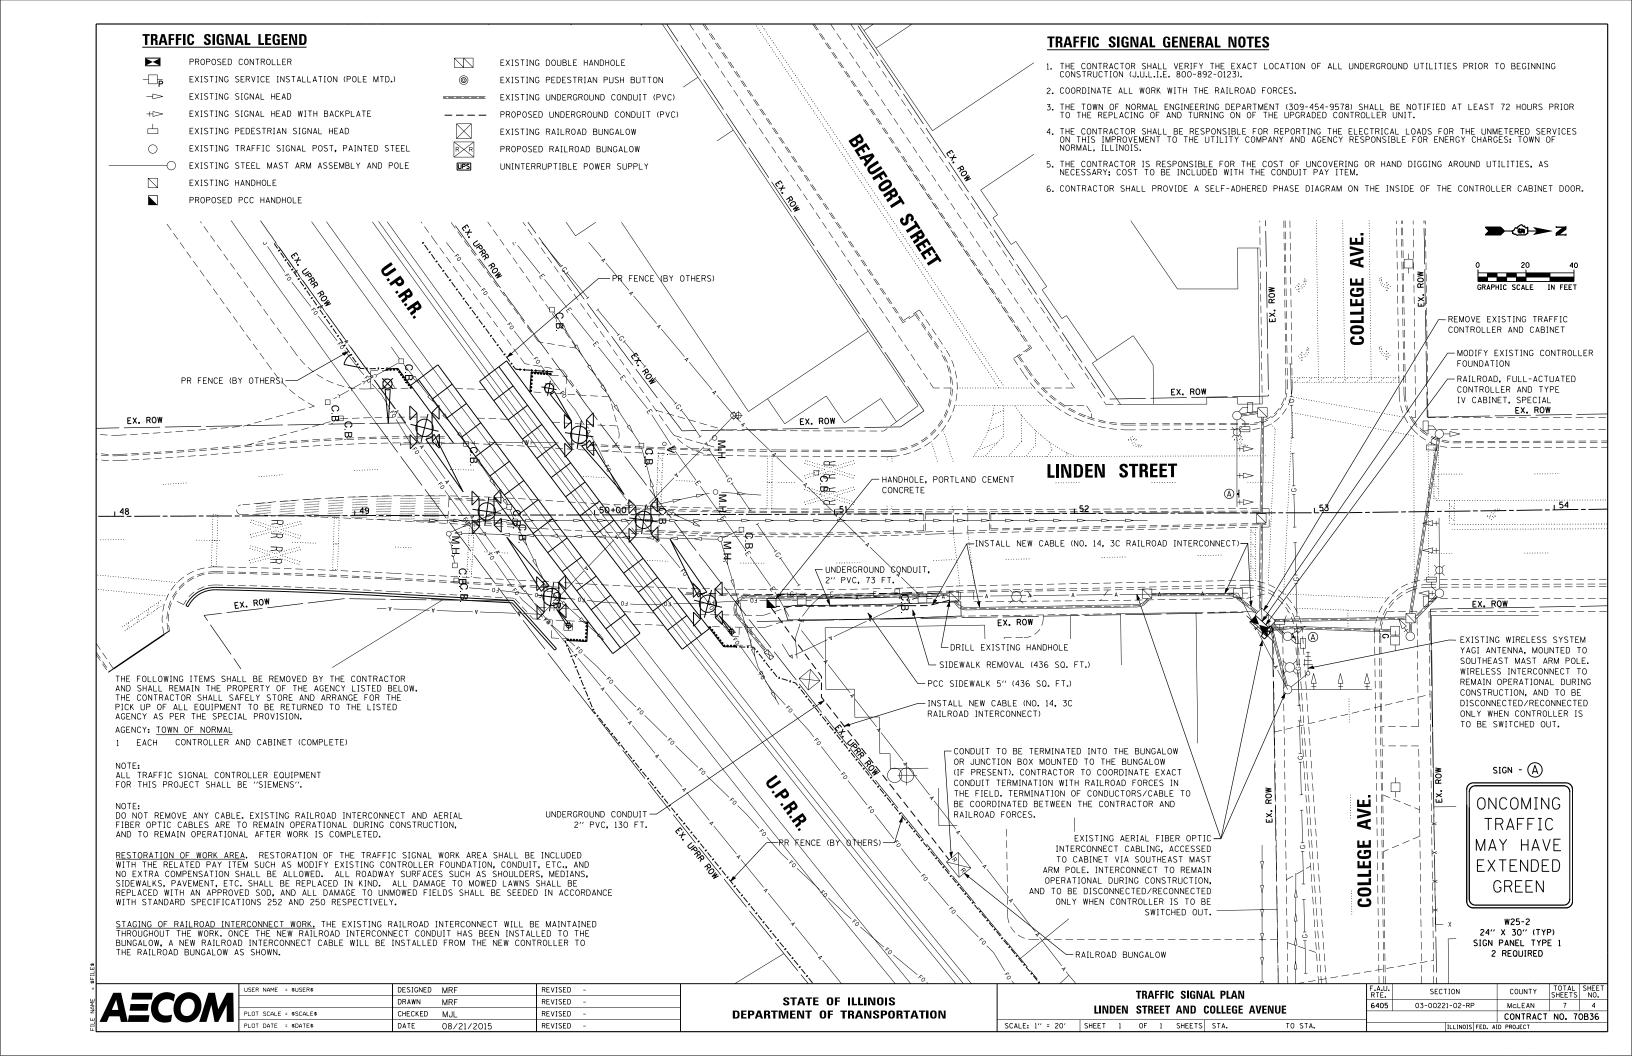
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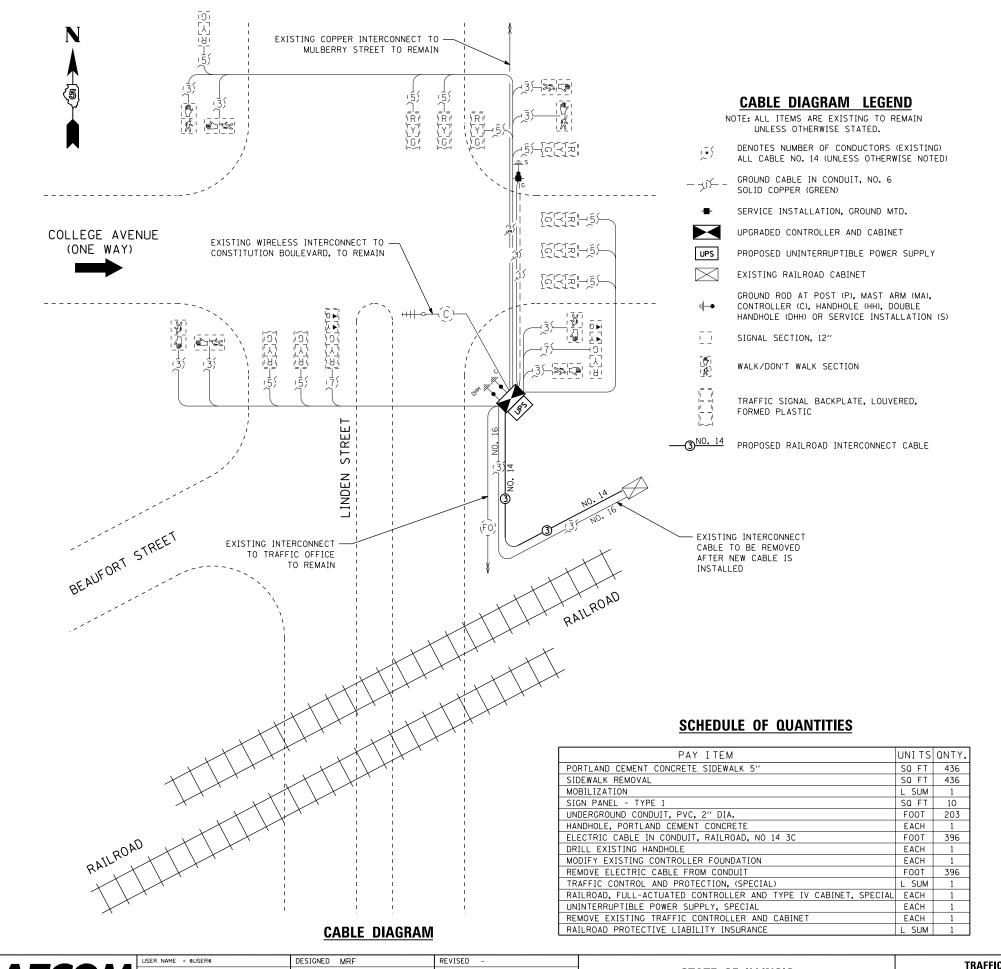
SECTION COUNTY TOTAL SHEET NO.

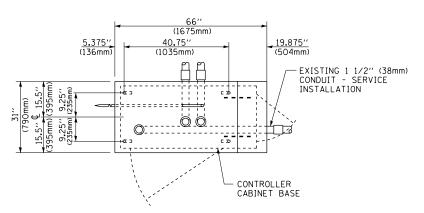
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CONTRACT NO. 70836

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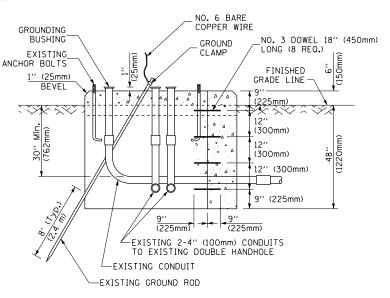




NOTE:

TOP OF FOUNDATION SHALL BE HIGHER THAN TOP OF DOUBLE HANDHOLE

TOP VIEW



MODIFY EXISTING TYPE "D" FOUNDATION TO TYPE "C" FOUNDATION FOR GROUND MOUNTED SUPER P (TYPE IV) AND SUPER R (TYPE V) CONTROLLER CABINETS

NOTES:

- 1. FURNISH AND INSTALL A 20 AMP, 1 POLE, 120VAC, 10,000 A/C AT 120VAC CIRCUIT BREAKER FOR DUPLEX RECEPTACLES, AND A U.L. LISTED GROUNDED THREE-WIRE, 120VAC, 20 AMP GROUND FAULT INTERRUPTER TYPE DUPLEX RECEPTACLE (NEMA 5-20R) ALL LOCATED IN THE CONTROLLER CABINET.
- 2. CONTROLLER SPECIFIED: FULL-ACTUATED CONTROLLER, STANDARD SEQUENCE II, 8 PHASE, IN TYPE IV "SUPER P" CABINET.
- 3. THE TRAFFIC SIGNAL CONTROLLER SHALL HAVE REMOTE MONITORING CAPABILITES INCLUDING ALL NECESSARY PERIPHERAL HARDWARE SUCH AS INTERSECTION MONITOR, ETC. TO ALLOW FOR BOTH REMOTE ACCESS AND AUTOMATIC CONTROLLER REPORTING OF ALARMS. THE COST OF THE NECESSARY ADDITIONAL HARDWARE SHALL BE INCLUDED IN THE UNIT PRICE FOR "RAILROAD, FULL-ACTUATED CONTROLLER AND TYPE IV CABINET (SPECIAL)."
- 4. CARE SHOULD BE TAKEN DURING MODIFICATION OF THE EXISTING FOUNDATION TO NOT DAMAGE THE EXISTING SERVICE CONDUIT, SERVICE CABLE AND FIBER OPTIC CABLING.

STAGING OF TRAFFIC SIGNAL CONTROLLER REPLACEMENT AND CABINET MODIFICATIONS. THE EXISTING TRAFFIC SIGNAL CABINET FOUNDATION IS TO BE MODIFIED AS SHOWN WHILE THE EXISTING TRAFFIC SIGNAL CONTROLLER MAINTAINS ITS' CURRENT OPERATION. ONCE THE FOUNDATION MODIFICATIONS ARE COMPLETE AND ALL NEW CONTROLLER AND CABINET MATERIALS ARE PRESENT, THE CONTROLLER AND CABINET (COMPLETE) ARE TO BE REMOVED AND THE NEW CONTROLLER AND CABINET ARE TO BE INSTALLED. THE CONTRACTOR IS RESPONSIBLE FOR PROVIDING TRAFFIC CONTROL AT THE INTERSECTION TO THE SATISFACTION OF THE ENGINEER DURING THE CHANGEOVER.



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STATE OF ILLINOIS
DEPARTMENT OF TRANSPORTATION

TR							QUANTITIES AVENUE
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SCALE: NTS

F.A.U. RTE.	SECTION		COUNTY	SHEETS	SHEE NO.
6405	03-00221-02-RF	,	McLEAN	7	5
			CONTRACT	NO. 7	0B36
	ILLINOIS	FED. A	D PROJECT		

SEQUENCE OF OPERATION

MOVEMENT		COLLEGE -	1338615	AVENUE			COLLE	139415 N39417	† AVEMA	 KE 		corr	ECE —	AVEA	ue —	
PHASE			1 + 6					2 -	+ 6					4		F Ļ
INTERVAL	1	2	3	4A	4B	5	6	7A	7B	8.8	8B	9	10	11	12	L A S H
CHANGE TO	8	8	2 + 6	4	*	8	8		4	1 +	· 6*			1 -	- 6 + 6	
LINDEN STREET S/B END MAST ARM AND FAR LEFT SIGNALS	_C _C	G _C	GY	Y	R	G	G	Υ	R	G	G	R	R	R	R	R
LINDEN STREET S/B MID & FAR RIGHT MAST ARM, NEAR RIGHT SIGNALS	G	G	G	Y	R	G	G	Y	R	G	G	R	R	R	R	R
LINDEN STREET N/B ALL SIGNALS	R	R	R	R	R	G	G	Υ	R	Y	R	R	R	R	R	R
COLLEGE AVENUE E/E ALL SIGNALS	R	R	R	R	R	R	R	R	R	R	R	G	G	Υ	R	R
PEDESTRIAN SIGNALS CROSSING COLLEGE AVENUE ON WEST SIDE OF LINDEN STREET	Р	**FH	Н	Н	Н	Р	**FH	Н	Н	Н	Н	Н	Н	Н	Н	0
PEDESTRIAN SIGNALS CROSSING COLLEGE AVENUE ON EAST SIDE OF LINDEN STREET	Н	Н	Н	Н	Н	Р	**FH	Н	Н	Н	Н	Н	Н	Н	Н	D A R
PEDESTRIAN SIGNALS CROSSING LINDEN STREET ON BOTH SIDES OF COLLEGE AVENUE	Н	Н	Н	Н	Н	Н	Н	Н	Н	Н	Н	Р	**FH	Н	Н	К

PHASE 2 + 6 SHALL BE PLACED ON RECALL

- * = TO APPEAR ONLY UPON PUSHBUTTON ACTUATION
- •• = FLASHING "DON'T WALK" IS TO TERMINATE AT THE COMPLETION OF THE PEDESTRIAN INTERVAL CLEARANCE.
- P = ILLUMINATED PERSON = WALK
- FH = ILLUMINATED FLASHING HAND = FLASHING DON'T WALK
- H = ILLUMINATED SOLID HAND = DON'T WALK
- \[
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- * = SB LEFT TURN INDICATION MAY OPERATE AS A LEAD OR A LAG, BASED ON COORDINATION PLAN.



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COUNTY TOTAL SHEET NO.

MCLEAN 7 6

CONTRACT NO. 70B36

RAILROAD PREEMPTION SEQUENCE OF OPERATION

							PREEMPTOR NUMBER 2						
CHANGE FROM NORMAL SEQUENCE OF OPERATION INTERVAL NUMBER	1		6		10								
RAILROAD PREEMPTION SEQUENCE OF OPERATION INTERVAL NUMBER	1 A	1B	1C	1D	1E	1F	2	3	4	5	6	7	CLEAR TO
CHANGE TO RAILROAD PREEMPTION SEQUENCE OF OPERATION INTERVAL NUMBER	1B	2	1D	2	1F	2	3	4	5	6	7		NORMAL SEQUENCE
LINDEN STREET S/B END MAST ARM AND FAR LEFT SIGNALS	Y	R	Y	R	R	R	R	R	R	R	R	R	Δ
LINDEN STREET S/B MID & FAR RIGHT MAST ARM, NEAR RIGHT SIGNALS	Y	R	Y	R	R	R	R	R	R	R	R	R	Δ
LINDEN STREET N/B ALL SIGNALS	R	R	G	G	R	R	G	Υ	R	R	R	R	Δ
COLLEGE AVENUE E/B ALL SIGNALS	R	R	R	R	Y	R	R	R	R	G	Y	R	Δ
PEDESTRIAN SIGNALS CROSSING COLLEGE AVENUE ON WEST SIDE OF LINDEN STREET	FH	Н	FH	Н	Н	Н	Н	Н	Н	Н	Н	Н	Δ
PEDESTRIAN SIGNALS CROSSING COLLEGE AVENUE ON EAST SIDE OF LINDEN STREET	Н	Н	FH	Н	Н	Н	Н	Н	Н	Н	Н	Н	Δ
PEDESTRIAN SIGNALS CROSSING LINDEN STREET ON BOTH SIDES OF COLLEGE AVENUE	Н	Н	Н	Н	FH	Н	Н	Н	Н	Н	Н	Н	Δ
												HOLD	

P = ILLUMINATED PERSON = WALK

FH = ILLUMINATED FLASHING HAND = FLASHING DON'T WALK

H = ILLUMINATED SOLID HAND = DON'T WALK

- * = TO APPEAR ONLY UPON PUSHBUTTON ACTUATION
- •• = FLASHING "DON'T WALK" IS TO TERMINATE AT THE COMPLETION OF THE PEDESTRIAN INTERVAL CLEARANCE.

☐ = RAILROAD PREEMPTION SEQUENCE SHALL PROVIDE THE PROPER CLEARANCE INTERVAL TO RESUME THE NORMAL SEQUENCE OF OPERATION OR PROPER CLEARANCE INTERVAL TO DISPLAY AN EMERENCY VEHICLE INTERVAL (IF APPLICABLE) AFTER RAILROAD INTERVAL 7 IS TERMINATED.

NOTES

- 1. ONCE PREEMPTION HAS BEEN CALLED, THE TRACK CLEAR SIGNAL DISPLAY SHALL APPEAR IMMEDIATELY AFTER ALL NECESSARY VEHICULAR CLEARANCES HAVE BEEN PROVIDED.
- 2. RAILROAD PREEMPTION WILL TERMINATE ACTIVE PEDESTRIAN PHASES IMMEDIATELY. PEDESTRIAN CLEARANCES WILL BE ABBREVIATED.
- 3. THE RAILROAD PREEMPTION SEQUENCE OF OPERATION SHALL HAVE PRIORITY OVER ALL OTHER SEQUENCES OF OPERATION.

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	R/	AILROAD	PF	REEMI	PTI	ON SEQU	JENCE	OF OPERATION
		LINE	EN	STR	EET	AND C	OLLEGE	AVENUE
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