



WETLAND SITE 1 TOTAL AREA = 0.19 AC  
 WETLAND AREA WITHIN EX ROW, 0.02 AC  
 WETLAND IMPACTED AREA, 0.05 AC  
 WATERS OF THE U.S. IMPACTED AREA, 0.05 AC  
 TOTAL IMPACTED AREA = 0.10 AC (PERMANENT)

NOTE: MINIMUM LENGTH OF CLASS 4 SEEDING BUFFER IS 100'.

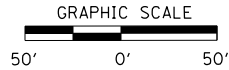

**LEGEND**

- EROSION CONTROL BLANKET, CLASS 2A SEEDING
- HEAVY DUTY EROSION CONTROL BLANKET, CLASS 4 SEEDING
- WETLAND IMPACTS
- TEMPORARY DITCH CHECK
- INLET AND PIPE PROTECTION
- PERIMETER EROSION BARRIER

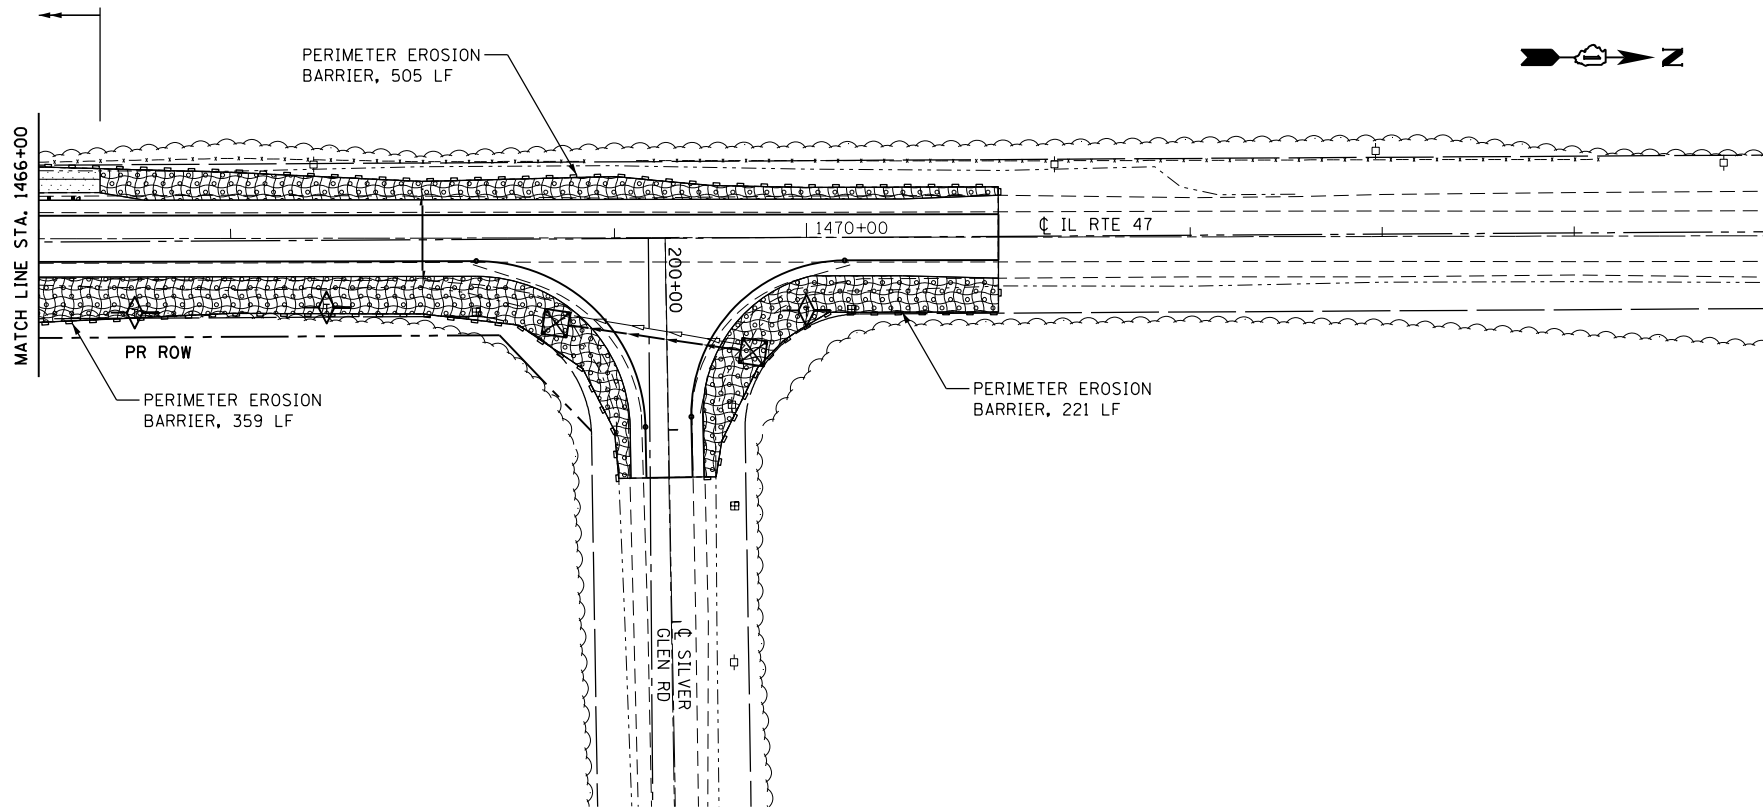

FILE NAME = D:\60N13-sht-erosudgn  
 MODEL = Default  
 PLOT DRIVER = V8i\_PDF...1x17.pltcf9



USER NAME = mmann	DESIGNED - CMM	REVISED -
PLOT SCALE = 100.0000' / 1"	DRAWN - CMM	REVISED -
PLOT DATE = 10/24/2012	CHECKED - MTM	REVISED -
	DATE - 10/12	REVISED -

**STATE OF ILLINOIS  
 DEPARTMENT OF TRANSPORTATION**

**IL ROUTE 77 OVER VIRGIL DITCH #2  
 EROSION & SEDIMENT CONTROL PLAN**

SCALE: 1"=50' SHEET NO. 1 OF 1 SHEETS STA. 1451+50 TO STA. 1475+00

F.A.P. RTE.	SECTION	COUNTY	TOTAL SHEETS	SHEET NO.
326	106X-B	KANE	87	25
CONTRACT NO. 60N13				
ILLINOIS FED. AID PROJECT				