
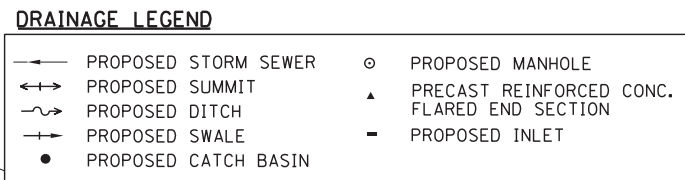



PLAN	SURVEYED	DATE
	PLOTTED	
	GRADES CHECKED	
	STRUCTURE NOTATIONS OK'D	
	NO. _____	

PROFILE	SURVEYED	DATE
	PLOTTED	
	GRADES CHECKED	
	STRUCTURE NOTATIONS OK'D	
	NO. _____	

18-03-2012 12:28:47
 M:\MANHAMA
 F:\DDE\EXP\CH\80022584-02\COMMON\PE\TEMP\SHEET.PLOT\01050935-SHT-DRAIN\PRF_06.DGN

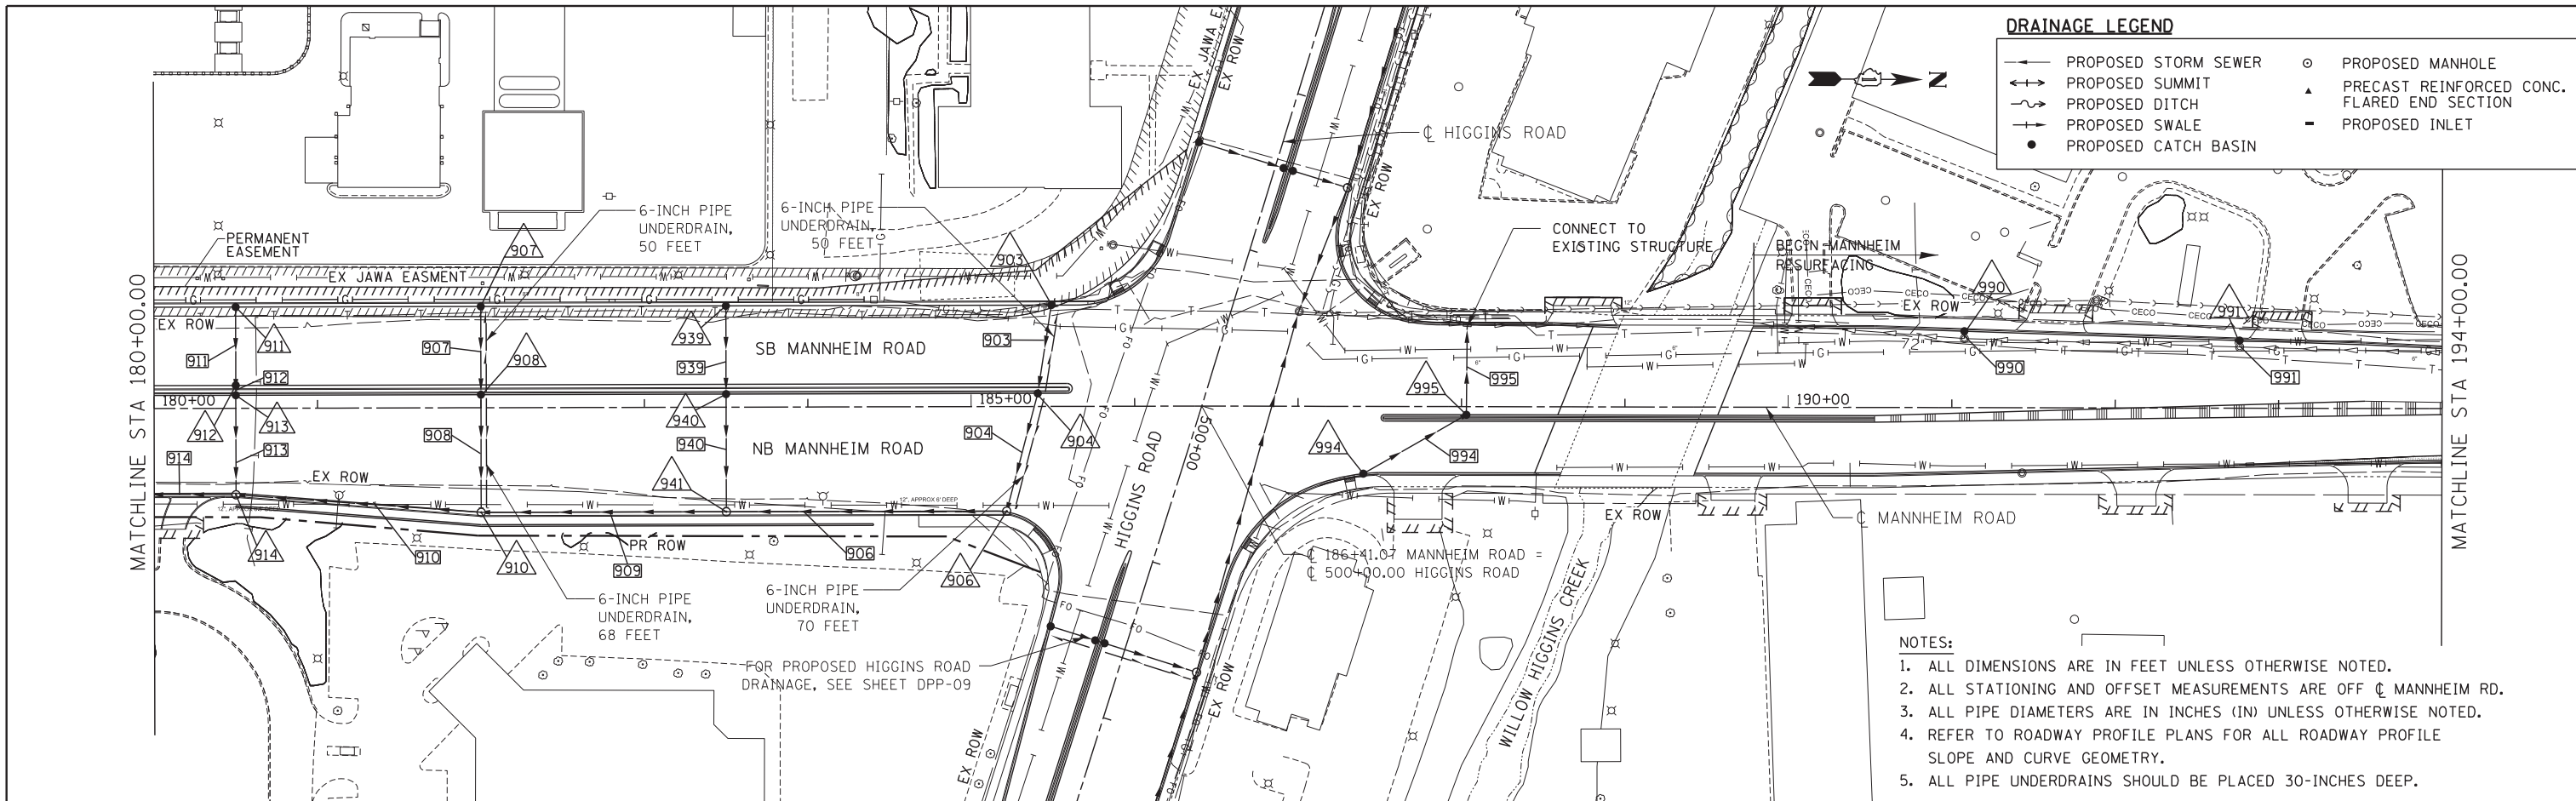

- NOTES:**
1. ALL DIMENSIONS ARE IN FEET UNLESS OTHERWISE NOTED.
 2. ALL STATIONING AND OFFSET MEASUREMENTS ARE OFF ϕ MANNHEIM RD.
 3. ALL PIPE DIAMETERS ARE IN INCHES (IN) UNLESS OTHERWISE NOTED.
 4. REFER TO ROADWAY PROFILE PLANS FOR ALL ROADWAY PROFILE SLOPE AND CURVE GEOMETRY.
 5. ALL PIPE UNDERDRAINS SHOULD BE PLACED 30-INCHES DEEP.

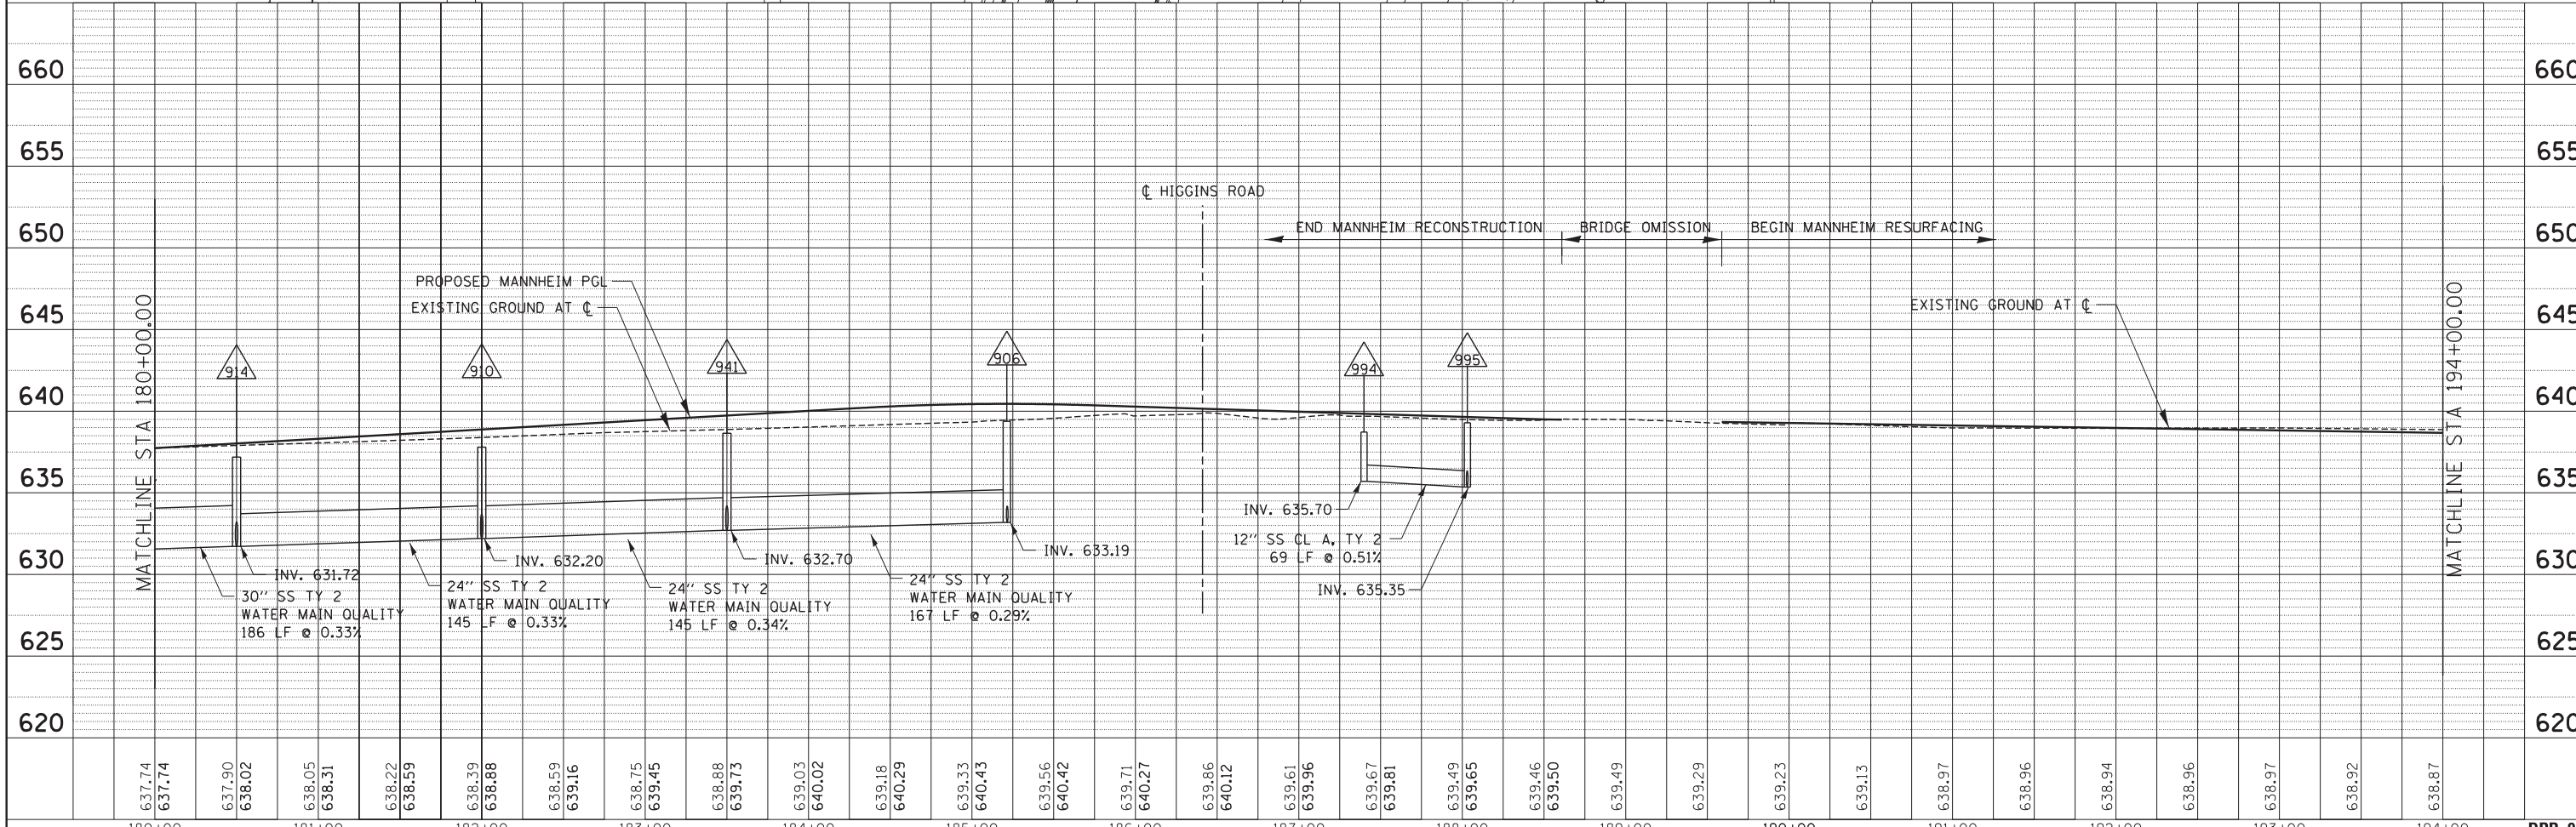

FILE NAME =	USER NAME = *USER*	DESIGNED - TKL	REVISED -	STATE OF ILLINOIS DEPARTMENT OF TRANSPORTATION	PROPOSED DRAINAGE MANNHEIM ROAD PLAN AND PROFILE			F.A. RTE.	SECTION	COUNTY	TOTAL SHEETS	SHEET NO.
FILE.L		DRAWN - KC	REVISED -					0105-WRS	COOK	537	183	
PLOT SCALE = *SCALE*		CHECKED - MCD	REVISED -					CONTRACT NO. 60P35				
PLOT DATE = *DATE*		DATE - 10/19/12	REVISED -					ILLINOIS FED. AID PROJECT				

SCALE: HORIZ. 1"=50' VERT. 1"=5' STA. 180+00.00 TO STA. 194+00.00