



LEGEND:

- STORM SEWER
- STORM SEWER INLET
- STORM SEWER CATCH BASIN
- STORM SEWER MANHOLE
- SANITARY SEWER
- SANITARY SEWER MAN HOLE
- WATERMAIN
- VALVE VAULT

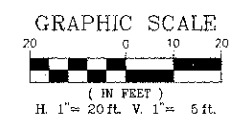


MATCH LINE STA. 166+50
SEE SHEET 44

MATCH LINE STA. 171+50
SEE SHEET 46

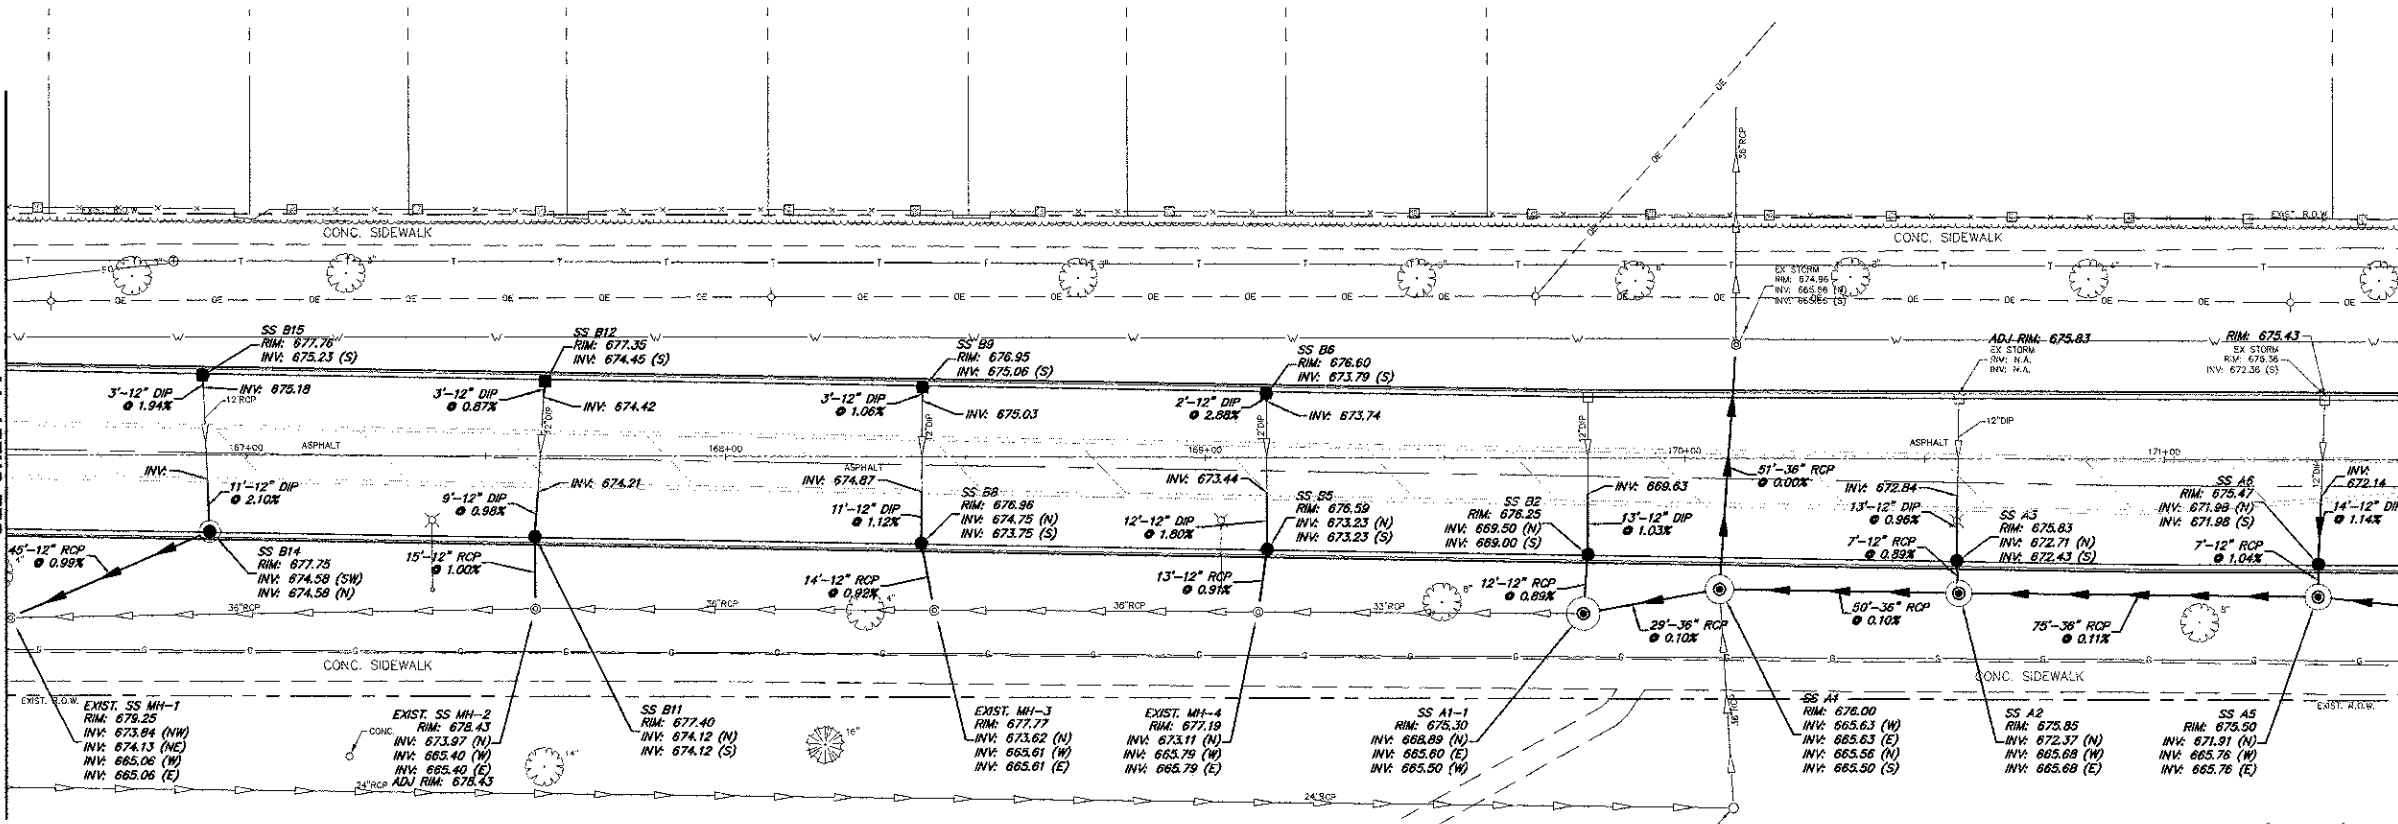

WEST KENSINGTON ROAD

STORM STRUCTURES		
STRUCTURE #	TYPE	FRAME & GRATE
SS A1	MH TYPE A, 7' DIA	TYPE 1 FR & CL
SS A1-1	MH TYPE A, 6' DIA	TYPE 1 FR & OL
SS A2	MH TYPE A, 5' DIA	TYPE 1 FR & CL
SS A3	CB TYPE C	TYPE 23 FR & GR
SS A5	MH TYPE A, 5' DIA	TYPE 1 FR & CL
SS A6	CB TYPE C	TYPE 23 FR & GR
SS B2	CB TYPE C	TYPE 23 FR & GR
SS B5	CB TYPE C	TYPE 23 FR & GR
SS B6	INLET TYPE A	TYPE 23 FR & GR
SS B8	CB TYPE C	TYPE 23 FR & GR
SS B9	INLET TYPE A	TYPE 23 FR & GR
SS B11	CB TYPE C	TYPE 23 FR & GR
SS B12	INLET TYPE A	TYPE 23 FR & GR
SS B14	CB TYPE A, 4' DIA	TYPE 23 FR & GR
SS B15	INLET TYPE A	TYPE 23 FR & GR

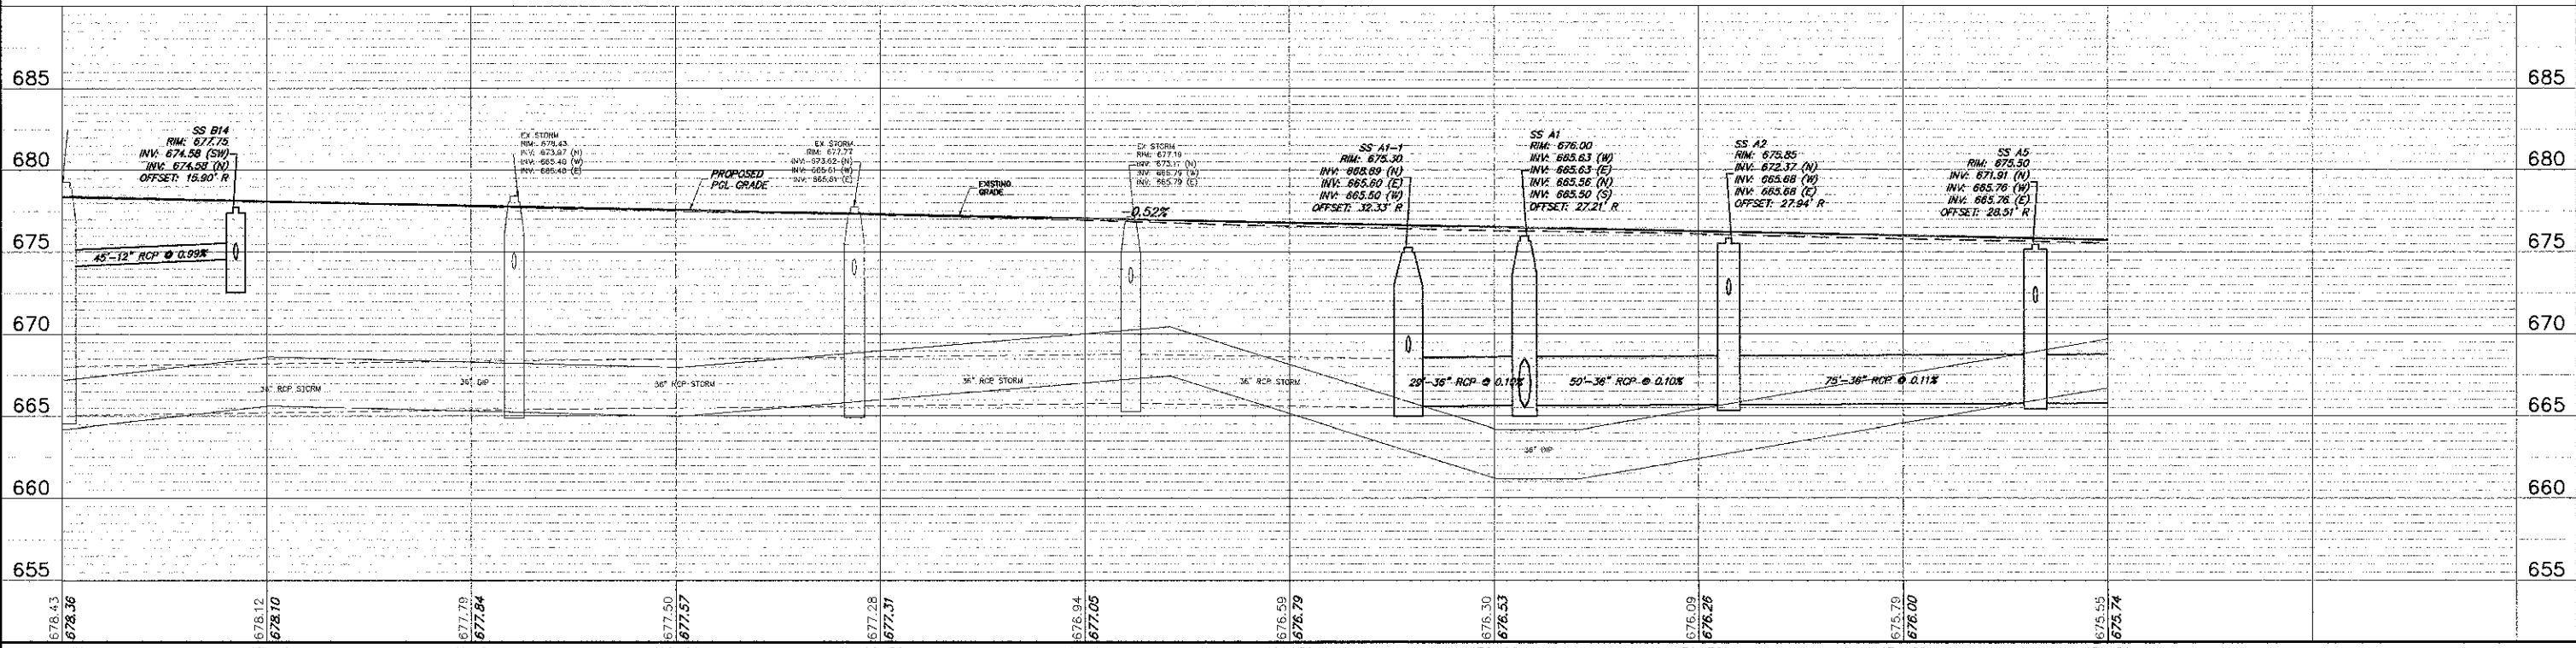

FILE NAME = 4185.800-PR3.dwg	USER NAME = PAUL SWATEK	DESIGNED - BVS	REVISED -	STATE OF ILLINOIS DEPARTMENT OF TRANSPORTATION	DRAINAGE AND UTILITY - PLAN AND PROFILE KENSINGTON ROAD IMPROVEMENTS	FAU RTE	SECTION	COUNTY	TOTAL SHEETS	SHEET NO.	
PLOT SCALE = 1" = 40'						1295	09-00154-00-PV	COOK	119	45	
PLOT DATE = 10/17/2012						DATE = 10/17/12	CONTRACT # = 63746		ILLINOIS FED. AID PROJECT		
						SCALE: 1" = 20'	SHEET NO. OF SHEETS	STA. 166+50 TO STA. 171+50			