


LEGEND:

- STORM SEWER
- STORM SEWER INLET
- STORM SEWER CATCH BASIN
- STORM SEWER MANHOLE
- SANITARY SEWER
- SANITARY SEWER MAN HOLE
- WATERMAIN
- VALVE VAULT

GRAPHIC SCALE
 (IN FEET)
 H. 1" = 20 FT. V. 1" = 5 FT.

STORM STRUCTURES		
STRUCTURE #	TYPE	FRAME & GRATE
SS J1	CB TYPE C	TYPE 23 FR & GR
SS J2	MH TYPE A, 6' DIA.	TYPE 1 FR & CL (2)
SS J3	CB TYPE A, 4' DIA.	TYPE 23 FR & GR
SS J4	MH TYPE A, 4' DIA.	TYPE 1 FR & CL
SS J5	CB TYPE C	TYPE 23 FR & GR
SS K1	CB TYPE C	TYPE 23 FR & GR
SS K2	CB TYPE C	TYPE 23 FR & GR

* MANHOLE WITH RESTRICTOR PLATE SEE DETAIL

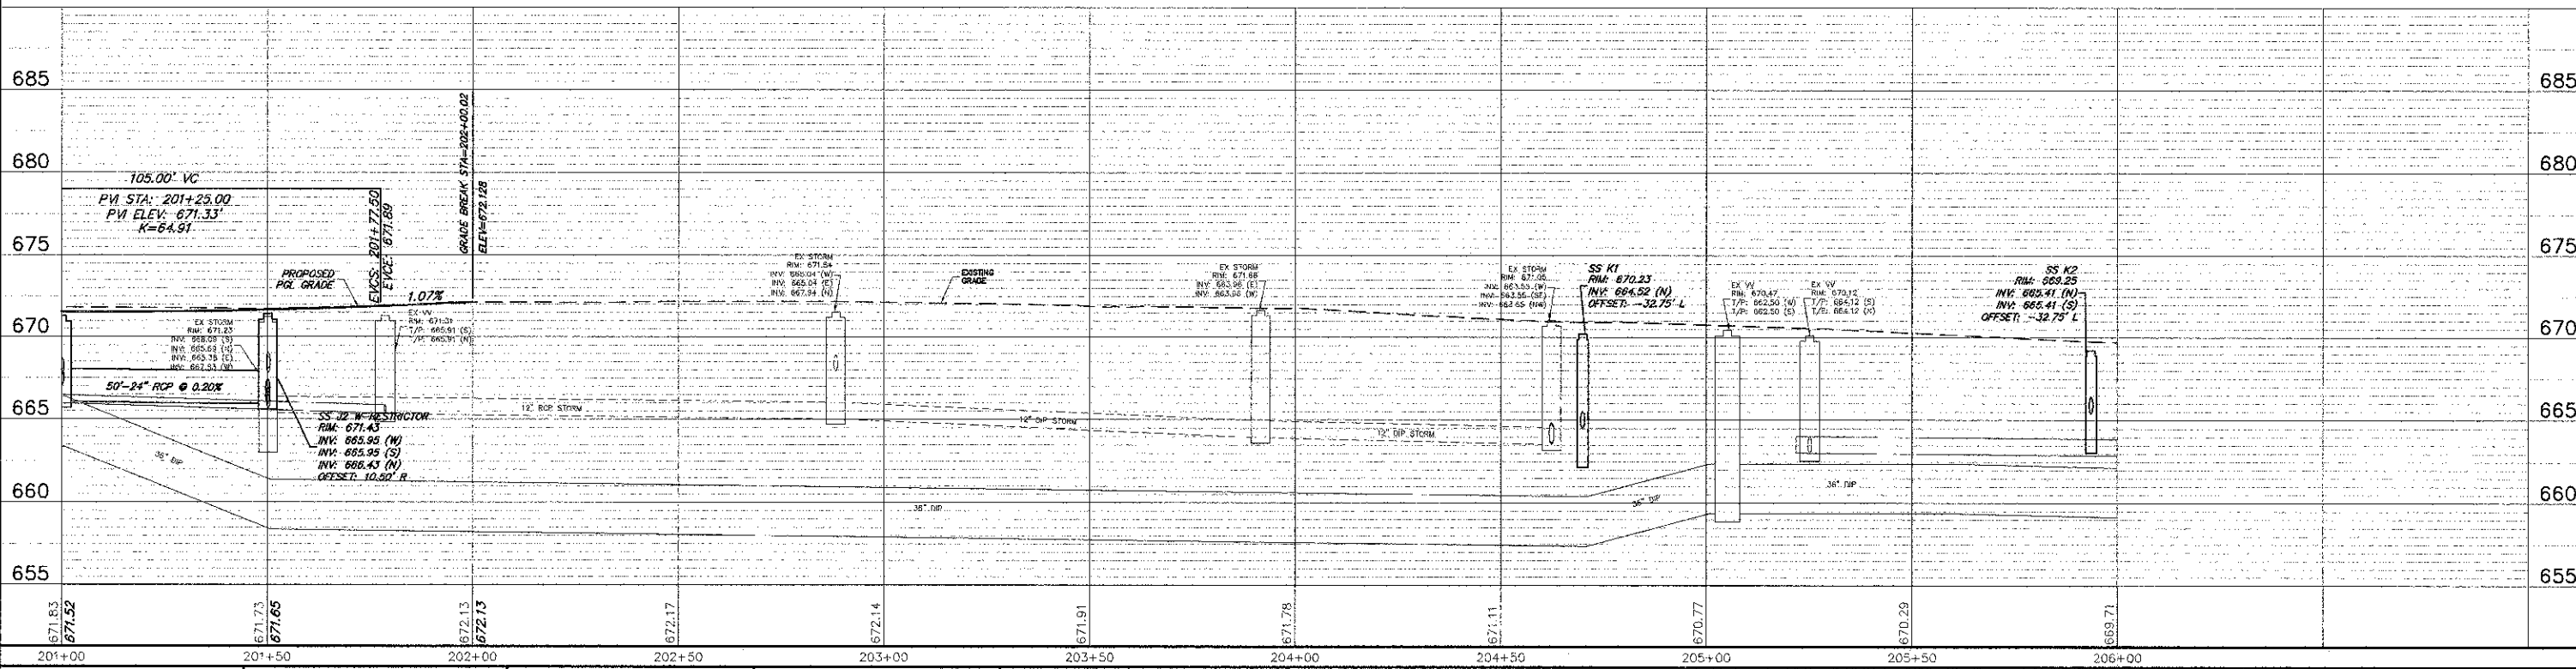

FILE NAME = 4185.600-FR3.dwg	USER NAME = PAUL SWIATEK	DESIGNED - BVS	REVISED -	STATE OF ILLINOIS DEPARTMENT OF TRANSPORTATION	DRAINAGE AND UTILITY - PLAN AND PROFILE KENSINGTON ROAD IMPROVEMENTS	FAU RTE	SECTION	COUNTY	TOTAL SHEETS	SHEET NO.	
		DRAWN - PJS	REVISED -			1295	09-00154-00-PV	COOK	119	52	
		CHECKED - KLB	REVISED -			SCALE: 1"=20'		SHEET NO. OF SHEETS		STA. 201+00 TO STA. 206+00	
		DATE - 10/17/12	REVISED -			CONTRACT #		ILLINOIS FED. AID PROJECT		63746	