




SEE US 34 EROSION CONTROL PLANS
FOR EROSION CONTROL INFORMATION

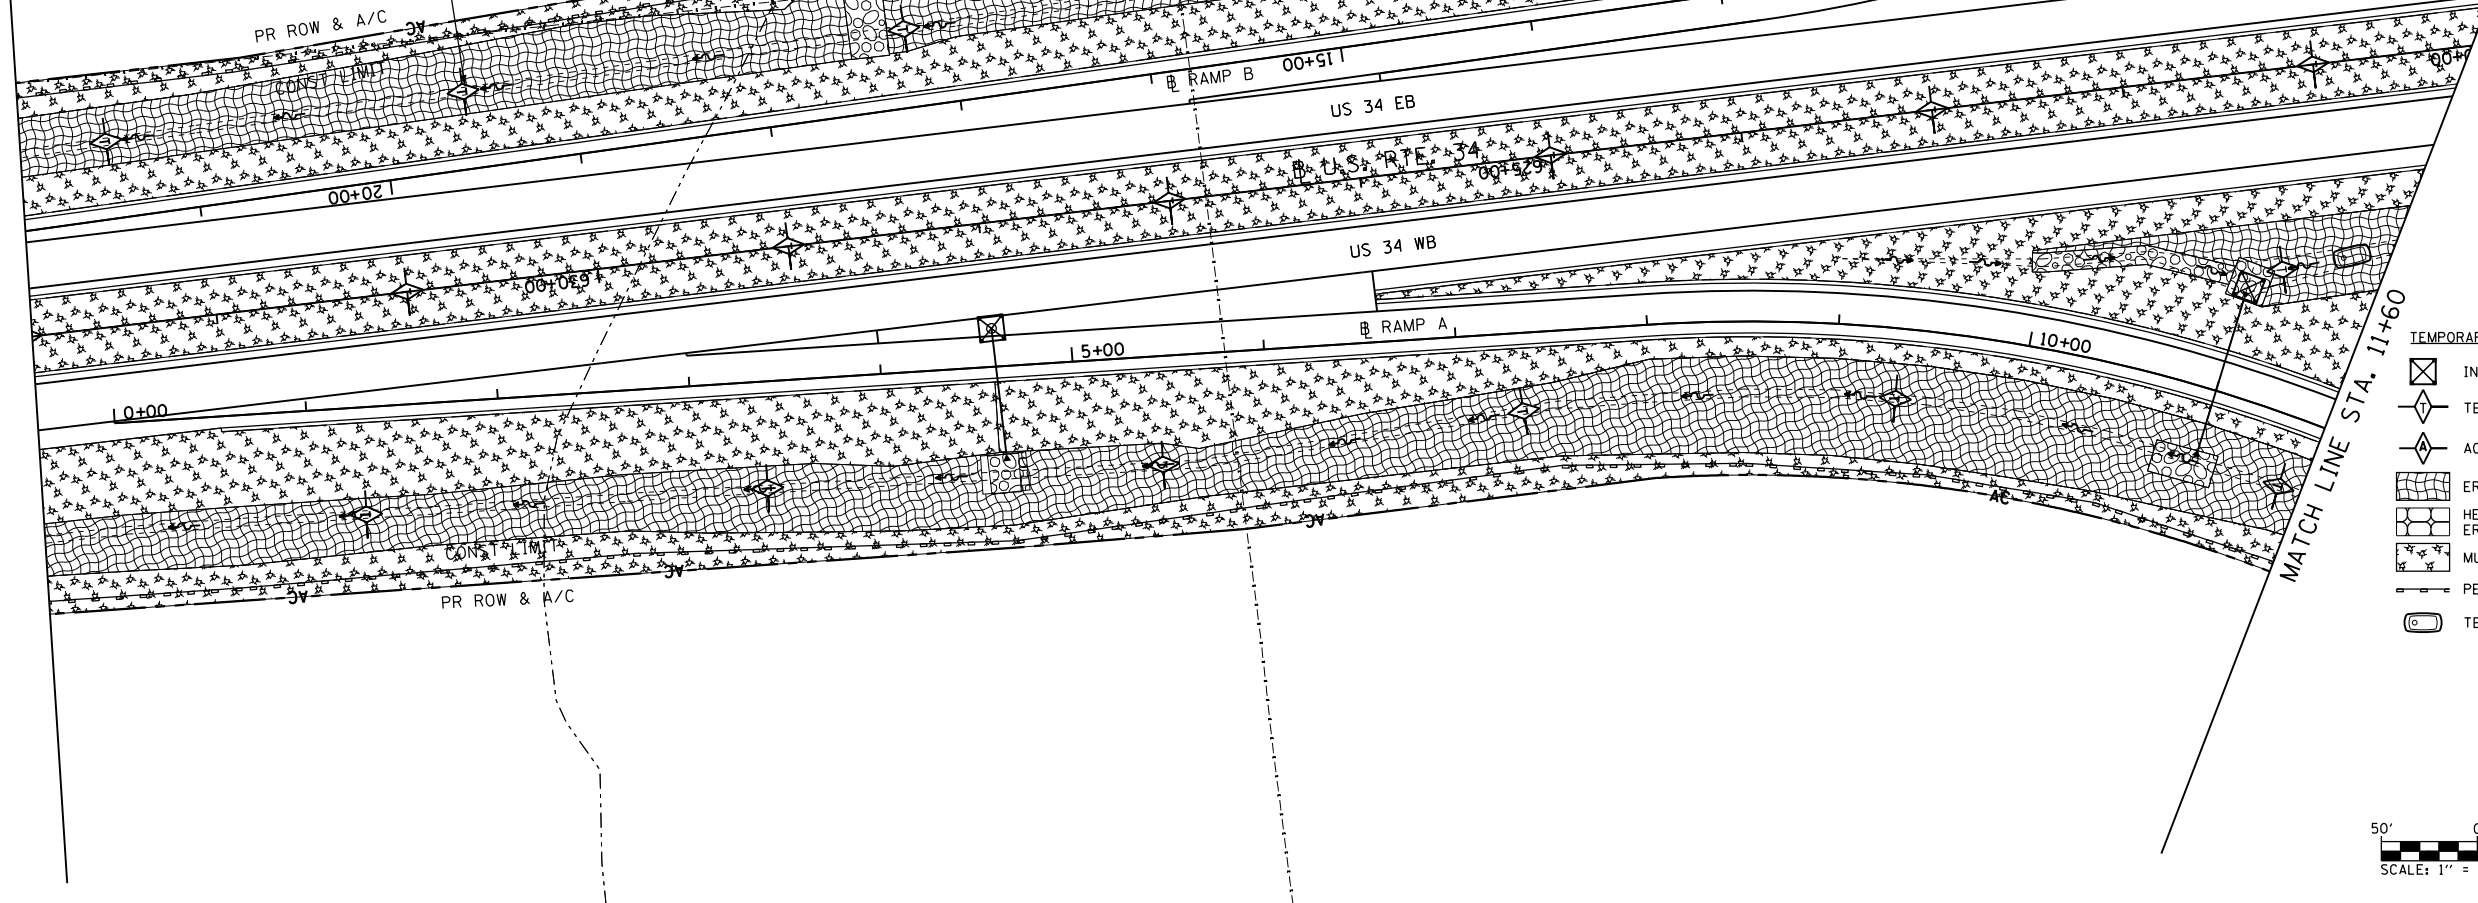

- TEMPORARY EROSION CONTROL LEGEND
- INLET AND PIPE PROTECTION
 - TEMPORARY DITCH CHECK
 - AGGREGATE DITCH CHECK
 - EROSION CONTROL BLANKET
 - HEAVY DUTY EROSION CONTROL BLANKET
 - MULCH METHOD 2
 - PERIMETER EROSION BARRIER
 - TEMPORARY SEDIMENT BASIN

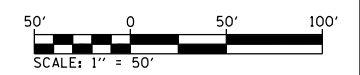

SEE US 34 EROSION CONTROL PLANS
FOR EROSION CONTROL INFORMATION

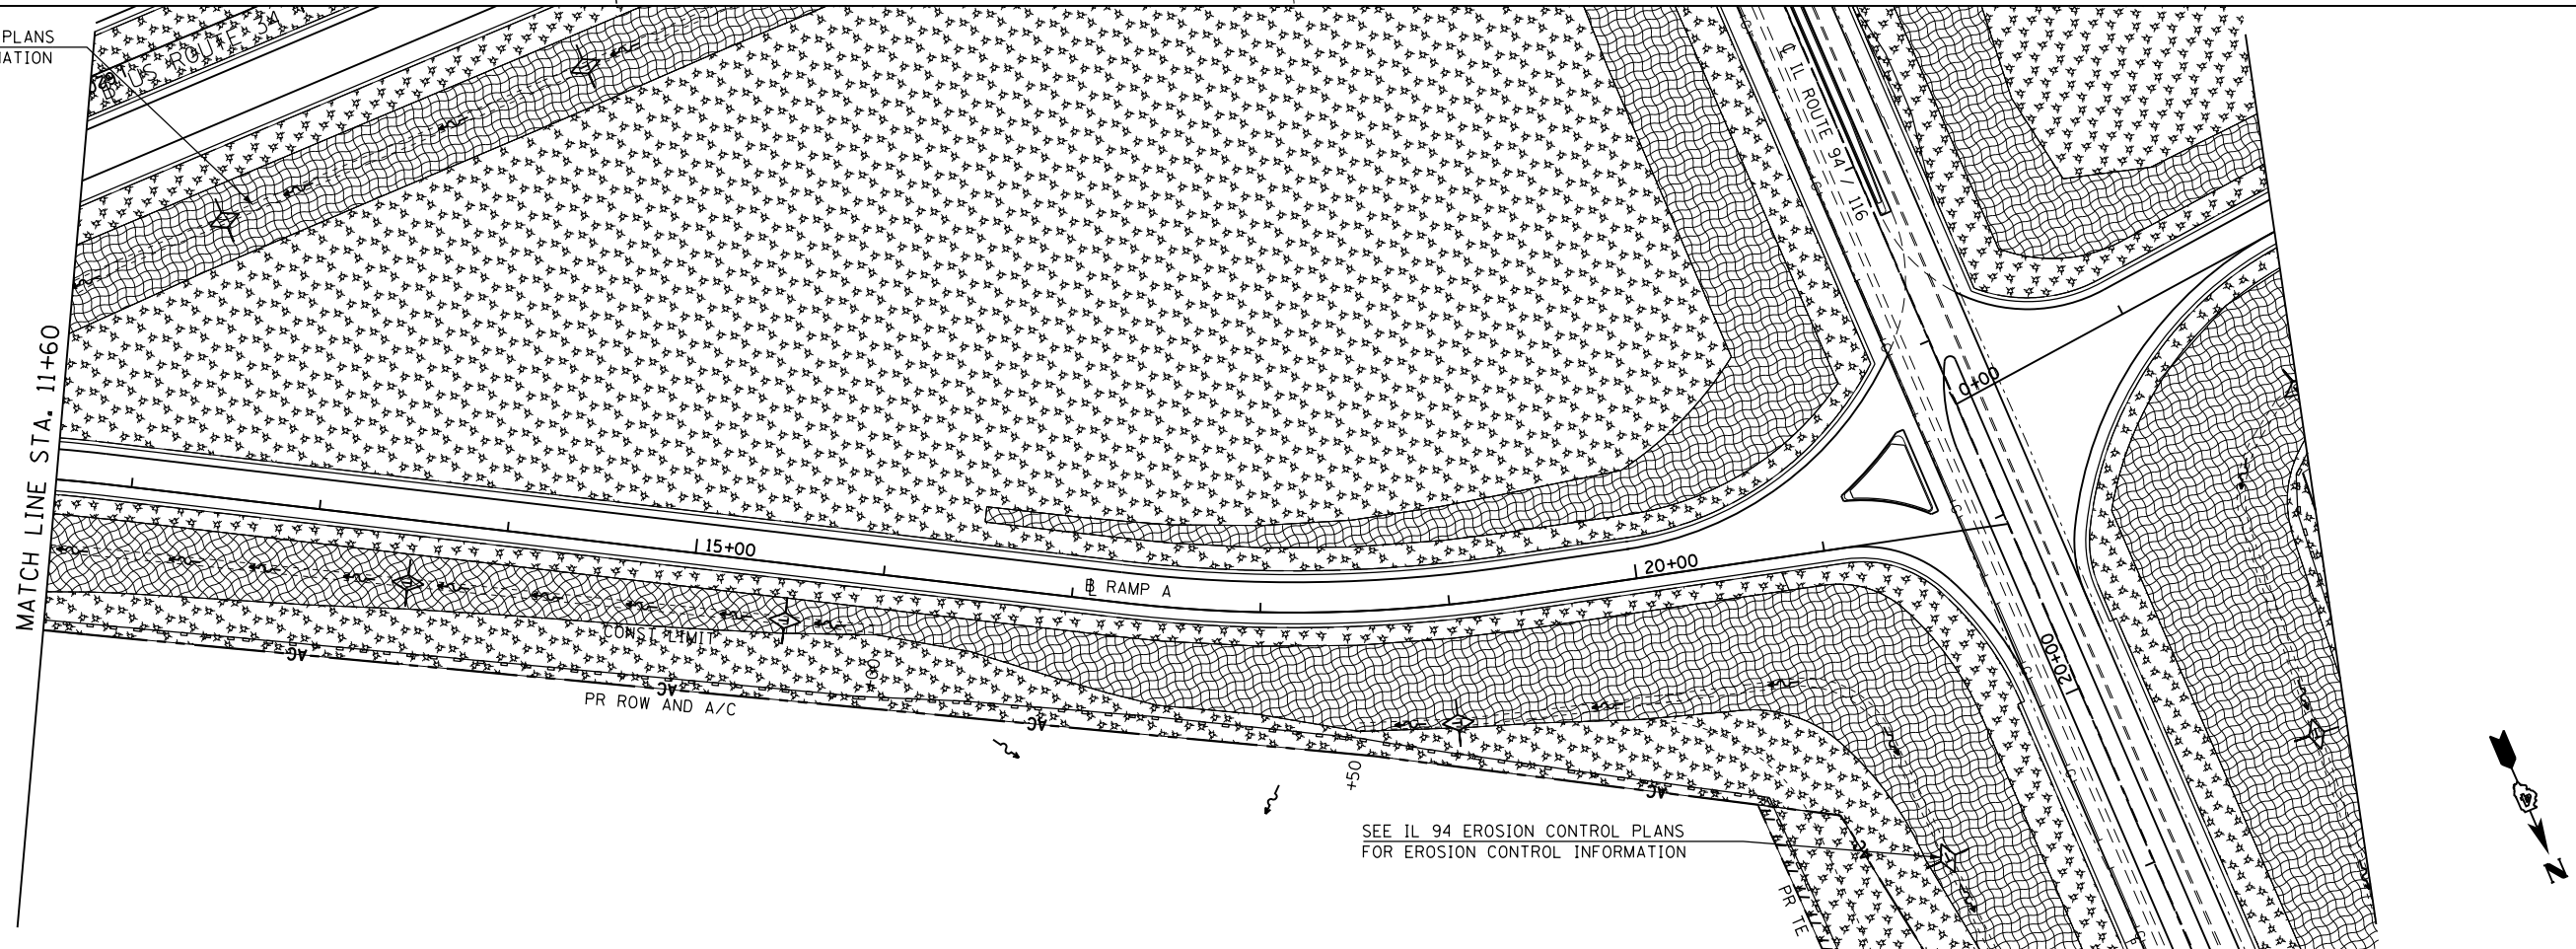

SEE IL 94 EROSION CONTROL PLANS
FOR EROSION CONTROL INFORMATION

FILE NAME =
D468409-SHT-17-EROS-RAMPA.dgn

USER NAME = zachl
PLOT SCALE = 100.0000' / 1" = 100'
PLOT DATE = 10/16/2012

DESIGNED - DBS
DRAWN - PSBA
CHECKED - CSB
DATE - 10/2012

REVISED -
REVISED -
REVISED -
REVISED -

**STATE OF ILLINOIS
DEPARTMENT OF TRANSPORTATION**

**EROSION CONTROL PLANS
RAMP A**

SCALE: 1" = 50' SHEET NO. 17 OF 34 SHEETS STA. 0+00 TO STA. 21+98

F.A.P. RTE.	SECTION	COUNTY	TOTAL SHEETS	SHEET NO.
313	7-2 ; 6-1	HENDERSON	976	257
CONTRACT NO. 68409				

ILLINOIS FED. AID PROJECT