STATE OF ILLINOIS DEPARTMENT OF TRANSPORTATION

789 12580R-2 MADISON 30 1 11LINOIS CONTRACT NO. 76K22

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TRAFFIC DATA:

ADT ON S.N. 060-0083 2015 = 9,350 (ACTUAL) 2017 = 9,550 (ESTIMATED) 2037 = 11,600 (ESTIMATED) SU = 4.8% MU = 1.2%

FULL SIZE PLANS HAVE BEEN PREPARED USING STANDARD ENGINEERING SCALES. REDUCED SIZED PLANS WILL NOT CONFORM TO STANDARD SCALES. IN MAKING MEASUREMENTS ON REDUCED PLANS, THE ABOVE SCALES MAY BE USED.

J.U.L.I.E. JOINT UTILITY LOCATION INFORMATION FOR EXCAVATION 1-800-892-0123 OR 811


PROJECT ENGINEER: TIM PADGETT (618) 346-3325
PROJECT MANAGER: PHIL FREIMUTH (618) 346-3194

PROPOSED HIGHWAY PLANS

F.A.P. ROUTE 789 (IL 143) SECTION 125BDR-2

BRIDGE REPAIR
MADISON COUNTY


C-98-154-18

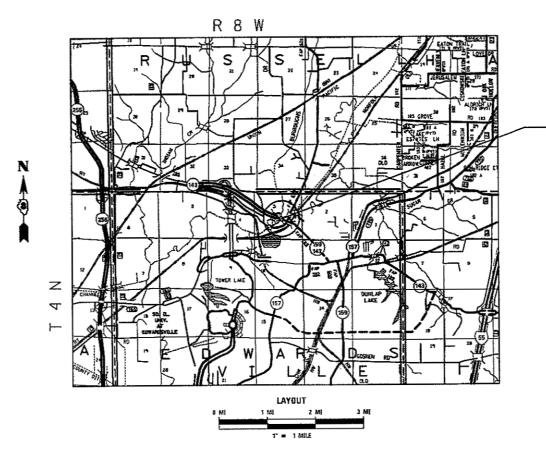

GROSS LENGTH = 1306.00 FT. = 0.247 MILE NET LENGTH = 1306.00 FT. = 0.247 MILE LATITUDE = 38.807811 LONGITUDE = 89.974569 0-98-040-17



PROJECT LOCATION - S.N. 060-0083
STA. 117+28.14 TO STA. 119+26.14 BK TO BK ABUT.
COMPOSITE 3 SPAN WIDE FLANGE W. CONCRETE SLAB;
CARRIES IL ROUTE 143 OVER CAHOKIA DRAINAGE CANAL
ON MULTI-COLUMNED PIERS W! PILE SUPPORTED
FOOTING AND PILE STUB ABUTMENTS;
SPAN LENGTHS ARE - 1 @ 59'-8"; 1 @ 76'-8"; AND 1 @ 59'-8"

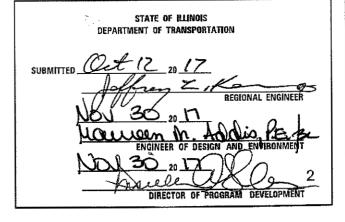

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CONTRACT NO. 76K22

STANDARDS

000001-06 001001-02	STANDARD SYMBOLS, ABBREVIATIONS AND PATTERNS AREAS OF REINFORCEMENT BARS
001006	DECIMAL OF AN INCH AND OF A FOOT
420001-09	PAVEMENT JOINTS
542401-03	METAL FLARED END SECTION FOR PIPE CULVERTS
606001-07	CONCRETE CURB TYPE B AND COMBINATION CONCRETE CURB AND GUTTER
606301-04	PC CONCRETE ISLANDS AND MEDIANS
701426-09	LANE CLOSURE, MULTILANE, INTERMITTENT OR MOVING OPER., FOR SPEEDS 2 45 MPH
701427-05	LANE CLOSURE, MULTILANE, INTERMITTENT OR MOVING OPER., FOR SPEEDS & 40 MPH
701501-06	URBAN LANE CLOSURE, 2L, 2W, UNDIVIDED
701606-10	URBAN SINGLE LANE CLOSURE, MULTILANE, 2W WITH MOUNTABLE MEDIAN
701611-01	URBAN HALF ROAD CLOSURE, MULTILANE, 2W WITH MOUNTABLE MEDIAN
701701-10	URBAN LANE CLOSURE, MULTILANE INTERSECTION
701901-07	TRAFFIC CONTROL DEVICES
704001-08	TEMPORARY CONCRETE BARRIER
720001-01	SIGN PANEL MOUNTING DETAILS
720006-04	SIGN PANEL ERECTION DETAILS
731001-01	BASE FOR TELESCOPING STEEL SIGN SUPPORT
780001-05	TYPICAL PAVEMENT MARKINGS
781001-04	TYPICAL APPLICATIONS RAISED REFLECTIVE PAVEMENT MARKERS
782001-01	CURB REFLECTORS
782006	GUARDRAIL AND BARRIER WALL REFLECTOR MOUNTING DETAILS

GENERAL NOTES

- ILLINOIS STATE LAW REQUIRES A 48-HOUR NOTICE BE GIVEN TO ALL UTILITIES WITHIN THE PROJECT AREA BEFORE DIGGING. FIELD MARKING OF FACILITIES MAY BE OBTAINED BY CONTACTING J.U.L.I.E. OR FOR NON-MEMBERS, THE UTILITY COMPANY DIRECTLY. AGENCIES KNOWN TO HAVE FACILITIES WITHIN THE PROJECT AREA ARE AS FOLLOWS:
 - * AMEREN ILLINOIS (GAS & ELECTRIC) * AT&T ILLINOIS (COMMUNICATIONS)

 - * CHARTER COMMUNICATIONS. INC. (CABLE TV)

 - * CITY OF EDWARDSVILLE (ELECTRIC)
 * CITY OF EDWARDSVILLE (WATER & SANITARY SEWER)
 - * MARATHON PIPE LINE LLB (PIPELINE)
 - * NORTHEAST CENTRAL COUNTY PUBLIC WATER DISTRICT (WATER)
 - * TRANSCANADA KEYSTONE PIPELINE (PIPELINE)

MEMBERS OF J.U.L.I.E. CALL TOLL FREE (800) 892-0123 OR 811 AND ARE INDICATED BY *. NON-J.U.L.I.E. MEMBERS MUST BE NOTIFIED INDIVIDUALLY.

- THE CONTRACTOR SHALL VERIFY ALL DIMENSIONS AND CONDITIONS IN THE FIELD PRIOR TO CONSTRUCTION AND ORDERING OF MATERIALS.
- THE PROPOSED PERMANENT PAVEMENT MARKING SHALL MATCH THE LOCATIONS OF THE EXISTING PAVEMENT MARKING, AS DIRECTED BY THE ENGINEER.
- 4. ALL AREAS DISTURBED FOR ANY REASON SHALL BE PERMANENTLY SEEDED AS DIRECTED BY THE ENGINEER. ALL AREAS DISTURBED BY THE CONTRACTOR OUTSIDE THE PROPOSED CONSTRUCTION LIMITS SHALL BE SEEDED AT THE CONTRACTOR'S EXPENSE.
- A QUANTITY OF 2,187.5 FEET OF TEMPORARY PAVEMENT MARKING LINE 6" HAS BEEN INCLUDED IN THE PLANS FOR PAINTING THE BOTTOM 6" OF THE TEMPORARY CONCRETE BARRIER.
- THE THICKNESS OF THE BITUMINOUS MIXTURE SHOWN ON THE PLANS IS THE NOMINAL THICKNESS. DEVIATIONS FROM THE NOMINAL THICKNESS WILL BE PERMITTED WHEN SUCH DEVIATIONS OCCUR DUE TO IRREGULARITIES IN THE EXISTING SURFACE OR BASE ON WHICH THE BITUMINOUS MIXTURE IS PLACED.

GENERAL NOTES (CONTINUED)

- THE ILLINOIS DEPARTMENT OF TRANSPORTATION STRONGLY ENCOURAGES THE PRIME CONTRACTOR AND THEIR APPROVED SUB-CONTRACTORS TO HIRE MINORITY, WOMEN AND DISADVANTAGED INDIVIDUALS FROM ITS FEDERALLY FUNDED HIGHWAY CONSTRUCTION CAREERS TRAINING PROGRAM (HCCTP) TO HELP MEET WORKFORCE AND TRAINEE GOALS. THIS PROGRAM IS TRAINING MINORITIES, WOMEN AND DISADVANTAGED INDIVIDUALS IN HIGHWAY CONSTRUCTION-RELATED SKILLS, E.G., MATH FOR THE TRADES, JOB READINESS, TECHNICAL SKILLS COURSEWORK (CARPENTRY, CONCRETE FLATWORK, BLUEPRINT READING, SITE PLANS, SITE WORK, TOOLS USE, ETC.) AND OSHA 10 HOUR CERTIFICATION, TO PREPARE THEM FOR A CAREER IN THE HIGHWAY CONSTRUCTION TRADES. GRADUATES ARE WELL-TRAINED AND READY TO BECOME PRODUCTIVE ENTRY-LEVEL CONSTRUCTION WORKERS. PLEASE CONTACT THE DISTRICT 8 EEO OFFICE AT 618-346-3360 AND/OR THE HCCTP COORDINATOR AT 618/874-6528 TO LEARN MORE ABOUT THE PROGRAM AND FOR ASSISTANCE IN MEETING WORKFORCE AND TRAINEE GOALS.
- ALL TRAFFIC CONTROL DEVICES SHALL BE NEW OR "LIKE NEW" CONDITION AT THE BEGINNING OF THE PROJECT.
- ALL EXCAVATION ADJACENT TO THE EDGE OF PAVEMENT SHALL BE PROTECTED WITH EXTENDED LEG BARRICADES AND APPROPRIATE LIGHTS.
- 10. ONE WEEK PRIOR TO SETUP OF TRAFFIC CONTROL, THE CONTRACTOR SHALL CONTACT DAVID WALKER, OF THE ILLINOIS DEPARTMENT OF TRANSPORTATION, AT (618) 346-3274 TO ADJUST SIGNAL PHASING AT THE IL 143 & IL 159 INTERSECTION.

COMMITMENTS

NONE

MIXTURE REQUIREMENTS

SCALE:

THE FOLLOWING MIXTURE REQUIREMENTS ARE APPLICABLE FOR THIS PROJECT.

MIXTURE USE	BRIDGE DECK & APPROACH (SURFACE COURSE)	STAGE CONSTRUCTION (BASE COURSE)	BINDER
AC/PG	SBS PG 76-22	PG 64-22	PG 64-22
RAP % (MAX)	SEE SPECIAL PROVISION	SEE SPECIAL PROVISION	SEE SPECIAL PROVISION
DESIGN AIR VOIDS	4.0% @ Ndes=70	4.0% @ Ndes=70	4.0% @ Ndes=70
MIX COMPOSITION (GRADATION)	IL 9.5 IL 19.0 I		IL 19.0
FRICTION AGG	MIXTURE "D"	MIXTURE "B"	MIXTURE "B"
QUALITY MGMT PROGRAM	QC/QA	QC/QA	QC/QA

PLAN QUANTITIES FOR HMA SURFACE COURSE ITEMS ARE CALCULATED USING A UNIT WEIGHT OF 112 LB/SQ YD/IN.

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STATE	E OF	ILLINOIS
DEPARTMENT	OF	TRANSPORTATION

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IGHWAY STANDARDS, GENERAL NOTES, &		COMMITMENTS	789	125BDR-2	MADISON	30	2					
	,									CONTRACT	Γ NO. 1	76K22
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				CONSTR. CODE
			URBAN	
				BRIDGE
CODE			TOTAL	0047
NO.	ITEM	UNIT	QUANTITY	S.N. 060-0083
28100107	STONE RIPRAP, CLASS A4	SQ YD	12	12
		04 15	12	12
28200200	FILTER FABRIC	SQ YD	24	24
31101000	SUBBASE GRANULAR MATERIAL, TYPE B	TON	75	75
			,	
35501287	HOT-MIX ASPHALT BASE COURSE, 2 1/4"	SQ YD	60	60
35501315	HOT-MIX ASPHALT BASE COURSE, 7 3/4"	SQ YD	197	197
40600275	BITUMINOUS MATERIALS (PRIME COAT)	POUND	442	442
10600290	BITUMINOUS MATERIALS (TACK COAT)	DOLLAD	115	
	BITUMINOUS MATERIALS (TACK COAT)	POUND	115	115
40600295	POLYMERIZED BITUMINOUS MATERIALS (TACK COAT)	POUND	438	438
10600982	HOT-MIX ASPHALT SURFACE REMOVAL - BUTT JOINT	SQ YD	563	563
10603085	HOT-MIX ASPHALT BINDER COURSE, IL-19.0, N70	TON	30	30
10603540	POLYMERIZED HOT-MIX ASPHALT SURFACE COURSE, MIX "D", N7	0 TON	202	202
140001				
14000100	PAVEMENT REMOVAL	SQ YD	45	45
14000400	GUTTER REMOVAL	FOOT	541	541
14003100	MEDIAN REMOVAL	SQ FT	1769	1769

		1	URBAN	B01010
0005				BRIDGE
CODE	TTEM		TOTAL	0047
NO.	ITEM	UNIT	QUANTITY	S.N. 060-0083
14003510	MEDIAN REMOVAL PARTIAL DEPTH	SQ FT	544	544
50102400	CONCRETE REMOVAL	CU YD	17. 2	17. 2
50300100	FLOOR DRAINS	EACH	2	2
,0300100		EACH		2
50300255	CONCRETE SUPERSTRUCTURE	CU YD	19.1	19.1
50800205	REINFORCEMENT BARS, EPOXY COATED	POUND	1900	1900
50800515	BAR SPLICERS	EACH	24	24
52000110	PREFORMED JOINT STRIP SEAL	FOOT	127	127
542 617 15	STEEL FLARED END SECTIONS IS"	EACH	2	2
58100200	WATERPROOFING MEMBRANE SYSTEM	SQ YD	1101	1101
50103600	PIPE DRAINS, CORRUGATED STEEL 15"	FOOT	70	70
50605500	COMBINATION CONCRETE CURB AND GUTTER, TYPE B-6.24 (VARIABLE WIDTH GUTTER FLAG)	FOOT	523	523
51000050	CONCRETE THRUST BLOCKS	EACH	2	2
3300575	3300575 REMOVE AND REERECT RAIL ELEMENT OF EXISTING GUARDRAIL		50	50
6900200	NON-SPECIAL WASTE DISPOSAL	CU YD	85	85

STATE OF ILLINOIS
DEPARTMENT OF TRANSPORTATION

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		URBAN				
			OND/ (I	BRIDGE		
CODE			TOTAL	0047		
NO.	ITEM	UNIT	QUANTITY	S. N. 060-0083		
66900450	SPECIAL WASTE PLANS AND REPORTS	LSUM	1	1		
				W1 - 1-11-1		
66900530	SOIL DISPOSAL ANALYSIS	EACH	3	3		
67000400	ENGINEER'S FIELD OFFICE, TYPE A	CAL MO	5	5		
67100100	MOBILIZATION	LSUM	1	1		
70102620	TRAFFIC CONTROL AND PROTECTION, STANDARD 701501	LSUM	1	1		
70102625	TRAFFIC CONTROL AND PROTECTION, STANDARD 701606	LSUM	1	1		
70102634	TRAFFIC CONTROL AND PROTECTION, STANDARD 701611	LSUM	1	1		
70102635	TRAFFIC CONTROL AND PROTECTION, STANDARD 701701	LSUM	1	1		
70300100	SHORT TERM PAVEMENT MARKING	FOOT	328	328		
70300150	SHORT TERM PAVEMENT MARKING REMOVAL	SQ FT	109	109		
70300210	TEMPORARY PAVEMENT MARKING LETTERS AND SYMBOLS	SQ FT	63	63		
70300220	TEMPORARY PAVEMENT MARKING - LINE 4"	FOOT	7349	7349		
70300240	TEMPORARY PAVEMENT MARKING - LINE 6"	FOOT	2187.5	2187.5		
70300260	TEMPORARY PAVEMENT MARKING - LINE 12"	FOOT	205	205		

CODE			URBAN	BRIDGE
NO.	ITEM	UNIT	TOTAL QUANTITY	0047 S.N. 060-008
70400100	TEMPORARY CONCRETE BARRIER	FOOT	987.5	987.5
70400200	RELOCATE TEMPORARY CONCRETE BARRIER	FOOT	1200	1200
70600250	IMPACT ATTENUATORS, TEMPORARY (NON- REDIRECTIVE), TEST LEVEL 3	EACH	2	2
70600350	IMPACT ATTENUATORS, RELOCATE (NON- REDIRECTIVE), TEST LEVEL 3	EACH	4	4
72400310	REMOVE SIGN PANEL - TYPE 1	SQ FT	5	5
72400710	RELOCATE SIGN PANEL - TYPE 1	SQ FT	5	5
72800100	TELESCOPING STEEL SIGN SUPPORT	FOOT	9.5	9. 5
73100100	BASE FOR TELESCOPING STEEL SIGN SUPPORT	EACH	1	1
78000100	THERMOPLASTIC PAVEMENT MARKING - LETTERS AND SYMBOLS	SQ FT	63	63
78000200	THERMOPLASTIC PAVEMENT MARKING - LINE 4"	FOOT	3208	3208
78000600	THERMOPLASTIC PAVEMENT MARKING - LINE 12"	FOOT	205	205
78004354	PREFORMED PLASTIC PAVEMENT MARKING, TYPE D - INLAID - LINE 4"	FOOT	891	891
78100100	RAISED REFLECTIVE PAVEMENT MARKER	EACH	36	36
78100300	REPLACEMENT REFLECTOR	EACH	57	57

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STATE OF ILLINOIS
DEPARTMENT OF TRANSPORTATION

CONSTR. CODE

SUMMARY OF QUANTITIES

F.A.P. RTE. 789


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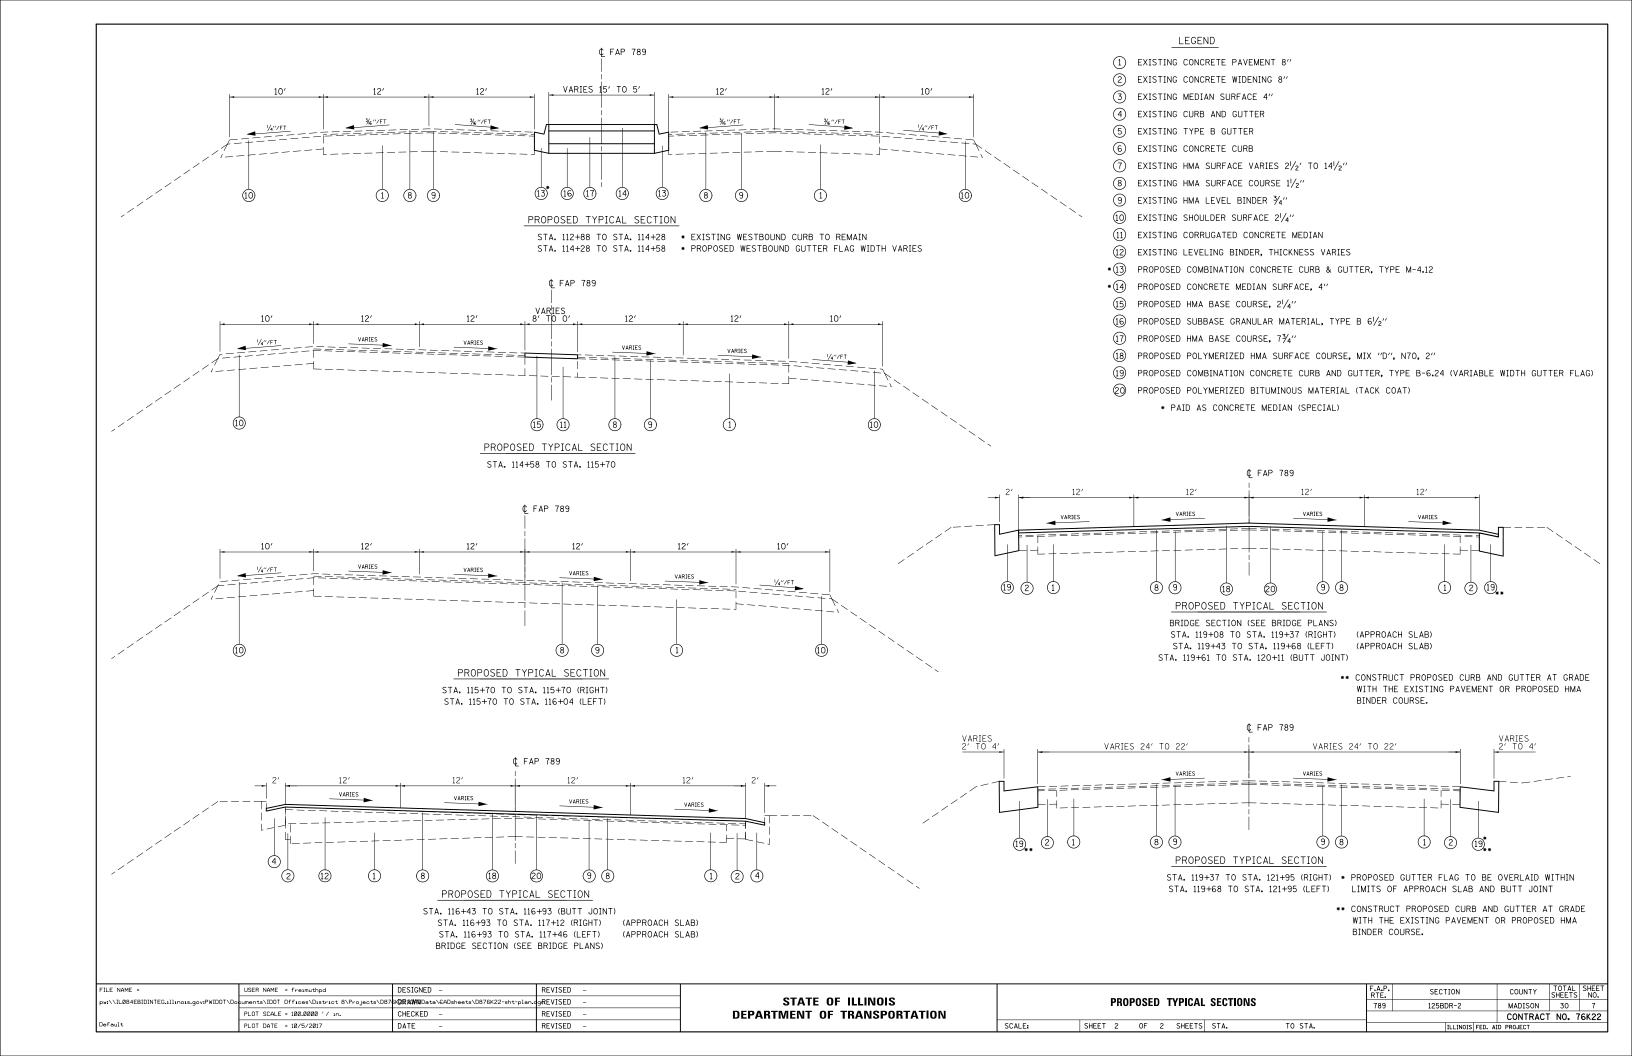
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CODE			TOTAL	0047
NO.	ITEM	UNIT	QUANTITY	S.N. 060-0083
78200020	CURB REFLECTORS	EACH	13	13
78300200	RAISED REFLECTIVE PAVEMENT MARKER REMOVAL	EACH	104	104
X0324058	OUTLET SPECIAL	EACH	2	2
X0327980	PAVEMENT MARKING REMOVAL - WATER BLASTING	SQ FT	1634	1634
X5870015	BRIDGE DECK CONCRETE SEALER	SQ FT	1932	1932
X6060714	CONCRETE MEDIAN (SPECIAL)	SQ FT	1769	1769
X7010216	TRAFFIC CONTROL AND PROTECTION, (SPECIAL)	LSUM	1	1
X7030005	TEMPORARY PAVEMENT MARKING REMOVAL	SQ FT	2718	2718
X7800100	PAINT PAVEMENT MARKING - RAISED MEDIAN	SQ FT	14	14
X7800200	PAINT PAVEMENT MARKING CURB	FOOT	64	64
X7830070	GROOVING FOR RECESSED PAVEMENT MARKING 5"	FOOT	891	891
Z0015802	PLUG EXISTING DECK DRAINS	EACH	2	2
Z0016002	DECK SLAB REPAIR (FULL DEPTH, TYPE II)	SQ YD	3	3
Z0016200	DECK SLAB REPAIR (PARTIAL)	SQ YD	40	40

* SPECIALTY ITEM

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		RESURFACIN	G SCHEDULE		
STATION	LENGTH	POLYMERIZED HMA SURFACE COURSE MIX "D", N70	HMA SURFACE REMOVAL - BUTT JOINT	POLYMERIZED BITUMINOUS MATERIAL (TACK COAT)	COMMENTS
	FOOT	TON	SQ YD	POUND	
STAGE 1					
116+42.98 TO 116+92.98	50.00	10.6	94	42.5	BUTT JOINT
116+92.98 TO 117+28.64	35.66	10.0		40.3	APPROACH SLAB ²
117+28.64 TO 119+25.64	197.00				BRIDGE DECK
119+25.64 TO 119+61.35	35.71	4.6		18.7	APPROACH SLAB ²
119+61.35 TO 120+11.35	50.00	9.0	81	36. 3	BUTT JOINT
STAGE 1 SUBTOTAL		34	175	138	
STAGE 2					
116+42.98 TO 116+92.98	50.00	10.6	94	42.5	BUTT JOINT
116+92.98 TO 117+28.64	35.66	7. 6		30.7	approach slab²
117+28.64 TO 119+25.64	197.00				BRIDGE DECK
119+25.64 TO 119+61.35	35.71	7.5		30.2	approach slab²
119+61.35 TO 120+11.35	50.00	10.6	94	42.5	BUTT JOINT
STAGE 2 SUBTOTAL		36	188	146	
STAGE 3					
116+42.98 TO 116+92.98	50.00	11.2	100	45.0	BUTT JOINT
116+92.98 TO 117+28.64	35.66	5.5		22.1	approach slab²
117+28.64 TO 119+25.64	197.00				BRIDGE DECK
119+25.64 TO 119+61.35	35.71	10.6		42.4	APPROACH SLAB ²
119+61.35 TO 120+11.35	50.00	11.2	100	45.0	BUTT JOINT
STAGE 3 SUBTOTAL		38	200	154	
TOTAL		109	563	438	

TRAFFIC CONTROL BARRIER SCHEDULE												
LOCATION	TCB REQUIRED CONCRETOR FOR STAGE TEMPORA CONCRETOR BARRIE		RELOCATE TEMPORARY CONCRETE		PAVEMENT LINE, 6"	IMPACT ATTENUATORS, TEMPORARY (NON-REDIRECTIVE),	IMPACT ATTENUATORS, RELOCATE (NON-REDIRECTIVE),					
	STAGE		BARRIER	WHITE	YELLOW	TEST LEVEL 3	TEST LEVEL 3					
	FOOT	FOOT	FOOT	FOOT	FOOT	EACH	EACH					
CONSTRUCTION STAGE 1	575.00	575		575		2						
CONSTRUCTION STAGE 2	987.50	412.5	575		987.5		2					
CONSTRUCTION STAGE 3	625.00		625	625			2					
TOTAL	TOTAL 987.5 1200 2187.5		7. 5	2	4							

		SIGN SCHEDULE		
LOCATION	REMOVE SIGN PANEL - TYPE 1	RELOCATE SIGN PANEL - TYPE 1	TELESCOPING STEEL SIGN SUPPORT	BASE FOR TELESCOPING STEEL SIGN SUPPORT
	SQ FT	SQ FT	FT	EACH
IL 143				
MEDIAN	5	5	9.5	1
TOTAL	5	5	9. 5	1

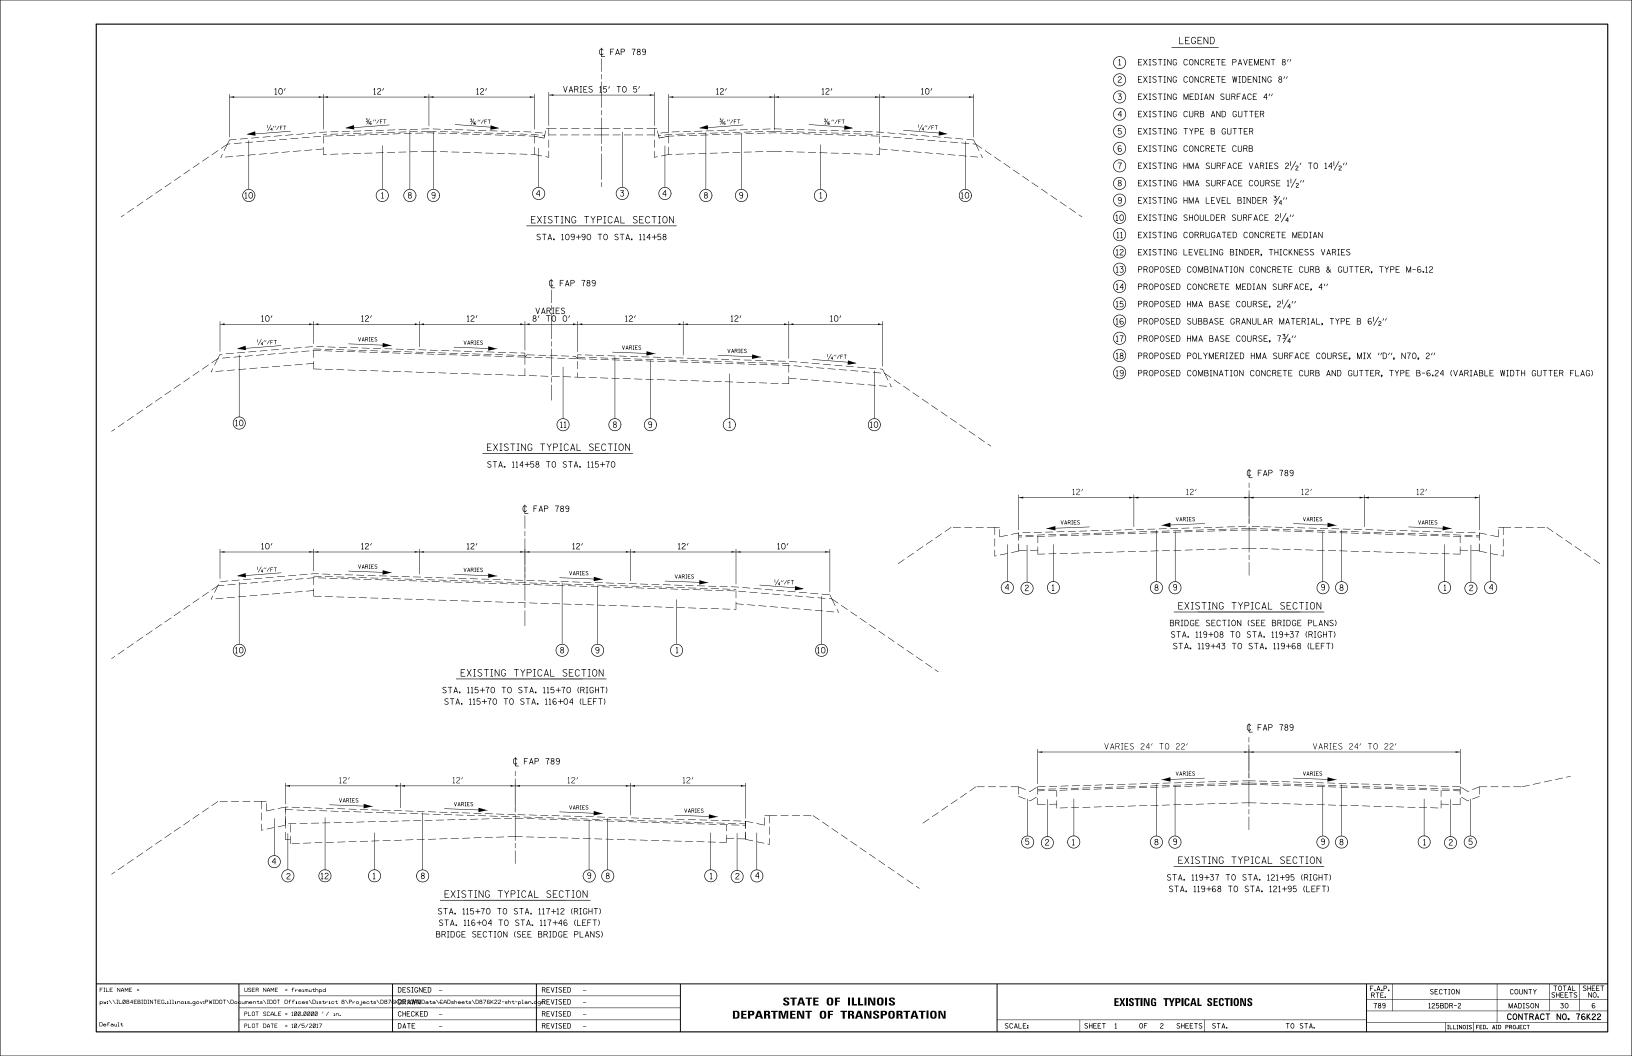- 1. HMA SURFACE IS FOR BUTT JOINT AREAS AND EXTENSIONS TO AVOID CONCRETE APPROACHES AND INLETS.
- 2. AREAS FOR APPROACH SLABS ESTABLISHED FROM CADD MEASUREMENTS.

					MEDI	AN SCHEDULE						
	PRE-STAGE									POST-STAC	E E	
LOCATION	MEDIAN REMOVAL	MEDIAN REMOVAL PARTIAL DEPTH	EMOVAL GRANULAR BITUMINOUS BITUMINOUS F ARTIAL MATERIAL, MATERIALS ASP ARTIAL MATERIAL, (PRIME COAT) COUR			HOT-MIX ASPHALT BASE COURSE, 7 3/4"	HOT-MIX ASPHALT BASE COURSE, 2 1/4"	PAVEMENT REMOVAL	CONCRETE MEDIAN (SPECIAL)	PAINT PAVEMENT MARKING CURE	PAINT PAVEMENT MARKING - RAISED MEDAIN	CURB REFLECTORS (AMBER)
	SQ FT	SQ FT	TON	POUND	POUND	SQ YD	SQ YD	SQ YD	SQ FT	FT	SQ FT	EACH
IL 143												
MEDIAN	1769		75	442	88	197		45	1769	64	14	13
CORRUGATED MEDIAN		544			27		60					
TOTAL	1769	544	75	442	115	197	60	45	1769	64	14	13

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						PAVEMEN.	T MARKING SC	HEDULE						
	LENGTH		THERMOPLAS & TEMPORA	TIC PAVEMEN			TYPE D	LASTIC PAVEM - INLAID & TE VEMENT MARKI	EMPORARY	GROOVING FOR RECESSED	PAVEMENT MARKING	TEMPORARY PAVEMENT	SHORT TERM	SHORT TERM PAVEMENT
STATION	LENGIA	4" WHITE	4" YELLOW	4" WHITE	12" YELLOW	LETTERS &	4" WHITE	4" YELLOW	4" WHITE	PAVEMENT	REMOVAL -	MARKING	PAVEMENT	MARKING
		SKIP DASH	SOLID	SOLID	DIAGONAL	SYMBOLS	SKIP DASH	SOLID	SOLID	MARKING, 5"	WATER BLASTING	REMOVAL	MARKING	REMOVAL
	FOOT	FOOT	FOOT	FOOT	FOOT	SQ FT	FOOT	FOOT	FOOT	FOOT	SQ FT	SQ FT	FOOT	SQ FT
IL 143														
109+90.00 TO 114-	+60.00 470.0		470		112						269	269	43	14
114+60.00 TO 115-	5+38.00 78.0		156		29						81	8 1	14	5
115+38.00 TO 115-	5+93.00 55.0	1 4	110	110	32						110	110	15	5
115+93.00 TO 117-	+28.00 135.0	68	270	270	32						234	234	49	16
117+28.00 TO 119-	9+26.00 198.0						99	396	396	891	297	297	72	24
119+26.00 TO 121-	+95.00 269.0	67	538	807		46.8					518	518	98	33
121+95.00 TO 122-	2+96.00 101.0	25	202	101		15.6					125	125	37	12
TOTAL	.L		3208*		205	63		891*		891	1634	1634*	328	109


* ADDITIONAL 3250 FT OF TEMPORARY PAVEMENT MARKING LINE - 4" AND 1084 SQ FT OF TEMPORARY PAVEMENT MARKING REMOVAL MAY BE NECESSARY FOR PRE-STAGE AND POST-STAGE CONSTRUCTION.


				DAICED	REFLECTI	\/F DA\/FME	NT MADVED	<u></u>					
								_					
			RAISED REFLECTIVE PAVEMENT MARKER REMOVAL			RAISED R	RAISED REFLECTIVE PAVEMENT MARKER			REPLACEMENT REFLECTOR			
STA	STATION			ONE-WAY AMBER	TWO-WAY AMBER			TWO-WAY AMBER	ONE-WAY CRYSTAL	ONE-WAY AMBER	TWO-WAY AMBER		
			EACH	EACH	EACH	EACH	EACH	EACH	EACH	EACH	EACH		
WES-	твоι	DND											
109+90.00	TO²	114+60.00		12						12			
114+60.00	TO²	115+38.00		4						4			
115+38.00	TO²	115+93.00	1	4					1	4			
115+93.00	TO²	116+42.98	4	8					4	8			
116+42.98	TO ¹	117+28.14	8	16		8	16						
117+28.14	TO	119+26.14	6		5								
119+26.14	TO	120+11.35	9		3	9		3					
120+11.35	TO²	121+27.00	8		3				8		3		
121+27.00	ΤO²	121+86.00	3		2				3		2		
121+86.00	ΤO²	122+96.00	5		3				5		3		
SUB	втот	AL	44	44	16	17	16	3	21	28	8		
T	ΟΤΑΙ	-	104			36			57				

- 1. RRPMS WITHIN THE LIMITS OF THE RESURFACING TO BE FULLY REMOVED AND ONLY REPLACED IN THE RESURFACING NOT ON THE BRIDGE DECK.
- 2. RRPM REMOVAL OUTSIDE OF BRIDGE RESURFACING LIMITS SHALL ONLY REMOVE REFLECTORS FROM ROADWAY DURING STAGE CONSTRUCTION.


	CURB WIDENING & OUTLET IMPROVEMENTS												
LOCATION	GUTTER REMOVAL	COMBINATION CONCRETE CURB AND GUTTER, TYPE B-6.24 (VARIABLE WIDTH GUTTER FLAG)	OUTLET SPECIAL	PIPE DRAINS, CORRUGATED STEEL 15"	STEEL END SECTIONS 15"	CONCRETE THRUST BLOCKS	STONE RIPRAP, CLASS A4	FILTER FABRIC					
	FOOT	FOOT	EACH	FOOT	EACH	EACH	SY	SY					
IL 143													
EASTBOUND	288	279	1	25	1	1	6	12					
WESTBOUND	253	244	1	45	1	1	6	12					
TOTAL	541	523	2	70	2	2	12	24					

FILE	NAME =	USER NAME = freimuthpd	DESIGNED -	REVISED -						F.A.P.	SECTION	COUNTY	TOTAL SHEET
pw://	\ILØ84EBIDINTEG.ıllınoıs.gov:PWIDOT\Do	cuments\IDOT Offices\District 8\Projects\D	0875K 2RXXXXX Data\€ADsheets\D876K22-sht-plan.		STATE OF ILLINOIS	SCHEDULE OF QUANTITIES		789	125BDR-2	MADISON	30 9		
		PLOT SCALE = 100.0000 '/ in.	CHECKED -	REVISED -	DEPARTMENT OF TRANSPORTATION							CONTRACT	T NO. 76K22
Defau	ult	PLOT DATE = 10/5/2017	DATE -	REVISED -		SCALE:	SHEET 2 OF 2 SHEETS	STA.	TO STA.		ILLINOIS FED.	AID PROJECT	

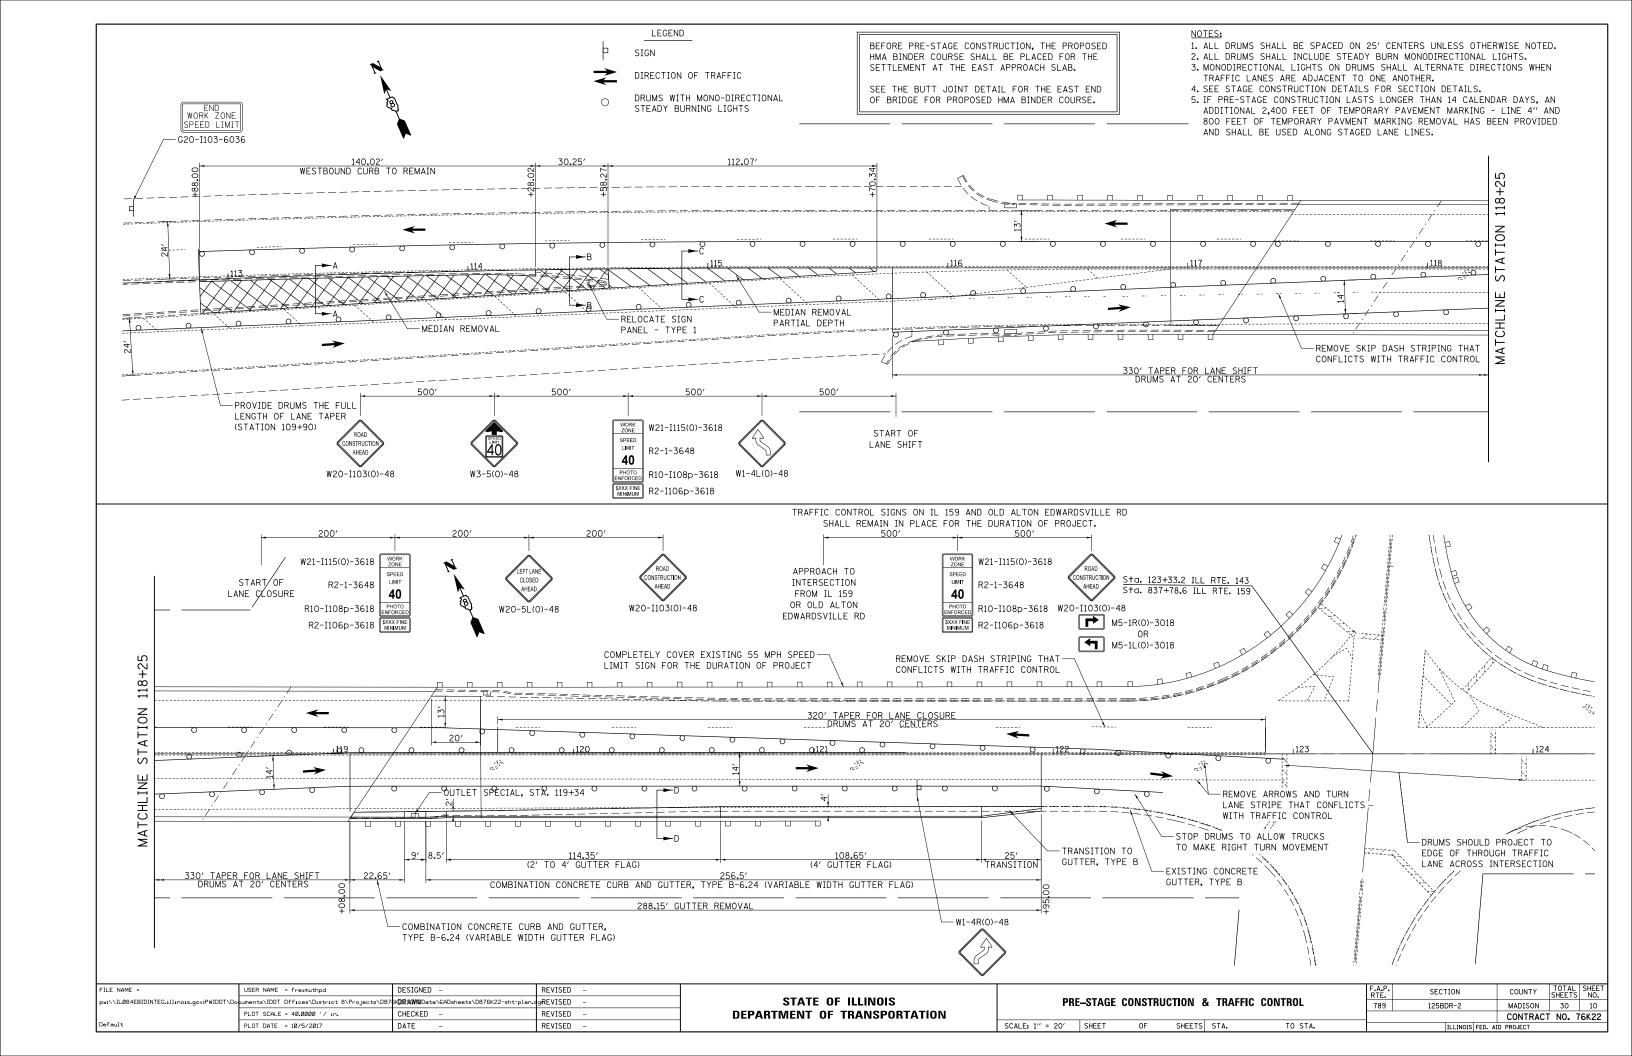


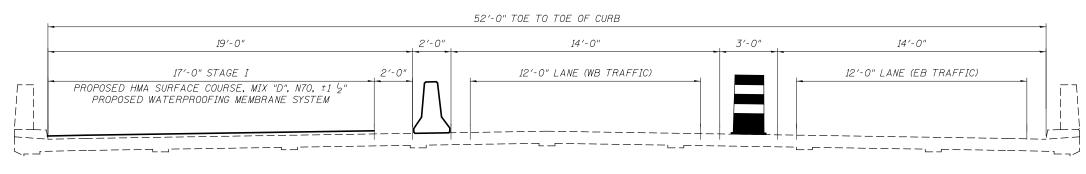

STAGE I CONSTRUCTION
(LOOKING EAST)

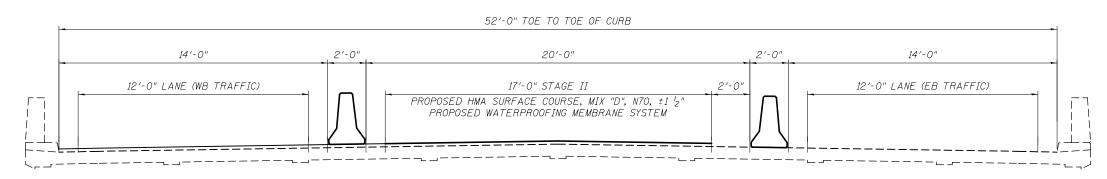



STAGE II CONSTRUCTION (LOOKING EAST)

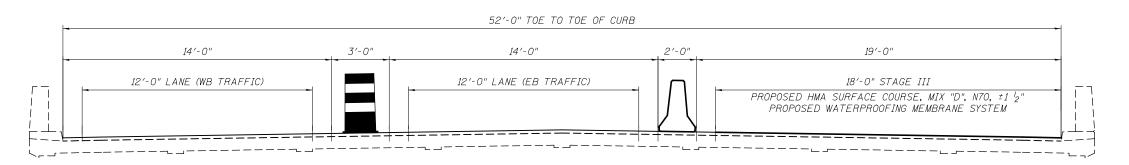



STAGE III CONSTRUCTION (LOOKING EAST)


FILE NAME =	USER NAME = freimuthpd	DESIGNED -	REVISED -		STAGE CONSTRUCTION & TRAFFIC CONTROL ACROSS S.N. 060-0083 SCALE: N.T.S. SHEET OF SHEETS STA. TO STA.		F.A.P.	SECTION	COUNTY	TOTAL SHEET			
pw:\\ILØ84EBIDINTEG.:111:no:s.gov:PWIDOT\Do	cuments\IDOT Offices\District 8\Projects\D87	K 2R XXXX Data\€ADsheets\D876K22-sht-plan.	gREVISED -	STATE OF ILLINOIS			789	125BDR-2	MADISON	30 11			
	PLOT SCALE = 40.0000 '/ in.	CHECKED -	REVISED -	DEPARTMENT OF TRANSPORTATION						CONTRACT	T NO. 76K22		
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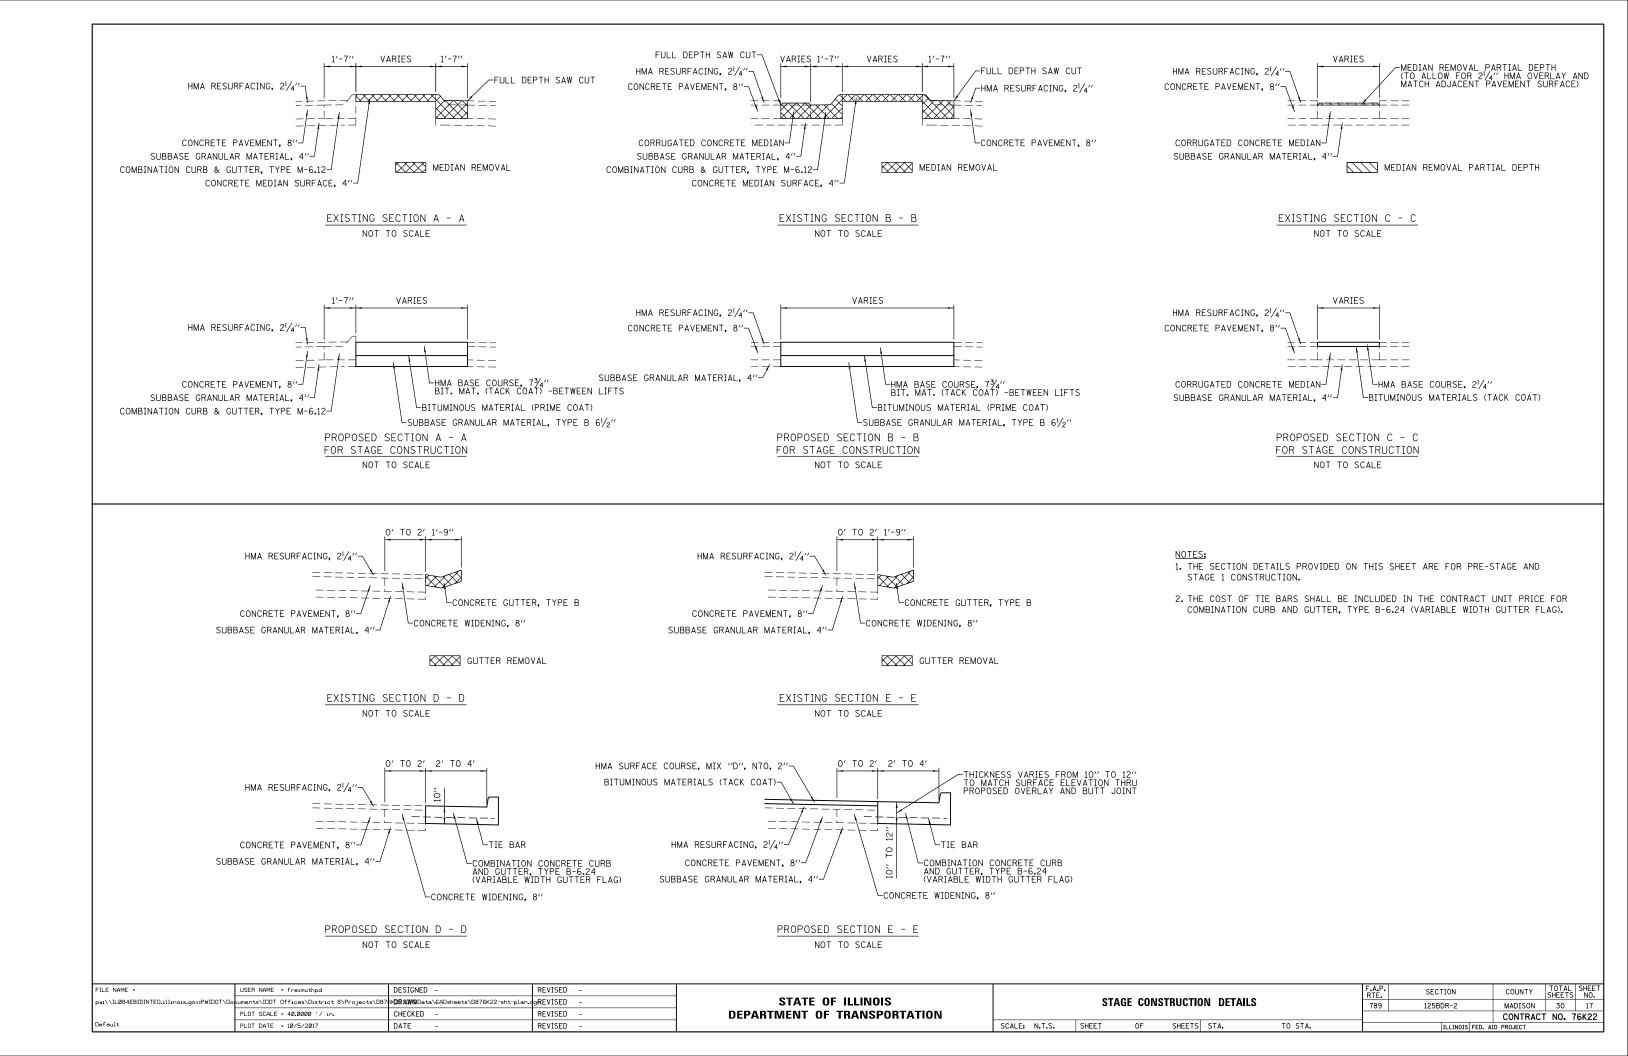


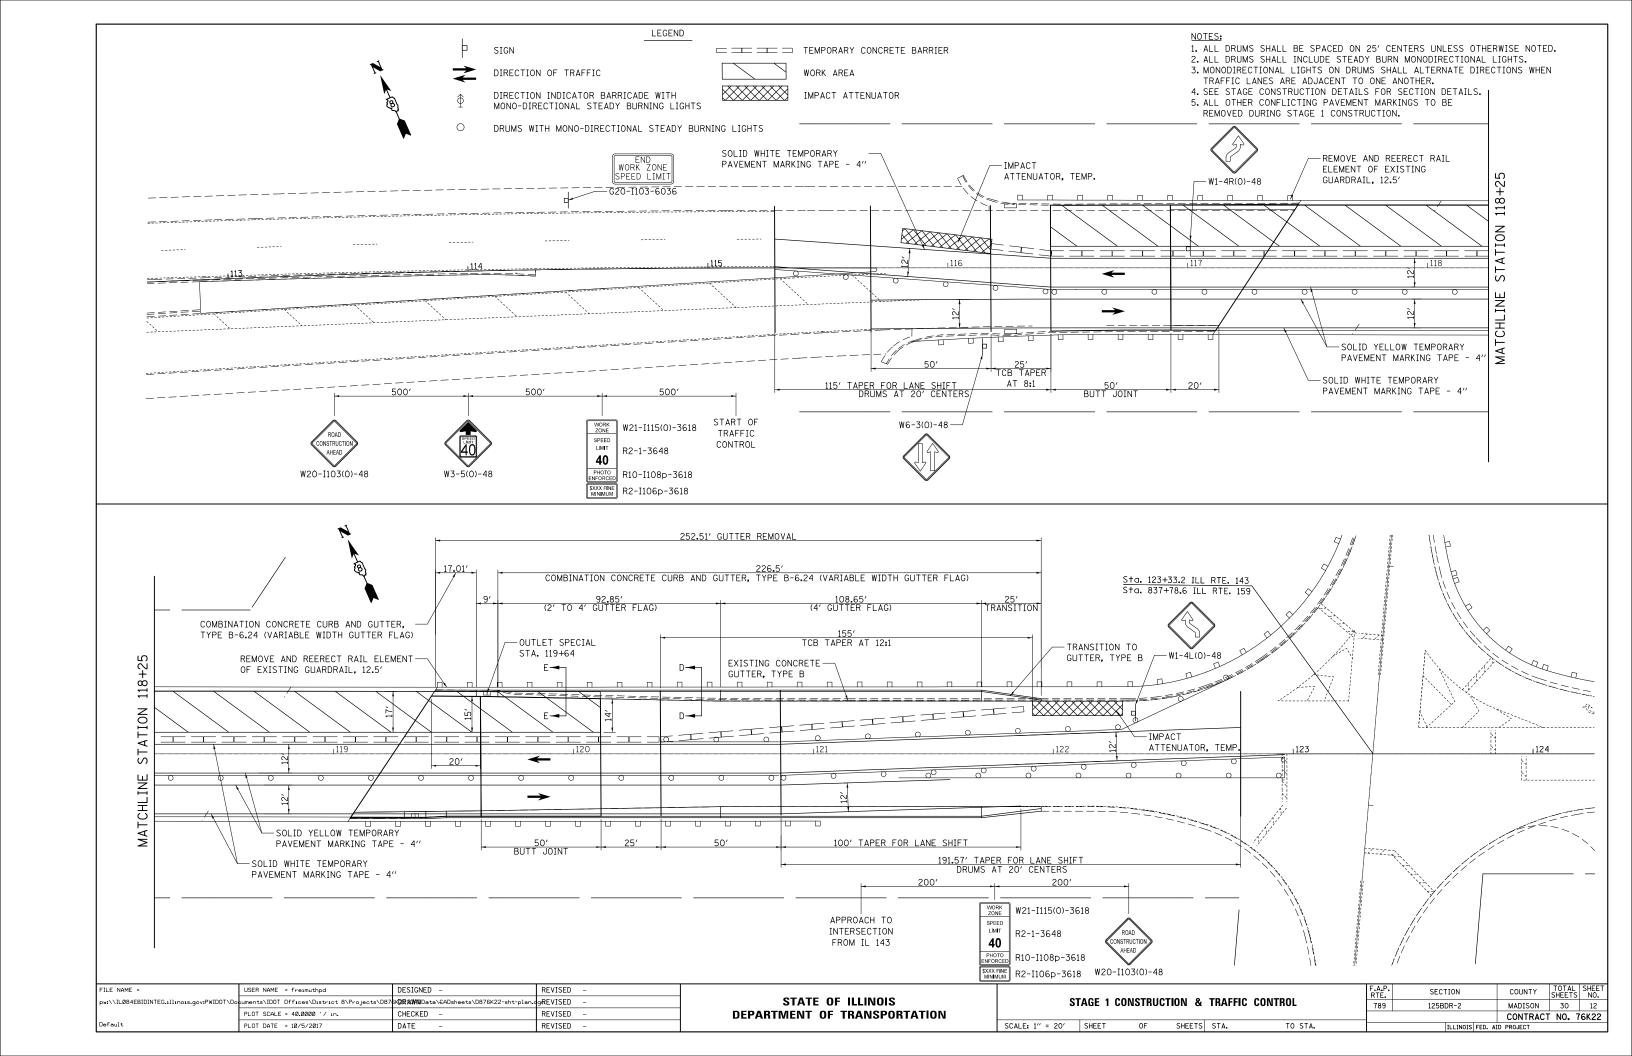


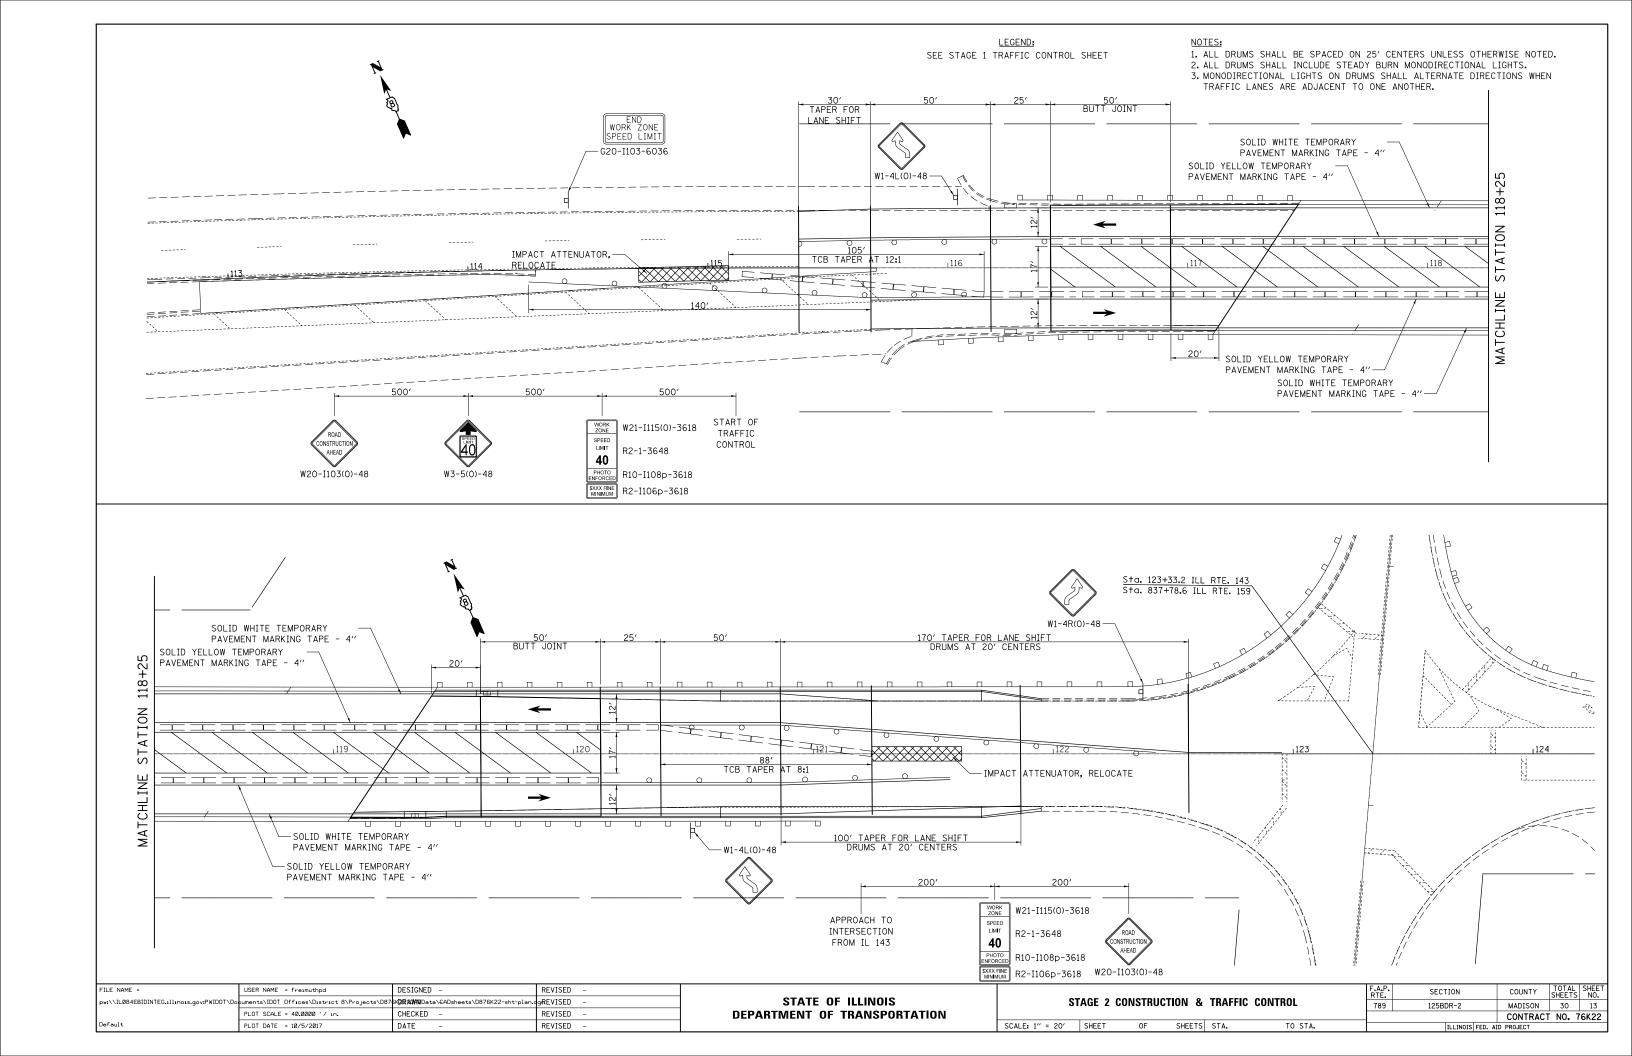


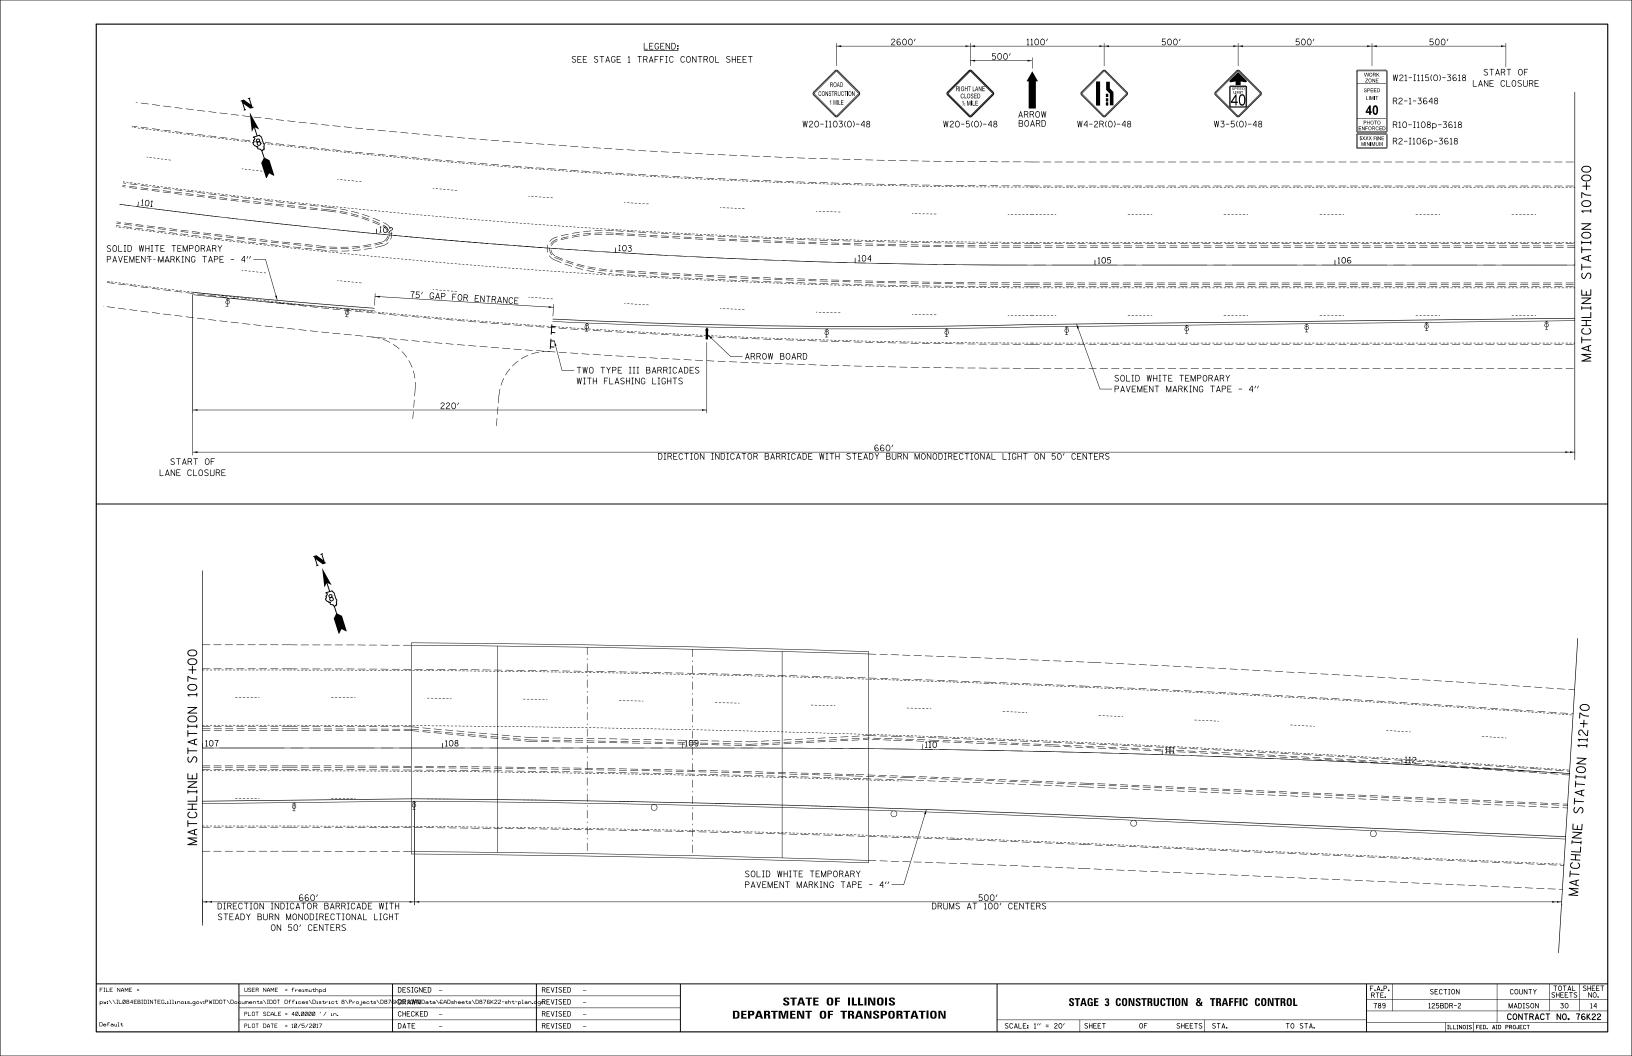

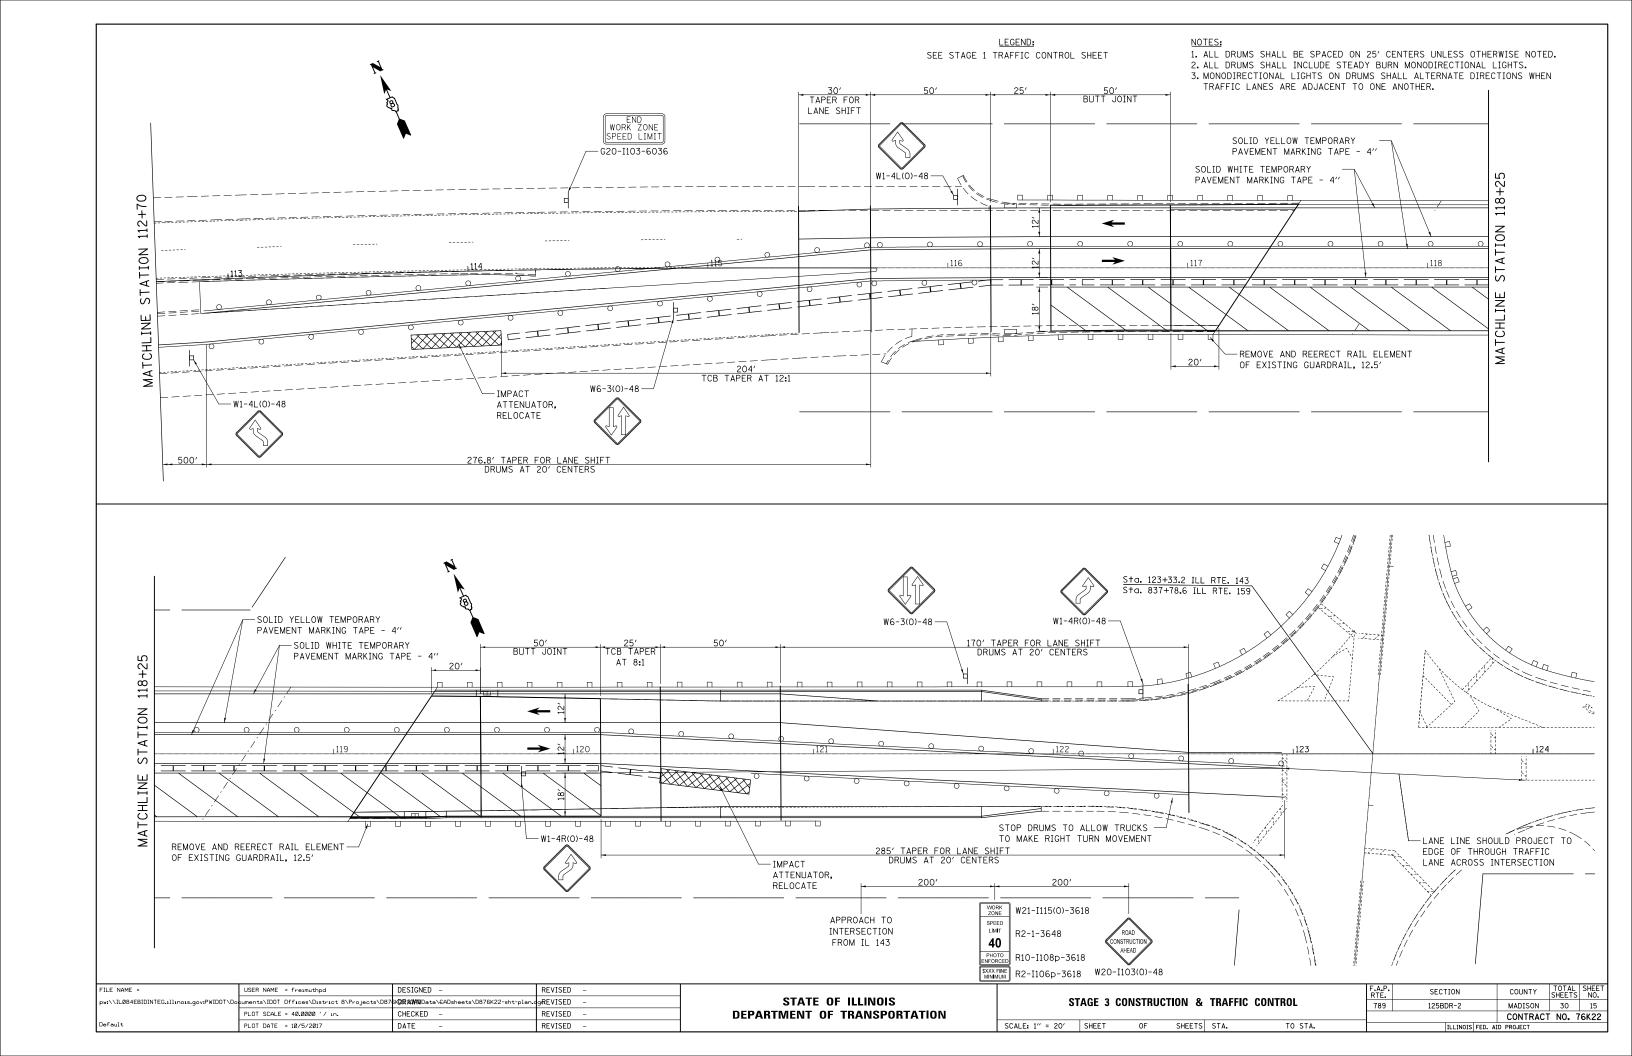

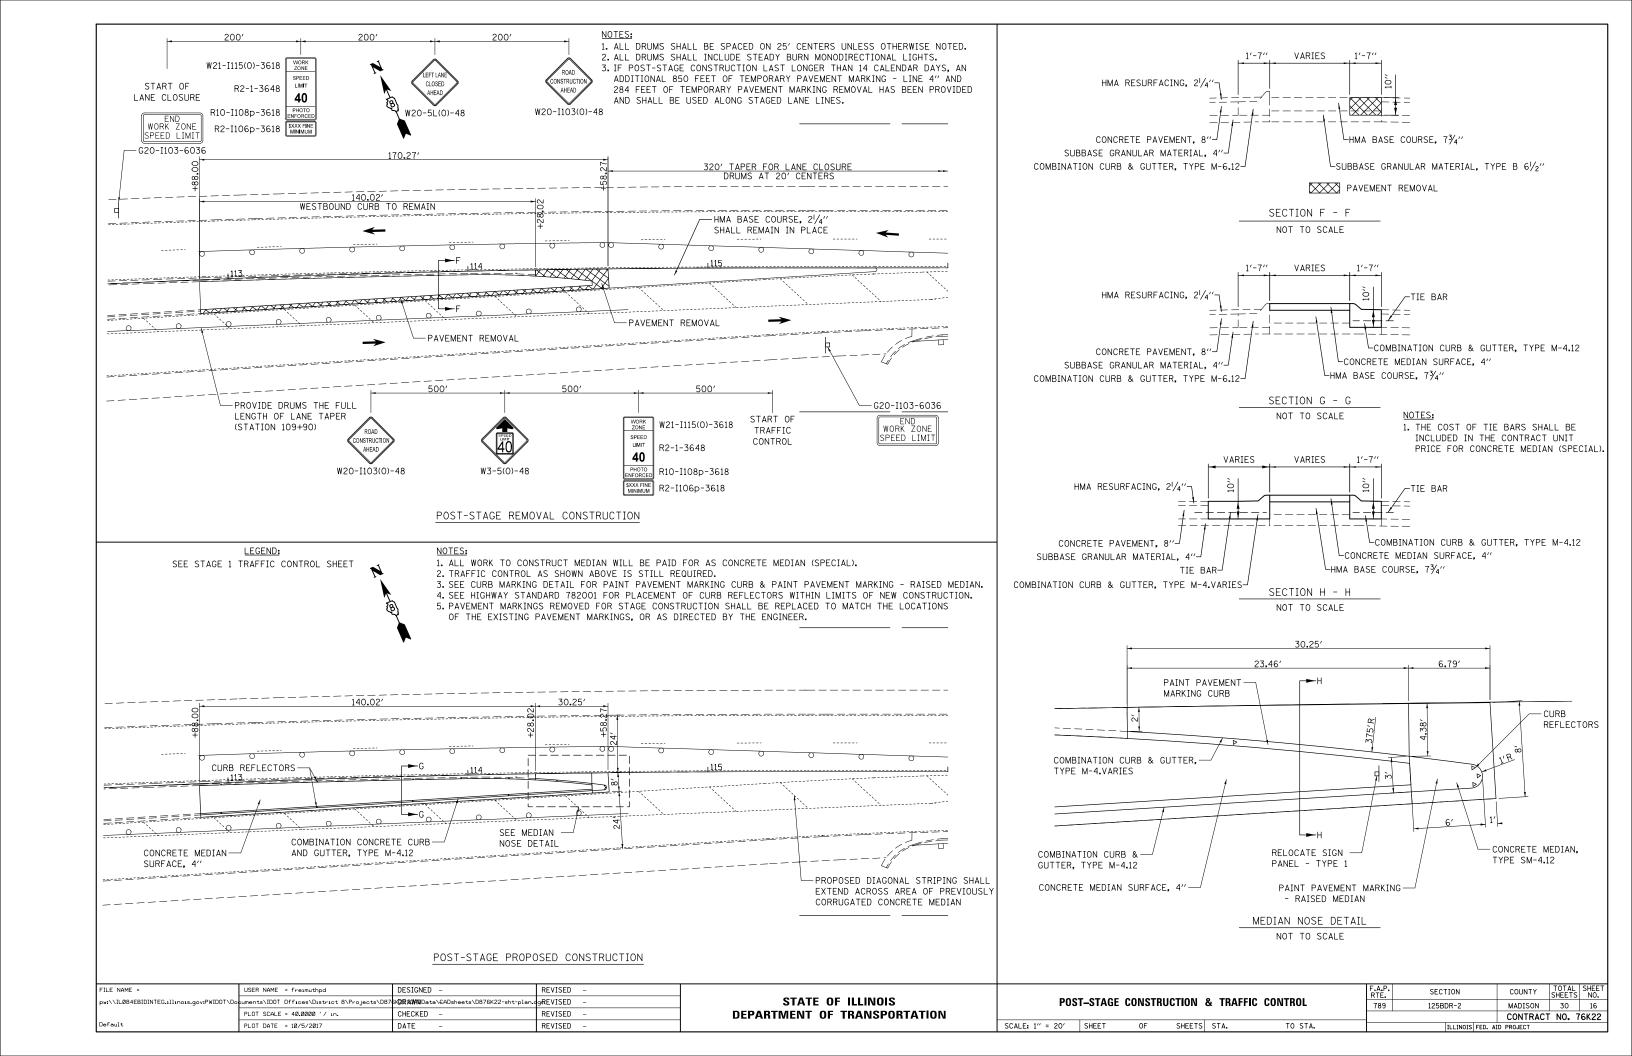

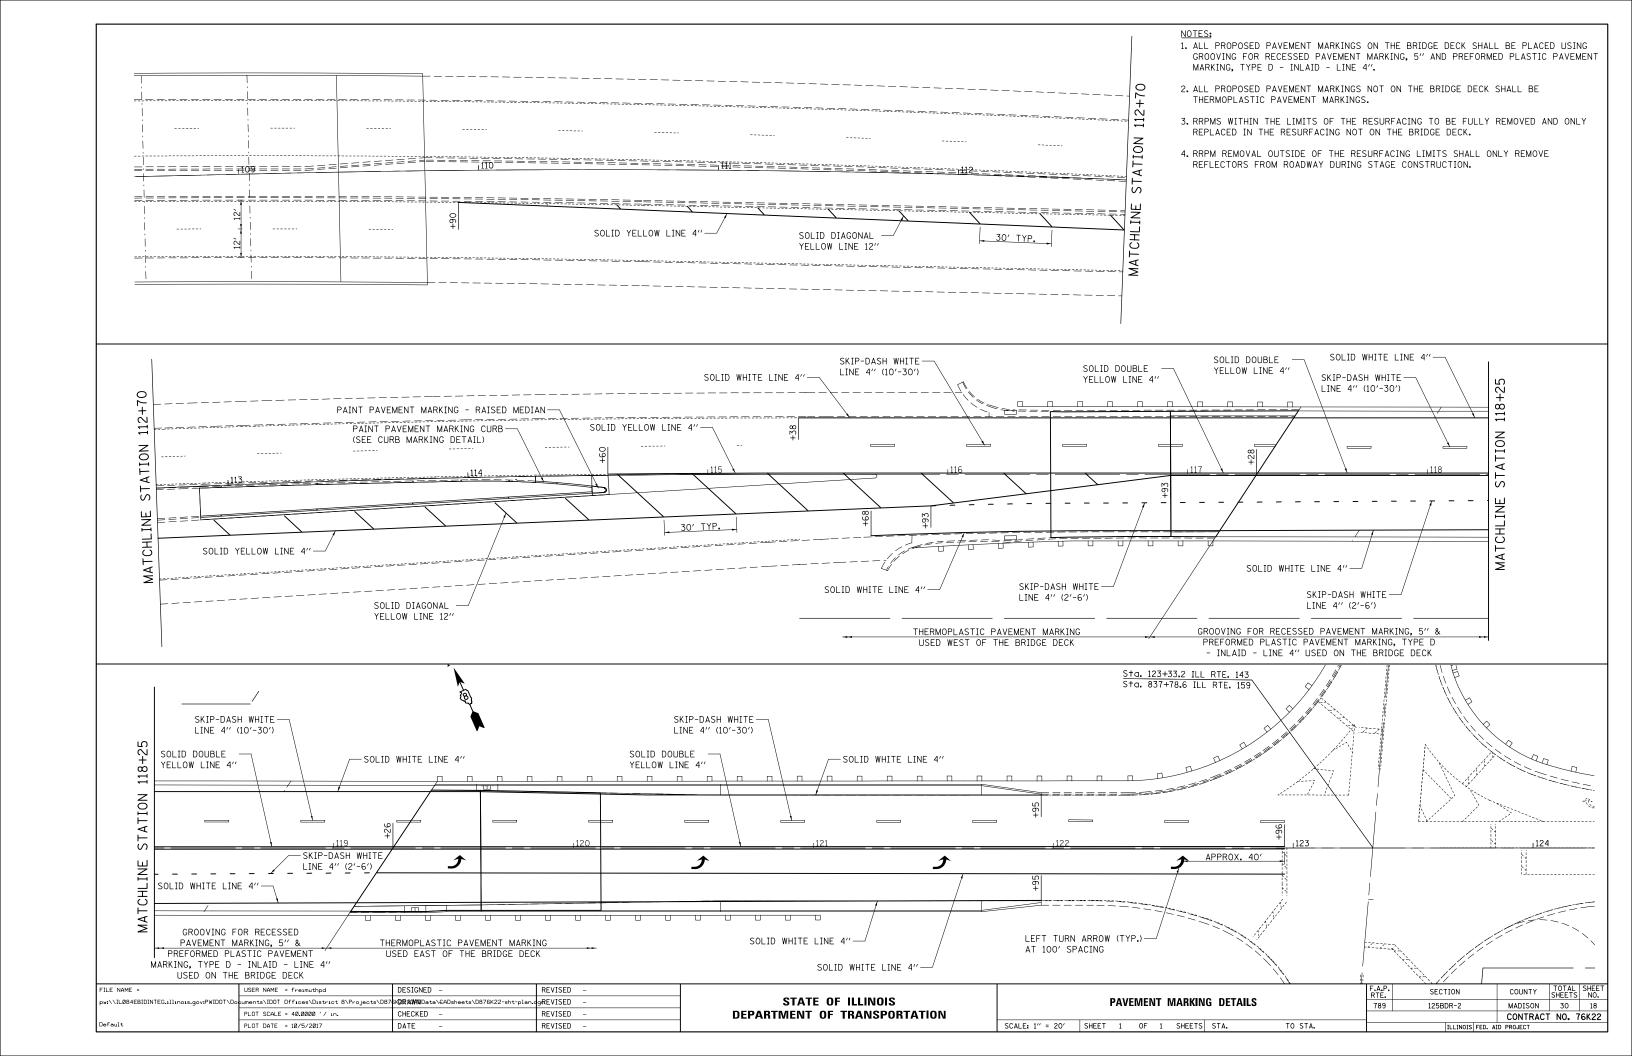

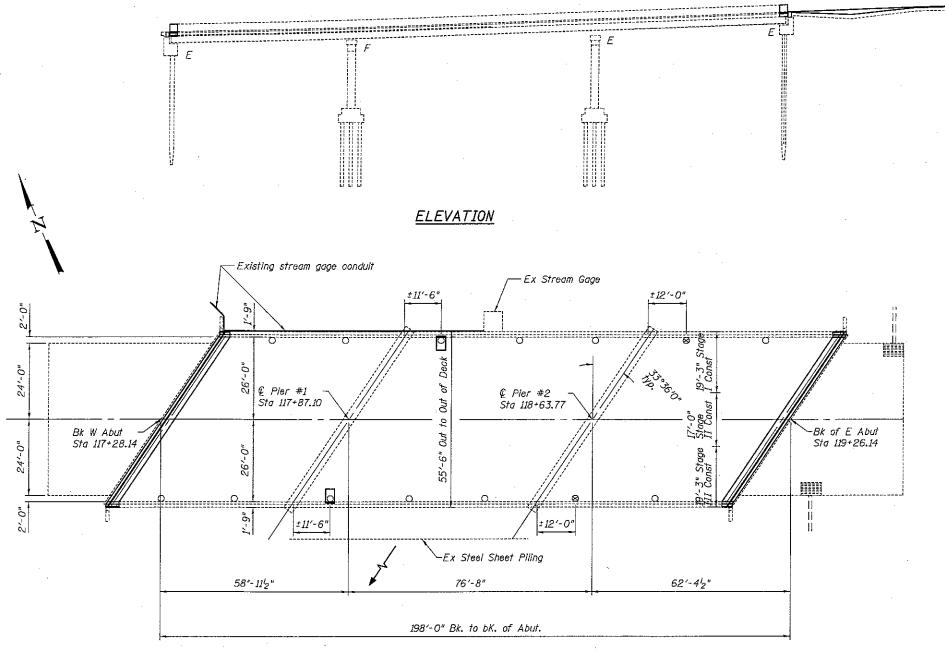

PLAN

PUZEY 081-005470

() Floor Drains to Remain

(2 Req'd) Plug Existing Drains

FLOOR DRAIN REPLACEMENT

2 Req'd) Existing scuppers & adjacent concrete to be removed and replaced with 6" circular drains and full depth patch. (See sheet 8 of 10 for details)

SCOPE OF WORK

- -Replace deck ends
- -Install Preformed Joint Strip Seals -HMA overlay with WMS on deck
- -Partial Deck Slab Repair
- -Eliminate floor drains within 10' of substructures and replace existina scuppers and adjacent concrete with 6" circular drains and full depth patch.

INDEX OF SHEETS

GENERAL NOTES Reinforcement bars designated (E) shall be epoxy coated.

covering removal of the existing concrete.

Prior to pouring the new concrete deck, all heavy or loose rust, loose mill scale, and other loose or potentially detrimental foreign material shall be removed from the surfaces in contact with concrete. Tightly adhered paint may

Plan dimensions and details relative to existing plans are subject to nominal construction variations. The Contractor shall field verify existing dimensions and details affecting new construction and make necessary approved adjustments prior to construction or ordering of materials. Such variations shall not be cause for additional compensation for a change in scope of the work, however, the Contractor will be paid for the quantity actually furnished at the unit price bid

Joint opening shall be adjusted according to Article 520.04 of the Standard Specs, when the deck is poured at an ambient temperature other than 50° F.

Existing reinforcement bars extending into removal area shall be cleaned, straightened and Incorporated into the new construction. Any reinforcement bars that are damaged during concrete removal shall be replaced with an approved bar

splicer or anchorage system. Cost included with Concrete Removal.

according to Article 420.09(e)(1) of the Standard Specifications.

Cost included with "Concrete Superstructure".

ITËM

Polymerized HMA Surface Course, Mix "D" N70

damage, please contact USGS.

Concrete Removal

Floor Drains

Concrete Superstructure

Plug Existing Deck Drains

Preformed Joint Strip Seal

Deck Slab Repair (Partial)

in the As-Built plans.

Reinforcement Bars, Epoxy Coated Bar Splicers

Deck Slab Repair (Full Depth, Type II.

* Quantities are estimated. The Engineer shall

determine the actual locations, and record them

Waterproofing Membrane System

Bridge Deck Concrete Sealer

Bridge deck concrete sealer shall be placed on top/inside faces

of (parapets & curbs) (full length) and on top of new concrete at joints.


The concrete on both sides of the joints shall have its final finish fined

Care shall be taken not to damage existing stream gage conduit when removing and replacing concrete at NW corner of bridge. In the event of

TOTAL BILL OF MATERIAL

remain unless otherwise noted. Removal shall be accomplished by methods that will not damage the steel and the cost will be included in the pay item

- 1. General Plan & Elevation
- 2. Deck Cross Section & Waterproofing Staging
- 3. Stage Traffic Lanes
- 4. Joint Removal
- 5. Joint Replacement
- 6. Joint Details
- 7. Strip Seal Details 8. Drain Details
- 9. Temporary Concrete Barrier
- 10. Bar Splicers

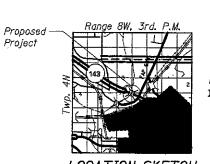

LOCATION SKETCH

UNIT TOTAL

Cu. Yd. 19.1

Each 2 Pound 1900

Each 24

Foot 127

Sg. Yd. 1101

Each 2

Sq. Yd. 40

Sq. Yd. 3

Sg. Ft. 1932

93 Cu. Yd. 17.2


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Each

	<u> </u>	
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STATE OF ILLINOIS **DEPARTMENT OF TRANSPORTATION** GENERAL PLAN & ELEVATION (IL 143 over Cahokia Creek) SN 060-0083 SHEET NO. 1 OF 10 SHEETS

F.A.P. RTE.	SECTION	COUNTY	TOTAL	SHEE NO.
789	125B0R-2	MADISON	30	19
		CONTRACT	NO. 7	6K22
	ILLINOIS FED. A	D PROJECT		




WATERPROOFING STAGING

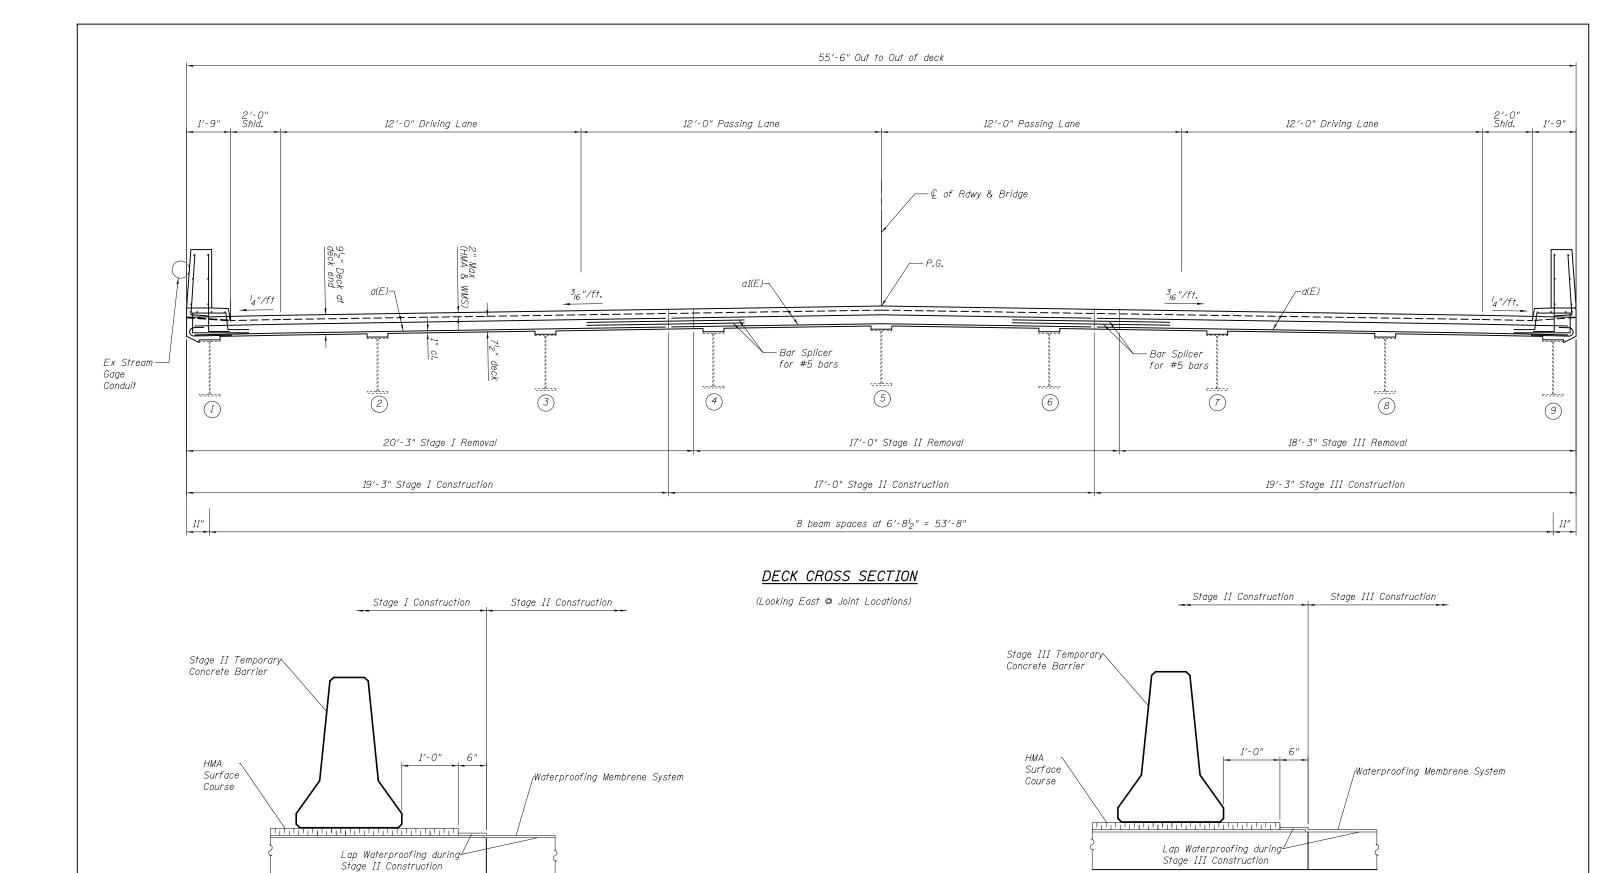(Across Stages I & II)

WATERPROOFING STAGING

(Across Stages II & III)

DESIGNED - AYV	EXAMINED		DATE -	OTATE OF HAMOLO	DECK CROSS SECTION & WATERPROOFING STAGING	F.A.P. RTE.	SECTION	COUNTY	TOTAL SHEET SHEETS NO.
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CHECKED -		ACTING ENGINEER OF BRIDGES AND STRUCTURES	REVISED		SHEET NO. 2 OF 10 SHEETS		ILLINOIS FED.	AID PROJECT	

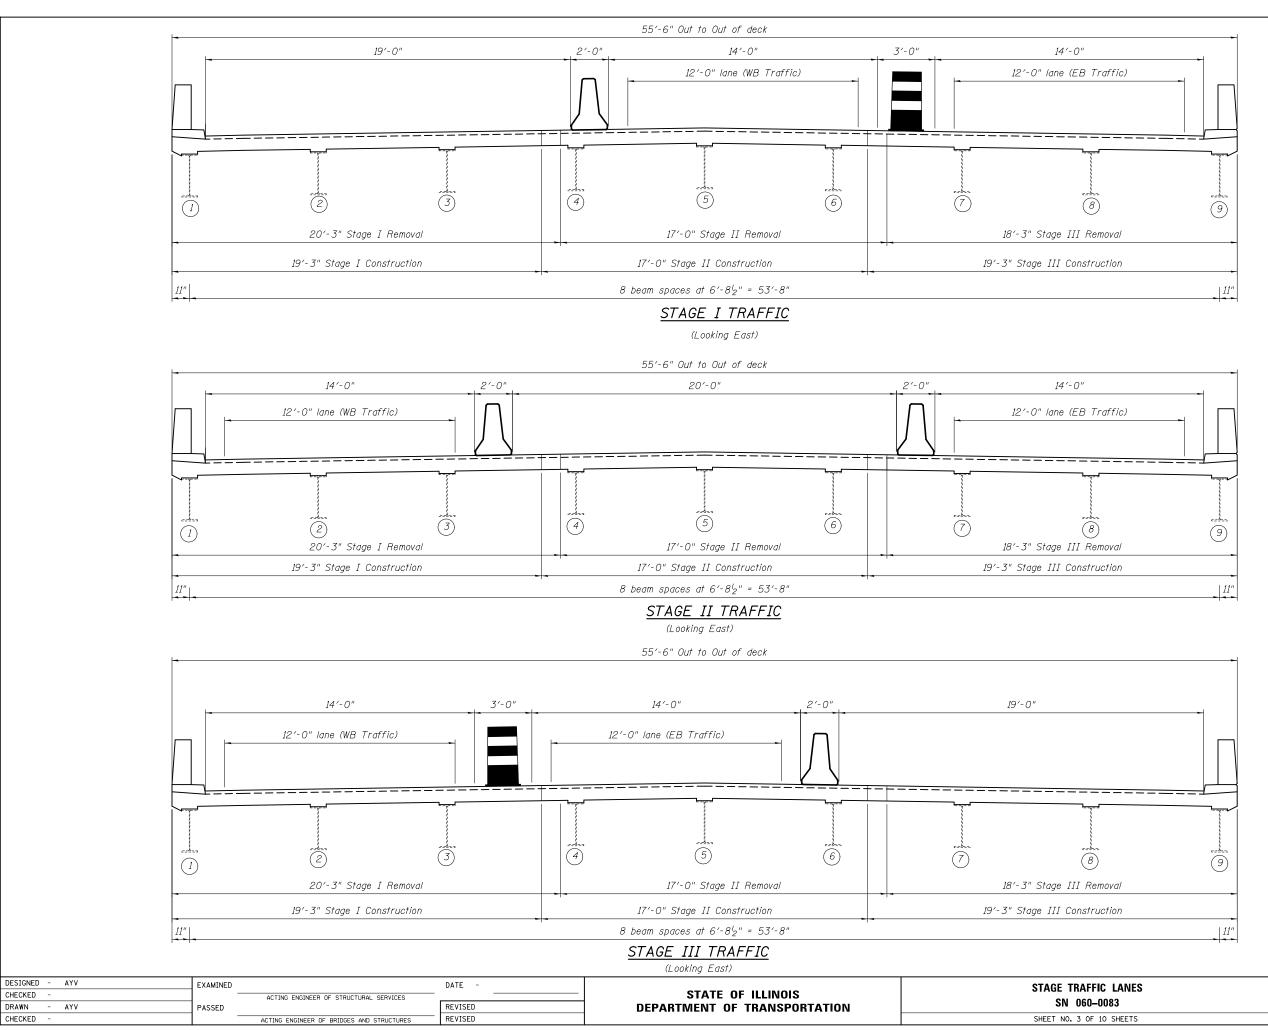

SECTION


125BDR-2


MADISON 30 21


CONTRACT NO. 76K22


789

7/26/2017 9:30

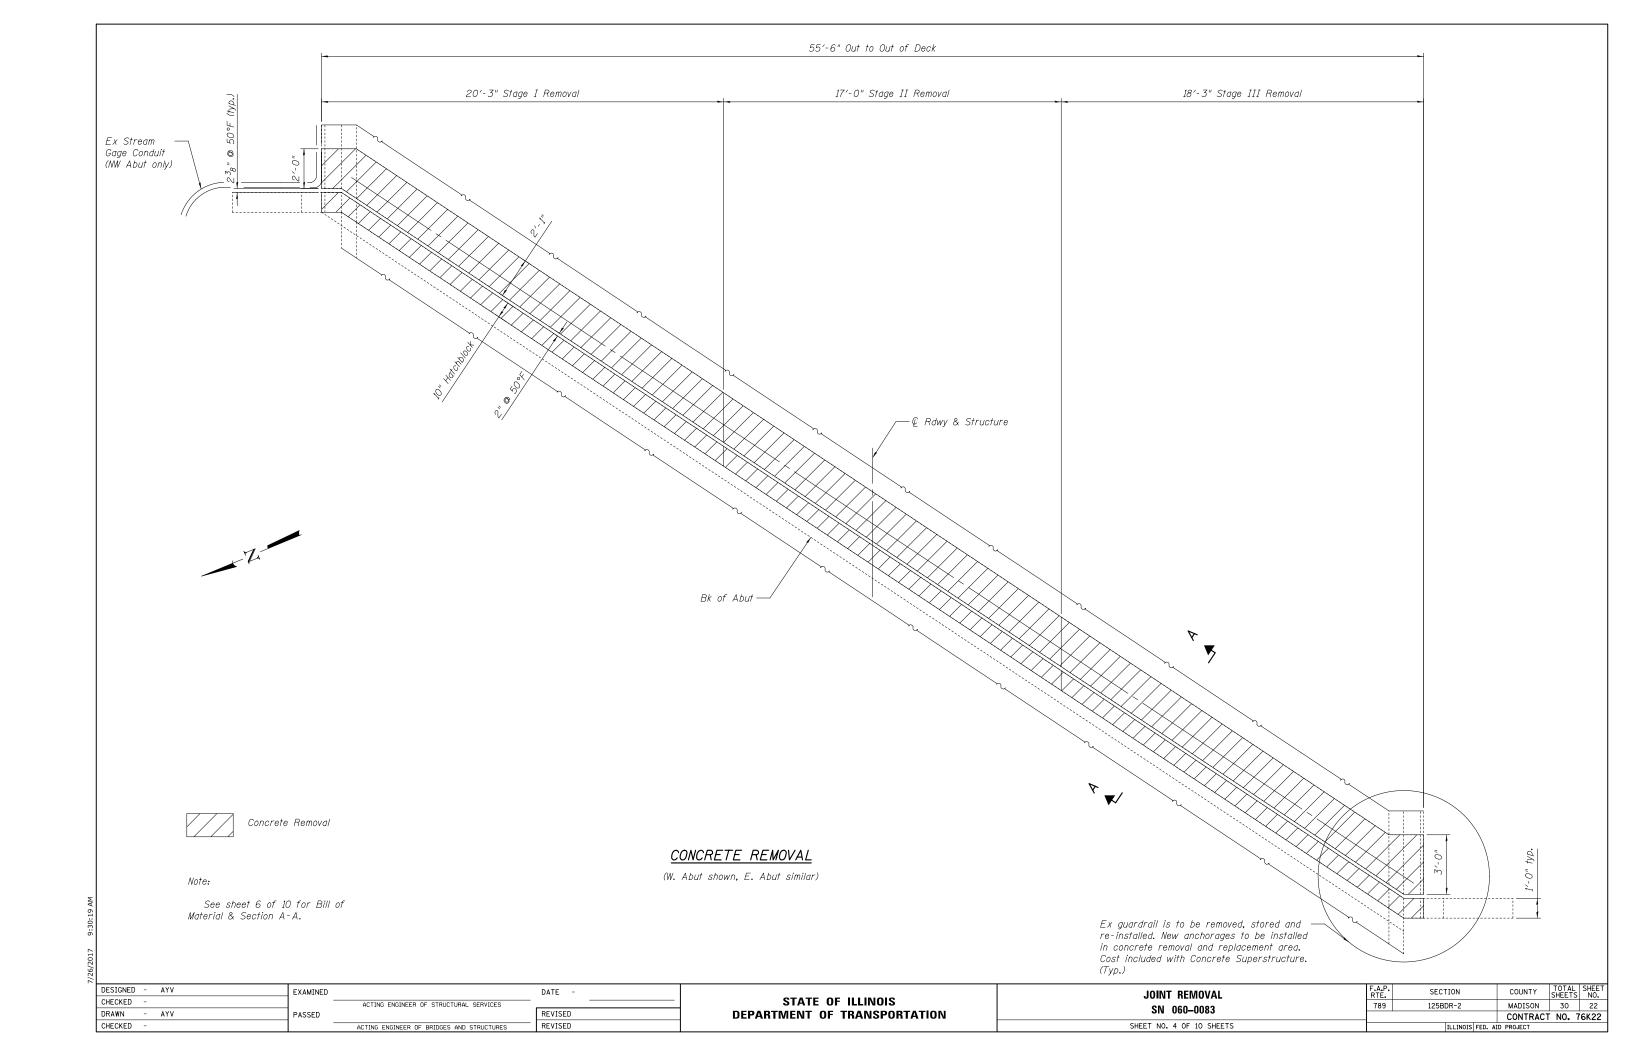

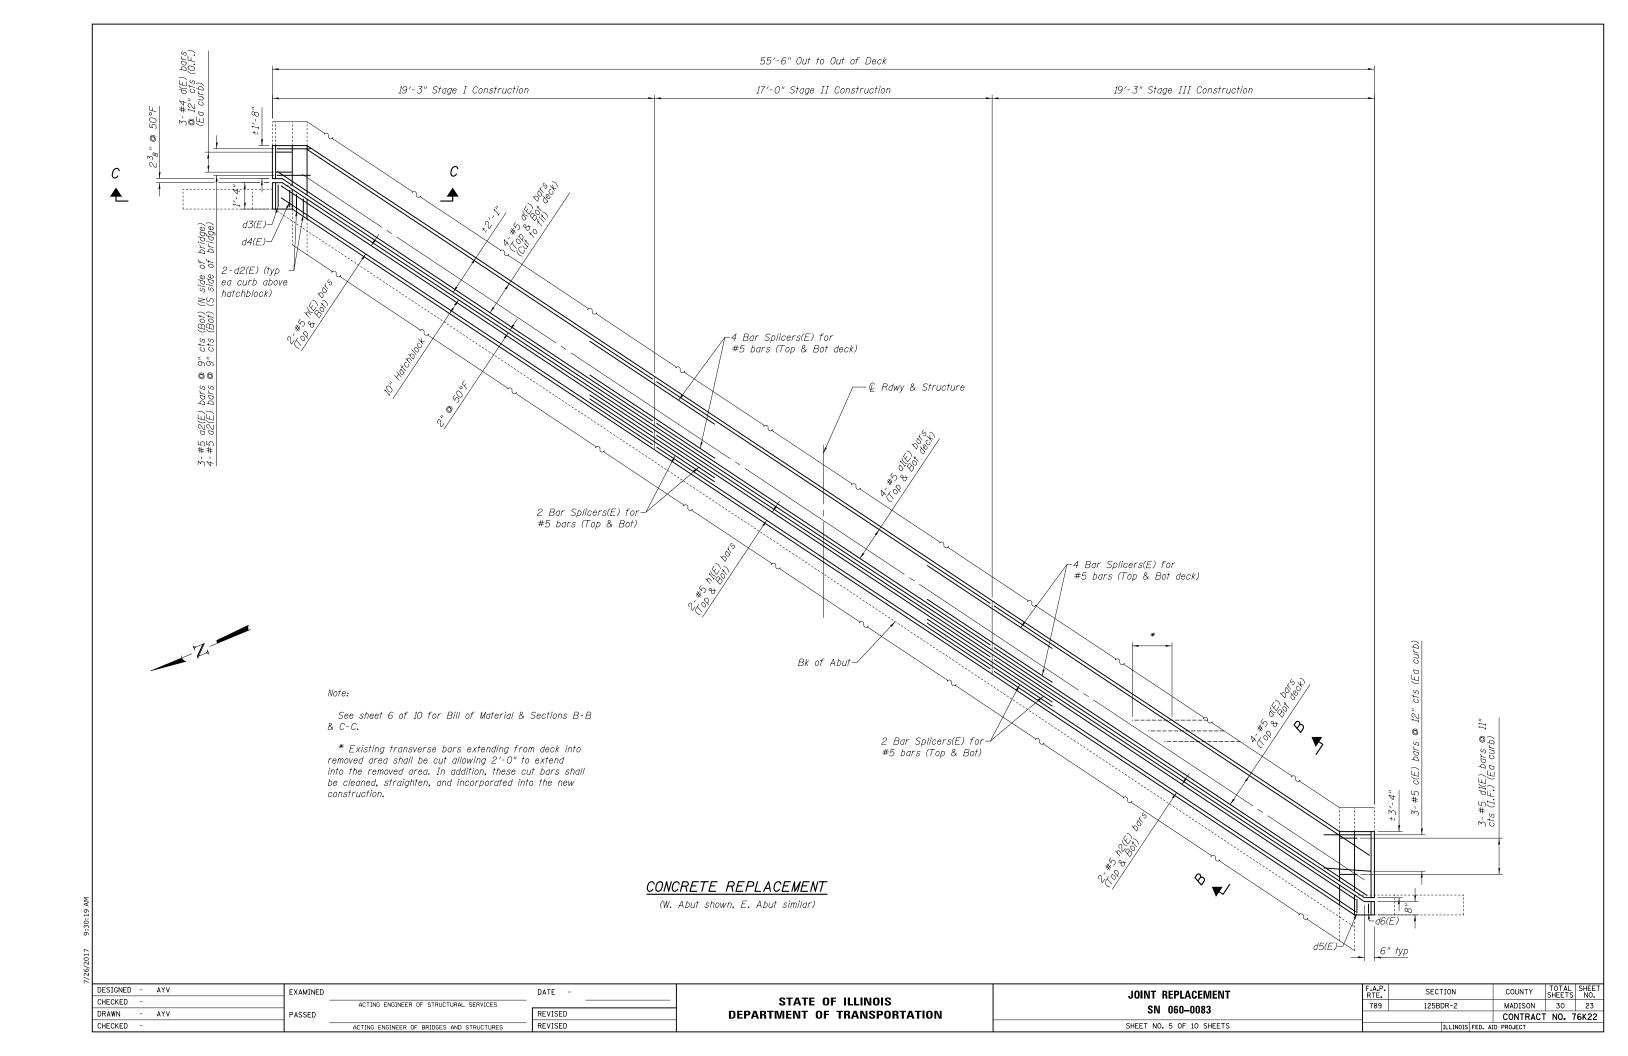

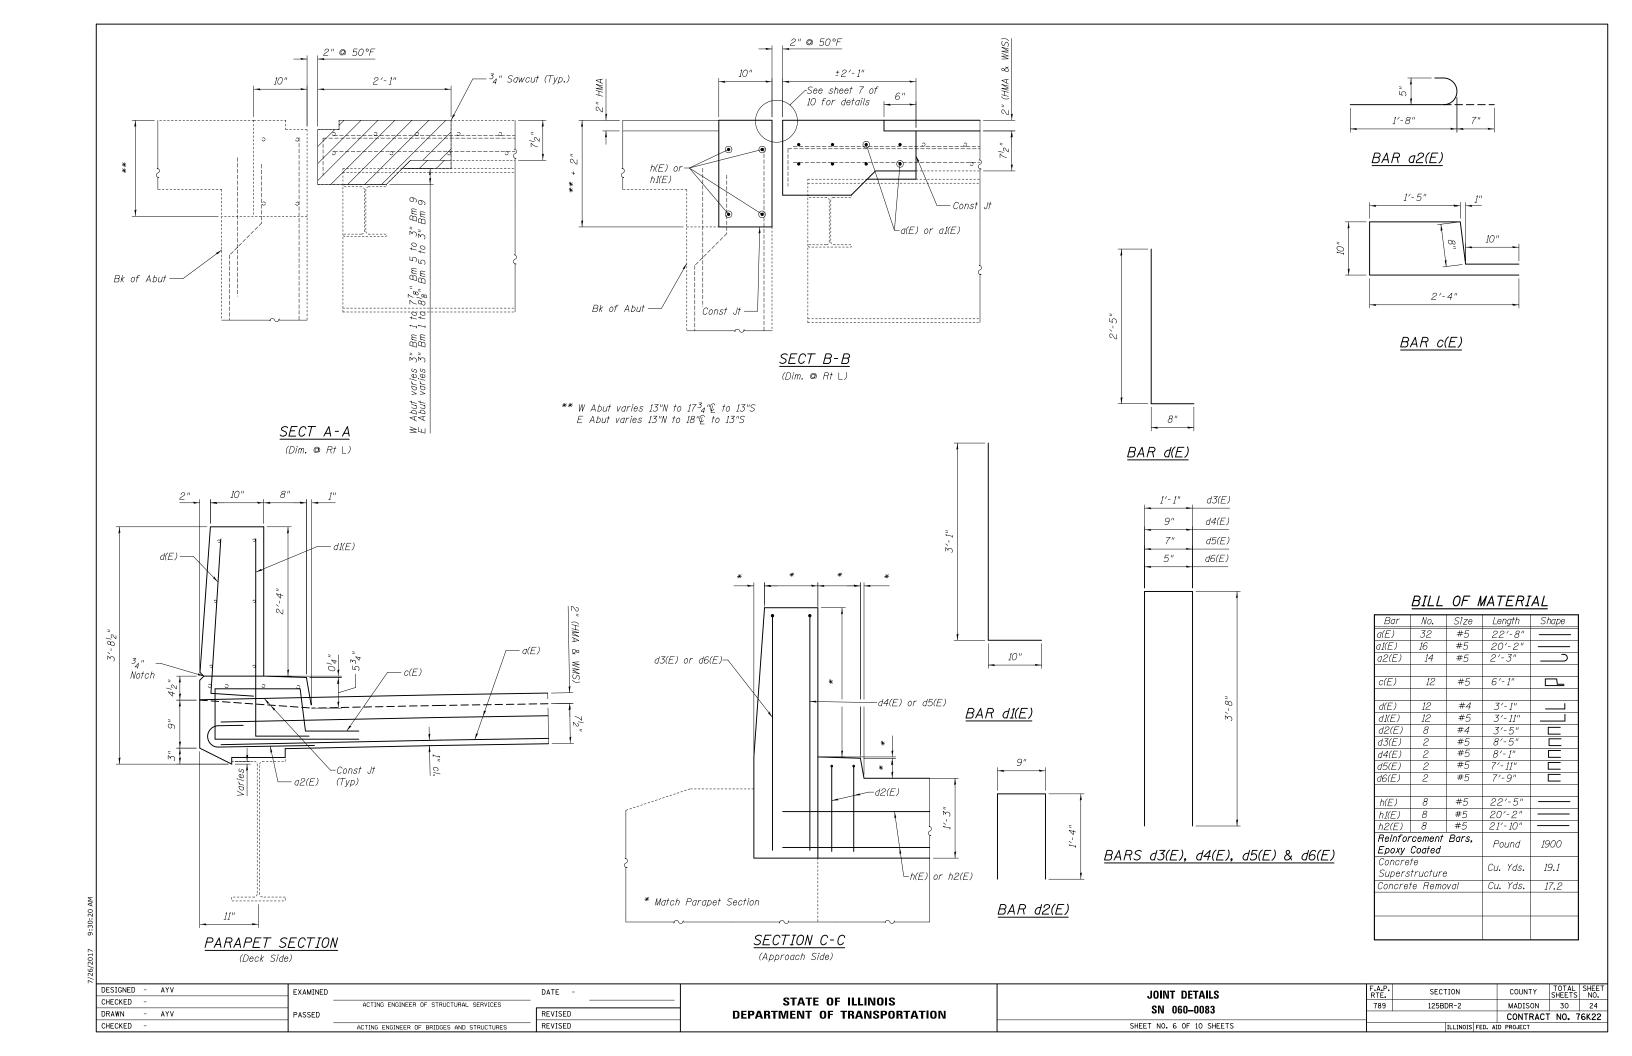


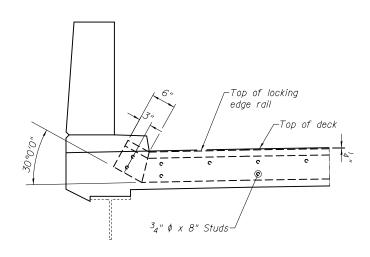


ELEVATION AT CURB / PARAPET

SECTION THRU

ROLLED RAIL JOINT

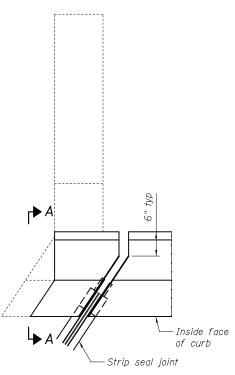


PLAN AT CURB / PARAPET

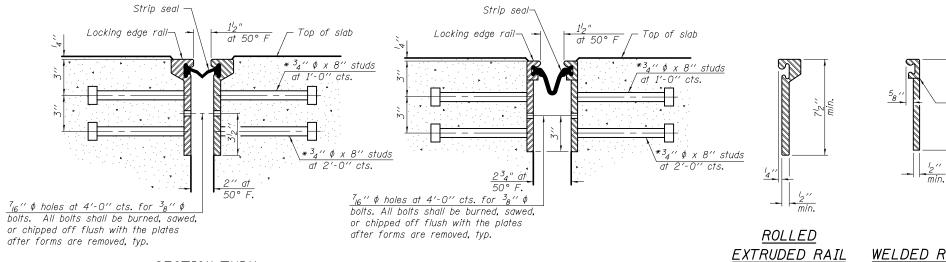

SECTION THRU WELDED RAIL JOINT

* Granular or solid flux filled headed studs conforming to Article 1006.32 of the Std. Specs., automatically end welded.

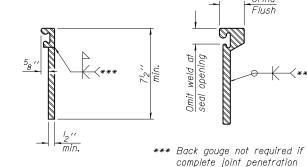

WELDED RAIL

LOCKING EDGE RAIL SPLICE

is verified by mock-up.

The inside of the locking edge rail groove shall be free of weld residue.

Rolled rail shown, welded rail similar.

LOCKING EDGE RAILS

Notes:

The strip seal shall be made continuous and shall have a minimum thickness of $\frac{1}{4}$ ". The configuration of the strip seal shall match the configuration of the Locking Edge Rails. Open or "webbed" strip seal gland configurations are not permitted. The gland shall be sized for a maximum rated movement of 4 inches.

The Locking Edge Rails depicted are conceptual only, except for the minimum dimensions shown. The actual configuration of the Locking Edge Rails and matching strip seal may vary from manufacturer to manufacturer. Flanged edge rails will not be allowed. Locking Edge Rails may be spliced at slope discontinuities.

The manufacturer's recommended installation methods shall be followed.

The joint opening and deck dimensions detailed on the superstructure are based on a rolled rail expansion joint. If the Contractor elects to use the welded rail expansion joint, the opening and deck dimensions shall be modified according to the dimensions detailed on this sheet. Required modifications shall be made at no additional cost to the State.

All steel components shall be galvanized after fabrication according to Article 520.03 of the Standard Specifications.


Maximum space between rail segments shall be 316", sealed with a suitable sealant. Joints in rails within 10 ft. of curbs shall be welded.

Parapet plates and anchorage studs for skews > 30° included in the cost of Preformed Joint Strip Seal.


BILL OF MATERIAL

Item	Unit	Total
Preformed Joint Strip Seal	Foot	127

DESIGNED - AYV	EXAMINED	DATE - MARCH 3, 2017	OTATE OF HILINOIS	PREFORMED JOINT STRIP SEAL	F.A.P. RTE.	SECTION	COUNTY	TOTAL SHEET NO.
CHECKED DRAWN - AYV	ACTING ENGINEER OF STRUCTURAL SERVICES	REVISED	STATE OF ILLINOIS	STRUCTURE NO. 060-0083	789	125BDR-2	MADISON	30 25
CHECKED	ACTING ENGINEER OF BRIDGES AND STRUCTURES	REVISED	DEPARTMENT OF TRANSPORTATION	SHEET NO. 7 OF 10 SHEETS		ILLINOIS FED. A	CONTRACT AID PROJECT	Г NO. 76K22

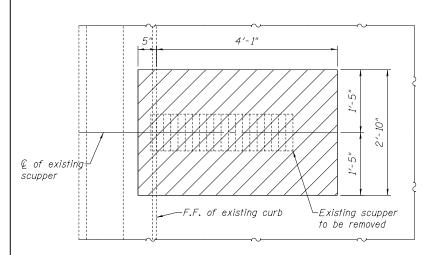

PLAN-REMOVAL OF EXISTING SCUPPER AND ADJACENT CONCRETE

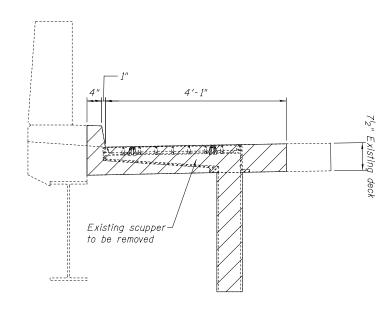


<u>SECTION-REMOVAL OF EXISTING</u> SCUPPER AND ADJACENT CONCRETE

The floor drains shall be painted to match the outside of the fascia beams. Fiberglass pipe shall conform to ASTM D 2996, with short-time rupture strength hoop tensile strees of 30,000 p.s.i. minimum.


Galvanize clamping device according to AASHTO M232.

Cost of clamping device and inserts is included with Floor Drains.


Cost of Concrete Removal and replacement and removal of existing drains is included in cost of Deck Slab Repair (Full Depth, Type II)

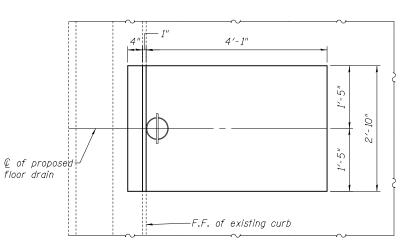



PLAN-PROPOSED FLOOR DRAIN & FULL DEPTH PATCH

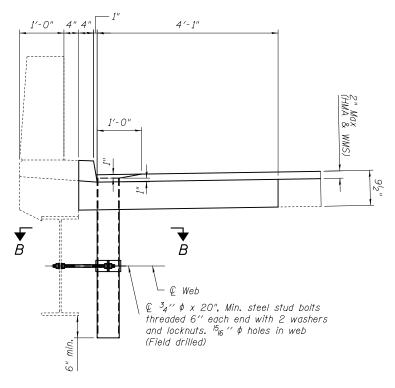


SECTION-PROPOSED FLOOR DRAIN & FULL DEPTH PATCH

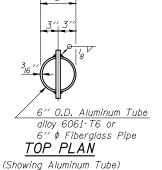


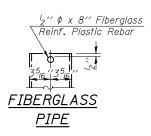

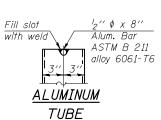


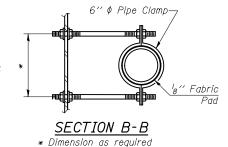

by Pipe Clamp

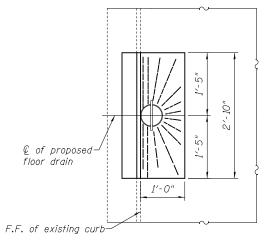


(See sheet 1 of 10 for locations to replace scupper with proprosed drain) (2 Req'd)

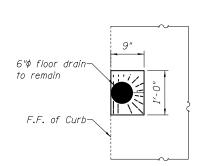

(See sheet 1 of 10 for locations to remain) (10 Req'd)

Slope to drain with 1" minimum HMA at drains edge

PLAN-HMA @ DRAINS

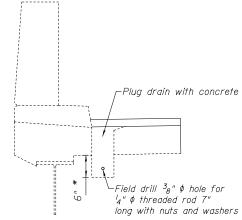

* Cut off drain 6" below the deck

PLUG DRAIN DETAIL

(See sheet 1 of 10 for locations) (2 Req'd)

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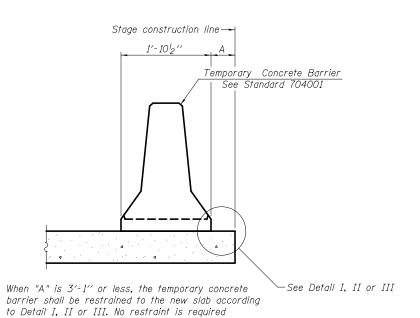
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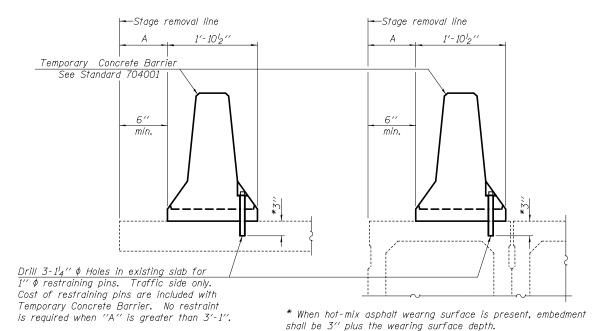
DATE REVISED REVISED


STATE OF ILLINOIS **DEPARTMENT OF TRANSPORTATION**

DRAIN DETAILS 060-0083 SHEET NO. 8 OF 10 SHEETS

SECTION COUNTY 789 125BDR-2 MADISON 30 26 CONTRACT NO. 76K22





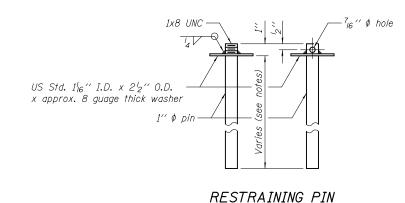


NEW SLAB OR NEW DECK BEAM


when "A" is greater than 3'-1".


EXISTING SLAB

EXISTING DECK BEAM

SECTIONS THRU SLAB OR DECK BEAM

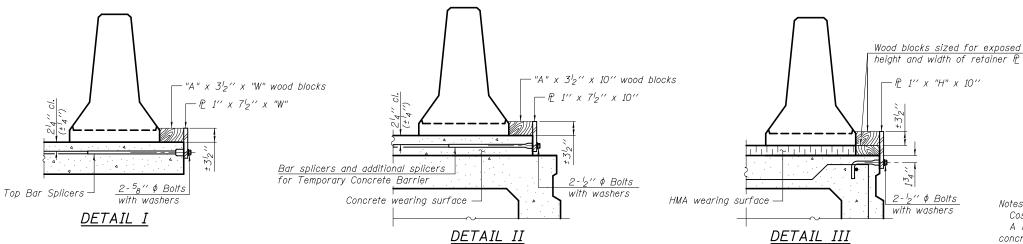

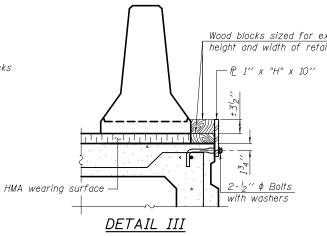

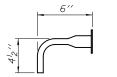

BAR SPLICER FOR #4 BAR - DETAIL III

Detail I Detail II 2" Top bars Spa. 2" Detail I Detail II 64 $-Q 7_8'' \phi$ Holes

10′′ 6′′

STEEL RETAINER PL 1" x "H" x 10"

(Detail III)

Cost of retainer assembly is included with Temporary Concrete Barrier. A retainer assembly shall be located at the approximate ${\mathfrak C}$ of each temporary concrete barrier.

The retainer plate shall not be removed until the concrete on the adjacent stage is ready to be poured. For Detail III applications the retainer plate shall not be removed until just prior to placing the adjacent beam.

When the 'A' dimension is less than $1_2^{\prime\prime}$, the wood block shall be omitted and the barrier shall be placed in direct contact with the steel retainer plate. For deck beam applications the minimum required 'A' distance is 6" to accommodate the shear key clamping device.

- Detail I Installation for a new bridge deck or bridge slab.
- Detail II Installation for a new deck beam with an initial concrete wearing surface. Additional bar splicers shall be provided at 6'-0" centers and paired with the bar splicers of the concrete wearing surface reinforcement to accommodate the installation of the retainer assemblies. The cost of the additional bar splicers is included with the concrete wearing surface.
- Detail III Installation for a new deck beam with no initial wearing surface or with an initial hot-mix asphalt (HMA) wearing surface present. The deck beam directly beneath the temporary concrete barrier shall be fabricated with bar splicer inserts in the side of the beam, as detailed, to accommodate the installation of the retainer assemblies. A pair of bar splicers, 6" apart, shall be placed at 6'-0" centers along the length of the beam. The cost of the bar splicers is included with the deck beam.

STEEL RETAINER PL 1" x 7 2" x "W"


(Detail I and II)

R-27	11-22	2-2016			
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CHECKED -		_	ACTING ENGINEER OF BRIDGES AND STRUCTURES	REVISED	

STATE OF ILLINOIS
DEPARTMENT OF TRANSPORTATION

	F.A.P. RTE.	SECTION	COUNTY	TOTAL SHEETS	SHEET NO.
STRUCTURE NO. 060-0083		125BDR-2	MADISON	30	27
STHOUTONE NO. 000-0003			CONTRACT	NO. 7	6K22
SHEET NO. 9 OF 10 SHEETS		ILLINOIS FED. AI	D PROJECT		

R-27

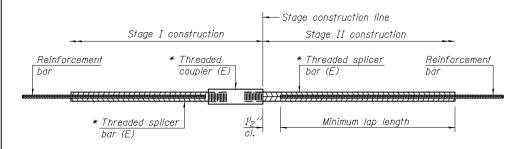


STANDARD BAR SPLICER ASSEMBLY

Threaded splicer bar length = min. lap length + 1^{l}_{2} " + thread length

* Epoxy not required on Bar Splicer Assembly components used in conjunction with black bars.


Location	Bar size	No. assemblies required	Minimum Iap length
W Abut (Hatchblock)	#5	4	3′-6"
W Abut (Deck)	#5	8	3′-6"
E Abut (Deck)	#5	8	3′-6"
E Abut (Hatchblock)	#5	4	3′-6"

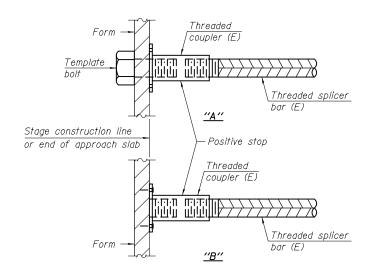

INSTALLATION AND SETTING METHODS


"A": Set bar splicer assembly by means of a template bolt. "B" : Set bar splicer assembly by nailing to wood forms or cementing to steel forms.

(E): Indicates epoxy coating.

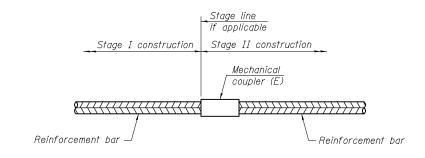

STANDARD MECHANICAL SPLICER

Location	Bar size	No. assemblies required

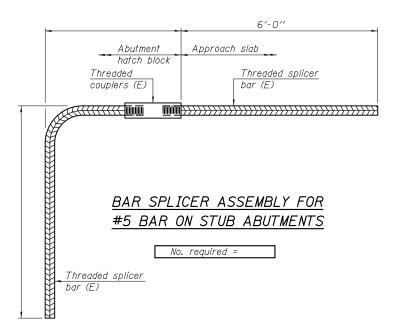

NOTES

Splicer bars shall be deformed with threaded ends and have a minimum 60 ksi yield strength.

All reinforcement shall be lapped and tied to the splicer bars. Bar splicer assemblies shall be epoxy coated according to the requirements

for reinforcement bars. See Section 508 of the Standard Specifications. See approved list of bar splicer assemblies and mechanical splicers for alternatives.

BSD-1

11-22-2016


DESIGNED	-	A.Y.V.	EXAMINED		DATE -	
CHECKED	-			ACTING ENGINEER OF STRUCTURAL SERVICES		
DRAWN	-	A.Y.V.	PASSED		REVISED	
CHECKED	-			ACTING ENGINEER OF BRIDGES AND STRUCTURES	REVISED	


STATE OF ILLINOIS

BAR SPLICER ASSEMBLY AND MECHANICAL SPLICER DETAILS STRUCTURE NO. 060-0083 SHEET NO. 10 OF 10 SHEETS

SECTION COUNTY 789 125BDR-2 MADISON 30 28 CONTRACT NO. 76K22

DEPARTMENT OF TRANSPORTATION

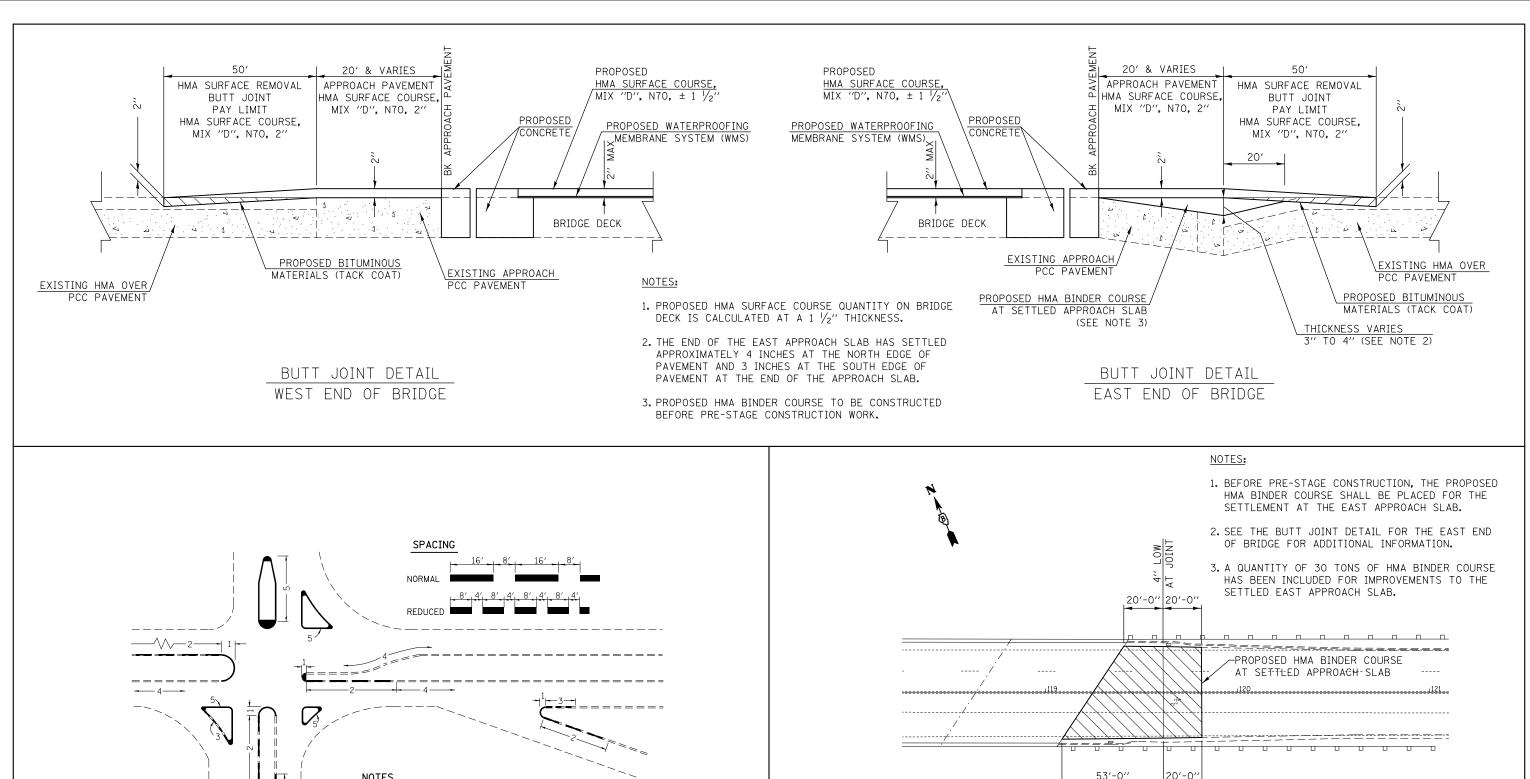

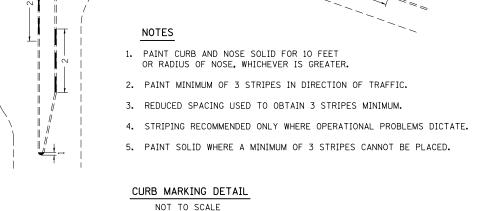


SETTLED APPROACH SLAB OVERLAY DETAIL NOT TO SCALE


EAST APPROACH SLAB


APPROACH SLAB


PWINIDBREDINTEG.111:nois.goviPWIDDTNDo uments\IDDT Offices\District 8\Projects\DB76KZ2-sht-plan.egeREVISED - STATE OF ILLINOIS PLOT SCALE = 100.0000 '/ in. CHECKED - REVISED - DEPARTMENT OF TRANSPORTATION STATE OF ILLINOIS DETAILS TO DEPARTMENT OF TRANSPORTATION	SHEETS NO.
PLOT SCALE = 100 0000 // 10 CHECKED - PEVISED - DEPARTMENT OF TRANSCOORTATION	MADISON 30 29
TEXT SCREEN TIME OF THE PROPERTY OF THE PROPER	CONTRACT NO. 76K22
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* PER LOCATION

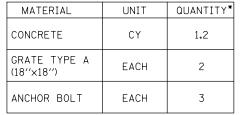



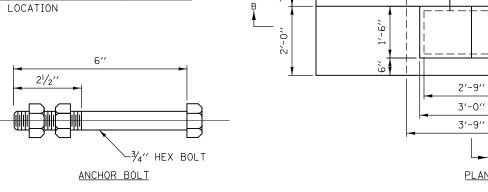

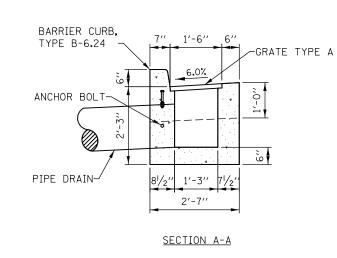
OUTLET SPECIAL NOT TO SCALE

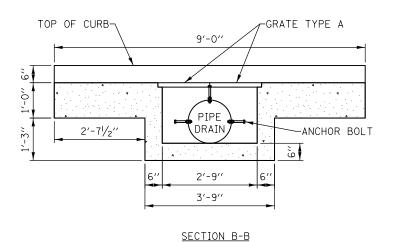∠PIPE DRAIN

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<u>PLAN</u>

-ANCHOR BOLT

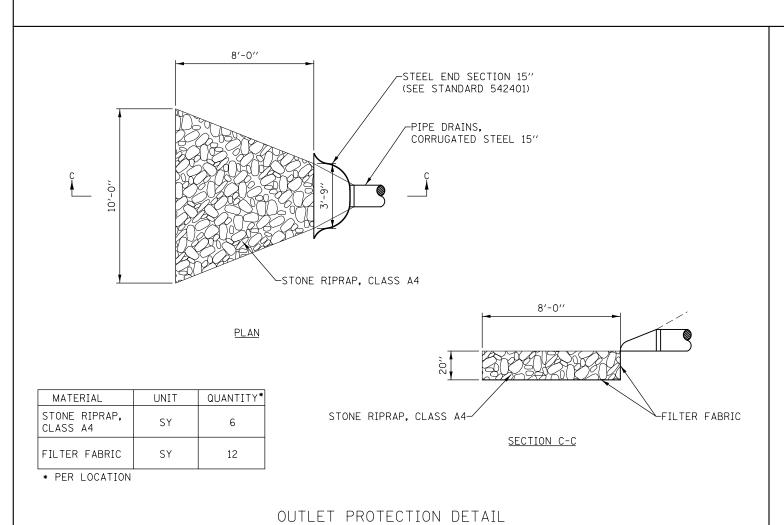

BACK OF CURB-

NOTES: INSTALL PIPE DRAIN BETWEEN EXISTING GUARDRAIL POSTS -1. PROPOSED PIPE DRAIN SHALL BE LOCATED IN SIMILAR LOCATION AS EXISITNG PIPE DRAIN. EXISTING FORESLOPE--OUTLET SPECIAL PIPE DRAINS, CORRUGATED STEEL 15"
(SLOPE TO MATCH FORESLOPE) CAST-IN-PLACE CONCRETE THRUST BLOCK 27"x27"x27" STEEL END SECTION 15" (SEE STANDARD 542401) PIPE DRAIN DETAIL NOT TO SCALE

NOT	TO SCALE

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STATE OF ILLINOIS **DEPARTMENT OF TRANSPORTATION**

DETAILS		SECTION	COUNTY	TOTAL SHEETS	SHEET NO.
		125BDR-2	MADISON	30	30
			CONTRACT	T NO.	76K22
SCALE: N.T.S. SHEET 2 OF 2 SHEETS STA. TO STA.	ILLINOIS FED. AID PROJECT				