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STATE OF ILLINOIS

DEPARTMENT OF TRANSPORTATION

DIVISION OF HIGHWAYS

FOR INDEX OF SHEETS AND HIGHWAY STANDARDS, SEE SHEET NO. 2

PROPOSED HIGHWAY PLANS

FAI ROUTE 94: I-90/94
AT ROOSEVELT ROAD
SECTION: 2020-166-BR
PROJECT: NHPP-2T3W(364)

BRIDGE DECK OVERLAY AND BRIDGE JOINT REPAIRS COOK COUNTY

C-91-382-20

TRAFFIC DATA

THIS PROJECT IS LOCATED IN THE CITY OF CHICAGO

2022 ADT = 22,600 VPD POSTED SPEED LIMIT = 30 MPH PRINCIPAL ARTERIAL

PROJECT LOCATION
ROOSEVELT RD
OVER I-90/94
STRUCTURE NO. 016-0478

0 100' 200' 300' 1"= 100' 0 50' 100' 1"= 50' 0 50' 100' 1"= 40' 0 50' 100' - 1"= 30' - 1"= 20'

FULL SIZE PLANS HAVE BEEN PREPARED USING STANDARD ENGINEERING SCALES. REDUCED SIZED PLANS WILL NOT CONFORM TO STANDARD SCALES. IN MAKING MEASUREMENTS ON REDUCED PLANS, THE ABOVE SCALES MAY BE USED.

J.U.L.I.E. JOINT UTILITY LOCATION INFORMATION FOR EXCAVATION 1–800–892–0123 OR 811

MEADE ELECTRIC CO. DISTRICT ONE ELECTRICAL MAINTENANCE CONTRACTOR LOCATES IDOT ELECTRICAL EQUIPMENT AND UNDERGROUND CABLES 773–287–7672

PROJECT ENGINEER: DAN WILGREEN (847) 705–4240
PROJECT MANAGER: FAWAD AQUEEL

CONTRACT NO. 62M52

W Faiton St.

W Adams St.

W Adams St.

W Adams St.

W Waskington Blvd.

W Waskington

CHICAGO CITY

GROSS LENGTH = 1185 FT. = 0.22 MILES

NET LENGTH = 1185 FT. = 0.22 MILES

INFRASTRUCTURE
ENGINEERING | INCORPORATED

1 South Wacker | Suite 2650 | Chicago, IL 60606

CONTACT: ALEXANDER LANE (312) 477-0620

* 39 + 5 = 44 TOTAL SHEETS

D-91-583-20



STATE OF ILLINOIS
DEPARTMENT OF TRANSPORTATION

SUBMITTED OCTOBER 13 20 23

BOL PROP CAS

December 8, 29

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December 8, 2023

DIRECTOR OF HIGHWAYS PROJECT IMPLEMENTATION

PRINTED BY THE AUTHORITY OF THE STATE OF ILLINOIS

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STATE STANDARDS

STANDARD NO.	DRAWING NAME
000001-08	STANDARD SYMBOLS, ABBREVIATIONS AND PATTERNS
000001-08	STANDARD STMBOLS, ADDREVIATIONS AND PATTERNS
701101-05	OFF-RD OPERATIONS, MULTILANE, 15' (4.5 m) TO 24" (600 mm) FROM PAVEMENT EDGE
701400-11	APPROACH TO LANE CLOSURE, FREEWAY/EXPRESSWAY
701401-13	LANE CLOSURE, FREEWAY/EXPRESSWAY
701411-09	LANE CLOSURE, MULTILANE, AT ENTRANCE OR EXIT RAMP, FOR SPEEDS ≥ 45 MPH
701426-09	LANE CLOSURE, MULTILANE, INTERMITTENT OR MOVING OPER., FOR SPEEDS ≥ 45 MPH
701427-05	LANE CLOSURE, MULTILANE, INTERMITTENT OR MOVING OPER., FOR SPEEDS 40 MPH
701428-01	TRAFFIC CONTROL SETUP AND REMOVAL FREEWAY/EXPRESSWAY
701446-11	TWO LANE CLOSURE, FREEWAY/EXPRESSWAY
701601-09	URBAN LANE CLOSURE, MULTILANE, 1W OR 2W WITH NONTRAVERSABLE MEDIAN
701602-10	URBAN LANE CLOSURE, MULTILANE, 2W WITH BIDIRECTIONAL LEFT TURN LANE
701606-10	URBAN SINGLE ROAD CLOSURE, MULTILANE, 2W WITH MOUNTABLE MEDIAN
701701-10	URBAN LANE CLOSURE, MULTILANE INTERSECTION
701801-06	SIDEWALK, CORNER OR CROSSWALK CLOSURE
701901-09	TRAFFIC CONTROL DEVICES
704001-08	TEMPORARY CONCRETE BARRIER

HMA TABLE

		Y				
HOT-MIX ASPHALT MIXTURE REQUIRMENTS		CHANTY MANAGEMENT				
MIXTURE TYPE	AIR VOIDS @ Ndes	QUALITY MANAGEMENT PROGRAM (QMP)				
BUTT JOINT						
HOT-MIX ASPHALT SURFACE COURSE, MIX "D", IL-9.5, N70, 1-1/2" & VARIES 4% @ 70 Gyr QC/QA						
QMP DESIGNATION: QUALITY CONTROL/ QUALITY ASSURANCE (QC/QA): QUALITY CONTROL FO	OR PERFORMANCE (QCP): PAY FOR PERFORMANCE (PFP)				
MIXTURE REQUIREMENT NOTES:						
1. THE UNIT WEIGHT USED TO CALCULATE ALL HMA SURFACE MIXTURE QUANTITIES IS 112 LBS/SQ YD/IN.						
2. THE "AC TYPE" FOR POLYMERIZED HMA MIXES SHALL BE "SBS/SBR PG 76-22" AND FOR NON-POLYMERIZED HMA THE "AC TYPE" SHALL BE "PG 64-22" UNLESS MODIFIED BY RECLAIMED MATERIALS SPECIFICATIONS.						

GENERAL NOTES

- THE EXACT LOCATION OF ALL UTILITIES SHALL BE FIELD VERIFIED BY THE CONTRACTOR BEFORE ORDERING ANY MATERIALS AND STARTING ANY WORK. FOR LOCATIONS OF UTILITIES, LOCALLY OWNED EQUIPMENT, LEASED ENFORCEMENT CAMERA SYSTEM FACILITIES AND IDOT UNDERGROUND FACILITIES, CONTACT THE LOCAL COUNTIES, MUNICIPALITIES AND IDOT FOR LOCATES.
- 2. MEADE ELECTRIC COMPANY, THE IDOT DISTRICT ONE ELECTRICAL MAINTENANCE CONTRACTOR, LOCATES IDOT ELECTRICAL EQUIPMENT AND UNDERGROUND CABLES. CALL 773-287-7672 FOR THE INITIAL LOCATE. REQUEST FOR LOCATES OF PREVIOUSLY MARKED FACILITIES MAY BE AT THE CONTRACTOR'S EXPENSE.
- 3. IN ADDITION TO FIELD REVIEW AND AERIAL DATA, PLAN DIMENSIONS AND DETAILS RELATIVE TO THE EXISTING FACILITIES HAVE BEEN TAKEN FROM EXISTING PLANS AND ARE SUBJECT TO CONSTRUCTION VARIATIONS. PLAN DIMENSIONS AND DETAILS RELATIVE TO EXISTING PLANS ARE SUBJECT TO ROUTINE VARIATIONS. IT SHALL BE THE CONTRACTOR'S RESPONSIBILITY TO VERIFY EXISTING DIMENSIONS AND DETAILS AFFECTING NEW CONSTRUCTION AND MAKE NECESSARY APPROVED ADJUSTMENTS PRIOR TO CONSTRUCTION OR ORDERING MATERIALS. SUCH VARIATIONS SHALL NOT BE CAUSE FOR ADDITIONAL COMPENSATION FOR A CHANGE IN THE SCOPE OF WORK. HOWEVER, THE CONTRACTOR WILL BE PAID FOR THE QUANTITY ACTUALLY FURNISHED AT THE BID PRICE FOR THE WORK.
- 4. THE CONTRACTOR WILL NOT BE ALLOWED TO SET UP A YARD OR FIELD OFFICE ON STATE PROPERTY WITHOUT WRITTEN PERMISSION FROM THE DEPARTMENT.
- 5. IT SHALL BE THE CONTRACTOR'S RESPONSIBILITY TO VERIFY ALL DIMENSIONS AND CONDITIONS EXISTING IN THE FIELD PRIOR TO BEGINNING CONSTRUCTION AND ORDERING MATERIALS.
- 6. THE CONTRACTOR SHALL TAKE ALL NECESSARY PRECAUTIONS FOR THE PROTECTION OF EXISTING PLANT MATERIAL FOR WHICH THE CONTRACT DOES NOT PROVIDE REMOVAL. THE PROTECTION OF EXISTING PLANT MATERIAL AND THE REPAIR OR REPLACEMENT OF EXISTING PLANT MATERIAL DAMAGED BY THE CONTRACTOR SHALL BE DONE IN ACCORDANCE WITH THE REQUIREMENTS OF SECTION 201 OF THE STANDARD SPECIFICATIONS.
- 7. THE DEPARTMENT HAS NOT OBTAINED ANY PERMITS FOR OFFSITE BORROW, WASTE, USE (BWU) AREAS. PRIOR TO WORKING IN BWU AREAS, IF THE CONTRACTOR CHOOSES TO USE ACTIVITIES REQUIRING PERMITS IT IS THE CONTRACTOR'S RESPONSIBILITY TO SECURE THE PROPER PERMITS. IN ADDITION TO THE BORROW REVIEW (BDE 2289) AND USE/WASTE REVIEW (BDE 2290) SUBMITTALS, THE CONTRACTOR SHALL SUBMIT AN EROSION AND SEDIMENT CONTROL (ESC) PLAN FOR EVERY BWU SITE TO THE DEPARTMENT FOR ACCEPTANCE. GUIDELINES FOR ACCEPTABLE BWU PRACTICES CAN BE FOUND IN SECTION 11.G.1. THE COST OF ALL MATERIALS AND LABOR NECESSARY TO COMPLY WITH THE ABOVE PROVISIONS TO PREPARE AND IMPLEMENT ESC PLANS WILL NOT BE PAID FOR SEPARATELY, BUT SHALL BE CONSIDERED AS INCLUDED IN THE CONTRACT UNIT PRICES AND NO ADDITIONAL COMPENSATION WILL BE ALLOWED.
- 8. THE CONTRACTOR SHALL CONTACT KALPANA KANNAN-HOSADURGA THE DISTRICT ONE TRAFFIC CONTROL SUPERVISOR AT KALPANA.KANNAN-HOSADURGA@ILLINOIS.GOV A MINIMUM OF 72 HOURS IN ADVANCE OF BEGINNING WORK.
- 9. THE CONTRACTOR SHALL CONTACT CARLOS MUNOZ DISTRICT ONE EXPRESSWAYS TRAFFIC CONTROL SUPERVISOR AT CARLOS.MUNOZ@ILLINOIS.GOV A MINIMUM OF 72 HOURS IN ADVANCE OF BEGINNING WORK
- 10. THE RESIDENT ENGINEER SHALL CONTACT PATRICE HARRIS, AREA TRAFFIC FIELD TECHNICIAN, AT PATRICE.HARRIS@ILLINOIS.GOV A MINIMUM OF TWO (2) WEEKS PRIOR TO THE PLACEMENT OF PERMANENT PAVEMENT MARKINGS.
- 11. THE DEPARTMENT HAS DETERMINED THAT IN STREAM WORK IS NOT REQUIRED FOR THE WORK SPECIFIED IN THIS CONTRACT. THE DEPARTMENT HAS NOT OBTAINED A 404 PERMIT. IF THE CONTRACTOR CHOSES TO USE ACTIVITIES REQUIRING AN USACE 404 PERMIT IT IS THE CONTRACTOR'S RESPONSIBILITY TO SECURE THE PROPER USACE PERMITS.
- 12. THESE PLANS HAVE BEEN PREPARED FROM NOTES RECEIVED FROM I.D.O.T. FIELD MAINTENANCE ENGINEERS.
- 13. THE CONTRACTOR SHALL USE CARE IN REMOVING OR EXCAVATING NEAR ALL EXISTING ITEMS WHICH WILL REMAIN. ANY DAMAGE DONE TO EXISTING ITEMS BY THE CONTRACTOR SHALL BE REPAIRED AT THE CONTRACTOR'S EXPENSE.
- 14. SAW CUTTING PRIOR TO ANY REMOVAL ITEMS NOTED ON THE PLANS OR DIRECTED BY THE ENGINEER SHALL BE CONSIDERED INCLUDED IN THE COST OF THE ITEMS BEING REMOVED.
- 15. FOR WORK OUTSIDE THE LIMITS OF BRIDGE APPROACH PAVEMENT. ALL REFERENCES IN THE HIGHWAY STANDARDS AND STANDARD SPECIFICATIONS FOR REINFORCEMENT, DOWEL BARS AND TIE BARS IN PAVEMENT SHALL BE EPOXY COATED UNLESS NOTED ON THE PLANS.
- 16. DOUBLE LANE MARKERS ARE TO BE USED AS SHOWN ON THE DISTRICT ONE DETAIL "TYPICAL APPLICATIONS-RAISED REFLECTIVE PAVEMENT MARKERS (SNOW-PLOW RESISTENT)" SHOWN IN PLANS.
- 17. THE CENTERLINE IS FOR INFORMATION ONLY

SCALE:

1	USER NAME = ALane	DESIGNED DBE	REVISED =
INFRASTRUCTURE ENGINEERING INCORPORATED 1 South Wacker Suite 2650 Chicago, IL 60606		DRAWN - DBE	REVISED _
		CHECKED - ACL	REVISED -
	PLOT DATE = 11/15/2023	DATE = 10/06/2023	REVISED -

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	HOUSEVEE	ו ווטאט						CONTRACT	NO. 62	2M52
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				CONSTRUCTION CO			
			URBAN	0059		<u> </u>	
PAY ITEM NUMBER	DESIGNATION	UNIT	TOTAL QUANTITY	90% FEDERAL 10% STATE	100% STATE		
20200100	EARTH EXCAVATION	CU YD	2.6	2.6			
28000510	INLET FILTERS	EACH	3	3			
35101400	AGGREGATE BASE COURSE, TYPE B	TON	2	2			
40600290	BITUMINOUS MATERIALS (TACK COAT)	POUND	158	158			
40600982	HOT-MIX ASPHALT SURFACE REMOVAL - BUTT JOINT	SQ YD	352	352			
40604062	HOT-MIX ASPHALT SURFACE COURSE, IL-9.5, MIX "D", N70	TON	37	37			
42400200	PORTLAND CEMENT CONCRETE SIDEWALK 5 INCH	SQ FT	207.5	207.5			
44000600	SIDEWALK REMOVAL	SQ FT	208	208			
50102400	CONCRETE REMOVAL	CU YD	36.5	36.5			
50157300	PROTECTIVE SHIELD	SQ YD	1,844	1,844			
50300255	CONCRETE SUPERSTRUCTURE	CU YD	36.4	36.4			
50300260	RRIDGE DECK GROOVING	SQ YD	1,715	1,715			
50300300	PROTECTIVE COAT	SQ YD	1,823	1,823			
50800205	REINFORCEMENT BARS, EPOXY COATED	POUND	3,720	3,720			
50800515	BAR SPLICERS	EACH	48	48			
52000110	PREFORMED JOINT STRIP SEAL	FOOT	172	172			
60300105	FRAMES AND GRATES TO BE ADJUSTED	EACH	8	8			
67100100	MOBILIZATION	L SUM	1	1			
66900200	NON-SPECIAL WASTE DISPOSAL	CU YD	5	5			
66900530	SOIL DISPOSAL ANALYSIS	EACH	1	1			
66901001	REGULATED SUBSTANCES PRE-CONSTRUCTION PLAN	L SUM	1	1			
66901003	REGULATED SUBSTANCES FINAL CONSTRUCTION REPORT	L SUM	1	1			
66901006	REGULATED SUBSTANCES MONITORING	CAL DA	1	1			

* =	SPECIALTY	ITEM
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				CONSTRUCTION COD		
			URBAN	0059		
PAY ITEM NUMBER	DESIGNATION	UNIT	TOTAL QUANTITY	90% FEDERAL 10% STATE	100% STATE	
70107025	CHANGEABLE MESSAGE SIGN	CAL DA	180	180		
70307100	TEMPORARY PAVEMENT MARKING LETTERS AND SYMBOLS - TYPE IV TAPE	SQ FT	206	206		
70307120	TEMPORARY PAVEMENT MARKING - LINE 4" - TYPE IV TAPE	FOOT	3,629	3,629		
70307210	TEMPORARY PAVEMENT MARKING - LINE 24"- TYPE IV TAPE	FOOT	151	151		
70400100	TEMPORARY CONCRETE BARRIER	FOOT	512.5	512.5		
70400200	RELOCATE TEMPORARY CONCRETE BARRIER	FOOT	512.5	512.5		
70600255	IMPACT ATTENUATORS, TEMPORARY (FULLY REDIRECTIVE, NARROW), TEST LEVEL 2	EACH	4	4		
70600322	IMPACT ATTENUATORS, RELOCATE (FULLY REDIRECTIVE, NARROW), TEST LEVEL 2	EACH	4	4		
78000200	THERMOPLASTIC PAVEMENT MARKING - LINE 4"	FOOT	3,204	3,204		
78000400	THERMOPLASTIC PAVEMENT MARKING - LINE 6"	FOOT	58	58		
78000650 78004635	THERMOPLASTIC PAVEMENT MARKING - LINE 24" PREFORMED PLASTIC PAVEMENT MARKING, TYPE D - LINE 7"	FOOT	100	100		
78009000	MODIFIED URETHANE PAVEMENT MARKING - LETTERS AND SYMBOLS	SQ FT	103	103		
78009004	MODIFIED URETHANE PAVEMENT MARKING - LINE 4"	FOOT	706	706		
78009006	MODIFIED URETHANE PAVEMENT MARKING - LINE 6"	FOOT	269	269		
78009024	MODIFIED URETHANE PAVEMENT MARKING - LINE 24"	FOOT	84	84		
78011040	grooving for recessed pavement marking 8"	FOOT	191	191		
78300202	PAVEMENT MARKING REMOVAL - WATER BLASTING	SQ FT	1,934	1,934		
78200011 X0327032	BARRIER WALL REFLECTORS, TYPE C TEMPORARY VIDEO DETECTION	FOOT	41 6	4 1 6		
XUSEFUSE	The same of the sa					
X4240800	DETECTABLE WARNINGS (SPECIAL)	SQ FT	24	24		
X4400503	COMBINATION CURB AND GUTTER REMOVAL AND REPLACEMENT GREATER THAN 10 FEET	FOOT	129	129		
X5537800	STORM SEWERS TO BE CLEANED 12"	FOOT	100		100	
X6700407	ENGINEER'S FIELD OFFICE, TYPE A (D1)	CAL MO	12	12		
X7010216	TRAFFIC CONTROL AND PROTECTION, (SPECIAL)	L SUM	1	1		
X7011015	TRAFFIC CONTROL AND PROTECTION (EXPRESSWAYS)	L SUM	1	1		

I		USER NAME = alane	DESIGNED VW	REVISED =
	INFRASTRUCTURE ENGINEERING INCORPORATED		DRAWN - VW	REVISED _
	1 South Wacker Suite 2650 Chicago, IL 60606		CHECKED ACL	REVISED -
	P 312.425.9560 F 312.425.9564 www.infrastructure-eng.com		DATE 10/06/2023	REVISED

STATE OF ILLINOIS
DEPARTMENT OF TRANSPORTATION

SUMMARY OF QUANTITIES
ROOSEVELT ROAD OVER 1-90/94 BRIDGE
SHEET OF SHEETS STA. TO STA.

			HDDAN	CONSTRUC	CTION CO)DE
			URBAN	0059		
PAY ITEM NUMBER	DESIGNATION	UNIT	QUANTITY	90% FEDERAL 10% STATE	100% STATE	ļ
Z0001700	APPROACH SLAB REPAIR (FULL DEPTH)	SQ YD	1	1		
Z0006014	BRIDGE DECK LATEX CONCRETE OVERLAY, 2 1/2 INCHES	SQ YD	1,733	1,733		
Z0012130	BRIDGE DECK SCARIFICATION 3/4"	SQ YD	1,733	1,733		
Z0012754	STRUCTURAL REPAIR OF CONCRETE (DEPTH EQUAL TO OR LESS THAN 5 INCHES)	SQ FT	254	254		
Z0012755	STRUCTURAL REPAIR OF CONCRETE (DEPTH GREATER THAN 5 INCHES)	SQ FT	20	20		
Z0016002	DECK SLAB REPAIR (FULL DEPTH, TYPE II)	SQ YD	1	1		
Z0018500	DRAINAGE STRUCTURES TO BE CLEANED	EACH	6		6	
Z0029603	HANDRAIL REPAIRS	L SUM	1	1		
Z0030850	TEMPORARY INFORMATION SIGNING	SQ FT	52	52		
Z0073200	TEMPORARY SHORING AND CRIBBING	EACH	1	1		
Z0073510	TEMPORARY TRAFFIC SIGNAL TIMING	EACH	6	6		

* = SPECIALTY ITEM

COUNTY SHEET NO.

COOK 39 4

CONTRACT NO. DESIGNED - VW REVISED SECTION SUMMARY OF QUANTITIES STATE OF ILLINOIS DEPARTMENT OF TRANSPORTATION DRAWN - VW REVISED 2020-166-BR ROOSEVELT ROAD OVER I-90/94 BRIDGE REVISED CHECKED -ACL CONTRACT NO. 62M52 10/06/2023 SHEET OF SHEETS STA.

MAINTENANCE OF TRAFFIC GENERAL NOTES

- 1. ALL MAINTENANCE OF TRAFFIC (MOT) LANE CLOSURES CAN BE COMPLETED WITH IDOT HIGHWAY STANDARDS (ROOSEVELT ROAD) AND ILLINOIS TOLLWAY STANDARD DRAWINGS (I-90/94). THE MOT PLANS SHALL SERVE AS A GUIDE FOR SAFE DIVERSION OF TRAFFIC DURING EXECUTION OF THIS CONTRACT. HOWEVER, THE CONTRACTOR MAYCONTRACT'S MAINTENANCE OF TRAFFIC, ALONG WITH ANY OTHER MARKERS THAT WERE MISSING REFLECTORS PRIOR TO REOPENING THE LANES TO
- 2. THE CONTRACTOR SHALL CONTACT THE IDOT DISTRICT 1 ARTERIAL TRAFFIC CONTROL SUPERVISOR AT KALPANA.KANNAN-HOSADURGA@ILLINOIS.GOV A MINIMUM OF 72 HOURS IN ADVANCE OF BEGINNING WORK.
- THE CONTRACTOR SHALL CONTACT CARLOS MUNOZ DISTRICT ONE EXPRESSWAYS TRAFFIC CONTROL SUPERVISOR AT CARLOS.MUNOZ@ILLINOIS.GOV A MINIMUM OF 72 HOURS IN ADVANCE OF BEGINNING WORK
- THE ROOSEVELT ROAD WORK ZONE SPEED LIMIT SHALL BE 30 MPH.
- EXISTING REFLECTORS IN RAISED REFLECTIVE PAVEMENT MARKERS THAT CONFLICT WITH STAGED TRAFFIC PATTERNS SHALL BE REMOVED UNDER THIS CONTRACT. THESE SHALL BE REPLACED WITHIN THE LIMITS OF THIS IMPROVE OR MODIFY THE MOT PLANS TO MEET CONSTRUCTION NEEDS BUT NOT AT THE EXPENSE OF PUBLIC SAFETY OR CONVENIENCE. ANY CHANGES TO THE MOT PLANS SHALL BE SUBMITTED TO THE ENGINEER FOR APPROVAL.
- ALL EXISTING PAVEMENT MARKINGS IN CONFLICT WITH THE PAVEMENT MARKING TAPE, TYPE IV (AND/OR MODIFIED URETHANE) USED FOR STAGING SHALL BE REMOVED. THIS WORK SHALL BE PAID FOR AS "PAVEMENT MARKING REMOVAL-GRINDING" WITHIN THE PROJECT LIMITS AND "PAVEMENT MARKING REMOVAL-WATER BLASTING" OUTSIDE THE PROJECT LIMITS
- PAVEMENT MARKING TAPE, TYPE IV (AND/OR TYPE III) SHOWN ON THE PLANS FOR ANY CONSTRUCTION STAGE THAT THE CONTRACTOR PROPOSES TO EXTEND OVER THE WINTER PERIOD SHALL MEAN MODIFIED URETHANE PAVEMENT MARKING AND WILL BE PAID FOR THEIR RESPECTIVE CONTRACT UNIT PRICE.
- THE "ROAD CONSTRUCTION AHEAD" SIGNS SHALL REMAIN INSTALLED UNTIL THE COMPLETION OF THE PROJECT OR WHEN NO ROADWAY HAZARDS REMAIN WITHIN THE WORK ZONE.
- CHANGEABLE MESSAGE SIGNS SHALL BE INSTALLED TWO WEEKS PRIOR TO ALL ROAD CLOSURE, TRAFFIC STAGE CHANGES, AND NEW TRAFFIC SIGNAL TURN-ON EVENTS ON EACH APPROACH OF THE EFFECTED ROADWAY TO WARN MOTORISTS OF THE UPCOMING EVENT. THE SIGNS SHALL BE REMOVED TWO WEEKS THEREAFTER UNLESS THE SIGNS ARE NEEDED AGAIN FOR A SUBSEQUENT FUTURE EVENT THAT WILL OCCUR WITHIN 2 WEEKS ON THE SAME APPROACH OF THE EFFECTED ROADWAY. THE SIGN LOCATIONS SHALL BE (DETERMINED BY THE ENGINEER) PLACED AS DIRECTED BY THE ENGINEER

ROOSEVELT ROAD CONSTRUCTION STAGING

MAINTENANCE OF TRAFFIC - STAGE 1

- 1. COMPLETE BRIDGE DECK AND JOINT REPAIRS AND OVERLAY OF THE INSIDE LANES IN EACH DIRECTION.
- 2. COMPLETE BUTT JOINT ON THE APPROACH PAVEMENT OF THE INSIDE LANES.

MAINTENANCE OF TRAFFIC:

- 1. CLOSE THE INSIDE LANES OF TRAFFIC IN BOTH DIRECTIONS AND MAINTAIN TRAFFIC ON THE OUTSIDE LANES.
- DETOUR RUBLE STREET TO WESTBOUND ROOSEVELT ROAD VIA DETOUR PLAN.
- DETOUR UNION AVENUE TO EASTBOUND ROOSEVELT ROAD VIA DETOUR PLAN.
- BICYCLE TRAFFIC WILL BE MAINTAINED ON THE OUTSIDE LANES. 5. PEDESTRIAN ACCESS WILL REMAIN ON THE SIDEWALKS.
- MAINTENANCE OF TRAFFIC STAGE 2

CONSTRUCTION:

- 1. COMPLETE BRIDGE DECK AND JOINT REPAIRS AND OVERLAY OF THE OUTSIDE LANES IN THE EASTBOUND AND
- 2. COMPLETE BUTT JOINT ON THE APPROACH PAVEMENT OF THE OUTSIDE LANES AND ADJACENT SIDE STREETS.

MAINTENANCE OF TRAFFIC:

- 1. CLOSE THE OUTSIDE LANES OF TRAFFIC IN THE EASTBOUND AND WESTBOUND DIRECTIONS AND MAINTAIN ONE LANE OF TRAFFIC ON THE INSIDE LANES.
- 2. DETOUR RUBLE STREET TO WESTBOUND ROOSEVELT ROAD VIA DETOUR PLAN.
- DETOUR UNION AVENUE TO EASTBOUND ROOSEVELT ROAD VIA DETOUR PLAN.
- BICYCLE TRAFFIC WILL BE SHIFTED TO THE SIDEWALK, BIKES WLL BE WALKED IN THE WORK ZONE 5. PEDESTRIAN ACCESS SHALL BE MAINTAINED ON ONE OF THE SIDEWALKS AT ALL TIMES.

I-90/94 CONSTRUCTION STAGING

MAINTENANCE OF TRAFFIC - STAGE 1

CONSTRUCTION:

COMPLETE WEST ABUTMENT REPAIRS

MAINTENANCE OF TRAFFIC:

1. CLOSE THE OUTSIDE SHOULDER AND OUTSIDE LANE OF EASTBOUND I-90/94 DURING ALLOWABLE LANE CLOSURE HOURS.


MAINTENANCE OF TRAFFIC - STAGE 2

CONSTRUCTION:

- COMPLETE THE WEST FACE OF PIER REPAIRS
- 2. COMPLETE THE EAST FACE OF PIER REPAIRS


- 1. CLOSE THE INSIDE SHOULDER AND INSIDE LANE ON EASTBOUND I-90/94 DURING ALLOWABLE LANE CLOSURE HOURS.
- CLOSE THE INSIDE SHOULDER AND INSIDE LANE ON WESTBOUND I-90/94 DURING ALLOWABLE LANE CLOSURE HOURS.

WORK ZONE SPEED LIMIT:							
	EXISTING POSTED SPEED	PROPOSED POSTED SPEED					
ROOSEVELT STAGE 1	30 MPH	30 MPH					
ROOSEVELT STAGE 2	30 MPH	30 MPH					
I-90/94 STAGE 1	45 MPH	45 MPH					
I-90/94 STAGE 2	45 MPH	45 MPH					

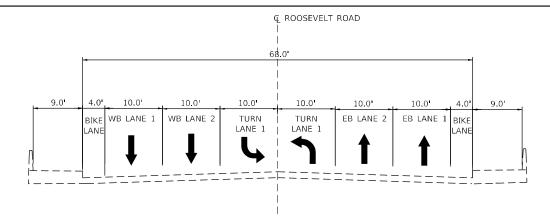


EXISTING TYPICAL CROSS SECTION

ON SN 016-0478

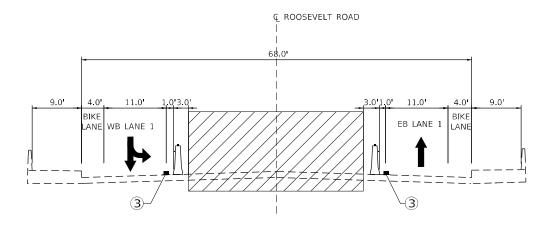

STAGE 1 CONSTRUCTION

ON SN 016-0478

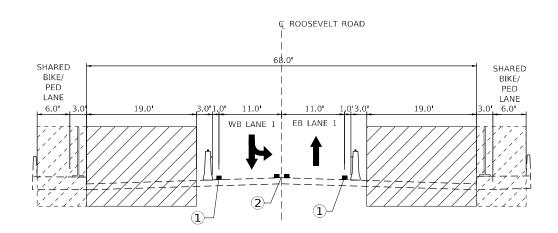

STAGE 2 CONSTRUCTION

SHEET

ON SN 016-0478

SCALE:

MOT TYPICAL LEGEND

TEMPORARY CONCRETE BARRIER WITH TYPE C, BI-DIRECTIONAL CRYSTAL REFLECTORS PER STD 704001 AND 782006.

CONSTRUCTION FENCE

WORK AREA

SIDEWALK WORK AREA - ONE SIDEWALK TO REMAIN OPEN AT ALL TIMES

DIRECTION OF TRAVEL

TEMPORARY PAVEMENT MARKINGS

TEMPORARY PAVEMENT MARKING TAPE, TYPE IV (WHITE)

TEMPORARY PAVEMENT MARKING TAPE, TYPE IV (DOUBLE YELLOW @ 8' C-C)

TEMPORARY PAVEMENT MARKING TAPE.

TYPE IV (SINGLE YELLOW)




STATE OF ILLINOIS **DEPARTMENT OF TRANSPORTATION** TRAFFIC CONTROL PLANS **GENERAL NOTES**

TO STA.

SHEETS STA

SECTION 94 2020-166-BR COOK 39 CONTRACT NO. 62M52

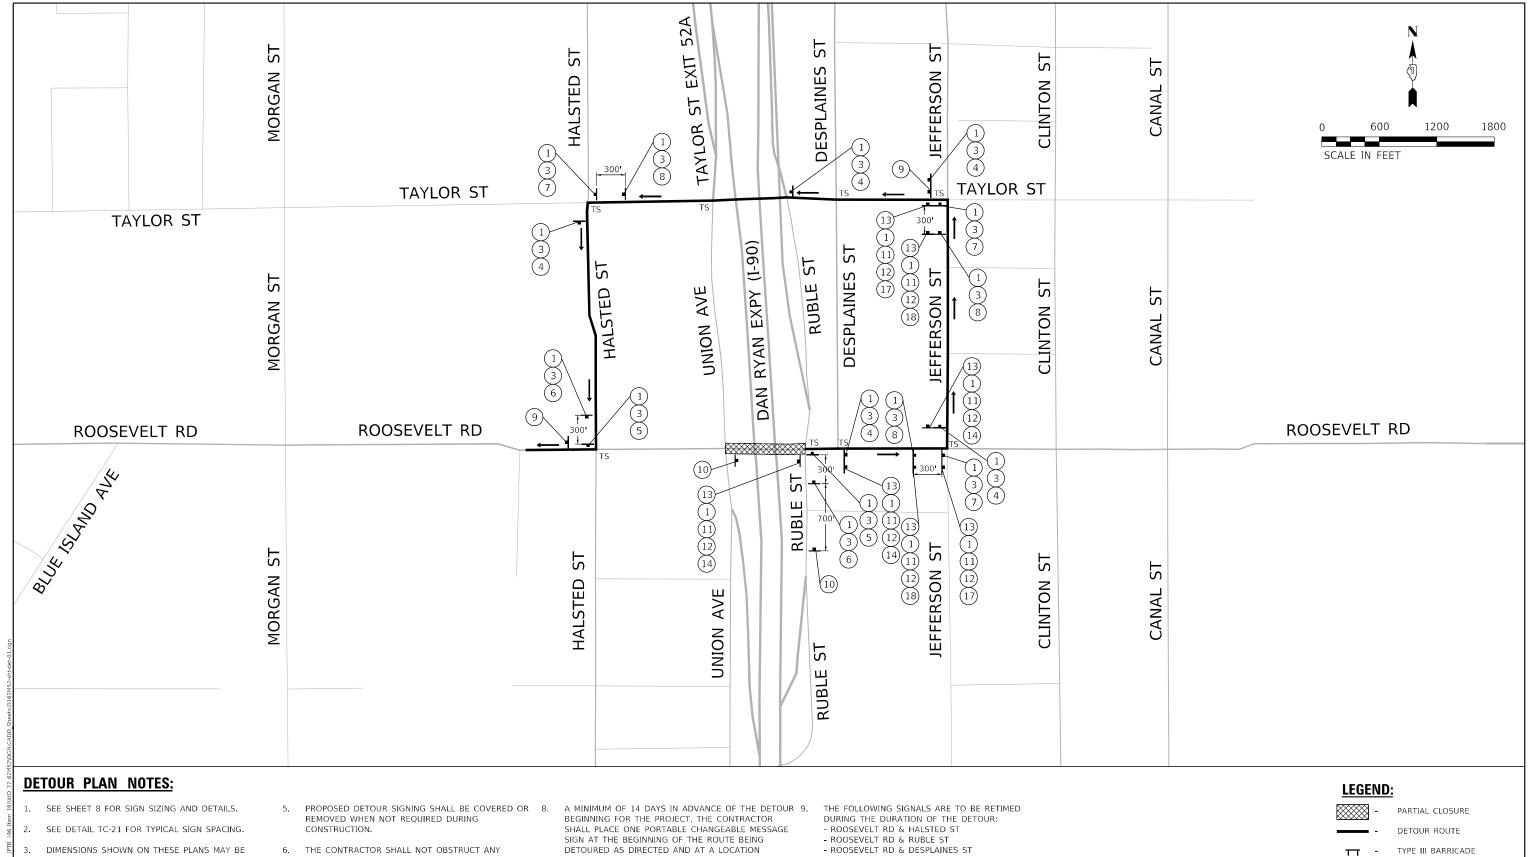


- DIMENSIONS SHOWN ON THESE PLANS MAY BE ADJUSTED TO FIT FIELD CONDITIONS AS DIRECTED BY THE ENGINEER
- ALL EXISTING SIGNING THAT IS NOT APPLICABLE WHILE THE DETOUR IS IN EFFECT SHALL BE
- 6. THE CONTRACTOR SHALL NOT OBSTRUCT ANY EXISTING SIGN WITH THE PLACEMENT OF DETOUR
- DETOUR SIGNAGE SHALL BE CONSIDERED INCLUDED IN THE COST FOR TEMPORARY TRAFFIC CONTROL AND PROTECTION (SPECIAL) EXCEPT AS OTHERWISE NOTED.
- DETOURED AS DIRECTED AND AT A LOCATION DESIGNATED BY THE ENGINEER TO INFORM MOTORISTS OF THE UPCOMING CLOSURE, THE MESSAGE SHALL BE APPROVED BY THE ENGINEER. THIS WORK IS TO BE PAID FOR PER CONTRACT UNIT PRICE FOR CHANGEABLE MESSAGE SIGN.
- ROOSEVELT RD & JEFFERSON ST
- TAYLOR ST & HALSTED ST
- TAYLOR ST & UNION AVE
- TAYLOR ST & DESPLAINES ST
- TAYLOR ST & JEFFERSON ST

TYPE III BARRICADE

DETOUR / CLOSURE SIGNAGE

TRAFFIC SIGNALIZED INTERSECTION

DESIGNED REVISED SECTION **DETOUR PLAN** INFRASTRUCTURE STATE OF ILLINOIS DRAWN VW REVISED 2020-166-BR COOK 39 ENGINEERING LINCORE RUBLE ST TO WB ROOSEVELT ROAD HECKED ACL REVISED **DEPARTMENT OF TRANSPORTATION** 1 South Wacker | Suite 2650 | Chicago, IL 60606 CONTRACT NO. 62M52

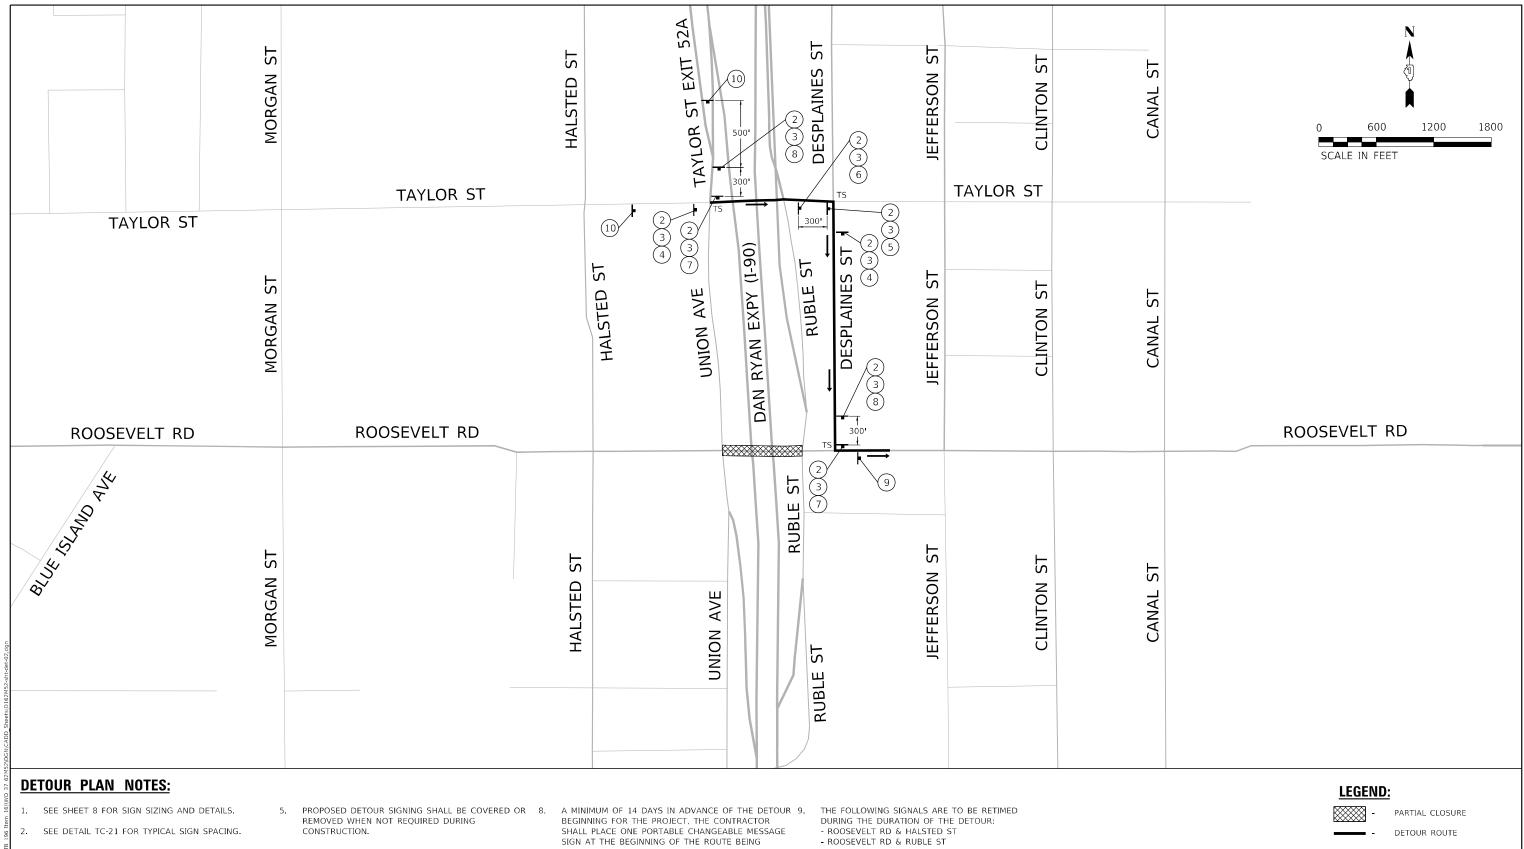

- DIMENSIONS SHOWN ON THESE PLANS MAY BE ADJUSTED TO FIT FIELD CONDITIONS AS DIRECTED BY THE ENGINEER.
- 4. ALL EXISTING SIGNING THAT IS NOT APPLICABLE WHILE THE DETOUR IS IN EFFECT SHALL BE COMPLETELY COVERED.
- 6. THE CONTRACTOR SHALL NOT OBSTRUCT ANY EXISTING SIGN WITH THE PLACEMENT OF DETOUR SIGNAGE.
- DETOUR SIGNAGE SHALL BE CONSIDERED INCLUDED IN THE COST FOR TEMPORARY TRAFFIC CONTROL AND PROTECTION (SPECIAL) EXCEPT AS OTHERWISE NOTED.
- A MINIMUM OF 14 DAYS IN ADVANCE OF THE DETOUR SEGINNING FOR THE PROJECT. THE CONTRACTOR SHALL PLACE ONE PORTABLE CHANGEABLE MESSAGE SIGN AT THE BEGINNING OF THE ROUTE BEING DETOURED AS DIRECTED AND AT A LOCATION DESIGNATED BY THE ENGINEER TO INFORM MOTORISTS OF THE UPCOMING CLOSURE. THE MESSAGE SHALL BE APPROVED BY THE ENGINEER. THIS WORK IS TO BE PAID FOR PER CONTRACT UNIT PRICE FOR CHANGEABLE MESSAGE SIGN.
- ROOSEVELT RD & DESPLAINES ST - ROOSEVELT RD & JEFFERSON ST
- TAYLOR ST & HALSTED ST
- TAYLOR ST & HALSTED ST - TAYLOR ST & UNION AVE
- TAYLOR ST & DESPLAINES ST - TAYLOR ST & JEFFERSON ST

T - TYPE III BARRICADE

- DETOUR / CLOSURE SIGNAGE

- TRAFFIC SIGNALIZED INTERSECTION

efault E: P:\P.	INEDA CTRUCTURE	USER NAME = ALane	DESIGNED - VW	REVISED -		DETOUR PLAN					F.A.I. RTE.	SECTION	COUNTY S	OTAL	SHEE NO.	
2.5	INFRASTRUCTURE		DRAWN - VW	REVISED -	STATE OF ILLINOIS		LINUANI					94	2020-166-BR	COOK	39	7
ODE!	1 South Wacker Suite 2650 Chicago, IL 60606	PLOT SCALE = 100.0000 / in.	CHECKED - ACL	REVISED -	DEPARTMENT OF TRANSPORTATION	UNION AVE TO EB ROOSEVELT ROAD		עו			CONTRACT N	NO. 62	M52			
žĒ	P 312 425 9560 F 312 425 9564 www.infrastructure.eng.com	PLOT DATE = 11/16/2023	DATE - 10/06/2023	REVISED -		SCALE:	SHEET	OF	SHEETS	STA.	TO STA.		ILLINOIS FED.	AID PROJECT		

DETOUR SIGNAGE LEGEND ROOSEVELT ROAD


















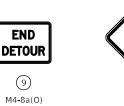



11









4 M4-9(O) 30" x 24"

(5) M4-9R(O) 30" x 24"

6 SPECIAL 30" x 24"

7 M4-9L(O) 30" x 24"

—

7

8 SPECIAL 30" x 24"

24" x 18"





DETOUR


AHEAD

M1-1(O) 36" x 36"

DETOUR

4

24" x 12"

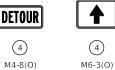


21" x 15"



21" x 15"



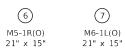






DETOUR SIGNAGE LEGEND ROOSEVELT ROAD

6

3

Roosevelt 4"C W=15.4" X=4.3" BORDER R=1.13" TH=0.63" IN=0.38" 24"

Panel Style: warning_rectangular_IDOT_FO_0.625_0.375.ssi M.U.T.C.D.: 2009 Edition

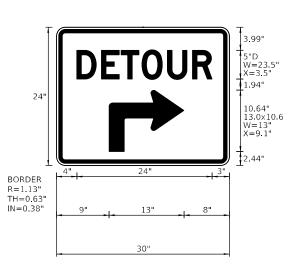

Panel Style: warning_rectangular_IDOT_FO_0.625_0.375.ssi M.U.T.C.D.: 2009 Edition

SCALE:

10.9 10.6 13.0×10. W=13 X=7.9 15.02" 24" BORDER R=1.13" TH=0.63" IN=0.38"

8

Panel Style: warning_rectangular_IDOT_FO_0.625_0.375.ssi M.U.T.C.D.: 2009 Edition


INF ENG 1 South


	USER NAME = ALane	DESIGNED - VW	REVISED -
IFRASTRUCTURE		DRAWN - VW	REVISED -
NGINEERING INCORPORATED outh Wacker Suite 2650 Chicago, IL 60606		CHECKED - ACL	REVISED -
12.425.9560 F 312.425.9564 www.infrastructure-eng.com	PLOT DATE = 11/16/2023	DATE - 10/06/2023	REVISED -

STATE OF ILLINOIS **DEPARTMENT OF TRANSPORTATION**

DETOUR		DETAILS EVELT R		NOTES	
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	F.A.I. RTE	SECT	ION		COUNTY	TOTAL SHEETS	SHEET NO.		
	94	2020-1	66-BR		СООК	39	8		
_				CONTRACT NO. 62M52					
			ILLINOIS	ID PROJECT					



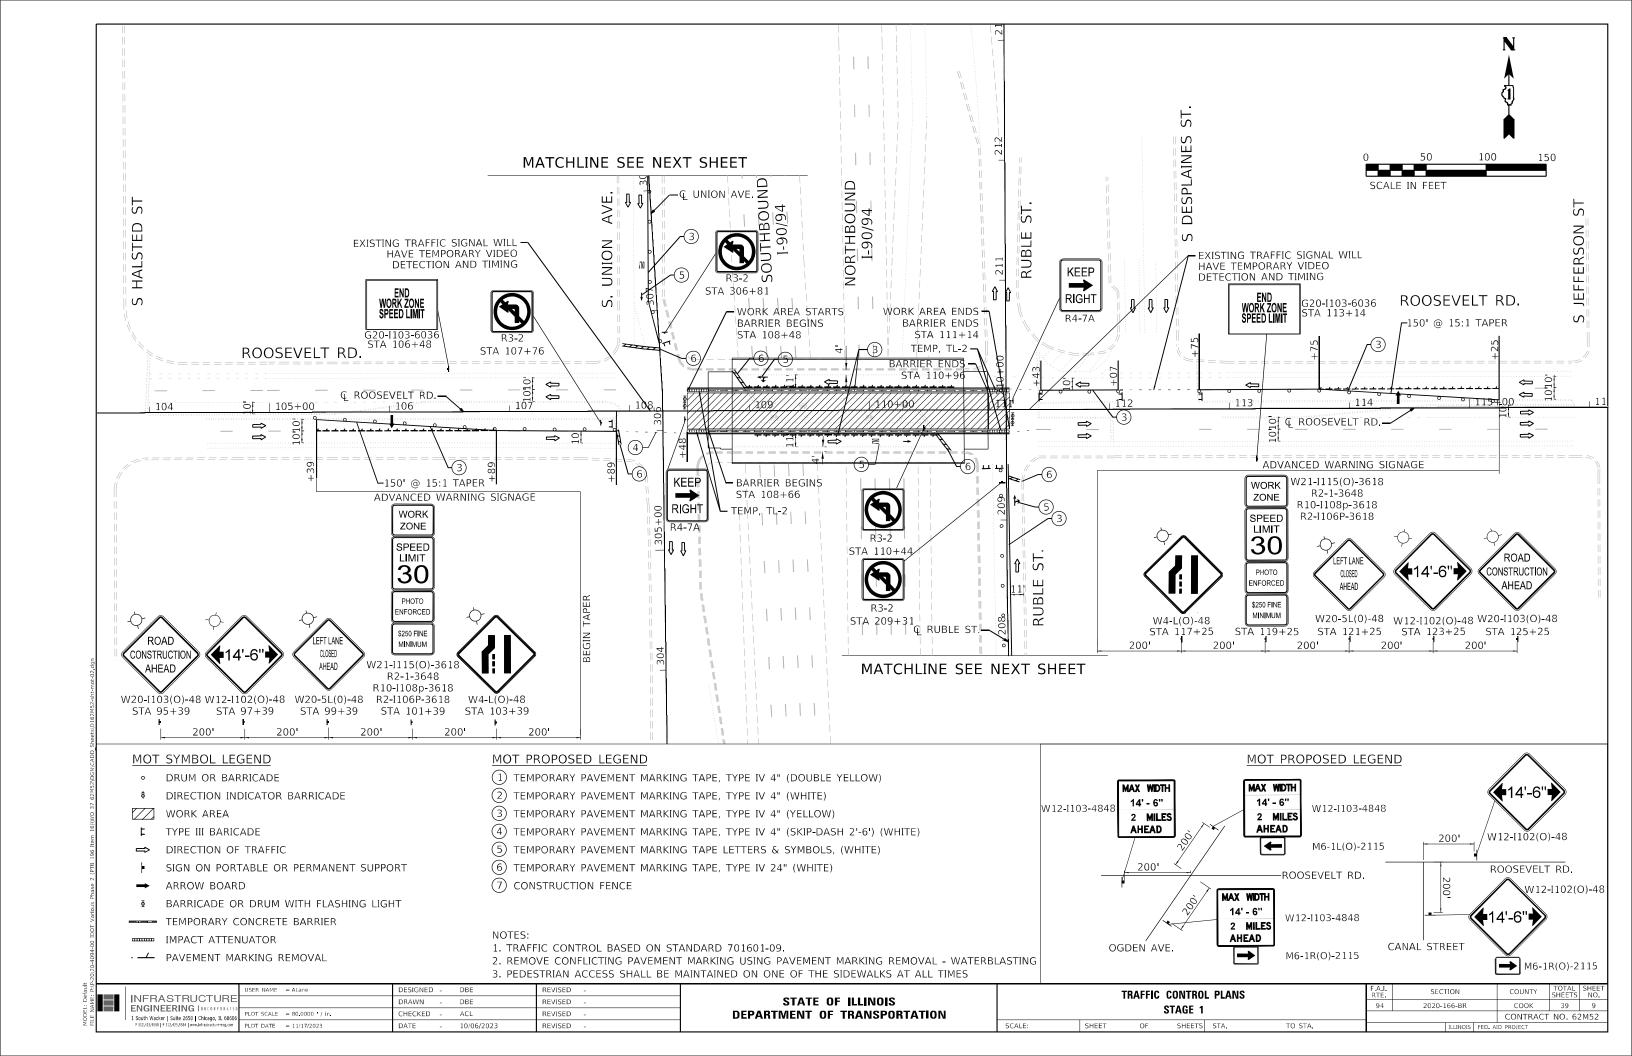

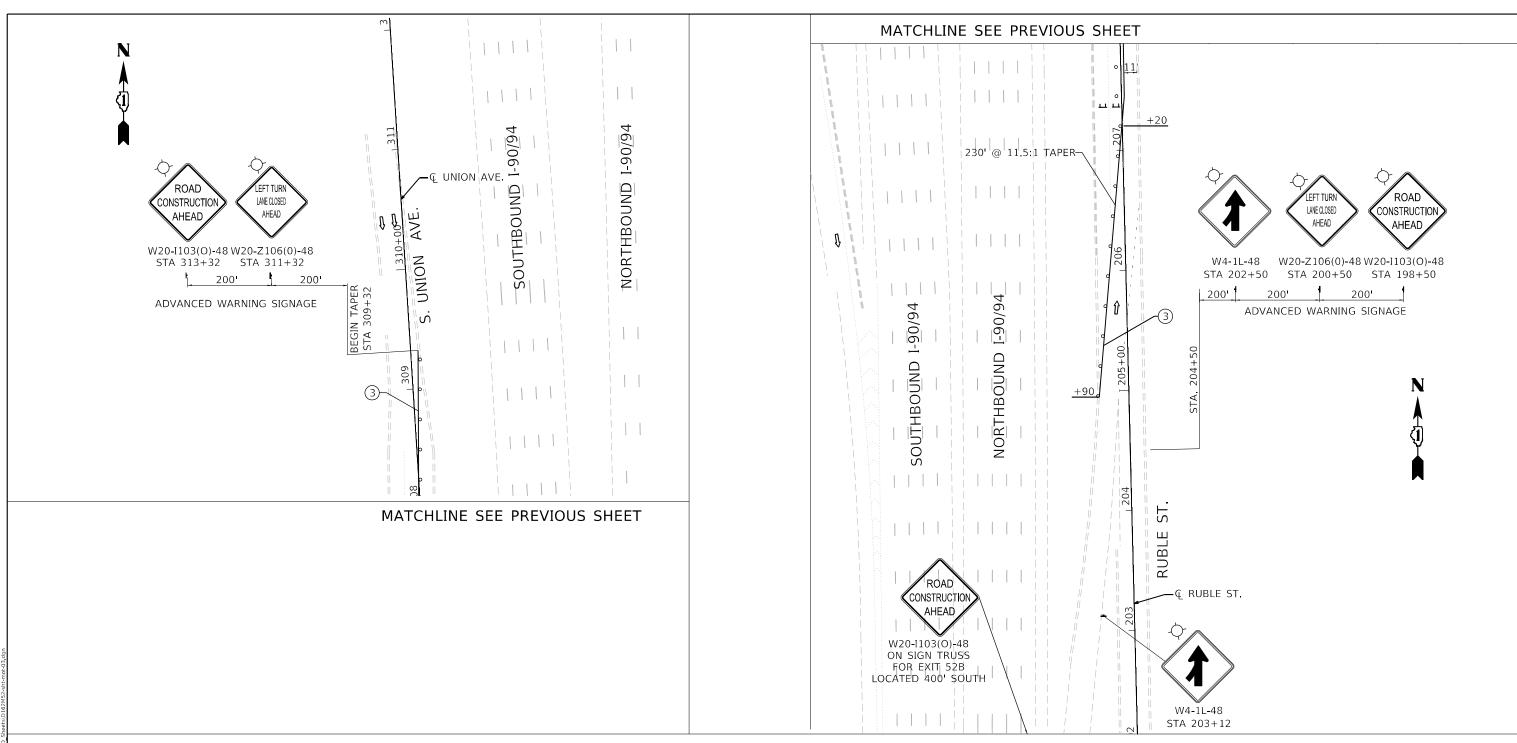MOT SYMBOL LEGEND

- DRUM OR BARRICADE
- DIRECTION INDICATOR BARRICADE
- WORK AREA
- TYPE III BARICADE
- ⇒ DIRECTION OF TRAFFIC
- SIGN ON PORTABLE OR PERMANENT SUPPORT
- → ARROW BOARD
- BARRICADE OR DRUM WITH FLASHING LIGHT
- TEMPORARY CONCRETE BARRIER
- IMPACT ATTENUATOR
- · PAVEMENT MARKING REMOVAL


MOT PROPOSED LEGEND


- 1 TEMPORARY PAVEMENT MARKING TAPE, TYPE IV 4" (DOUBLE YELLOW)
- (2) TEMPORARY PAVEMENT MARKING TAPE, TYPE IV 4" (WHITE)
- 3 TEMPORARY PAVEMENT MARKING TAPE, TYPE IV 4" (YELLOW)
- 4 TEMPORARY PAVEMENT MARKING TAPE, TYPE IV 4" (SKIP-DASH 2'-6') (WHITE)
- (5) TEMPORARY PAVEMENT MARKING TAPE LETTERS & SYMBOLS, (WHITE)
- (6) TEMPORARY PAVEMENT MARKING TAPE, TYPE IV 24" (WHITE)
- (7) CONSTRUCTION FENCE

NOTES:

- 1. TRAFFIC CONTROL BASED ON STANDARD 701601-09.
- 2. REMOVE CONFLICTING PAVEMENT MARKING USING PAVEMENT MARKING REMOVAL WATERBLASTING
- 3. PEDESTRIAN ACCESS SHALL BE MAINTAINED ON ONE OF THE SIDEWALKS AT ALL TIMES

IN IED A OTDI IOTI IDE	USER NAME = ALane	DESIGNED -	DBE	REVISED -		TRAFFIC CONTROL PLANS		F.A.I. BTE	SECTION	COUNTY	TOTAL SHEET				
INFRASTRUCTURE ENGINEERING INCORPORATED		DRAWN -	DBE	REVISED -	STATE OF ILLINOIS							94	2020-166-BR	соок	39 10
1 South Wacker Suite 2650 Chicago, IL 60606	PLOT SCALE = 80.0000 / in.	CHECKED -	ACL	REVISED -	DEPARTMENT OF TRANSPORTATION				STAGE 1					CONTRACT	NO. 62M52
P 312 425 9560 F 312 425 9564 www.infrastructure-eng.com	PLOT DATE = 11/17/2023	DATE - 10/06/2023 REVISED -			SCALE:	SHEET	OF	SHEETS	STA.	TO STA.	ILLINOIS FED. AID PROJECT		PROJECT		

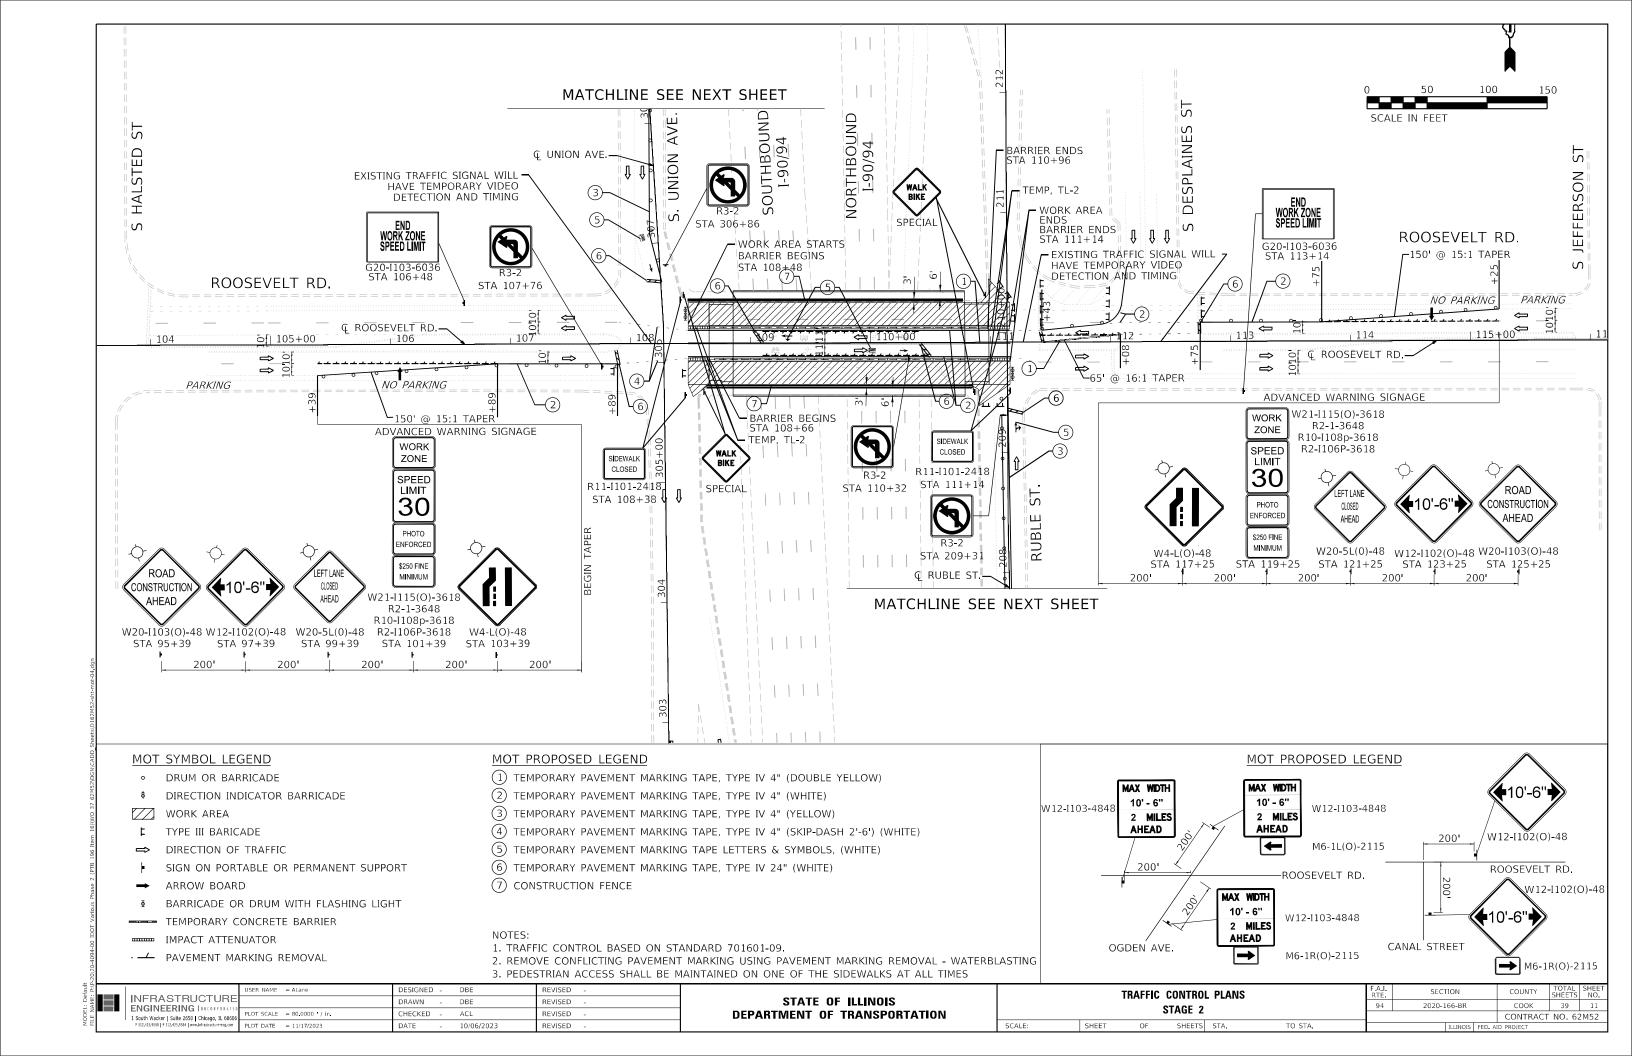

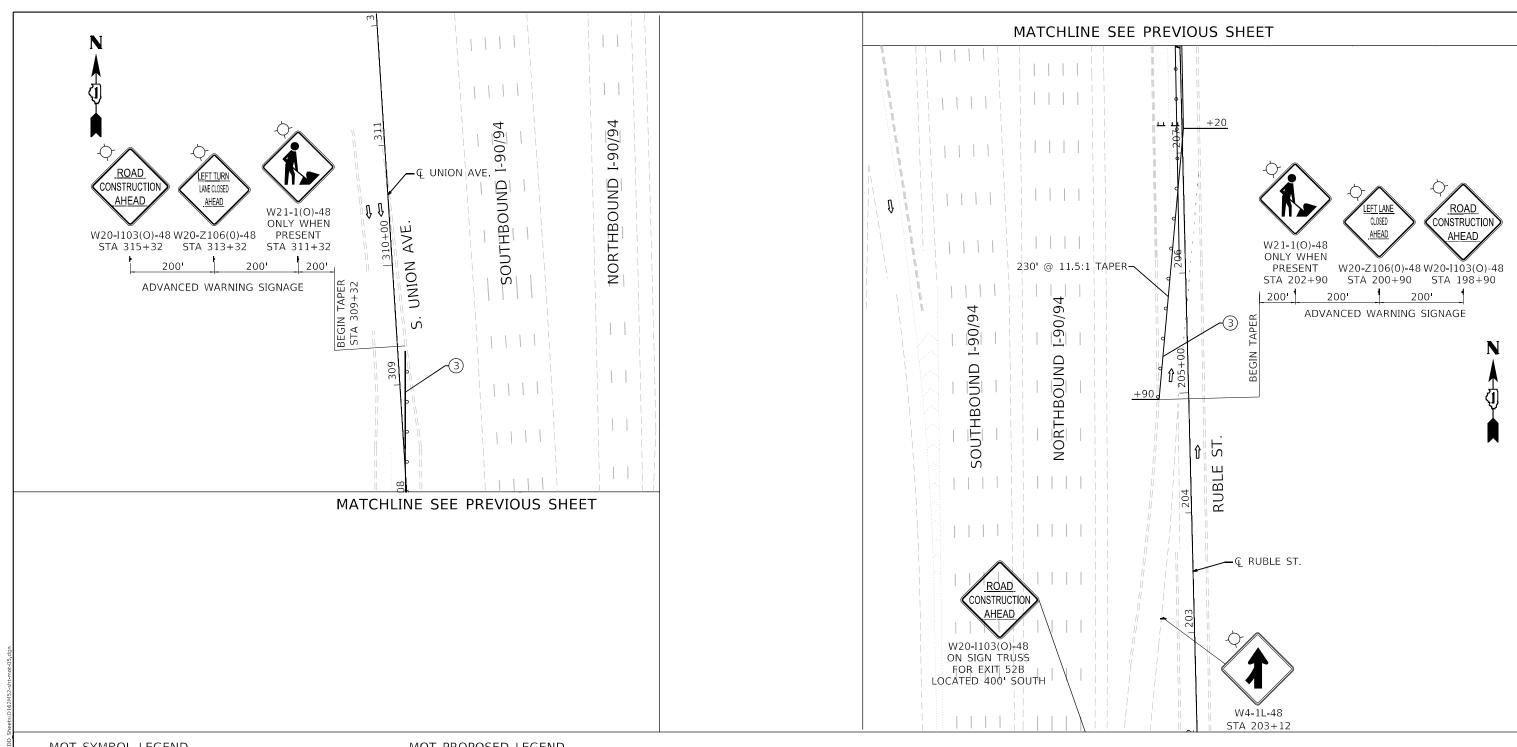

MOT SYMBOL LEGEND

- DRUM OR BARRICADE
- DIRECTION INDICATOR BARRICADE

WORK AREA

- TYPE III BARICADE
- DIRECTION OF TRAFFIC
- SIGN ON PORTABLE OR PERMANENT SUPPORT
- ARROW BOARD
- BARRICADE OR DRUM WITH FLASHING LIGHT
- TEMPORARY CONCRETE BARRIER
- IMPACT ATTENUATOR
- · -- PAVEMENT MARKING REMOVAL


MOT PROPOSED LEGEND

- 1 TEMPORARY PAVEMENT MARKING TAPE, TYPE IV 4" (DOUBLE YELLOW)
- (2) TEMPORARY PAVEMENT MARKING TAPE, TYPE IV 4" (WHITE)
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- 4 TEMPORARY PAVEMENT MARKING TAPE, TYPE IV 4" (SKIP-DASH 2'-6') (WHITE)
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- (6) TEMPORARY PAVEMENT MARKING TAPE, TYPE IV 24" (WHITE)
- (7) CONSTRUCTION FENCE

NOTES:

- 1. TRAFFIC CONTROL BASED ON STANDARD 701601-09.
- 2. REMOVE CONFLICTING PAVEMENT MARKING USING PAVEMENT MARKING REMOVAL WATERBLASTING
- 3. PEDESTRIAN ACCESS SHALL BE MAINTAINED ON ONE OF THE SIDEWALKS AT ALL TIMES

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1 South Wacker Suite 2650 Chicago, IL 60606 PLOT SCAI	CALE = 80.0000 / in.	CHECKED -	ACL	REVISED -	DEPARTMENT OF TRANSPORTATION STAGE 2								CONTRACT	T NO. 62	2M52	
P 312 425 9560 F 312 425 9564 www.lnfrastructure-eng.com PLOT DAT	ATE = 11/17/2023	DATE -	10/06/2023	REVISED -		SCALE: SHEET OF SHEETS STA. TO STA.				ILLINOIS FED	ILLINOIS FED. AID PROJECT					

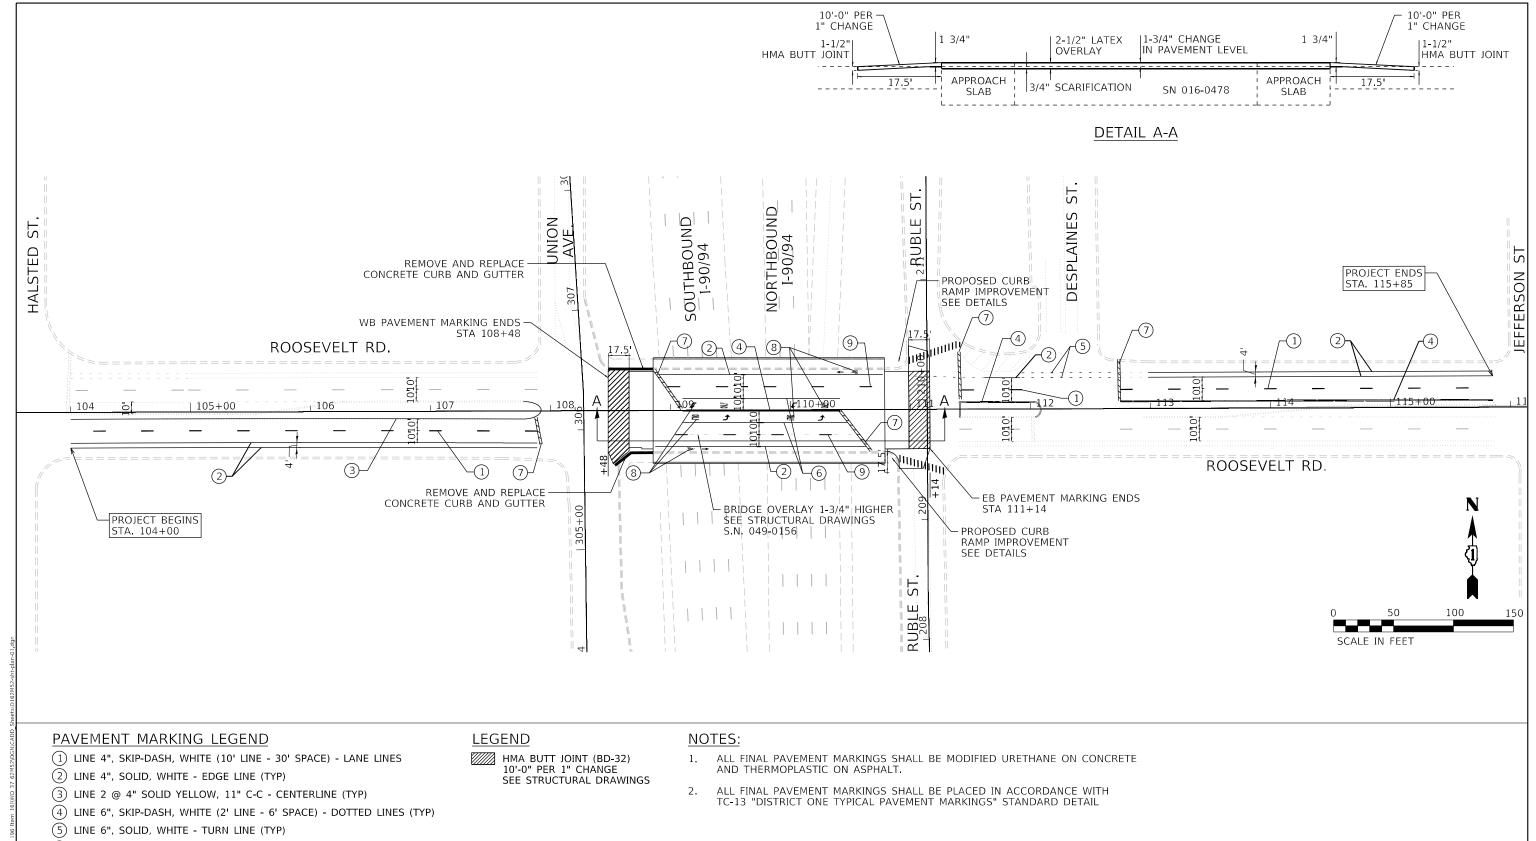


- (6) LINE 8", SOLID, WHITE GORE LINE (TYP)
- (7) LINE 12", SOLID, WHITE PAINTED MEDIANS DIAGONALS (TYP) (SEE DISTRICT DETAIL TC-13 FOR SPACING)
- 8 LINE 24", SOLID, WHITE STOP LINE (TYP)
- (9) LETTERS & SYMBOLS, SOLID, WHITE TURN LANE MARKINGS (TYP)

INFRASTRUCTURE		DRAWN - DBE	REVISED -	
ENGINEERING INCORPORATED 1 South Wacker Suite 2650 Chicago, IL 60606	DIOT COME = 90 0000 1 / in	CHECKED - ACL	REVISED -	l D
P 312 425 9560 F 312 425 9564 www.infrastructure.eng.com		DATE - 10/06/2023	REVISED -	

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SHEET

ROA	DWAY P	LAN		F.A.I. RTE	SECTION		COUNTY	TOTAL SHEETS	SHEET NO.	
ROOSEVELT ROAD					2020-166-BR		соок	39	13	
nou.	SLVLLI N	UAD		CONTRACT NO. 62M5						
OF	SHEETS	STA.	TO STA.	ILLINOIS FED. AID PROJECT						

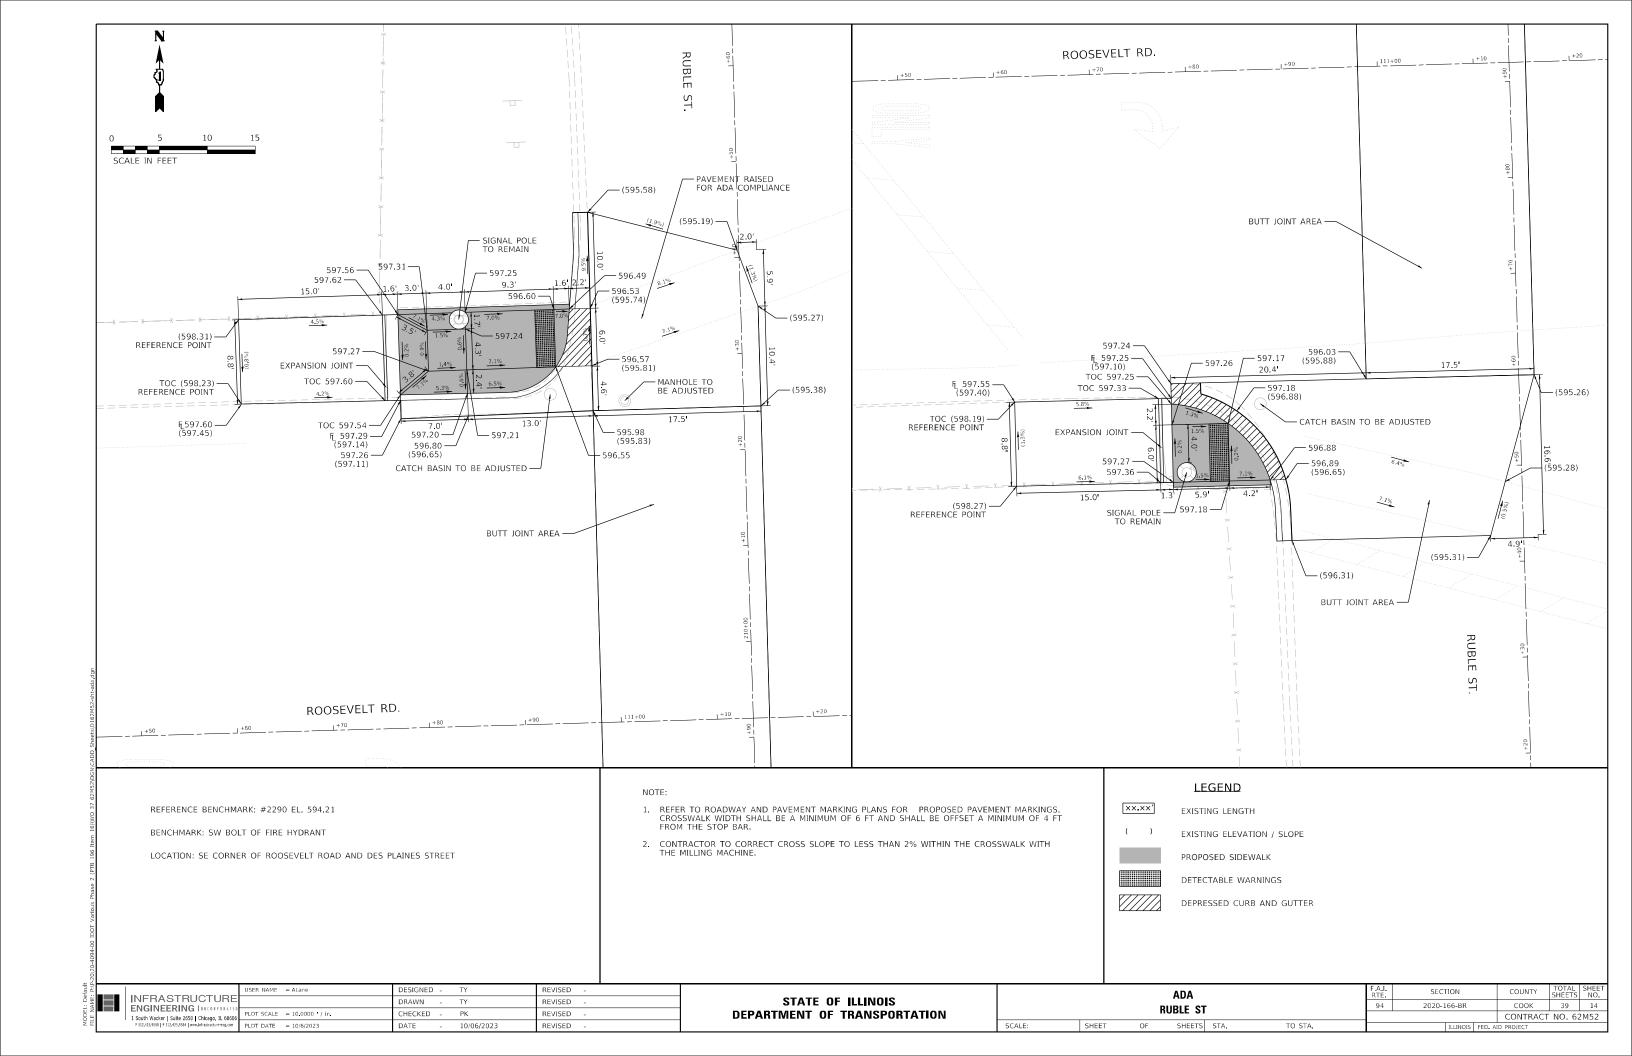

Benchmark: Cut at SW bolt of fire hydrant at SE corner of Roosevelt Road and Des Plaines Street, EL 594.21. INDEX OF SHEETS Existing Structure: SN 016-0478 was built as FAI 94, Section S-2626.2-4B at Sta. 5+97.03 in 1961. The entire structure General Plan and Elevation except center pier was replaced in 1986. Superstructures consist of concrete deck on two span continuous composite General Notes, Scope of Work, & Bill of Materials rolled steel beams. Substructures consist of high wall abutments on steel piles and a wall pier on drilled shafts. Stage Construction Details Length is 194'-10" back-to-back abutments. Out-to-out deck width is 88'-0". Temporary Concrete Barrier For Stage Construction Deck Plan Traffic will be maintained using Stage Construction. Abutment and Deck Concrete Removal Pankaj Kumar. Abutment and Deck Concrete Removal Sections No Salvage Abutment and Deck Alterations Abutment and Deck Details (Sheet 1 of 4) PANKAJ KUMAR. S.E. Abutment and Deck Details (Sheet 2 of 4) NO. 081-007577 Abutment and Deck Details (Sheet 3 of 4) EXP. DATE: 11/30/2024 Abutment and Deck Details (Sheet 4 of 4) Limits of Protective Shield Bridge Fence Railing 14. Preformed Joint Strip Seal - Sidewalk (Sheet 1 of 2) Preformed Joint Strip Seal - Sidewalk (Sheet 2 of 2) Abutment and Pier Repairs 17. Bar Splicer Assembly And Mechanical Splicer Details Ε DESIGN STRESSES Existing Construction f'c = 3,500 psi (Concrete)fs = 20,000 psi (Pier Reinforcement) fy = 60,000 psi (Reinforcement)fy = 50,000 psi (Structural Steel, AASHTO M223, Grade 50) fy = 36,000 psi (Structural Steel, AASHTO M183) ELEVATION (Looking North) New Construction f'c = 4,000 psi (Superstructure Concrete) Ν fy = 60,000 psi (Reinforcement) Limits of Protective Shield — DESIGN SPECIFICATIONS 20'-0" Bridge Approach Pavement, typ. 2002 AASHTO Standard Specifications for Perform $\frac{3}{4}$ " Bridge Deck Scarification and Q I-90/94 -⊈ Pier – € I-90/94 Apply 21/3" Bridge Deck Latex Concrete Overlay, Highway Bridges (17th Edition) Southbound Northbound typ. Approach Pavements and Deck. LOADING HS20-44 - Exist. Catch Basin, typ. - Replace Expansion Joints at Stage Construction Line Abutments with Strip Seal Joints, typ. both abutments Range 14E 3rd P.M. ⊊ Pier - Ç Bearing W. Abut. Bk. E. Abut. Exist. Structure Bk. W. Abut. Sta. 5+97.03 Sta. 5+13.28 Sta. 7+05.70 Sta. 5+10.86 9 © Bearing E. Abut └─ @ Roosevelt Road Sta. 7+03.28 Sta. 5+63.49 (Roosevelt Road) = Sta. 190+31.57 (I-90/94 SB) Sta. 6+29.79 (Roosevelt Road) = Sta. 190+31.05 (I-90/94 NB) Bike Stage Construction Line -LOCATION SKETCH GENERAL PLAN AND ELEVATION ROOSEVELT ROAD 2'-5" 83'-9" 106'-3" 2'-5" OVER I-90/94 (DAN RYAN EXPRESSWAY) Span 1 Span 2 194'-10"

FAI ROUTE 90/94 SECTION 2020-166-BR

COOK COUNTY STATION 5+97.03 STRUCTURE NO. 016-0478

SHEET 1 OF 17 SHEETS

DESIGNED REVISED INFRASTRUCTURE HECKED PK REVISED ENGINEERING LINCOR DRAWN REVISED 1 South Wacker | Suite 2650 | Chicago, IL 60606 PLOT DATE = 11/28/2023 REVISED CHECKED .

STATE OF ILLINOIS **DEPARTMENT OF TRANSPORTATION**

Back to Back Abutments

PLAN

SECTION 94 2020-166-BR соок 39 15 CONTRACT NO. 62M52

GENERAL NOTES

All expansion joint structural steel shall conform to AASHTO Classification M-270 Gr. 36, unless otherwise noted.

Plan dimensions and details relative to existing plans are subject to nominal construction variations. The Contractor shall field verify existing dimensions and details affecting new construction and make necessary approved adjustments prior to construction or ordering of materials. Such variations shall not be cause for additional compensation for a change in scope of the work, however, the Contractor will be paid for the quantity actually furnished at the unit price bid for the work.

Reinforcement bars designated (E) shall be epoxy coated.

Prior to pouring the new concrete deck, all heavy or loose rust, loose mill scale, and other loose or potentially detrimental foreign material shall be removed from the surfaces in contact with concrete. Tightly adhered paint may remain unless otherwise noted. Removal shall be accomplished by methods that will not damage the steel and the cost will be included in the pay item covering removal of the existing concrete.

If the Contractor elects to use cantilever forming brackets on the exterior girders, the brackets shall be placed at the same locations as required for the hardwood blocks in Article 503.06(b) of the Standard Specifications. If additional cantilever forming brackets are required, hardwood blocking shall be wedged between the exterior and first interior girder at each of these additional bracket locations.

SCOPE OF WORK

- 1. Perform $\frac{3}{4}$ " bridge deck scarification on the bridge deck and approach slabs.
- 2. Repair structural concrete on Pier and Abutment. Install shoring and cribbing to support Girder 6 on the west side of Pier.
- 3. Remove bridge deck expansion joints at both abutments and install new preformed strip seal joints.
- 4. Replace missing handrails.
- 5. Apply 2½" bridge deck latex concrete overlay on the bridge deck and approach
- Apply protective coat to deck, approach slabs, reconstructed sidewalks, and reconstructed parapets.
- 7. Perform bridge deck grooving on the bridge deck and approach slabs.
- Remove and reconstruct sidewalks and parapets at east end deck for ADA Compliance

TOTAL BILL OF MATERIAL

ITEM	UNIT	SUPER	SUB	TOTAL
Concrete Removal	Cu Yd	36.5		36.5
Protective Shield	Sq Yd	1,843		1,843
Concrete Superstructure	Cu Yd	36.4		36.4
Bridge Deck Grooving	Sq Yd	1,715		1,715
Protective Coat	Sq Yd	1,823		1,823
Reinforcement Bars, Epoxy Coated	Pound	3,720		3,720
Bar Splicers	Each	48		48
Preformed Joint Strip Seal	Foot	172		172
Approach Slab Repair (Full Depth)	Sq Yd	1		1
Bridge Deck Latex Concrete Overlay, 2½ Inches	Sq Yd	1,733		1,733
Bridge Deck Scarification, ¾"	Sq Yd	1,733		1,733
Structural Repair Of Concrete (Depth Equal To Or Less Than 5 Inches)	Sq Ft		254	254
Structural Repair Of Concrete (Depth Greater Than 5 Inches)	Sq Ft		20	20
Deck Slab Repair (Full Depth, Type II)	Sq Yd	1		1
Handrail Repairs	L. Sum	1		1
Temporary Shoring and Cribbing	Each		1	1

* Quantity is for the top of deck, sidewalks, and parapets and the roadway face of sidewalks and parapets.


Quantity is also for the top of new concrete on both abutment backwalls.

STATE OF ILLINOIS
DEPARTMENT OF TRANSPORTATION

GENERAL NOTES, SCOPE OF WORK, & BILL OF MATERIALS
STRUCTURE NO. 016-0478


SHEET 2 OF 17 SHEETS

F.A.I. SECTION COUNTY TOTAL SHEETS NO.
94 2020-166-BR COOK 39 16
CONTRACT NO. 62M52

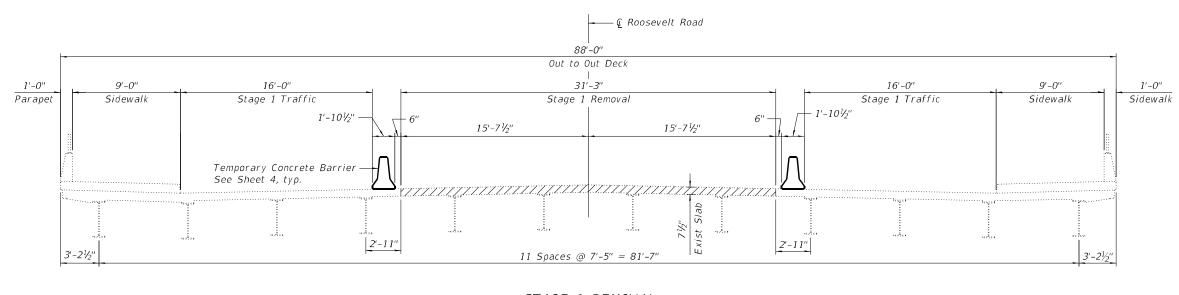


STAGE 1 REMOVAL

(Looking East)

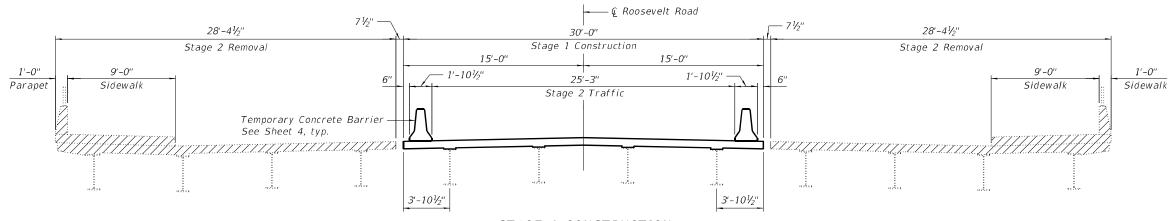

STAGE 1 CONSTRUCTION & STAGE 2 REMOVAL

(Looking East)

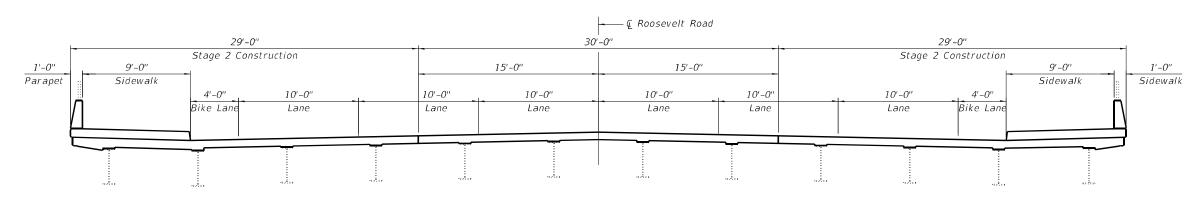

STAGE 2 CONSTRUCTION

(Looking East)


NOTES

- 1. Stage Construction Details are shown for the expansion joint replacement at the west and east ends of the deck.
- 2. Hatch area indicates concrete removal

	STATE OF ILLINOIS	REVISED - REVISED -	DESIGNED - TY CHECKED - PK	USER NAME = ALane	INFRASTRUCTURE	AME: P:
I	DEPARTMENT OF TRANSPORTATION	REVISED -	DRAWN - TY	PLOT SCALE =		й г
		REVISED -	CHECKED - PK		P 312.425.9560 F 312.425.9564 www.infrastructure.eng.com	ž E
	DEPARTMENT OF TRANSPORTATION				1 South Wacker Suite 2650 Chicago, IL 6060	H N

TAGE CO	TAGE CONSTRUCTION DETAILS									
STRUC	STRUCTURE NO. 016-0478							94	2	
311100	1011	LIVU	. 01	0-0470						
SHEET	3	OF	17	SHEETS						

RTE.	SECTION			COUNTY	SHEETS	NO.
94	2020-166-BR			СООК	39	17
·				CONTRACT	NO. 62	2M52
ILLINOIS FED.			FED. A	ID PROJECT		

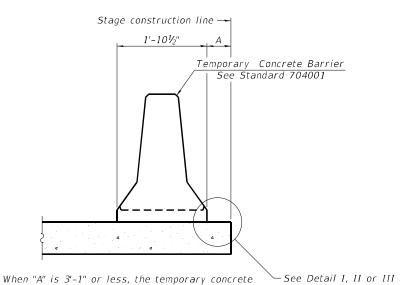

barrier shall be restrained to the new slab according to Detail I, II or III. No restraint is required when "A" is greater than 3'-1".

← Stage removal line ← Stage removal line 1'-101/2" 1'-101/2" Temporary Concrete Barrier See Standard 704001 6" min. min. Drill 3-11/4" Ø Holes in existing slab for 1" Ø restraining pins. Traffic side only. Cost of restraining pins are included with Temporary Concrete Barrier. No restraint st When hot-mix asphalt wearing surface is present, embedment is required when "A" is greater than 3'-1".


shall be 3" plus the wearing surface depth. EXISTING DECK BEAM


US Std. 11/16" I.D. x 21/2" O.D. x approx. 8 gauge thick washer 1" Ø pin RESTRAINING PIN

NEW SLAB OR NEW DECK BEAM

SECTIONS THRU SLAB OR DECK BEAM

EXISTING SLAB

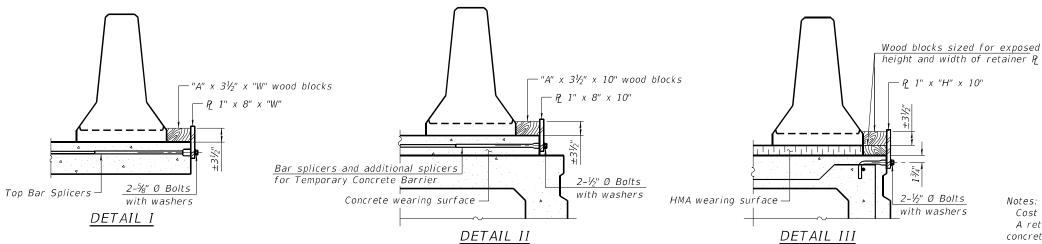

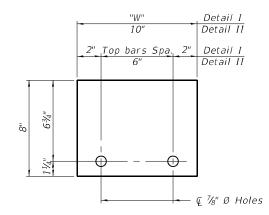


STEEL RETAINER P 1" x 8" x "W"

(Detail I and II)

RAILING CRITERIA

NCHRP 350 Test Level Railing Weight (plf)

R-27 10-12-2021

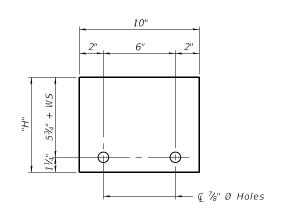

STEEL RETAINER P 1" x "H" x 10" (Detail III)

BAR SPLICER FOR #4 BAR - DETAIL III

Cost of retainer assembly is included with Temporary Concrete Barrier. A retainer assembly shall be located at the approximate \cline{Q} of each temporary

The retainer plate shall not be removed until the concrete on the adjacent stage is ready to be poured. For Detail III applications the retainer plate shall not be removed until just prior to placing the adjacent beam.


When the 'A' dimension is less than $1\frac{1}{2}$ ", the wood block shall be omitted and the barrier shall be placed in direct contact with the steel retainer plate. For deck beam applications the minimum required 'A' distance is 6" to accommodate the shear key clamping device.

- Detail I Installation for a new bridge deck or bridge slab.
- Detail II Installation for a new deck beam with an initial concrete wearing surface. Additional bar splicers shall be provided at 6'-0" centers and paired with the bar splicers of the concrete wearing surface reinforcement to accommodate the installation of the retainer assemblies. The cost of the additional bar splicers is included with the concrete wearing surface.
- Detail III Installation for a new deck beam with no initial wearing surface or with an initial hot-mix asphalt (HMA) wearing surface present. The deck beam directly beneath the temporary concrete barrier shall be fabricated with bar splicer inserts in the side of the beam, as detailed, to accommodate the installation of the retainer assemblies. A pair of bar splicers, 6" apart, shall be placed at 6'-0" centers along the length of the beam. The cost of the bar splicers is included with the deck beam.

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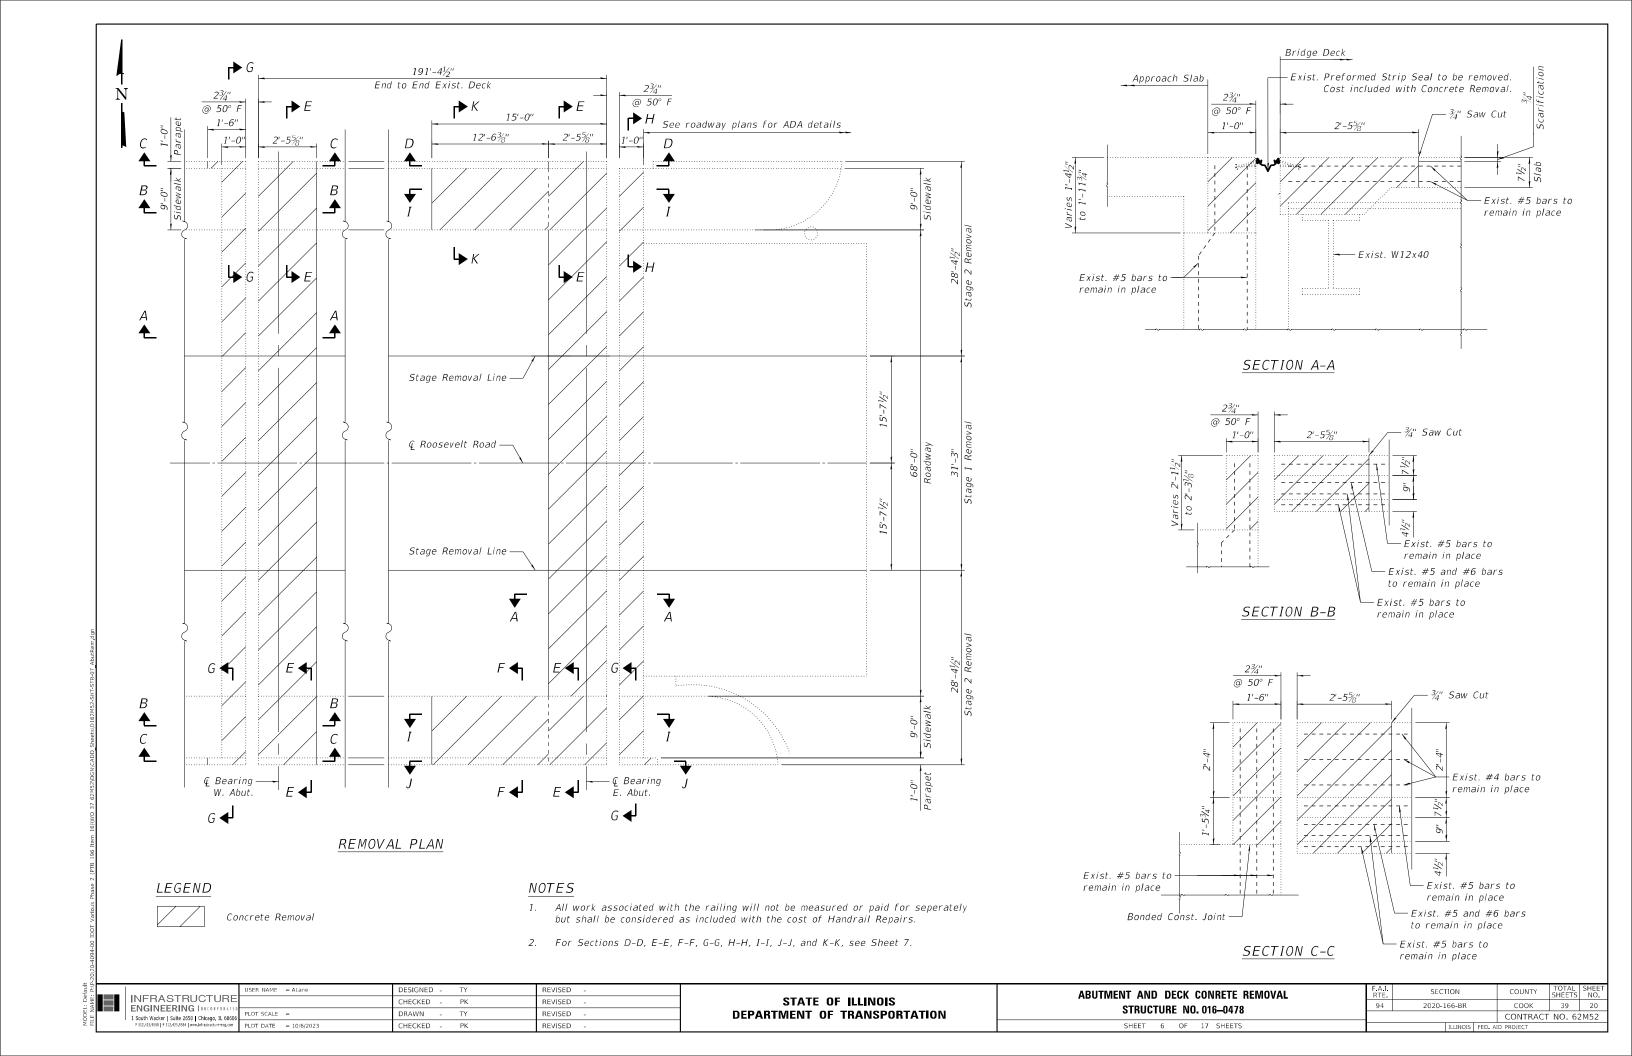
STATE OF ILLINOIS **DEPARTMENT OF TRANSPORTATION** TEMPORARY CONCRETE BARRIER FOR STAGE CONSTRUCTION **STRUCTURE NO. 016-0478** SHEET 4 OF 17 SHEETS


SECTION 94 2020-166-BR COOK 39 18 CONTRACT NO. 62M52

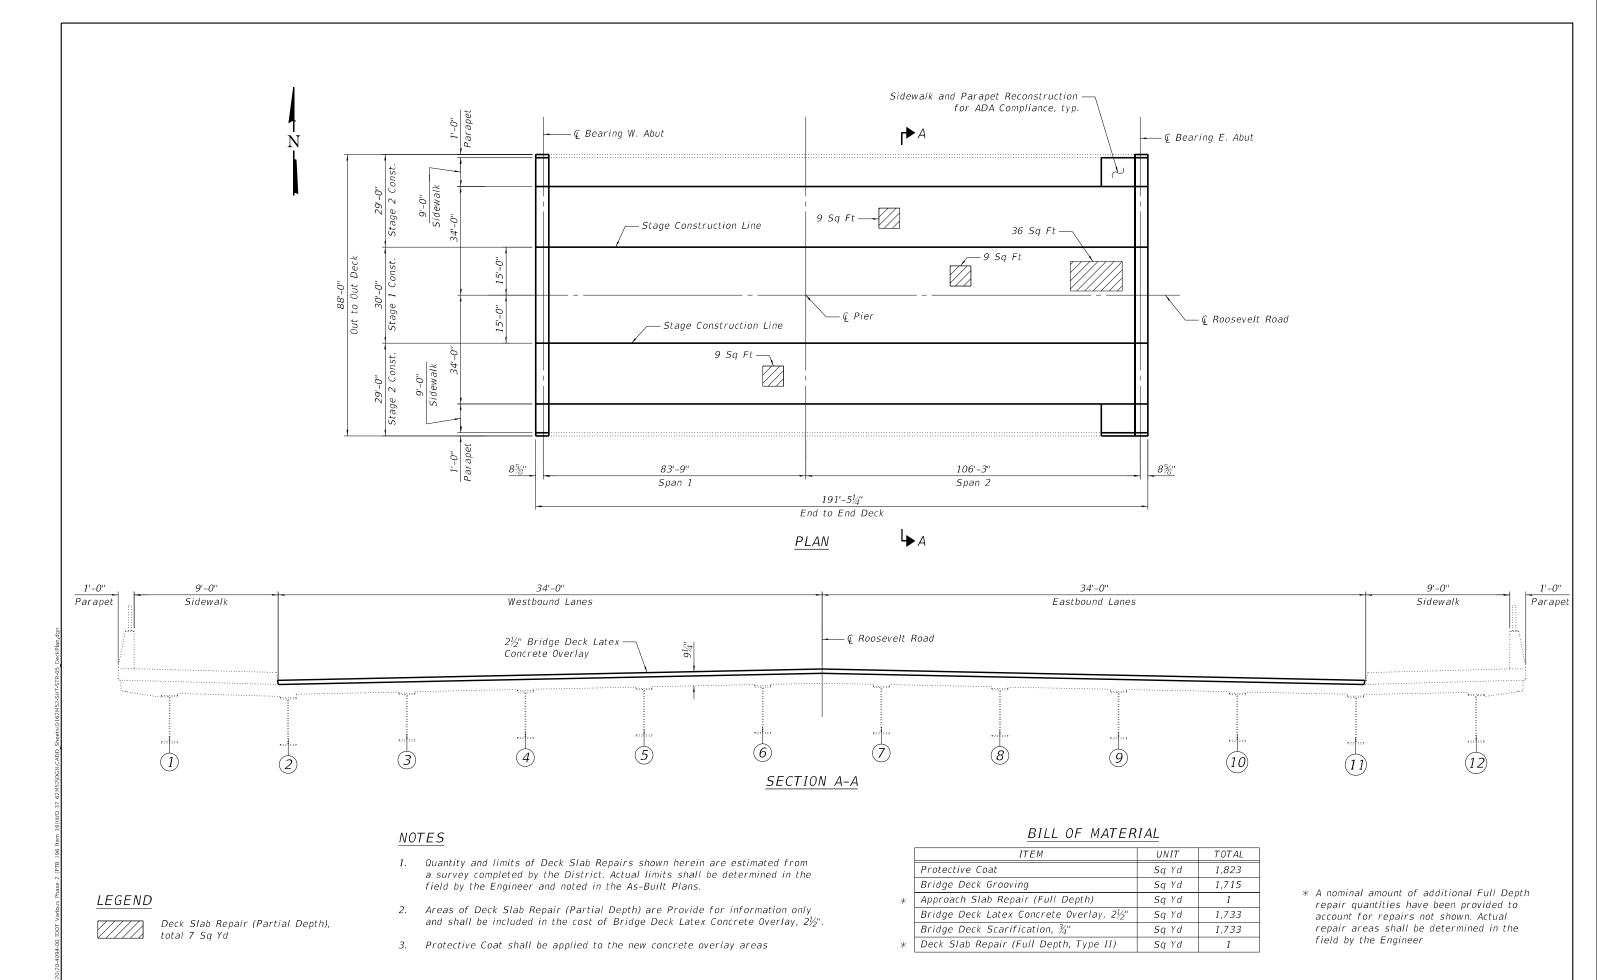


STATE OF ILLINOIS
DEPARTMENT OF TRANSPORTATION

SECTION COUNTY TOTAL SHEETS NO.
4 2020-166-BR COOK 39 19
CONTRACT NO. 62M52



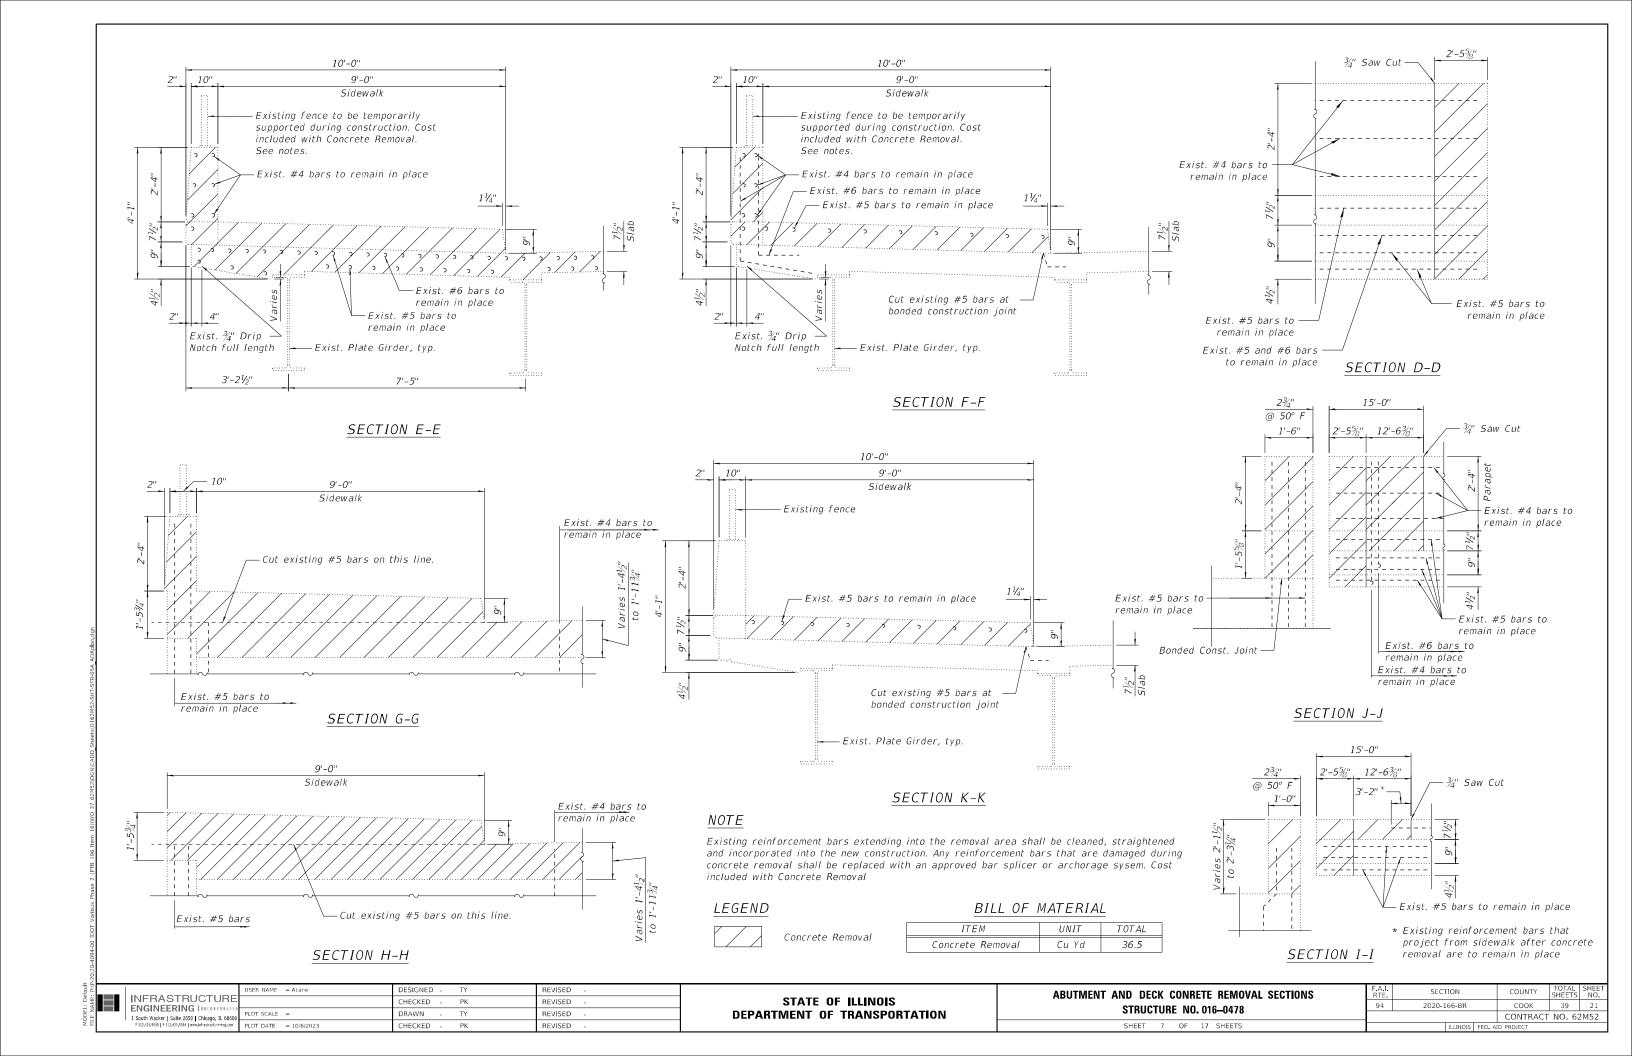

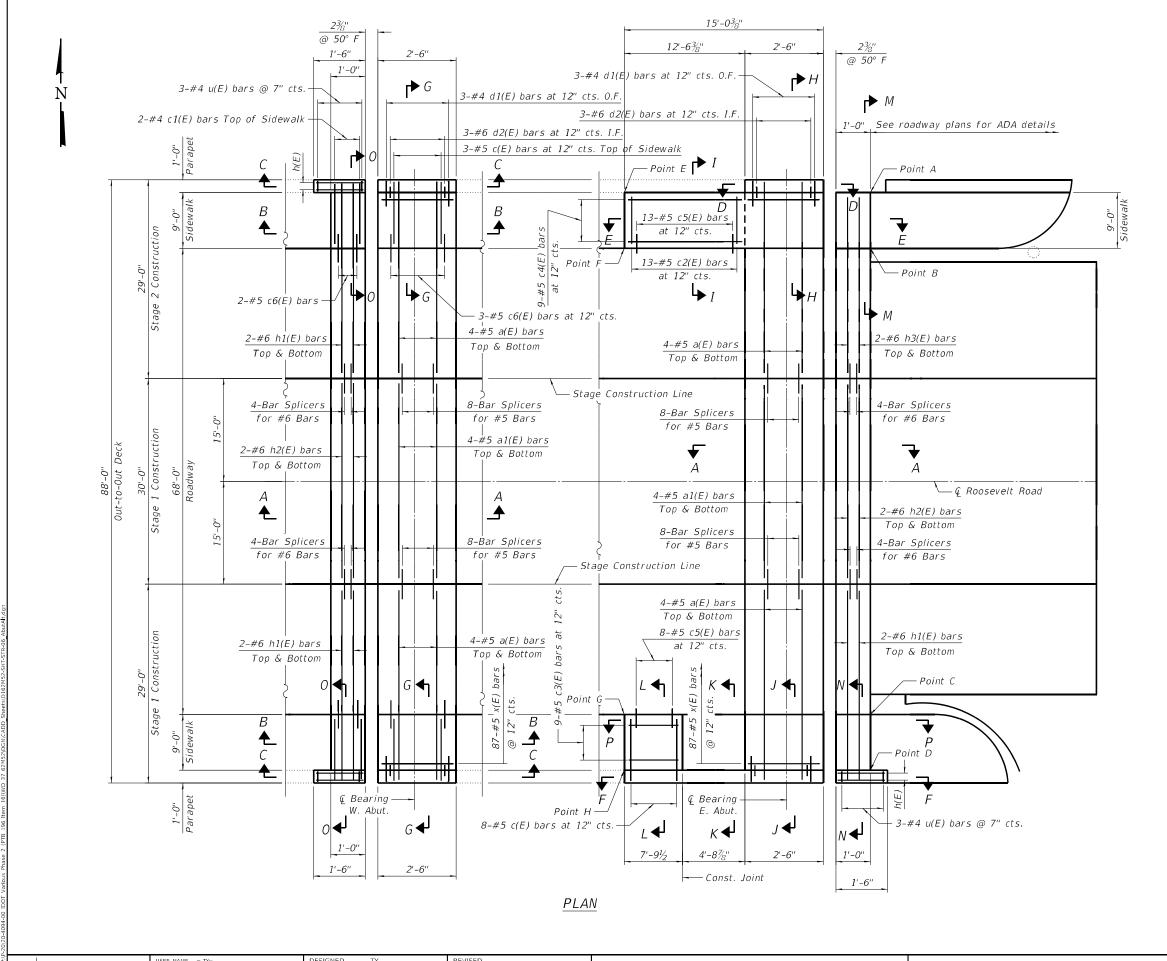

ELEVATION TABLE


	Location	Prop. Elev.
	Point A	597.56
	Point B Top of Sidewalk	597.54
	Point C Top of Sidewalk	597.25
	Point D	597.27
<	Point E	598.31
ć	Point F Top of Sidewalk	598.23
ł	Point G Top of Sidewalk	598.19
<	Point H	598.27


^{*} Match existing elevations

NOTE


1. For Sections A-A thru P-P, see Sheets 9 thru 12.

g.		USER NAME = TYu	DESIGNED - TY	REVISED -		ABUTMENT AND DECK ALTERATIONS	F.A.I.	SECTION	COUNTY	SHEETS	SHEET
AME	INFRASTRUCTURE		CHECKED - PK	REVISED -	STATE OF ILLINOIS		94	2020-166-BR	соок	39	22
Z H	1 South Wacker I Suite 2650 I Chicago, II 60606	PLOT SCALE =	DRAWN - TY	REVISED -	DEPARTMENT OF TRANSPORTATION	STRUCTURE NO. 016-0478			CONTRACT	T NO. 6	2M52
Ē	P 312.425.9560 F 312.425.9564 www.infrastructure-eng.com	PLOT DATE = 11/30/2023	CHECKED - PK	REVISED -		SHEET 8 OF 17 SHEETS		ILLINOIS FED. A	AID PROJECT		

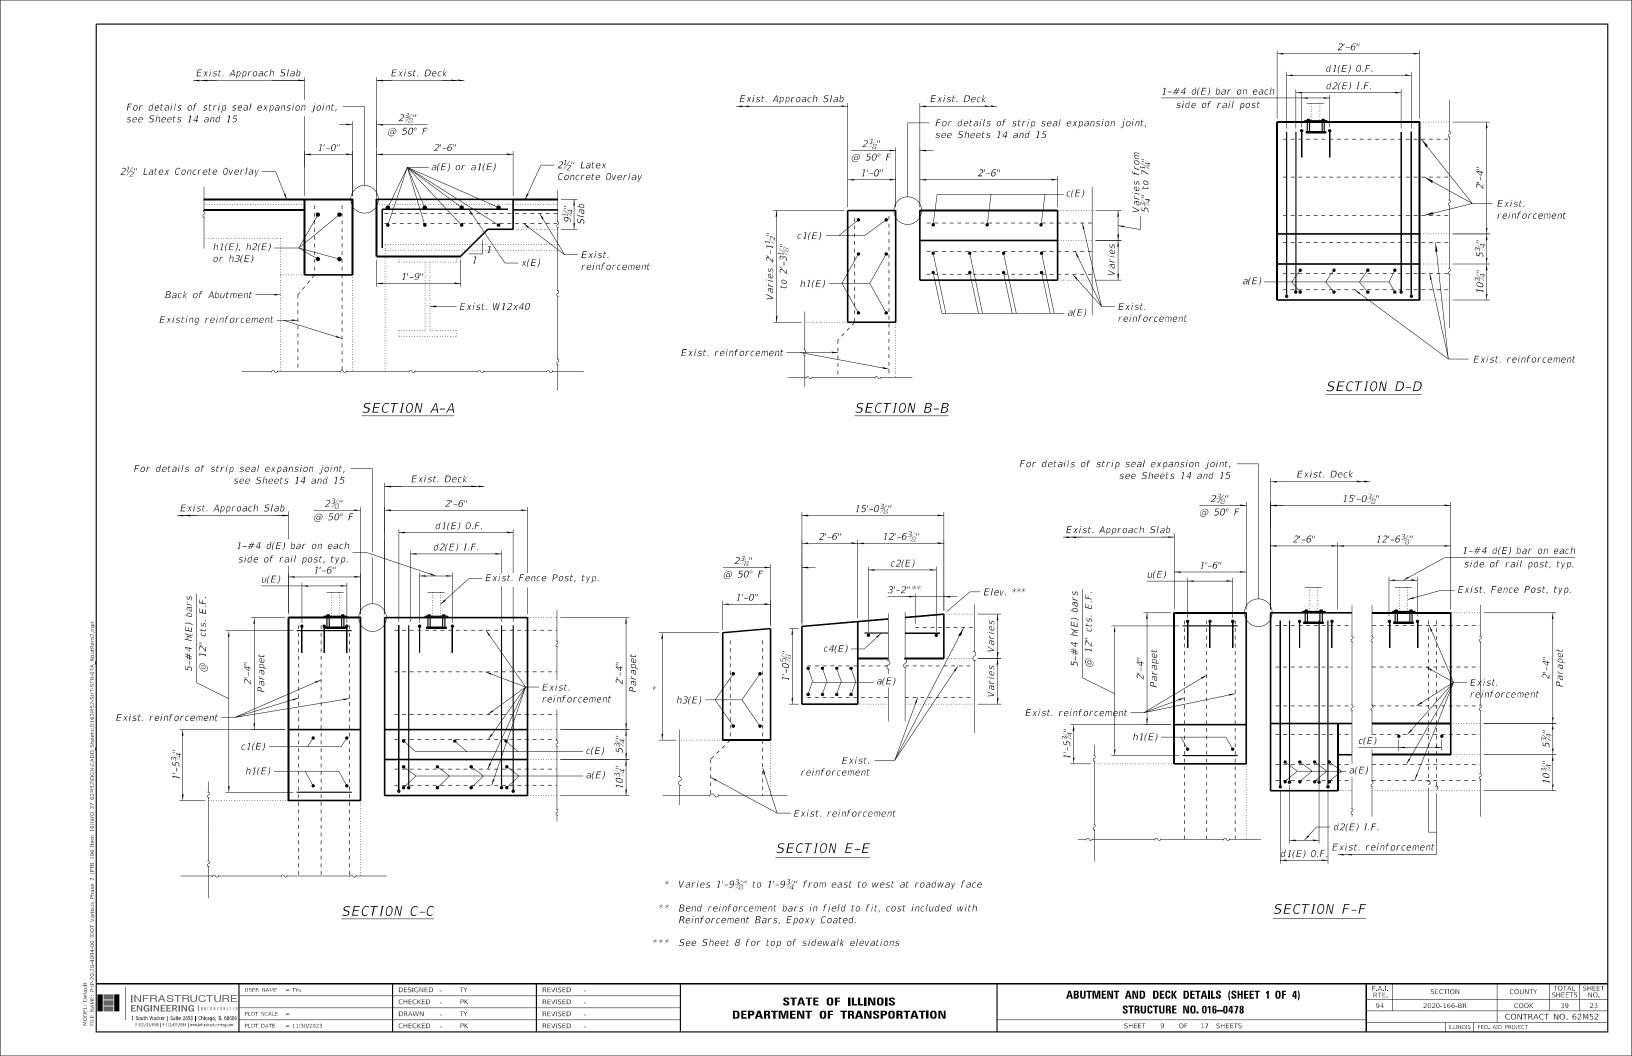

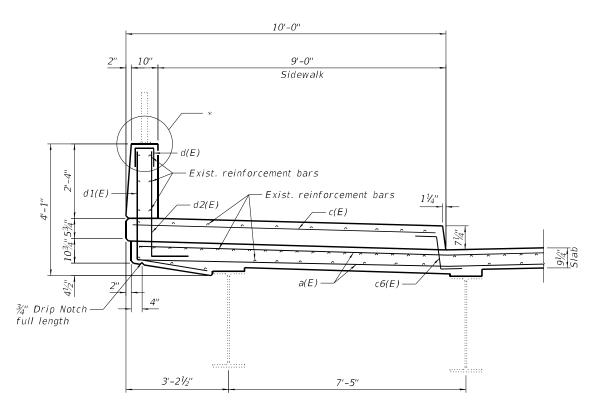

SECTION G-G

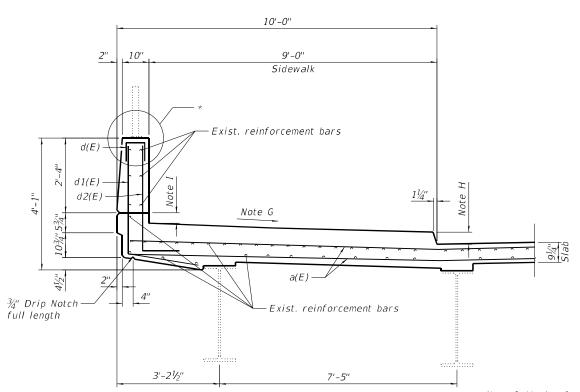


SECTION J-J

Note G: Varies from 0.27% at Sta. 7+07.40 to 0.45% at Sta.7+09.90

Note H: Varies from 5%" at Sta. 7+07.40 to 134" at Sta. 7+09.90


Note I: Varies from $4\frac{1}{2}$ " at Sta. 7+07.40 to $3\frac{3}{4}$ " at Sta. 7+09.90

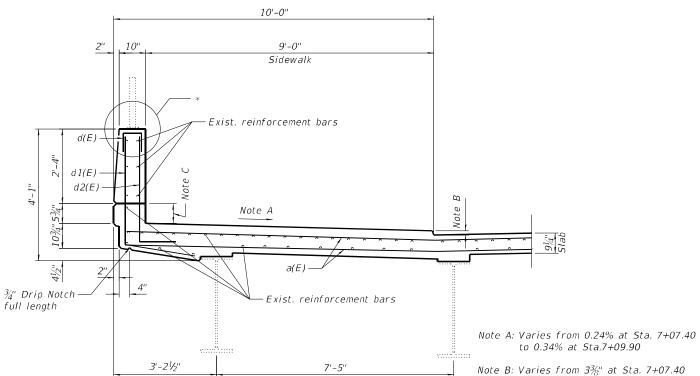

SECTION H-H

Note B: Varies from 3¾" at Sta. 7+07.40 to 4" at Sta. 7+09.90

Note C: Varies from $2\frac{7}{8}$ " at Sta. 7+07.40 to $2\frac{1}{2}$ " at Sta. 7+09.90

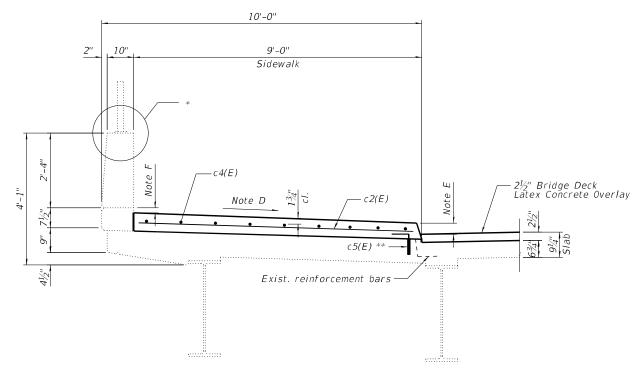

SECTION I-I

- * See Anchorage Assembly on Sheet 12
- ** Drill and set c5(E) bars according to Article 509.06 of the Standard Specifications. Drilled hole shall be roughened or scored per manufacturer's recommendations. Maximum depth of hole shall not exceed 6".
- Note D: Varies from 0.34% at Sta. 7+09.90 to 0.8% at Sta. 7+22.43
- Note E: Varies from 4" at Sta. 7+09.90 to $7\frac{1}{2}$ " at Sta. 7+22.43
- Note F: Varies from 2½" at Sta. 7+09.90 to 0" at Sta. 7+22.43


STATE OF ILLINOIS
DEPARTMENT OF TRANSPORTATION

ABUTMENT AND DECK DETAILS (SHEET 2 OF 4)
STRUCTURE NO. 016-0478


SHEET 10 OF 17 SHEETS

A.I. SECTION COUNTY TOTAL SHEETS NO.
4 2020-166-BR COOK 39 24

CONTRACT NO. 62M52

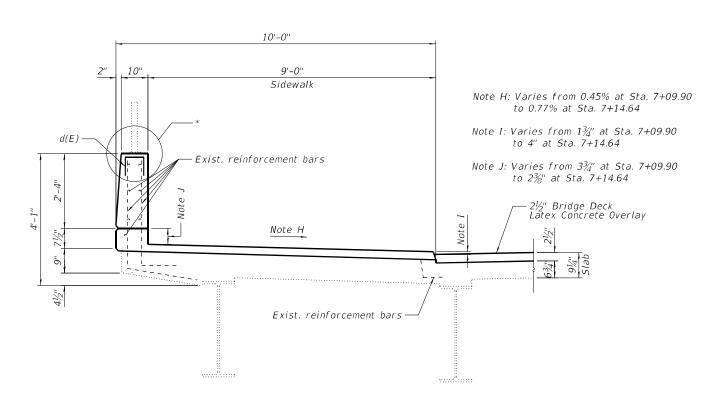

SECTION K-K

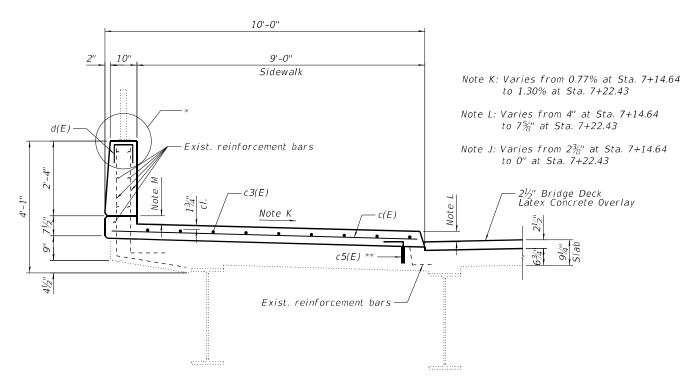


* See Anchorage Assembly on Sheet 12 SECTION L-L


** Drill and set c5(E) bars according to Article 509.06 of the Standard Specifications. Drilled hole shall be roughened or scored per manufacturer's recommendations. Maximum depth of hole shall not exceed 6".

9'-0" Sidewalk Note E: Varies from 0.2% at Sta. 7+06.20 to 0.27% at Sta.7+07.20 Note F: Varies from 1'-6%" at Sta. 7+06.20 to 1'-7" at Sta. 7+07.20 Note G: Varies from O" at Sta. 7+06.20 to 5/8" at Sta. 7+07.20 – Exist. reinforcement bars h(E) -- h1(E) Note E Exist. reinforcement bars

SECTION N-N

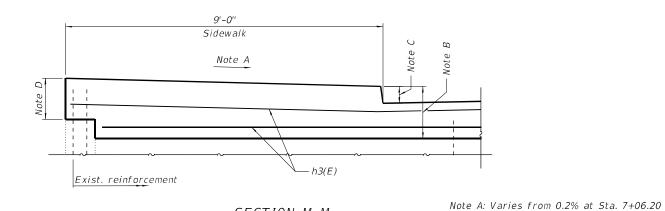

SECTION M-M

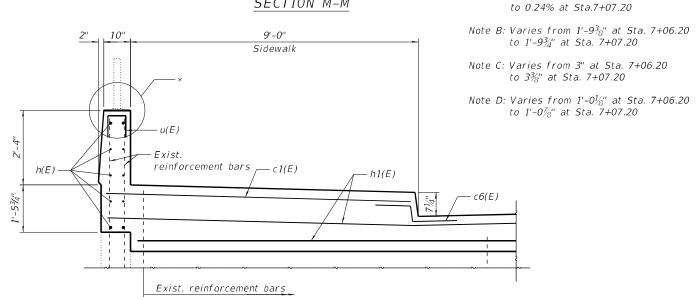

SECTION 0-0


	ABUTMENT AND DECK DETAILS (SHEET 3 OF 4)	F.A.I. RTE	SECTION	COUNTY	TOTAL SHEETS	SHEETS 39
	STRUCTURE NO. 016-0478	94	2020-166-BR	СООК	39	ĺ
ON	STHOUTONE NO. 010-0470			CONTRACT	NO. 62	2
	CHEET 11 OF 17 CHEETC					-

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STATE OF ILLINOIS **DEPARTMENT OF TRANSPORTATIO** SHEET NO. 25 62M52

ANCHORAGE ASSEMBLY

The Bridge Fence Railing fasteners for end posts near expansion joints may need to be installed prior to installing the bent plates. In lieu of the cast-in-place anchor device shown, the Contractor has the option of drilling and setting $\frac{4}{3}$ " \emptyset fully threaded anchor rods with the same plate washers as specified above and heavy hex lock nuts according to Article 509.06 of the Standard Specifications. Embedment shall be according to the manufacturer's specifications.

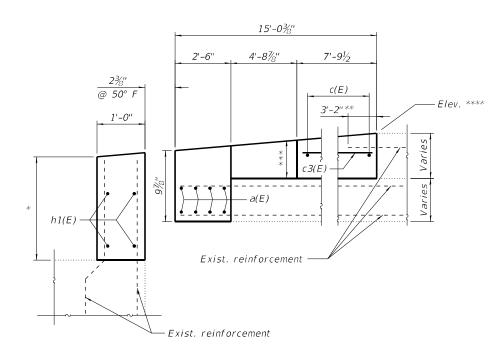



SECTION P-P

- * Varies 1'-6%" to 1'-7" from east to west at roadway face
- ** Bend reinforcement bars in field to fit, cost included with Reinforcement Bars, Epoxy Coated.
- *** Varies $1\frac{3}{4}$ " to 4" from east to west at roadway face
- **** See Sheet 8 for top of sidewalk elevations

BILL OF MATERIAL

-		<i>C</i> ·		C /
Bar	No.	Size	Length	Shape
a(E)	32	#5	28'-8"	
a1(E)	16	#5	29'-8''	
c(E)	14	#5	9'-6''	
c1(E)	4	#4	9'-6"	
c2(E)	13	#5	8'-6"	
c3(E)	9	#5	7'-5"	
c4(E)	9	#5	12'-2"	
c5(E)	23	#5	1'-8"	
c6(E)	10	#5	2'-5"	1
d(E)	10	#4	2'-1"	
d1(E)	12	#4	5'-6''	
d2(E)	12	#6	4'-4''	
h(E)	30	#4	1'-3"	
h1(E)	12	#6	28'-8"	
h2(E)	8	#6	29'-8"	
h3(E)	4	#6	27'-8"	
u(E)	9	#4	3'-1"	
x(E)	174	#5	2'-10"	
Concret	e Super:	structure	Cu Yd	36.4
	cement L	Pound	3,720	
Ероху	Coated		, ound	3,720

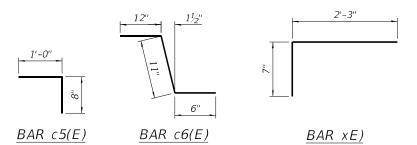

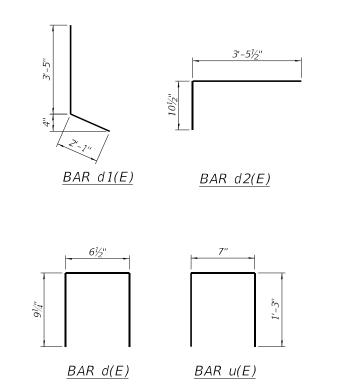

NOTE


1. Cost of furnishing and installing the fence post anchorage assembly and fabric bearing pad is included with Handrail Repairs.


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INFRASTRUCTURE ENGINEERING INCORPORATE 1 South Wacker Suite 2650 Chicago, IL 60606		CHECKED - PK	REVISED -	
		DRAWN - TY	REVISED -	
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STATE OF ILLINOIS
DEPARTMENT OF TRANSPORTATION

ABUTMENT				•	4 OF 4)
	STRU	CTURE	NO. 01	6-0478	
	SHEET	12	OF 17	SHEETS	

A.I. RTE				COUNTY	TOTAL SHEETS	SHEET NO.
94	2020-166-BR			COOK	39	26
·				CONTRACT	NO. 62	2M52
ILLINOIS FED. A				ID PROJECT		



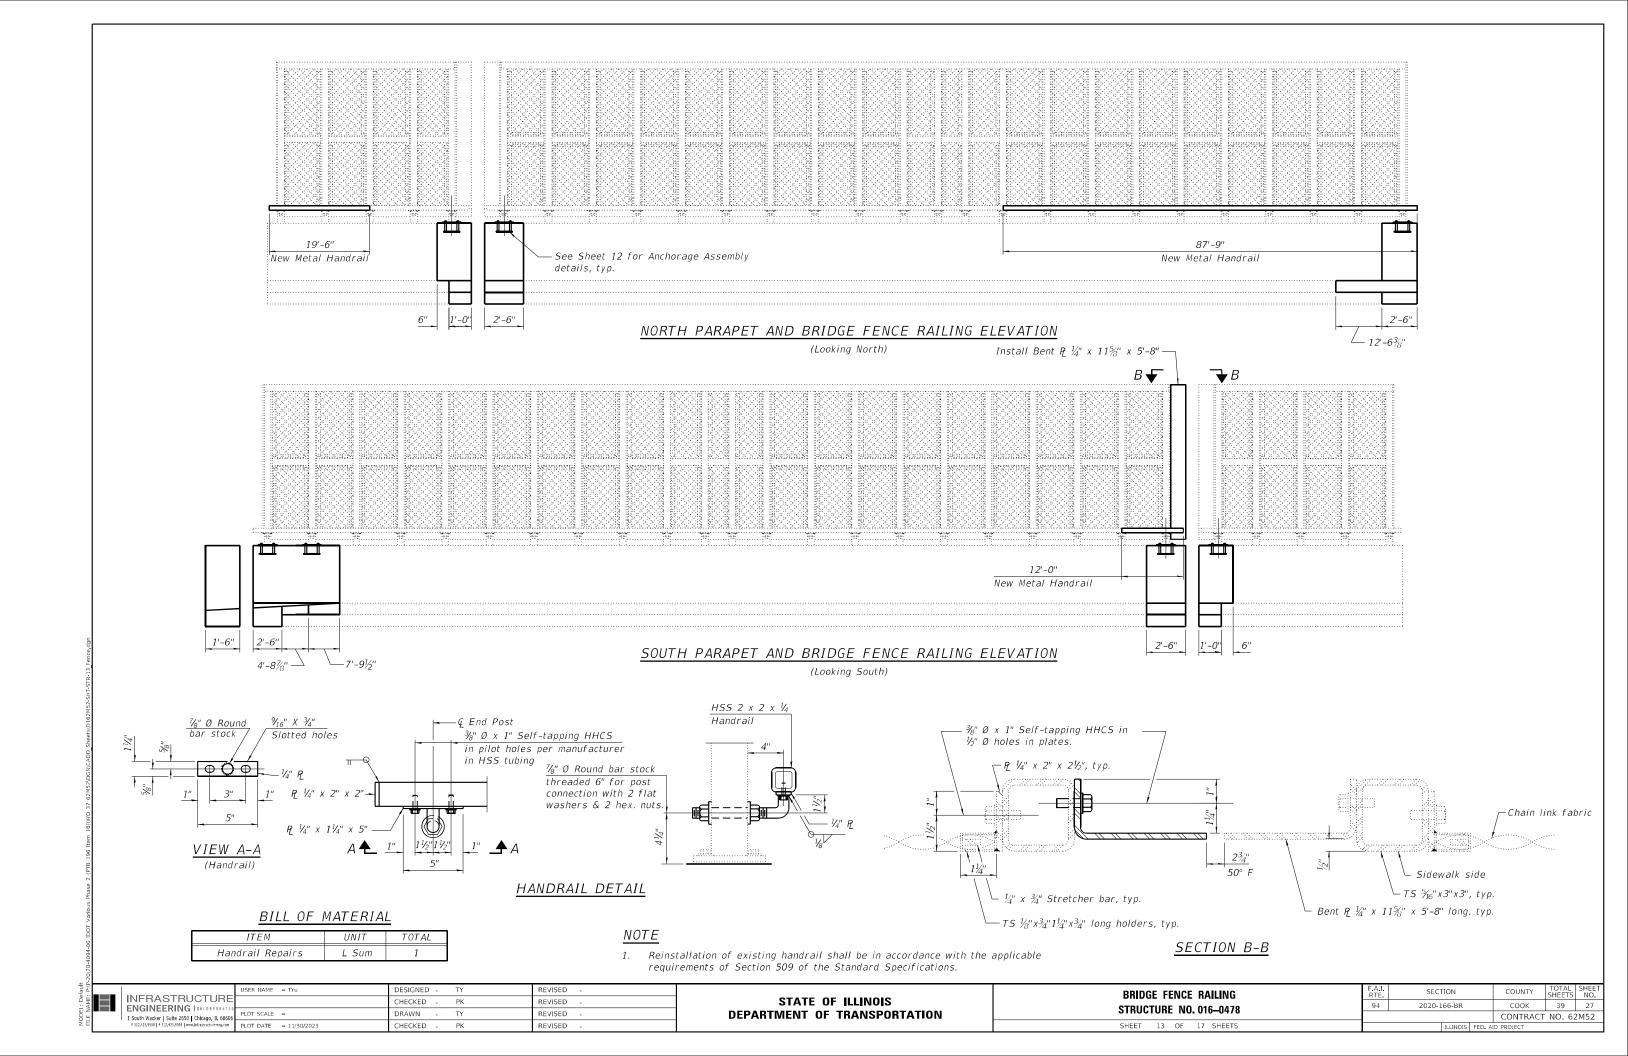

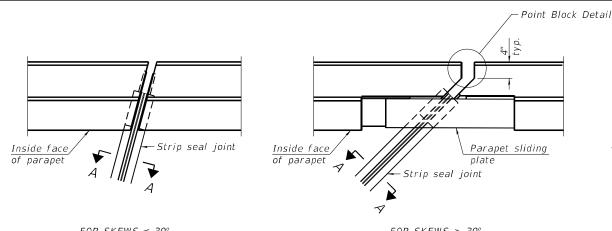PLAN AT PARAPET

FOR SKEWS ≤ 30°

FOR SKEWS > 30°

SECTION B-B

* ¾" Ø x 6" Studs (8 per side 39" parapet) (10 per side 44" parapet) ኘ 🗖 ¾" Embedded plate full depth ¾" Embedded plate, full depth 1/2" Parapet sliding plate 3/8" Ø Countersunk bolts 1'-0" (10 per side 39" parapet) (12 per side 44" parapet) <u>Direction</u> of traffic

Concrete flush with back face of ¾" plate ¾" Plate 0--0 ¾" Plate 2" Chamfer a----

The strip seal shall be made continuous and shall have a minimum thickness of $\frac{1}{4}$ ". The configuration of the strip seal shall match the configuration of the locking edge rails. Open or "webbed" strip seal gland configurations are not permitted. The gland shall be sized for a maximum rated movement of 4 inches.

The locking edge rails depicted are configured for typical applications and are conceptual only. The actual configuration of the locking edge rails and matching strip seal may vary from manufacturer to manufacturer provided they fit the application and meet the minimum anchorage shown. Flanged edge rails, however, will not be allowed. Locking edge rails may exceed the 4½" maximum depth provided the anchorage system is revised according to the manufacturer's recommendation.

The manufacturer's recommended installation methods shall be followed.

All steel components shall be galvanized after fabrication according to Article 520.03 of the Standard Specifications.


The Maximum space between locking edge rail segments shall be $\frac{3}{16}$ " and sealed with a suitable sealant; however, any rail joint within 10' measured perpendicular to the face of the curb or parapet shall be welded as shown in the locking edge rail splice detail.

The top surface of sidewalk sliding plates shall have a raised pattern according to ASTM A786.

Cost of parapet sliding plates, sidewalk sliding plates, embedded plates, anchorage studs, and expansion anchors included with Preformed Joint Strip Seal.

39" constant slope barrier shown, 44" constant slope barrier similar as noted.

The concrete opening below the strip seal will vary based on the locking edge rail chosen by the Contractor. Deck and parapet lengths shown elsewhere in the plans are dimensioned to the concrete opening, not the joint opening, and are based on the rolled locking edge rail. If the Contractor elects to use a different locking edge rail, dimensional adjustments may be required. One exception to this would be the strip seal joint at the end of the precast bridge approach slab. For these cases the pavement connector length shall be adjusted, not the length of the bridge approach slab.

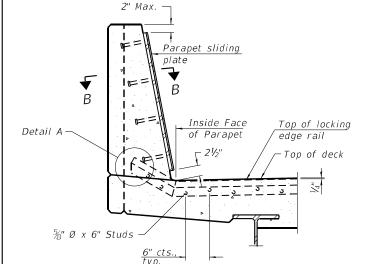


SECTION AT PARAPET

(Skews > 30° shown. Skews ≤ 30° similar except as shown in plan view.)

Locking edge rail-

Top of concrete

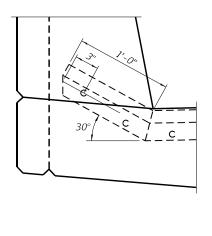


DETAIL A

SECTION A-A * Granular or solid flux filled headed studs conforming to Article 1006.32 of the Std. Specs., automatically end welded.

TRIMETRIC VIEW (Showing embedded plates only)


Concrete flush with back

face of ¾" plate

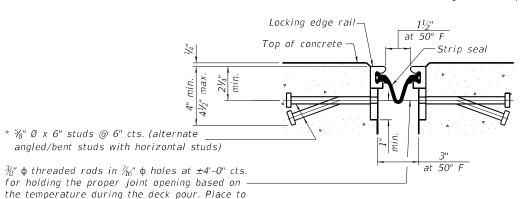


SHOWING ROLLED RAIL JOINT

miss studs. All rods shall be burned, or sawed SHOWING WELDED RAIL JOINT off flush with the plates after concrete is set.

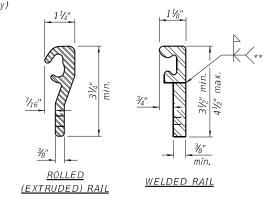

LOCKING EDGE RAILS

** Back gouge not required if complete joint penetration is verified by mock-up.

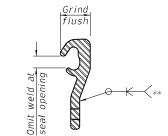

LOCKING EDGE RAIL SPLICE

The inside of the locking edge rail groove shall be free of weld residue. Rolled rail shown, welded rail similar.

BILL OF MATERIAL

T	Unit	T-4-1
Item	Unit	Total
Preformed Joint Strip Seal	Foot	172

EJ-SS-S

11-1-2022

at 50°

_		USER NAME = TYu	DESIGNED - TY	REVISED -
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at 50° F


Strip seal

STATE OF ILLINOIS


PREFORMED	JOINT STRIP				IDEWALK (SHEET 1 OF 2) 6–0478)
	SHEET	14	OF	17	SHEETS	


A.I. RTE	SECT	TON		COUNTY	TOTAL SHEETS	SHEET NO.
94	2020-1	COOK	39	28		
			CONTRACT	NO. 62	2M52	

DEPARTMENT OF TRANSPORTATION

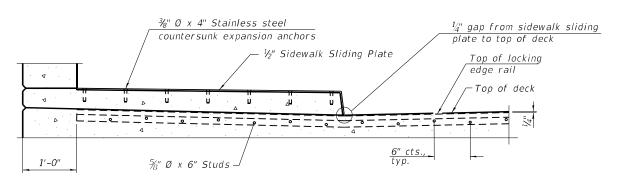


SECTION AT RAISED SIDEWALK

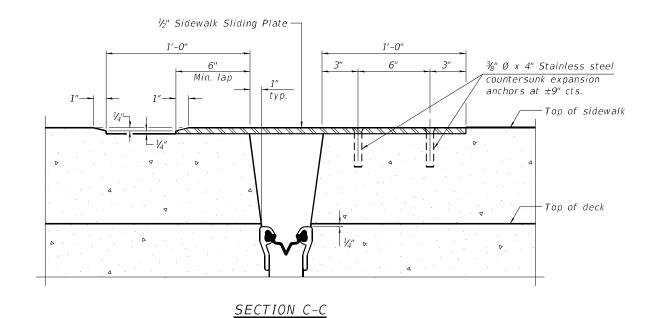

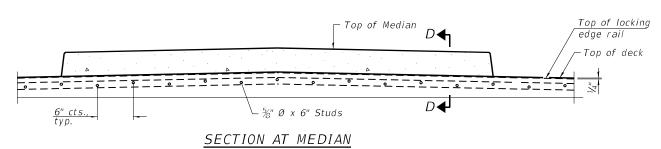


For skews > 30°, chamfer acute corners 2" similar to sidewalk.

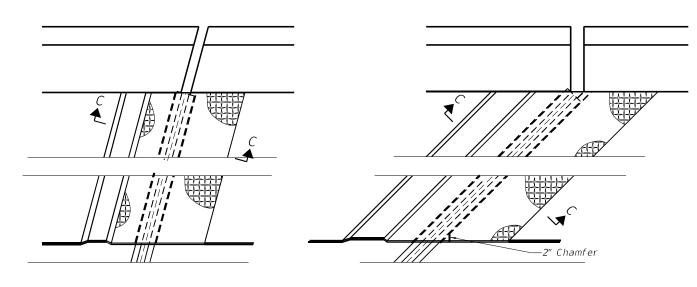

PLAN AT RAISED SIDEWALK

 $(FOR SKEWS \le 30^{\circ})$

(FOR SKEWS > 30°)

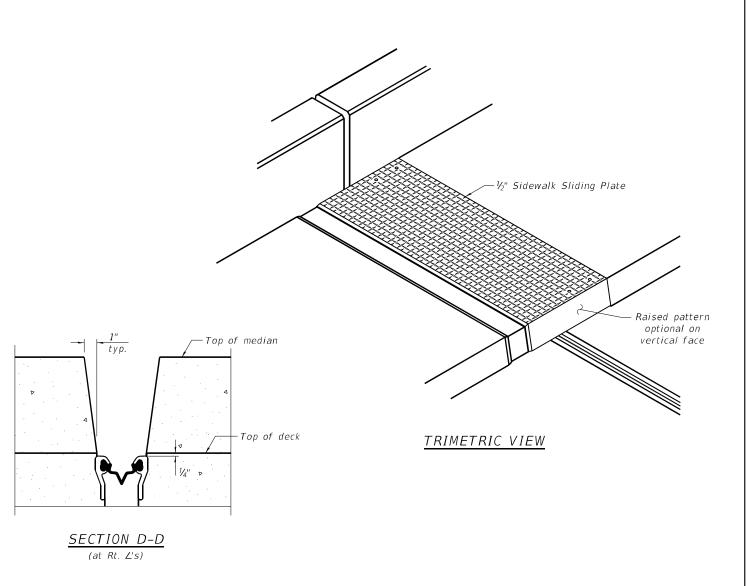


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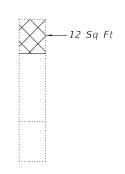
11-1-2022

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STATE OF ILLINOIS **DEPARTMENT OF TRANSPORTATION** PREFORMED JOINT STRIP SEAL - SIDEWALK (SHEET 2 OF 2) **STRUCTURE NO. 016-0478** SHEET 15 OF 17 SHEETS

SECTION COOK 39 29 2020-166-BR CONTRACT NO. 62M52




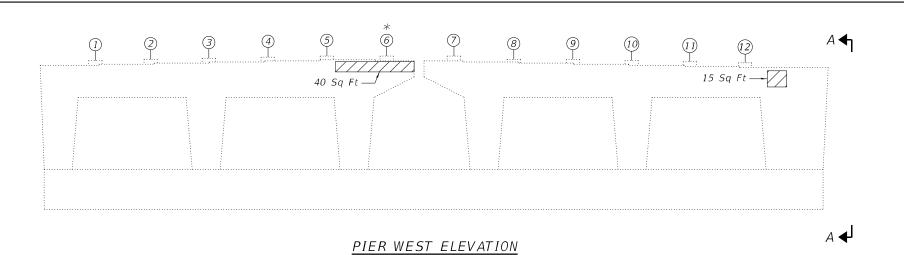

SECTION A-A

PIER EAST ELEVATION



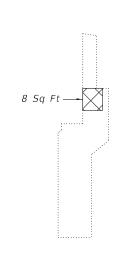

SECTION B-B

BILL OF MATERIAL

ITEM	UNIT	TOTAL
Structural Repair Of Concrete (Depth Equal To Or Less Than 5 Inches)	Sq Ft	254
Structural Repair Of Concrete (Depth Greater Than 5 Inches)	Sq Ft	20
Temporary Shoring and Cribbing	Each	1

LEGENDS

Structural Repair Of Concrete (Depth Equal To Or Less Than 5 Inches)



Structural Repair Of Concrete (Depth Greater Than 5 Inches)



Girder Number

Beam Requires Temporary Shoring

WEST ABUTMENT ELEVATION

(Looking West)

INTERIOR BEAM REACTION TABLE AT PIER

R DL (k)	155.5
R LL (k)	71.1
Imp (k)	17.1
R_Total (k)	243.7

Note: Values given in this table is based on Service Loads

INFRASTRUCTURE
ENGINEERING INCORPORATIO
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STATE OF ILLINOIS DEPARTMENT OF TRANSPORTATION ABUTMENT AND PIER REPAIRS
STRUCTURE NO. 016–0478

SHEET 16 OF 17 SHEETS

 F.A.I. RTE.
 SECTION
 COUNTY SHEETS NO.
 TOTAL SHEETS NO.

 94
 2020-166-BR
 COOK
 39
 30

 CONTRACT NO. 62M52


STANDARD BAR SPLICER ASSEMBLY PLAN

(All components shall be provided from one supplier)

Threaded splicer bar length = min. lap length + $1\frac{1}{2}$ " + thread length

* Epoxy not required on Bar Splicer Assembly components used in conjunction with black bars.

Location	Bar size	No. assemblies required	Minimum Iap length
Abutments	#6	16	4'-0''
Deck	#5	32	3'-6"

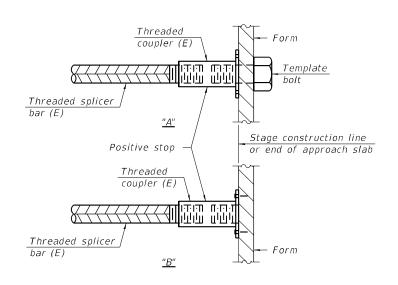

INSTALLATION AND SETTING METHODS

"A" : Set bar splicer assembly by means of a template bolt "B" : Set bar splicer assembly by nailing to wood forms or cementing to steel forms.

(E): Indicates epoxy coating.

Stage line Stage I construction | Stage II construction Mechanical splicer (E) Reinforcement bar-└ Reinforcement bar

STANDARD MECHANICAL SPLICER

Location	Bar size	No. assemblies required	

Notes:

Splicer bars shall be deformed with threaded ends and have a minimum 60 ksi yield strength.

All reinforcement shall be lapped and tied to the splicer bars. Bar splicer assemblies shall be epoxy coated according to the requirements for reinforcement bars. See Section 508 of the Standard Specifications.


See approved list of bar splicer assemblies and mechanical splicers for alternatives.

BSD-1

1-1-2020


	USE
INFRASTRUCTURE	
ENGINEERING INCORPORATED 1 South Wacker Suite 2650 Chicago, IL 60606	PLC
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ING INCORPORATED te 2650 Chicago, IL 60606		DRAWN - TY	REVISED -
	PLOT DATE = 10/6/2023	CHECKED - PK	REVISED -

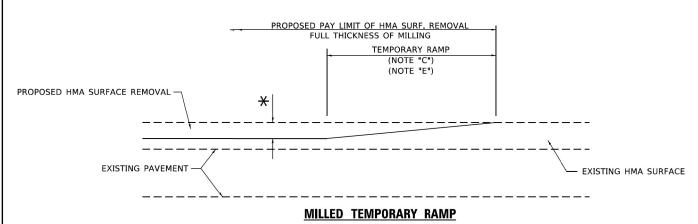

(FOR BUTT JOINT AND HMA TAPER SEE DETAIL BELOW)

OPTION 1

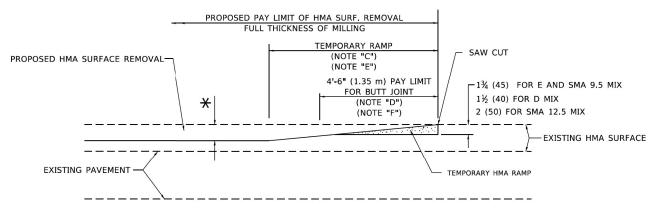


HMA CONSTRUCTED TEMPORARY RAMP

(FOR BUTT JOINT AND HMA TAPER SEE DETAIL BELOW)


OPTION 2


TYPICAL TEMPORARY RAMP

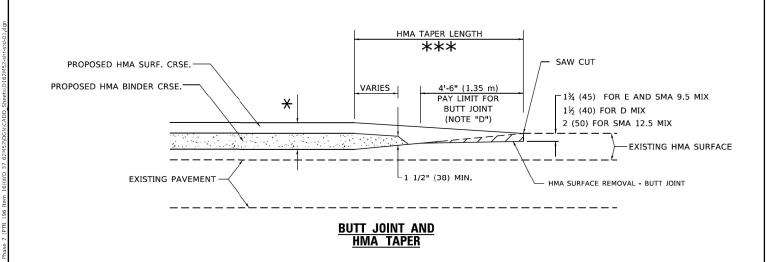

TYPICAL BUTT JOINT AND HMA TAPER FOR MILLING AND RESURFACING

REVISED REVISED

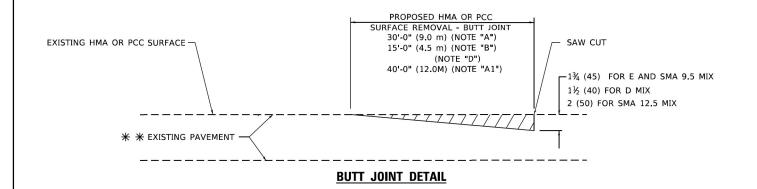

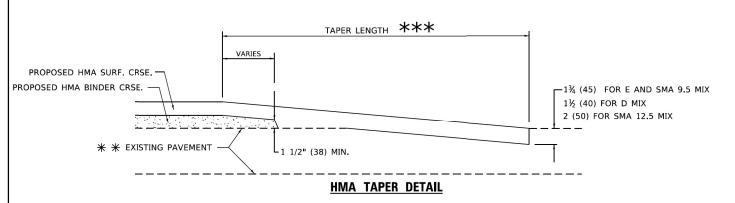

TYPICAL BUTT JOINT AND HMA TAPER FOR RESURFACING ONLY

** PC CONCRETE, HMA OR HMA RESURFACED PAVEMENT

GENERAL NOTES

- A. MAINLINE ARTERIAL ROADWAYS AND MAJOR SIDE ROADS.
- A1. INTERSTATES
- B. MINOR SIDE ROADS.
- C. THE TEMP. RAMP SHALL BE CONSTRUCTED IMMEDIATELY UPON REMOVAL OF THE EXISTING HMA SURFACE.
- D. THE BUTT JOINT SHALL BE CONSTRUCTED IMMEDIATELY PRIOR TO PLACING THE PROPOSED HMA COURSES.
- E. TAPER THE TEMP. RAMP AT A RATE OF 3' 4" (1.02m) PER 1 INCH (25 mm) OF MILLING THICKNESS.
 - igstar SEE TYPICAL SECTIONS FOR MILLING THICKNESS.
- F. SEE ARTICLE 406.08 AND 406.14 OF THE STANDARD SPECIFICATIONS FOR "HMA AND/OR PCC SURFACE REMOVAL, BUTT JOINT".
- *** 20'-0" (6.1 m) PER 1 (25) RESURFACING (NOTE "A") 10'-0" (3.0 m) PER 1 (25) RESURFACING (NOTE "B")

BASIS OF PAYMENT

- THE BUTT JOINT WILL BE PAID FOR AT THE CONTRACT UNIT PRICE PER SQUARE YARD (SQUARE METER) FOR "HOT-MIX ASPHALT SURFACE REMOVAL BUTT JOINT" OR FOR "PORTLAND CEMENT CONCRETE SURFACE REMOVAL- BUTT JOINT".
- THE TEMPORARY RAMP AND SAW CUT SHALL BE INCLUDED IN THE UNIT COST FOR HMA OR PCC SURFACE REMOVAL-BUTT JOINT


SCALE:


ALL DIMENSIONS ARE IN INCHES (MILLIMETERS) UNLESS OTHERWISE SHOWN.

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ш	INFRASTRUCTURE			DRAWN	-	VW
•	I South Wacker Suite 2650 Chicago, IL 60606		= 20.0000 / in.	CHECKED	-	AC
	P 312.425.9560 F 312.425.9564 www.infrastructure.eng.com	PLOT DATE	= 10/6/2023	DATE	-	10/

STATE OF ILLINOIS **DEPARTMENT OF TRANSPORTATION**

DISTRICT O	NE – BUTT	JOINT	AND HI	VIA TAPER	DETAILS (BD-32)	F.A.I. RTE	SECTION	COUNTY	TOTAL SHEETS	SHEET NO.
						94	2020-166-BR	соок	39	32
								CONTRACT	Γ NO. 67	2M52
ALE:	SHEET	OF	SHEETS	STA	TO STA		TILINOIS FED. A	ID DROJECT		-

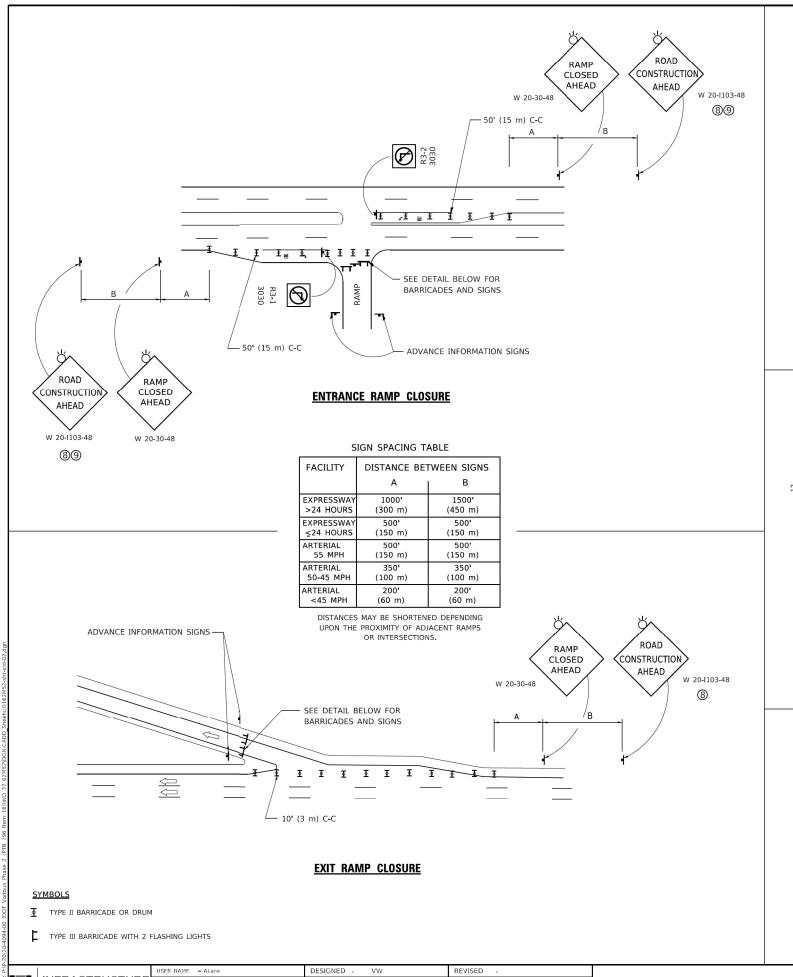

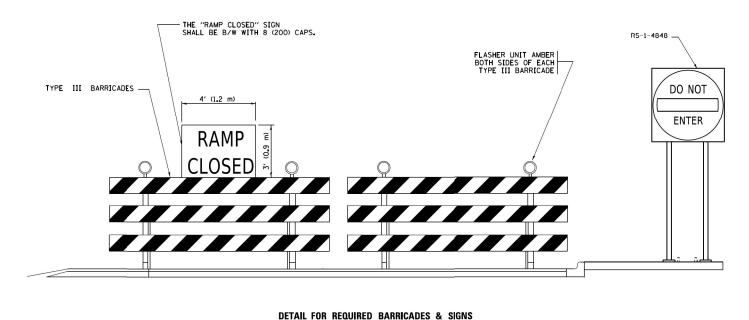

RAMP CLOSURE ADVANCE INFORMATION SIGN




RAMP CLOSURE ADVANCE WARNING SIGN

BLACK LEGEND ON ORANGE

BACKGROUND MOUNTED DIAGONALLY E MOD FONT

1 (25) BORDER THESE SIGNS ARE REQUIRED ON ALL THE EXIT GUIDE SIGNS FOR EXIT RAMPS THAT WILL BE CLOSED FOR MORE THAN FOUR (4) CONSECUTIVE DAYS

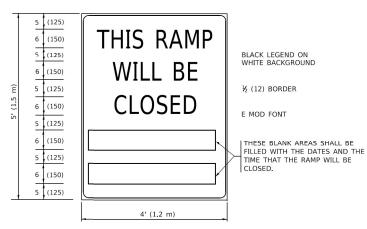

THESE SIGNS ARE REQUIRED ON BOTH SIDES OF THE RAMP, MINIMUM OF 1 WEEK IN ADVANCE OF THE CLOSURE.

THESE SIGNS SHALL BE FABRICATED AND PAID FOR ACCORDING TO THE TEMPORARY INFORMATION SIGNING SPECIAL PROVISION

GENERAL NOTES:

- CONES MAY BE SUBSTITUTED FOR DRUMS OR TYPE II 1 BARRICADES DURING DAY OPERATIONS. CONES SHALL BE A MINIMUM OF 28 (700) HIGH.
- (2) VERTICAL BARRICADES SHALL NOT BE USED FOR RAMP CLOSURES.
- 3 A FLAGGER SHALL BE POSITIONED AT EACH CLOSED RAMP THAT IS OPEN TO CONSTRUCTION VEHICLES, PRECEEDED BY A W20-7 FLAGGER WARNING SIGN.
- ALL ROUTE MARKERS AND TRAILBLAZER ASSEMBLIES WHICH DIRECT MOTORISTS TO A CLOSED ENTRANCE RAMP SHALL BE COVERED WHEN THE RAMP IS CLOSED FOR MORE THAN FOUR (4) DAYS.
- 5 THE SIGNING AND BARRICADING WHICH IS REQUIRED BY THIS DETAIL SHALL BE INCLUDED IN THE COST OF TRAFFIC CONTROL AND PROTECTION (EXPRESSWAYS).


- 6 AUTHORIZATION FROM THE DISTRICT'S BUREAU OF TRAFFIC IS REQUIRED FOR ALL RAMP CLOSURES.
- THE RAMP CLOSURE ADVANCE INFORMATION SIGNS SHALL BE ERECTED IF THE CLOSURE TIME EXCEEDS TWENTY-FOUR (24) HOURS. ADDITIONAL ADVANCE WARNING SIGNS ON EXIT GUIDE SIGNING WILL BE REQUIRED FOR EXIT RAMP CLOSURES THAT EXCEED FOUR (4) DAYS IN LENGTH
- 8 ROAD CONSTRUCTION AHEAD SIGNS MAY BE OMITTED WHEN THIS DETAIL IS USED IN CONJUNCTION WITH OTHER TRAFFIC CONTROL THAT ALREADY INCLUDES A ROAD CONSTRUCTION AHEAD SIGN.
- ARTERIAL ROAD CONSTRUCTION AHEAD SIGNS SHALL BE INSTALLED ON THE LEFT SIDE OF TRAFFIC IF THE MEDIAN IS MORE THAN 10 FT WIDE.


ALL DIMENSIONS ARE IN INCHES (MILLIMETERS) UNLESS OTHERWISE SHOWN.

INFRASTRUCTURE DRAWN VW REVISED ENGINEERING LINCORPO HECKED ACL REVISED 1 South Wacker | Suite 2650 | Chicago, IL 60606 PLOT DATE = 11/14/2023 REVISED DATE 10/06/2023

STATE OF ILLINOIS **DEPARTMENT OF TRANSPORTATION**

DISTRICT ONE	– ENTRANG	E AND	EXIT R	АМР	CLOSURE	DETAILS	(TC-08)	F.A.I. RTE	SECT	ПОИ	COUNTY	TOTAL SHEETS	SHEET NO.	
								94	2020-1	166-BR	COOK	39	32A	
											CONTRACT	NO. 62	2M52	
SCALE:	SHEET	OF	SHEETS	STA.		TO STA.				ILLINOIS FED. A	D PROJECT			

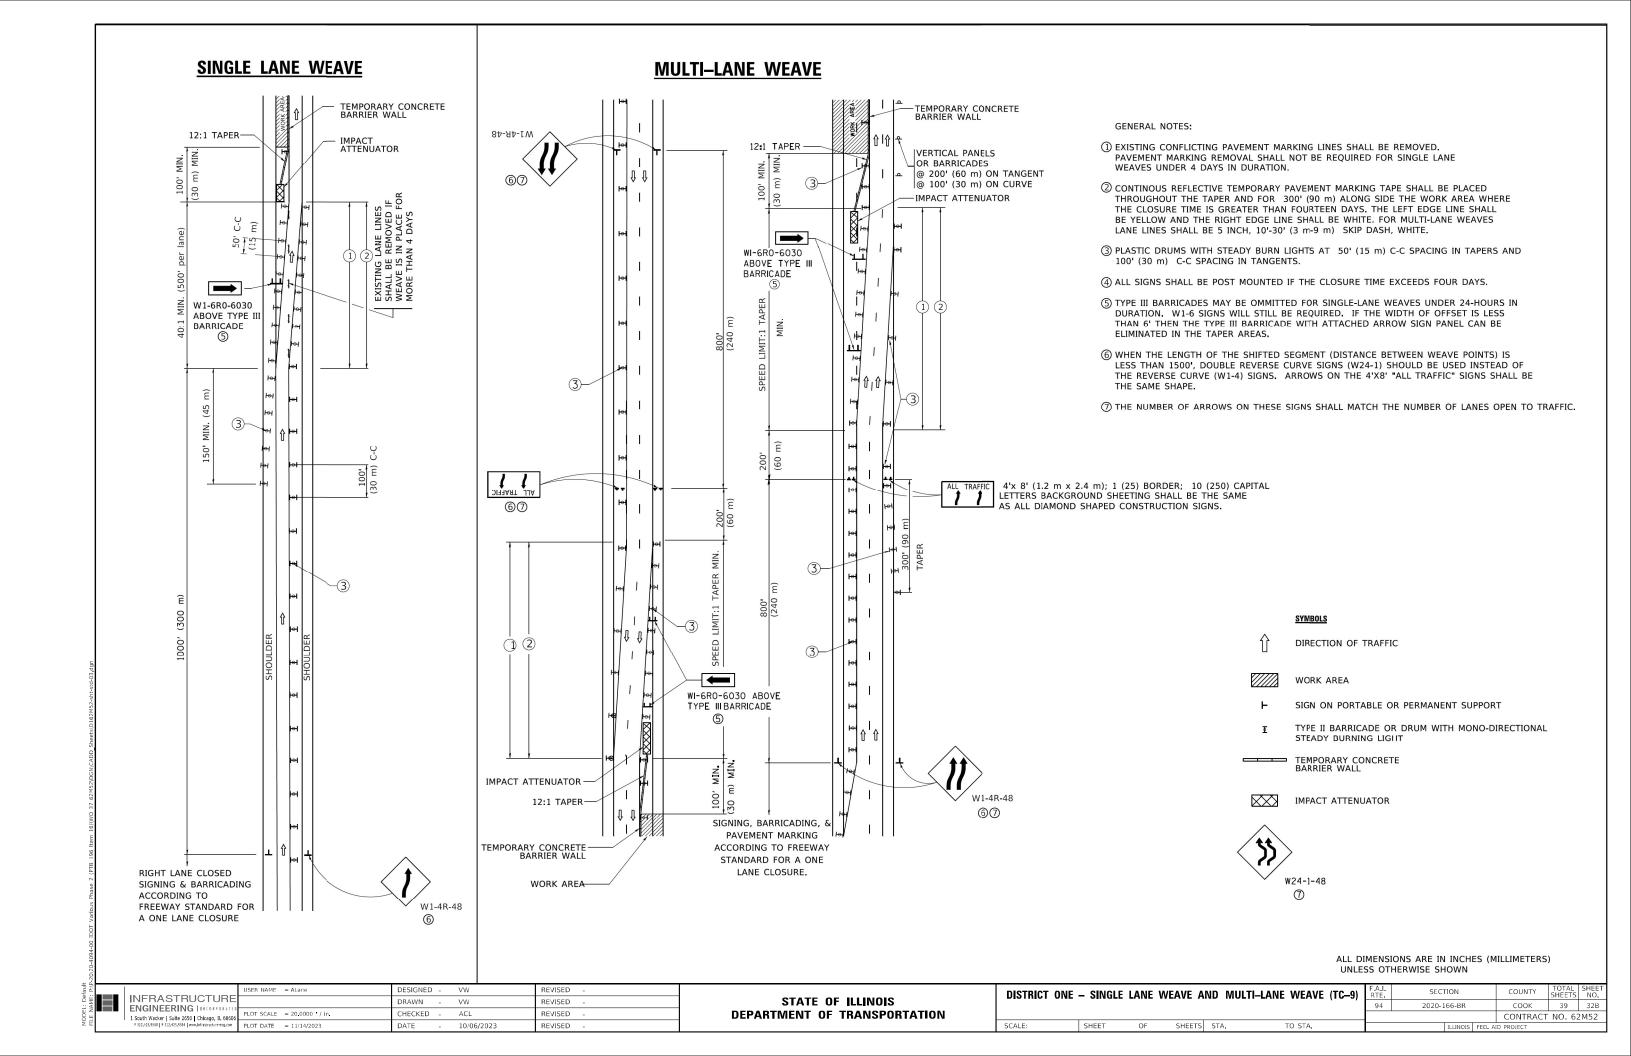

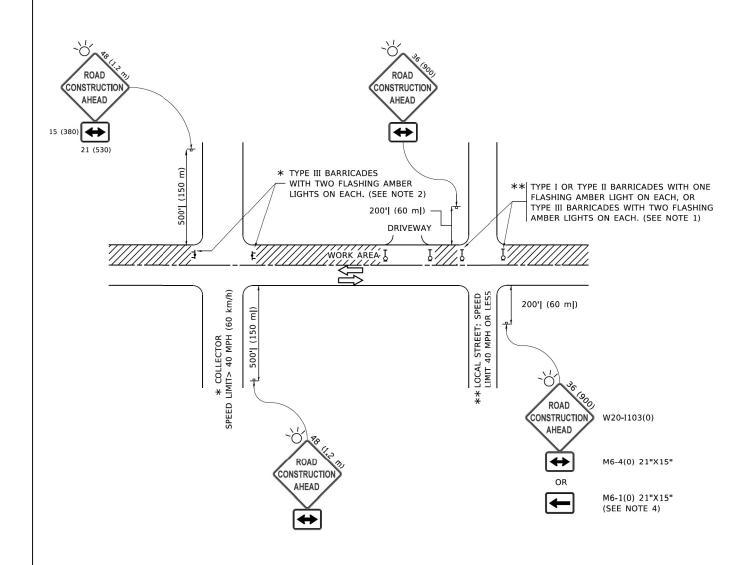

NOTES:

- 1. SIDE ROAD WITH A SPEED LIMIT OF 40 MPH (60 km/h) OR LESS AS SHOWN ON THE DRAWING AND AS DIRECTED BY THE ENGINEER:
- a) ONE "ROAD CONSTRUCTION AHEAD" SIGN 36 x 36 (900x900) WITH A FLASHER MOUNTED ON IT APPROXIMATELY 200' (60 m) IN ADVANCE OF THE MAIN ROUTE.
- b) THE CLOSED PORTION OF THE MAIN ROUTE SHALL BE PROTECTED BY BLOCKING WITH TYPE I, TYPE II OR TYPE III BARRICADES, 1/3 OF THE CROSS SECTION OF THE CLOSED PORTION.
- SIDE ROAD WITH A SPEED LIMIT GREATER THAN 40 MPH (60 km/h) AS SHOWN ON THE DRAWING AND AS DIRECTED BY THE ENGINEER:
- a) ONE "ROAD CONSTRUCTION AHEAD" SIGN 48 x 48 (1.2 m x 1.2 m) WITH A FLASHER MOUNTED ON IT APPROXIMATELY 500' (150 m) IN ADVANCE OF THE MAIN POLITE
- THE CLOSED PORTION OF THE MAIN ROUTE SHALL BE PROTECTED BY
 b) BLOCKING WITH TYPE III BARRICADES, 1/2 OF THE CROSS SECTION
 OF THE CLOSED PORTION.
- 3. CONES MAY BE SUBSTITUTED FOR BARRICADES OR DRUMS AT HALF THE SPACING DURING DAY OPERATIONS. CONES SHALL BE A MINIMUM OF 28 (710)
- WHEN THE SIDE ROAD LIES BETWEEN THE BEGINNING OF THE MAINLINE
 4. SIGNING AND THE WORK ZONE, A SINGLE HEADED ARROW (M6-1) SHALL
 BE USED IN LIEU OF THE DOUBLE HEADED ARROW (M6-4).

SCALE:

- 5. WHEN WORK IS BEING PERFORMED ON A SIDE ROAD OR DRIVEWAY, FOLLOW THE APPLICABLE STANDARD(S). THE DIRECTIONAL ARROW (M6-1 OR M6-4) SHALL BE COVERED OR REMOVED WHEN NO LONGER CONSISTENT WITH THE TRAFFIC CONTROL SET-UP.
- 6. ADVANCE WARNING SIGNS ARE TO BE OMITTED ON DRIVEWAYS UNLESS OTHERWISE SPECIFIED IN THE PLANS OR BY THE ENGINEER
- 7. THE TRAFFIC CONTROL AND PROTECTION FOR SIDE ROADS, INTERSECTIONS, AND DRIVEWAYS SHALL BE INCLUDED IN THE COST OF SPECIFIED TRAFFIC CONTROL STANDARDS OR ITEMS.


All dimensions are in inches (millimeters) unless otherwise shown.


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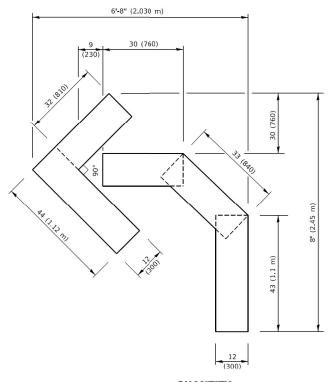
	USER NAME = ALane	DESIGNED - VW	REVISED -
ASTRUCTURE		DRAWN - VW	REVISED -
cker Suite 2650 Chicago, IL 60606		CHECKED - ACL	REVISED -
	PLOT DATE = 10/6/2023	DATE - 10/06/2023	REVISED -

 				ROTECTION FOR WAYS (TC-10)
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F.A.I. RTE	SECTION	COUNTY	TOTAL SHEETS	SHE	
94	2020-166-BR		СООК	39	33
			CONTRACT	NO. 62	2M52
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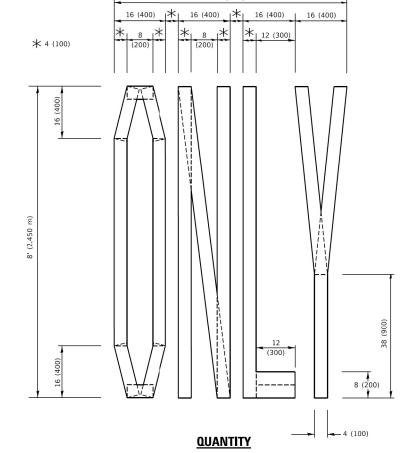




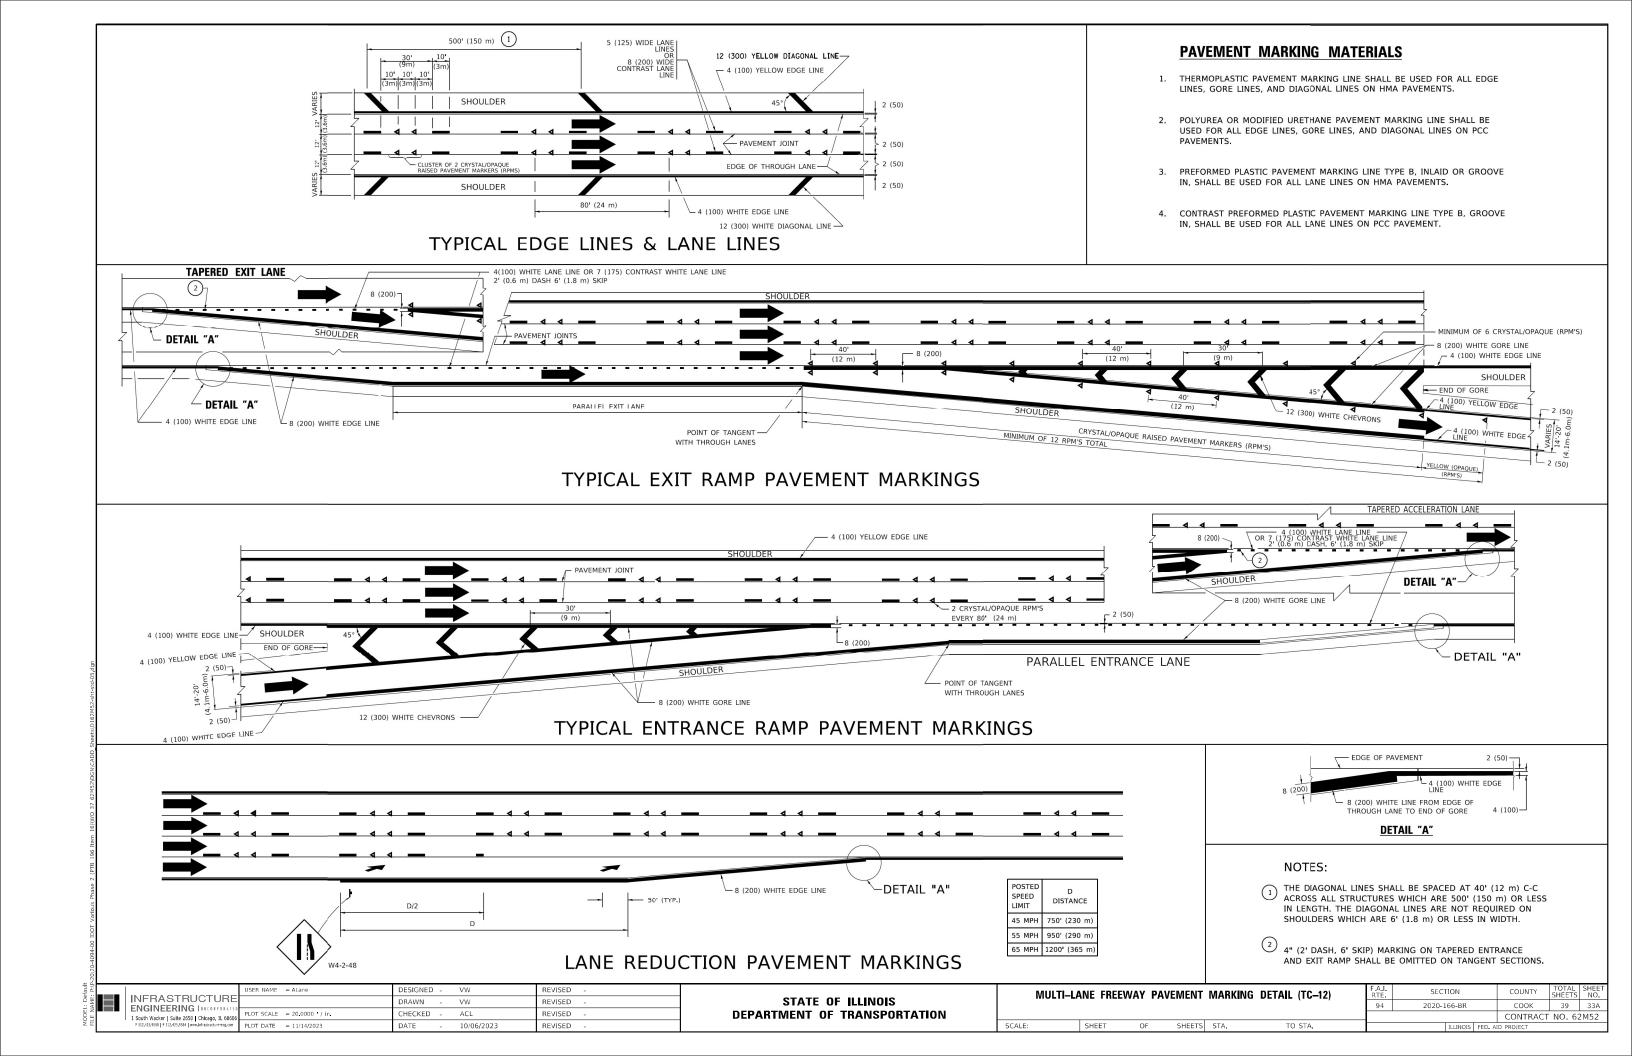


QUANTITY

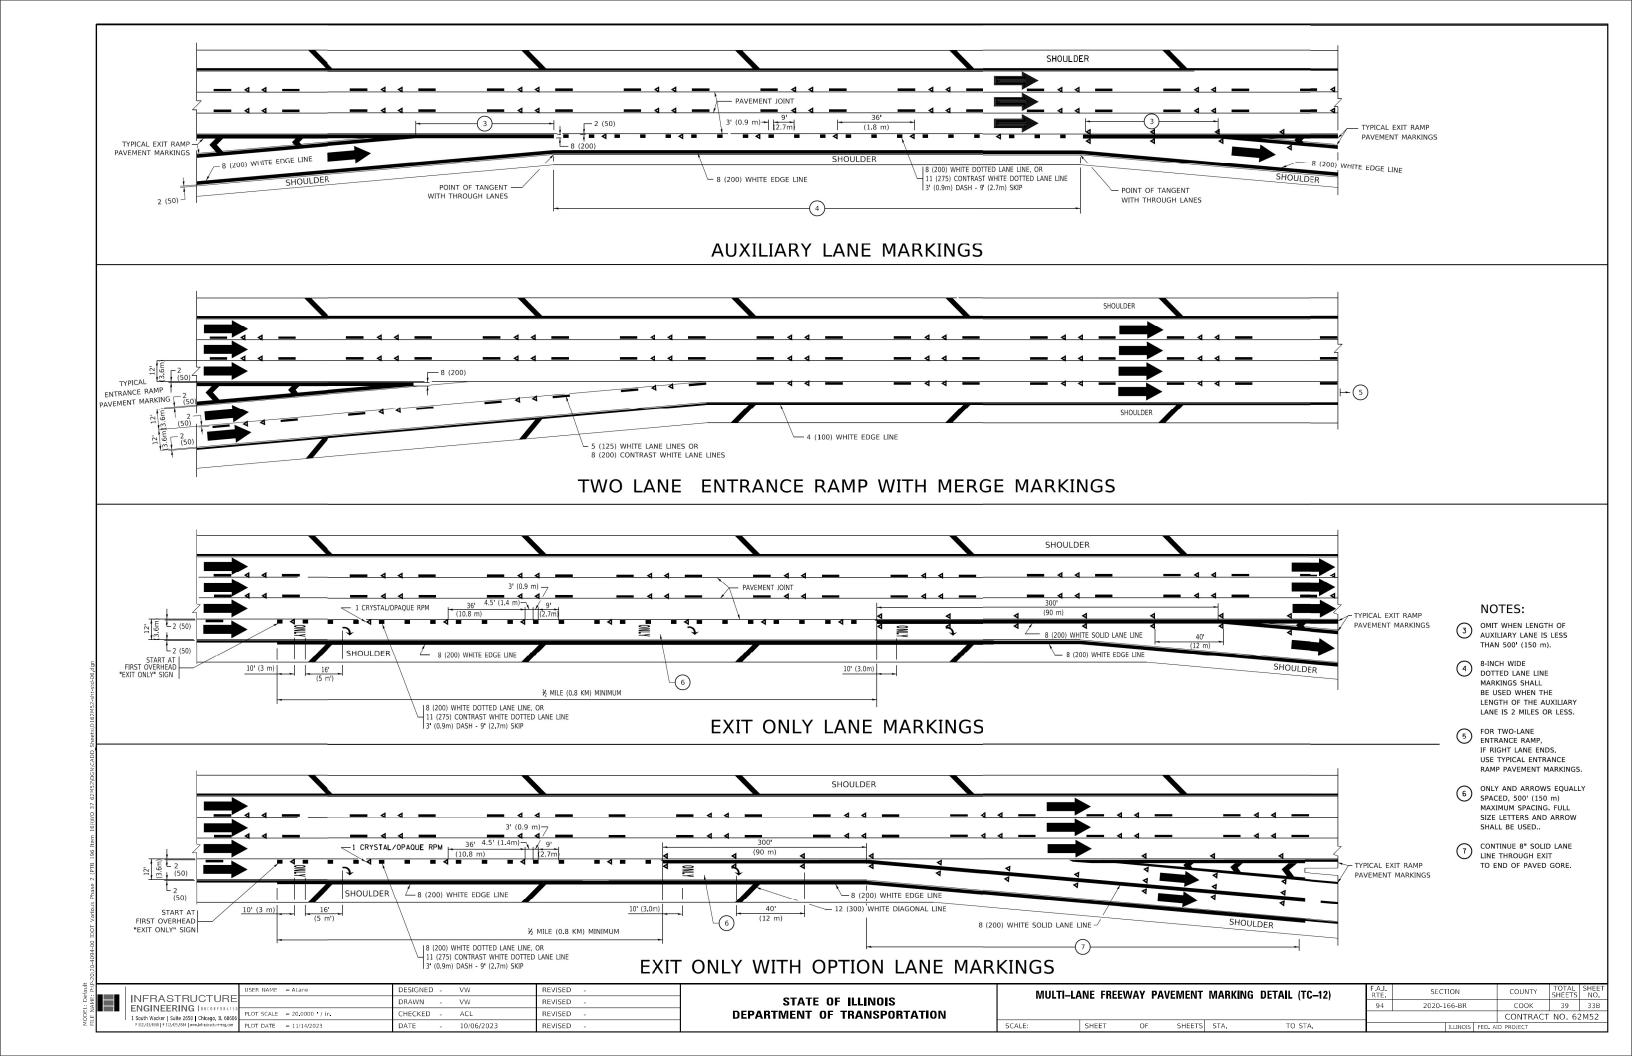4 (100) LINE = 45.5 ft. (13.9 m) 15.2 sq. ft. (1.41 sq. m)



4 (100) LINE = 64.1 ft. (19.5 m) 21.4 sq. ft. (1.99 sq. m)

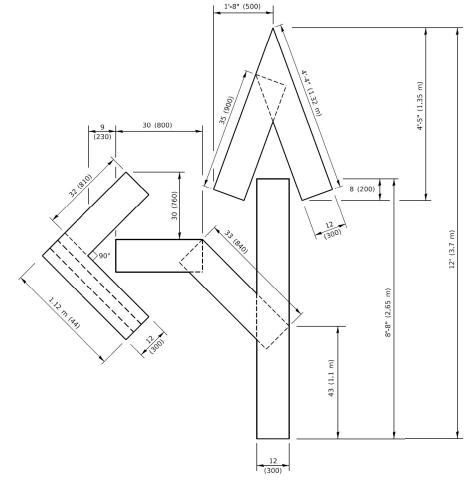


QUANTITY

4 (100) LINE = 82.5 ft. (25.1 m) 27.5 sq. ft. (2.53 sq. m)

NOTE:

ALL QUANTITIES OF PLACEMENT ARE REPRESENTED IN LINEAR FEET OF 4" LINES TO MATCH THE 4" TEMPORARY TAPE PAY ITEM AND REPRESENTS THE TOTAL QUANTITY OF 4" TAPE REQUIRED.

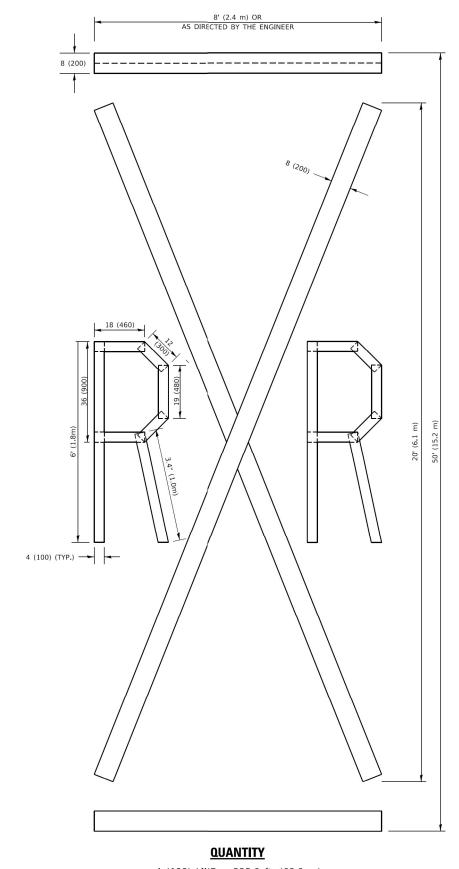

4 (100) LINE = 225.9 ft. (68.9 m) 75.3 sq. ft. (6.99 sq. m)


> All dimensions are in inches (millimeters) unless otherwise shown.


DESIGNED - VW REVISED INFRASTRUCTURE ENGINEERING INCORPORATED DRAWN -VW REVISED CHECKED -ACL REVISED 1 South Wacker | Suite 2650 | Chicago, IL 60606 PLOT DATE = 10/6/2023 REVISED DATE 10/06/2023


STATE OF ILLINOIS **DEPARTMENT OF TRANSPORTATION**

SECTION 2020-166-BR

DISTRICT ONE - SHORT TERM PAVEMENT MARKING 94 COOK 39 34 LETTERS AND SYMBOLS (TC-16) CONTRACT NO. 62M52 SCALE: OF SHEETS STA. TO STA.

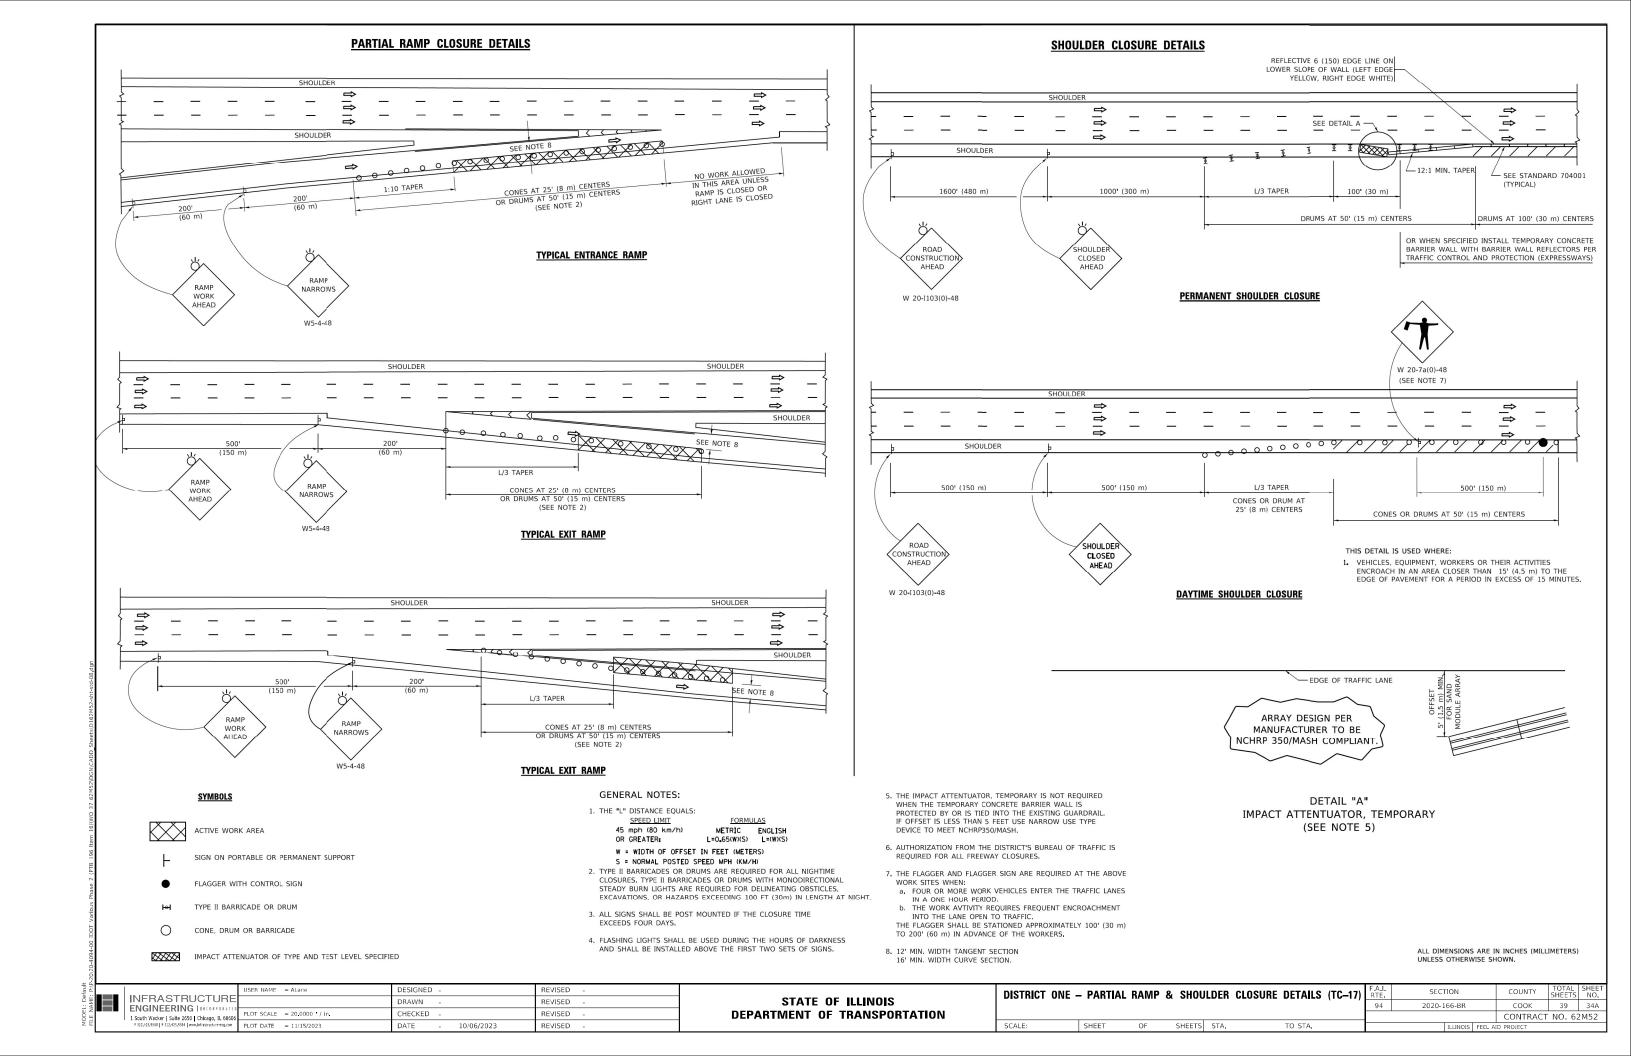

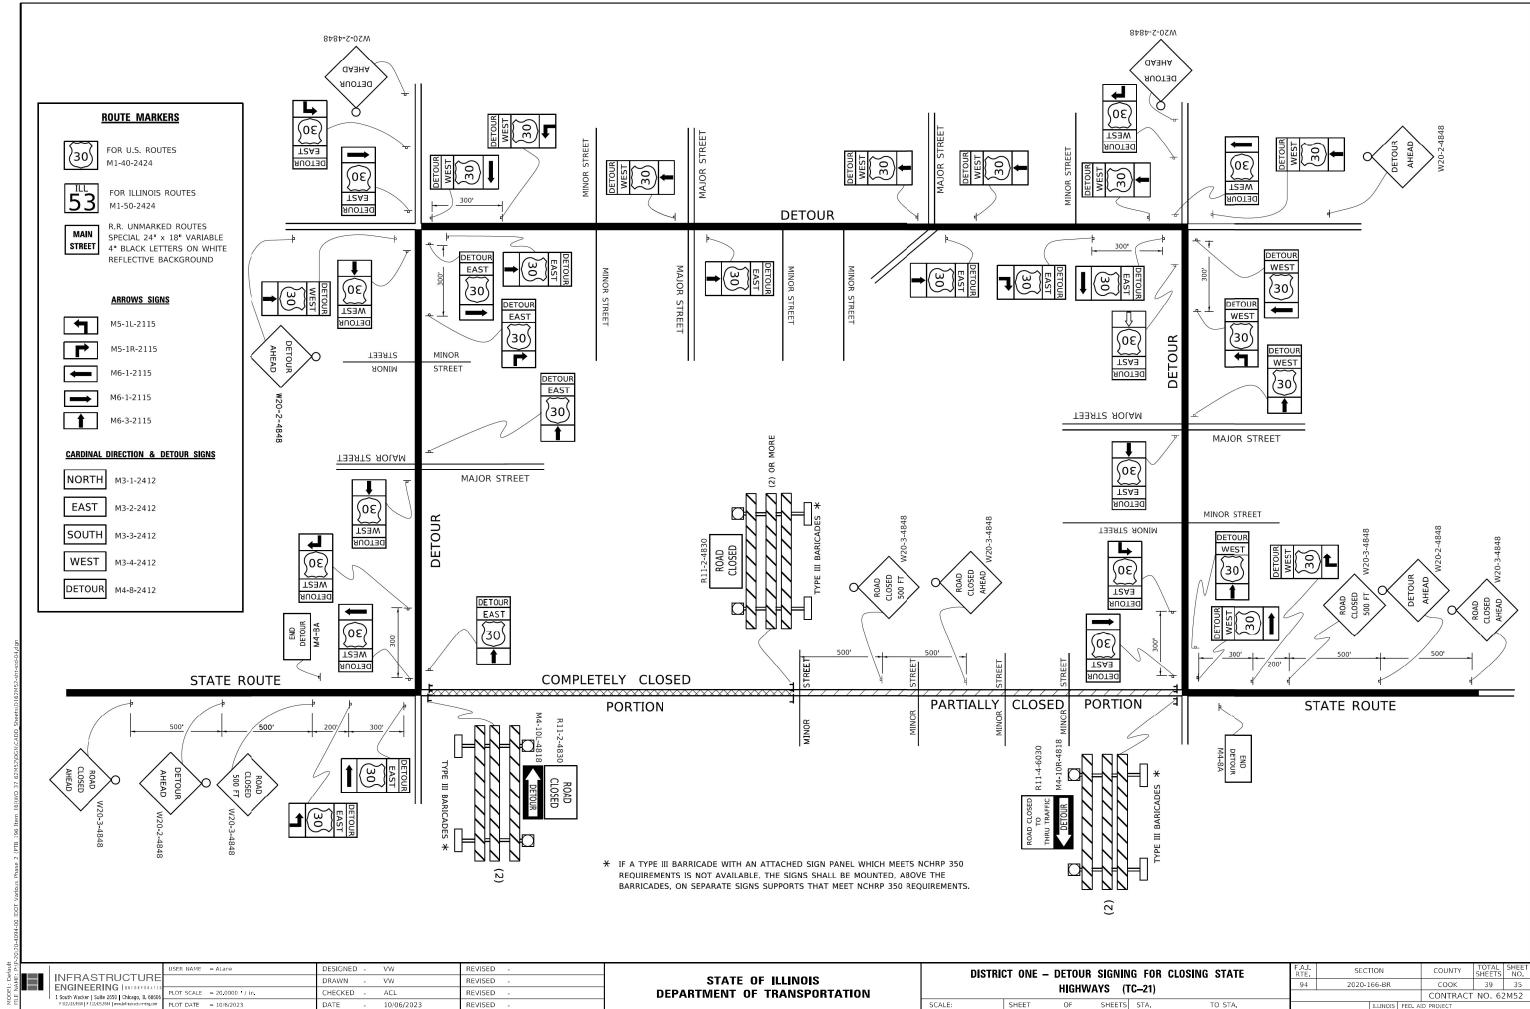

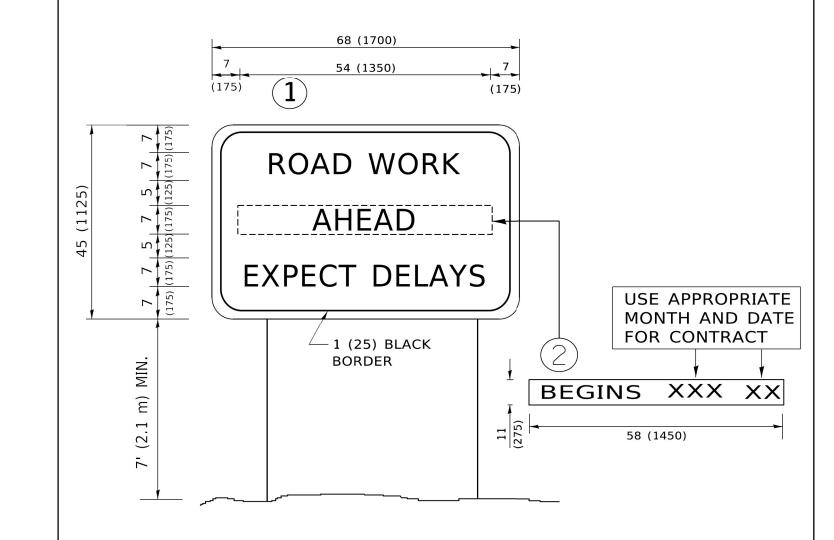

NOTES:

- 1. USE BLACK LETTERING ON ORANGE BACKGROUND.
- 2. ERECT SIGNS IN ADVANCE OF THE LOCATION FOR THE "ROAD CONSTRUCTION AHEAD" SIGN AT LOCATIONS AS DIRECTED BY THE ENGINEER.
- 3. ERECT SIGN 1 WITH INSTALLED PANEL 2 ONE WEEK PRIOR TO THE START OF CONSTRUCTION.
- 4. REMOVE PANEL 2 SOON AFTER THE START OF CONSTRUCTION.
- 5. SEE SPECIAL PROVISION FOR "TEMPORARY INFORMATION SIGNING" FOR ADDITIONAL INFORMATION.
- 6. ONE SIGN ASSEMBLY EQUALS 25.70 SQ. FT. (2.3 SQ. M.)

SCALE:

7. SHALL BE PAID FOR AS TEMPORARY INFORMATION SIGNING.


ALL DIMENSIONS ARE IN INCHES (MILLIMETERS) UNLESS OTHERWISE SHOWN.


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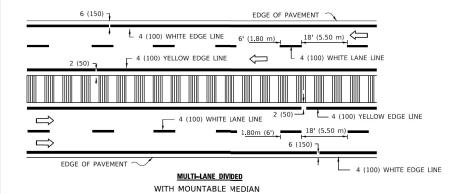
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INFRASTRUCTURE ENGINEERING INCORPORATED 1 South Wacker Suite 2650 Chicago, IL 60606 7312-425,9590 F312-425,9594 www.lnfraszructure-tog.com		DRAWN - VW	REVISED -
		CHECKED - ACL	REVISED -
		DATE - 10/06/2023	REVISED -

DISTRICT (ONE –	ARTERIAL	ROAD	INFORMATION	SIGN	(TC-22)	
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RTE	SECTION			COUNTY	SHEETS	NO.
94	2020-1	166-BR		СООК	39	36
·			CONTRACT	NO. 62	2M52	
		ILLINOIS	FED. A	ID PROJECT		







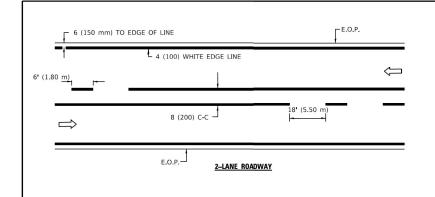

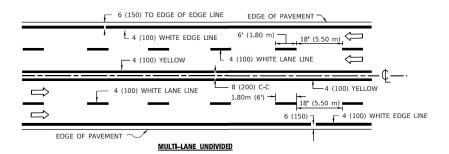TYPICAL LANE AND EDGE LINE MARKING

NOTE: MEDIANS WITH BARRIER CURB DO NOT REQUIRE AN EDGE LINE

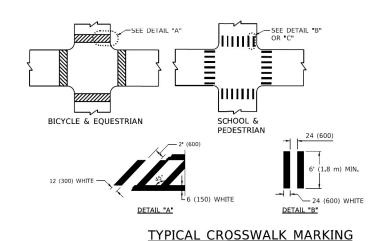


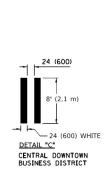


2-4 (100) @ 8 (200) C-C (MINIMUM 5)

- * FOR MEDIAN LENGTHS WHERE DIAGONAL SPACING CANNOT BE ATTAINED, USE 5 (FIVE) EQUALLY SPACED DIAGONAL LINES.
- * DIAGONAL LINE SPACING: 20' (6.1 m) C-C

PAINTED MEDIANS

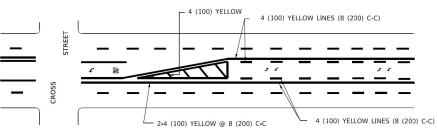


A MINIMUM OF TWO PAIRS OF TURN ARROWS SHALL BE USED, WHITE IN COLOR, ADDITIONAL PAIRS SHALL BE PLACED AT 200' (60 m) TO 300' (90 m) INTERVALS.

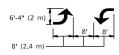

MEDIAN WITH TWO-WAY LEFT TURN LANE

TYPICAL PAINTED MEDIAN MARKING

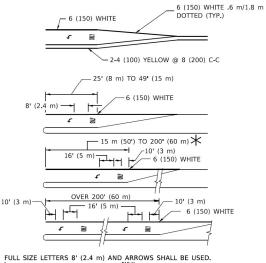


THE POLL SIZE LETTERS 8' (2.4 m) AND ARROWS SHALL BE USED.

AREA = 15.8 SQ. FT. (1.47 m²) ONLY AREA = 22.9 SQ. FT. (2.13 m²)

* TURN LANES IN EXCESS OF 400' (120 m) IN LENGTH MAY HAVE AN ADDITIONAL SET OF ARROW - "ONLY" INSTALLED MIDWAY BETWEEN THE OTHER TWO SETS OF ARROW - "ONLY".

TYPICAL LEFT (OR RIGHT) TURN LANE

TYPICAL TURN LANE MARKING

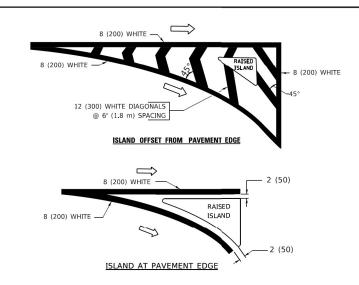

TYPICAL ISLAND MARKING

TYPE OF MARKING	WIDTH OF LINE	PATTERN	COLOR	SPACING / REMARKS
CENTERLINE ON 2 LANE PAVEMENT	4 (100)	SKIP-DASH	YELLOW	6' (1.80 m) LINE WITH 18' (5.50 m) SPACE
CENTERLINE ON MULTI-LANE UNDIVIDED PAVEMENT	2 @ 4 (100)	SOLID	YELLOW	8 (200) C-C
NO PASSING ZONE LINES: FOR ONE DIRECTION FOR BOTH DIRECTIONS	4 (100) 2 @ 4 (100)	SOLID SOLID	YELLOW YELLOW	8 (200) C-C
LANE LINES	4 (100) 5 (125) ON FREEWAYS	SKIP-DASH SKIP-DASH	WHITE WHITE	6' (1.80 m) LINE WITH 18' (5.50 m) SPACE
DOTTED LINES (EXTENSIONS OF CENTER, LANE OR TURN LANE MARKINGS)	SAME AS LINE BEING EXTENDED	SKIP-DASH	SAME AS LINE BEING EXTENDED	2' (600) LINE WITH 6' (1.8) SPACE
EDGE LINES	4 (100)	SOLID	YELLOW-LEFT WHITE-RIGHT	OUTLINE MOUNTABLE MEDIANS IN YELLOW; EDGE LINES ARE NOT USED NEXT TO BARRIER CURB
TURN LANE MARKINGS	6 (150) LINE; FULL SIZE LETTERS & SYMBOLS (8' (2.4 m))	SOLID	WHITE	SEE TYPICAL TURN LANE MARKING DETAIL
TWO WAY LEFT TURN MARKING	2 @ 4 (100) EACH DIRECTION	SKIP-DASH AND SOLID	YELLOW	6' (1.8 m) LINE WITH 18' (5.50 m) SPACE FOR SKIP-DASH; 8 (200) C-C BETWEEN SOLID LINE AND SKIP-DASH LINE
	8' (2.4 m) LEFT ARROW	IN PAIRS	WHITE	SEE TYPICAL TWO-WAY LEFT TURN MARKING DETAIL
CROSSWALK LINES A. DIAGONALS (BIKE & EQUESTRIAN) B. LONGITUDINAL BARS (SCHOOL & PEDESTRIAN)	12 (300) @ 45° 24 (600) @ 90°	SOLID SOLID	WHITE WHITE	2' (600) APART 2' (600) APART SEE TYPICAL CROSSWALK MARKING DETAILS.
STOP LINES	24 (600)	SOLID	WHITE	PLACE 4' (1.2 m) IN ADVANCE OF AND PARALLEL TO CROSSWALK, IF PRESENT. OTHERWISE, PLACE AT DESIRED STOPPING POINT. PARALLEL TO CROSSROAD CENTERLINE, WHERE POSSIBLE
PAINTED MEDIANS	2 @ 4 (100) WITH 12 (300) DIAGONALS @ 45°	SOLID	YELLOW: TWO WAY TRAFFIC WHITE: ONE WAY TRAFFIC	8 (200) C-C FOR THE DOUBLE LINE SEE TYPICAL PAINTED MEDIAN MARKING.
GORE MARKING AND CHANNELIZING LINES	8 (200) WITH 12 (300) DIAGONALS @ 45°	SOLID	WHITE	DIAGONALS: 20' (6.1 m) (LESS THAN 30 MPH (50 km/h))
RAILROAD CROSSING	24 (600) TRANSVERSE LINES; "RR" IS 6' (1.8 m) LETTERS; 16 (400) LINE FOR "X"	SOLID	WHITE	SEE STATE STANDARD 780001 AREA OF: "R"=3.6 SQ, FT. (0.33m²) EACH "X"=54.0 SQ, FT. (5.0 m²)

FOR FURTHER DETAILS ON PAVEMENT MARKING REFER TO STREET MARKING STANDARDS, PRINTED BY CITY OF CHICAGO, DEPARTMENT OF TRANSPORTATION, BUREAU OF TRAFFIC.


SCALE:


ALL DIMENSIONS ARE IN INCHES (MILLIMETERS) UNLESS OTHERWISE SHOWN.

INFRASTRUCTURE ENGINEERING 18 CORPORATED 1 South Wacker Suite 2550 Chicago, IL 60606 P 312, 235, 5560 F 312, 255, 5564 www.lafraerartur-eng.com	USER NAME = ALane	DESIGNED -	VW	REVISED	-	
		DRAWN -	VW	REVISED	-	
		CHECKED -	ACL	REVISED	-	
			DATE -	10/06/2023	REVISED	-

STATE OF ILLINOIS
DEPARTMENT OF TRANSPORTATION

DISTRICT ONE - CITY OF CHICAGO TYPICAL		F.A.I. RTE	SECTION	COUNTY	TOTAL SHEETS	SHEET NO.
PAVEMENT MARKINGS (TC-24)			2020-166-BR	соок	39	37
TAVEIVIENT INFANKINGO (10-24)				CONTRACT	NO. 62	2M52
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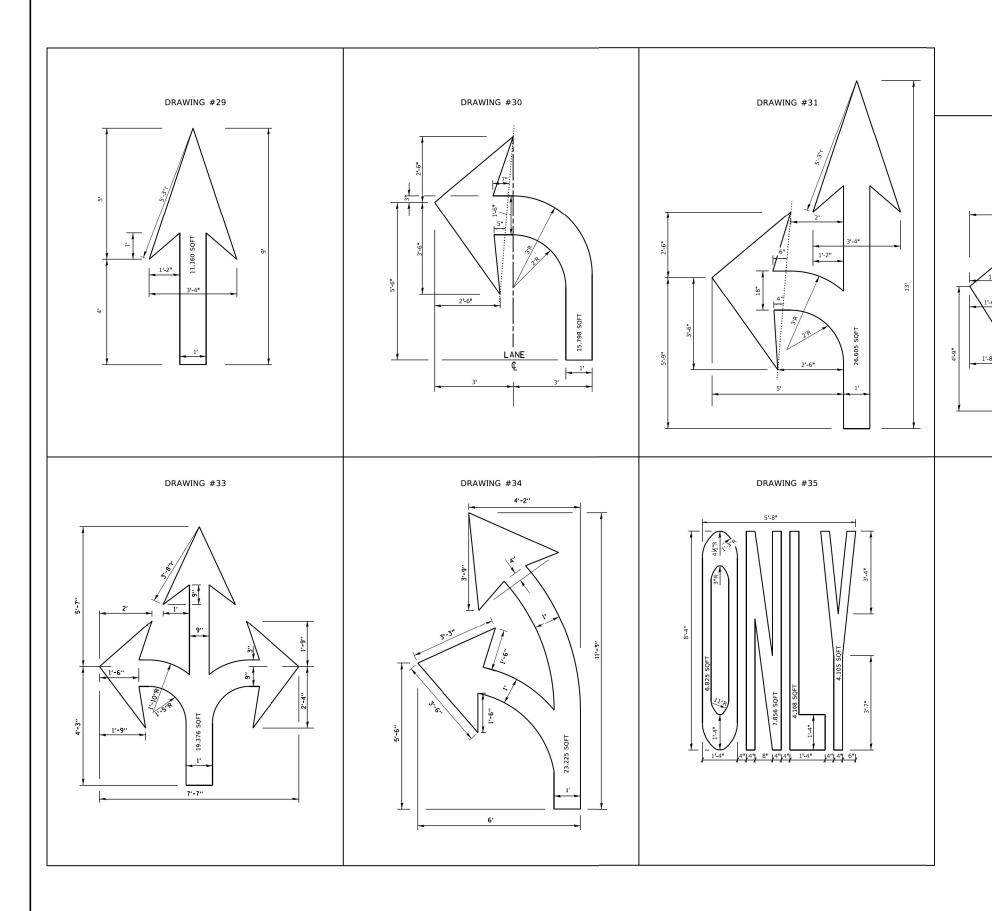


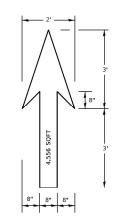

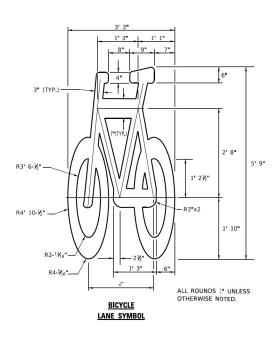NOTE:

- 1. FOR BIKE LANE SYMBOLS ONLY, USE PRE-FORMED THERMOPLASTIC WITH A MINIMUM THICKNESS OF 90 MILS, MINIMUM SKID RESISTANCE VALUE OF 60 BPN, & A MINIMUM INDEX OF REFRACTION OF 1.50.
- 2. THE RESIDENT ENGINEER SHALL CONTACT MR. BEN GOMBERG AT 312-744-8093 AT LEAST ONE CALENDAR WEEK PRIOR TO INSTALLING BIKE LANE SYMBOLS.

TYPICAL BIKE LANE SYMBOLS DRAWING #28



INFRASTRUCTURE 1 South Wacker | Suite 2650 | Chicago, IL 60606

DESIGNED -VW REVISED DRAWN -VW REVISED CHECKED -ACL REVISED PLOT DATE = 10/6/2023 DATE REVISED 10/06/2023

STATE OF ILLINOIS **DEPARTMENT OF TRANSPORTATION**

ı			CITY OF Markin		
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SCALE:

F.A.I. RTE	SEC	SECTION			COUNTY	TOTAL SHEETS	SHEET NO.
94	2020-166-BR				соок	39	38
					CONTRACT	NO. 62	2M52
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DRAWING #32

NOTE:

PLANS

ALL MARKINGS SHALL BE SOLID WHITE UNLESS OTHERWISE NOTED IN THE

