ITEM NO: 16A

IDOT LETTING: JANUARY 19, 2024

CONSTRUCTION PLANS

RECONSTRUCT WEST AIRCRAFT T-HANGAR AREA PAVEMENTS


COLES COUNTY AIRPORT AUTHORITY
COLES COUNTY MEMORIAL AIRPORT (MTO)
MATTOON-CHARLESTON, COLES COUNTY, ILLINOIS

IDA PROJECT NO. MTO-4816 SBG PROJECT NO. N/A


NOVEMBER 17, 2023 (100% SUBMITTAL)




THESE CONSTRUCTION PLANS RELY UPON THE SPECIAL PROVISIONS AND THE SPECIFICATIONS TO PROVIDE FOR A COMPLETE DESCRIPTION OF THE WORK AND CONSTRUCTION REQUIREMENTS. THE PLANS SHALL ONLY BE USED IN COMBINATION WITH ALL CONTRACT DOCUMENTS.

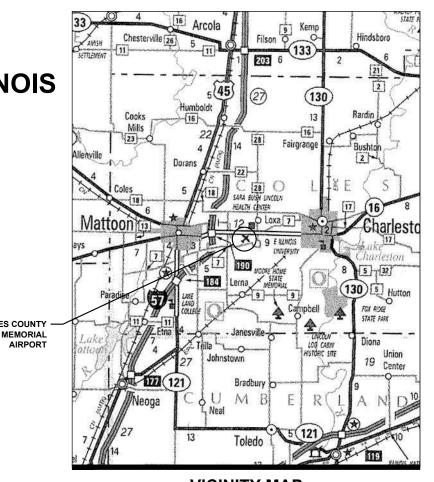



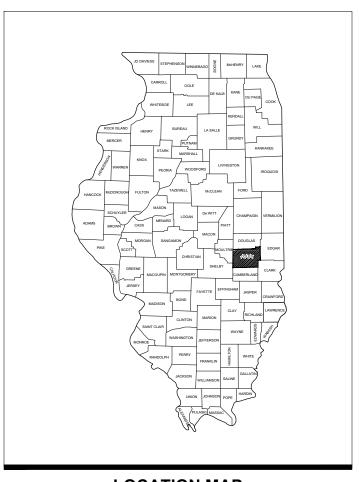

LOCATION MAP

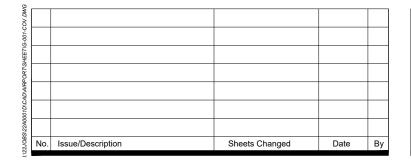





COLES COUNTY AIRPORT	COLES COUNTY MEMORIAL AIRPORT			
COLES COUNTY AIRPORT AUTHORITY COUNTY NUMBERORY	COLES COUNTY AIRPORT AUHORITY 432 Airport Road Mattoon, Illinois 61938 Telephone: 217.234.7120 Fax: 217.234.7116			
Andrew Fearn Airpon Manager	NOVEMBER 17, 2023 Date			

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57	ARC FLASH RISK LABELS SHEET 1
J1	ANO I LAGITINON LABLES STILL I

ITEM NO.	DESCRIPTION	UNIT	TOTAL QUANTITY	AS-BUILT QUANTITY
AR106905	REMOVE LIGHT POLE & FIXTURE	EACH	12	
AR115610	ELECTRICAL HANDHOLE	EACH	2	
AR150510	ENGINEER'S FIELD OFFICE	L SUM	1	
AR150520	MOBILIZATION	L SUM	1	
AR150530	TRAFFIC MAINTENANCE	L SUM	1	
AR152410	UNCLASSIFIED EXCAVATION	CU YD	986	
AR152480	SHOULDER ADJUSTMENT	SQ YD	1288	
AR152540	SOIL STABILIZATION FABRIC	SQ YD	8751	
AR154606	GRANULAR DRAINAGE SUBBASE-6"	SQ YD	2332	
AR156510	SILT FENCE	FOOT	570	
AR156520	INLET PROTECTION	EACH	4	
AR162508	CLASS E FENCE 8'	FOOT	42	
AR162606	CLASS E GATE-6'	EACH	1	
AR162728	ELECTRIC GATE-28'	EACH	2	
AR162900	REMOVE CLASS E FENCE	FOOT	57	
AR162908	REMOVE ELECTRIC GATE	EACH	2	
AR162910	REMOVE CLASS E GATE	EACH	1	
AR201670	CRACK CONTROL FABRIC	SQ YD	117	
AR209606	CRUSHED AGG. BASE COURSE-6"	SQ YD	6419	
AR401613	BIT. SURF. CSEMETHOD I, SUPERPAVE	TON	915	
AR401660	SAW & SEAL BIT. JOINTS	FOOT	1990	
AR401900	REMOVE BITUMINOUS PAVEMENT	SQ YD	8593	
AR401916	REM & REP BIT PAVEMENT-TYPE B	SQ YD	94	
AR403613	BIT. BASE CSEMETHOD I, SUPERPAVE	TON	915	
AR501506	6" PCC PAVEMENT	SQ YD	1543	
AR501530	PCC TEST BATCH	EACH	1	
AR501605	5" PCC SIDEWALK	SQ FT	6640	
AR501690	PCC SIDEWALK REMOVAL	SQ FT	136	
AR602510	BITUMINOUS PRIME COAT	GALLON	1910	
AR603510	BITUMINOUS TACK COAT	GALLON	955	
AR620520	PAVEMENT MARKING-WATERBORNE	SQ FT	1084	
AR620525	PAVEMENT MARKING-BLACK BORDER	SQ FT	1084	
AR701012	12" PVC STORM SEWER	FOOT	44	
AR705506	6" PERFORATED UNDERDRAIN	FOOT	855	
AR705640	UNDERDRAIN CLEANOUT	EACH	4	
AR751001	TRENCH DRAIN	FOOT	160	
AR800527	APRON LIGHTING SYSTEM	L SUM	1	
AR800928	GRANULAR DRAINAGE SUBBASE-4"	SQ YD	6419	
AR800967	REMOVE PIPE AND STRUCTURES	L SUM	1	
AR901510	SEEDING	ACRE	0.27	
AR908510	MULCHING	ACRE	0.27	
AR910410	PARKING BLOCK	EACH	3	
AR910415	REMOVE PARKING BLOCK	EACH	3	

SUMMARY OF QUANTITIES - ADD ALT 1						
ITEM NO.	DESCRIPTION	UNIT	TOTAL QUANTITY	AS-BUILT QUANTITY		
AS401613	BIT. SURF. CSEMETHOD I, SUPERPAVE	TON	300			
AS401650	BITUMINOUS PAVEMENT MILLING	SQ YD	2,087			
AS401660	SAW AND SEAL BIT. JOINTS	FOOT	358			
AS603510	BITUMINOUS TACK COAT	GALLON	313			

SUMMARY OF QUANTITIES - ADD ALT 2						
ITEM NO.	DESCRIPTION	UNIT	TOTAL QUANTITY	AS-BUILT QUANTITY		
AT152480	SHOULDER ADJUSTMENT	SQ YD	295			
AT156510	SILT FENCE	FOOT	217			
AT156520	INLET PROTECTION	EACH	3			
AT401613	BIT. SURF. CSEMETHOD I, SUPERPAVE	TON	648			
AT401650	BITUMINOUS PAVEMENT MILLING	SQ YD	4,503			
AT401660	SAW AND SEAL BIT. JOINTS	FOOT	583			
AT603510	BITUMINOUS TACK COAT	GALLON	676			
AT620520	PAVEMENT MARKING-WATERBORNE	SQ FT	930			
AT620525	PAVEMENT MARKING-BLACK BORDER	SQ FT	930			
AT901510	SEEDING	ACRE	0.06			
AT908510	MULCHING	ACRE	0.06			

UTILITY NOTE

THE LOCATION, SIZE, AND TYPE OF MATERIAL OF EXISTING UNDERGROUND AND/OR ABOVEGROUND UTILITIES INDICATED ON THE PLANS ARE NOT REPRESENTED AS BEING ACCURATE, SUFFICIENT OR COMPLETE. NEITHER THE OWNER NOR THE ENGINEER ASSUMES ANY RESPONSIBILITY WHATEVER IN RESPECT TO THE ACCURACY, COMPLETENESS, OR SUFFICIENCY OF THE INFORMATION. THERE IS NO GUARANTEE, EITHER EXPRESSED OR IMPLIED, THAT THE LOCATIONS, SIZE AND TYPE OF MATERIAL OF EXISTING UNDERGROUND UTILITIES INDICATED ARE REPRESENTATIVE OF THOSE TO BE ENCOUNTERED IN THE CONSTRUCTION. IT SHALL BE THE CONTRACTOR'S RESPONSIBILITY TO DETERMINE THE ACTUAL LOCATION OF ALL SUCH FACILITIES, INCLUDING SERVICE CONNECTIONS TO UNDERGROUND UTILITIES. PRIOR TO CONSTRUCTION. THE CONTRACTOR SHALL NOTIFY THE UTILITY COMPANIES OF HIS OPERATIONAL PLANS AND SHALL OBTAIN FROM THE RESPECTIVE UTILITY COMPANIES DETAILED INFORMATION AND ASSISTANCE RELATIVE TO THE LOCATION OF THEIR FACILITIES AND THE WORKING SCHEDULE OF THE COMPANIES FOR REMOVAL OR ADJUSTMENT WHERE REQUIRED. IN THE EVENT AN UNEXPECTED UTILITY INTERFERENCE IS ENCOUNTERED DURING CONSTRUCTION, THE CONTRACTOR SHALL IMMEDIATELY NOTIFY THE UTILITY COMPANY OF JURISDICTION. THE OWNER'S REPRESENTATIVE AND/OR THE RESIDENT ENGINEER SHALL ALSO BE IMMEDIATELY NOTIFIED. ANY DAMAGE TO SUCH MAINS AND SERVICES SHALL BE RESTORED TO SERVICE AT ONCE AND PAID FOR BY THE CONTRACTOR AT NO ADDITIONAL COST TO THE CONTRACT. ALL UTILITY CABLES AND LINES SHALL BE LOCATED BY THE RESPECTIVE UTILITY. CONTACT JULIE (JOINT UTILITY LOCATION INFORMATION FOR EXCAVATORS) FOR UTILITY INFORMATION, PHONE: 1-800-892-0123. CONTACT THE FAA. (FEDERAL ALVATION ADMINISTRATION) FOR ASSISTANCE IN LOCATING FAA CABLES AND UTILITIES. LOCATION OF FAAP POWER, CONTROCL, AND COMMUNICATION CABLES SHALL BE COORDINATED WITH AND/OR LOCATED BY THE FAA. ALSO CONTACT AIRPORT DIRECTOR/MANAGER AND AIRPORT PERSONNEL FOR ASSISTANCE IN LOCATING UNDERGROUND AIRPORT CABLES AND/OR UTILITIES. ALSO COORDINATE WORK WITH ALL ABOVEGROUND UTILITIES.

GENERAL NOTES

- 1. THE PROJECT PAY ITEMS ARE INTENDED TO BE INCLUSIVE OF ALL WORK TO BE PERFORMED AS SHOWN IN THESE PLANS. ALL INCIDENTAL WORK REQUIRED TO COMPLETE THE PROJECT TO THE SATISFACTION OF THE RESIDENT ENGINEER IS TO BE INCLUDED IN THE COSTS OF PERFORMING THESE ITEMS. THE CONTRACTOR SHALL FURNISH ALL LABOR, MATERIAL, EQUIPMENT, AND TRANSPORTATION NECESSARY TO CONSTRUCT ALL ELEMENTS OF THE PROJECT AS DESCRIBED IN THE CONSTRUCTION PLANS AND SPECIFICATIONS.
- 2. THE RULES, REGULATIONS, AND SPECIFICATIONS ENUMERATED HEREIN SHALL BE CONSIDERED AS MINIMUM REQUIREMENTS. THEY SHALL NOT PROHIBIT THE CONTRACTOR FROM FURNISHING AND INSTALLING HIGHER GRADES OF MATERIAL THAN ARE SPECIFIED HEREIN, IF APPROVED BY THE ENGINEER.
- ACCESS TO THE SITE SHALL BE RESTRICTED EXCLUSIVELY TO THE DESIGNATED CONSTRUCTION ENTRANCE, STAGING AREA, AND HAUL ROUTE. NO EQUIPMENT OR PERSONNEL SHALL BE PERMITTED OUTSIDE THE GENERAL PROJECT AREA.
- 4. IT SHALL BE THE RESPONSIBILITY OF THE CONTRACTOR TO PROTECT AND KEEP CLEAN OF DEBRIS ALL EXISTING AIRFIELD AND ROADWAY PAVEMENTS AT ALL TIMES. ANY DAMAGE TO EXISTING ELECTRICAL, DRAINAGE, AND PAVEMENT STRUCTURES SHALL BE IMMEDIATELY REPAIRED AT NO ADDITIONAL COST TO THE CONTRACT.
- 5. CONTRACTOR IS REQUIRED TO PROVIDE THEIR OWN RESTROOM FACILITIES.
- THE LOCATION OF THE ENGINEER'S FIELD OFFICE WILL BE DETERMINED AT THE PRE-CONSTRUCTION MEETING.
- THE OWNER SHALL HAVE THE RIGHT OF FIRST REFUSAL FOR ALL SALVAGEABLE MATERIAL REMOVED ON THE PROJECT.
- B. THE CONTRACTOR SHALL BE RESPONSIBLE FOR OBTAINING PERMITS FOR HAULING ON PUBLIC ROADS, AS APPLICABLE. THE CONTRACTOR SHALL BE RESPONSIBLE FOR CORRECTING ANY DAMAGES TO ANY PAVEMENTS (PUBLIC OR PRIVATE) CAUSED BY HIS/HER CONSTRUCTION EQUIPMENT OR PERSONNEI
- THE CONTRACTOR SHALL PROVIDE ONE SET OF PRELIMINARY REDLINED RECORD DRAWINGS TO THE RESIDENT ENGINEER AT THE COMPLETION OF THE PROJECT FOR INCORPORATION INTO THE OFFICIAL RECORD DRAWINGS HE WILL PREPARE.
- 10. APPROXIMATE LOCATIONS OF UNDERGROUND UTILITIES ARE SHOWN THROUGHOUT THESE PLANS. THE CONTRACTOR SHALL DETERMINE EXACT LOCATIONS AND PROTECT THESE UTILITIES DURING CONSTRUCTION. ANY UTILITIES DAMAGED DURING CONSTRUCTION SHALL BE REPAIRED AT THE CONTRACTOR'S EXPENSE. CONTRACTOR SHALL COORDINATE WITH THE PROPER AUTHORITIES FOR THE PURPOSE OF LOCATING AND PROTECTING EXISTING UNDERGROUND UTILITIES.
- 11. NPDES PERMIT THIS PROJECT DISTURBS MORE THAN 1 ACRE, THEREFORE, AN NPDES PERMIT WILL BE REQUIRED.
- 12. MATERIAL CERTIFICATIONS MATERIALS CANNOT BE INSTALLED UNTIL ALL THE MATERIAL CERTIFICATIONS FOR THAT ITEM HAVE BEEN RECEIVED, REVIEWED AND ACCEPTED BY THE RESIDENT ENGINEER. MATERIALS INSTALLED WITHOUT APPROVAL ARE SUBJECT TO REMOVAL AND REPLACEMENT AT THE CONTRACTOR'S EXPENSE.
- 13. <u>CERTIFIED PAYROLLS</u> THE RESIDENT ENGINEER <u>CANNOT</u> FORWARD A CONSTRUCTION REPORT FOR PAYMENT TO THE IDOT-DIVISION OF AERONAUTICS FOR PROCESSING UNTIL <u>ALL</u> CERTIFIED PAYROLLS FOR THAT PERIOD HAVE BEEN RECEIVED.

J.U.L.I.E. INFORMATION

COUNTY______
CITY_____
TOWNSHIP____
SECTION NO.____
ADDRESS

COLES
MATTOON
LAFAYETTE
14,15,22,23
COLES COUNTY
MEMORIAL AIRPORT
432 AIRPORT ROAD
MATTTON, ILLINOIS
61938



Offices Nationwide www.hanson-inc.com

Hanson Professional Services Inc. 1525 S. 6th Street Springfield, IL 62568 phone: 217-788-2450 fax: 217-788-2503

Illinois Licensed Professional Service Corporation #184-001084

COLES COUNTY AIRPORT
AUTHORITY
COLES COUNTY MEMORIAL AIRPORT

RECONSTRUCT WEST AIRCRAFT T-HANGAR AREA PAVEMENTS

IDA No: MTO-4816 SBG Project No: N/A

Contract No. CO072

NO.	DATE	DES	CRIPT	ION
110.	DAIL	DES	DWN	REV
ISSUE:	11/17/20)23		
PROJEC	CT NO: 2	2A000	1D	
CAD FIL	E: G-00	2-SOC	.DWG	
DESIGN	BY: LD	H 9/4/	2023	

SUMMARY OF QUANTITIES AND SHEET INDEX

DRAWN BY: JP 9/18/2023
REVIEWED BY: LDH 10/19/23

SHEET TITLE

SCOPE OF WORK

PROJECT BASE BID CONSISTS OF FULL DEPTH PAVEMENT REMOVAL, 6" PCC FULL DEPTH PAVEMENT, 5" FULL DEPTH HMA PAVEMENT, WATERBORNE AIRFIELD MARKING, APRON LIGHTING AND ASSOCIATED ELECTRICAL WORK, INSTALLATION OF A TRENCH DRAIN AND UNDER DRAINS, INSTALLATION OF 2 - 28' ELECTRIC SLIDE GRATES AMD ASSOCIATED FENCING, SHOULDER ADJUSTMENT, SEEDING, AND MULCHING. OF THE WEST T-HANGAR ACCESS PAVEMENTS INCLUDING THE WEST AND NORTH ENTRANCES TO THE T-HANGAR AREA.

ADDITIVE ALTERNATE 1 - INCLUDES 2.5" NOMINAL DEPTH HMA MILLING AND OVERLAY OF SOUTH PORTION OF T-HANGAR APRON.

ADDITIVE ALTERNATE 2 - INCLUDES 2.5" NOMINAL DEPTH HMA MILLING AND OVERLAY, WATERBORNE AIRFIELD MARKING, SHOULDER ADJUSTMENT, SEEDING, AND MULCHING OF APRON TAXILANE.

GENERAL

THE COLES COUNTY MEMORIAL AIRPORT IS A FAA PART 139, NON-TOWER CONTROLLED, GENERAL AVIATION AIRPORT COMPRISED OF TWO PAVED RUNWAYS AND ONE SOD SHORT TAKEOFF AND LANDING (STOL) RUNWAY. THE PROPOSED CONSTRUCTION NOT WILL REQUIRE THE CLOSURE ANY ACTIVE RUNWAYS OR TAXIWAYS.

THE BASE BID AND ADDITIVE ALTERNATE 1 WILL REQUIRE THE CLOSURE OF THE WEST T-HANGAR APRON PAVEMENT. INCLUDING WEST AND NORTH ENTRANCES TO THE APRON HANGAR AREA. ADDITIVE ALTERNATE 2 WILL REQUIRE THE CLOSURE OF THE APRON TAXILANE BETWEEN THE T-HANGAR AREAS.

STATE HIGHWAY 16

AIRFIELD SAFETY

- 1. AIRFIELD SAFETY SHALL BE HELD PARAMOUNT AT ALL TIMES. ANY INDIVIDUALS RESPONSIBLE FOR INCURSIONS OR POTENTIAL INCURSIONS WITH AIR TRAFFIC DUE TO NON-COMPLIANCE WITH REQUIREMENTS SET FORTH IN THESE PLANS, SPECIFICATIONS, SPECIAL PROVISIONS, AND FAA ADVISORY CIRCULAR 150/5370-2 (CURRENT EDITION) WILL BE SUBJECT TO AN IMMEDIATE SUSPENSION OF DRIVING PRIVILEGES ON THE AIRPORT OR A COMPLETE RESTRICTION FROM ENTERING THE AIR OPERATIONS AREA ALTOGETHER. THE AIRPORT MANAGER OR RESIDENT ENGINEER/TECHNICIAN MAY STOP THE WORK AT ANY TIME THEY BELIEVE AIRFIELD SAFETY IS BEING COMPROMISED.
- 2. AIRPORT SECURITY WILL BE MAINTAINED AT ALL TIMES. ONLY CONTRACTOR EMPLOYEES SHALL BE ALLOWED WITHIN THE PROJECT LIMITS. GATES SHALL BE CLOSED AT ALL TIMES UNLESS THE CONTRACTOR IS IN A CONTINUOUS HAULING OPERATIONS, DURING WHICH TIME HE WILL PROVIDE A PERSON TO MONITOR THE GATE AREA.
- 3. RADIO CONTROL THE CONTRACTOR WILL BE REQUIRED TO BE IN TWO-WAY RADIO CONTACT WITH THE AIRPORT UNICOM (122.70 MHz) ANY TIME THERE ARE WORKERS OR EQUIPMENT ON THE AIRFIELD.



Offices Nationwide www.hanson-inc.com

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COLES COUNTY AIRPORT
AUTHORITY
COLES COUNTY MEMORIAL ARFORT



IDA No: MTO-4816 SBG Project No: N/A


Contract No. CO072

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	SSUE:	11/17/20	23			
	PROJEC	CT NO: 2	2A000	1D		
	CAD FIL	E: C-10	1-SOW	/.DWG	;	
	DESIGN	BY: LD	H 9/4/	2023		
	DRAWN	BY: JP	9/18	/2023		

SCOPE OF WORK

REVIEWED BY: LDH 10/19/23

SHEET TITLE

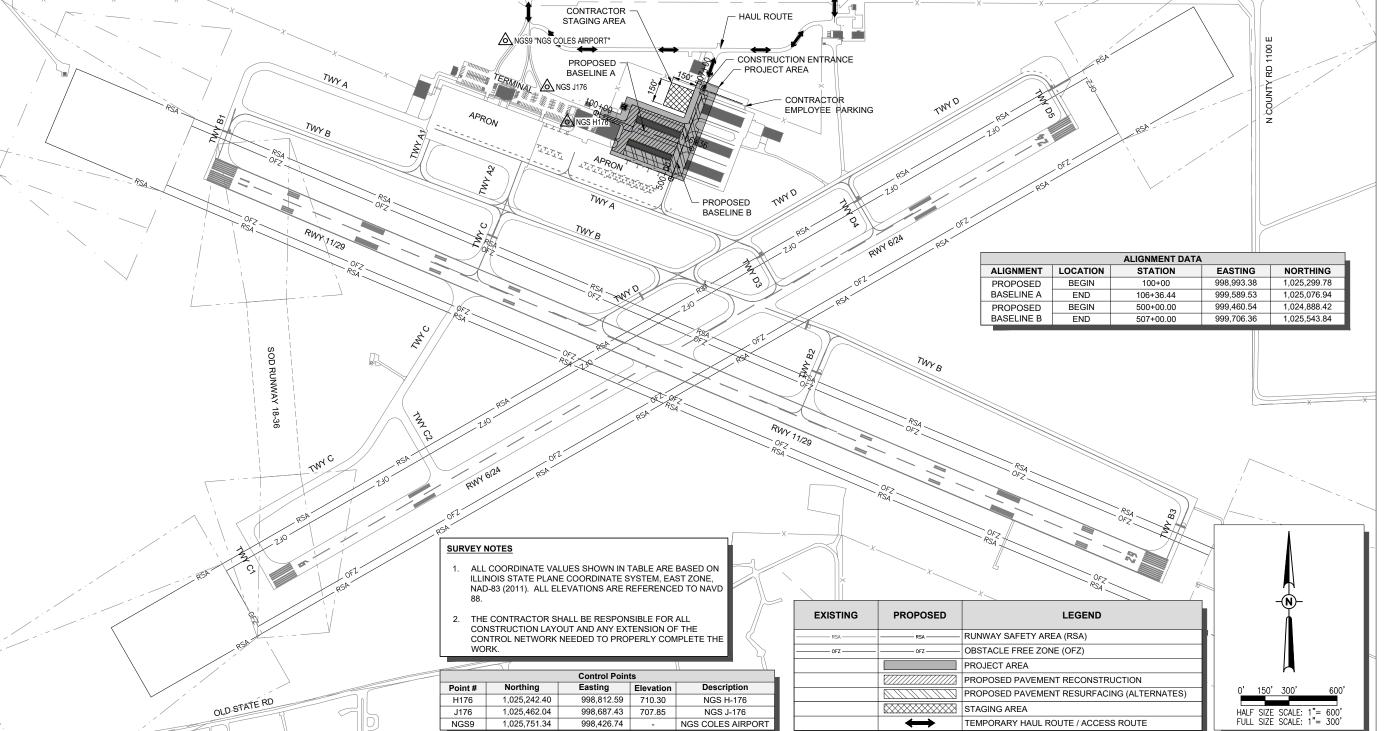

CONTRACTOR STAGING & STORAGE AREA

LOW-PROFILE BARRICADES (TYP.) SEE DETAIL. PHASE 1 - WEST APRON ENTRANCE RECONSTRUCTION

CRITICAL POINTS EXIST. EQUIPMENT OBJECT TOP FLEV POINT GROUND DESCRIPTION LAT. LONG. HEIGHT ELEV. (MSL) (FT) (MSL) LOW PROFILE BARRICADE N039° 28' 53.6021" W088° 16' 50.9065" 708 711 3 2 LOW PROFILE BARRICADE N039° 28' 51.9039" W088° 16' 45.1497" 705 708 3 CONSTRUCTION STAGING AREA / EQUIPMENT N039° 28' 55.8847" W088° 16' 44.8243" 703 728 3 25 CONSTRUCTION STAGING AREA / EQUIPMENT 4 N039° 28' 56.4020" W088° 16' 46.6172" 702 25 727 LOW PROFILE BARRICADE 5 N039° 28' 54 9088" W088° 16' 43 7818" 705 3 708 LOW PROFILE BARRICADE 6 N039° 28' 54.6487" W088° 16' 49.1263" 706 3 709 7 LOW PROFILE BARRICADE N039° 28' 56.5372" W088° 16' 43.69.12" 704 3 707 LOW PROFILE BARRICADE N039° 28' 52.2400" W088° 16' 46.2371" 706 709 9 LOW PROFILE BARRICADE N039° 28' 53.5439" W088° 16' 50.7126" 708 711 LOW PROFILE BARRICADE N039° 28' 55.2492" W088° 16' 44.7725" 708 *OBJECT HEIGHT TO BE VERIFIED IN THE FIELD

PHASE 1 SAFETY PLAN

NOTES

GENERAL

1. THE PROPOSED SAFETY PLAN WILL GOVERN WHEN WORK IS BEING COMPLETED IN THE SHADED REGIONS SHOWN ON THE PLANS.

CLOSURES

1. NO RUNWAY OR TAXIWAY CLOSURES

PHASE TRANSITION

1. THE CONTRACTOR WILL CONTACT THE AIRPORT A MINIMUM OF 7 DAYS BEFORE THE DESIRED INITIATION DATE OF WORK IN EACH WORK AREA, AND KEEP THE AIRPORT APPRISED OF ANY CHANGES TO THE PROJECT SCHEDULE, BOTH IMMEDIATE AND

2. PRIOR TO REMOVING ANY BARRICADES AND REOPENING ANY PAVEMENTS, THE CONTRACTOR SHALL THOROUGHLY CLEAN AND INSPECT THE AREA.

FLAGGER NOTES

RADIO CONTROL - THE CONTRACTOR WILL BE REQUIRED TO BE IN TWO-WAY RADIO CONTACT (122.70 MHz.) WITH THE AIRPORT UNICOM. THIS WILL KEEP THE CONTRACTOR IN CONSTANT CONTACT WITH THE FLORA AIRPORT AND ENABLE THE AIRPORT TO IMMEDIATELY CONTACT THE CONTRACTOR IN CASE OF AN AERONAUTIC EMERGENCY THAT WOULD REQUIRE ACTION BY THE CONTRACTOR AND/OR HIS PERSONNEL.


PHASE 1 NOTES:

PHASE 1 INCLUDES RECONSTRUCTING THE EXISTING WEST APRON ENTRANCE FROM THE PARKING LOT AND THE NORTH APRON ENTRANCE FROM THE MAINTENANCE (SRE) BUILDING.

INSTALLATION OF ELECTRICAL EQUIPMENT / LIGHTING INCLUDING BURIED CONDUIT

FULL DEPTH REMOVAL OF EXISTING PAVEMENT PCC PAVEMENT CONSTRUCTION DRAINAGE IMPROVEMENTS INCLUDING GRADING AND UNDERDRAINS INSTALLATION OF 2 - 28' ELECTRIC SLIDE GATES/FENCING AND FENCE REMOVAL / REPLACEMENT

PROPOSED	LEGEND
A 4	PHASE 1
	PHASE 2
	PHASE 3
	STAGING AREA
\leftrightarrow	TEMPORARY HAUL ROUTE / ACCESS ROUTE
	LOW PROFILE BARRICADE
1	SAFETY CRITICAL POINT

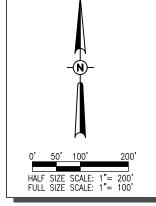

PHASE 1 - MAINTENANCE ENTRANCE

LOW-PROFILE BARRICADES

RECONSTRUCTION

(TYP.) SEE DETAIL.

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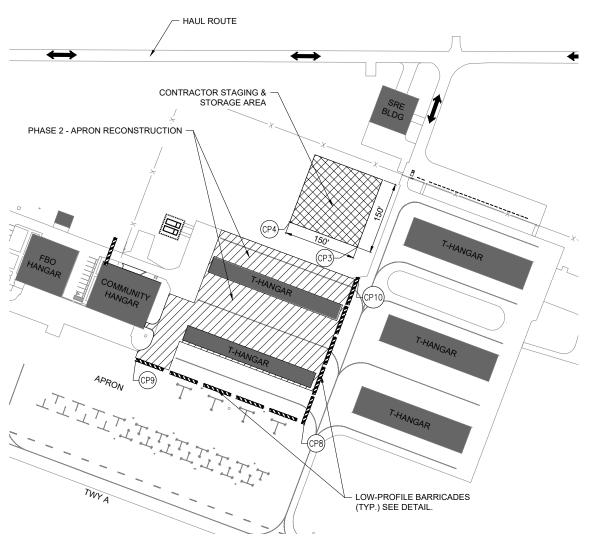
NO.	DATE	DESCRIPTION		
INO.	DATE	DES	DWN	REV
ISSUE: 11/17/2023				
PROJECT NO: 22A0001D				
OAD EU E. O 101 0000 01110				

CAD FILE: C-101-CSPP.DWG

DESIGN BY: 1 DH 9/4/2023 DRAWN BY: JP 9/18/2023 REVIEWED BY: LDH 10/19/23

SHEET TITLE

AIRFIELD SAFETY PLAN - PHASE 1




PHASE 2 SAFETY PLAN

PHASE 2

1. PHASE 2 INCLUDES RECONSTRUCTING THE EXISTING APRON / TAXILANE.

FULL DEPTH REMOVAL OF EXISTING PAVEMENT PCC SIDEWALK PAVEMENT APPROACHES AROUND EXISTING T-HANGARS HMA PAVEMENT CONSTRUCTION INSTALLATION OF TRENCH DRAIN BETWEEN THE EXISTING T-HANGARS DRAINAGE IMPROVEMENTS INCLUDING GRADING AND UNDERDRAINS INSTALLATION OF ELECTRICAL EQUIPMENT / LIGHTING INCLUDING BURIED CONDUIT

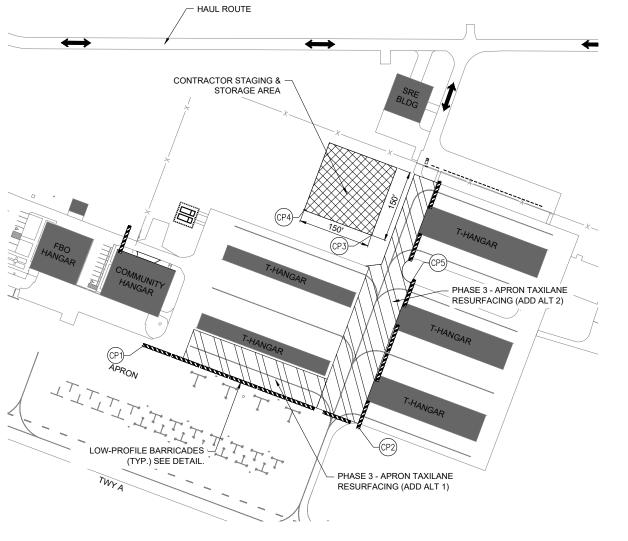


PHASE 3 SAFETY PLAN

PHASE 3 - ADDITIVE ALTERNATE 1 AND 2

1. PHASE 3 INCLUDES RESURFACING THE EXISTING APRON / TAXILANE.

HMA MILL AND OVERLAY PAVEMENT MARKING GRADING SEEDING AND MULCHING

PROPOSED	LEGEND
	PHASE 1
	PHASE 2
	PHASE 3
	STAGING AREA
\leftrightarrow	TEMPORARY HAUL ROUTE / ACCESS ROUTE
	LOW PROFILE BARRICADE
1	SAFETY CRITICAL POINT

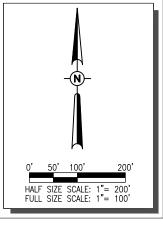



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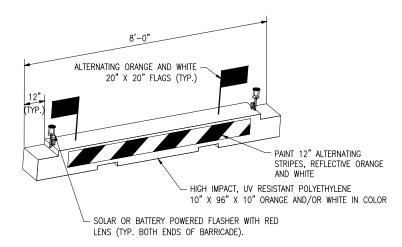
CAD FILE: C-101-CSPP.DWG DESIGN BY: LDH 9/4/2023 DRAWN BY: JP 9/18/2023 REVIEWED BY: LDH 10/19/23

SHEET TITLE

AIRFIELD SAFETY PLAN - PHASE 2 AND

- 2. THE CONTRACTORS SHALL MINIMIZE DISRUPTION OF STANDARD OPERATING PROCEDURES FOR AERONAUTICAL ACTIVITY BY REMAINING WITHIN THE PRESCRIBED STAGING, CONSTRUCTION, AND PHASING AREAS PRESENTED ON THE CONSTRUCTION SAFETY AND PHASING PLAN SHEETS.
- 3. NO UNAUTHORIZED PERSONNEL SHALL ENTER ANY AREA OF THE AIRPORT THAT COULD POTENTIALLY BE HAZARDOUS. THE AIRPORT MANAGER RESERVES THE RIGHT TO SUSPEND OPERATIONS IN ORDER TO MAINTAIN SAFETY AT THE AIRPORT.
- 4. PRIOR TO ACCESSING THE AIRFIELD, ANY DESIGNATED CONTRACTOR OR SUBCONTRACTOR EMPLOYEES WHO WILL BE OPERATING OR ESCORTING A VEHICLE ON AN ACTIVE AREA OF THE AIRFIELD MUST ATTEND A 1 HOUR AIRFIELD SAFETY TRAINING AND ORIENTATION PROVIDED BY THE AIRFORT. PRIOR TO THE TRAINING, THE EMPLOYEES MUST BE FAMILIAR WITH THE "FAA GUIDE TO GROUND VEHICLE OPERATIONS", AND KEEP A HARD COPY IN THE VEHICLE FOR REFERENCE. THE GUIDE CAN BE FOUND AT: https://www.faa.gov/airports/runway_safety/media/Ground_Vehicle_Guide_Proof_Final.pdf
- NO CONSTRUCTION VEHICLES SHALL BE DRIVEN ACROSS ANY ACTIVE AIRFIELD PAVEMENT AREA WITHOUT AN APPROPRIATE ESCORT.
- CONTRACTOR EQUIPMENT, VEHICLES, AND PROJECT MATERIALS SHALL BE STORED AT THE STAGING AREA SHOWN ON THE PLAN VIEW, EXCEPT AS OTHERWISE PROVIDED FOR AT THE PRE—CONSTRUCTION CONFERENCE.
- ALL CONSTRUCTION EQUIPMENT OPERATING IN THE PRESCRIBED CONSTRUCTION AREA IS REQUIRED TO DISPLAY A CHECKERBOARD FLAG PROPERLY LOCATED OR A ROTATING BEACON (STROBE) AS SPECIFIED IN AC 150/5210-5. "PAINTING. MARKING. AND LIGHTING OF VEHICLES USED ON AN AIRPORT" LATEST EDITION.
- 8. CLOSED AIRFIELD PHASING AREAS, OPEN TRENCHES, AND STOCKPILED MATERIALS AT THE CONSTRUCTION SITE SHALL BE PROMINENTLY MARKED WITH LIGHTED BARRICADES WITH STEADY BURNING OR FLASHING RED LIGHTS AS SPECIFIED IN 150/5370-2, "OPERATIONAL SAFETY ON AIRPORT DURING CONSTRUCTION", LATEST EDITION. LIGHTED BARRICADES MUST BE NO TALLER THAN 18" (EXCLUSIVE OF SUPPLEMENTARY LIGHTS AND FLAGS) ON THE TAXWAYS AND COMPLY WITH ADVISORY CIRCULAR 150/5370-2, LATEST EDITION. CONTRACTOR SHALL NIGHT CHECK BARRICADES DAILY FOR PROPER OPERATION.
- 9. OPEN TRENCHES, EXCAVATIONS, AND STOCKPILED MATERIALS AT THE CONSTRUCTION SITE SHOULD BE PROMINENTLY MARKED WITH ORANGE FLAGS AND LIGHTED WITH FLASHING RED LIGHTS DURING HOURS OF RESTRICTED VISIBILITY AND/OR DARKNESS.
- 10. NO CONSTRUCTION EQUIPMENT GREATER THAN 25' TALL, OTHER THAN AS SHOWN ON THE SAFETY PLAN, WILL BE PERMITTED ON THE AIRPORT WITHOUT THE APPROVAL OF THE AIRPORT MANAGER AND ADDITIONAL AIRSPACE APPROVAL BY THE FAA. AIRSPACE APPROVALS REQUIRE CONSIDERABLE LEAD TIME AND SHOULD BE REQUESTED WELL IN ADVANCE.
- 11. NO OPEN FLAME WELDING OR TORCH CUTTING OPERATION IS PERMITTED UNLESS ADEQUATE FIRE AND SAFETY PRECAUTIONS ARE PROVIDED AND HAVE BEEN APPROVED BY THE AIRPORT MANAGER NO FLARE POTS ARE ALLOWED ON THE PROJECT
- 12. SOIL, DEBRIS, AND LOOSE MATERIAL DROPPED OR TRUCKED ONTO AIRPORT ROADS, TAXIWAYS, AND SOD SURFACES, OR WHICH CAN BE BLOWN ONTO SUCH SURFACES, SHALL BE IMMEDIATELY SWEPT, PICKED UP AND REMOVED, OR PLACED INTO CLOSED CONTAINERS. ANY DAMAGE TO AIRPORT PROPERTY SHALL BE REPAIRED IMMEDIATELY AT NO COST TO THE OWNER.
- 13. EACH CONTRACTOR SHALL BE RESPONSIBLE FOR LOCATING AND MAINTAINING AIRPORT LIGHTING AND NAVIGATIONAL ELECTRICAL SYSTEMS DURING CONSTRUCTION. A CONTACT PERSON AND TELEPHONE NUMBER FOR 24 HOUR EMERGENCY IMMEDIATE REPAIR SHALL BE SUBMITTED TO THE AIRPORT MANAGER AND RESIDENT ENGINEER/TECHNICIAN. HAUL ROUTES CROSSING PAVEMENT, DRAINAGE, MISCELLANEOUS. STRUCTURES AND/OR AIRFIELD CABLES SHALL BE PROTECTED FROM DAMAGE.
- 14. ALL AIRCRAFT AND AIRPORT OPERATIONS HAVE THE RIGHT-OF-WAY. CONTRACTOR TO YIELD TO VEHICLES AND REMAIN CLEAR AT ALL TIMES.
- 15. CONTRACTOR SHALL PLACE, SECURE, AND MAINTAIN LIGHTED BARRICADES AND CLOSURE CROSSES WHEN A RUNWAY/TAXIWAY/APRON IS CLOSED OR AS REQUIRED BY THE PLANS AND DESIGNATED BY THE RESIDENT ENGINEER/TECHNICIAN.
- 16. CONTRACTOR SHALL MARK HAZARDOUS AREA WITH STEADY-BURNING OR FLASHING RED LIGHTS DURING PERIODS OF LOW VISIBILITY AS REQUIRED.
- 17. THE CONTRACTOR SHALL PERIODICALLY PERFORM ONSITE INSPECTIONS THROUGHOUT THE DURATION OF THE PROJECT WITH THE IMMEDIATE REMEDY OF ANY DIFFERENCES, WHETHER CAUSED BY NEGLIGENCE, OVERSIGHT, OR PROJECT SCOPE CHANGE.
- 18. CONTRACTOR SHALL MOVE MAINTENANCE OF TRAFFIC COMPONENTS AT THE WRITTEN DIRECTION OF THE RESIDENT ENGINEER/TECHNICIAN AT NO ADDITIONAL COST.
- CONTRACTOR SHALL NOT REMOVE THE BARRICADES WITHOUT THE APPROVAL BY THE RESIDENT ENGINEER/TECHNICIAN OR PROPER AIRPORT PERSONNEL.
- 20. CONTRACTOR SHALL MAINTAIN FLASHERS, SIGNS AND/OR BARRICADES AS REQUIRED BY THE PLANS, CITY OR COUNTY REGULATIONS OR CONTRACTOR ACTIVITIES. CONTRACTOR SHALL OBTAIN ANY AND ALL REQUIRED LOCAL PERMITS UNLESS SPECIFIED OTHERWISE.
- 21. THE CONTRACTOR SHALL UTILIZE WATER AND/OR CHEMICALS APPROVED BY THE RESIDENT ENGINEER/TECHNICIAN AS NECESSARY TO CONTROL DUST.
- 22. THE CONTRACTOR WILL BE RESPONSIBLE FOR IMPLEMENTING MEASURES TO CONTROL OR AVOID CREATING

- ATTRACTANTS TO WILDLIFE. MEASURES MAY INCLUDE CONTINUOUSLY REMOVING ANY WASTE OR LOOSE MATERIALS, PLACEMENT OF MATERIALS IN APPROPRIATE STORAGE CONTAINERS, PROPERLY MAINTAINING FENCES AND GATES TO PREVENT ACCESS, AND PREVENTING PONDING OF WATER THROUGHOUT THE SITE.
- 23. UNLESS SPECIFIED OTHERWISE, COST FOR SAFETY, STAGING, AND TRAFFIC MAINTENANCE ITEMS IS TO BE PAID LINDER AR150530
- 24. ALL AIRFIELD CLOSURES SHALL BE COORDINATED WITH AIRPORT MANAGEMENT A MINIMUM OF 7 DAYS BEFORE THE DESIRED CLOSING TIME TO ALLOW FOR THE PROPER COORDINATION. AIRPORT MANAGEMENT HAS COMPLETE AUTHORITY IN DETERMINING WHEN THE AIRFIELD MAY BE CLOSED.



LOW PROFILE AIRCRAFT BARRICADE DETAIL

BARRICADE NOTES

- 1. ALL CONSTRUCTION SIGNS AND TRAFFIC CONTROL DEVICES SHALL CONFORM TO THE MANUAL ON UNIFORM TRAFFIC CONTROL DEVICES INCLUDING THE ILLINOIS SUPPLEMENT (LATEST EDITION) AND THE FAA ADVISORY CIRCULARS (LATEST EDITION) UNLESS NOTED OTHERWISE. THE FAA OR MORE STRINGENT SPECIFICATIONS SHALL GOVERN.
- 2. BARRICADES SHALL BE INTERLOCKED END TO END OVER THE LENGTH OF THE PAVEMENT WHERE PROTECTING OPEN RUNWAYS, AND SPACED END TO END A MAXIMUM OF 4 FEET IN OTHER ALL OTHER AREAS. BARRICADES ARE TO BE SET BACK FROM THE ACTIVE RUNWAY OR TAXIWAY CENTERLINE THE DISTANCE AS SHOWN ON THE PLANS.
- 3. CONSTRUCTION RED WARNING LIGHT: THESE ARE PORTABLE, LENS DIRECTED, ENCLOSED LIGHTS. THE COLOR OF THE LIGHT EMITTED SHALL BE RED. THEY MAY BE USED IN EITHER A STEADY BURN (TYPE C) OR LOW INTENSITY FLASHING MODE (TYPE A) UNLESS NOTED OTHERWISE.
- 4. THE LIGHTING SHALL BE MAINTAINED IN OPERATION DURING THE HOURS OF DARKNESS BETWEEN 1/2 HOUR AFTER SUNSET AND 1/2 HOUR BEFORE SUNRISE AND WHEN CONDITIONS EXIST WHICH TEND TO OBSCURE VISION.
- 5. BARRICADES SHALL BE SECURED TO THE GROUND BY APPROVED METHODS TO PREVENT MOVEMENT BY PROP WASH, JET BLAST OR OTHER WIND CURRENTS.
- . THE ONLY COLOR COMBINATION ON BARRICADES IS ORANGE AND WHITE. THE ORANGE STRIPES SHALL BE ENCAPSULATED LENS REFLECTIVE SHEETING. THE WHITE STRIPES SHALL BE EITHER ENCAPSULATED OR ENCLOSED LENS REFLECTIVE SHEETING AND MUST BE IN ACCEPTABLE CONDITION.
- 7. COST FOR PROVIDING, PLACING, MAINTAINING, RELOCATING AND REMOVING BARRICADES SHALL BE PAID UNDER ITEM AR150530.



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RECONSTRUCT WEST AIRCRAFT T-HANGAR AREA PAVEMENTS

IDA No: MTO-4816 SBG Project No: N/A

Contract No. CO072

	NO.	DATE	DES	CRIPT	ION
	NO.	DATE	DES	DWN	REV
i	ISSUE: 11/17/2023				

PROJECT NO: 22A0001D

CAD FILE: C-101-CSPP.DWG

DESIGN BY: LDH 9/4/2023

DRAWN BY: JP 9/18/2023

REVIEWED BY: LDH 10/19/23

SHEET TITLE

AIRFIELD SAFETY NOTES & DETAILS

CONTRACTOR'S CERTIFICATION STATEMENT

THIS CERTIFICATION STATEMENT IS A PART OF THE STORM WATER POLLUTION PREVENTION PLAN FOR THE PROJECT DESCRIBED BELOW IN ACCORDANCE WITH NPDES PERMIT NO. ILR10 ISSUED BY THE ILLINOIS ENVIRONMENTAL PROTECTION AGENCY.

PROJECT INFORMATION:

AIRPORT: __ PROJECT: PROJECT NO: COUNTY:

CONTRACT NUMBER:

I CERTIFY UNDER PENALTY OF LAW THAT I UNDERSTAND THE TERMS AND CONDITIONS OF THE GENERAL NATIONAL POLLUTION DISCHARGE ELIMINATION SYSTEM (NPDES) PERMIT (ILR10) THAT AUTHORIZES THE STORM WATER DISCHARGES ASSOCIATED WITH INDUSTRIAL ACTIVITY FROM THE CONSTRUCTION SITE IDENTIFIED AS PART OF THIS

SIGNATURE: _


DATE: _ PRINTED NAME:

NAME OF FIRM: STREET ADDRESS:


CITY, STATE, ZIP:

PHONE NUMBER:

THE INFORMATION WITHIN THIS BOX SHALL BE COMPLETED BY THE CONTRACTOR AFTER THE AWARD OF THE CONTRACT TO OBTAIN THE REQUIRED NPDES PERMIT FROM IEPA. COMPLETION OF THIS IS A CONTRACT REQUIREMENT.

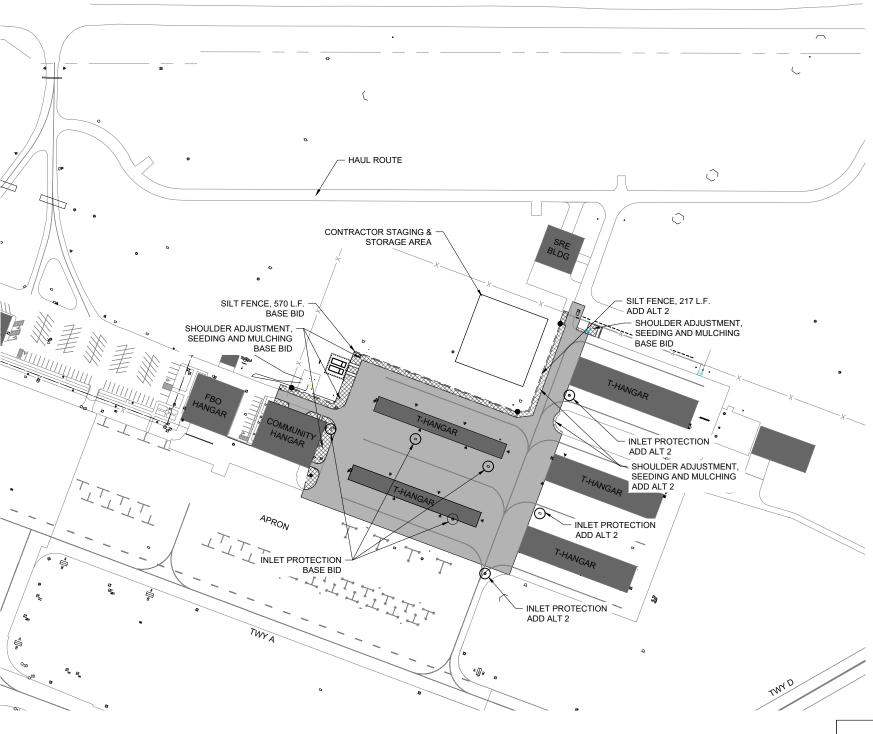

PROPOSED	LEGEND	
	PROJECT AREA	
	SHOULDER ADJUSTMENT	
	SILT FENCE	
0	INLET PROTECTION	

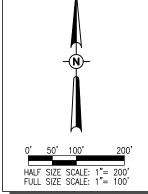



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COLES COUNTY AIRPORT AUTHORITY

RECONSTRUCT WEST AIRCRAFT T-HANGAR AREA PAVEMENTS

IDA No: MTO-4816 SBG Project No: N/A

Contract No. CO072

DESCRIPTION NO. DATE DES DWN REV ISSUE: 11/17/2023

PROJECT NO: 22A0001D CAD FILE: C-181-SWP.DWG


DESIGN BY: LDH 9/4/2023 DRAWN BY: JP 9/18/2023 REVIEWED BY: LDH 10/19/23

SHEET TITLE

STORM WATER **POLLUTION** PREVENTION PLAN

NOTES:


- 1. FENCE POST SHALL BE EITHER STEEL "T" LINE POST OR HARDWOOD POST WITH A MINIMUM SECTIONAL AREA OF 2.0 SQUARE INCHES. A CARPENTER'S (NOMINAL) 2"x2" POST WILL MEET
- 2. TOP AND BOTTOM WIRE OF WIRE FABRIC SHALL BE MINIMUM GAGE NO. 9. INTERMEDIATE WIRES OF THE WIRE FABRIC SHALL BE MINIMUM GAGE NO. 11.
- 3. WIRE FABRIC SHALL BE SECURELY FASTENED TO FENCE POSTS WITH NO. 9 GAGE WIRE MINIMUM. FOUR (4) FASTENERS PER POST REQUIRED.
- 4. FILTER FABRIC SHALL BE SECURELY FASTENED TO WIRE FABRIC AND POSTS WITH TIES OR STAPLES SPACED AT 12" APART AT THE TOP, MIDDLE AND BOTTOM
- 5. WHEN TWO SECTIONS OF FILTER FABRIC MEET, THEY SHALL BE OVERLAPPED BY 6" AND FOLDED AND ATTACHED TO THE WIRE FABRIC AT A POST.
- 6. FILTER FABRIC SHALL BE IN ACCORDANCE WITH SPECIAL PROVISIONS WITH APPARENT OPENING SIZE (AOS) OF AT LEAST 40 FOR NONWOVEN AND WOVEN. THE FABRIC MUST MEET THE APPLICABLE STANDARDS OF AASHTO 288-00 (Article IV, Section B.1.j.1.f.i, AS AMENDED), OR
- 7. A MAXIMUM OF 5 FEET IS USED FOR POST-TO-POST SPACING
- SOIL DISTURBANCE SHALL BE CONDUCTED IN SUCH A MANNER AS TO MINIMIZE EROSION. SOIL STABILIZATION MEASURES SHALL CONSIDER THE TIME OF YEAR, SITE CONDITIONS AND THE USE OF TEMPORARY OR PERMANENT MEASURES.
- 9. ALL STORM SEWERS THAT ARE OR WILL BE FUNCTIONING DURING CONSTRUCTION SHALL BE PROTECTED BY AN APPROPRIATE SEDIMENT CONTROL MEASURE.
- 10. SILT FENCE SHALL BE INSTALLED PRIOR TO ANY GRADING WORK IN THE AREA TO BE PROTECTED. PERIODIC INSPECTION SHALL BE PERFORMED AND REQUIRED MAINTENANCE SHALL BE PROVIDED AFTER EACH RAIN EVENT.
- 11. MAINTENANCE SHALL BE PERFORMED AS NEEDED AND MATERIAL REMOVED AND REPLACED WHEN BULGES DEVELOP IN THE SILT FENCE.
- 12. IF DEWATERING SERVICES ARE USED, ADJOINING PROPERTIES AND DISCHARGE LOCATIONS SHALL BE PROTECTED FROM EROSION. DISCHARGES SHALL BE ROUTED THROUGH AN EFFECTIVE SEDIMENT CONTROL MEASURE (E.G. SEDIMENT TRAP, SEDIMENT BASIN, OR OTHER APPROPRIATE MEASURE)
- 13. FENCE POSTS SHALL BE REMOVED WHEN DIRECTED AT PROJECT END.
- 14. THE EROSION CONTROL MEASURES INDICATED ON THE PLANS ARE THE MINIMUM REQUIREMENTS. ADDITIONAL MEASURES MAY BE REQUIRED, AS DIRECTED BY THE ENGINEER OR GOVERNING AGENCY

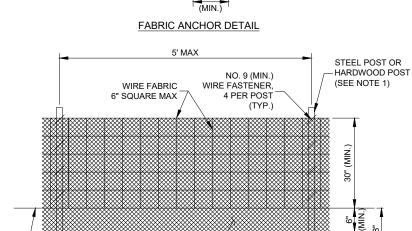

FILTER FABRIC

COMPACTED


BACKFILL

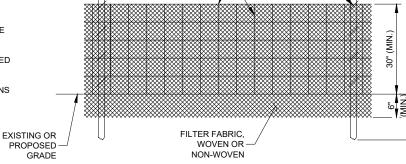

EXISTING OR

PROPOSED GRADE

ELEVATION

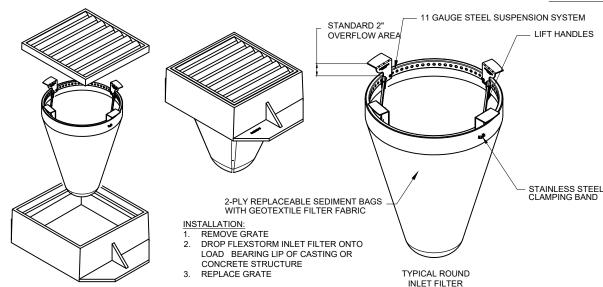

- FILTER FABRIC INLET PROTECTION SHALL CONSIST OF INLET BASKET AND FABRIC INSERT, FLEXSTORM CATCH-IT BY ADVANCED DRAINAGE
- SYSTEMS, FLOGARD TEMPORARY INLET FILTER BY OLDCASTLE, OR APPROVED EQUAL.

 DEVICE SHALL BE EQUIPPED WITH AN OVERFLOW FEATURE SO DRAINAGE TO INLET IS NOT COMPLETELY BLOCKED IF DEVICE IS FULL OF SILT INLET BASKET IS AVAILABLE TO FIT ROUND, RECTANGULAR, BEEHIVE OR CURB INLET CASTINGS.
- FILTER FABRIC SHALL HAVE AN APPARENT OPENING SIZE (AOS) OF AT LEAST 70 SIEVE FOR NONWOVEN
- FILTER FABRIC SHALL HAVE A GRAB TENSILE STRENGTH OF A LEAST 100 LBS FOR NON WOVEN.
- POLYESTER OUTER REINFORCEMENT BAG SHALL HAVE FABRIC WITH A WEIGHT OF 4.55 OZ/SQYD +/- 15 PERCENT
- FRAME CONSTRUCTION SHALL HAVE A TENSILE STRENGTH OF AT LEAST 58,000 PSI AND A YIELD STRENGTH OF AT LEAST 36,000 PSI. MAINTENANCE SHALL BE PERFORMED AS NEEDED. REMOVE SILT FROM FABRIC INSERT WHEN 50% OF CAPACITY IS REACHED. REMOVE SILT FROM INTERIOR AND EXTERIOR OF INLET DAM WHEN 50% OF DAM HEIGHT IS REACHED
- 9. PAYMENT FOR INLET PROTECTION MAINTENANCE SHALL BE INCIDENTAL TO INLET PROTECTION.

SEDIMENTATION AND EROSION CONTROL NOTES:

- SEDIMENT CONTROL MEASURES SHALL BE INSTALLED PRIOR TO THE COMMENCEMENT OF HYDROLOGIC
- FOR THOSE DEVELOPMENTS THAT REQUIRE A DESIGNATED EROSION CONTROL INSPECTOR (DECI), INSPECTIONS AND DOCUMENTATION SHALL BE PERFORMED, AT A MINIMUM:
- UPON COMPLETION OF SEDIMENT AND RUNOFF CONTROL MEASURES (INCLUDING PERIMETER CONTROLS AND DIVERSIONS), PRIOR TO PROCEEDING WITH ANY OTHER EARTH DISTURBANCE OR GRADING
- AFTER EVERY SEVEN (7) CALENDAR DAYS OR STORM EVENT WITH GREATER THAN 0.5 INCH OF RAINFALL OR LIQUID EQUIVALENT PRECIPITATION.
- SOIL DISTURBANCE SHALL BE CONDUCTED IN SUCH A MANNER AS TO MINIMIZE EROSION. IF STRIPPING, CLEARING, GRADING, OR LANDSCAPING ARE TO BE DONE IN PHASES, THE PERMITTEE SHALL PLAN FOR APPROPRIATE SOIL EROSION AND SEDIMENT CONTROL MEASURES.
- D. A STABILIZED MAT OF CRUSHED STONE MEETING IDOT GRADATION CA-01 UNDERLAIN WITH FILTER FABRIC AND IN ACCORDANCE WITH THE ILLINOIS URBAN MANUAL, OR OTHER APPROPRIATE MEASURE(S) AS APPROVED BY THE ENFORCEMENT OFFICER, SHALL BE INSTALLED AT ANY POINT WHERE TRAFFIC WILL BE ENTERING OR LEAVING A CONSTRUCTION SITE. SEDIMENT OR SOIL REACHING AN IMPROVED PUBLIC RIGHT OF WAY, STREET, ALLEY OR PARKING AREA SHALL BE REMOVED BY SCRAPING OR STREET CLEANING AS ACCUMULATIONS WARRANT AND TRANSPORTED TO A CONTROLLED SEDIMENT DISPOSAL AREA.
- E. TEMPORARY DIVERSIONS SHALL BE CONSTRUCTED AS NECESSARY TO DIRECT ALL RUNOFF FROM HYDROLOGICALLY DISTURBED AREAS TO AN APPROPRIATE SEDIMENT TRAP OR BASIN.
- DISTURBED AREAS SHALL BE STABILIZED WITH TEMPORARY OR PERMANENT MEASURES WITHIN SEVEN (7) CALENDAR DAYS FOLLOWING THE END OF ACTIVE HYDROLOGIC DISTURBANCE OR REDISTURBANCE.
- ALL STOCKPILES SHALL HAVE APPROPRIATE MEASURES TO PREVENT EROSION. STOCKPILES SHALL NOT BE PLACED IN FLOOD PRONE AREAS OR WETLANDS AND DESIGNATED BUFFERS.
- SLOPES STEEPER THAN 3H:1V SHALL BE STABILIZED WITH APPROPRIATE MEASURES AS APPROVED BY THE ENFORCEMENT OFFICER.
- APPROPRIATE EROSION CONTROL BLANKET SHALL BE INSTALLED ON ALL INTERIOR DETENTION BASIN SIDE SLOPES BETWEEN THE NORMAL WATER LEVEL AND HIGH WATER LEVEL.
- STORM SEWERS THAT ARE OR WILL BE FUNCTIONING DURING CONSTRUCTION SHALL BE PROTECTED BY AN APPROPRIATE SEDIMENT CONTROL MEASURE.
- IF DEWATERING SERVICES ARE USED, ADJOINING PROPERTIES AND DISCHARGE LOCATIONS SHALL BE PROTECTED FROM EROSION AND SEDIMENTATION. DISCHARGES SHALL BE ROUTED THROUGH AN APPROVED ANIONIC POLYMER DEWATERING SYSTEM OR A SIMILAR MEASURE AS APPROVED BY THE ENFORCEMENT OFFICER, DEWATERING SYSTEMS SHOULD BE INSPECTED DAILY DURING OPERATIONAL PERIODS. THE ENFORCEMENT OFFICER, OR APPROVED REPRESENTATIVE, MUST BE PRESENT AT THE COMMENCEMENT OF
- IF INSTALLED SOIL EROSION AND SEDIMENT CONTROL MEASURES DO NOT MINIMIZE SEDIMENT LEAVING THE DEVELOPMENT SITE, ADDITIONAL MEASURES SUCH AS ANIONIC POLYMERS OR FILTRATION SYSTEMS MAY BE REQUIRED BY THE ENFORCEMENT OFFICER.
- M. ALL TEMPORARY AND PERMANENT EROSION CONTROL MEASURES MUST BE MAINTAINED AND REPAIRED AS NEEDED. THE PROPERTY OWNER SHALL BE ULTIMATELY RESPONSIBLE FOR MAINTENANCE AND REPAIR
- ALL TEMPORARY SEDIMENT CONTROL MEASURES SHALL BE REMOVED WITHIN 30 DAYS AFTER FINAL SITE STABILIZATION IS ACHIEVED OR AFTER THE TEMPORARY MEASURES ARE NO LONGER NEEDED
- O. THE EROSION CONTROL MEASURES INDICATED ON THE PLANS ARE THE MINIMUM REQUIREMENTS. ADDITIONAL MEASURES MAY BE REQUIRED, AS DIRECTED BY THE ENGINEER, ENFORCEMENT OFFICER, OR OTHER

STORM WATER POLLUTION PREVENTION NOTES

THE CONTRACTOR SHALL IMPLEMENT ALL PROVISIONS OF THE CONTRACT DOCUMENTS TO ASSURE THAT STORM WATER POLLUTION PREVENTION ITEMS ARE CONSTRUCTED AND MAINTAINED IN A TIMELY MANNER. SEDIMENTATION MUST NOT BE TRANSPORTED OFF THE CONSTRUCTION SITE. PERMANENT DRAINAGE FEATURES AND VEGETATIVE MEASURES SHALL BE PROVIDED AS SOON AS POSSIBLE

THE MAINTENANCE OF ALL STORM WATER POLLUTION PREVENTION MEASURES IS INCIDENTAL TO THE ASSOCIATED

POLLUTION PREVENTION MEASURES

THE CONTRACTOR SHALL BE REQUIRED TO IMPLEMENT AND MAINTAIN STORM WATER POLLUTION PREVENTION PRACTICES AND MEASURES PRIOR TO THE STRIPPING OF EXISTING VEGETATION WHEREVER POSSIBLE AND AS SOON AS CONSTRUCTION PERMITS IN OTHER AREAS. POLLUTION CONTROL MEASURES SHALL BE IN ACCORDANCE WITH THE CONTRACT DOCUMENTS, INCLUDING THESE CONSTRUCTION PLANS, AND WITH STANDARDS AND SPECIFICATIONS FOR SOIL EROSION AND SEDIMENT CONTROL, ILLINOIS ENVIRONMENTAL PROTECTION AGENCY, CURRENT ISSUE. THE CONTRACTOR SHALL ADJUST HIS OPERATIONS AND IMPLEMENT POLLUTION CONTROL MEASURES SO THAT NO RUNOFF FROM STRIPPED AREAS WILL LEAVE THE CONSTRUCTION SITE OTHER THAN THROUGH SEDIMENT TRAPS OR OTHER SUITABLE CONTROL MEASURES.

POLLUTION CONTROL ITEMS SHALL BE PROVIDED AS NOTED ON THE STORM WATER POLLUTION PREVENTION PLAN AND IN THE STORM WATER POLLUTION PREVENTION DETAILS AND AS DIRECTED BY THE ENGINEER. THE LIMITS OF SUCH MEASURES SHALL BE STAKED BY THE CONTRACTOR PRIOR TO THE COMMENCEMENT OF CONSTRUCTION. SUCH LIMITS MAY BE ADJUSTED BY THE ENGINEER TO ACCOUNT FOR ACTUAL SITE CONDITIONS EXPERIENCED DURING CONSTRUCTION. ADDITIONAL COMPENSATION FOR MEASURES EXCEEDING THE PLAN QUANTITIES WILL BE PAID FOR AT THE CONTRACT UNIT PRICE FOR EACH ITEM.

THE CONTRACTOR IS TO MAINTAIN AND ADJUST. REPAIR OR REPLACE ALL POLLUTION PREVENTION MEASURES AS REQUIRED OR AS DIRECTED BY THE ENGINEER UNTIL PERMANENT VEGETATION HAS BEEN ESTABLISHED. MAINTENANCE OF POLLUTION CONTROL MEASURES IS TO BE PROVIDED AT NO ADDITIONAL COST TO THE CONTRACT

ADDITIONAL STORMWATER POLLUTION PREVENTION MEASURES ARE EXISTING ON SITE LOCATED AT DRAINAGE FACILITIES AND ALONG THE PROPERTY LINE



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RECONSTRUCT WEST AIRCRAFT T-HANGAR AREA PAVEMENTS

IDA No: MTO-4816 SBG Project No: N/A

Contract No. CO072


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PROJECT NO: 22A0001D


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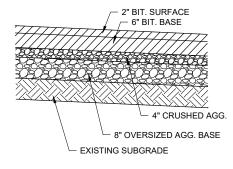
SHEET TITLE

STORM WATER **POLLUTION PREVENTION DETAILS**



PROPOSED PCC APRON ENTRANCE SECTION A-A NOT TO SCALE

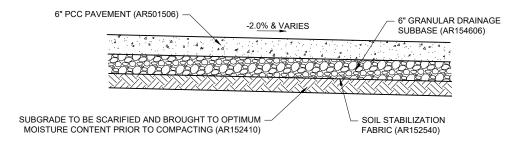

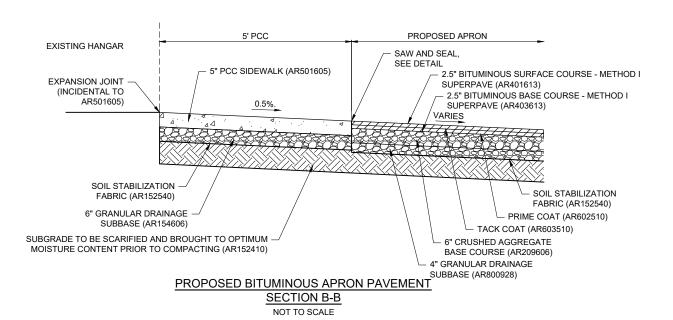

EXISTING APRON PAVEMENT

NOT TO SCALE

ADDITIVE ALTERNATIVE 1 AND 2

2.5" - BITUMINOUS PAVEMENT MILLING
2.5" - BITUMINOUS SURFACE COURSE METHOD I SUPERPAVE (AR401613)

MATCH
EXISTING
TACK COAT (AR603510)

EXISTING PAVEMENT STRUCTURE

EXISTING SUBGRADE

 $\frac{\text{PROPOSED BITUMINOUS MILL AND OVERLAY}}{\text{SECTION C-C}}$

NOT TO SCALE

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COLES COUNTY AIRPORT
AUTHORITY
COLES COUNTY MEMORIAL ABFORT

RECONSTRUCT WEST AIRCRAFT T-HANGAR AREA PAVEMENTS

IDA No: MTO-4816 SBG Project No: N/A

Contract No. CO072

NO. DATE DESCRIPTION
DES DWN REV


ISSUE: 11/17/2023
PROJECT NO: 22A0001D
CAD FILE: C-302-TYP.DWG
DESIGN BY: LDH 9/4/2023

SHEET TITLE

TYPICAL PAVEMENT SECTIONS


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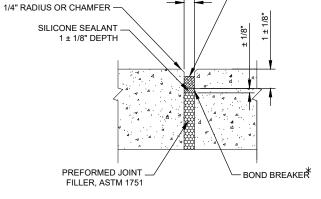
REVIEWED BY: LDH 10/19/23

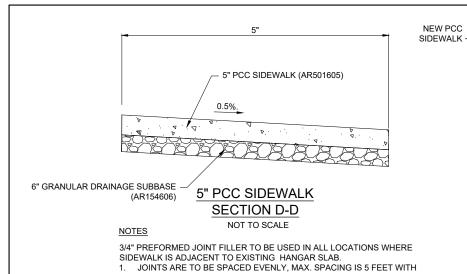

3/4" PREFORMED EXPANSION JOINTS AT 25' MAX. INTERVALS.

NEW PCC PAVEMENT SEE SEALANT -**DETAIL 1** AGGREGATE BASE COURSE **EXPANSION JOINT**



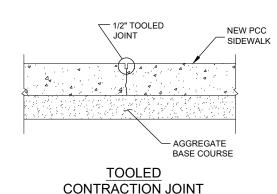

1/4" MAX. BELOW

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Professional Service Corporation #184-001084

COLES COUNTY AIRPORT

AUTHORITY

PAVEMENT

* POLYETHYLENE OR POLYESTER TAPE (3 MIL. MIN.) OR MARKING TAPE, RUBBER TAPE, 1/8" WIDER THAN WIDTH OF

DETAIL 1 - SEALANT

SIDEWALK JOINT DETAILS

1/4" MAX. BELOW | 3/8" ± 1/8" PAVEMENT SEALANT ASTM $1-1/2" \pm 1/8"$ D6690-TYPE II NEW BITUMINOUS EXISTING BITUMINOUS OR PAVEMENT PCC PAVEMENT

ALL BITUMINOUS/BITUMINOUS JOINT SEALING TO BE PAID UNDER SAW AND SEAL BITUMINOUS JOINTS, ITEM AR401660.

BITUMINOUS/BITUMINOUS SEAL

DESCRIPTION NO. DATE DES DWN REV ISSUE: 11/17/2023 PROJECT NO: 22A0001D

RECONSTRUCT WEST AIRCRAFT T-HANGAR AREA PAVEMENTS IDA No: MTO-4816 SBG Project No: N/A

Contract No. CO072


CAD FILE: C-302-TYP.DWG

DESIGN BY: LDH 9/4/2023 DRAWN BY: JP 9/18/2023

REVIEWED BY: LDH 10/19/23

SHEET TITLE

PAVEMENT DETAILS

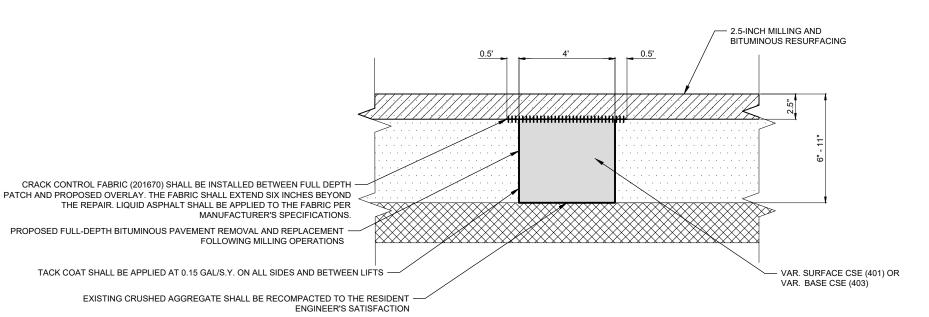

AR401916 REMOVE & REPLACE BITUMINOUS PAVEMENT - TYPE B (FULL DEPTH)

NOT TO SCALE

DEMOLITION NOTES

- PRIOR TO THE INITIATION OF ANY SITE WORK, CONTRACTOR SHALL LAYOUT LIMITS FOR ALL PROPOSED WORK ITEMS AND LOCATE ALL EXISTING UTILITIES WITHIN THE PROJECT VICINITY. ANY POTENTIAL AREAS OF CONFLICT SHALL BE POT-HOLED BY THE CONTRACTOR FOR VERIFICATION AND REPORTED TO THE OWNER'S REPRESENTATIVE. CONTRACTOR SHALL MAKE MINOR ADJUSTMENTS TO THE PROPOSED LAYOUT AS REQUIRED TO AVOID CONFLICTS AT NO ADDITIONAL COST. CONFLICTS THAT CANNOT BE MITIGATED BY ADJUSTMENTS TO THE LAYOUT WILL REQUIRE FURTHER EVALUATION
- REMOVED CONCRETE, ASPHALT, MILLED MATERIAL, EXCAVATION, ABANDONED UTILITIES AND OTHER MATERIALS SHALL BE DISPOSED OF OFFSITE. UNLESS OTHERWISE DIRECTED BY THE RESIDENT ENGINEER/TECHNICIAN.
- 3. STRIPPED TOPSOIL SHALL BE RETAINED ONSITE AND USED TO CAP GRADED AREAS ENSURING A MINIMUM THICKNESS OF 4" OF TOPSOIL MATERIAL.
- 4. PAVEMENT SAWING INCIDENTAL TO PAVEMENT REMOVAL / BITUMINOUS PAVEMENT MILLING.


- SEE ELECTRICAL PLANS FOR REMOVAL OF LIGHT POLES, ELECTRIC SLIDE GATE EQUIPMENT AND OTHER ASSOCIATED ELECTRICAL ITEMS.
- 2. ALL WORK, POWER OUTAGES, AND/OR SHUT DOWN OF EXISTING SYSTEMS SHALL BE COORDINATED WITH THE AIRPORT MANAGER/DIRECTOR AND RESIDENT

BITUMINOUS PAVEMENT MILLING


CONTRACTOR SHALL PROTECT ALL ADJACENT PAVEMENT EDGES DURING MILLING AND PAVING OPERATIONS. ANY DAMAGE DONE TO EXISTING PAVEMENT OR MARKINGS SHALL BE REPAIRED OR REMARKED AT THE CONTRACTOR'S EXPENSE.

REMOVE & REPLACE BITUMINOUS PAVEMENT

SEE DETAILS SHEET FOR PATCHING. PATCHING LOCATIONS ARE APPROXIMATE AND WILL BE CONFIRMED AND LAID OUT BY THE RESIDENT ENGINEER/TECHNICIAN.

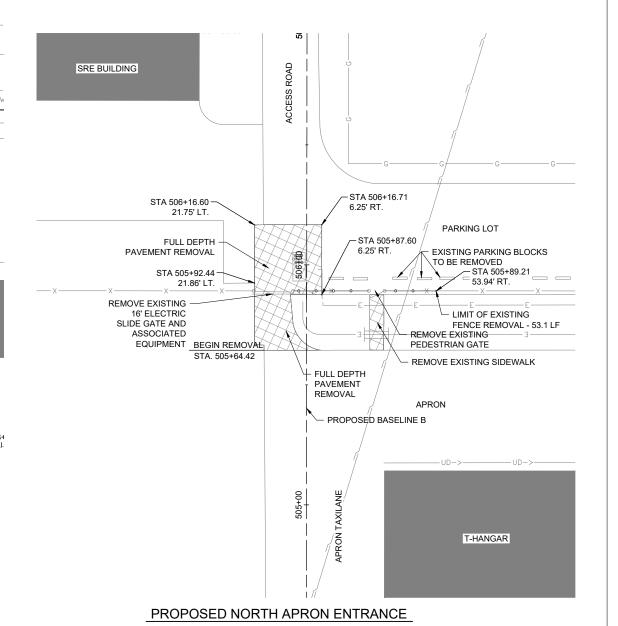

EXISTING	PROPOSED	LEGEND
	KXXXXXXX	BITUMINOUS PAVEMENT REMOVAL
		BITUMINOUS PAVEMENT MILLING
		REMOVE AND REPLACE BITUMINOUS PAVEMENT
		SILT FENCE
		AIRPORT BUILDING
UD->		UNDERDRAIN
		STORM SEWER
——т—		TELEPHONE LINE
x		FENCE
——Е——		ELECTRICAL CABLES
		WATER LINES
		SANITARY SEWER
G		GAS
0		MANHOLE
		HANDHOLE
		INLET
<u> </u>		LIGHT

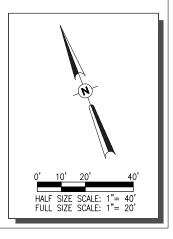



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RECONSTRUCT WEST AIRCRAFT T-HANGAR AREA PAVEMENTS

IDA No: MTO-4816 SBG Project No: N/A


Contract No. CO072

NO.	DATE	DES	CRIPT	ION	
NO.	DATE	DES	DWN	REV	
ISSUE: 11/17/2023					
PROJECT NO: 22A0001D					
CAD FIL	F: C-111-D	EMO-PH	1 DWG		

DESIGN BY: 1 DH 9/4/2023 DRAWN BY: JP 9/18/2023 REVIEWED BY: LDH 10/19/23

SHEET TITLE

DEMOLITION PLAN -PHASE 1

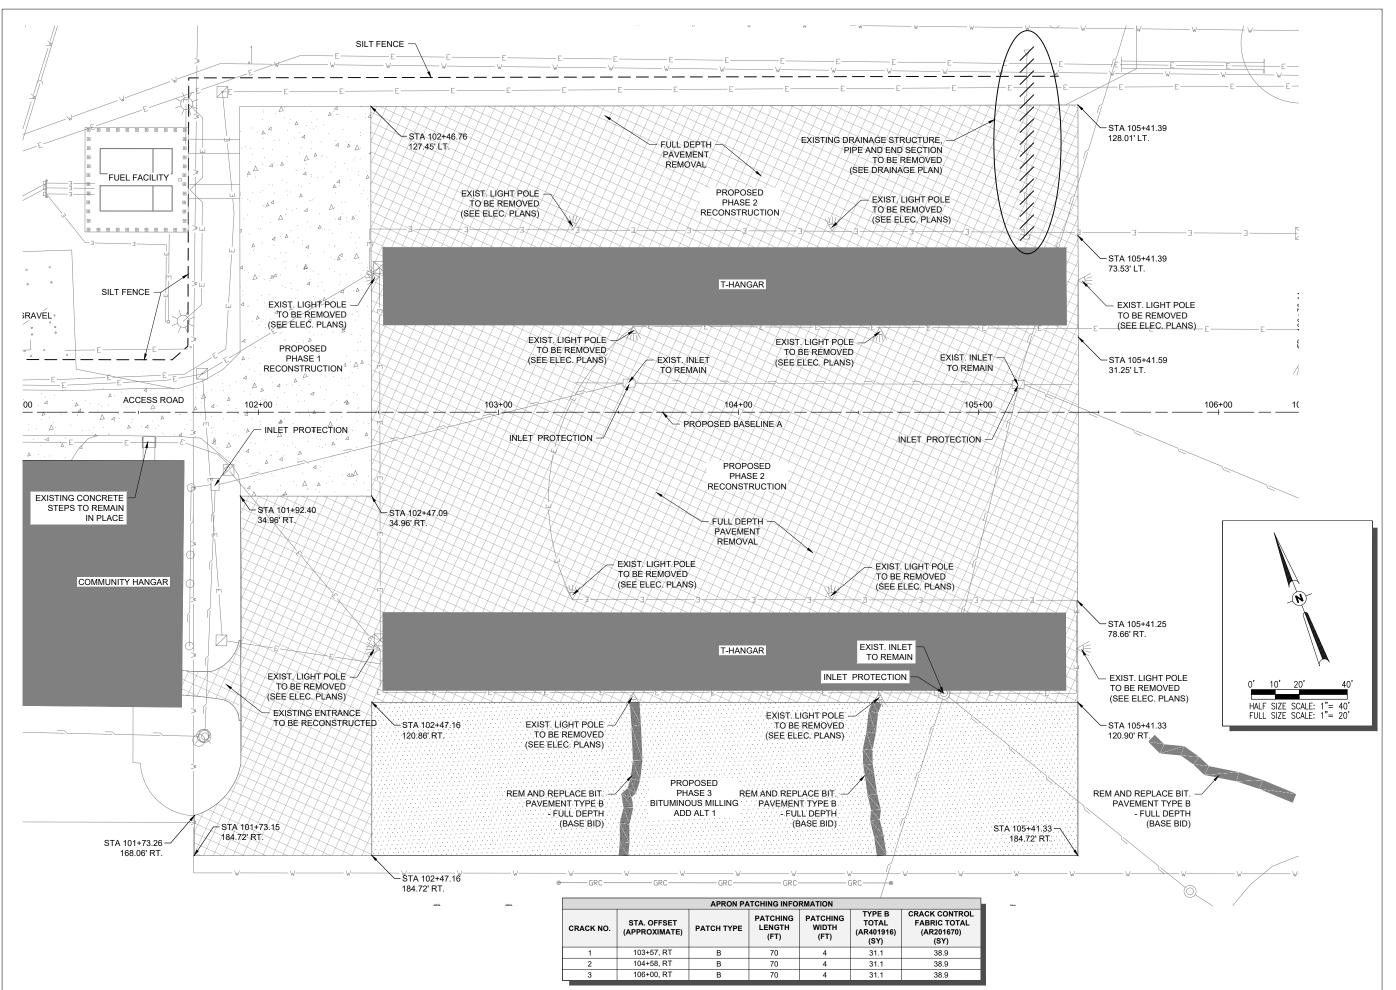



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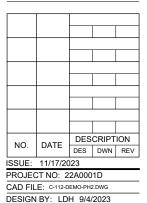
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COLES COUNTY AIRPORT
AUTHORITY
COLES CHAPTY MEMORIAL AIRPORT

RECONSTRUCT WEST AIRCRAFT T-HANGAR AREA PAVEMENTS

IDA No: MTO-4816 SBG Project No: N/A

Contract No. CO072




DEMOLITION PLAN -

DRAWN BY: JP 9/18/2023

SHEET TITLE

REVIEWED BY: LDH 10/19/23

PHASE 2 AND 3

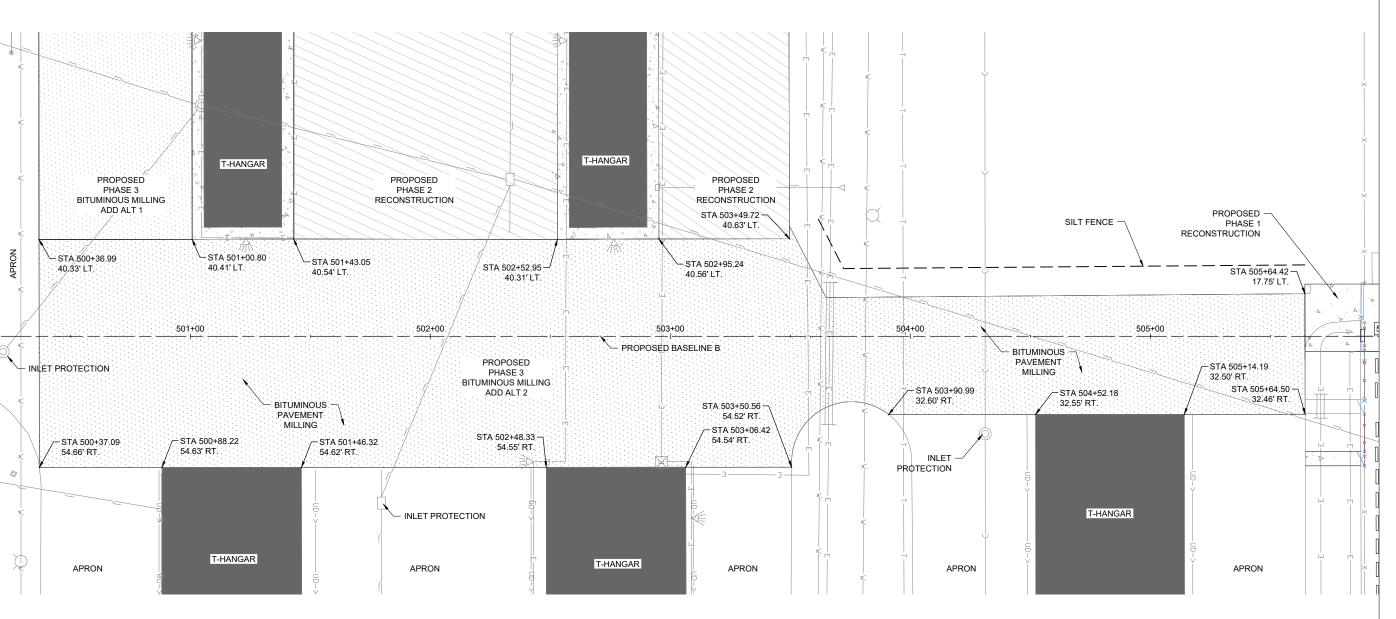



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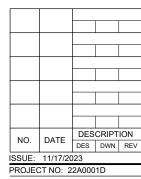
Illinois Licensed Professional Service Corporation #184-001084

COLES COUNTY AIRPORT AUTHORITY

RECONSTRUCT WEST AIRCRAFT T-HANGAR AREA PAVEMENTS

IDA No: MTO-4816 SBG Project No: N/A

Contract No. CO072




CAD FILE: C-113-DEMO-PH3-ADDALT.DWG

DESIGN BY: LDH 9/4/2023 DRAWN BY: JP 9/18/2023 REVIEWED BY: LDH 10/19/23

SHEET TITLE

DEMOLITION PLAN -PHASE 3


HALF SIZE SCALE: 1"= 40' FULL SIZE SCALE: 1"= 20'

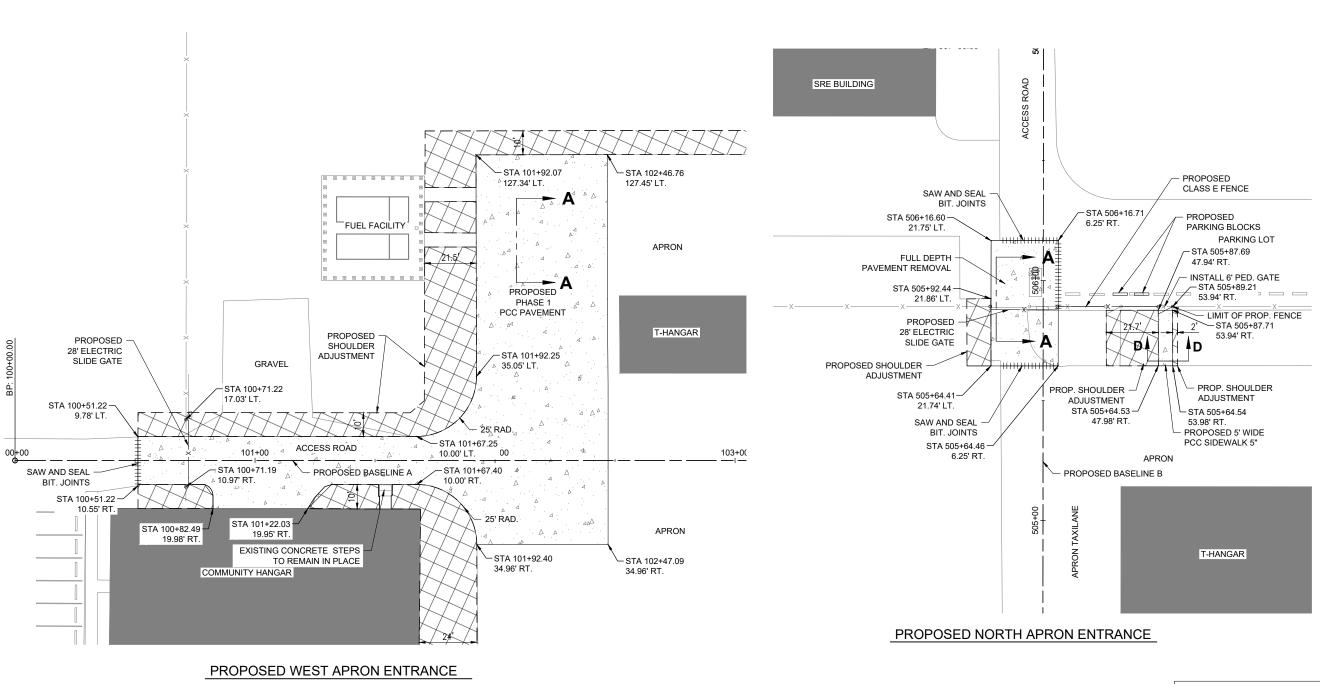

NOTES

- 1. SEE PROPOSED GRADING PLAN FOR ELEVATION INFORMATION
- 2. SEE ELECTRICAL PLANS FOR REMOVAL OF LIGHT POLES, ELECTRIC SLIDE GATE EQUIPMENT AND OTHER ASSOCIATED ELECTRICAL ITEMS.
- 3. SEE DRAINAGE PLAN FOR INSTALLATION OF PROPOSED DRAINAGE ITEMS.

LDER ADJUSTMENT			
PCC PAVEMENT			
SAW & SEAL BITUMINOUS JOINTS			
FENCE / ELECTRIC SLIDE GATE			

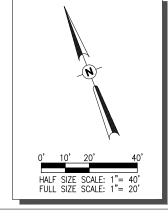



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RECONSTRUCT WEST AIRCRAFT T-HANGAR AREA PAVEMENTS

IDA No: MTO-4816 SBG Project No: N/A

Contract No. CO072

NO.	DATE	DES	CRIPT	ION	
110.	DAIL	DES	DWN	REV	
ISSUE: 11/17/2023					
PROJECT NO: 22A0001D					

PROJECT NO: 22A0001D

CAD FILE: C-121-PLAN-PH 1.DWG


DESIGN BY: LDH 9/4/2023

DRAWN BY: JP 9/18/2023

REVIEWED BY: LDH 10/19/23

SHEET TITLE

CONSTRUCTION PLAN - PHASE 1

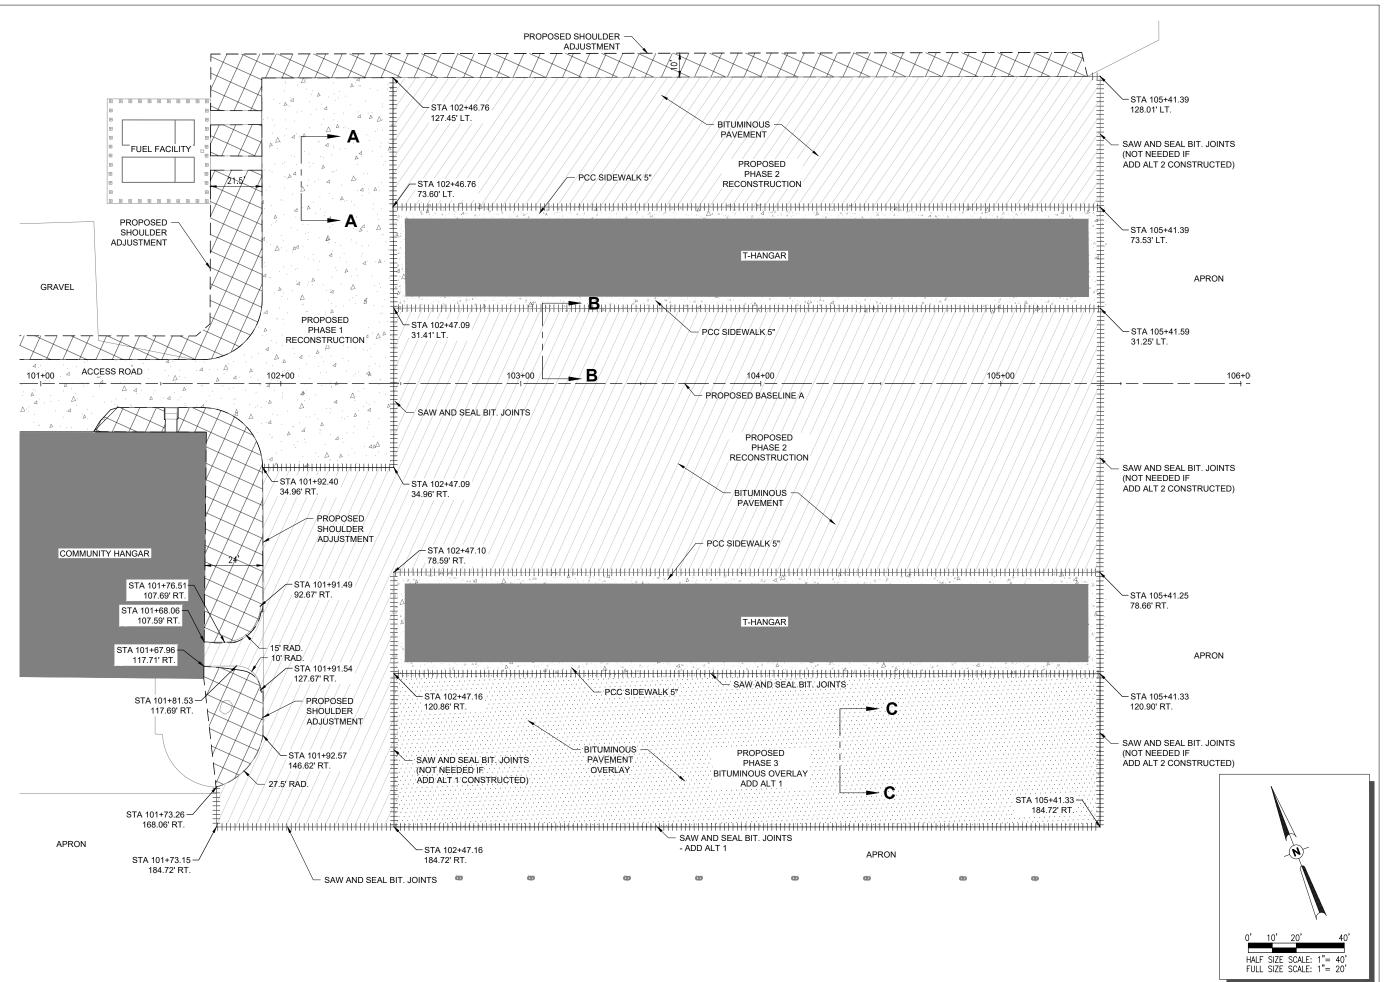



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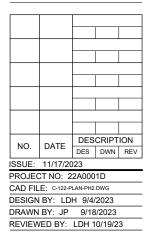
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COLES COUNTY AIRPORT
AUTHORITY
COLES COUNTY MEMORIAL AIRPORT

RECONSTRUCT WEST AIRCRAFT T-HANGAR AREA PAVEMENTS


IDA No: MTO-4816 SBG Project No: N/A

Contract No. CO072



SHEET TITLE

CONSTRUCTION PLAN - PHASE 2 AND 3

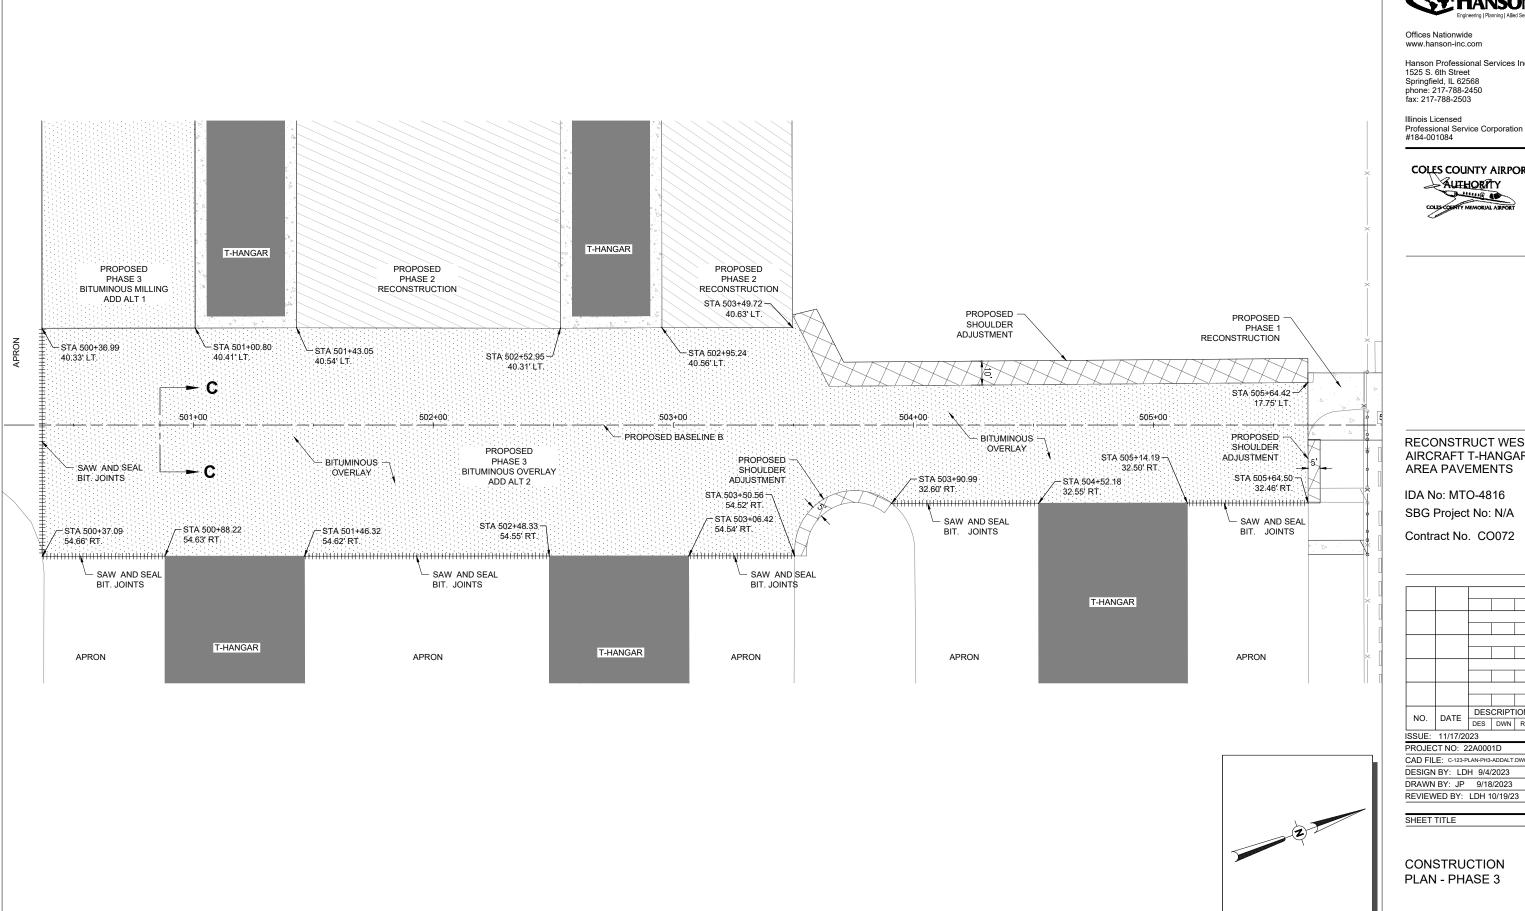



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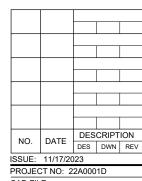
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COLES COUNTY AIRPORT AUTHORITY

RECONSTRUCT WEST AIRCRAFT T-HANGAR AREA PAVEMENTS

IDA No: MTO-4816 SBG Project No: N/A

Contract No. CO072




CAD FILE: C-123-PLAN-PH3-ADDALT.DWG

DESIGN BY: LDH 9/4/2023 DRAWN BY: JP 9/18/2023

SHEET TITLE

HALF SIZE SCALE: 1"= 40'

CONSTRUCTION PLAN - PHASE 3

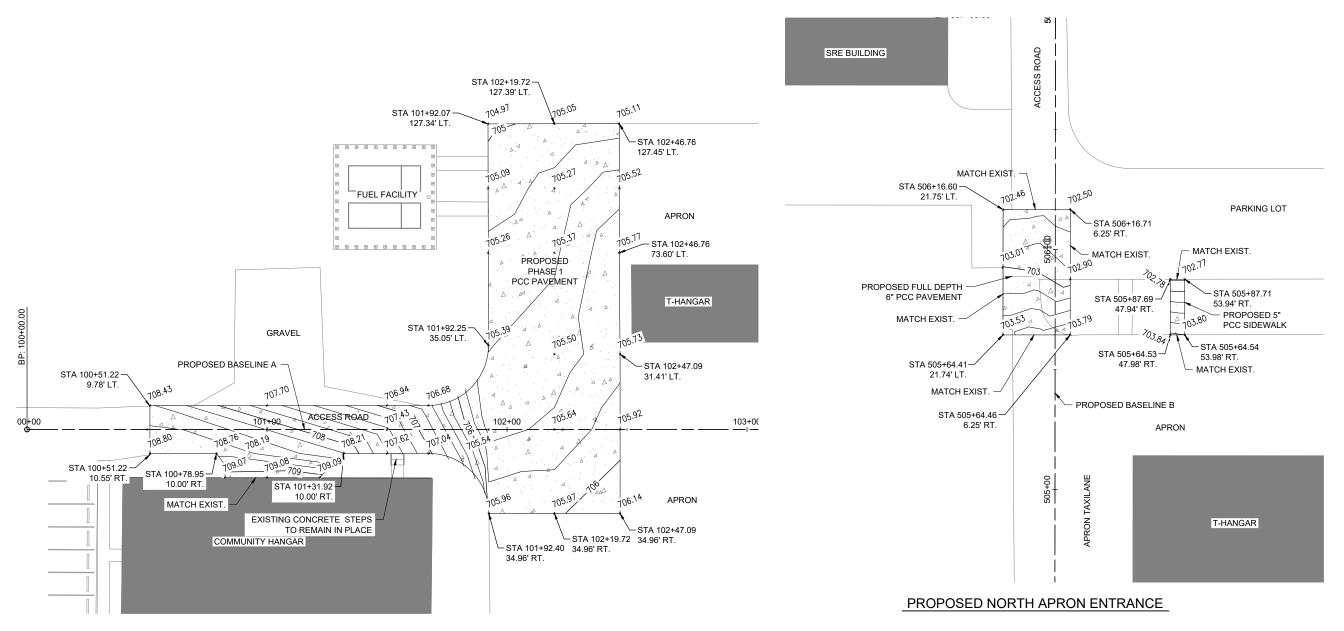


PROPOSED WEST APRON ENTRANCE

NOTES

- 1. SEE ELECTRICAL PLANS FOR REMOVAL OF LIGHT POLES, ELECTRIC SLIDE GATE EQUIPMENT AND OTHER ASSOCIATED ELECTRICAL ITEMS.
- 2. SEE DRAINAGE PLAN FOR INSTALLATION OF PROPOSED DRAINAGE ITEMS.

PROPOSED	LEGEND
44 *	PCC PAVEMENT
	FULL DEPTH BITUMINOUS PAVEMENT
	BITUMINOUS OVERLAY
705	1-FOOT CONTOURS
*103 ^{,75}	ELEVATION

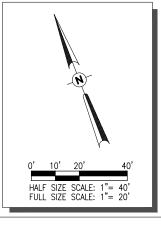



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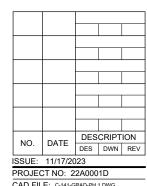
Illinois Licensed Professional Service Corporation #184-001084



RECONSTRUCT WEST AIRCRAFT T-HANGAR AREA PAVEMENTS

IDA No: MTO-4816 SBG Project No: N/A

Contract No. CO072




CAD FILE: C-141-GRAD-PH 1.DWG

DESIGN BY: LDH 9/4/2023 DRAWN BY: JP 9/18/2023 REVIEWED BY: LDH 10/19/23

SHEET TITLE

GRADING PLAN -PHASE 1

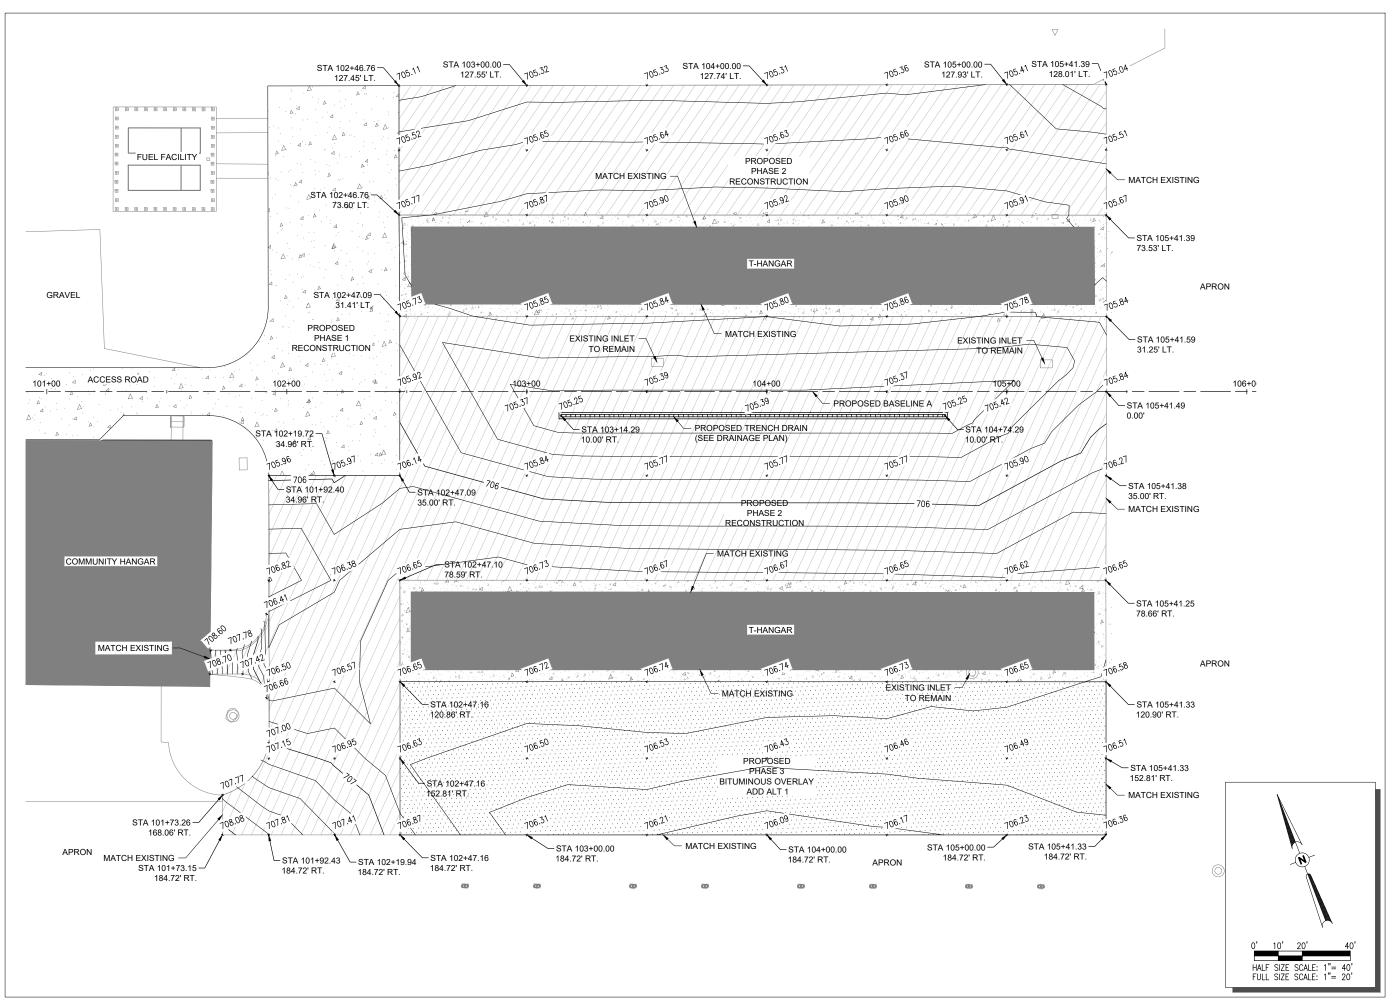



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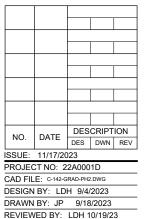
Illinois Licensed Professional Service Corporation #184-001084

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RECONSTRUCT WEST AIRCRAFT T-HANGAR AREA PAVEMENTS


IDA No: MTO-4816 SBG Project No: N/A

Contract No. CO072



SHEET TITLE

GRADING PLAN -PHASE 2 AND 3

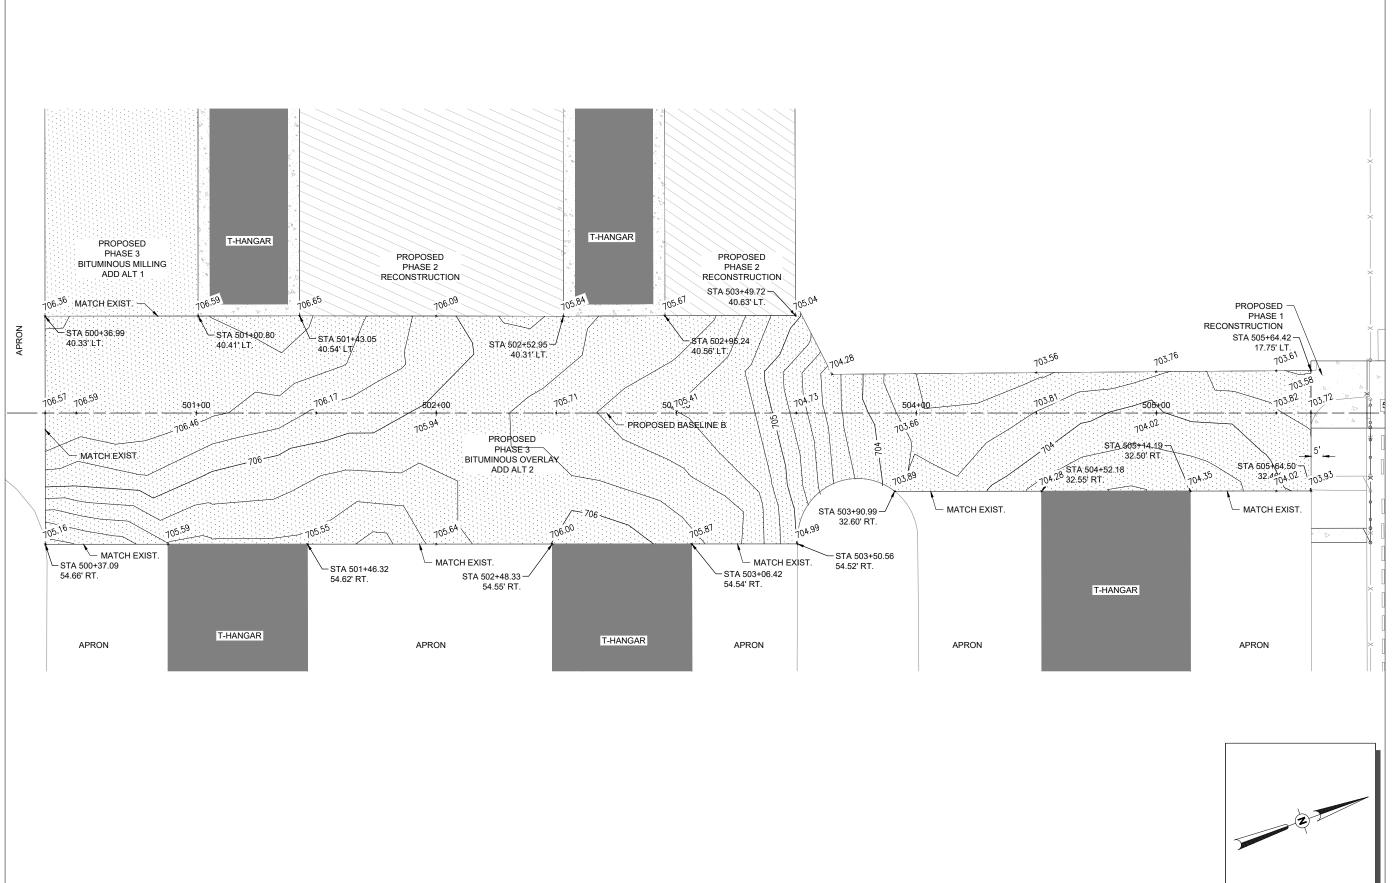



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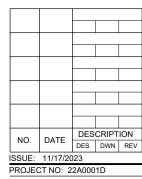
Illinois Licensed Professional Service Corporation #184-001084

COLES COUNTY AIRPORT AUTHORITY

RECONSTRUCT WEST AIRCRAFT T-HANGAR AREA PAVEMENTS

IDA No: MTO-4816 SBG Project No: N/A

Contract No. CO072



CAD FILE: C-143-GRAD-PH3-ADDALT.DWG

DESIGN BY: LDH 9/4/2023 DRAWN BY: JP 9/18/2023 REVIEWED BY: LDH 10/19/23

SHEET TITLE


HALF SIZE SCALE: 1"= 40'

GRADING PLAN -PHASE 3

NOTES

- 1. SEE PROPOSED GRADING PLAN FOR ELEVATION INFORMATION
- 2. SEE JOINTING DETAILS SHEET
- 3. ALL WELDED WIRE FABRIC TO BE 12" X 12"- W5 X W5, WITH 65,000 PSI YIELD STRENGTH. WIRE SIZE AND SPACING MAY BE ALTERED AS LONG AS A MINIMUM W4 WIRE SIZE IS USED AND THE SECTIONAL AREA IS A MINIMUM OF 0.05 SQUARE INCHES PER FOOT AND 12" MAX WIRE SPACING.
- 4. EDGE SPACING FOR THE WELDED WIRE FABRIC TO BE THREE (3) INCHES. A MINIMUM OF THREE (3) WIRES ARE TO BE PROVIDED IN ANY ONE DIRECTION IN EACH SLAB.
- WELDED WIRE FABRIC, JOINT REINFORCING, JOINT EXPANSION MATERIAL AND JOINT SAWING AND SEALING ARE INCIDENTAL TO P.C.C. PAVEMENT.

PROPOSED	LEGEND			
44.	PCC PAVEMENT			
———A———	TYPE A - THICKENED EDGE ISOLATION JOINT			
——В——	TYPE B - HINGED CONTRACTION JOINT			
c	TYPE C - DOWELED CONTRACTION JOINT			
D	TYPE D - DUMMY CONTRACTION JOINT			
——Е——	TYPE E - DOWELED CONSTRUCTION JOINT			
	REINFORCED SLAB			

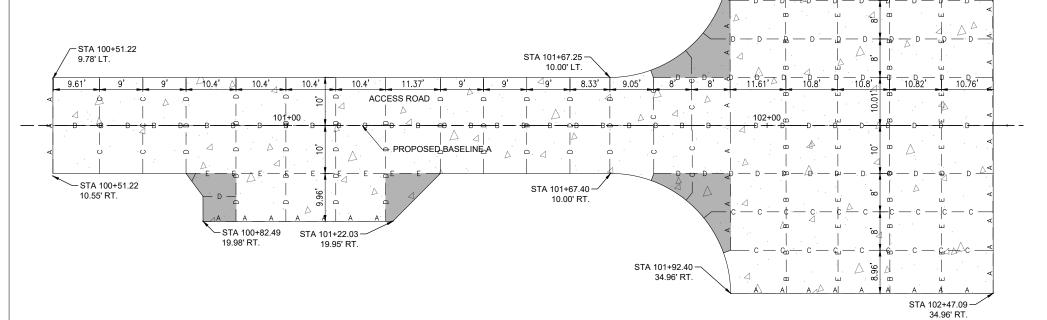

PROPOSED WEST APRON ENTRANCE

STA 101+92.25 -35.05' LT.


STA 101+92.07

127.34' LT.


STA 102+46.76-

127.45' LT.

10.68

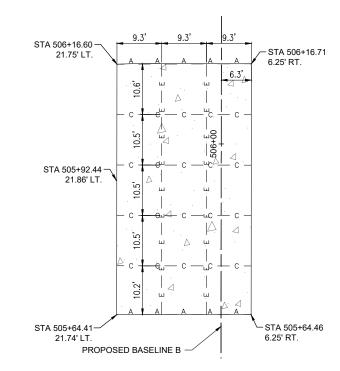

PROPOSED NORTH APRON ENTRANCE

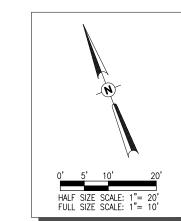

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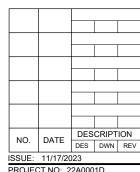
Illinois Licensed Professional Service Corporation #184-001084

COLES COUNTY AIRPORT AUTHORITY

RECONSTRUCT WEST AIRCRAFT T-HANGAR AREA PAVEMENTS

IDA No: MTO-4816 SBG Project No: N/A

Contract No. CO072





PROJECT NO: 22A0001D

CAD FILE: C-125-JNT-PH1.DWG DESIGN BY: LDH 9/4/2023 DRAWN BY: JP 9/18/2023 REVIEWED BY: LDH 10/19/23


SHEET TITLE

PCC JOINTING PLAN

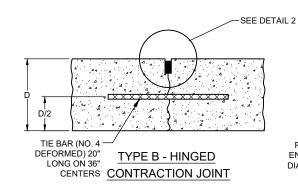


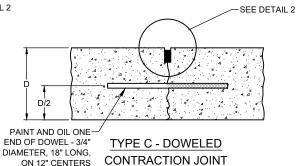


ON 12" CENTERS

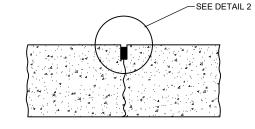


TYPE D - DUMMY CONTRACTION JOINT

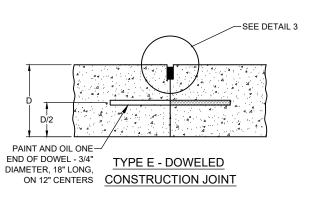


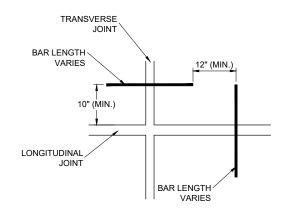


- 1. POSITION OF DOWELS AT EDGE OF JOINT TYPE C OR E
- ELIMINATE DOWEL OR TIE BAR FROM LONGITUDINAL JOINT AS NECESSARY TO MAINTAIN 12 INCH FROM END OF TRANSVERSE DOWEL BARS

DOWEL PLAN VIEW

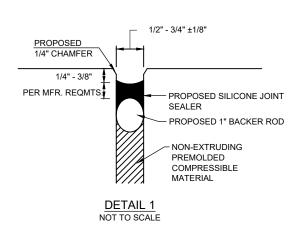

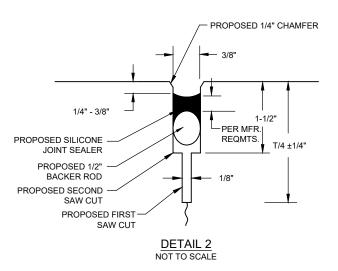

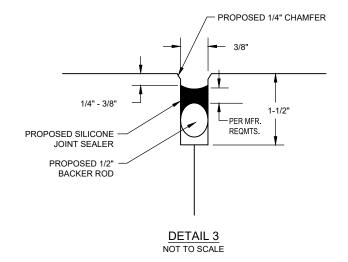

JOINT SEALING DETAILS

NOT TO SCALE

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RECONSTRUCT WEST AIRCRAFT T-HANGAR AREA PAVEMENTS


IDA No: MTO-4816 SBG Project No: N/A

Contract No. CO072

NO.	NO. DATE DESCRI			ION
INO.	DATE	DES	DWN	REV
ISSUE:	11/17/20	23		
PROJEC	CT NO: 2	2A000	1D	
CAD FIL	E: C-56	1-JNT.	DWG	
DESIGN BY: LDH 9/4/2023				
DRAWN	BY: JP	9/18	3/2023	
REVIEW	/ED BY:	LDH 1	0/19/2	3

PROPOSED JOINT **DETAILS**

SHEET TITLE

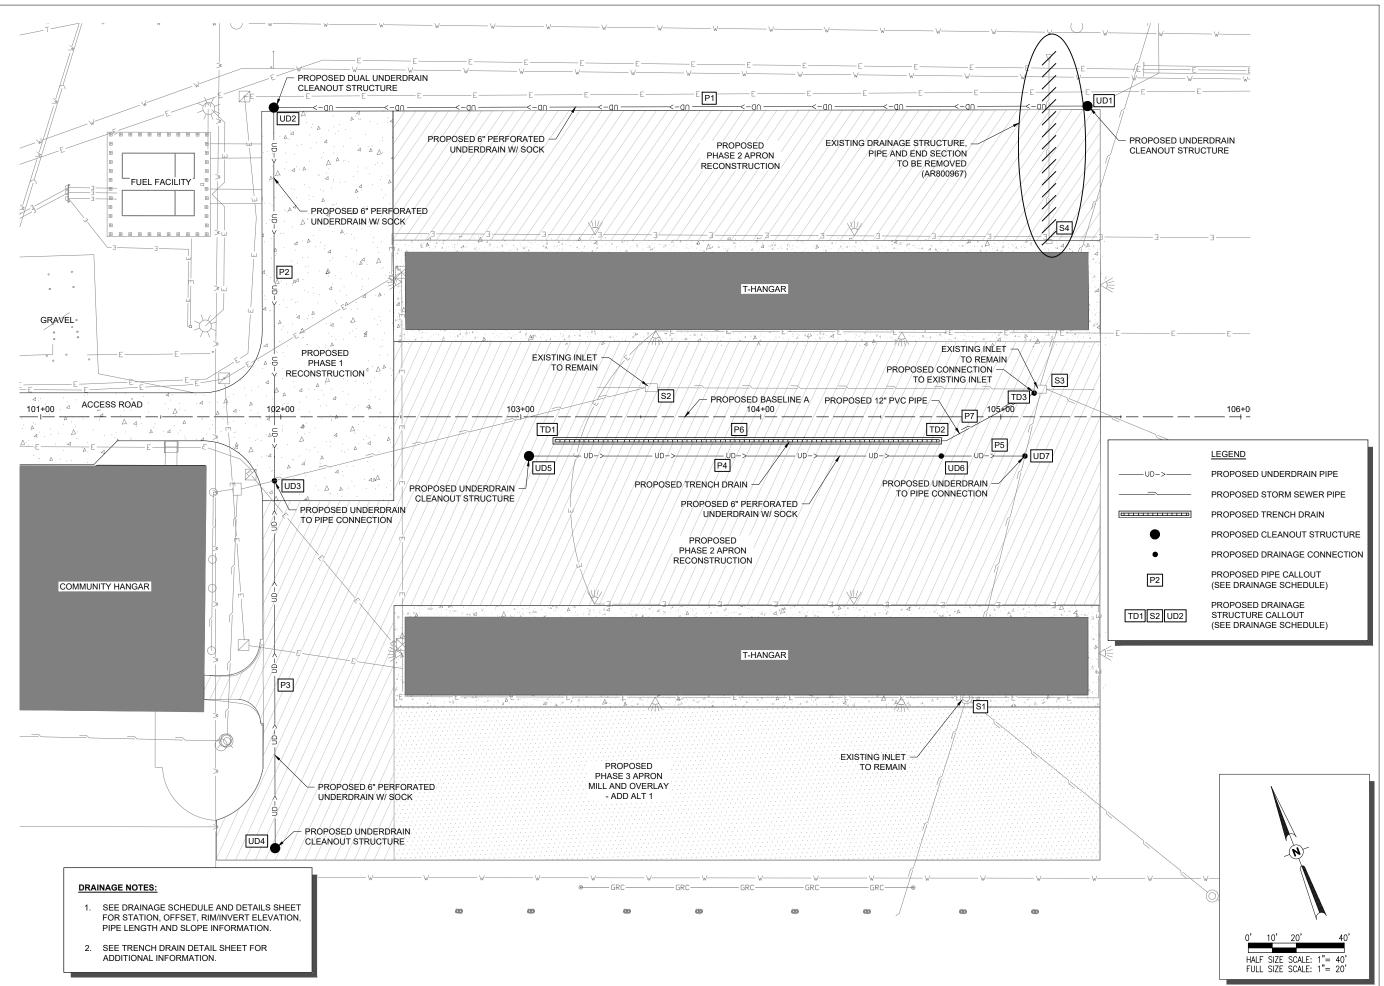



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COLES COUNTY AIRPORT
AUTHORITY
COLES COUNTY MEMORIAL AIRFORT

RECONSTRUCT WEST AIRCRAFT T-HANGAR AREA PAVEMENTS

IDA No: MTO-4816 SBG Project No: N/A

Contract No. CO072

NO. DATE DESCRIPTION DES DWN REV ISSUE: 11/17/2023

PROJECT NO: 22A0001D

CAD FILE: C-162-DRN.DWG

DESIGN BY: LDH 9/4/2023


DRAWN BY: JP 9/18/2023

REVIEWED BY: LDH 10/19/23


SHEET TITLE

DRAINAGE PLAN


UNDERDRAIN ALONG PAVEMENT EDGE

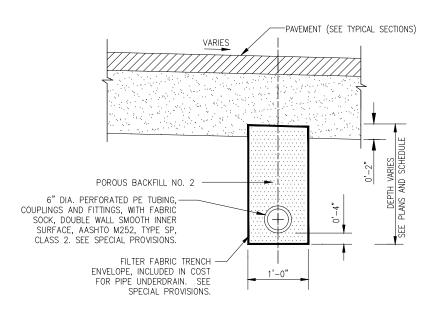

UNDERDRAIN UNDER PAVEMENT

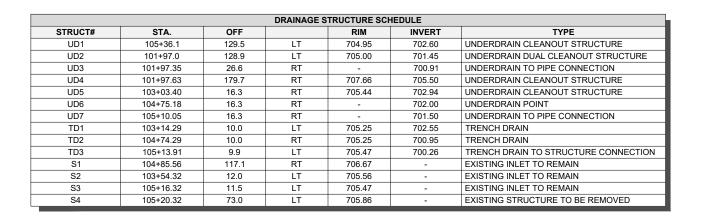

	DRAINAGE PIPE SCHEDULE						
PIPE NO.	FROM	то	L.F.	SLOPE	TYPE		
P1	UD1	UD2	339.0	0.34%	6" PERFORATED UNDERDRAIN W/SOCK		
P2	UD2	UD3	155.5	0.35%	6" PERFORATED UNDERDRAIN W/SOCK		
P3	UD4	UD3	153.1	1.50%	6" PERFORATED UNDERDRAIN W/SOCK		
P4	UD5	UD6	171.8	0.55%	6" PERFORATED UNDERDRAIN W/SOCK		
P5	UD6	UD7	35.0	1.43%	6" PERFORATED UNDERDRAIN W/SOCK		
P6	TD1	TD2	160.0	1.00%	TRENCH DRAIN (12" EQUIVALENT)		
P7	TD2	TD3	43.8	1.57%	12" PVC		

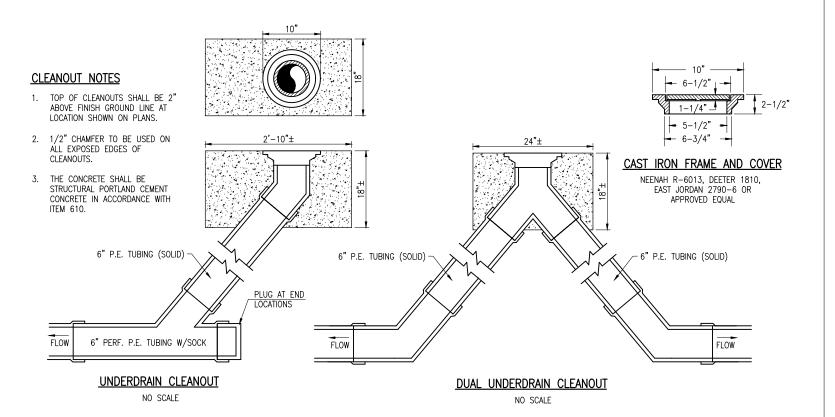

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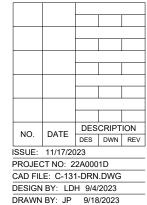
Illinois Licensed Professional Service Corporation #184-001084

COLES COUNTY AIRPORT
AUTHORITY
COLES CONTY MEMORIAL AIRPORT

RECONSTRUCT WEST AIRCRAFT T-HANGAR AREA PAVEMENTS

IDA No: MTO-4816 SBG Project No: N/A

Contract No. CO072



DRAINAGE SCHEDULES AND DETAILS


SHEET TITLE

REVIEWED BY: KLB3H 10/08/2319

TRENCH DRAIN DETAIL

TRENCH DRAIN.


EXISTING INLET -

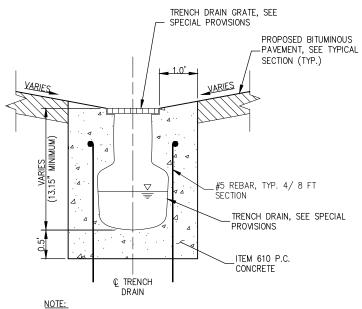

12 INCHES P.C. CONCRETE AROUND ALL SIDES OF TRENCH DRAIN, SEE PLAN.

SECTION B-B


TRENCH DRAIN

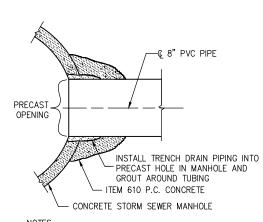

<u>NOTES</u> 1. HOLE FOR TRENCH DRAIN PIPING TO BE PRECAST INTO MANHOLE AT ELEVATION SPECIFIED IN TRENCH DRAIN SCHEDULE.

2.CONNECTIONS INCIDENTAL TO UNDERDRAIN.

TRENCH DRAIN CONCRETE COLLAR AND GROUT CONNECTION

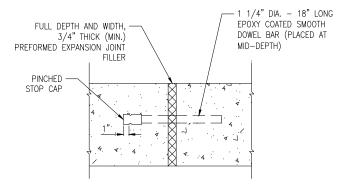

NOTES:

- 1. CONTRACTION JOINTS TO BE LOCATED AT NO GREATER THAN 12.5' ON CENTER. CONTRACTION JOINTS ARE TO BE EITHER 3/4" THICK PREFORMED JOINT FILLER, SAWED 2" DEEP AT 4 TO 24 HOURS OR FORMED WITH A 1/8" THICK STEEL TEMPLATE 2" DEEP.
- 2. EXPANSION JOINTS TO BE LOCATED AT 50' MAX SPACING.
- ALL EXPANSION AND SAWED CONTRACTION JOINTS SHALL BE SEALED WITH HOT-POURED SEALANT, ASTM D6690, TYPE II, COST INCIDENTAL TO TRENCH

EXPANSION JOINT DETAIL



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> COLES COUNTY AIRPORT AUTHORITY

RECONSTRUCT WEST AIRCRAFT T-HANGAR AREA PAVEMENTS

IDA No: MTO-4816 SBG Project No: N/A

Contract No. CO072

DESCRIPTION NO. DATE DES DWN REV ISSUE: 11/17/2023

PROJECT NO: 22A0001D

CAD FILE: C-503-DRN.DWG DESIGN BY: LDH 9/4/2023 DRAWN BY: JP 9/18/2023

REVIEWED BY: LDH 10/19/23

SHEET TITLE

TRENCH DRAIN **DETAILS**



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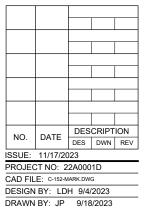
Illinois Licensed Professional Service Corporation #184-001084



RECONSTRUCT WEST AIRCRAFT T-HANGAR AREA PAVEMENTS

IDA No: MTO-4816 SBG Project No: N/A


Contract No. CO072



SHEET TITLE

MARKING PLAN

REVIEWED BY: LDH 10/19/23

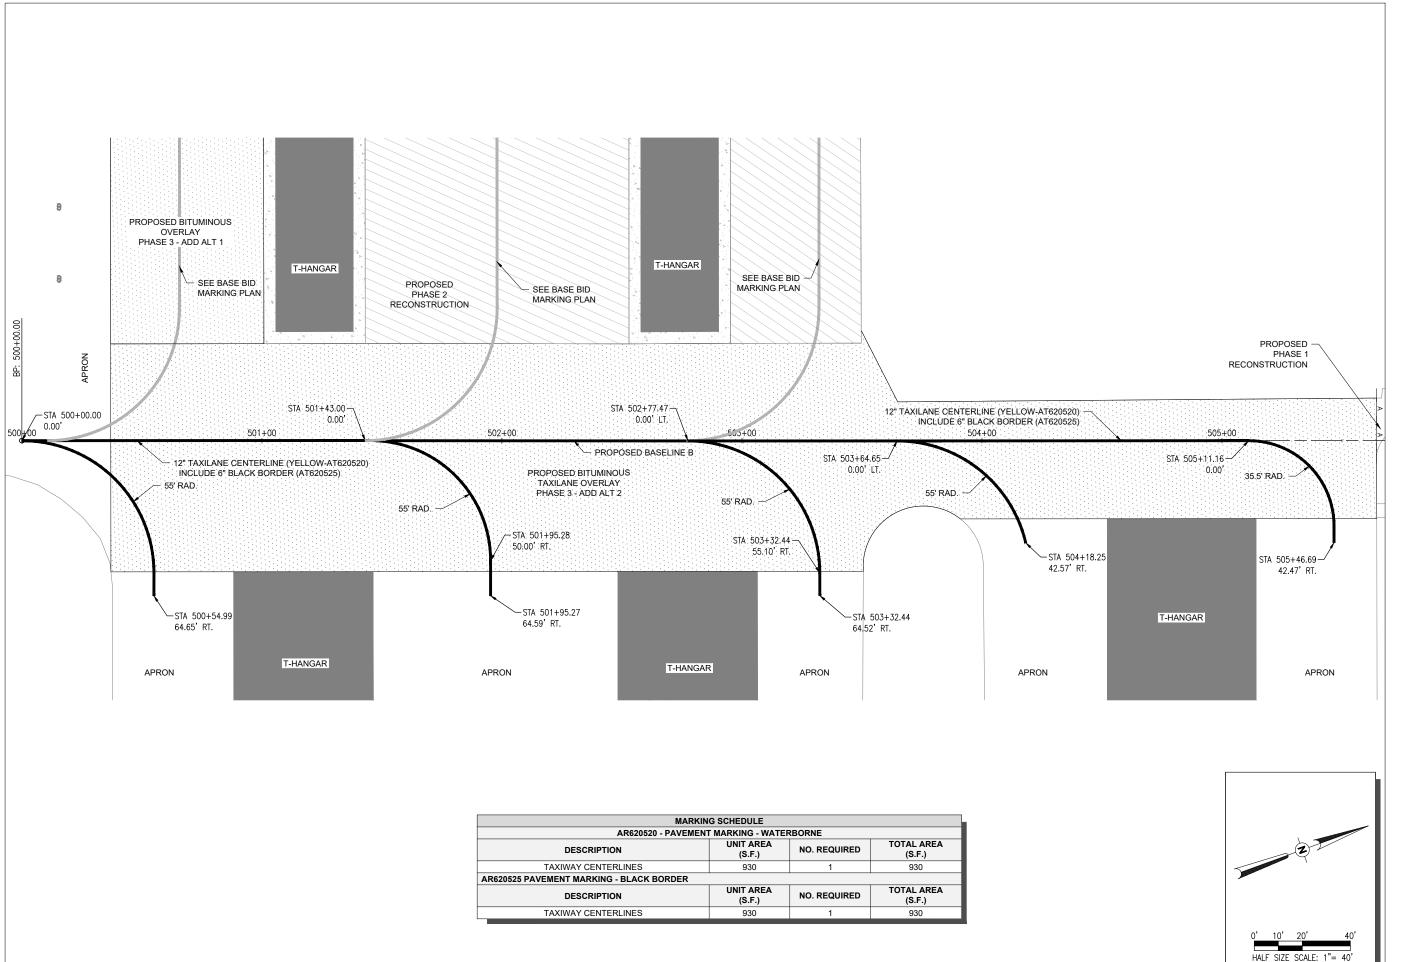



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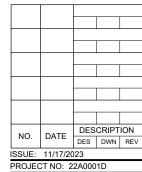
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RECONSTRUCT WEST AIRCRAFT T-HANGAR AREA PAVEMENTS

IDA No: MTO-4816 SBG Project No: N/A

Contract No. CO072



CAD FILE: C-153-MARK-ADDALT.DWG
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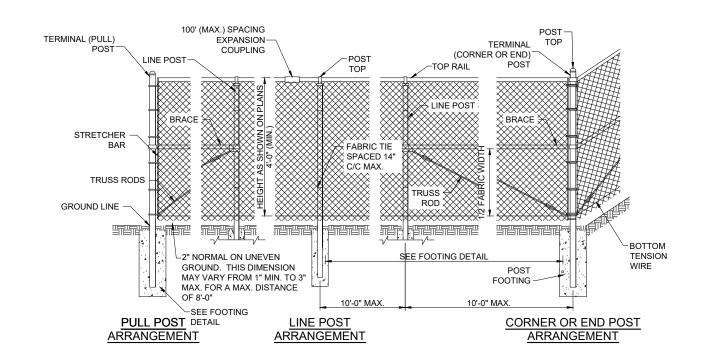
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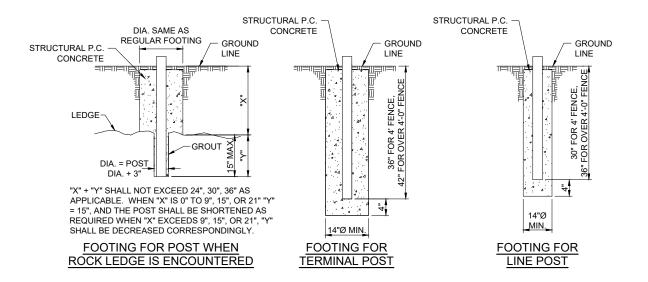
MARKING PLAN -PHASE 3 BE HOOVER FENCE COMPANY'S BULLDOG CHAIN LINK GATE HINGE OR APPROVED EQUAL.


NOTE: 180° HINGES FOR GATES SHALL NOT BE AN

"ADJUSTABLE ARM HINGE." INSTEAD HINGE SHALL

PEDESTRIAN GATE, 6 FOOT WIDE





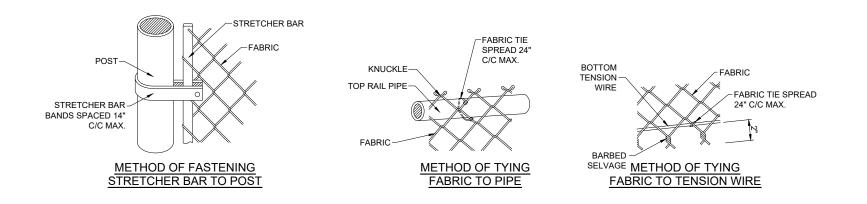



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IDA No: MTO-4816 SBG Project No: N/A

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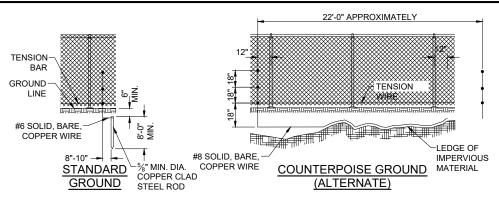
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ISSUE: 11/17/2023							
PROJECT NO: 22A0001D							

CAD FILE: C-501-FEN.DWG DESIGN BY: LDH 9/4/2023 DRAWN BY: JP 9/18/2023

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SHEET TITLE


FENCE DETAILS



GROUNDING NOTE:

PROTECTIVE ELECTRICAL GROUND

CONTINUOUS FENCE SHALL BE GROUNDED AT INTERVALS NOT EXCEEDING 500 FT IN URBAN AREAS AND 1,000 FT IN RURAL AREAS. THERE SHALL BE A GROUND WITHIN 100 FT OF GATES IN EACH SECTION OF THE FENCE ADJACENT TO THE GATE. FENCE UNDER A POWER LINE SHALL BE GROUNDED BY THREE GROUNDS; ONE DIRECTLY UNDER THE CROSSING AND ONE ON EACH SIDE 25 FT TO 50 FT AWAY. A SINGLE GROUND SHALL BE LOCATED DIRECTLY UNDER EACH TELEPHONE WIRE OR CABLE CROSSING. THE COUNTERPOISE GROUND SHALL BE USED ONLY WHERE IT IS IMPOSSIBLE TO DRIVE A GROUND ROD. THE GROUND WIRE SHALL BE CONNECTED TO THE FABRIC AND TENSION WIRE WITH UL LISTED GROUNDING CONNECTORS OF CAST BRONZE BODY AND BRONZE OR STAINLESS STEEL BOLTS AND WASHERS. GROUNDING CONNECTORS SHALL BE SIZED AND SUITABLE FOR THE RESPECTIVE APPLICATION. CONNECTIONS TO GROUND RODS SHALL BE WITH UL LISTED GROUNDING CONNECTORS SUITABLE FOR EXOTHERMIC WELD TYPE CONNECTORS, CADWELD BY ERICO PRODUCTS, INC., DIRECT BURIAL IN FARTH OR SOLON OHIO (PHONE 1-800-248-9353) THERMOWELD BY CONTINENTAL INDUSTRIES INC. TULSA OKLAHOMA (PHONE 918-663-1440) OR ULTRAWELD BY HARGER, GRAYSLAKE, ILLINOIS (PHONE 1-800-842-7437). EXOTHERMIC WELD CONNECTIONS SHALL BE INSTALLED IN CONFORMANCE WITH THE RESPECTIVE MANUFACTURER'S DIRECTIONS USING MOLDS SUITABLE FOR EACH RESPECTIVE APPLICATION. GROUND RODS SHALL BE 5/8-IN. DIAMETER BY 8 FT LONG (MINIMUM), UL-LISTED, COPPER-CLAD. THE GROUND WIRE USED TO BOND THE FENCE FABRIC AND TENSION WIRE TO THE GROUND ROD SHALL BE #6 AWG BARE SOLID COPPER CONDUCTOR.

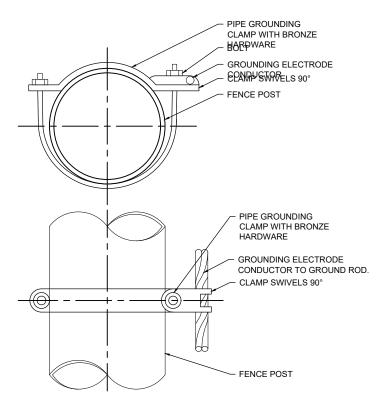

PIPE GROUNDING CLAMP TABLE (OR APPROVED EQUAL)					
BURNDY CAT. NO.	THOMAS & BETTS CAT. NO.	PIPE SIZE			
GAR3902-BU	3902BU	1/2" - 1"			
GAR3903-BU	3903BU	1 1/4" - 2"			
GAR3904-BU	3904BU	2 1/2" - 3 1/2"			
GAR3905-BU	3905BU	4" - 5"			
GAR3906-BU	3906BU	6"			

- PIPE GROUNDING CLAMPS SHALL HAVE BRONZE HARDWARE, BE CORROSION RESISTANT, SUITABLE FOR DIRECT BURIAL IN EARTH OR CONCRETE, & UL467 LISTED.
- CONNECT FENCE POST TO GROUND ROD WHERE ACCESS TO FENCE FABRIC IS NOT AVAILABLE TO ACCOMMODATE PROTECTIVE ELECTRICAL GROUND AT A GATE.

FENCE POST GROUNDING CLAMP DETAIL NOT TO SCALE

GENERAL NOTES

- 1 FABRIC THE FABRIC MAY BE WOVEN WITH FITHER ZINC COATED STEEL WIRE OR ALLIMINUM-ALLOY WIRE IN A 2-INCH MESH, COATED WIRE AND ALUMINUM-ALLOY SHALL HAVE A DIAMETER OF 0.148 INCHES. THE FABRIC SHALL MEET THE FOLLOWING REQUIREMENTS:
 - ZINC-COATED STEEL FABRIC SHALL CONFORM TO THE REQUIREMENTS OF AASHTO M 181, TYPE 1, CLASS D. THE FABRIC SHALL BE GALVANIZED AFTER WEAVING
- B. ALUMINUM-COATED STEEL FABRIC SHALL CONFORM TO THE REQUIREMENTS OF AASHTO M 181 TYPE II. THE UNIT WEIGHT OF THE COATING SHALL BE DETERMINED IN ACCORDANCE WITH AASHTO T 213. THE ALUMINUM-COATED STEEL FABRIC SHALL BE GIVEN A CLEAR ORGANIC COATING AFTER FABRICATION
- C. ALUMINUM-ALLOY FABRIC SHALL BE MADE FROM WIRE CONFORMING TO THE REQUIREMENTS OF AASHTO M 181 TYPE III.
- D. VINYL-COATED FABRIC IS NOT INCLUDED.
- E. ZINC-5% ALUMINUM-MISCHMETAL ALLOY-COATED STEEL SHALL CONFORM TO THE REQUIREMENTS OF ASTM F 1345, CLASS 2.
- 2. METAL POSTS METAL POSTS (LINE, CORNER, END, PULL AND GATE POSTS) SHALL BE THE SHAPES, DIMENSIONS, AND WEIGHT SHOWN IN THE TABLES WITHIN IDOT STANDARD 664001-02- CHAIN LINK FENCE. FOR THE SHAPES IDENTIFIED BELOW
 - A. STEEL PIPE, TYPE A. SHALL BE HOT-DIPPED GALVANIZED CONFORMING TO THE REQUIREMENTS OF ASTM F 1083.
 - STEEL PIPE, TYPE B, SHALL BE MANUFACTURED FROM COLD ROLLED ELECTRIC RESISTANCE WELDED, HEATED AND TEMPERED STEEL. THE STEEL STRIP USED IN THE MANUFACTURE OF THE PIPE SHALL CONFORM TO ASTM A 569 OR ASTM A 607. THE WALL THICKNESS SHALL NOT BE LESS THAN THAT SHOWN IN THE TABLES. THE PRODUCT OF THE YIELD STRENGTH AND SECTION MODULUS OF THE PIPE SHALL NOT BE LESS THAN THAT OF THE PIPE MEETING THE REQUIREMENTS OF ASTM F 1083.

THE PROTECTIVE COATINGS SHALL BE AS FOLLOWS:

- EXTERNAL AND INTERNAL HOT-DIPPED ZINC COATING ACCORDING TO ASTM F1083.
- EXTERNAL COATING SHALL BE IN-LINE HOT-DIPPED ZINC COATING AFTER FABRICATION FOLLOWED BY A CHROMATE CONVERSION COATING WITH AN ELECTROSTATIC THERMOPLASTIC FINISH. THE ZINC COATING SHALL BE NOT LESS THAN .9 OUNCES PER SQUARE FOOT OF SURFACE. THE CHROMATE COATING WEIGHT SHALL BE 30 MICROGRAMS + .0002 INCHES.
- THE INTERNAL SURFACE SHALL BE GIVEN CORROSION PROTECTION BY IN-LINE APPLICATION OF A FULL ZINC BASE ORGANIC COATING AFTER FABRICATION. THE COATING SHALL BE 87% ZINC POWDER BY WEIGHT AND CAPABLE OF PROVIDING GALVANIC PROTECTION. THE THICKNESS SHALL BE A MINIMUM OF .5 MIL. THE EXTERNAL PROTECTIVE COATING SHALL BE CAPABLE OF WITHSTANDING THE

EXPOSURE TEST ASTM DESIGNATION EXPOSURE TIME SALT SPRAY ASTM B 117 1000 HRS MIN HUMIDITY ASTM D 2247 500 HRS MIN WEATHERING ASTM G 23 500 HRS, MIN.

THE INTERNAL PROTECTIVE COATING SHALL BE CAPABLE OF WITHSTANDING EXPOSURE TO SALT SPRAY, ASTM B 117, FOR A MINIMUM

- C. STEEL PIPE, TYPE C, SHALL BE MANUFACTURED BY ROLLED FORMING ALUMINIZED STEEL TYPE 2 STRIP AND ELECTRIC RESISTANCE WELDING INTO TUBULAR FORM. THE OUTSIDE OF THE WELD AREA SHALL BE METALLIZED WITH COMMERCIALLY PURE ALUMINUM TO A THICKNESS SUFFICIENT TO PROVIDE RESISTANCE TO CORROSION EQUAL TO THAT OF THE REMAINDER OF THE OUTSIDE OF THE TUBE. THE ALUMINUM COATING WEIGHT SHALL BE A MINIMUM OF 0.75 OUNCES PER SQUARE FOOT, TRIPLE SPOT TEST, 0.70 OUNCES PER SQUARE FOOT SINGLE SPOT TEST, AS MEASURED IN ACCORDANCE WITH ASTM A 428. THE STEEL STRIP USED IN THE MANUFACTURE OF THE PIPE SHALL CONFORM TO ASTM A 787 TYPE 1 AND SHALL HAVE A MINIMUM YIELD STRENGTH OF 50 000 P.S.L. THE WEIGHT OF THE PIPE SHALL NOT BE LESS THAN THAT SHOWN ON THE PLANS AND THE PRODUCT OF THE YIELD STRENGTH AND SECTION MODULUS OF THE PIPE SHALL NOT BE LESS THAN THAT OF PIPE MEETING THE REQUIREMENTS OF ASTM A 120.
- SQUARE HOLLOW STRUCTURAL TUBING SHALL CONFORM TO THE REQUIREMENTS OF ASTM A 500, GRADE B OR ASTM A 501, THE TUBING SHALL BE GALVANIZED INSIDE AND OUTSIDE IN ACCORDANCE WITH AASHTO M 111, USING ZINC OF ANY GRADE CONFORMING TO THE REQUIREMENT OF AASHTO M 120. THE ZINC COATING SHALL NOT BE LESS THAN 2.0 OUNCES PER SQUARE FOOT OF SURFACE.
- E. STRUCTURAL SHAPES SHALL BE EXCLUDED
- 3. BOTTOM TENSION WIRE THE BOTTOM TENSION WIRE SHALL BE #9 GAUGE GALVANIZED STEEL WIRE MEETING THE REQUIREMENTS OF AASHTO M 181, THE WIRE SHALL BE STRETCHED TIGHT WITH GALVANIZED TURNBUCKLES SPACED AT INTERVALS NOT MORE THAN 1,000 FEET. THE ZINC COATING SHALL BE NOT LESS THAN 12 OUNCES PER SQUARE FOOT OF SURFACE.
- 4. METAL BRACES METAL BRACES SHALL HAVE THE SHAPES SHOWN ON THE PLANS AND AT THE DIMENSIONS SHOWN WITHIN THE TABLE WITHIN IDOT STANDARD 664001-02 - CHAIN LINK FENCE. THEY SHALL BE ACCORDING TO THE SPECIFICATIONS FOR METAL POSTS, EITHER STEEL PIPE, STRUCTURAL SHAPE OR ROLLED FORMED SECTION AND SHALL BE GALVANIZED AS SPECIFIED FOR METAL POSTS.
- 5. GATE THE GATE TYPE AND SIZE SHALL CONFORM TO THE DETAILS SHOWN ON THE PLANS AND AS PROVIDED IN THE SPECIAL PROVISIONS.
- 6. STRUCTURAL P.C. CONCRETE THE STRUCTURAL P.C. CONCRETE SHALL CONFORM TO IDOT CLASS SI CONCRETE. A HIGH EARLY STRENGTH CONCRETE MAY BE USED. THE CONCRETE MIX DESIGN SHALL BE APPROVED FOR USE BY THE ENGINEER PRIOR TO USING IT ON THE PROJECT.
- 7. BOLTS AND NUTS ALL BOLTS AND NUTS SHALL CONFORM TO THE REQUIREMENTS OF ASTM A 307 AND SHALL BE ZINC-COATED IN ACCORDANCE WITH AASHTO M 298, CLASS 50 OR ASTM A 153.
- 8. WIRE TIES AND TENSION WIRE WIRE FABRIC TIES, WIRE TIES, AND TENSION WIRE FURNISHED FOR USE IN CONJUNCTION WITH A GIVEN TYPE OF FABRIC SHALL BE OF THE SAME MATERIAL AND COATING WEIGHT IDENTIFIED WITH THE FABRIC TYPE. ZINC-COATED STEEL WIRE, ALUMINUM-COATED STEEL WIRE, AND ALUMINUM ALLOY WIRE SHALL CONFORM TO REQUIREMENTS OF AASHTO M 181, TYPE I CLASS 2 OR TYPE II. THE TOP TENSION WIRE WILL BE DELETED IN LIEU OF THE TOP RAIL WHEN TOP RAIL IS REQUIRED. THE BOTTOM TENSION WIRE IS
- 9. TOP RAILS THE TOP RAILS SHALL BE 1.66 INCH O.D., GALVANIZED OR ALUMINUM COATED PIPE HAVING A MINIMUM BENDING STRENGTH OF 202 LBS. AT THE CENTER OF A 10 FT. SPAN AND WILL BE REQUIRED.
- 10. PRIVACY SLATS PROPOSED CHAIN-LINK FENCING AND GATE SHALL INCLUDE VERTICAL POLYMER PRIVACY INSERT SLATS, PROVIDING VISUAL CLOSURE OF A MINIMUM OF 70%. THE SLATS SHALL EITHER BE PRE-INSTALLED INTO THE CHAIN-LINK MESH OR INSTALLED AFTER THE CHAIN-LINK FENCE INSTALLATION. THE INSERT SLATS SHALL MEET ASTM F3000/F3000M. THE LENGTH OF THE SLAT INSERTS SHALL COVER THE FULL DIAMOND PORTION OF THE CHAIN-LINK FABRIC, AND SHALL NOT PROTRUDE ABOVE THE TOP RAIL OR BELOW THE BOTTOM TENSION WIRE. THE FENCE FRAMEWORK SHALL BE DESIGNED TO SUPPORT THE WIND LOADING CALCULATED WITH THE INSERT SLATS INSTALLED, WHICH MAY AFFECT THE LINE POST SIZE AND SPACING. COLOR OF THE INSERT SLATS SHALL BE BLACK.



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COLES COUNTY AIRPORT AUTHORITY

RECONSTRUCT WEST AIRCRAFT T-HANGAR AREA PAVEMENTS

IDA No: MTO-4816 SBG Project No: N/A

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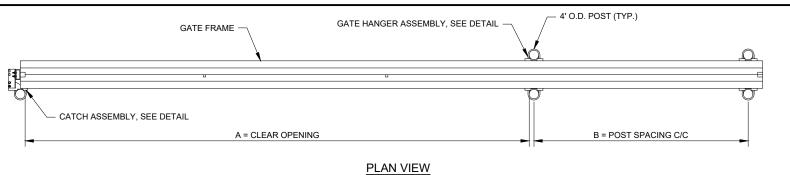
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CAD FILE: C-501-FEN.DWG DESIGN BY: 1 DH 9/4/2023 DRAWN BY: JP 9/18/2023

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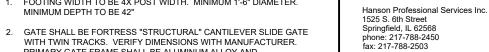
SHEET TITLE

FENCE NOTES



NOTES

- 1. FOOTING WIDTH TO BE 4X POST WIDTH. MINIMUM 1'-6" DIAMETER. MINIMUM DEPTH TO BE 42"
- WITH TWIN TRACKS. VERIFY DIMENSIONS WITH MANUFACTURER. PRIMARY GATE FRAME SHALL BE ALUMINUM ALLOY AND RECTANGULAR IN SHAPE. GATE MESH SHALL MATCH FENCE MESH SIZE AND MATERIAL. (2-INCH MESH, 9 GAUGE). SEE SPECS
- 3. ALL SIGN INSTALLATIONS SHALL BE CONSIDERED INCIDENTAL TO THE FENCE & GATE INSTALLATIONS. SEE SIGNAGE DETAILS



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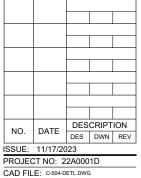
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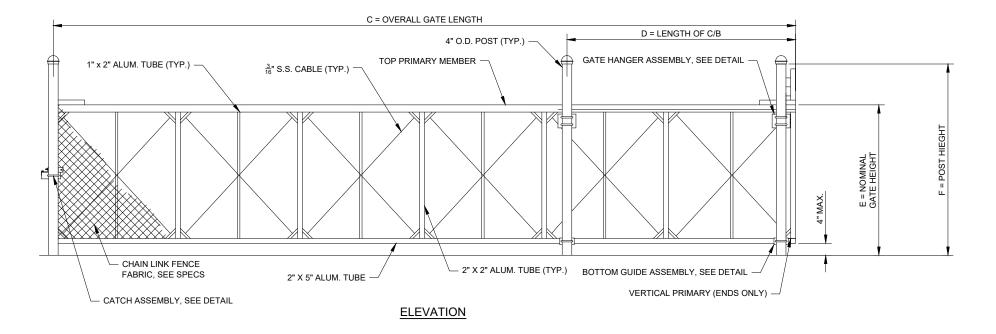


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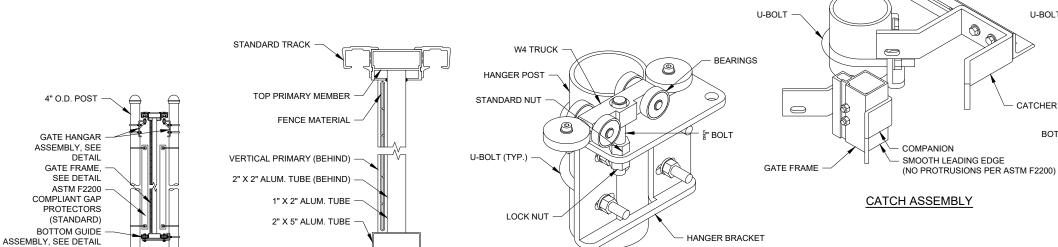
DESIGN BY: LDH 9/4/2023 DRAWN BY: JP 9/18/2023 REVIEWED BY: LDH 10/19/23

SHEET TITLE

28 FOOT SLIDE GATE DETAILS



CATCH POST



U-BOLT

CATCHER

BOTTOM GUIDE BRACKET

	NOMINAL GATE SIZE **	28' W X 8' H
Α	CLEAR OPENING	28'-0"
В	COUNTERBALANCE POST SPACING C/C	13'-1"
С	OVERALL GATE LENGTH	42'-0"
D	COUNTERBALANCE LENGTH	14'-0"
Ε	NOMINAL GATE HEIGHT *	8'-0"
F	POST HEIGHT	9'-6"

CRITICAL DIMENSION CHART

BOTTOM GUIDE ASSEMBLY

HANGER POST

GUIDE

WHEELS

UL 325

COMPLIANT WHEEL COVERS

(STANDARD)

GATE FRAME SECTION GATE HANGER ASSEMBLY

EXCLUDES BARBED WIRE ARM CONFIRM ALL DIMENSIONS WITH GATE MFR.

29

ASSEMBLY SECTION

	ELECTRICAL ABBREVIATIONS
A.F.F.	ABOVE FINISHED FLOOR
A, AMP	AMPERES
ATS	AUTOMATIC TRANSFER SWITCH
AWG	AMERICAN WIRE GAUGE
BKR	BREAKER
С	CONDUIT
СВ	CIRCUIT BREAKER
СКТ	CIRCUIT
CR	CONTROL RELAY
CU	COPPER
DPDT	DOUBLE POLE DOUBLE THROW
DPST	DOUBLE POLE SINGLE THROW
EM	EMERGENCY
EMT	ELECTRICAL METALLIC TUBING
ENCL	ENCLOSURE
EOR	ENGINEER OF RECORD
EP	EXPLOSION PROOF
ES	EMERGENCY STOP
ETL	INTERTEK - ELECTRICAL TESTING LABS
ETM	ELAPSE TIME METER
GFCI	GROUND FAULT CIRCUIT INTERRUPTER
GFI	GROUND FAULT INTERRUPTER
GND	GROUND
GRSC	GALVANIZED RIGID STEEL CONDUIT
HID	HIGH INTENSITY DISCHARGE
HOA	HAND OFF AUTOMATIC
HP	HORSEPOWER
HPS	HIGH PRESSURE SODIUM
J	JUNCTION BOX
KNL	KEVIN NEIL LIGHTFOOT
KVA	KILOVOLT AMPERE(S)
KW	KILOWATTS
LC	LIGHTING CONTACTOR
LTFMC	LIQUID TIGHT FLEXIBLE METAL CONDUIT (UL LISTED)
LTG	LIGHTING
LP	LIGHTING PANEL
MAX	MAXIMUM
МСВ	MAIN CIRCUIT BREAKER
МСМ	THOUSAND CIRCULAR MIL
MDP	MAIN DISTRIBUTION PANEL
MFR	MANUFACTURER
MH	METAL HALIDE
MIN	MINIMUM
MLO	MAIN LUGS ONLY
NEC	NATIONAL ELECTRICAL CODE (NFPA 70)
NC	NORMALLY CLOSED
NO	NORMALLY OPEN
NTS	NOT TO SCALE
OHE	OVERHEAD ELECTRIC
OL	OVERLOAD
	I

ELECTRICAL ABBREVIATIONS (CONTINUED)				
PB	PULL BOX			
PC	PHOTO CELL			
PDB	POWER DISTRIBUTION BLOCK			
PNL	PANEL			
RCPT	RECEPTACLE			
R	RELAY			
S	STARTER			
SPD	SURGE PROTECTION DEVICE			
SPST	SINGLE POLE SINGLE THROW			
TVSS	TRANSIENT VOLTAGE SURGE SUPPRESSOR			
TYP	TYPICAL			
UG	UNDERGROUND			
UGE	UNDERGROUND ELECTRIC			
UL	UNDERWRITER'S LABORATORIES			
V	VOLTS			
W/	WITH			
W/O	WITHOUT			
WP	WEATHER PROOF			
XFER	TRANSFER			
XFMR	TRANSFORMER			

XFMR	TRANSFORMER					
AIRPORT EQUIPMENT/FACILITY ABBREVIATIONS						
ASOS	AUTOMATED SURFACE OBSERVING SYSTEM					
ATCT	AIR TRAFFIC CONTROL TOWER					
AWOS	AUTOMATED WEATHER OBSERVING SYSTEM					
CCR	CONSTANT CURRENT REGULATOR					
DME	DISTANCE MEASURING EQUIPMENT					
FAR	FEDERAL AVIATION REGULATION					
GS	GLIDE SLOPE FACILITY					
HIRL	HIGH INTENSITY RUNWAY LIGHT					
ILS	INSTRUMENT LANDING SYSTEM					
IM	INNER MARKER					
LIR	LOW IMPACT-RESISTANT					
LOC	LOCALIZER FACILITY					
MALS MEDIUM INTENSITY APPROACH LIGHTIN SYSTEM						
MALSR	MEDIUM INTENSITY APPROACH LIGHTING SYSTEM WITH RUNWAY ALIGNMENT INDICATING LIGHTS					
MIRL	MEDIUM INTENSITY RUNWAY LIGHT					
MITL	MEDIUM INTENSITY TAXIWAY LIGHT					
NDB	NON-DIRECTIONAL BEACON					
PAPI	PRECISION APPROACH PATH INDICATOR					
PLASI	PULSE LIGHT APPROACH SLOPE INDICATOR					
RAIL	RUNWAY ALIGNMENT INDICATING LIGHTS					
REIL	RUNWAY END IDENTIFIER LIGHT					
RVR	RUNWAY VISUAL RANGE					
VADI	VISUAL APPROACH DESCENT INDICATOR					
VASI	VISUAL APPROACH SLOPE INDICATOR					
VOR	VERY HIGH FREQUENCY OMNIDIRECTIONAL RANGE FACILITY					
WC	WIND CONE					

ELECTRICAL LEGEND - ONE-LINE DIAGRAM				
	CABLE TERMINATOR/LUG			
***	TRANSFORMER			
	DISCONNECT SWITCH			
__	FUSIBLE DISCONNECT SWITCH			
└──2P <u>30A</u>	HEAVY DUTY FUSIBLE SAFETY SWITCH 2 POLE 30A WITH 20A FUSES			
	CIRCUIT BREAKER			
-^- ↓	THERMAL MAGNETIC CIRCUIT BREAKER			
	FUSE			
↓ ≑	TRANSIENT VOLTAGE SURGE SUPPRESSOR OR SURGE PROTECTOR DEVICE			
 -	GROUND - GROUND ROD, GROUNDING ELECTRODE, OR AT EARTH POTENTIAL			
Ø	INDICATING LIGHT			
M	MOTOR			
#	LOAD, MOTOR, # = HORSEPOWER			
	ELECTRIC UTILITY METER BASE			
0	JUNCTION BOX WITH SPLICE			
XXX	EQUIPMENT, XXX = DEVICE DESCRIPTION			
GND	GROUND BUS OR TERMINAL			
S/N	NEUTRAL BUS			
‡	PANELBOARD WITH MAIN LUGS			
	PANELBOARD WITH MAIN BREAKER			
FUSE PANEL WITH MAIN FUSE PULLOUT				
#	DUPLEX RECEPTACLE 120V SINGLE PHASE GROUNDING TYPE			
CONTROL STATION				

TRANSFER SWITCH

ENGINE GENERATOR SET

ELECTRICAL LECEND ONE LINE DIACRAM

	ELECTRICAL LEGEND - PLANS			
	CONDUIT (EXPOSED)			
	CONDUIT OR DUCT (CONCEALED OR BURIED)			
~ ¤	POLE MOUNTED LED FIXTURE			
	#12 AWG TWHN COPPER UNLESS NOTED OTHERWISE. LONG SLASHES INDICATE NEUTRAL. SHORT SLASHES INDICATE HOT OR SWITCHED LEG. SLASHES WITH DOT INDICATE SEPARATE GROUND WIRE.			
PNL A 1,3,5	HOMERUN TO PANEL PNL A INDICATES PANEL 1,3,5 INDICATES CIRCUIT NUMBERS			
наа	WALL OR CEILING MT'D. LED FIXTURE.			
	DUCT			
	DUCT			
—Е—	BURIED/UNDERGROUND ELECTRIC			
-ОНЕ-	OVERHEAD ELECTRIC			
\$	TOGGLE SWITCH			
₽	PUSH BUTTON STATION			
HJ J °	WALL OR CEILING MT'D. JUNCTION BOX. CONFIGURATION VARIES WITH USE			
4	SINGLE THROW DISCONNECT SWITCH			
Ą	SINGLE THROW, FUSIBLE DISCONNECT SWITCH			
СВ	ENCLOSED CIRCUIT BREAKER			
M	MOTOR			
Т	TRANSFORMER			
	ELECTRIC UTILITY METER			
	ENCLOSURE			
	ENCLOSURE			

ELECTRICAL LECEND DIANG

NOTES:

- 1. ALL ELECTRICAL EQUIPMENT SHALL BE INSTALLED IN CONFORMANCE WITH NFPA 70 NATIONAL ELECTRICAL CODE (NEC) MOST CURRENT ISSUE IN FORCE, THE RESPECTIVE EQUIPMENT MANUFACTURER'S DIRECTIONS AND ALL OTHER APPLICABLE LOCAL CODES, LAWS, ORDINANCES, AND REQUIREMENTS IN FORCE. ANY INSTALLATIONS WHICH VOID THE U.L. LISTING, INTERTEK TESTING SERVICES VERIFICATION/ETL LISTING (OR OTHER THIRD PARTY LISTING) AND/OR THE MANUFACTURER'S WARRANTY OF A DEVICE WILL NOT BE PERMITTED.
- KEEP A COPY OF THE LATEST NEC IN FORCE ON SITE AT ALL TIMES DURING/CONSTRUCTION FOR USE AS A REFERENCE.
- 3. NEW WORK, POWER OUTAGES, AND/OR SHUT DOWN OF EXISTING SYSTEMS SHALL BE COORDINATED WITH THE AIRPORT MANAGER. ONCE SHUT DOWN, THE CIRCUITS SHALL BE LABELED AS SUCH TO PREVENT ACCIDENTAL ENERGIZING OF THE RESPECTIVE CIRCUITS. ALL PERSONNEL SHALL FOLLOW U.S. DEPARTMENT OF LABOR OCCUPATIONAL SAFETY & HEALTH ADMINISTRATION (OSHA) 29 CFR PART 1910 OCCUPATIONAL SAFETY & HEALTH STANDARDS FOR ELECTRICAL SAFETY AND LOCKOUT/TAGOUT PROCEDURES INCLUDING, BUT NOT LIMITED TO, 29 CFR SECTION 1910.147 THE CONTROL OF HAZARDOUS ENERGY (LOCKOUT/TAGOUT).

- 4. LTFMC DENOTES LIQUID TIGHT FLEXIBLE METAL CONDUIT UL LISTED, SUNLIGHT RESISTANT, & SUITABLE FOR GROUNDING. LIQUID TIGHT FLEXIBLE METAL CONDUIT AND ASSOCIATED FITTINGS SHALL BE U.L. LISTED TO MEET THE REQUIREMENTS OF NEC 350.6. LIQUID TIGHT FLEXIBLE METAL CONDUIT THAT IS USED FOR FLEXIBILITY (INCLUDING CONNECTIONS TO CCR'S & TRANSFORMERS) SHALL REQUIRE AN EXTERNAL BONDING JUMPER OR INTERNAL EQUIPMENT GROUNDING CONDUCTOR PER NEC 350.60. EXTERNAL BONDING JUMPERS USED WITH CCR INSTALLATIONS SHALL BE #6 AWG COPPER (MINIMUM). DO NOT INSTALL LIFFMC THAT IS NOT UL LISTED. CONFIRM LTFMC BEARS THE UL LABEL PRIOR TO INSTALLATION.
- 5. INSULATED CONDUCTORS SHALL COLOR CODE PHASE AND NEUTRAL CONDUCTOR INSULATION FOR NO. 6 AWG OR SMALLER. PROVIDE COLORED INSULATION OR COLORED MARKING TAPE FOR PHASE AND NEUTRAL CONDUCTORS FOR NO. 4 AWG AND LARGER. INSULATED GROUND CONDUCTORS SHALL HAVE GREEN COLORED INSULATION FOR ALL CONDUCTOR AWG AND/OR KCMIL TO COMPLY WITH NEC 250.119. NEUTRAL CONDUCTORS SHALL HAVE WHITE COLORED INSULATION FOR NO. 6 AWG AND SMALLER TO MEET THE REQUIREMENTS OF NEC 200.6. STANDARD COLORS FOR POWER WIRING AND BRANCH CIRCUITS SHALL BE AS FOLLOWS:

120/240 VAC, 1 PHASE, 3 WIRE
PHASE A BLACK
PHASE B RED
NEUTRAL WHITE
GROUND GREEN

- 6. SEE RESPECTIVE SITE PLANS FOR SITE LEGEND INFORMATION.
- 7. ENCLOSURES RATED NEMA 4, 4X SHALL HAVE WATERTIGHT HUBS AT CONDUIT ENTRANCES UL LISTED NEMA 4, 4X FOR THE RESPECTIVE ENCLOSURE, TO MAINTAIN THE NEMA 4, 4X RATING.
- ONLY QUALIFIED ELECTRICAL CONTRACTORS SHALL PERFORM ELECTRICAL WORK ON THIS PROJECT.
- RESPECTIVE POWER SOURCES FOR EACH PANEL, EQUIPMENT, LIGHT, GATE OPERATOR, OR OTHER DEVICE SHALL BE VERIFIED PRIOR TO WORKING ON, RELOCATING, REMOVING, DISCONNECTING, AND/OR INSTALLING THE RESPECTIVE DEVICES. SHUT OFF, LOCKOUT, AND TAGOUT FOR PROTECTION OF PERSONNEL.
- 10. HIGH VOLTAGE CIRCUITS (AIRFIELD LIGHTING 5000 VOLT SERIES CIRCUITS AND OTHER CIRCUITS RATED ABOVE 600 VOLTS) AND LOW VOLTAGE CIRCUITS (RATED 600 VOLTS AND BELOW) SHALL NOT BE INSTALLED IN THE SAME WIREWAY, CONDUIT, DUCT, RACEWAY, JUNCTION STRUCTURE OR HANDHOLE.
- 11. PER NEC 513 THE ENTIRE AREA OF A HANGAR INCLUDING ANY ADJACENT AND COMMUNICATING AREAS NOT SUITABLY CUT OFF FROM THE HANGAR, SHALL BE CLASSIFIED AS A CLASS I, DIVISION 2 HAZARDOUS LOCATION UP TO A LEVEL 18 INCHES ABOVE THE FLOOR, PER NEC 513.3(C) "VICINITY OF AIRCRAFT", THE AREA WITHIN 5 FT HORIZONTALLY FROM AIRCRAFT POWER PLANTS OR AIRCRAFT FUEL TANKS SHALL BE CLASSIFIED AS A CLASS I, DIVISION 2 LOCATION THAT SHALL EXTEND UPWARD FROM THE FLOOR TO A LEVEL 5FT. ABOVE THE UPPER SURFACE OF WINGS AND OF ENGINE ENCLOSURES ALL ELECTRICAL INSTALLATIONS IN CLASSIFIED HAZARDOUS LOCATIONS SHALL BE AVOIDED UNLESS SPECIFICALLY APPROVED FOR SUCH LOCATIONS AND INSTALLED IN CONFORMANCE WITH NEC 500, 501, AND 513 AS WELL AS OTHER APPLICABLE CODES AND REQUIREMENTS.
- 12. PER NEC 511 THE SNOW REMOVAL EQUIPMENT BUILDING MAY HAVE CLASSIFIED HAZARDOUS AREAS. ALL ELECTRICAL INSTALLATIONS IN CLASSIFIED HAZARDOUS LOCATIONS SHALL BE AVOIDED UNLESS SPECIFICALLY APPROVED FOR SUCH LOCATIONS AND INSTALLED IN CONFORMANCE WITH NEC 500, 501, AND 511 AS WELL AS OTHER APPLICABLE CODES AND REQUIREMENTS.



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COLES COUNTY AIRPORT
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DATE SIGNED: 11/17/23 LICENSE EXPIRES: 11/30/25

RECONSTRUCT WEST AIRCRAFT T-HANGAR AREA PAVEMENTS

IDA No: MTO-4816 SBG Project No: N/A

Contract No. CO072

NO. DATE DESCRIPTION
DES DWN REV

ISSUE: 11/17/2023
PROJECT NO: 22A0001D

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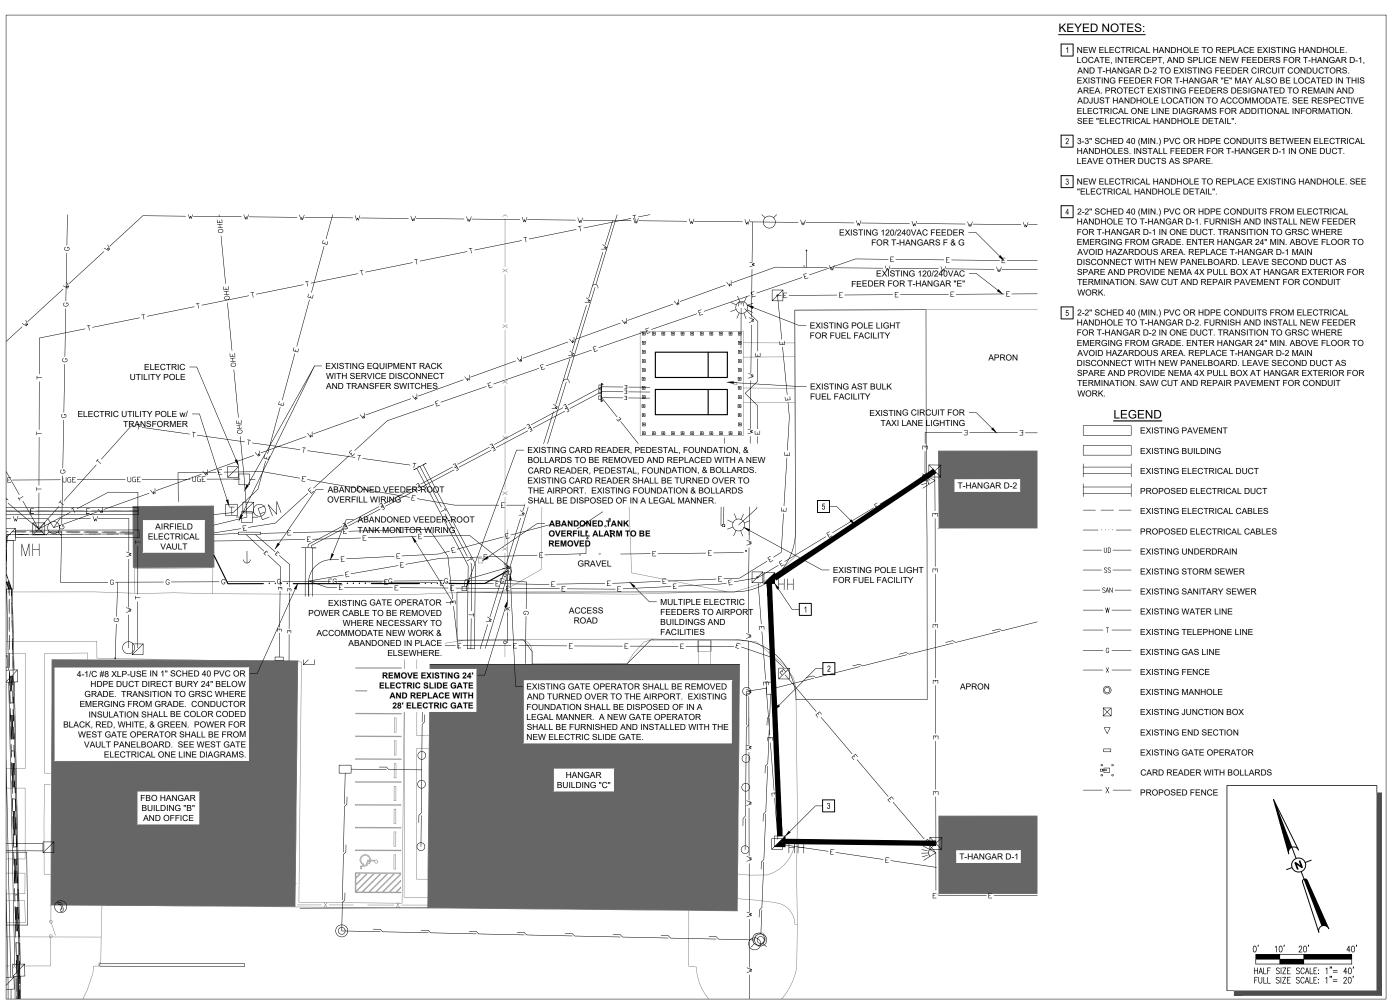
DESIGN BY: KNL 09/16/2023

DRAWN BY: CWS 09/18/2023

REVIEWED BY: KNL 11/13/2023

SHEET TITLE

ELECTRICAL LEGEND AND NOTES





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DATE SIGNED: 11/17/23 LICENSE 11/30/25

RECONSTRUCT WEST AIRCRAFT T-HANGAR AREA PAVEMENTS

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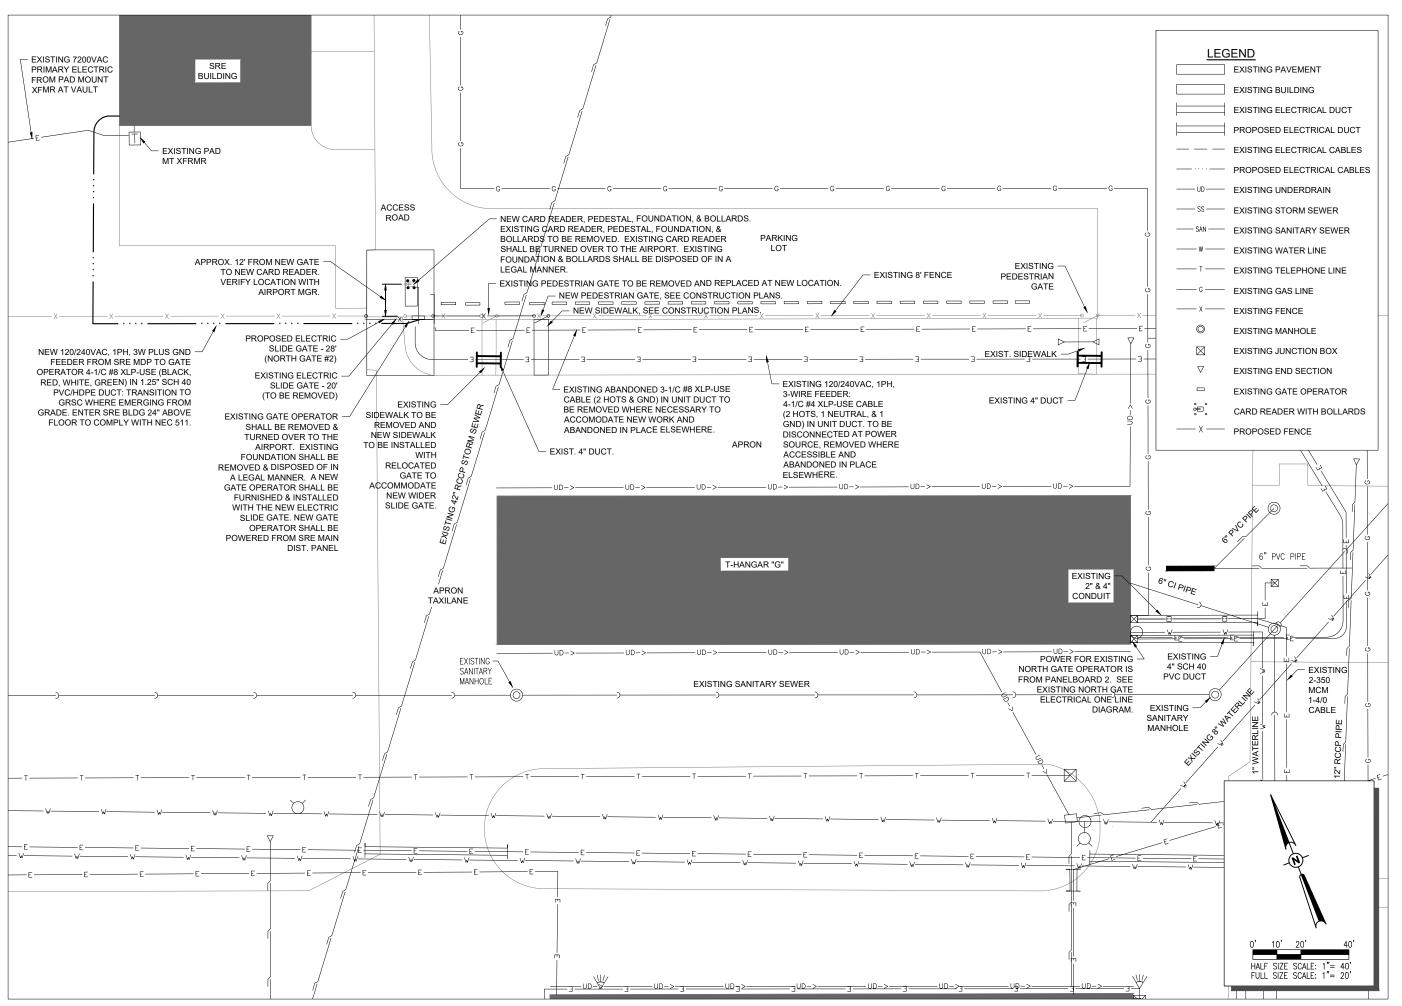
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CAD FILE: E-102-SITE.DWG
DESIGN BY: KNL 09/23/2023
DRAWN BY: CWS 09/26/2023

REVIEWED BY: KNL 11/13/2023
SHEET TITLE

ELECTRICAL SITE

PLAN 1





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COVERING ELECTRICAL DESIGN KEVIN N. LIGHTFOOT 062-047643

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IDA No: MTO-4816 SBG Project No: N/A

Contract No. CO072


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DESIGN BY: KNL 09/23/2023 DRAWN BY: CWS 09/26/2023 REVIEWED BY: KNL 11/13/2023

SHEET TITLE

ELECTRICAL SITE PLAN 2



T-HGR #10
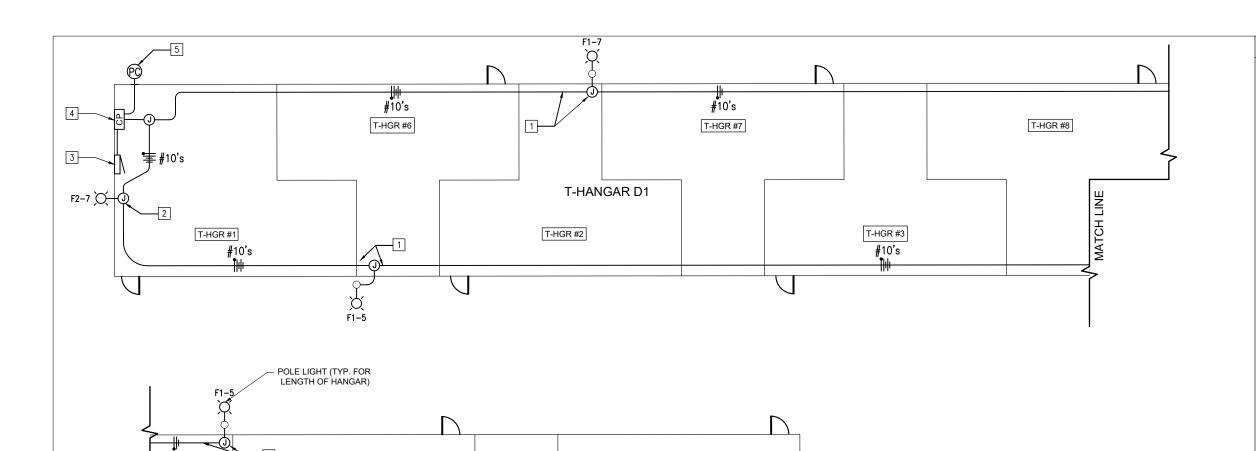
#10's

CONDUIT NIPPLES TO WALL MOUNT

LIGHT FIXTURES SHALL BE GRSC

WALL PACK LIGHT (TYP. AT HANGAR ENDS)

() F2−5

T-HANGAR D1 FLOOR PLAN O 4' 8' 16' HALF SIZE SCALE: 1/16" = 1'-0" FULL SIZE SCALE: 1/8" = 1'-0"

ELECTRICAL NOTES

- 1. FURNISH AND INSTALL LIGHTING CONTACTOR CONTROL PANEL AS DETAILED HEREIN.
- 2. SEE LIGHT FIXTURE SCHEDULE.

#10's

T-HGR #4

#10's

- 3. JUNCTION BOXES WILL BE SIZED PER NEC 314 FOR THE RESPECTIVE SPLICES, WIRING AND CONDUITS.
- 4. 15 AMP AND 20 AMP LIGHTING BRANCH CIRCUITS SHALL USE #10 AWG THWN COPPER CONDUCTORS (MINIMUM). 15 AMP & 20 AMP, OTHER BRANCH CIRCUITS SHALL USE #12 AWG THWN COPPER CONDUCTORS (MINIMUM). FOR 20 AMP BRANCH CIRCUITS NO MORE THAN 9 #12 AWG CURRENT CARRYING CONDUCTORS SHALL BE INSTALLED IN THE SAME CONDUIT OR RACEWAY. ADJUST/INCREASE CABLE SIZES WHERE MORE THAN 3 CURRENT CARRYING CONDUCTORS ARE INSTALLED IN A SINGLE RACEWAY. PER THE REQUIREMENTS OF NEC 310.15(B)(3)(a).
- THE ELECTRICAL CONTRACTOR SHALL BE RESPONSIBLE FOR LOCATING THE POSITION OF ALL CONDUITS ALONG STRUCTURAL ROOF MEMBERS, PROPERLY FASTENING, SLEEVING AND FLASHING ALL OPENINGS THROUGH THE PARTITION WALLS. FIELD VERIFY CONDUIT ROUTING.

T-HGR #9

F1-7 💢

T-HANGAR D1

T-HGR #5

LIGHT FIXTURES SHALL ALTERNATE CIRCUITS. ADJACENT LIGHT FIXTURES

- 6. HANGAR CLASSIFICATION: NFPA 409 GROUP III, TYPE II (000) CONSTRUCTION.
- PER NEC 513 THE ENTIRE AREA OF A HANGAR INCLUDING ANY ADJACENT AND COMMUNICATING AREAS NOT SUITABLY CUT OFF FROM THE HANGAR, SHALL BE CLASSIFIED AS A CLASS I, DIVISION 2 HAZARDOUS LOCATION UP TO A LEVEL 18 INCHES ABOVE THE FLOOR, PER NEC 513.3(C) "VICINITY OF AIRCRAFT", THE AREA WITHIN 5 FT. HORIZONTALLY FROM AIRCRAFT POWER PLANTS OR AIRCRAFT FUEL TANKS SHALL BE CLASSIFIED AS A CLASS I, DIVISION 2 LOCATION THAT SHALL EXTEND UPWARD FROM THE FLOOR TO A LEVEL 5FT. ABOVE THE UPPER SURFACE OF WINGS AND OF ENGINE ENCLOSURES. ALL ELECTRICAL INSTALLATIONS IN CLASSIFIED HAZARDOUS LOCATIONS SHALL BE AVOIDED UNLESS SPECIFICALLY APPROVED FOR SUCH LOCATIONS AND INSTALLED IN CONFORMANCE WITH NEC 500, 501, AND 513 AS WELL AS OTHER APPLICABLE CODES AND REQUIREMENTS.

KEYED NOTES

- ROUTE ¾" EMT CONDUIT AT THE CEILING LEVEL OF THE HANGAR AT THE EXTERIOR LIGHT POLE LOCATIONS PROVIDE A JUNCTION BOX AND ROUTE THE CONDUIT DOWN THE BUILDING WALL TO 24 INCHES ABOVE EXTERIOR GRADE THEN USE A GALVANIZED RIGID STEEL "LB" FITTING ON THE EXTERIOR OF THE BUILDING AND TURN GRS CONDUIT DOWN TO BELOW GRADE AND OVER TO THE LIGHT POLE FOUNDATION. SEE LIGHT POLE FOUNDATION DETAIL. SAW CUT PAVEMENT TO FACILITATE CONDUIT ROUTING TO POLE AND REPAIR PAVEMENT TO MATCH EXISTING ONCE THE CONDUIT IS IN PLACE. PROVIDE A MINIMUM OF 18 INCHES OF SEPARATION BETWEEN THE BUILDING WALL AND THE CLOSEST EDGE OF THE LIGHT POLE FOUNDATION
- MOUNT WALL PACK F2 LIGHT
 FIXTURE AT 12 FT ABOVE FINISHED
 GRADE AND CONNECT TO LIGHTING
 CIRCUIT AS INDICATED. LOCATE
 WALL PACK AS CLOSE TO THE
 CENTERLINE OF THE BUILDING AS
 POSSIBLE WHILE AVOIDING ANY
 EXSITING CONFLICTS ON THE
 WALL.
- 3 NEW HANGAR D1 DISTRIBUTION PANEL SEE ONE-LINE DIAGRAM AND PANEL SCHEDULE.
- 4 NEW LIGHTING CONTACTOR PANEL SEE DETAIL SHEETS.
- 5 NEW LINE VOLTAGE PHOTOCELL.
 MOUNT FACING NORTH SEE
 LIGHTING CONTACTOR DETAIL
 SHEET FOR WIRING
 REQUIREMENTS.

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RECONSTRUCT WEST AIRCRAFT T-HANGAR AREA PAVEMENTS

IDA No: MTO-4816 SBG Project No: N/A

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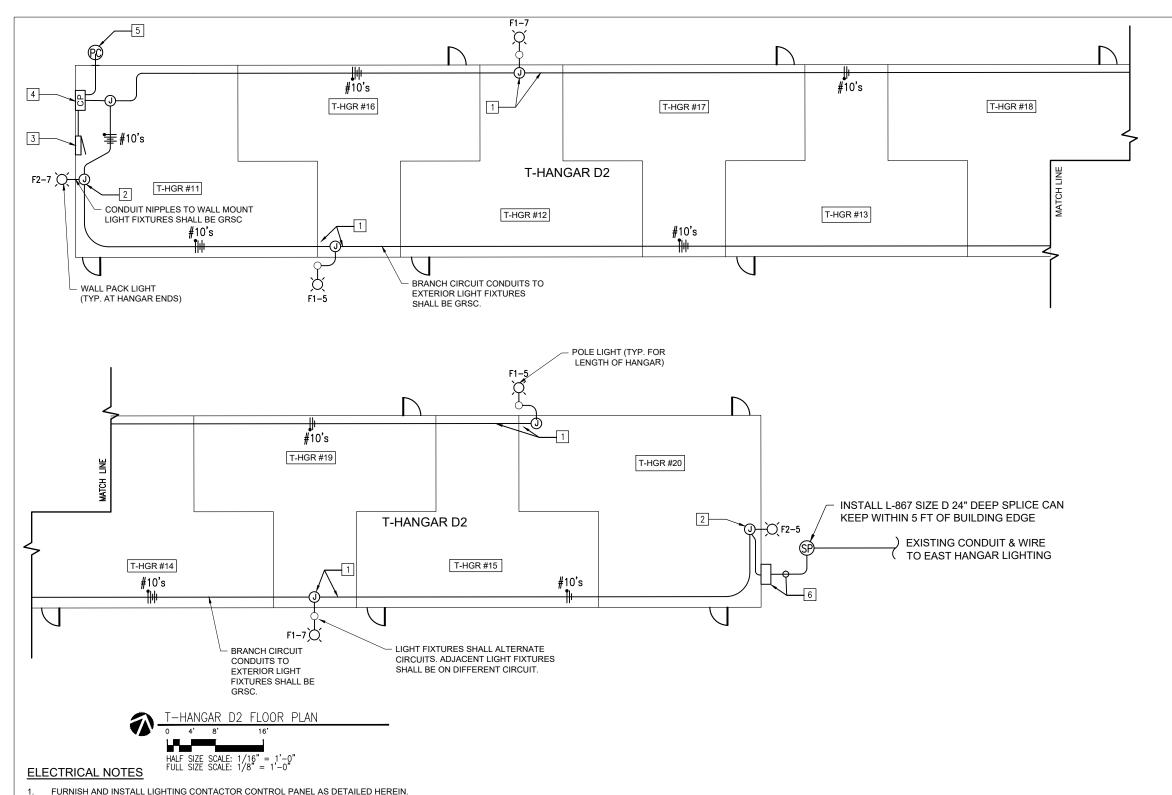
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CAD FILE: E-103-HGR D1.DWG

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DRAWN BY: MLM 10/24/2023

REVIEWED BY: KNL 11/13/2023

SHEET TITLE

EXTERIOR LIGHTING PLAN - HANGAR D1



KEYED NOTES

- ROUTE 3/4" EMT CONDUIT AT THE CEILING LEVEL OF THE HANGAR AT THE EXTERIOR LIGHT POLE LOCATIONS PROVIDE A JUNCTION BOX AND ROUTE THE CONDUIT DOWN THE BUILDING WALL TO 24 INCHES ABOVE EXTERIOR GRADE THEN USE A GALVANIZED RIGID STEEL "LB" FITTING ON THE EXTERIOR OF THE BUILDING AND TURN GRS CONDUIT DOWN TO BELOW GRADE AND OVER TO THE LIGHT POLE FOUNDATION. SEE LIGHT POLE FOUNDATION DETAIL SAW CUT PAVEMENT TO FACILITATE CONDUIT ROUTING TO POLE AND REPAIR PAVEMENT TO MATCH EXISTING ONCE THE CONDUIT IS IN PLACE. PROVIDE A MINIMUM OF 18 INCHES OF SEPARATION BETWEEN THE BUILDING WALL AND THE CLOSEST EDGE OF THE LIGHT POLE FOUNDATION
- MOUNT WALL PACK F2 LIGHT FIXTURE AT 12 FT ABOVE FINISHED GRADE AND CONNECT TO LIGHTING CIRCUIT AS INDICATED. LOCATE WALL PACK AS CLOSE TO THE CENTERLINE OF THE BUILDING AS POSSIBLE WHILE AVOIDING ANY EXSITING CONFLICTS ON THE WALL.
- 3 NEW HANGAR D2 DISTRIBUTION PANEL SEE ONE-LINE DIAGRAM AND PANEL SCHEDULE.
- 4 NEW LIGHTING CONTACTOR PANEL SEE DETAIL SHEETS.
- 5 NEW LINE VOLTAGE PHOTOCELL.
 MOUNT FACING NORTH SEE
 LIGHTING CONTACTOR DETAIL
 SHEET FOR WIRING
 REQUIREMENTS.

6 INTERCEPT EXISTING CONDUIT

AND WIRING EXTENDING TO HANGER LIGHTING TO THE EAST. ROUTE INTO T-HANGAR D2 AND CONNECT TO NEW LIGHTING CIRCUIT #5. ROUTE 2#10, #10G IN ¾" GRS CONDUIT FROM J-BOX ADJACENT TO F2 LIGHT FIXTURE IN HANGAR D2 TO SPLICE CAN. USE A GRS "LB" FITTING ON THE EXTERIOR WALL AT 24 INCHES ABOVE FINISHED GRADE TO EXTEND CONDUIT THROUGH BUILDING WALL. SAW CUT CONCRETE BETWEEN BUILDING WALL AND NEW SPLICE CAN TO FACILITATE CONDUIT ROUTING REPAIR CONCRETE TO MATCH EXISTING ONCE CONDUIT IS IN PLACE. SEE REFERENCE DRAWING FROM ORIGINAL 1970



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RECONSTRUCT WEST AIRCRAFT T-HANGAR AREA PAVEMENTS

IDA No: MTO-4816 SBG Project No: N/A

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DRAWN BY: MLM 10/24/2023 REVIEWED BY: KNL 11/13/2023

SHEET TITLE

EXTERIOR LIGHTING PLAN - HANGAR D2

ROUTING.

JUNCTION BOXES WILL BE SIZED PER NEC 314 FOR THE RESPECTIVE SPLICES, WIRING AND CONDUITS.


SEE LIGHT FIXTURE SCHEDULE.

6. HANGAR CLASSIFICATION: NFPA 409 GROUP III, TYPE II (000) CONSTRUCTION.

7. PER NEC 513 THE ENTIRE AREA OF A HANGAR INCLUDING ANY ADJACENT AND COMMUNICATING AREAS NOT SUITABLY CUT OFF FROM THE HANGAR, SHALL BE CLASSIFIED AS A CLASS I, DIVISION 2 HAZARDOUS LOCATION UP TO A LEVEL 18 INCHES ABOVE THE FLOOR, PER NEC 513.3(C) "VICINITY OF AIRCRAFT", THE AREA WITHIN 5 FT. HORIZONTALLY FROM AIRCRAFT POWER PLANTS OR AIRCRAFT FUEL TANKS SHALL BE CLASSIFIED AS A CLASS I, DIVISION 2 LOCATION THAT SHALL EXTEND UPWARD FROM THE FLOOR TO A LEVEL 5FT. ABOVE THE UPPER SURFACE OF WINGS AND OF ENGINE ENCLOSURES. ALL ELECTRICAL INSTALLATIONS IN CLASSIFIED HAZARDOUS LOCATIONS SHALL BE AVOIDED UNLESS SPECIFICALLY APPROVED FOR SUCH LOCATIONS AND INSTALLED IN CONFORMANCE WITH NEC 500, 501, AND 513 AS WELL AS OTHER APPLICABLE CODES AND REQUIREMENTS.

15 AMP AND 20 AMP LIGHTING BRANCH CIRCUITS SHALL USE #10 AWG THWN COPPER CONDUCTORS (MINIMUM). 15 AMP & 20 AMP, OTHER BRANCH CIRCUITS SHALL USE #12 AWG THWN COPPER CONDUCTORS (MINIMUM). FOR 20 AMP BRANCH CIRCUITS NO MORE THAN 9 #12 AWG CURRENT CARRYING CONDUCTORS SHALL BE INSTALLED IN THE SAME CONDUIT OR RACEWAY. ADJUST/INCREASE CABLE SIZES WHERE MORE

THAN 3 CURRENT CARRYING CONDUCTORS ARE INSTALLED IN A SINGLE RACEWAY, PER THE REQUIREMENTS OF NEC 310.15(B)(3)(a). THE ELECTRICAL CONTRACTOR SHALL BE RESPONSIBLE FOR LOCATING THE POSITION OF ALL CONDUITS ALONG STRUCTURAL ROOF MEMBERS, PROPERLY FASTENING, SLEEVING AND FLASHING ALL OPENINGS THROUGH THE PARTITION WALLS. FIELD VERIFY CONDUIT

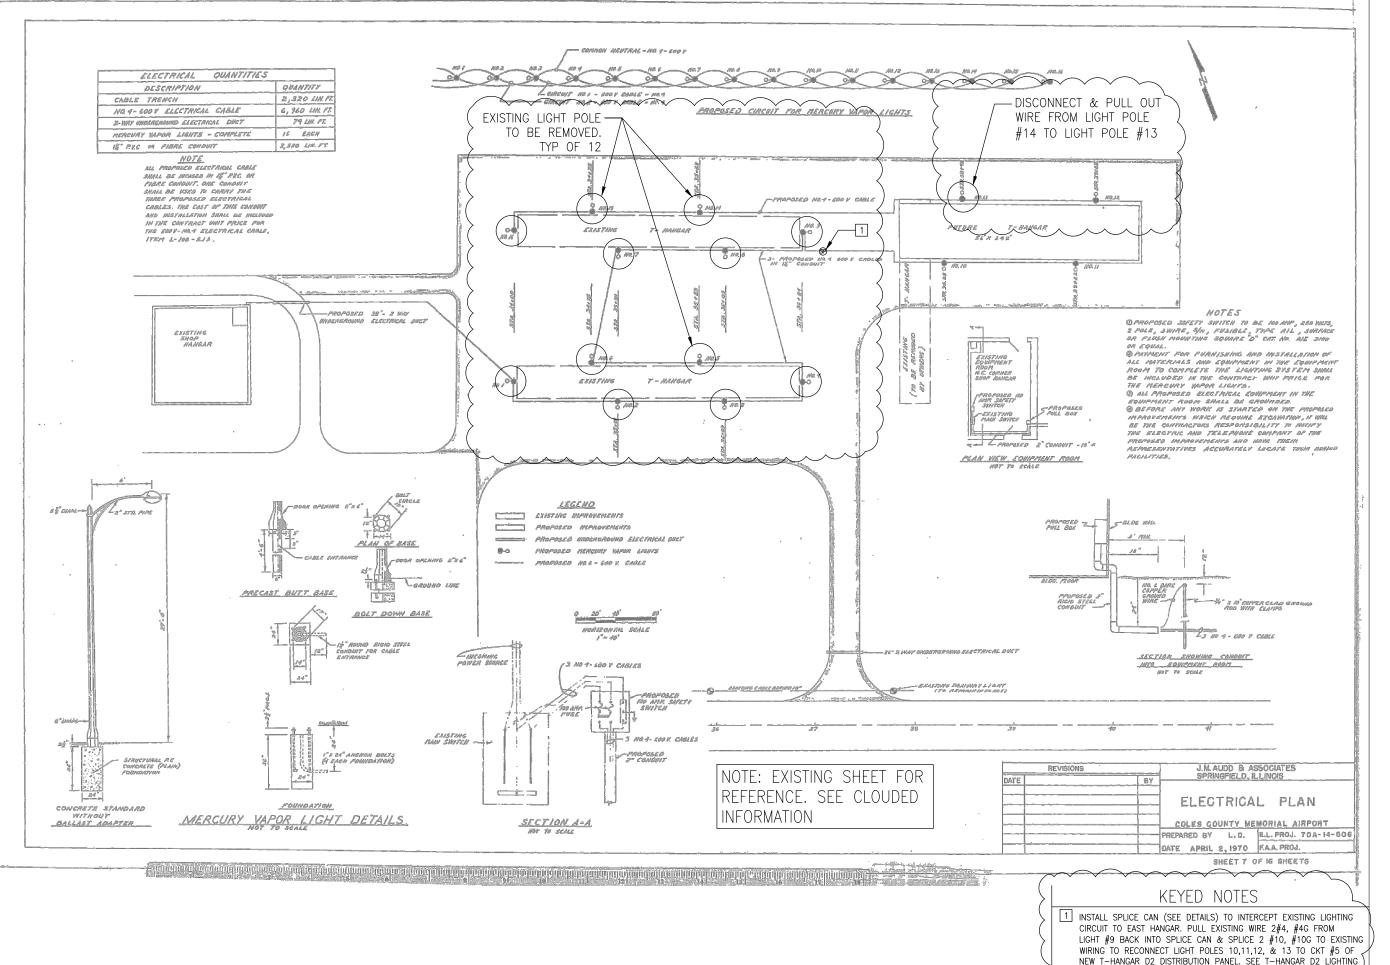

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IDA No: MTO-4816 SBG Project No: N/A

Contract No. CO072

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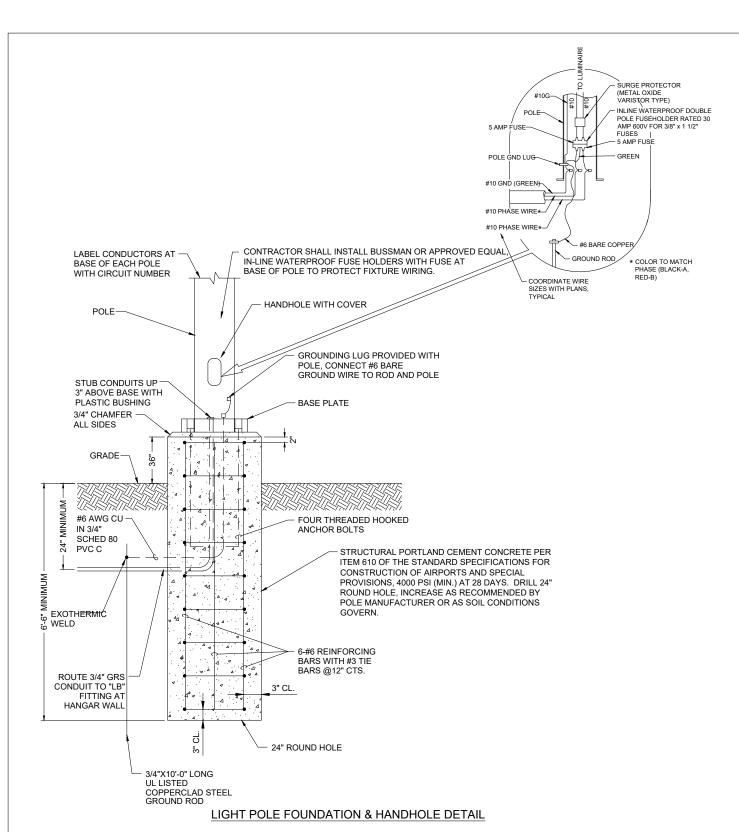
CAD FILE: E-105-1970 REFERENCE.DWG DESIGN BY: RDN 10/24/2023 DRAWN BY: MLM 10/24/2023

REVIEWED BY: KNL 11/13/2023

SHEET TITLE

PLAN FOR ADDITIONAL REQUIREMENTS.

1970S ELECTRICAL PLAN



		LIGHTING F	IXTURE SCHE	DULE		
FIXT. TYPE	DESCRIPTION	MANUFACTURER & CATALOG NO.	LAMPS/ WATTS	VOLTS	MOUNTING	REMARKS
F1	LEO AREA LIGHT FIXTURE. SINGLE PIECE DIE CAST ALUMINUM HOUSING WITH INTEGRAL HEAT SINK, MODULAR DESIGN FOR EASE OF MAINTENANCE. PREGISION MOLDED SILLOONE LENS, IP-66 RATED. LB1 RATING OF 100,000 HOURS, ZINC INFUSED TIGIC. THERMOSE TPOWDER COAT FINISH, DARK BRONZE, FUSED.	UTHONIA DSX1- LED-P8-40K- 70CR-T2M OR APPROVED EQUAL	216W LED		POLE MOUNTED TO A 22 FT, ROUND TAPERED STEEL POLE WITH A MINIMUM EPA RATING OF 5 AT 100 MPH. DARK BRONZE POLE FINISH.	EXTURE TO BE CONTROLLED THROUGH A LIGHTING CONTACTOR PANEL AS DETAILED ON THE PLANS.
F2	WALL MOUNTED LED EXTERIOR LIGHT FIXTURE, CAST ALUMINUM HOUSING, DARK BRONZE POLYESTER POWDER COAT FINISH, ONE PIECE GASKET, IP-65 RATED, L90 RATING AT 100,000 HOURS,	LITHONIA: TWR2- LED-ALO-MED- 40K-UVOLT OR APPROVED EQUAL	83W LED, 12,100 LUMENS	120	HANGAR WALL 12 FT-	PROVIDE BACK BOX OR WALL MOUNTING BRACKET AS REQUIRED BY THE MANUFACTURER. FIXTURE TO BE CONTROLLED THROUGH A LIGHTING CON TACTOR PANEL AS DETAILED ON THE DRAWINGS.

LIGHTING FIXTURE SCHEDULE NOTES:

- IF ALTERNATE LIGHT FIXTURES ARE SUBMITTED INCLUDE A PHOTOMETRIC STUDY OF THE AREA TO IDENTIFY LIGHT LEVELS AROUND THE HANGARS.
- 2. STEEL LIGHT POLES, REINFORCING STEEL, AND GROUND RODS SHALL BE MANUFACTURED IN THE UNITED STATES OF AMERICA FROM DOMESTIC STEEL TO COMPLY WITH THE STEEL PRODUCTS PROCUREMENT ACT (30 ILS 565)



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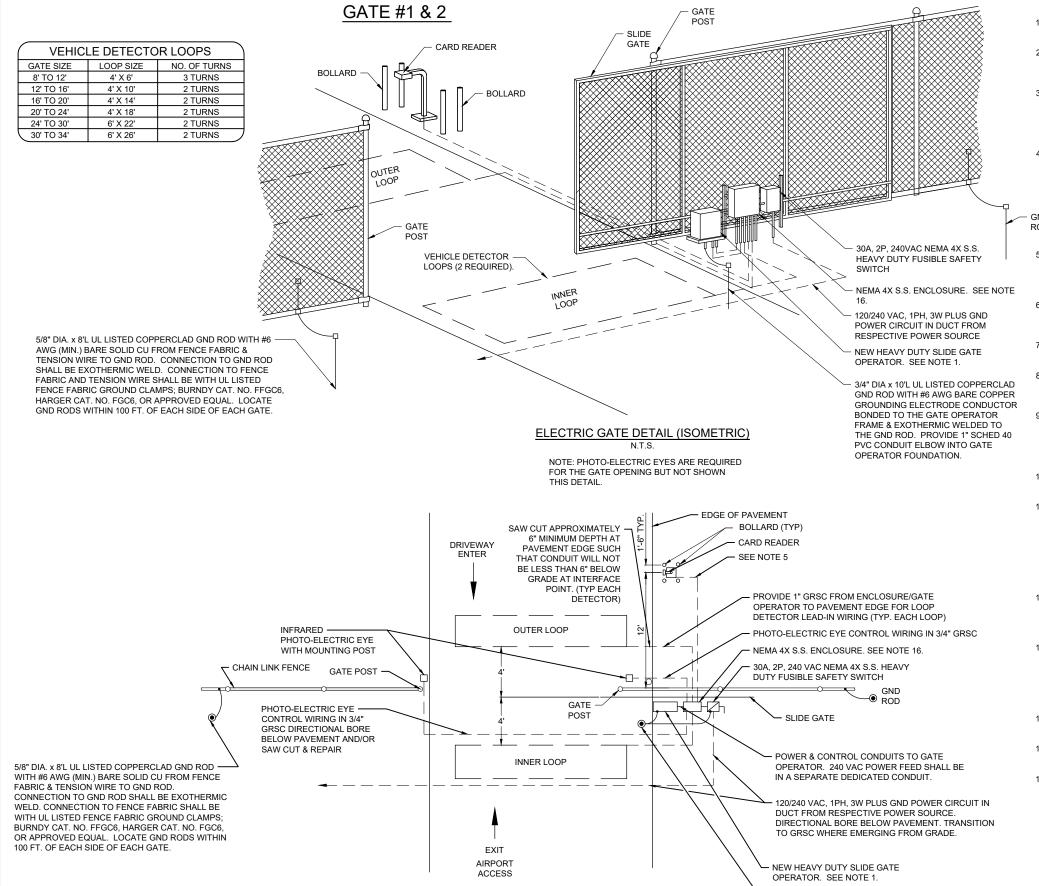
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LIGHTING SCHEDULE & ELECTRICAL DETAILS

DESIGN BY: RDN 10/24/2023 DRAWN BY: MLM 10/24/2023



ELECTRIC GATE PLAN

NOTES:

- . SEE SPECIAL PROVISION SPECS FOR REQUIREMENTS ON RESPECTIVE GATE & GATE OPERATOR SYSTEM.
- 2. ALL DIMENSIONS AND LAYOUT INFORMATION SHOWN SHOULD BE ADJUSTED AS RECOMMENDED BY THE MANUFACTURER. SEE RESPECTIVE SITE PLAN FOR EACH GATE.
- CONCRETE FOUNDATIONS SHALL BE PROVIDED FOR THE SLIDE GATE OPERATOR. FOUNDATION FOR THE GATE OPERATOR SHALL BE 48" (MIN.) IN DEPTH AND OF THE SIZE RECOMMENDED BY THE MANUFACTURER. FOUNDATION FOR THE GATE OPERATOR SHALL EXTEND APPROX. 8" ABOVE GRADE. SEE DETAILS.
- 1" GRSC CONDUIT WILL BE REQUIRED BETWEEN THE SLIDE GATE OPERATOR INSTALLATION, AND THE DETECTOR LOOPS. PROVIDE 3/4" GRSC BETWEEN THE SLIDE GATE OPERATOR AND THE PHOTO-ELECTRIC EYES. THE MINIMUM BURYING DEPTH IS 18" IN AREAS NOT SUBJECT TO VEHICLE TRAFFIC AND 30" IN AREAS SUBJECT TO VEHICLE TRAFFIC. ALL METAL CONDUITS ENTERING THE GATE OPERATOR SHALL BE BONDED TO THE GATE OPERATOR FRAME WITH A #8 AWG (MIN.) COPPER BONDING JUMPER. CONFIRM CONTROL WIRING REQUIREMENTS WITH THE RESPECTIVE GATE OPERATOR SALES AND SERVICE REPRESENTATIVE.
- NEW GATE OPERATOR SHALL INTERFACE TO THE CARD READER. FIELD VERIFY EXISTING SITE CONDITIONS, CABLE ROUTES, & DUCT LOCATIONS AS APPLICABLE TO INTERFACE THE CONTROL SYSTEM TO THE NEW GATE OPERATOR.
- 6. THE SLIDING GATE SHALL BE CANTILEVER TYPE OF THE SIZE CALLED FOR ON THE PLANS, SHALL HAVE AN ENCLOSED ROLLER ASSEMBLY AND SHALL BE AS MANUFACTURED BY TYMETAL CORPORATION OR APPROVED EQUAL
- . PROVIDE SIGNS FOR EACH NEW GATE. SECURE WITH STAINLESS STEEL HARDWARE. PROVIDE NEW SIGNS AS DETAILED HEREIN.
- CONTRACTOR SHALL COORDINATE ANY POWER OUTAGES TO EXISTING EQUIPMENT WITH THE RESPECTIVE OWNER'S REPRESENTATIVE AND THE AIRPORT DIRECTOR.
- INCLUDE AC SURGE PROTECTOR FOR THE GATE OPERATOR, UL 1449 LISTED, SURGE CURRENT RATING OF 40KA, SUITABLE FOR USE ON A 120/240 VAC, 1 PHASE, 3 WIRE SYSTEM WITH LED INDICATING OPERATIONAL STATUS, JOSLYN MODEL 1265-21, SQUARE D CAT. NO. TVS120XR50S OR APPROVED EQUAL. INCLUDE MOUNTING BRACKET.
- CONCRETE USED FOR INSTALLING THE GATE OPERATOR, CARD READER
 FENCE SHALL MEET THE REQUIREMENTS OF ITEM 610 CONCRETE.
- 11. ALL ELECTRICAL EQUIPMENT SHALL BE INSTALLED IN CONFORMANCE WITH NFPA 70 NATIONAL ELECTRICAL CODE (NEC) MOST CURRENT ISSUE IN FORCE, THE RESPECTIVE EQUIPMENT MANUFACTURER'S DIRECTIONS AND ALL OTHER APPLICABLE LOCAL CODES, LAWS, ORDINANCES, AND REQUIREMENTS IN FORCE. ANY INSTALLATIONS WHICH VOID THE UL LISTING, INTERTEK TESTING SERVICES VERIFICATION/ETL LISTING, (OR OTHER THIRD PARTY LISTING) AND/OR THE MANUFACTURER'S WARRANTY OF A DEVICE WILL NOT BE PERMITTED.
- 12. PROVIDE A WEATHERPROOF ENGRAVED PHENOLIC OR PLASTIC LEGEND PLATE FOR THE SAFETY SWITCH AT THE RESPECTIVE GATE OPERATOR NOTING THE GATE SERVED, VOLTAGE, AND RESPECTIVE POWER SOURCE CIRCUIT AND LOCATION
- 13. PAYMENT FOR EACH SLIDE GATE, GATE OPERATOR, AND ALL ASSOCIATED CONTROL & SAFETY DEVICES SHALL BE ON A PER EACH BASIS AND SHALL BE FULL COMPENSATION FOR ALL MATERIALS, EQUIPMENT, CABLE IN CONDUIT, DUCT, OR UNIT DUCT, GROUNDING, LABOR, TOOLS, COORDINATION, TESTING, AND INCIDENTALS REQUIRED TO INSTALL THE GATE COMPLETE AND IN OPERATING CONDITION.
- 14. CONTROL CIRCUIT WIRING SHALL NOT BE ROUTED THROUGH THE SAFETY SWITCH/DISCONNECT.
- INCLUDE CORROSION RESISTANT SUPPORT POSTS AND HARDWARE WITH THE PHOTO-ELECTRIC EYE SAFETY DEVICES.
- S. ALL CONTROL POWER TRANSFORMERS, SURGE PROTECTORS, POWER SUPPLIES, RECEPTACLES, LOOP DETECTOR AMPLIFIERS, SECONDARY SAFETY DEVICE EQUIPMENT, SECURITY SYSTEM EQUIPMENT AND ANY OTHER ASSOCIATED CONTROLS SHALL BE INSTALLED EITHER INSIDE THE GATE OPERATOR CONTROL PANEL OR INSIDE A SEPARATE NEMA 4 STAINLESS STEEL CONTROL PANEL ENCLOSURE. WHERE THE CONTROL EQUIPMENT IS TO BE INSTALLED INSIDE THE GATE OPERATOR CONTROL PANEL THE CONTRACTOR SHALL COORDINATE THIS WITH THE GATE OPERATOR MANUFACTURER AND THE RESPECTIVE GATE OPERATOR EQUIPMENT SUPPLIER. LOCATING THESE CONTROLS OUTSIDE OF GATE OPERATOR CONTROL PANEL BUT WITHIN THE GATE OPERATOR HOUSING WILL NOT MEET THIS REQUIREMENT.

3/4" DIA x 10"L UL LISTED COPPERCLAD GND ROD WITH #6
AWG BARE COPPER GROUNDING ELECTRODE CONDUCTOR
BONDED TO THE GATE OPERATOR FRAME & EXOTHERMIC
WELDED TO THE GND ROD. PROVIDE 1" SCHED 40 PVC
CONDUIT ELBOW INTO GATE OPERATOR FOUNDATION.




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COLES COUNTY AIRPORT
AUTHORITY
COLES ON THE MEMORIAL ARRORT



DATE SIGNED: 11/17/23 LICENSE 11/30/2

RECONSTRUCT WEST AIRCRAFT T-HANGAR AREA PAVEMENTS

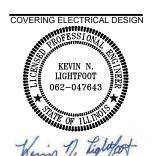IDA No: MTO-4816 SBG Project No: N/A

Contract No. CO072

NO.	DATE	DES	CRIPT	ION
INO.	NO. DATE	DES	DWN	REV
SSUE:	11/17/20	023		
PROJEC	CT NO: 2	2A000	1D	

CAD FILE: E-501-DETL.DWG


DESIGN BY: KNL 09/16/2023

DRAWN BY: CWS 09/18/2023

REVIEWED BY: KNL 11/13/2023

SHEET TITLE

PROPOSED SLIDE GATE DETAILS -GATE 1 & 2

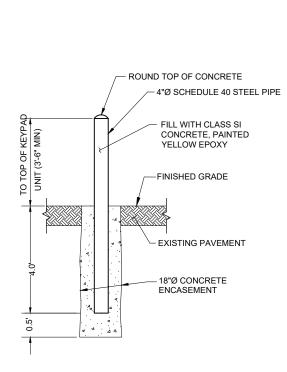

- 1. THE EXPOSED PORTION OF THE BOLLARD SHALL HAVE YELLOW PLASTIC SLEEVES WITH REFLECTIVE TAPE, SUITABLE FOR **OUTDOOR USE**
- 2. BOLLARD AND ASSOCIATED ITEMS ARE INCIDENTAL TO THE ELECTRIC SLIDING GATE INSTALLATION.

BOLLARD DETAIL NOT TO SCALE

ADDITIONAL-

CONDUITS TO

PEDESTAL AS

APPLICABLE

PROPOSED CARD READER ACCESS CONTROL UNIT WITH PEDESTAL & FOUNDATION WILL REQUIRE INTERFACE TO THE NEW GATE OPERATOR

CARD READER ACCESS CONTROL UNIT. INCLUDE HARDWARE TO INTERFACE TO PEDESTAL.

GOOSENECK PEDESTAL

FINISHED GRADE

CONTROLLER

CONCRETE

ANCHOR BOLTS PER MANUFACTURER RECOMMENDATION (TYPICAL FOR 4)

-1" GRSC TO GATE OPERATOR

OR RESPECTIVE ACCESS

CONCRETE PIER FOUNDATION.

CONCRETE SHALL CONFORM TO ITEM


610 STRUCTURAL PORTLAND CEMENT

INCLUDE #12 AWG EQUIPMENT GND WIRE TO CARD READER.


→ 12" DIA.

FACE OF KEYPAD ACCESS CONTROL UNIT SHALL NOT EXTEND BEYOND

CARD READER ACCESS CONTROL UNIT PEDESTAL ELEVATION DETAIL NOT TO SCALE

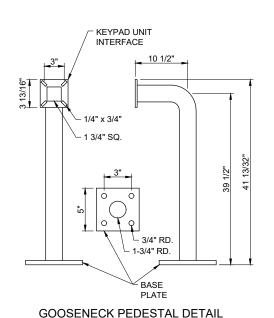

NOT TO SCALE

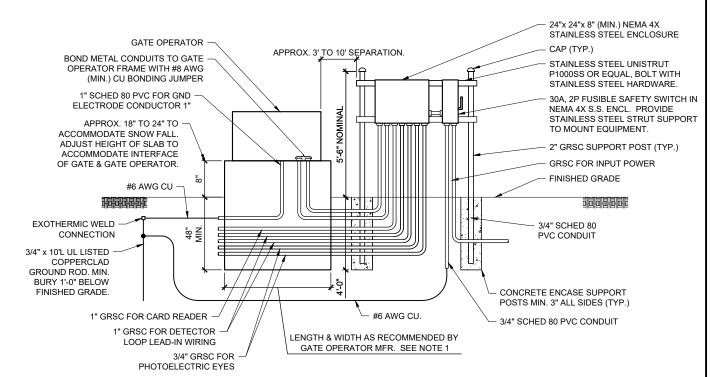

NOTES

- FOUNDATION FOR GATE OPERATOR SHALL BE 48" MIN. IN DEPTH AND OF THE LENGTH & WIDTH RECOMMENDED BY THE MANUFACTURER. CONFIRM MOUNTING REQUIREMENTS WITH THE RESPECTIVE GATE OPERATOR MANUFACTURER
- COORDINATE CONDUITS INTO FOUNDATION.
- CONFIRM CONDUIT SIZES AND WIRING REQUIREMENTS WITH THE GATE OPERATOR MFR. ADJUST/INCREASE CONDUIT SIZES WHERE APPLICABLE. REQUIREMENTS VARY BETWEEN DIFFERENT MANUFACTURERS.
- ALL ENCLOSURES RATED NEMA 4, 4X SHALL HAVE WATERTIGHT HUBS AT CONDUIT ENTRANCES U.L. LISTED NEMA 4, 4X FOR THE RESPECTIVE ENCLOSURE,
- GATE WILL REQUIRE PHOTOELECTRIC EYE SECONDARY SAFETY DEVICES. PROVIDE CONDUITS BETWEEN GATE OPERATOR SYSTEM AND SAFETY DEVICES.

GATE OPERATOR FOUNDATION DETAIL

NOT TO SCALE

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RECONSTRUCT WEST AIRCRAFT T-HANGAR AREA PAVEMENTS

IDA No: MTO-4816 SBG Project No: N/A

Contract No. CO072

DESCRIPTION NO. DATE DES DWN REV ISSUE: 11/17/2023

PROJECT NO: 22A0001D CAD FILE: E-502-DETL.DWG

DESIGN BY: KNI 09/16/2023 DRAWN BY: CWS 09/18/2023

REVIEWED BY: KNL 11/13/2023

SHEET TITLE

GATE OPERATOR DETAILS

TOP VIEW

DUCT

0.75"

0.15"-

BITUMINOUS PAVEMENT DUCT MARKERS

'NOT TO SCALE"

FINISHED PAVEMENT SURFACE. MARKER MAY

2. BRASS DUCT MARKERS ARE AVAILABLE FROM G&S FOUNDRY & MANUFACTURING CO., INC.,

210 KASKASKIA DRIVE, RED BUD, IL 62278,

1. TOP OF MARKER SHALL BE FLUSH WITH

SECURED WITH EPOXY GLUE.

PHONE: (618)-282-4114

BE INSTALLED IN A DRILLED HOLE AND

INDICATES

NUMBER AND

SIZE OF DUCT

BANK

PRESTAMPED OR

18" R.

3/16" R

CHISELED ON THE JOB


(3/8" HIGH LETTERING MIN.)

CONDUIT IN TRENCH - PAVED AREAS

"NOT TO SCALE"

DUCT BANK NOTES:

- 1. DIMENSIONS FOR COVERAGE AND SEPARATION BETWEEN DUCTS ARE MINIMUM FOR SECURED AREAS AT AIRPORTS.
- 2. TRENCHES WITH MORE THAN TWO CONDUITS OR DUCTS SHALL BE INCREASED 3" IN WIDTH PLUS DIAMETER OF RESPECTIVE DUCT FOR EACH ADDITIONAL CONDUIT, OR DUCT; IF SPECIFIED ON PLANS TWO PARALLEL TRENCHES MAY BE CONSTRUCTED.
- 3 DEPTH OF TRENCHES SHALL BE AS SHOWN ABOVE LINLESS OTHERWISE SPECIFIED ON THE PLANS, MINIMUM COVER REQUIREMENTS FOR CABLES AND DUCTS AT AIRPORT RUNWAYS AND ADJACENT AREAS WHERE TRESPASSING IS PROHIBITED IS 18 INCHES PER NEC 300.5 AND 300.50. COVER IS DEFINED AS THE SHORTEST DISTANCE IN INCHES MEASURED BETWEEN A POINT ON THE TOP SURFACE OF ANY DIRECT-BURIED CONDUCTOR, CABLE, CONDUIT, OR OTHER RACEWAY AND THE TOP SURFACE OF FINISHED GRADE. CONCRETE OR SIMILAR COVER.
- 4. HIGH VOLTAGE AND LOW VOLTAGE CIRCUITS SHALL NOT BE INSTALLED IN THE SAME RACEWAY, CONDUIT, DUCT, HANDHOLE, OR MANHOLE.
- 5. COMMUNICATION CIRCUITS SHALL NOT BE INSTALLED IN THE SAME RACEWAY, CONDUIT, DUCT, OR HANDHOLE WITH POWER CIRCUITS.
- 6. DUCT AND CONDUIT INTERFACE TO HANDHOLES OR MANHOLES WILL BE CONSIDERED INCIDENTAL TO THE RESPECTIVE DUCT WORK OR DUCT PAY
- 7. ALL DISTURBED SURFACES SHALL BE RESTORED TO THEIR ORIGINAL CONDITION. COST IS INCIDENTAL TO TRENCH.

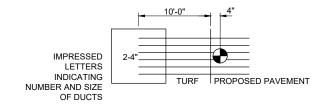


CONCRETE DUCT

DUCT MARKER DETAIL "NOT TO SCALE!


CABLE & DUCT MARKER NOTES:

- 1. THE COST OF ALL TURF AND PAVEMENT DUCT MARKERS SHALL BE INCIDENTAL TO THE DUCT. THE COST OF ALL CABLE MARKERS SHALL BE INCIDENTAL TO THE CABLE.
- 2. BITUMINOUS PAVEMENT DUCT MARKER AND CONCRETE DUCT MARKER TO BE PROVIDED AT EACH END OF EACH DUCT AS SHOWN ON THE LOCATION PLAN. FOR CONCRETE PAVEMENT, THE LETTER "D" SHALL BE IMPRESSED IN THE PAVEMENT INSTEAD OF THE MARKER. THE LETTER SHALL BE FORMED AS DESCRIBED
- 3. CABLE MARKERS SHALL BE PLACED AT CHANGES OF DIRECTION AND APPROXIMATELY EVERY 200' ALONG CABLE RUNS.
- 4. CONCRETE CABLE MARKERS AND DUCT MARKERS SHALL HAVE LETTERS 4" HIGH, 3" WIDE WITH WIDTH OF STROKE $\frac{1}{2}$ " AND $\frac{1}{4}$ " DEEP. ALL LETTERS, NUMBERS AND ARROWS TO BE IMPRESSED AND 30" MIN BELOW FINISHED GRADE IN PAVED AREAS.
- 5. EMPLOY THE FOLLOWING METHODS WERE ADDITIONAL SPACE TO FIT LEGEND IS REQUIRED:
 - A. REDUCE LETTER SIZE TO 3" HIGH, 2" WIDE. B. INCREASE THE MARKER SIZE TO 30" X 30". C. PROVIDE ADDITIONAL MARKERS PLACED SIDE BY SIDE.


ADJUST FOR RESPECTIVE LOCATION OF DUCT TERMINATION. DUCT TERMINATING AT HANDHOLES CONDUIT IN TRENCH - NON-PAVEMENT AREAS NEAR PAVEMENT WILL NOT REQUIRE ADDITIONAL DUCT "NOT TO SCALE" MARKERS IN TURF.

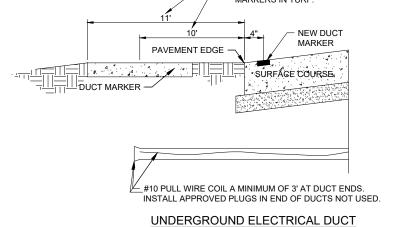

(NOT TO SCALE)

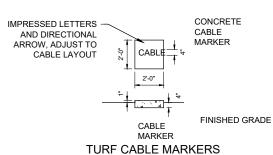

"NOT TO SCALE"

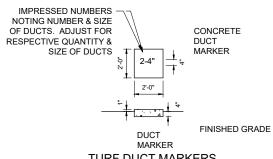

TURF DUCT MARKERS "NOT TO SCALE"

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DATE SIGNED: 11/17/23 LICENSE 11/30/25

RECONSTRUCT WEST AIRCRAFT T-HANGAR AREA PAVEMENTS

IDA No: MTO-4816 SBG Project No: N/A

Contract No. CO072


DESCRIPTION NO. DATE DES DWN REV ISSUE: 11/17/2023 PROJECT NO: 22A0001D

CAD FILE: E-503-DETL.DWG DESIGN BY: KNI 09/16/2023 DRAWN BY: CWS 09/18/2023


REVIEWED BY: KNL 11/13/2023

SHEET TITLE

CONDUIT AND DUCT **DETAILS**

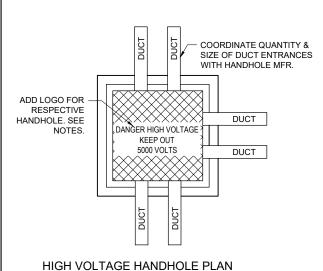


"NOT TO SCALE"

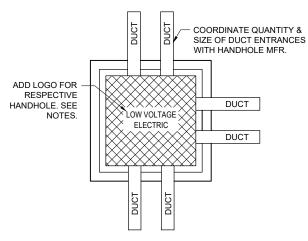

LOW VOLTAGE HANDHOLE PLAN


"NOT TO SCALE"

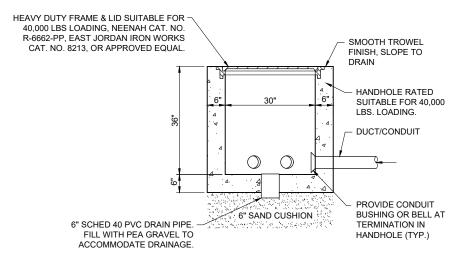

ELEVATION
"NOT TO SCALE"

HANDHOLE NOTES:

- 1. LIDS FOR LOW VOLTAGE HANDHOLES (CONTAINING CIRCUITS RATED 600 VOLTS AND BELOW) SHALL BE LABELED "LOW VOLTAGE" OR "0V 600V ELECTRIC". LIDS FOR HIGH VOLTAGE HANDHOLES CONTAINING AIRFIELD LIGHTING SERIES CIRCUIT WIRING SHALL BE LABELED "DANGER HIGH VOLTAGE KEEP OUT 5000 VOLTS" TO COMPLY WITH NEC ARTICLE 300.45 "WARNING SIGNS" AND NEC ARTICLE 314.30(D) "COVERS". COORDINATE LETTERING WITH MFR. HANDHOLES PROVIDED WITH THE WRONG LIDS SHALL HAVE THE LIDS REPLACED WITH THE CORRECT LIDS AT NO ADDITIONAL COST TO THE CONTRACT.
- 2. ELECTRICAL HANDHOLE, FRAME & LID SHALL BE CAPABLE OF WITHSTANDING MINIMUM 40,000 POUND LOADS.
- 3. REINFORCEMENT SHALL BE #6 BARS AT 6" CENTERS BASE & WALLS EACH WAY
- 4. CONCRETE SHALL BE 5000 PSI AT 28 DAYS.
- 5. HANDHOLES SHALL BE PRECAST. PRECAST MANUFACTURER MUST BE ON THE IDOT (ILLINOIS DEPARTMENT OF TRANSPORTATION) APPROVED LIST OF CERTIFIED PRECAST CONCRETE PRODUCERS.
- FRAMES AND LIDS (CASTINGS) SHALL BE MADE IN THE USA TO COMPLY WITH THE AIRPORT IMPROVEMENT PROGRAM BUY AMERICAN PREFERENCES REQUIREMENTS.
- 7. COORDINATE INSTALLATION OF HANDHOLES WITH RESPECTIVE FINISHED GRADE ELEVATION.
- ALL CORING, INTERFACE, AND LABOR ASSOCIATED WITH CONDUIT, DUCT, CABLE IN UNIT DUCT, AND/OR CABLE ENTRIES
 WILL BE CONSIDERED INCIDENTAL TO THE INSTALLATION OF THE HANDHOLE AND NO ADDITIONAL COMPENSATION WILL
 BE ALLOWED.
- 9. HANDHOLES WITH SIMILAR DIMENSIONS MEETING STRENGTH AND LOADING REQUIREMENTS WILL BE CONSIDERED.

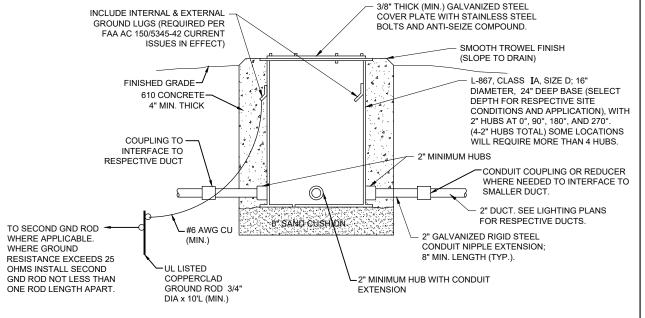

SPLICE CAN/JUNCTION CAN DETAIL

"NOT TO SCALE"

NOTES FOR SPLICE CAN/JUNCTION CAN DETAIL:

- 1. SPLICE CANS SHALL CONFORM TO THE REQUIREMENTS OF FAA AC 150/5345-42 (CURRENT ISSUES IN EFFECT), FOR TYPE L-867, CLASS IA, SIZE D, (16 IN. NOMINAL DIAMETER), AND 24 IN. DEEP AND/OR AS DETAILED ON THE PLANS. EACH SPLICE CAN SHALL INCLUDE INTERNAL AND EXTERNAL GROUND LUGS TO ACCOMMODATE THE RESPECTIVE APPLICATIONS. SPLICE CANS AND/OR JUNCTION CANS SHALL HAVE GALVANIZED STEEL COVERS, 3/8-INCH THICK (MINIMUM), WITH STAINLESS STEEL BOLTS.
- 2. FOR THE PURPOSE OF ENHANCING SAFETY, EACH BASE MUST HAVE INSTALLED, BY THE MANUFACTURER, AN INTERNAL AND EXTERNAL GROUND STRAP THAT IS AVAILABLE FOR THE PURPOSE OF ATTACHING A GROUND LUG THAT IS CONNECTED TO AN EARTH GROUND OR A SAFETY GROUND CONDUCTOR INSTALLED WITH THE RESPECTIVE CIRCUIT. FOR AIRPORT PROJECTS RECEIVING FEDERAL FUNDS THIS REQUIREMENT IS MANDATORY PER FAA AC 150/5345-42 (CURRENT ISSUES) IN EFFECT).
- 3. APPLY AN OXIDE-INHIBITING, ANTI-SEIZING COMPOUND TO ALL SCREWS, NUTS, AND ALL PLACES WHERE METAL COMES INTO CONTACT WITH METAL.
- 4. THE CONCRETE USED IN THE CONSTRUCTION OF THE BASES FOR THE AIRFIELD LIGHTING CANS SHALL BE IN ACCORDANCE WITH ITEM 610 STRUCTURAL PORTLAND CEMENT CONCRETE.
- 5. LIDS FOR THE SPLICE CANS CONTAINING HIGH VOLTAGE AIRFIELD LIGHTING CABLES SHALL INCLUDE MINIMUM 1/2-INCH HIGH LETTERING LABELED "DANGER HIGH VOLTAGE KEEP OUT" TO COMPLY WITH NEC ARTICLE 300.45 "WARNING SIGNS" AND NEC ARTICLE 314.71(E) "SUITABLE COVERS". THIS WILL NEED TO BE COORDINATED WITH THE SPLICE CAN MANUFACTURER.
- LIDS FOR THE SPLICE CANS CONTAINING LOW VOLTAGE CABLES (RATED 600 VOLTS AND BELOW) WILL BE ACCEPTABLE TO USE BLANK COVERS.



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COLES COUNTY AIRPORT
AUTHORITY
COLES COUNTY MEMORIAL ARFORT

COVERING ELECTRICAL DESIGN

WITH THE PROPERTY OF TAXABLE PROPERTY

DATE SIGNED: 11/17/23 LICENSE 11/30/25

RECONSTRUCT WEST AIRCRAFT T-HANGAR AREA PAVEMENTS

IDA No: MTO-4816 SBG Project No: N/A

Contract No. CO072

NO. DATE DESCRIPTION
DES DWN REV

ISSUE: 11/17/2023

PROJECT NO: 22A0001D

CAD FILE: E-505-DETL.DWG

CAD FILE: E-505-DETL.DWG


DESIGN BY: KNL 09/23/2023


DRAWN BY: JC 09/26/2023

REVIEWED BY: KNL 11/13/2023

SHEET TITLE


HANDHOLE AND SPLICE CAN DETAILS

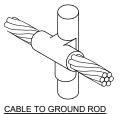


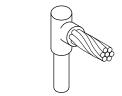


CABLE TO GROUND ROD



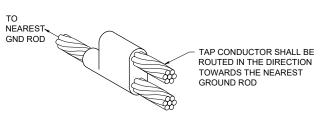

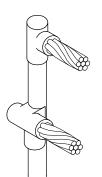

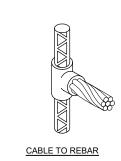

CABLE TO CABLE


HORIZONTAL PARALLEL TAP

CABLES TO GROUND ROD

DETAIL NOTES

- 1. ALL BELOW GRADE CONNECTIONS TO GROUND RODS & GROUND RING CONDUCTORS SHALL BE EXOTHERMIC WELD TYPE CONNECTIONS. EXOTHERMIC WELDS SHALL BE CADWELD AS MANUFACTURED BY PENTAIR ERICO PRODUCTS, ULTRAWELD AS MANUFACTURED BY HARGER LIGHTNING PROTECTION & GROUNDING EQUIPMENT, OR THERMOWELD AS MANUFACTURED BY CONTINENTAL INDUSTRIES OR APPROVED EQUAL. VERIFY PROPER SIZES, MOLDS, TYPES, AND REQUIREMENTS FOR THE RESPECTIVE APPLICATION WITH THE MANUFACTURER, AND INSTALL PER THEIR DIRECTIONS.
- 2. FOR APPLICATIONS TO GALVANIZED STEEL OR PAINTED STEEL, REMOVE GALVANIZING AND/OR PAINT & CLEAN THE SURFACE TO EXPOSE BARE STEEL BEFORE MAKING EXOTHERMIC WELD CONNECTION.
- 3. INDIVIDUAL GROUNDING ELECTRODE CONDUCTORS SHALL NOT BE INSTALLED IN METAL CONDUIT. INSTALL GROUNDING ELECTRODE CONDUCTORS IN SCHED 80 PVC CONDUIT AS REQUIRED IN FOUNDATIONS, FOR PROTECTION, WHERE ENTERING ENCLOSURES, ETC. WHERE PLASTIC CONDUIT IS USED FOR INDIVIDUAL GROUND WIRES, DO NOT COMPLETELY ENCIRCLE THE CONDUIT WITH FERROUS AND/OR MAGNETIC MATERIALS. WHERE METAL CLAMPS ARE INSTALLED USE NYLON BOLTS, NUTS, WASHERS, & SPACERS TO INTERRUPT A COMPLETE METALLIC PATH FROM ENCIRCLING THE CONDUIT.

EXOTHERMIC WELD DETAILS

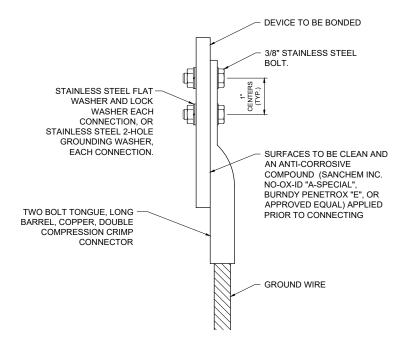



2 HOLE LONG BARREL COMPRESSION LUG TABLE (OR APPROVED EQUAL)			
WIRE SIZE	BURNDY CAT. NO.	THOMAS & BETTS CAT. NO.	PENN-UNION CAT. NO.
#8 AWG STRANDED	YA8C-2TC38	256-30695-1157	BBLU-8D-2TC38
#6 AWG SOLID	YA8C-2TC38 OR YGA6C-2TC38E2G1		
#6 AWG STRANDED	YA6C-2TC38	256-30695-1158	BBLU-6D-2TC38
#4 AWG STRANDED	YA4C-2TC38	256-30695-1159	BBLU-4D-2TC38
#2 AWG STRANDED	YA2C-2TC38	256-30695-1160	BBLU-2D-2TC38
#2 AWG SOLID	YA3C-2TC38	256-30695-1160	BBLU-3D-2TC38
#1/0 AWG STRANDED	YA25-2TC38	256-30695-1162	BBLU-1/0D-2TC38
#2/0 AWG STRANDED	YA26-2TC38	256-30695-1116	BBLU-2/0D-2TC38
#3/0 AWG STRANDED	YA27-2TC38	54816BE	BBLU-3/0D-2TC38
#4/0 AWG STRANDED	YA28-2TC38	256-30695-1117	BBLU-4/0D-2TC38

NOTES

- ALL CONNECTIONS TO GROUND BUS BAR SHALL BE WITH 2 HOLE TONGUE LONG BARREL COMPRESSION LUGS BOLTED TO THE BUS BAR.
- 2. GROUND WIRE CONNECTIONS TO EQUIPMENT SHALL BE WITH 2 HOLE TONGUE LONG BARREL COMPRESSION LUGS BOLTED TO THE DEVICE OR WITH THE RESPECTIVE EQUIPT MANUFACTURER'S LUG OR TERMINAL WHERE APPLICABLE
- GROUNDING ELECTRODE CONDUCTORS, BONDING JUMPERS, & INDIVIDUAL GROUND WIRES SHALL NOT BE INSTALLED IN METAL CONDUIT. WHERE PLASTIC CONDUIT IS USED FOR INDIVIDUAL GROUND WIRES, DO NOT COMPLETELY ENCIRCLE THE CONDUIT WITH FERROUS AND/OR MAGNETIC MATERIALS. WHERE METAL CLAMPS ARE INSTALLED USE NYLON BOLTS. NUTS, WASHERS, & SPACERS TO INTERRUPT A COMPLETE METALLIC APTH FROM ENCIRCLING THE CONDUIT
- 4. ALL CONNECTIONS SHALL BE COATED WITH A CORROSION PREVENTATIVE COMPOUND (SANCHEM INC. NO-OX-ID "A-SPECIAL", BURNDY PENETROX E, OR APPROVED EQUAL) BEFORE JOINING. ALL COPPER BUS BARS SHALL BE CLEANED PRIOR TO MAKING CONNECTIONS TO REMOVE SURFACE OXIDATION. CLEAN SURFACES, OF RESPECTIVE DEVICES TO BE BONDED, TO BARE METAL,

GROUNDING LUG CONNECTION DETAIL

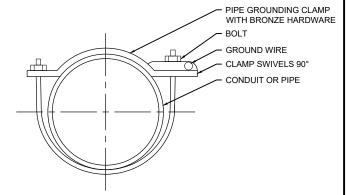

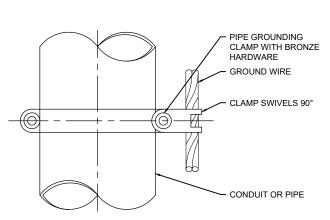

PIPE GROUNDING CLAMP TABLE (OR APPROVED EQUAL)			
BURNDY CAT. NO.	THOMAS & BETTS CAT. NO.	PIPE SIZE	
GAR3902-BU	3902BU	1/2" - 1"	
GAR3903-BU	3903BU	1 1/4" - 2"	
GAR3904-BU	3904BU	2 1/2" - 3 1/2"	
GAR3905-BU	3905BU	4" - 5"	
GAR3906-BU	3906BU	6"	

NOTES

- PIPE GROUNDING CLAMPS SHALL HAVE BRONZE HARDWARE BE CORROSION RESISTANT, SUITABLE FOR DIRECT BURIAL IN EARTH OR CONCRETE, & UL 467 LISTED.
- PENN-UNION TYPE "GPL" SERIES PIPE GROUNDING CLAMPS PROPERLY SIZED FOR THE RESPECTIVE PIPE AND GROUND WIRE ARE ALSO ACCEPTABLE.
- HARGER CPC AND APC SERIES PIPE GROUNDING CLAMPS PROPERLY SIZED FOR THE RESPECTIVE PIPE AND GROUND WIRE ARE ALSO ACCEPTABLE.

PIPE/CONDUIT GROUNDING CLAMP DETAIL



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DATE SIGNED: 11/17/23 LICENSE 11/30/25

RECONSTRUCT WEST AIRCRAFT T-HANGAR AREA PAVEMENTS

IDA No: MTO-4816 SBG Project No: N/A

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NO.	DATE	DES	CRIPT	ION
NO.	DATE	DES	DWN	REV
SSUE:	11/17/20)23		

PROJECT NO: 22A0001D

CAD FILE: E-504-DETL.DWG DESIGN BY: KNI 09/16/2023 DRAWN BY: CWS 09/18/2023

SHEET TITLE


GROUNDING DETAILS

REVIEWED BY: KNL 11/13/2023

THE CONTRACTOR SHALL FURNISH AND INSTALL ALL GROUNDING AS MAY BE NECESSARY OR REQUIRED TO MAKE A COMPLETE GROUNDING SYSTEM AS REQUIRED BY THE LATEST NATIONAL ELECTRICAL CODE (NFPA 70) IN FORCE AND AS DETAILED HEREIN. THE RELIABILITY OF THE GROUNDING SYSTEM IS DEPENDENT ON CAREFUL PROPER INSTALLATION AND CHOICE OF MATERIALS. IMPROPER PREPARATION OF SURFACES TO BE JOINED TO MAKE AN ELECTRICAL PATH, LOOSE JOINTS OR CORROSION CAN INTRODUCE IMPEDANCE THAT WILL SERIOUSLY IMPAIR THE ABILITY OF THE GROUND PATH TO PROTECT PERSONNEL AND EQUIPMENT AND TO ABSORB TRANSIENTS THAT CAN CAUSE NOISE IN COMMUNICATIONS CIRCUITS. THE FOLLOWING FUNCTIONS ARE PARTICULARLY IMPORTANT TO ENSURE A RELIABLE GROUND SYSTEM:

- FURNISH AND INSTALL GROUND RODS AS DETAILED HEREIN. GROUND RODS FOR ELECTRICAL INSTALLATIONS SHALL BE MINIMUM 3/4-IN. DIAMETER BY 10-FT LONG, UL-LISTED, COPPER CLAD WITH 10-MIL MINIMUM COPPER COATING. GROUND RODS FOR FENCE GROUNDING SHALL BE MINIMUM 5/8-IN. DIAMETER BY 8-FT. LONG, UL LISTED, COPPER CLAD WITH 10-MIL MINIMUM COPPER COATING. GROUND RODS SHALL BE SPACED OR AS DETAILED ON THE RESPECTIVE PLANS, AND IN NO CASE SPACED LESS THAN ONE ROD LENGTH APART. ALL CONNECTIONS TO GROUND RODS, GROUND FIELDS, AND/OR THE GROUND RING SHALL BE MADE WITH EXOTHERMIC WELD TYPE CONNECTORS, CADWELD BY PENTAIR ERICO PRODUCTS, INC., THERMOWELD BY CONTINENTAL INDUSTRIES, ULTRAWELD BY HARGER, OR APPROVED EQUAL EXOTHERMIC WELD CONNECTIONS SHALL BE INSTALLED IN CONFORMANCE WITH THE RESPECTIVE MANUFACTURER'S DIRECTIONS USING MOLDS AS REQUIRED FOR EACH RESPECTIVE APPLICATION. BOLTED CONNECTIONS WILL NOT BE PERMITTED AT GROUND RODS OR AT BURIED GROUNDING ELECTRODE CONDUCTORS.
- CONTRACTOR SHALL TEST EACH MADE ELECTRODE GROUND ROD/GROUND FIELD/GROUND RING WITH AN INSTRUMENT SPECIFICALLY DESIGNED FOR TESTING GROUND FIELD SYSTEMS. IF GROUND RESISTANCE EXCEEDS 25 OHMS, CONTACT THE PROJECT ENGINEER OF RECORD FOR FURTHER DIRECTION. ALSO REFER TO EOR-047643 FOR ADDITIONAL INFORMATION ON GROUNDING REQUIREMENTS, WHERE APPLICABLE. COPIES OF GROUND ROD TEST RESULTS SHALL BE FURNISHED TO THE RESIDENT ENGINEER/TECHNICIAN AND THE PROJECT ENGINEER OF RECORD
- ALL PRODUCTS ASSOCIATED WITH THE GROUNDING SYSTEM SHALL BE UL-LISTED AND LABELED.
- ALL BOLTED OR MECHANICAL CONNECTIONS SHALL BE COATED WITH A CORROSION PREVENTATIVE COMPOUND BEFORE JOINING, SANCHEM INC. "NO-OX-ID "A-SPECIAL" COMPOUND, BURNDY PENETROX E, OR APPROVED EQUAL
- METALLIC SURFACES TO BE JOINED SHALL BE PREPARED BY THE REMOVAL OF ALL NON-CONDUCTIVE MATERIAL, PER 2020 NATIONAL ELECTRICAL CODE ARTICLE 250-12. ALL COPPER BUS BARS MUST BE CLEANED PRIOR TO MAKING CONNECTIONS TO REMOVE SURFACE OXIDATION
- METALLIC RACEWAY FITTINGS SHALL BE MADE UP TIGHT TO PROVIDE A PERMANENT LOW IMPEDANCE PATH FOR ALL CIRCUITS. METAL CONDUIT TERMINATIONS IN ENCLOSURES SHALL BE BONDED TO THE ENCLOSURE WITH UL-LISTED FITTINGS SUITABLE FOR GROUNDING. PROVIDE GROUNDING BUSHINGS WITH BONDING JUMPERS FOR ALL METAL CONDUITS ENTERING SERVICE EQUIPMENT (METER BASE, CT CABINET, MAIN SERVICE BREAKER ENCLOSURE, ETC.). PROVIDE GROUNDING BUSHINGS WITH BONDING JUMPERS FOR ALL METAL CONDUITS ENTERING AN ENCLOSURE THROUGH CONCENTRIC OR ECCENTRIC KNOCKOUTS THAT ARE PUNCHED OR OTHERWISE FORMED SO AS TO IMPAIR THE ELECTRICAL CONNECTION TO GROUND. STANDARD LOCKNUTS OR BUSHINGS SHALL NOT BE THE SOLE MEANS FOR BONDING WHERE A CONDUIT ENTERS AN ENCLOSURE THROUGH A CONCENTRIC OR ECCENTRIC KNOCKOUT
- ALL CONNECTIONS, LOCATED ABOVE GRADE, BETWEEN THE DIFFERENT TYPES OF GROUNDING CONDUCTORS SHALL BE MADE USING UL-LISTED DOUBLE COMPRESSION CRIMP TYPE CONNECTORS OR UL-LISTED BOLTED GROUND CONNECTORS. FOR GROUND CONNECTIONS TO ENCLOSURES, CASES AND FRAMES OF ELECTRICAL EQUIPMENT NOT SUPPLIED WITH GROUND LUGS THE CONTRACTOR SHALL DRILL REQUIRED HOLES FOR MOUNTING A BOLTED GROUND CONNECTOR. ALL BOLTED GROUND CONNECTORS SHALL BE BURNDY, THOMAS AND BETTS, PENN-UNION OR EQUAL TIGHTEN CONNECTIONS TO COMPLY WITH TIGHTENING TORQUES IN UL STANDARD 486A TO ASSURE PERMANENT AND EFFECTIVE GROUNDING.
- ALL METAL EQUIPMENT ENCLOSURES, CONDUITS, CABINETS, BOXES, RECEPTACLES. MOTORS, ETC. SHALL BE BONDED TO THE RESPECTIVE GROUNDING SYSTEM.
- PROVIDE ALL BOXES FOR PROPOSED OUTLETS, SWITCHES, CIRCUIT BREAKERS, ETC. WITH GROUNDING SCREWS. PROVIDE ALL PANELBOARD, SWITCHGEAR, ETC., ENCLOSURES WITH GROUNDING BARS WITH INDIVIDUAL SCREWS, LUGS, CLAMPS, ETC., FOR EACH OF THE GROUNDING CONDUCTORS THAT ENTER THEIR RESPECTIVE
- EACH NEW FEEDER CIRCUIT AND/OR BRANCH CIRCUIT SHALL INCLUDE AN EQUIPMENT GROUND WIRE. METAL RACEWAY OR CONDUIT SHALL NOT MEET THIS REQUIREMENT. THE EQUIPMENT GROUND WIRE FROM EQUIPMENT SHALL NOT BE SMALLER THAN ALLOWED BY 2020 NEC TABLE 250-122 "MINIMUM SIZE CONDUCTORS OR GROUNDING RACEWAY AND EQUIPMENT." WHEN CONDUCTORS ARE ADJUSTED IN SIZE TO COMPENSATE FOR VOLTAGE DROP. EQUIPMENT-GROUNDING CONDUCTORS SHALL BE ADJUSTED PROPORTIONATELY ACCORDING TO CIRCULAR MIL AREA. ALL EQUIPMENT GROUND WIRES SHALL BE COPPER, EITHER BARE OR INSULATED GREEN IN COLOR. WHERE THE EQUIPMENT GROUNDING CONDUCTORS ARE INSULATED, THEY SHALL BE IDENTIFIED BY THE COLOR GREEN, AND SHALL BE THE SAME INSULATION TYPE AS THE PHASE CONDUCTORS

- ALL EXTERIOR METAL CONDUIT, WHERE NOT ELECTRICALLY CONTINUOUS BECAUSE OF MANHOLES, HANDHOLES, NON-METALLIC JUNCTION BOXES, ETC., SHALL BE BONDED TO ALL OTHER METAL CONDUIT IN THE RESPECTIVE DUCT RUN, AND AT EACH END, WITH A COPPER-BONDING JUMPER SIZED IN CONFORMANCE WITH 2020 NEC 250-102. WHERE METAL CONDUITS TERMINATE IN AN ENCLOSURE (SUCH AS A MOTOR CONTROL CENTER SWITCHBOARD, ETC) WHERE THERE IS NOT ELECTRICAL CONTINUITY WITH THE CONDUIT AND THE RESPECTIVE ENCLOSURE, PROVIDE A BONDING JUMPER FROM THE RESPECTIVE ENCLOSURE GROUND BUS TO THE CONDUIT SIZED PER 2020 NEC 250-102.
- IT IS THE INTENT OF THIS SPECIFICATION THAT ALL MOTOR FRAMES. PUMP BASES ELECTRICAL EQUIPMENT ENCLOSURES, PANEL HOUSINGS, CONDUITS, BOXES, ETC. HAVE A CONTINUOUS COPPER WIRE GROUND CONNECTION AND SHALL BE POSITIVELY BONDED TO THE RESPECTIVE GROUNDING SYSTEM. CONDUIT CONNECTORS WILL NOT BE CONSIDERED AS ADEQUATE GROUNDING.
- PROVIDE A POSITIVE GROUND BOND FOR ALL OUTLET BOXES, ELECTRICAL EQUIPMENT ENCLOSURES, GROUNDING RECEPTACLES, TOGGLE SWITCHES, ETC. INSTALL A GROUNDING CONDUCTOR IN ALL WIRE AND CABLE RACEWAYS. GROUND CONDUCTOR TO HAVE 600-VOLT INSULATION AND BE IDENTIFIED BY A CONTINUOUS GREEN COLOR COATING. THEY SHALL BE USED SOLELY FOR GROUNDING PURPOSES AND BE ENTIRELY SEPARATE FROM WHITE GROUNDED NEUTRAL CONDUCTOR, EXCEPT AT SUPPLY SIDE OF SERVICE DISCONNECTING MEANS, WHERE GROUNDING AND NEUTRAL SYSTEMS ARE TO BE CONNECTED TO SERVICE GROUND
- EACH AND ALL GROUNDED CASED AND METAL PARTS ASSOCIATED WITH ELECTRICAL EQUIPMENT SHALL BE TESTED FOR CONTINUITY OF CONNECTION WITH GROUND BUS SYSTEM BY CONTRACTOR IN PRESENCE OF OWNER'S REPRESENTATIVE.
- ALL CONNECTIONS BETWEEN THE DIFFERENT TYPES OF GROUNDING CONDUCTORS ABOVE GRADE SHALL BE MADE USING BOLTED GROUND CONNECTORS. GROUND LUGS SHALL BE PROVIDED IN ALL ENCLOSURES AND WIRING TERMINATION JUNCTION BOXES. EQUIPMENT GROUNDS AND GROUNDING CONDUCTOR SHALL BE CONNECTED TO THESE GROUND LUGS. FOR GROUND CONNECTIONS TO ENCLOSURES, CASES AND FRAMES OF ELECTRICAL EQUIPMENT NOT SUPPLIED WITH GROUND LUGS THE CONTRACTOR SHALL DRILL REQUIRED HOLES FOR MOUNTING A BOLTED GROUND CONNECTOR. ALL BOLTED GROUND CONNECTORS SHALL BE BURNDY, DOSSERT CORPORATION, ILSCO CORPORATION, PENN-UNION CORPORATION, THOMAS & BETTS, OR APPROVED EQUAL.
- BOND ALL NONCURRENT-CARRYING PARTS OF METAL EQUIPMENT TO GROUND SYSTEM.
- BUILDING STRUCTURAL STEEL SYSTEM SHALL BE BONDED TO ELECTRICAL GROUND
- INSTALL GROUNDING ELECTRODE CONDUCTORS, LIGHTNING PROTECTION DOWN CONDUCTORS AND SEPARATE GROUND CONDUCTORS IN SCHEDULE 80 PVC CONDUIT OR EXPOSED WHERE ACCEPTABLE TO LOCAL CODES. WHERE GROUNDING ELECTRODE CONDUCTORS, LIGHTNING PROTECTION DOWN CONDUCTORS OR INDIVIDUAL GROUND CONDUCTORS ARE RUN IN PVC CONDUIT, DO NOT COMPLETELY ENCIRCLE CONDUIT WITH FERROUS AND/OR MAGNETIC MATERIALS. USE NON-METALLIC REINFORCED FIBERGLASS STRUT SUPPORT. WHERE METAL CONDUIT CLAMPS ARE INSTALLED, USE NYLON BOLTS, NUTS, WASHERS AND SPACERS TO INTERRUPT A COMPLETE METALLIC PATH FROM ENCIRCLING THE CONDUIT. THIS IS REQUIRED TO AVOID GIRDLING OF GROUND CONDUCTORS. GIRDLING OF A GROUND CONDUCTOR IS THE RESULT OF PLACING THE CONDUCTOR IN A RING OF MAGNETIC MATERIAL. THIS RING COULD BE A METALLIC CONDUIT, U-BOLT OR STRUT SUPPORT PIPE CLAMP, OR OTHER SUPPORT HARDWARE. THE RESULT OF GIRDLING GROUND CONDUCTORS SIGNIFICANTLY INCREASES THE INDUCTIVE IMPEDANCE OF THE GROUND CONDUCTOR. INDUCTIVE AND CAPACITIVE IMPEDANCE IS A TYPE OF RESISTANCE THAT OPPOSES THE FLOW OF ALTERNATING CURRENT. ANY INCREASE IN THE IMPEDANCE OF A GROUND CONDUCTOR REDUCES ITS ABILITY TO EFFECTIVELY MITIGATE RADIO FREQUENCY NOISE IN THE GROUND SYSTEM. THE CONDITION WHERE A GROUND CONDUCTOR IS GIRDLED DURING A LIGHTNING STRIKE RESULTS IN PHENOMENA KNOWN AS SURGE IMPEDANCE LOADING. SURGE IMPEDANCE LOADING IS A RESULT OF VOLTAGE AND CURRENT REACHING 500,000 VOLTS AND 10,000 AMPS FOR A SHORT DURATION. GIRDLING FURTHER INCREASES THE IMPEDANCE AT LIGHTNING FREQUENCIES OF 100 KILOHERTZ TO 100 MEGAHERTZ. AT THESE POWER AND FREQUENCY LEVELS ANY INCREASE IN THE IMPEDANCE OF THE GROUND CONDUCTOR MUST BE CONTROLLED. DURING LIGHTNING DISCHARGE CONDITIONS A LOW INDUCTIVE IMPEDANCE PATH IS MORE IMPORTANT THAN A LOW DC
- IF LOCAL CODES DICTATE THAT INDIVIDUAL GROUNDING CONDUCTORS MUST BE RUN IN METAL CONDUIT OR RACEWAY, THEN THE CONDUIT OR RACEWAY MUST BE BONDED AT EACH END OF THE RUN WITH A BONDING JUMPER SIZED EQUAL TO THE INDIVIDUAL GROUNDING CONDUCTOR OR AS REQUIRED BY 2020 NEC 250-102. NOTE THIS DOES NOT APPLY TO AC EQUIPMENT GROUNDING CONDUCTORS RUN WITH AC CIRCUITS.
- NEVER REMOVE. ALTER. OR ATTEMPT TO REPAIR CONDUCTORS OR CONDUIT SYSTEMS PROVIDING GROUNDING OR ELECTRICAL BONDING FOR ANY ELECTRICAL EQUIPMENT UNTIL ALL POWER IS REMOVED FROM EQUIPMENT. WARN ALL PERSONNEL OF THE UNGROUNDED CONDITION OF THE EQUIPMENT. DISPLAY APPROPRIATE WARNING SIGNS, SUCH AS DANGER TAGS TO WARN PERSONNEL OF THE POSSIBLE HAZARDS.
- GROUNDING WORK AND MODIFICATIONS SHALL NOT BE PERFORMED DURING A THUNDERSTORM OR WHEN A THUNDERSTORM IS PREDICTED IN THE AREA
- WHERE A CONFLICT IS DETERMINED WITH RESPECT TO GROUNDING REQUIREMENTS PER MANUFACTURER INSTALLATION INSTRUCTIONS, NEC, AND/OR THE CONTRACT DOCUMENTS, CONTACT THE PROJECT ENGINEER OF RECORD FOR FURTHER DIRECTIONS
- GROUND RODS SHALL BE MANUFACTURED IN THE UNITED STATES OF AMERICA FROM 100 PERCENT DOMESTIC STEEL TO COMPLY WITH THE AIRPORT IMPROVEMENT PROGRAM BUY AMERICAN REQUIREMENTS, AND/OR THE STEEL PRODUCTS PROCUREMENT ACT (30

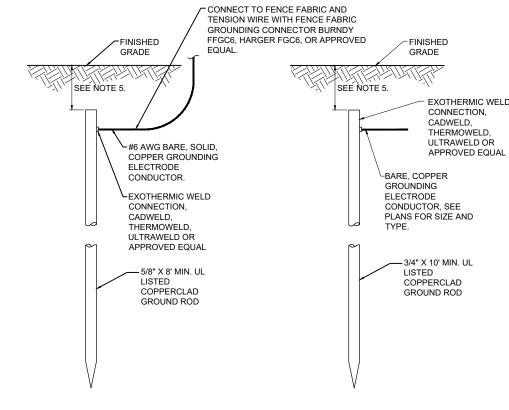

8 FT. GROUND ROD FOR FENCING

10 FT. GROUND ROD

NOTES

- TYPE AND MINIMUM NUMBER OF GROUND RODS SHALL BE AS SPECIFIED ON THE PLAN
- THE RESISTANCE TO GROUND OF THE GROUNDING SYSTEM SHALL NOT EXCEED 25 OHMS
- COST OF GROUND RODS IS INCIDENTAL TO THE ASSOCIATED ITEMS REQUIRING GROUNDING UNLESS OTHERWISE SPECIFIED
- GROUND RODS SHALL BE SPACED AS DETAILED ON THE PLANS AND SHALL NOT BE SPACED LESS THAN ONE ROD LENGTH APART.
- TOP OF GROUND RODS FOR ELECTRICAL INSTALLATIONS SHALL BE 12" MINIMUM BELOW GRADE UNLESS DETAILED OTHERWISE HEREIN. TOP OF GROUND RODS FOR FENCING APPLICATIONS (NON-ELECTRICAL INSTALLATIONS) SHALL BE 6" MINIMUM BELOW GRADE UNLESS DETAILED
- GROUND RODS FOR FENCING SHALL BE A MINIMUM 5/8-INCH DIAMETER BY 8-FT LONG UL LISTED COPPER CLAD.
- GROUND RODS FOR GATE OPERATORS AND OTHER ELECTRICAL EQUIPMENT SHALL BE A MINIMUM 3/4-INCH DIAMETER BY 10-FT LONG UL LISTED COPPER
- CONTINUOUS FENCE SHALL BE GROUNDED AT INTERVALS NOT EXCEEDING 500 FT IN URBAN AREAS AND 1,000 FT IN RURAL AREAS. THERE SHALL BE A GROUND WITHIN 100 FT OF GATES IN EACH SECTION OF THE FENCE ADJACENT TO THE GATE. FENCE UNDER A POWER LINE SHALL BE GROUNDED BY THREE GROUNDS; ONE DIRECTLY UNDER THE CROSSING AND ONE ON EACH SIDE 25 FT TO 50 FT AWAY. A SINGLE GROUND SHALL BE LOCATED DIRECTLY UNDER EACH TELEPHONE WIRE OR CABLE CROSSING. THE GROUND WIRE SHALL BE CONNECTED TO THE FABRIC AND TENSION WIRE WITH UL LISTED FENCE FABRIC GROUND CLAMPS; BURNDY CAT. NO. FFGC6, HARGER CAT NO. FGC6, OR APPROVED EQUAL. GROUNDING CONNECTORS SHALL BE SIZED AND SUITABLE FOR THE RESPECTIVE APPLICATION. CONNECTIONS TO GROUND RODS SHALL BE WITH UL LISTED CONNECTORS SUITABLE FOR DIRECT BURY IN EARTH OR EXOTHERMIC WELD TYPE CONNECTORS. THE GROUND WIRE USED TO BOND THE FENCE FABRIC AND TENSION WIRE TO THE GROUND ROD SHALL BE #6 AWG BARE SOLID COPPER CONDUCTOR.

GROUND RODS



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> **COLES COUNTY AIRPORT** AUTHORITY



DATE SIGNED: 11/17/23 LICENSE 11/30/25

RECONSTRUCT WEST AIRCRAFT T-HANGAR AREA PAVEMENTS

IDA No: MTO-4816 SBG Project No: N/A

Contract No. CO072

DESCRIPTION NO. DATE DES DWN REV ISSUE: 11/17/2023

PROJECT NO: 22A0001D

CAD FILE: E-002-NOTES.DWG DESIGN BY: KNI 09/16/2023 DRAWN BY: CWS 09/18/2023

REVIEWED BY: KNL 11/13/2023

SHEET TITLE

GROUNDING NOTES


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DATE SIGNED: 11/17/23 LICENSE EXPIRES: 11/30/25

RECONSTRUCT WEST AIRCRAFT T-HANGAR AREA PAVEMENTS

IDA No: MTO-4816 SBG Project No: N/A

Contract No. CO072

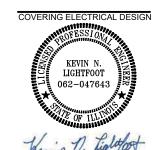

DESIGN BY: KNL 09/16/2023 DRAWN BY: CWS 09/18/2023 REVIEWED BY: KNL 11/13/2023

SHEET TITLE

EXIST ELEC 1-LINE FOR VAULT & BLDGS B THRU G

EXISTING ELECTRICAL ONE LINE FOR AIRPORT VAULT & BUILDINGS B THROUGH G CONTINUED

NOTES:

EXISTING ONE-LINE DIAGRAM WIRING IS BASED ON FIELD DATA AND INFORMATION PROVIDED BY OTHERS. CONTRACTOR SHALL FIELD VERIFY EXISTING CONDITIONS AND WIRING AND REPORT ANY VARIATIONS TO THE ENGINEER OF RECORD AND THE AIRPORT MANAGER. CONTRACTOR SHALL FIELD VERIFY RESPECTIVE CIRCUITS AND POWER SOURCES PRIOR TO WORKING ON, REMOVING, REPLACING, DISCONNECTING OR CONNECTING THE RESPECTIVE AIRFIELD LIGHTING, PANEL, SAFETY SWITCH, GATE OPERATOR, OR OTHER DEVICE.



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AUTHORITY
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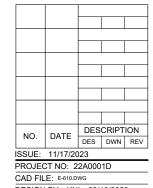


DATE SIGNED: 11/17/23 LICENSE 11/30/25 EXPIRES: 11/30/25

RECONSTRUCT WEST AIRCRAFT T-HANGAR AREA PAVEMENTS

IDA No: MTO-4816 SBG Project No: N/A


Contract No. CO072



DESIGN BY: KNL 09/16/2023 DRAWN BY: CWS 09/18/2023 REVIEWED BY: KNL 11/13/2023

SHEET TITLE

EXIST ELEC 1-LINE FOR VAULT & BLDGS B THRU G CONTINUED

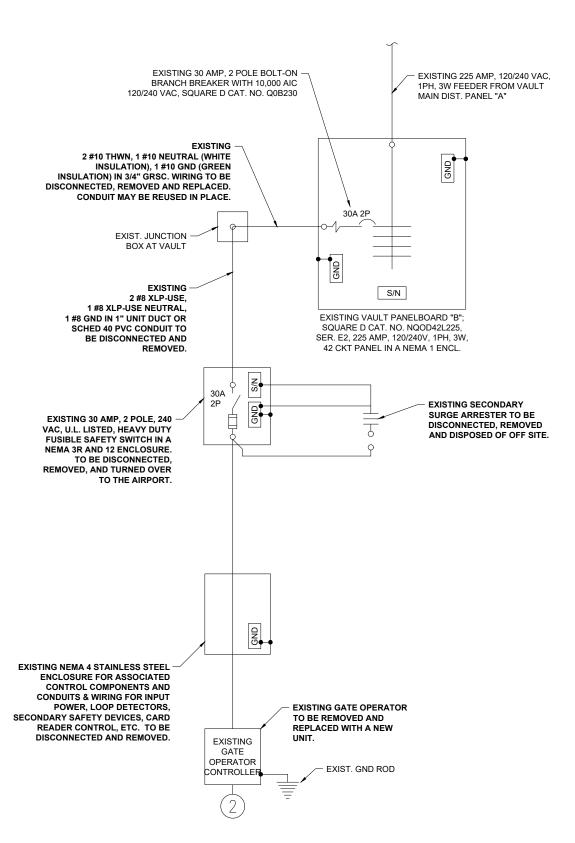

EXISTING WEST GATE #1 OPERATOR ELECTRICAL ONE LINE DIAGRAM

NOTES:

- 1. ALL WORK, POWER OUTAGES, AND/OR SHUT DOWN OF EXISTING SYSTEMS SHALL BE COORDINATED WITH THE AIRPORT DIRECTOR/MANAGER. ONCE SHUT DOWN, THE CIRCUITS SHALL BE LABELED AS SUCH TO PREVENT ACCIDENTAL ENERGIZING OF THE RESPECTIVE CIRCUITS. ALL PERSONNEL SHALL FOLLOW U.S. DEPARTMENT OF LABOR OCCUPATIONAL SAFETY & HEALTH ADMINISTRATION (OSHA) 29 CFR PART 1910 OCCUPATIONAL SAFETY & HEALTH STANDARDS FOR ELECTRICAL SAFETY AND LOCKOUT/TAGOUT PROCEDURES INCLUDING, BUT NOT LIMITED TO, 29 CFR SECTION 1910.147 THE CONTROL OF HAZARDOUS ENERGY (LOCKOUT/TAGOUT)
- CONTRACTOR SHALL COMPLY WITH THE APPLICABLE REQUIREMENTS OF NFPA 70E - STANDARD FOR ELECTRICAL SAFETY IN THE WORKPLACE.
- CONTRACTOR SHALL FIELD VERIFY EXISTING SITE CONDITIONS.
 CONTRACTOR SHALL FIELD VERIFY RESPECTIVE CIRCUITS AND POWER
 SOURCES PRIOR TO REMOVING, DISCONNECTING, RELOCATING, ADJUSTING,
 WORKING ON, INSTALLING, OR CONNECTING THE RESPECTIVE EQUIPMENT OR
 OTHER DEVICE. RESPECTIVE CIRCUITS SHALL BE DISCONNECTED AND/OR
 SHUT OFF AND LOCKED OFF FOR SAFETY OF PERSONNEL
- REMOVAL OF EXISTING ELECTRIC SLIDE GATE WILL BE PAID FOR UNDER ITEM AR162908 - REMOVE ELECTRIC GATE.




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RECONSTRUCT WEST AIRCRAFT T-HANGAR AREA PAVEMENTS

IDA No: MTO-4816 SBG Project No: N/A

Contract No. CO072

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PROJECT NO: 22A0001D CAD FILE: E-601.DWG

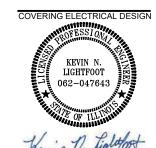DESIGN BY: KNL 09/16/2023 DRAWN BY: CWS 09/18/2023

REVIEWED BY: KNL 11/13/2023

SHEET TITLE

EXISTING WEST GATE NO. 1 ELECTRICAL ONE-LINE DIAGRAM

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NOTES:

ALL WORK, POWER OUTAGES, AND/OR SHUT DOWN OF EXISTING SYSTEMS

SHALL BE COORDINATED WITH THE AIRPORT DIRECTOR/MANAGER. ONCE

ACCIDENTAL ENERGIZING OF THE RESPECTIVE CIRCUITS. ALL PERSONNEL SHALL FOLLOW U.S. DEPARTMENT OF LABOR OCCUPATIONAL SAFETY &

HEALTH ADMINISTRATION (OSHA) 29 CFR PART 1910 OCCUPATIONAL SAFETY &

PROCEDURES INCLUDING, BUT NOT LIMITED TO, 29 CFR SECTION 1910.147 THE

SHUT DOWN, THE CIRCUITS SHALL BE LABELED AS SUCH TO PREVENT

HEALTH STANDARDS FOR ELECTRICAL SAFETY AND LOCKOUT/TAGOUT

CONTRACTOR SHALL COMPLY WITH THE APPLICABLE REQUIREMENTS OF

NFPA 70E - STANDARD FOR ELECTRICAL SAFETY IN THE WORKPLACE.

CONTRACTOR SHALL FIELD VERIFY RESPECTIVE CIRCUITS AND POWER

SOURCES PRIOR TO REMOVING, DISCONNECTING, RELOCATING, ADJUSTING,

OTHER DEVICE. RESPECTIVE CIRCUITS SHALL BE DISCONNECTED AND/OR

REMOVAL OF EXISTING ELECTRIC SLIDE GATE WILL BE PAID FOR UNDER ITEM

WORKING ON, INSTALLING, OR CONNECTING THE RESPECTIVE EQUIPMENT OR

CONTROL OF HAZARDOUS ENERGY (LOCKOUT/TAGOUT)

3. CONTRACTOR SHALL FIELD VERIFY EXISTING SITE CONDITIONS.


SHUT OFF AND LOCKED OFF FOR SAFETY OF PERSONNEL

AR162908 - REMOVE ELECTRIC GATE.

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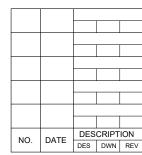


DATE SIGNED: 11/17/23 LICENSE 11/30/25

RECONSTRUCT WEST AIRCRAFT T-HANGAR AREA PAVEMENTS

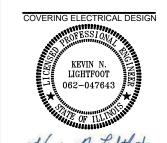IDA No: MTO-4816 SBG Project No: N/A

Contract No. CO072




ISSUE: 11/17/2023 PROJECT NO: 22A0001D

CAD FILE: E-602.DWG DESIGN BY: KNL 09/16/2023


DRAWN BY: CWS 09/19/2023 REVIEWED BY: KNL 11/13/2023

SHEET TITLE

EXISTING NORTH GATE NO. 2 **ELECTRICAL ONE-LINE DIAGRAM**

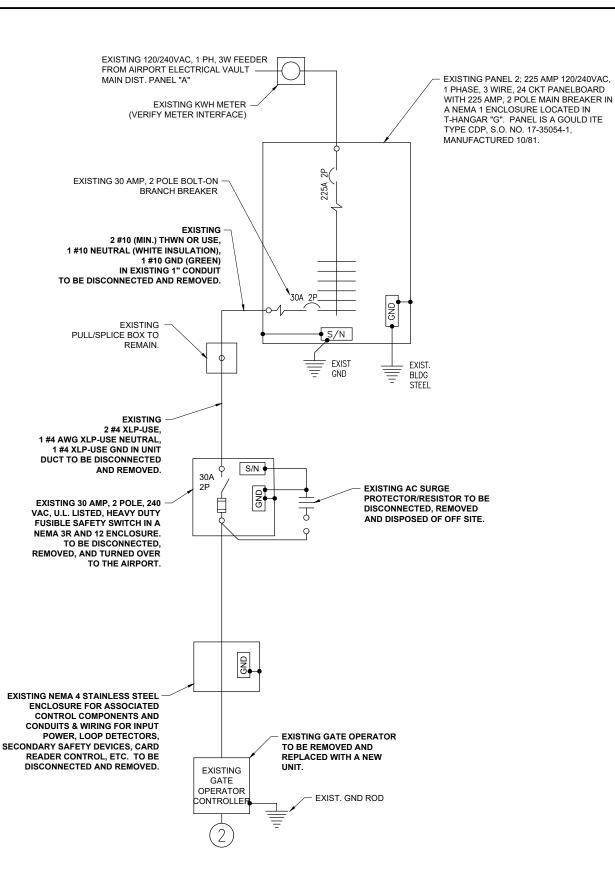

EXISTING NORTH GATE #2 OPERATOR ELECTRICAL ONE LINE DIAGRAM

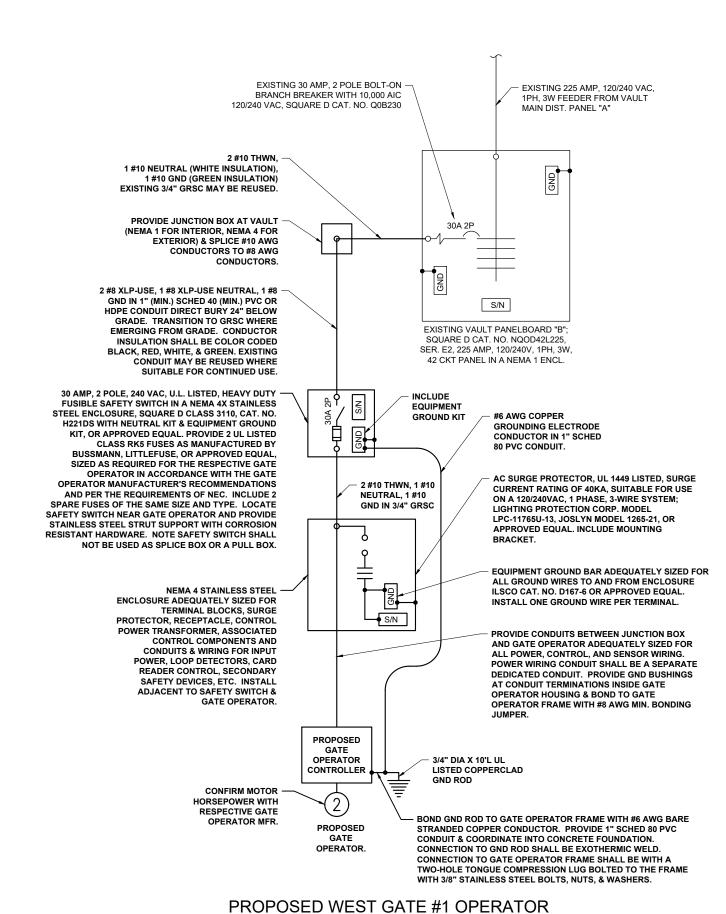

ELECTRICAL ONE LINE DIAGRAM

ELECTRICAL NOTES

- CONTRACTOR SHALL EXAMINE THE SITE TO DETERMINE EXISTING CONDITIONS
- SEE "ELECTRICAL LEGEND AND ABBREVIATIONS" SHEET FOR GENERAL NOTES AND REQUIREMENTS.
- ALL ELECTRICAL EQUIPMENT AND MATERIALS SHALL BE INSTALLED IN CONFORMANCE WITH NFPA 70-NATIONAL ELECTRICAL CODE (NEC) MOST CURRENT ISSUE IN FORCE, THE RESPECTIVE EQUIPMENT MANUFACTURER'S DIRECTIONS AND ALL OTHER APPLICABLE LOCAL CODES, LAWS, ORDINANCES AND REQUIREMENTS IN FORCE. ANY INSTALLATIONS WHICH VOID THE U.L. LISTING, INTERTEK TESTING SERVICES VERIFICATION/ETL LISTING, (OR OTHER THIRD PARTY LISTING) AND/OR THE MANUFACTURER'S WARRANTY OF A DEVICE WILL NOT BE PERMITTED.
- 4. MAINTAIN SECURITY OF AIRPORT THROUGHOUT GATE REPLACEMENT.
- 5. ALL EQUIPMENT SHOWN NOT LABELED AS EXISTING IS NEW.
- 6. ALL CONTROL POWER TRANSFORMERS, POWER SUPPLIES, SIMPLEX/DUPLEX RECEPTACLES, LOOP DETECTOR AMPLIFIERS, SECONDARY SAFETY DEVICE EQUIPMENT, AND ANY OTHER ASSOCIATED CONTROLS SHALL BE INSTALLED EITHER INSIDE THE GATE OPERATOR CONTROL PANEL OR INSIDE A SEPARATE NEMA 4 STAINLESS STEEL CONTROL PANEL ENCLOSURE. WHERE THE CONTROL EQUIPMENT IS TO BE INSTALLED INSIDE THE GATE OPERATOR CONTROL PANEL THE CONTRACTOR SHALL COORDINATE THIS WITH THE GATE OPERATOR MANUFACTURER AND THE RESPECTIVE GATE OPERATOR EQUIPMENT SUPPLIER. LOCATING THESE CONTROLS OUTSIDE OF GATE OPERATOR CONTROL PANEL BUT WITHIN THE GATE OPERATOR HOUSING WILL NOT MEET THIS REQUIREMENT.
- GATE OPERATORS SHALL BE RATED FOR THE RESPECTIVE VOLTAGE AVAILABLE AT THE SITE AND SHALL PROPERLY OPERATE ON THE RESPECTIVE NOMINAL VOLTAGE SYSTEM PLUS OR MINUS 10 PERCENT. CONTRACTOR SHALL CONFIRM WITH THE GATE OPERATOR MANUFACTURER THAT THE RESPECTIVE GATE OPERATOR HE SELECTS IS RATED SUITABLE FOR THE RESPECTIVE APPLICATION IS SUITABLE AND COMPATIBLE WITH THE RESPECTIVE GATE, AND WILL OPERATE PROPERLY ON THE RESPECTIVE POWER SUPPLY. NOTE THE GATE OPERATOR MUST ALSO OPERATE PROPERLY ON STANDBY ENGINE GENERATOR POWER AND SHALL NOT REQUIRE MANUAL RESET DUE TO TRANSFER FROM UTILITY POWER TO STANDBY GENERATOR POWER OR BACK TO UTILITY POWER. THE GATE OPERATOR MUST NOT REQUIRE MANUAL RESET FOR MOMENTARY POWER OUTAGES. WHERE A POWER OUTAGE OCCURS THE GATE OPERATOR SHALL AUTOMATICALLY RESUME NORMAL OPERATION UPON RESTORATION OF POWER.
- 3. FIELD VERIFY CONDUIT & CABLE ROUTING.



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DATE SIGNED: 11/17/23 LICENSE 11/30/25

RECONSTRUCT WEST AIRCRAFT T-HANGAR AREA PAVEMENTS

IDA No: MTO-4816 SBG Project No: N/A

Contract No. CO072

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PROJECT NO: 22A0001D

DESIGN BY: KNL 09/16/2023
DRAWN BY: CWS 09/18/2023

REVIEWED BY: KNL 11/13/2023

SHEET TITLE

PROPOSED WEST GATE NO. 1 ELECTRICAL ONE-LINE DIAGRAM

BOND GND ROD TO GATE OPERATOR FRAME WITH #6

CONCRETE FOUNDATION. CONNECTION TO GND ROD

SHALL BE EXOTHERMIC WELD. CONNECTION TO GATE OPERATOR FRAME SHALL BE WITH A TWO-HOLE TONGUE COMPRESSION LUG BOLTED TO THE FRAME WITH 3/8" STAINLESS STEEL BOLTS, NUTS, & WASHERS.

1" SCHED 40 PVC CONDUIT & COORDINATE INTO

AWG BARE STRANDED COPPER CONDUCTOR PROVIDE

ELECTRICAL NOTES

- CONTRACTOR SHALL EXAMINE THE SITE TO DETERMINE EXISTING
 CONDITIONS
- SEE "ELECTRICAL LEGEND AND ABBREVIATIONS" SHEET FOR GENERAL NOTES AND REQUIREMENTS.
- ALL ELECTRICAL EQUIPMENT AND MATERIALS SHALL BE INSTALLED IN CONFORMANCE WITH NFPA 70-NATIONAL ELECTRICAL CODE (NEC) MOST CURRENT ISSUE IN FORCE, THE RESPECTIVE EQUIPMENT MANUFACTURER'S DIRECTIONS AND ALL OTHER APPLICABLE LOCAL CODES, LAWS, ORDINANCES AND REQUIREMENTS IN FORCE. ANY INSTALLATIONS WHICH VOID THE U.L. LISTING, INTERTEK TESTING SERVICES VERIFICATION/ETL LISTING, (OR OTHER THIRD PARTY LISTING) AND/OR THE MANUFACTURER'S WARRANTY OF A DEVICE WILL NOT BE PERMITTED.
- 4. MAINTAIN SECURITY OF AIRPORT THROUGHOUT GATE REPLACEMENT.
- 5. ALL EQUIPMENT SHOWN NOT LABELED AS EXISTING IS NEW.
- ALL CONTROL POWER TRANSFORMERS, POWER SUPPLIES,
 SIMPLEX/DUPLEX RECEPTACLES, LOOP DETECTOR AMPLIFIERS,
 SECONDARY SAFETY DEVICE EQUIPMENT, AND ANY OTHER
 ASSOCIATED CONTROLS SHALL BE INSTALLED EITHER INSIDE THE
 GATE OPERATOR CONTROL PANEL OR INSIDE A SEPARATE NEMA 4
 STAINLESS STEEL CONTROL PANEL ENCLOSURE. WHERE THE
 CONTROL EQUIPMENT IS TO BE INSTALLED INSIDE THE GATE
 OPERATOR CONTROL PANEL THE CONTRACTOR SHALL COORDINATE
 THIS WITH THE GATE OPERATOR MANUFACTURER AND THE
 RESPECTIVE GATE OPERATOR EQUIPMENT SUPPLIER. LOCATING
 THESE CONTROLS OUTSIDE OF GATE OPERATOR CONTROL PANEL BUT
 WITHIN THE GATE OPERATOR HOUSING WILL NOT MEET THIS
 REQUIREMENT.
- 7. GATE OPERATORS SHALL BE RATED FOR THE RESPECTIVE VOLTAGE AVAILABLE AT THE SITE AND SHALL PROPERLY OPERATE ON THE RESPECTIVE NOMINAL VOLTAGE SYSTEM PLUS OR MINUS 10 PERCENT. CONTRACTOR SHALL CONFIRM WITH THE GATE OPERATOR MANUFACTURER THAT THE RESPECTIVE GATE OPERATOR HE SELECTS IS RATED SUITABLE FOR THE RESPECTIVE APPLICATION. IS SUITABLE AND COMPATIBLE WITH THE RESPECTIVE GATE, AND WILL OPERATE PROPERLY ON THE RESPECTIVE POWER SUPPLY. NOTE THE GATE OPERATOR MUST ALSO OPERATE PROPERLY ON STANDBY ENGINE GENERATOR POWER AND SHALL NOT REQUIRE MANUAL RESET DUE TO TRANSFER FROM UTILITY POWER TO STANDBY GENERATOR POWER OR BACK TO UTILITY POWER. THE GATE OPERATOR MUST NOT REQUIRE MANUAL RESET FOR MOMENTARY POWER OUTAGES. WHERE A POWER OUTAGE OCCURS THE GATE OPERATOR SHALL AUTOMATICALLY RESUME NORMAL OPERATION UPON RESTORATION OF POWER.
- 8. FIELD VERIFY CONDUIT & CABLE ROUTING.



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COLES COUNTY AIRPORT
AUTHORITY
COLES ON THE MEMORIAL AIRPORT

COVERING ELECTRICAL DESIGN

WEETING ELECTRICAL DESIGN

WEETING ELECTRICAL DESIGN

KEVIN N.

LIGHTFOOT

062-047643

DATE SIGNED: 11/17/23 LICENSE 11/30/25

RECONSTRUCT WEST AIRCRAFT T-HANGAR AREA PAVEMENTS

IDA No: MTO-4816 SBG Project No: N/A

Contract No. CO072

NO. DATE | DESCRIPTION | DES | DWN | REV | ISSUE: 11/17/2023

PROJECT NO: 22A0001D
CAD FILE: E-604.DWG

DESIGN BY: KNL 09/16/2023 DRAWN BY: CWS 09/19/2023

REVIEWED BY: KNL 11/13/2023

SHEET TITLE

PROPOSED NORTH GATE NO. 2 ELECTRICAL ONE-LINE DIAGRAM

HORSEPOWER WITH

RESPECTIVE GATE

OPERATOR MER.

PROPOSED

GATE

OPERATOR

GENERAL NOTES

- 1. THE EXISTING FBO HANGAR BUILDING "B" HAS APPARENT NATIONAL ELECTRICAL CODE VIOLATIONS WHICH MIGHT CAUSE UNSAFE WORKING CONDITIONS, APPARENT NEC VIOLATIONS INCLUDE, BUT ARE NOT LIMITED TO, NO GROUNDING ELECTRODE SYSTEM CONNECTED TO THE MAIN DISCONNECT, MISSING EQUIPMENT GROUND CONDUCTOR WITH FEEDER TO MAIN DISCONNECT, MISSING EQUIPMENT GROUND CONDUCTORS WITH FEEDER AND BRANCH CIRCUITS, DISCONNECTS AND PANEL ENCLOSURES NOT GROUNDED, POWER SOURCES NOT IDENTIFIED, AND PANELBOARD DIRECTORIES ARE MISSING, INCORRECT, AND/OR INCOMPLETE. CONTRACTOR WILL NEED TO EXERCISE CAUTION WHEN WORKING IN THIS FACILITY. CORRECTIVE MEASURES SHALL BE PROVIDED AS DETAILED HERE IN TO ADDRESS APPARENT CODE VIOLATIONS.
- CONTRACTOR SHALL EXAMINE THE SITE TO DETERMINE THE EXTENT OF THE WORK. CONTRACTOR SHALL FIELD VERIFY EXISTING SITE CONDITIONS. CONTRACTOR SHALL FIELD VERIFY RESPECTIVE CIRCUITS AND POWER SOURCES PRIOR TO REMOVING, DISCONNECTING, WORKING ON, RELOCATING, CONNECTING, OR RECONNECTING THE RESPECTIVE FEEDER CIRCUIT, HANGAR, ELECTRICAL DISTRIBUTION EQUIPMENT OR OTHER DEVICES.
- 3. ALL WORK, POWER OUTAGES, AND/OR SHUT DOWN OF EXISTING SYSTEMS SHALL BE COORDINATED WITH THE AIRPORT MANAGER. ONCE SHUT DOWN, THE CIRCUITS SHALL BE LABELED AS SUCH TO PREVENT ACCIDENTAL ENERGIZING OF THE RESPECTIVE CIRCUITS. ALL PERSONNEL SHALL FOLLOW U.S. DEPARTMENT OF LABOR OCCUPATIONAL SAFETY & HEALTH ADMINISTRATION (OSHA) 29 CFR PART 1910 OCCUPATIONAL SAFETY & HEALTH STANDARDS FOR ELECTRICAL SAFETY AND LOCKOUT/TAGOUT PROCEDURES INCLUDING, BUT NOT LIMITED TO, 29 CFR SECTION 1910.147 THE CONTROL OF HAZARDOUS ENERGY (LOCKOUT/TAGOUT).
- CONTRACTOR SHALL COMPLY WITH THE REQUIREMENTS OF FAA AC NO. 150/5370-2G (OR MOST CURRENT ISSUE) "OPERATIONAL SAFETY ON AIRPORTS DURING CONSTRUCTION".
- CONTRACTOR SHALL COMPLY WITH THE APPLICABLE
 REQUIREMENTS OF NFPA 70E STANDARD FOR ELECTRICAL
 SAFETY IN THE WORKPLACE.

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KEVIN N.

LIGHTFOOT

062-047643

DATE SIGNED: 11/17/23 LICENSE 11/30/25

RECONSTRUCT WEST AIRCRAFT T-HANGAR AREA PAVEMENTS

IDA No: MTO-4816 SBG Project No: N/A

Contract No. CO072

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SHEET TITLE

EXISTING ELECTRICAL ONE LINE FOR HANGARS D1 AND D2

EXISTING ELECTRICAL ONE-LINE DIAGRAM FOR HANGARS D1 AND D2

ELECTRICAL NOTES:

- ALL ELECTRICAL EQUIPMENT SHALL BE INSTALLED IN CONFORMANCE WITH NFPA 70 (NEC MOST CURRENT ISSUE IN FORCE), THE RESPECTIVE EQUIPMENT MANUFACTURER'S DIRECTIONS AND ALL OTHER APPLICABLE LOCAL CODES, LAWS, ORDINANCES AND REQUIREMENTS IN FORCE. ANY INSTALLATIONS WHICH VOID THE UL LISTINGS, INTERTEK TESTING SERVICES VERIFICATION/ETL LISTING, (OR OTHER THIRD PARTY LISTING) AND/OR THE MANUFACTURER'S WARRANTY OF A DEVICE WILL NOT BE PERMITTED.
- 2. PER NEC 513 THE ENTIRE AREA OF THE HANGAR INCLUDING ANY ADJACENT AND COMMUNICATING AREAS NOT SUITABLY CUT OFF FROM THE HANGAR, SHALL BE CLASSIFIED AS A CLASS 1, DIVISION 2 HAZARDOUS LOCATION UP TO A LEVEL 18 INCHES ABOVE THE FLOOR. THE AREA WITHIN 5 FT. HORIZONTALLY FROM AIRCRAFT POWER PLANTS OR AIRCRAFT FUEL TANKS SHALL BE CLASSIFIED AS A CLASS I, DIVISION 2 LOCATION THAT SHALL EXTEND UPWARD FROM THE FLOOR TO A LEVEL 5 FT. ABOVE THE UPPER SURFACE OF WINGS AND OF ENGINE ENCLOSURES. ALL ELECTRICAL INSTALLATIONS IN CLASSIFIED HAZARDOUS LOCATIONS SHALL BE AVOIDED UNLESS SPECIFICALLY APPROVED FOR SUCH LOCATIONS AND INSTALLED IN CONFORMANCE WITH NEC 500, 501 AND 513 AS WELL AS ANY OTHER APPLICABLE CODES AND REQUIREMENTS.
- 3. SAFETY SWITCHES, PANELBOARDS & LOAD CENTERS SHALL BE LOCATED SUCH THAT THEY WILL BE A MINIMUM OF 5 FEET CLEAR OF AIRCRAFT ENGINES AND FUEL TANK AREAS. NO ELECTRICAL ENCLOSURES AND NO CONDUITS SHALL BE INSTALLED THAT EXTEND INTO THE AREA 18 INCHES ABOVE THE FLOOR IN THE HANGARS.
- 4. FURNISH & INSTALL A WEATHERPROOF WARNING LABEL FOR EACH METER SOCKET, SERVICE DISCONNECT, SAFETY SWITCH, PANELBOARD & LOAD CENTER TO WARN PERSONS OF POTENTIAL ELECTRIC ARC FLASH HAZARDS, PER THE REQUIREMENTS OF NEC 110.16 "FLASH PROTECTION".
- 5. COLOR CODE PHASE AND NEUTRAL CONDUCTOR INSULATION FOR NO. 6 AWG OR SMALLER. PROVIDE COLORED INSULATION OR COLORED MARKING TAPE FOR PHASE AND NEUTRAL CONDUCTORS FOR NO. 4 AWG AND LARGER. NEUTRAL #6 AWG AND SMALLER REQUIRES WHITE INSULATION PER NEC 200.6. INSULATED GROUND CONDUCTORS SHALL HAVE GREEN COLORED INSULATION FOR ALL CONDUCTOR AWG AND/OR KCMIL. STANDARD COLORS FOR POWER WIRING AND BRANCH CIRCUITS SHALL BE AS FOLLOWS:

120/240 VAC, 1 PHASE, 3 WIRE
PHASE A BLACK
PHASE B RED
NEUTRAL WHITE
GROUND GREEN

- . ALL CONDUCTORS SHALL BE COPPER. FEEDER CONDUCTORS TO HANGARS D1 & D2 SHALL BE 600 VOLT TYPE THWN, OR TYPE XHHW OR TYPE USE. FEEDER AND BRANCH CIRCUIT CONDUCTORS INSIDE THE HANGAR SHALL BE 600 VOLT TYPE THWN. ALL CONDUCTORS SHALL BE SIZED PER NEC 75 DEG. C. AMPACITY TABLES. WHERE TYPE USE CONDUCTORS ARE SUBSTITUTED FOR THWN CONDUCTOR INCREASE CONDUIT SIZES, AS APPLICABLE TO MEET NEC CONDUIT & TUBING FILL REQUIREMENTS.
- ALL EQUIPMENT AND MATERIALS NOT LABELED AS EXISTING ARE NEW.



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KEVIN N.
LIGHTFOOT
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062-047643

DATE SIGNED: 11/17/23 LICENSE 11/30/25

RECONSTRUCT WEST AIRCRAFT T-HANGAR AREA PAVEMENTS

IDA No: MTO-4816 SBG Project No: N/A

Contract No. CO072

NO. DATE DESCRIPTION
DES DWN REV
ISSUE: 11/17/2023

PROJECT NO: 22A0001D
CAD FILE: E-606.DWG

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SHEET TITLE


PROPOSED ELECTRICAL ONE LINE FOR HANGARS D1 AND D2

PROPOSED ELECTRICAL ONE-LINE DIAGRAM FOR HANGARS D1 AND D2

100AMP (MIN), 120/240VAC, 1 PHASE, 3 WIRE 18 CIRCUIT (MIN.) PANELBOARD WITH 100AMP, 2 POLE MAIN BREAKER AND FEED THROUGH LUGS OR MAIN LUG PANEL WITH 100 AMP, 2 POLE BACKFED MAIN BREAKER AND USE MAIN LUGS AS FEED THROUGH LUGS, IN A NEMA 1 ENCLOSURE UL-LISTED SUITABLE FOR SERVICE ENTRANCE. PANEL SHALL ACCOMMODATE FEEDER AND BRANCH BREAKERS UP TO 100AMP, 2 POLE FRAME & TRIP RATING.

NOTES

- 1. MAIN, BRANCH CIRCUIT & FEEDER BREAKERS SHALL HAVE 10,000 AIC (MIN.) AT 120/240 VAC.
- 2. CIRCUIT BREAKERS AND WIRING SHALL BE SIZED FOR THE ACTUAL EQUIPMENT FURNISHED IN CONFORMANCE WITH THE RESPECTIVE MANUFACTURER'S RECOMMENDATION AND N.E.C. CONTRACTOR SHALL ADJUST CIRCUIT BREAKER SIZES & WIRING WHERE APPLICABLE TO CONFORM WITH THE MANUFACTURER'S RECOMMENDATIONS AND N.E.C. WHERE EXTERIOR LIGHTING REQUIRES 240 VAC POWER PROVIDE 2-POLE BREAKERS SIZED FOR THE APPLICATION.
- 3. FOR A BOTTOM FEED PANEL, MOVE AC SURGE PROTECTOR BREAKER DOWN TO POSITIONS 16 AND 18.
- 4. LOCATE REPLACEMENT PANEL TO PROVIDE MINIMUM 3 FEET CLEAR WORKING SPACE IN FRONT OF PANEL NOT LESS THAN 30 INCHES IN WIDTH. MAINTAIN 5 FEET CLEAR OF AIRCRAFT FUEL TANKS AND ENGINES. PANEL TOP SHALL NOT EXCEED 6 FEET ABOVE FLOOR, PANEL BOTTOM SHALL NOT BE LESS THAN 24 INCHES ABOVE FLOOR, TO COMPLY WITH NEC 513.
- 5. INCLUDE WITH THE PANELBOARD A U.L. LISTED PER U.L. 1449, AC SURGE PROTECTOR SUITABLE FOR 120/240 VAC, 1 PH 3W PLUS GROUND SYSTEM, WITH SURGE CURRENT RATING OF 40KA (MIN.) 8X20 MICROSECOND WAVE, AND STATUS INDICATION LIGHTS, JOSLYN MODEL 1265-21, SQUARE D CAT. NO. TVS120XR50S OR APPROVED EQUAL. INSTALL THE CIRCUIT BREAKER FOR THE SURGE PROTECTOR DEVICE AS CLOSE AS POSSIBLE TO THE PANELBOARD MAIN BREAKER OR MAIN LUGS. MAINTAIN LEADS AS SHORT & AS STRAIGHT AS POSSIBLE.
- 6. DO NOT SUBSTITUTE A LOAD CENTER FOR A PANELBOARD.
- 7. PROVIDE 2 #2 THWN, 1 #2 NEUTRAL, 1 #6 GROUND IN 1.25" EMT FROM PANELBOARD FEED THROUGH LUGS/SUB FEED LUGS TO FIRST RESPECTIVE FEEDER TAP JUNCTION BOX TO INTERFACE TO EXISTING DISTRIBUTION SYSTEM.
- 8. PROVIDE 3-NEMA RATED 30 AMP, 2 POLE LIGHTING CONTACTORS WITH 120 VAC COIL IN A NEMA 12 ENCLOSURE WITH HAND-OFF-AUTO SELECTOR SWITCH FOR EACH CONTACTOR AND PHOTOCELL CONTROL FOR HANGAR EXTERIOR LIGHTING
- 9. PROVIDE WORKSPACE CLEARANCE WARNING: "WARNING OSHA REGULATION AREA IN FRONT OF ELECTRICAL EQUIPMENT MUST E KEPT CLEAR FOR 36 IN. MINIMUM". INCREASE CLEARANCE DIMENSIONS AS APPLICABLE FOR THE RESPECTIVE VOLTAGE, APPLICATION, AND TO MEET NEC CLEARANCE REQUIREMENTS.
- PROVIDE LEGEND PLATE OR PLACARD FOR PANELBOARDS AND LOAD CENTERS LABELED "NOTICE AIRCRAFT SHALL MAINTAIN 5 FEET MINIMUM CLEARANCE FROM ELECTRICAL EQUIPMENT PANELS".

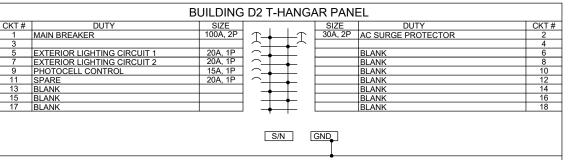

100AMP (MIN), 120/240VAC, 1 PHASE, 3 WIRE 18 CIRCUIT (MIN.) PANELBOARD WITH 100AMP, 2 POLE MAIN BREAKER AND FEED THROUGH LUGS OR MAIN LUG PANEL WITH 100 AMP, 2 POLE BACKFED MAIN BREAKER AND USE MAIN LUGS AS FEED THROUGH LUGS, IN A NEMA 1 ENCLOSURE UL-LISTED SUITABLE FOR SERVICE ENTRANCE. PANEL SHALL ACCOMMODATE FEEDER AND BRANCH BREAKERS UP TO 100AMP, 2 POLE FRAME & TRIP RATING.

NOTES

- 1. MAIN, BRANCH CIRCUIT & FEEDER BREAKERS SHALL HAVE 10,000 AIC (MIN.) AT 120/240 VAC.
- CIRCUIT BREAKERS AND WIRING SHALL BE SIZED FOR THE ACTUAL EQUIPMENT FURNISHED IN CONFORMANCE WITH THE RESPECTIVE MANUFACTURER'S RECOMMENDATION AND N.E.C. CONTRACTOR SHALL ADJUST CIRCUIT BREAKER SIZES & WIRING WHERE APPLICABLE TO CONFORM WITH THE MANUFACTURER'S RECOMMENDATIONS AND N.E.C. WHERE EXTERIOR LIGHTING REQUIRES 240 VAC POWER PROVIDE 2-POLE BREAKERS SIZED FOR THE APPLICATION.
- 3. FOR A BOTTOM FEED PANEL, MOVE AC SURGE PROTECTOR BREAKER DOWN TO POSITIONS 16 AND 18.
- LOCATE REPLACEMENT PANEL TO PROVIDE MINIMUM 3 FEET CLEAR WORKING SPACE IN FRONT OF PANEL NOT LESS THAN 30 INCHES IN WIDTH. MAINTAIN 5 FEET CLEAR OF AIRCRAFT FUEL TANKS AND ENGINES. PANEL TOP SHALL NOT EXCEED 6 FEET ABOVE FLOOR. PANEL BOTTOM SHALL NOT BE LESS THAN 24 INCHES ABOVE FLOOR. TO COMPLY WITH NEC 513.
- 5. INCLUDE WITH THE PANELBOARD A U.L. LISTED PER U.L. 1449, AC SURGE PROTECTOR SUITABLE FOR 120/240 VAC, 1 PH 3W PLUS GROUND SYSTEM, WITH SURGE CURRENT RATING OF 40KA (MIN.) 8X20 MICROSECOND WAVE, AND STATUS INDICATION LIGHTS, JOSLYN MODEL 1265-21, SQUARE D CAT. NO. TVS120XR50S OR APPROVED EQUAL. INSTALL THE CIRCUIT BREAKER FOR THE SURGE PROTECTOR DEVICE AS CLOSE AS POSSIBLE TO THE PANELBOARD MAIN BREAKER OR MAIN LUGS. MAINTAIN LEADS AS SHORT & AS STRAIGHT AS POSSIBLE.
- 6. DO NOT SUBSTITUTE A LOAD CENTER FOR A PANELBOARD.
- PROVIDE 2 #2 THWN, 1 #2 NEUTRAL, 1 #6 GROUND IN 1.25" EMT FROM PANELBOARD FEED THROUGH LUGS/SUB FEED LUGS TO FIRST RESPECTIVE FEEDER TAP JUNCTION BOX TO INTERFACE TO EXISTING DISTRIBUTION SYSTEM.
- 8. PROVIDE 3-NEMA RATED 30 AMP, 2 POLE LIGHTING CONTACTORS WITH 120 VAC COIL IN A NEMA 12 ENCLOSURE WITH HAND-OFF-AUTO SELECTOR SWITCH FOR EACH CONTACTOR AND PHOTOCELL CONTROL FOR HANGAR EXTERIOR LIGHTING
- PROVIDE WORKSPACE CLEARANCE WARNING: "WARNING OSHA REGULATION AREA IN FRONT OF ELECTRICAL EQUIPMENT MUST E KEPT CLEAR FOR 36 IN. MINIMUM". INCREASE CLEARANCE DIMENSIONS AS APPLICABLE FOR THE RESPECTIVE VOLTAGE, APPLICATION, AND TO MEET NEC CLEARANCE REQUIREMENTS.
- 10. PROVIDE LEGEND PLATE OR PLACARD FOR PANELBOARDS AND LOAD CENTERS LABELED "NOTICE AIRCRAFT SHALL MAINTAIN 5 FEET MINIMUM CLEARANCE FROM ELECTRICAL EQUIPMENT PANELS".



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COLES COUNTY AIRPORT
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COVERING ELECTRICAL DESIGN

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DATE SIGNED: 11/17/23 LICENSE 11/30/25

RECONSTRUCT WEST AIRCRAFT T-HANGAR AREA PAVEMENTS

IDA No: MTO-4816 SBG Project No: N/A

Contract No. CO072

NO. DATE DESCRIPTION
DES DWN REV

SSUE: 11/17/2023

PROJECT NO: 22A0001D
CAD FILE: E-607.DWG

DESIGN BY: KNL 09/16/2023
DRAWN BY: CWS 09/18/2023

REVIEWED BY: KNL 11/13/2023

SHEET TITLE

PANELBOARD SCHEDULES

- NEMA TYPE TERMINAL BLOCKS RATED 85A, 600

- 15 AMP & 20 AMP INPUT POWER/BRANCH CIRCUITS SHALL BE #10 AWG COPPER THWN FROM THE RESPECTIVE POWER SOURCE TO THE LIGHTING CONTACTOR PANEL. 30 AMP INPUT POWER/BRANCH CIRCUITS SHALL BE #8 AWG COPPER THWN (MIN.) FROM THE RESPECTIVE POWER SOURCE TO THE LIGHTING CONTACTOR
- 2. INPUT CONTROL CIRCUITS SHALL BE #12 AWG COPPER THWN.
- FOR 120 VAC BRANCH CIRCUITS THE NEUTRAL CONDUCTOR SHALL NOT BE SWITCHED THROUGH THE RELAY CONTACTS. USE TERMINAL BLOCKS TO TRANSITION FROM BRANCH CIRCUIT WIRING
- PROVIDE #10 AWG COPPER BONDING JUMPER FROM PANEL ENCLOSURE FRAME TO ENCLOSURE DOOR.
- PROVIDE 3-POSITION MAINTAINED CONTACT "HAND-OFF-AUTO" SELECTOR SWITCH FOR EACH LIGHTING CONTACTOR & MOUNT ON LIGHTING CONTACTOR PANEL ENCLOSURE DOOR. SELECTOR SWITCH SHALL BE SQUARE D CLASS 9001, TYPE KS43FBH13, ALLEN-BRADLEY CAT. NO. 800T-J2A, OR APPROVED EQUAL INCLUDE LEGEND PLATE TO IDENTIFY THE DEVICE CONTROLLED (EX: "LIGHTING CKT #1" OR "LIGHTING CKT #2").
- SEE "LIGHTING CONTACTOR SCHEMATIC" FOR ADDITIONAL INFORMATION ON WIRING.
- INCLUDE LEGEND PLATE ON CONTROL PANEL ENCLOSURE OUTER DOOR LABELED "NOTICE: CONTACTORS HAVE REMOTE LOCATED CONTROLS AND MAY ACTIVATE AT ANY TIME"
- 120/240 VAC PHASE "A" CONDUCTORS SHALL HAVE BLACK COLORED INSULATION. 120/240 VAC PHASE "B" CONDUCTORS SHALL HAVE RED COLORED INSULATION. NEUTRAL CONDUCTORS SHALL HAVE WHITE COLORED INSULATION. INSULATED EQUIPMENT GROUND WIRES SHALL HAVE GREEN COLORED
- CONTROL PANEL FOR LIGHTING SHALL BE MANUFACTURED BY A UL 508 INDUSTRIAL CONTROL PANEL BUILDER OR AN FAA APPROVED L-821 PANEL BUILDER OR A MAJOR ELECTRICAL EQUIPMENT MANUFACTURER; (EXAMPLE: SQUARE D COMPANY, ALLEN BRADLEY, EATON CUTLER-HAMMER, OR APPROVED EQUAL).

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COLES COUNTY AIRPORT AUTHORITY

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LIGHTFOOT 062-047643

DATE SIGNED: 11/17/23 LICENSE 11/30/25

RECONSTRUCT WEST AIRCRAFT T-HANGAR AREA PAVEMENTS

IDA No: MTO-4816 SBG Project No: N/A

Contract No. CO072

DESCRIPTION NO. DATE DES DWN REV ISSUE: 11/17/2023 PROJECT NO: 22A0001D

CAD FILE: E-613-APRON-LTG-CONTROL-PANAL.DWG DESIGN BY: KNI 09/30/2023 DRAWN BY: JP 10/24/2023


REVIEWED BY: KNL 11/13/2023

SHEET TITLE

CONTROL PANEL FOR APRON & TAXI-LANE LIGHTING

CONTROL PANEL FOR APRON/TAXI-LANE LIGHTING - TYP FOR 2

APPROVED EQUAL.

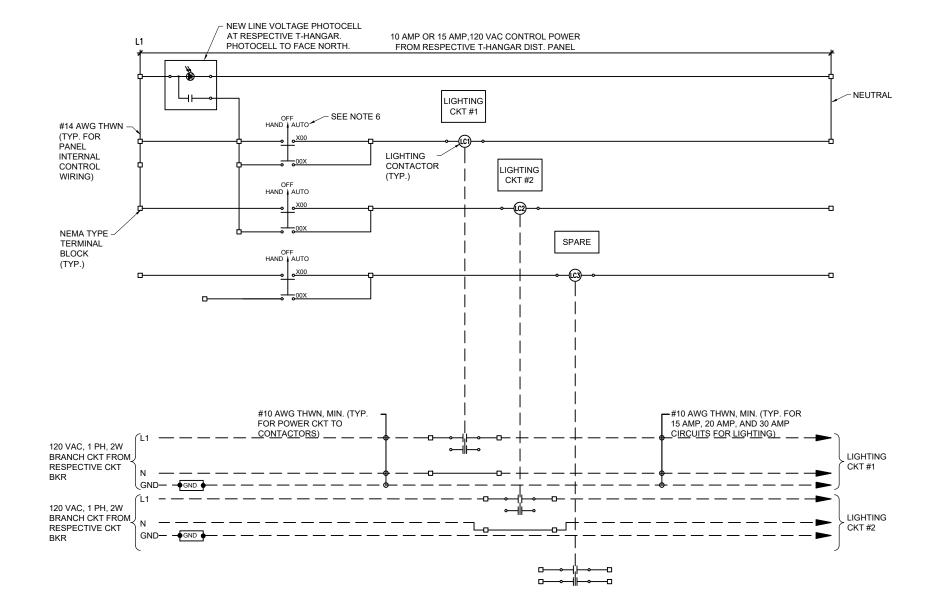

CONTROL PANEL FOR APRON/TAXI-LANE LIGHTING - TYP FOR 2

NOTES

- 15 AMP & 20 AMP INPUT POWER/BRANCH CIRCUITS SHALL BE #10 AWG COPPER THWN FROM THE RESPECTIVE POWER SOURCE TO THE LIGHTING CONTACTOR/RELAY PANEL. 25 AMP AND 30 AMP INPUT POWER/BRANCH CIRCUITS SHALL BE #8 AWG COPPER THWN (MIN.) FROM THE RESPECTIVE POWER SOURCE TO THE LIGHTING CONTACTOR/RELAY PANEL.
- 2. INPUT CONTROL CIRCUIT WIRING SHALL BE #12 AWG COPPER THWN.
- FOR 120 VAC BRANCH CIRCUITS THE NEUTRAL CONDUCTOR SHALL NOT BE SWITCHED THROUGH THE RELAY CONTACTS. USE TERMINAL BLOCKS TO TRANSITION FROM VAULT BRANCH CIRCUIT WIRING TO FIFLD WIRING
- 4. PROVIDE #10 AWG COPPER BONDING JUMPER FROM PANEL ENCLOSURE FRAME TO ENCLOSURE DOOR.
- 5. PROVIDE 3-POSITION MAINTAINED CONTACT "HAND-OFF-AUTO" SELECTOR SWITCH FOR EACH LIGHTING CONTACTOR & MOUNT ON LIGHTING CONTACTOR PANEL ENCLOSURE DOOR. SELECTOR SWITCH SHALL BE SQUARE D CLASS 9001, TYPE KS43FBH13, ALLEN-BRADLEY CAT. NO. 800T-J2A, OR APPROVED EQUAL. INCLUDE LEGEND PLATE TO IDENTIFY THE DEVICE CONTROLLED (EX: LIGHTING CKT #1 OR LIGHTING CKT #2).



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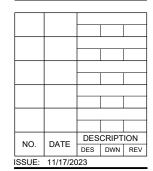


DATE SIGNED: 11/17/23 LICENSE 11/30/25

RECONSTRUCT WEST AIRCRAFT T-HANGAR AREA PAVEMENTS

IDA No: MTO-4816 SBG Project No: N/A

Contract No. CO072



PROJECT NO: 22A0001D

CAD FILE: E-614-APRON-LTG-CONTROL-PANEL DESIGN BY: KNL 09/30/2023 DRAWN BY: JP 10/24/2023

DRAWN BY: JP 10/24/2023 REVIEWED BY: KNL 11/13/2023

SHEET TITLE

CONTROL PANEL SCHEMATIC FOR APRON & TAXI-LANE LIGHTING

NO TRESPASSING

STATE LAW PROHIBITS UNAUTHORIZED
ENTRY, TAMPERING WITH AIRPORT
FACILITIES, OR TAMPERING
WITH AIRCRAFT.
VIOLATORS WILL BE FINED AND/OR
IMPRISONED

FENCING SIGN DETAIL

NOT TO SCALE

SIZED TO ACCOMMODATE TEXT, CONTRUCTED OF DURABLE MATERIALS, CONTRASTING COLORS, AND REFLECTIVE MATERIAL SIGN BLANK 0.080" ALUMINUM

> COLORS: LEGEND FOR "NO TRESPASSING" - RED TEXT BACKGROUND - WHITE (RETROREFLECTIVE)

LEGEND FOR REMAINING - BLACK TEXT BACKGROUND - WHITE (RETROREFLECTIVE)

TEXT:

MUTCD/FHWA (MANUAL ON UNIFORM TRAFFIC CONTROL DEVICES/FEDERAL HIGHWAY ADMINISTRATION) "SERIES C 2000" OR EQUIVALENT

▲ WARNING



Moving Gate Can Cause Serious Injury or Death.

KEEP CLEAR!

Gate May Move At Any Time.
Children Should Not Play Near Gate.
Children Should Not Operate The Gate.
Operate Gate Only When In Sight and
Free of People and Obstructions.
This Gate System for Vehicles Only.

NOTES

. WARNING SIGNS/PLACARDS AS DETAILED ABOVE OR SIMILAR, SHALL BE INSTALLED WHERE CLEARLY VISIBLE ON BOTH SIDES OF EACH ELECTRIC SLIDE GATE. WARNING SIGNS SHALL BE WEATHERPROOF, CORROSION RESISTANT METAL, AS DETAILED ABOVE (OR SIMILAR), AND IN A ACCORDANCE WITH THE RESPECTIVE GATE OPERATOR MANUFACTURER'S RECOMMENDATIONS. PROVIDE SIGNS FOR EACH ELECTRIC SLIDE GATE (EXISTING AND NEW), ON EACH SIDE OF EACH GATE.

WARNING SIGN DETAIL

SIGN NOTES

2.5"

1.5"

.75"

1.5"

.75"

1.5"

.75"

1.5"

.75"

1.5"

.75"

1.5"

- INSTALL SIGNS AT EACH ACCESS GATE AND ALONG FENCE AT SPACING NOT TO EXCEED 100 FEET. SIGNS ALONG FENCE LINE SHALL BE LOCATED SUCH THAT WHEN STANDING AT ONE SIGN, THE OBSERVER IS ABLE TO SEE THE NEXT SIGN IN BOTH DIRECTIONS.
- TOP OF SIGN SHALL BE INSTALLED APPROXIMATELY ONE FOOT BELOW THE TOP RAIL OF THE FENCE. CONFIRM MOUNTING HEIGHT WITH OWNER REPRESENTATIVE.
- 3. MOUNT SIGNS TO THE FENCE WITH COMPATIBLE MOUNTING HARDWARE, SUCH AS BRACKETS, BOLTS WASHERS, AND NUTS. THERE IS NO SEPARATE PAY ITEM FOR FURNISHING AND INSTALLING THE SIGNS TO THE FENCE. MOUNTING IS INCLUDED IN THE PAY ITEMS FOR FENCE AND GATES.

WAIT FOR

GATE TO CLOSE

BEHIND YOU

BEFORE PROCEEDING

1.5"

1.5"

ELECTRIC SLIDE GATE SIGN DETAIL

NOT TO SCALE

24" X 14"(MINIMUM) SIGN BLANK 0.080" ALUMINUM

COLORS: LEGEND - RED BACKGROUND - WHITE (RETROREFLECTIVE)

TEXT: MUTCD/FHWA "SERIES C 2000"

INSTALL SIGNS ON EACH SIDE OF ELECTRIC SLIDE GATE



R=1.5"

"DANGER - HIGH VOLTAGE UNAUTHORIZED PERSONNEL KEEP OUT" SIGN

PROVIDE WEATHERPROOF WARNING SIGN FOR EACH DOOR TO AIRPORT ELECTRICAL VAULT (5 SIGNS FOR 5 DOORS) LABELED "DANGER - HIGH VOLTAGE UNAUTHORIZED PERSONNEL KEEP OUT" PER THE REQUIREMENTS OF NEC 110.34 (C). SIGN SHALL BE APPROXIMATELY 10"H X 14"W.

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COLES COUNTY AIRPORT
AUTHORITY
COLES COUNTY MEMORIAL AIRPORT

COVERING ELECTRICAL DESIGN

OF ESSION

KEVIN N.

LIGHTFOOT

062-047643

DATE SIGNED: 11/17/23 LICENSE 11/30/25 EXPIRES: 11/30/25

RECONSTRUCT WEST AIRCRAFT T-HANGAR AREA PAVEMENTS

IDA No: MTO-4816 SBG Project No: N/A

Contract No. CO072

ISSUE: 11/17/2023
PROJECT NO: 22A0001D
CAD FILE: E-608.DWG

DESIGN BY: KNL 09/16/2023

DRAWN BY: CWS 09/18/2023

REVIEWED BY: KNL 11/13/2023

SHEET TITLE

SIGNAGE DETAILS

POWER SOURCE	LEGEND PLATES
DEVICE	LABEL
AIRPORT ELECTRICAL VAULT MAIN SERVICE DISCONNECT	AIRPORT ELECTRICAL VAULT MAIN SERVICE DISCONNECT 120/240 VAC, 1 PHASE, 3-WIRE NOTE THIS SERVICE HAS A STANDBY ENGINE GENERATOR BACKUP POWER SOURCE LOCATED IN THE ENGINE ROOM OF THE VAULT BUILDING
AIRPORT ELECTRICAL VAULT AUTO TRANSFER SWITCH	AIRPORT ELECTRICAL VAULT AUTO TRANSFER SWITCH 120/240 VAC, 1 PHASE, 3-WIRE NORMAL POWER SOURCE FROM AIRPORT ELECTRICAL VAULT MAIN SERVICE DISCONNECT BACKUP POWER SOURCE FROM AIRPORT ELECTRICAL VAULT STANDBY ENGINE GENERATOR
AIRPORT ELECTRICAL VAULT MAIN DISTRIBUTION PANEL "A"	AIRPORT ELECTRICAL VAULT MAIN DISTRIBUTION PANEL "A" 120/240 VAC, 1 PHASE, 3-WIRE FED FROM AUTO TRANSFER SWITCH NOTE THIS PANEL HAS A STANDBY ENGINE GENERATOR BACKUP POWER SOURCE LOCATED IN THE ENGINE ROOM OF THE VAULT BUILDING
AIRPORT ELECTRICAL VAULT MAIN DISTRIBUTION PANEL "B"	AIRPORT ELECTRICAL VAULT DISTRIBUTION PANEL "B" 120/240 VAC, 1 PHASE, 3-WIRE FED FROM AIRPORT ELECTRICAL VAULT MAIN DISTRIBUTION PANEL "A"
SAFETY SWITCH FOR UNIT HEATER LOCATED IN ENGINE GENERATOR ROOM OF AIRPORT ELECTRICAL VAULT	ENGINE ROOM HEATER 240 VAC, 1 PHASE, 2-WIRE FED FROM AIRPORT ELECTRICAL VAULT DISTRIBUTION PANEL "B"
WEST ACCESS GATE 1 OPERATOR DISCONNECT	WEST ACCESS GATE 1 OPERATOR DISCONNECT FED FROM AIRPORT ELECTRICAL VAULT DISTRIBUTION PANEL "B"
SERVICE FUSE BOX FOR BUILDINGS B, D1, D2, and E LOCATED AT EXTERIOR OF AIRPORT ELECTRICAL VAULT	SERVICE FUSE BOX FOR BUILDINGS B, D1, D2, AND E. 120/240 VAC, 1 PHASE, 3-WIRE NOTE THIS SERVICE HAS A STANDBY ENGINE GENERATOR BACKUP POWER SOURCE LOCATED IN THE ENGINE ROOM OF THE VAULT BUILDING
RONK SERVICE TRANSFER SWITCH FOR BUILDINGS B, D1, D2, AND E LOCATED AT EXTERIOR OF AIRPORT ELECTRICAL VAULT	RONK SERVICE TRANSFER SWITCH FOR BUILDINGS B, D1, D2, AND E. 120/240 VAC, 1 PHASE, 3-WIRE NORMAL POWER SOURCE FROM SERVICE FUSE BOX FOR BUILDINGS B, D1, D2 AND E. BACKUP POWER SOURCE FROM AIRPORT ELECTRICAL VAULT MAIN DISTRIBUTION PANEL "A"
SERVICE FUSE BOX FOR BUILDING "C" LOCATED AT EXTERIOR OF AIRPORT ELECTRICAL VAULT	SERVICE FUSE BOX FOR BUILDING "C". 120/240 VAC, 1 PHASE, 3-WIRE NOTE THIS SERVICE HAS A STANDBY ENGINE GENERATOR BACKUP POWER SOURCE LOCATED IN THE ENGINE ROOM OF THE VAULT BUILDING
RONK SERVICE TRANSFER SWITCH FOR BUILDING "C" LOCATED AT EXTERIOR OF AIRPORT ELECTRICAL VAULT	RONK SERVICE TRANSFER SWITCH FOR BUILDING "C" 120/240 VAC, 1 PHASE, 3-WIRE NORMAL POWER SOURCE FROM SERVICE FUSE BOX FOR BUILDING "C". BACKUP POWER SOURCE FROM AIRPORT ELECTRICAL VAULT MAIN DISTRIBUTION PANEL "A"

DEVIOL	LABEL
DEVICE SAFETY SWITCH FOR BUILDING "E" LOCATED AT EXTERIOR OF AIRPORT ELECTRICAL VAULT	LABEL HANGAR BUILDING "E" SAFETY SWITCH DISCONNECT 120/240 VAC, 1 PHASE, 3-WIRE FED FROM RONK SERVICE TRANSFER SWITCH FOR BUILDINGS B, D1, D2, AND E.
MAIN DISCONNECT FOR FBO HANGAR BUILDING "B"	FBO HANGAR BUILDING "B" MAIN DISCONNECT SWITCH 120/240 VAC, 1 PHASE, 3-WIRE FED FROM RONK SERVICE TRANSFER SWITCH FOR BUILDINGS B, D1, D2, AND E LOCATED AT EXTERIOR OF AIRPORT ELECTRICAL VAULT
MAIN DISTRIBUTION PANEL FOR FBO HANGAR BUILDING "B"	FBO HANGAR BUILDING "B" MAIN DISTRIBUTION PANEL 120/240 VAC, 1 PHASE, 3-WIRE FED FROM FBO HANGAR BUILDING "B" MAIN DISCONNECT SWITCH"
PANEL "A" FOR FBO HANGAR BUILDING "B"	FBO HANGAR BUILDING "B" PANEL "A" 120/240 VAC, 1 PHASE, 3-WIRE FED FROM FBO HANGAR BUILDING "B" MAIN DISTRIBUTION PANEL
SNACK BAR DISTRIBUTION PANEL FOR FBO HANGAR BUILDING "B"	FBO HANGAR BUILDING "B" SNACK BAR DISTRIBUTION PANEL 120/240 VAC, 1 PHASE, 3-WIRE FED FROM FBO HANGAR BUILDING "B" MAIN DISTRIBUTION PANEL
OVERHAUL ROOM PANEL FOR FBO HANGAR BUILDING "B"	FBO HANGAR BUILDING "B" OVERHAUL ROOM PANEL 120/240 VAC, 1 PHASE, 3-WIRE FED FROM FBO HANGAR BUILDING "B" MAIN DISTRIBUTION PANEL
FUEL FACILITY PANELBOARD FED FROM FBO MAIN DISTRIBUTION PANEL	FUEL FACILITY PANELBOARD 120/240 VAC, 1 PHASE, 3-WIRE FED FROM FBO HANGAR BUILDING "B" MAIN DISTRIBUTION PANEL THROUGH EMERGENCY SHUTOFF CONTACTOR
LOAD CENTER FOR HANGAR "D1" AND HANGAR "D2" FEEDERS LOCATED AT EXTERIOR OF FBO HANGAR BUILDING "B"	HANGAR "D1" AND HANGAR "D2" FEEDER CIRCUITS PANEL 120/240 VAC, 1 PHASE, 3-WIRE FED FROM DISCONNECT FOR BUILDINGS D1 and D2 LOCATED AT EXTERIOR OF AIRPORT ELECTRICAL VAULT
BUILDING "C" MAIN DISCONNECTING MEANS	BUILDING "C" MAIN DISCONNECT PANEL 120/240 VAC, 1 PHASE, 3-WIRE FED FROM RONK SERVICE TRANSFER SWITCH FOR BUILDING "C" LOCATED AT EXTERIOR OF AIRPORT ELECTRICAL VAULT
BUILDING "D1" T-HANGAR PANELBOARD	BUILDING "D1" T-HANGAR PANEL 120/240 VAC, 1 PHASE, 3-WIRE FED FROM LOAD CENTER FOR HANGAR "D1" AND HANGAR "D2" LOCATED AT EXTERIOR OF FBO HANGAR BUILDING "B"

POWER SOURCE	LEGEND PLATES
DEVICE	LABEL
BUILDING "D2" T-HANGAR PANELBOARD	BUILDING "D2" T-HANGAR PANEL 120/240 VAC, 1 PHASE, 3-WIRE FED FROM LOAD CENTER FOR HANGAR "D1" AND HANGAR "D2" LOCATED AT EXTERIOR OF FBO HANGAR BUILDING "B"
BUILDING "E" HANGAR MAIN DISCONNECTING MEANS	HANGAR BUILDING "E" MAIN DISCONNECT SWITCH 120/240 VAC, 1 PHASE, 3-WIRE FED FROM DISCONNECT FOR BUILDING "E" LOCATED AT EXTERIOR OF AIRPORT ELECTRICAL VAULT
BUILDING "E" HANGAR LOAD CENTER	BUILDING "E" HANGAR PANEL 120/240 VAC, 1 PHASE, 3-WIRE FED FROM MAIN DISCONNECT FOR HANGAR BUILDING "E"
BUILDING "F" HANGAR MAIN DISTRIBUTION PANEL	BUILDING "F" HANGAR MAIN DISTRIBUTION PANEL 120/240 VAC, 1 PHASE, 3-WIRE FED FROM AIRPORT ELECTRICAL VAULT MAIN DISTRIBUTION PANEL "A"
BUILDING "G" HANGAR MAIN PANEL	BUILDING "G" HANGAR MAIN DIST. PANEL 120/240 VAC, 1 PHASE, 3-WIRE FED FROM AIRPORT ELECTRICAL VAULT MAIN DISTRIBUTION PANEL "A"
BUILDING "F" HANGAR MAIN DISTRIBUTION PANEL	BUILDING "F" HANGAR MAIN DISTRIBUTION PANEL 120/240 VAC, 1 PHASE, 3-WIRE FED FROM AIRPORT ELECTRICAL VAULT MAIN DISTRIBUTION PANEL "A"
SNOW REMOVAL EQUIPMENT BUILDING MAIN DISCONNECTING MEANS	SNOW REMOVAL EQUIPMENT BUILDING MAIN DISCONNECT SWITCH 120/240 VAC, 1 PHASE, 3-WIRE FED FROM ADJACENT PAD MOUNT TRANSFORMER
SNOW REMOVAL EQUIPMENT BUILDING MAIN DISTRIBUTION PANEL "A"	SNOW REMOVAL EQUIPMENT BUILDING MAIN DISTRIBUTION PANEL "A" 120/240 VAC, 1 PHASE, 3-WIRE FED FROM SRE BUILDING MAIN DISCONNECT SWITCH
SNOW REMOVAL EQUIPMENT BUILDING DISTRIBUTION PANEL "B"	SNOW REMOVAL EQUIPMENT BUILDING DISTRIBUTION PANEL "B" 120/240 VAC, 1 PHASE, 3-WIRE FED FROM SRE BUILDING MAIN DISTRIBUTION PANEL "A"
NORTH ACCESS GATE 2 OPERATOR DISCONNECT	NORTH ACCESS GATE 2 OPERATOR DISCONNECT FED FROM SRE BUILDING MAIN DISTRIBUTION PANEL "A"

- 1. LEGEND PLATES SHALL BE WEATHERPROOF ENGRAVED PLASTIC OR PHENOLIC MATERIAL, 1/4" HIGH BLACK LETTERS ON A WHITE BACKGROUND UNLESS NOTED OTHERWISE. SECURE WITH WEATHERPROOF ADHESIVE AND MACHINE SCREWS. FURNISH ADDITIONAL LEGEND PLATES WHERE REQUIRED BY CODE, FOR ADDITIONAL EQUIPMENT, AS DETAILED HEREIN ON THE PLANS, AND AS NOTED IN THE SPECIAL PROVISION SPECIFICATIONS.
- PER NEC 110.24 "AVAILABLE FAULT CURRENT" PART (A)
 "FIELD MARKING", SERVICE EQUIPMENT SHALL BE
 LEGIBLY MARKED IN THE FIELD WITH THE AVAILABLE
 FAULT CURRENT.
- 3. PER NEC 408.6 "SHORT-CIRCUIT CURRENT RATING"
 THE AVAILABLE FAULT CURRENT AND THE DATE THE
 CALCULATION WAS PERFORMED SHALL BE FIELD
 MARKED ON THE ENCLOSURE AT THE POINT OF
 SUPPLY.



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Illinois Licensed Professional Service Corporation #184-001084

COLES COUNTY AIRPORT
AUTHORITY
COLES COUNTY MEMORIAL AIRPORT

COVERING ELECTRICAL DESIGN

WEEVIN N.

LIGHTFOOT

062-047643

DATE SIGNED: 11/17/23 LICENSE EXPIRES: 11/30/25

RECONSTRUCT WEST AIRCRAFT T-HANGAR AREA PAVEMENTS

IDA No: MTO-4816 SBG Project No: N/A

Contract No. CO072

NO. DATE DESCRIPTION
DES DWN REV
ISSUE: 11/17/2023
PROJECT NO: 22A0001D
CAD FILE: E-611.DWG

DESIGN BY: KNL 09/27/2023 DRAWN BY: CWS 09/27/2023 REVIEWED BY: KNL 11/13/2023

SHEET TITLE

POWER SOURCE LEGEND PLATES

FAULT CURRENT CALCU	JLATION LEGEND PLATES
DEVICE	LABEL
AIRPORT ELECTRICAL VAULT MAIN SERVICE DISCONNECT	MAX AVAILABLE FAULT CURRENT AT UTILITY TRANSFORMER SECONDARY WAS CALCULATED TO BE: 19,842 AMPS LINE TO LINE 29,763 AMPS LINE TO NEUTRAL ON 9/23/2023 MAX AVAILABLE FAULT CURRENT AT AIRPORT ELECTRICAL VAULT MAIN SERVICE DISCONNECT WAS CALCULATED TO BE: 17,847 AMPS LINE TO LINE 22,288 AMPS LINE TO NEUTRAL ON 9/23/2023
AIRPORT ELECTRICAL VAULT MAIN DISTRIBUTION PANEL "A"	MAX AVAILABLE FAULT CURRENT AT UTILITY TRANSFORMER SECONDARY WAS CALCULATED TO BE: 19,842 AMPS LINE TO LINE 29,763 AMPS LINE TO NEUTRAL ON 9/23/2023 MAX AVAILABLE FAULT CURRENT AT AIRPORT ELECTRICAL VAULT MAIN DISTRIBUTION PANEL "A" WAS CALCULATED TO BE: 16,726 AMPS LINE TO LINE 19,092 AMPS LINE TO NEUTRAL ON 9/23/2023
AIRPORT ELECTRICAL VAULT MAIN DISTRIBUTION PANEL "B"	MAX AVAILABLE FAULT CURRENT AT AIRPORT ELECTRICAL VAULT DISTRIBUTION PANEL "B" WAS CALCULATED TO BE: 14,117 AMPS LINE TO LINE 13,427 AMPS LINE TO NEUTRAL ON 9/23/2023
SERVICE FUSE BOX FOR BUILDINGS B, D1, D2, and E LOCATED AT EXTERIOR OF AIRPORT ELECTRICAL VAULT	MAX AVAILABLE FAULT CURRENT AT UTILITY TRANSFORMER SECONDARY WAS CALCULATED TO BE: 19,842 AMPS LINE TO LINE 29,763 AMPS LINE TO NEUTRAL ON 9/23/2023 MAX AVAILABLE FAULT CURRENT SERVICE FUSE BOX FOR BUILDINGS B, D1, D2, and E WAS CALCULATED TO BE: 16,734 AMPS LINE TO LINE 19,113 AMPS LINE TO NEUTRAL ON 9/23/2023
SERVICE FUSE BOX FOR BUILDING "C" LOCATED AT EXTERIOR OF AIRPORT ELECTRICAL VAULT	MAX AVAILABLE FAULT CURRENT AT UTILITY TRANSFORMER SECONDARY WAS CALCULATED TO BE: 19,842 AMPS LINE TO LINE 29,763 AMPS LINE TO NEUTRAL ON 9/23/2023 MAX AVAILABLE FAULT CURRENT SERVICE FUSE BOX FOR BUILDING "C" WAS CALCULATED TO BE: 16,734 AMPS LINE TO LINE 19,113 AMPS LINE TO NEUTRAL ON 9/23/2023
MAIN DISCONNECT FOR FBO HANGAR BUILDING "B"	MAX AVAILABLE FAULT CURRENT AT FBO HANGAR BUILDING "B" MAIN DISCONNECT SWITCH WAS CALCULATED TO BE: 9,556 AMPS LINE TO LINE 7,038 AMPS LINE TO NEUTRAL ON 9/23/2023

DEVICE	LABEL
MAIN DISTRIBUTION PANEL FOR FBO HANGAR BUILDING "B"	MAX AVAILABLE FAULT CURRENT AT FBO HANGAR BUILDING "B" MAIN DISTRIBUTION PANEL WAS CALCULATED TO BE: 9,556 AMPS LINE TO LINE 7,038 AMPS LINE TO NEUTRAL ON 9/23/2023
LOAD CENTER FOR HANGAR "D1" AND HANGAR "D2" FEEDERS LOCATED AT EXTERIOR OF FBO HANGAR BUILDING "B"	MAX AVAILABLE FAULT CURRENT AT BUILDING "C" MAIN DISCONNECT PANEL WAS CALCULATED TO BE: 10,288 AMPS LINE TO LINE 7,862 AMPS LINE TO NEUTRAL ON 9/23/2023
BUILDING "D1" T-HANGAR PANELBOARD	MAX AVAILABLE FAULT CURRENT AT BUILDING "D1" T-HANGAR PANEL WAS CALCULATED TO BE: 1,471 AMPS LINE TO LINE 774 AMPS LINE TO NEUTRAL ON 9/23/2023
BUILDING "D2" T-HANGAR PANELBOARD	MAX AVAILABLE FAULT CURRENT AT BUILDING "D2" T-HANGAR PANEL WAS CALCULATED TO BE: 1,844 AMPS LINE TO LINE 983 AMPS LINE TO NEUTRAL ON 9/23/2023
BUILDING "E" HANGAR MAIN DISCONNECTING MEANS	MAX AVAILABLE FAULT CURRENT AT HANGAR BUILDING "E" MAIN DISCONNECT SWITCH WAS CALCULATED TO BE: 526 AMPS LINE TO LINE 268 AMPS LINE TO NEUTRAL ON 9/23/2023
BUILDING "F" HANGAR MAIN DISTRIBUTION PANEL	MAX AVAILABLE FAULT CURRENT AT BUILDING "F" HANGAR MAIN DISTRIBUTION PANEL WAS CALCULATED TO BE: 1,150 AMPS LINE TO LINE 599 AMPS LINE TO NEUTRAL ON 9/23/2023
BUILDING "G" HANGAR MAIN PANEL	MAX AVAILABLE FAULT CURRENT AT BUILDING "G" HANGAR MAIN DIST. PANEL WAS CALCULATED TO BE: 1,243 AMPS LINE TO LINE 649 AMPS LINE TO NEUTRAL ON 9/23/2023
SNOW REMOVAL EQUIPMENT BUILDING MAIN DISCONNECTING MEANS	MAX AVAILABLE FAULT CURRENT AT TRANSFORMER SECONDARY FEEDI SNOW REMOVAL EQUIPMENT BUILDII MAIN DISCONNECT SWITCH WAS CALCULATED TO BE: 5,754 AMPS LINE TO LINE 8,631 AMPS LINE TO NEUTRAL ON 9/23/2023
SNOW REMOVAL EQUIPMENT BUILDING MAIN DISTRIBUTION PANEL "A"	MAX AVAILABLE FAULT CURRENT AT TRANSFORMER SECONDARY FEEDI SNOW REMOVAL EQUIPMENT BUILDII MAIN DISCONNECT SWITCH WAS CALCULATED TO BE: 5,754 AMPS LINE TO LINE 8,631 AMPS LINE TO NEUTRAL ON 9/23/2023

- LEGEND PLATES SHALL BE WEATHERPROOF ENGRAVED PLASTIC OR PHENOLIC MATERIAL, 1/4" HIGH BLACK LETTERS ON A WHITE BACKGROUND UNLESS NOTED OTHERWISE. SECURE WITH WEATHERPROOF ADHESIVE AND MACHINE SCREWS. FURNISH ADDITIONAL LEGEND PLATES WHERE REQUIRED BY CODE, FOR ADDITIONAL EQUIPMENT, AS DETAILED HEREIN ON THE PLANS, AND AS NOTED IN THE SPECIAL PROVISION SPECIFICATIONS.
- 2. PER NEC 110.22 "IDENTIFICATION OF DISCONNECT MEANS", EACH DISCONNECTING MEANS SHALL BE LEGIBILY MARKED TO INDICATE ITS PURPOSE AND IDENTIFY THE POWER SOURCE THAT SUPPLIES THE DISCONNECTING MEANS.
- 3. PER NEC 408.4 "FIELD MARKING REQUIRED" PART (B) "SOURCE OF SUPPLY", ALL SWITCHBOARDS, SWITCHGEAR, AND PANELBOARDS SUPPLIED BY A FEEDER(S) SHALL BE PERMANENTLY MARKED TO INDICATED EACH DEVICE OR EQUIPMENT WHERE THE POWER ORIGINATES.
- 4. PER NEC 702.2 "SIGNS" PART (A) "STANDBY", A SIGN SHALL BE PLACED AT THE SERVICE-ENTRANCE EQUIPMENT THAT INDICATES THE TYPE AND LOCATION OF EACH ON-SITE OPTIONAL STANDBY POWER
- VERIFY ALL POWER SOURCES AND REPORT ANY VARIATIONS OR CONFLICTS WITH SCHEDULE TO THE ENGINEER OF RECORD AND THE AIRPORT MANAGER.



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Illinois Licensed Professional Service Corporation #184-001084

COLES COUNTY AIRPORT AUTHORITY

COVERING ELECTRICAL DESIGN



DATE SIGNED: 11/17/23 LICENSE 11/30/25

RECONSTRUCT WEST AIRCRAFT T-HANGAR AREA PAVEMENTS

IDA No: MTO-4816 SBG Project No: N/A

Contract No. CO072

NO. DATE DESCRIF

DES DWN REV ISSUE: 11/17/2023 PROJECT NO: 22A0001D

DESIGN BY: KNL 09/27/2023 DRAWN BY: CWS 09/27//2023

CAD FILE: E-612.DWG

REVIEWED BY: KNL 11/13/2023

SHEET TITLE

FAULT CURRENT CALCULATION LEGEND PLATES

ARC FLASH	I RISK LABEL
EQUIPMENT	LABEL
AIRPORT ELECTRICAL VAULT MAIN SERVICE DISCONNECT	WARNING ARC FLASH HAZARD APPROPRIATE PERSONAL PROTECTIVE EQUIPMENT IS REQUIRED. NOMINAL VOLTAGE: 120/240 VAC, 1-PHASE, 3-WIRE ARC FLASH BOUNDARY: 19 INCHES ARC FLASH PPE CATEGORY: 1
AIRPORT ELECTRICAL VAULT MAIN DISTRIBUTION PANEL "A"	WARNING ARC FLASH HAZARD APPROPRIATE PERSONAL PROTECTIVE EQUIPMENT IS REQUIRED. NOMINAL VOLTAGE: 120/240 VAC, 1-PHASE, 3-WIRE ARC FLASH BOUNDARY: 19 INCHES ARC FLASH PPE CATEGORY: 1
AIRPORT ELECTRICAL VAULT DISTRIBUTION PANEL "B"	WARNING ARC FLASH HAZARD APPROPRIATE PERSONAL PROTECTIVE EQUIPMENT IS REQUIRED. NOMINAL VOLTAGE: 120/240 VAC, 1-PHASE, 3-WIRE ARC FLASH BOUNDARY: 19 INCHES ARC FLASH PPE CATEGORY: 1
EACH CIRCUIT BREAKER ON THE AIRPORT ELECTRICAL VAULT BUSWAY (10 LABELS)	WARNING ARC FLASH HAZARD APPROPRIATE PERSONAL PROTECTIVE EQUIPMENT IS REQUIRED. NOMINAL VOLTAGE: 120/240 VAC, 1-PHASE, 3-WIRE ARC FLASH BOUNDARY: 19 INCHES ARC FLASH PPE CATEGORY: 1
RELAY INTERFACE PANEL FOR RUNWAY AND NAVAIDS LOCATED IN THE AIRPORT ELECTRICAL VAULT	WARNING ARC FLASH HAZARD APPROPRIATE PERSONAL PROTECTIVE EQUIPMENT IS REQUIRED. NOMINAL VOLTAGE: 120 VAC, 1-PHASE, 2-WIRE ARC FLASH BOUNDARY: 19 INCHES ARC FLASH PPE CATEGORY: 1
RELAY INTERFACE PANEL FOR TAXIWAY LIGHTING LOCATED IN THE AIRPORT ELECTRICAL VAULT	WARNING ARC FLASH HAZARD APPROPRIATE PERSONAL PROTECTIVE EQUIPMENT IS REQUIRED. NOMINAL VOLTAGE: 120 VAC, 1-PHASE, 2-WIRE ARC FLASH BOUNDARY: 19 INCHES ARC FLASH PPE CATEGORY: 1
LIGHTING CONTACTOR CONTROL PANEL LOCATED IN THE AIRPORT ELECTRICAL VAULT	WARNING ARC FLASH HAZARD APPROPRIATE PERSONAL PROTECTIVE EQUIPMENT IS REQUIRED. NOMINAL VOLTAGE: 120/240 VAC, 1-PHASE, 3-WIRE ARC FLASH BOUNDARY: 19 INCHES ARC FLASH PPE CATEGORY: 1
LIGHTING CONTACTOR CONTROL PANEL FOR RUNWAY 11 PAPI AND REILS LOCATED IN THE AIRPORT ELECTRICAL VAULT	WARNING ARC FLASH HAZARD APPROPRIATE PERSONAL PROTECTIVE EQUIPMENT IS REQUIRED. NOMINAL VOLTAGE: 120/240 VAC, 1-PHASE, 3-WIRE ARC FLASH BOUNDARY: 19 INCHES ARC FLASH PPE CATEGORY: 1
DOUBLE THROW SAFETY SWITCH FOR RUNWAY 11-29 CCR'S LOCATED IN THE AIRPORT ELECTRICAL VAULT	WARNING ARC FLASH HAZARD APPROPRIATE PERSONAL PROTECTIVE EQUIPMENT IS REQUIRED. NOMINAL VOLTAGE: 240 VAC, 1-PHASE, 2-WIRE ARC FLASH BOUNDARY: 19 INCHES ARC FLASH PPE CATEGORY: 1
EXHAUST FAN CONTROL PANEL LOCATED IN THE AIRPORT ELECTRICAL VAULT	WARNING ARC FLASH HAZARD APPROPRIATE PERSONAL PROTECTIVE EQUIPMENT IS REQUIRED. NOMINAL VOLTAGE: 120 VAC, 1-PHASE, 2-WIRE ARC FLASH BOUNDARY: 19 INCHES ARC FLASH PPE CATEGORY: 1
AIRPORT ELECTRICAL VAULT L-854 RADIO CONTROLLER	WARNING ARC FLASH HAZARD APPROPRIATE PERSONAL PROTECTIVE EQUIPMENT IS REQUIRED. NOMINAL VOLTAGE: 120 VAC, 1-PHASE, 2-WIRE ARC FLASH BOUNDARY: 19 INCHES ARC FLASH PPE CATEGORY: 1

ARC FLASH RISK LABEL		
EQUIPMENT SAFETY SWITCH FOR UNIT HEATER LOCATED IN ENGINE GENERATOR ROOM OF AIRPORT ELECTRICAL VAULT	LABEL WARNING ARC FLASH HAZARD APPROPRIATE PERSONAL PROTECTIVE EQUIPMENT IS REQUIRED. NOMINAL VOLTAGE: 240 VAC, 1-PHASE, 2-WIRE ARC FLASH BOUNDARY: 19 INCHES ARC FLASH PPE CATEGORY: 1	
WEST ACCESS GATE 1 OPERATOR DISCONNECT	WARNING ARC FLASH HAZARD APPROPRIATE PERSONAL PROTECTIVE EQUIPMENT IS REQUIRED. NOMINAL VOLTAGE: 120/240 VAC, 1-PHASE, 3-WIRE ARC FLASH BOUNDARY: 19 INCHES ARC FLASH PPE CATEGORY: 1	
NORTH ACCESS GATE 2 OPERATOR DISCONNECT	WARNING ARC FLASH HAZARD APPROPRIATE PERSONAL PROTECTIVE EQUIPMENT IS REQUIRED. NOMINAL VOLTAGE: 120/240 VAC, 1-PHASE, 3-WIRE ARC FLASH BOUNDARY: 19 INCHES ARC FLASH PPE CATEGORY: 1	
SERVICE FUSE BOX FOR BUILDINGS "B" AND "E" LOCATED AT EXTERIOR OF AIRPORT ELECTRICAL VAULT	WARNING ARC FLASH HAZARD APPROPRIATE PERSONAL PROTECTIVE EQUIPMENT IS REQUIRED. NOMINAL VOLTAGE: 120/240 VAC, 1-PHASE, 3-WIRE ARC FLASH BOUNDARY: 19 INCHES ARC FLASH PPE CATEGORY: 1	
RONK SERVICE TRANSFER SWITCH FOR BUILDINGS "B" AND "E" LOCATED AT EXTERIOR OF AIRPORT ELECTRICAL VAULT	WARNING ARC FLASH HAZARD APPROPRIATE PERSONAL PROTECTIVE EQUIPMENT IS REQUIRED. NOMINAL VOLTAGE: 120/240 VAC, 1-PHASE, 3-WIRE ARC FLASH BOUNDARY: 19 INCHES ARC FLASH PPE CATEGORY: 1	
RELAY INTERFACE PANEL FOR TAXIWAY LIGHTING LOCATED IN THE AIRPORT ELECTRICAL VAULT	WARNING ARC FLASH HAZARD APPROPRIATE PERSONAL PROTECTIVE EQUIPMENT IS REQUIRED. NOMINAL VOLTAGE: 120 VAC, 1-PHASE, 2-WIRE ARC FLASH BOUNDARY: 19 INCHES ARC FLASH PPE CATEGORY: 1	
SERVICE FUSE BOX FOR BUILDING "C" LOCATED AT EXTERIOR OF AIRPORT ELECTRICAL VAULT	WARNING ARC FLASH HAZARD APPROPRIATE PERSONAL PROTECTIVE EQUIPMENT IS REQUIRED. NOMINAL VOLTAGE: 120/240 VAC, 1-PHASE, 3-WIRE ARC FLASH BOUNDARY: 19 INCHES ARC FLASH PPE CATEGORY: 1	
RONK SERVICE TRANSFER SWITCH FOR BUILDING "C" LOCATED AT EXTERIOR OF AIRPORT ELECTRICAL VAULT	WARNING ARC FLASH HAZARD APPROPRIATE PERSONAL PROTECTIVE EQUIPMENT IS REQUIRED. NOMINAL VOLTAGE: 120/240 VAC, 1-PHASE, 3-WIRE ARC FLASH BOUNDARY: 19 INCHES ARC FLASH PPE CATEGORY: 1	
SAFETY SWITCH FOR BUILDING "E" LOCATED AT EXTERIOR OF AIRPORT ELECTRICAL VAULT	WARNING ARC FLASH HAZARD APPROPRIATE PERSONAL PROTECTIVE EQUIPMENT IS REQUIRED. NOMINAL VOLTAGE: 120/240 VAC, 1-PHASE, 3-WIRE ARC FLASH BOUNDARY: 19 INCHES ARC FLASH PPE CATEGORY: 1	
SAFETY SWITCH FOR APRON LIGHTING "D" AND "E" LOCATED AT EXTERIOR OF AIRPORT ELECTRICAL VAULT	WARNING ARC FLASH HAZARD APPROPRIATE PERSONAL PROTECTIVE EQUIPMENT IS REQUIRED. NOMINAL VOLTAGE: 120/240 VAC, 1-PHASE, 3-WIRE ARC FLASH BOUNDARY: 19 INCHES ARC FLASH PPE CATEGORY: 1	
MAIN DISCONNECT FOR FBO HANGAR BUILDING "B"	WARNING ARC FLASH HAZARD APPROPRIATE PERSONAL PROTECTIVE EQUIPMENT IS REQUIRED. NOMINAL VOLTAGE: 120/240 VAC, 1-PHASE, 3-WIRE ARC FLASH BOUNDARY: 19 INCHES ARC FLASH PPE CATEGORY: 1	

	ARC FLASH RISK LABEL	
EQUIPMENT	LABEL	
PANEL "A" FOR FBO HANGAR BUILDING "B"	WARNING ARC FLASH HAZARD APPROPRIATE PERSONAL PROTECT EQUIPMENT IS REQUIRED. NOMINAL VOLTAGE: 120/240 VAC, 1-PHASE, 3-WIRE ARC FLASH BOUNDARY: 19 INCHES ARC FLASH PPE CATEGORY: 1	
SNACK BAR DISTRIBUTION PANEL FOR FBO HANGAR BUILDING "B"	WARNING ARC FLASH HAZARD APPROPRIATE PERSONAL PROTECT EQUIPMENT IS REQUIRED. NOMINAL VOLTAGE: 120/240 VAC, 1-PHASE, 3-WIRE ARC FLASH BOUNDARY: 19 INCHES ARC FLASH PPE CATEGORY: 1	
OVERHAUL ROOM PANEL FOR FBO HANGAR BUILDING "B"	WARNING ARC FLASH HAZARD APPROPRIATE PERSONAL PROTECT EQUIPMENT IS REQUIRED. NOMINAL VOLTAGE: 120/240 VAC, 1-PHASE, 3-WIRE ARC FLASH BOUNDARY: 19 INCHES ARC FLASH PPE CATEGORY: 1	
FUEL FACILITY PANELBOARD FED FROM FBO MAIN DISTRIBUTION PANEL	WARNING ARC FLASH HAZARD APPROPRIATE PERSONAL PROTECT EQUIPMENT IS REQUIRED. NOMINAL VOLTAGE: 120/240 VAC, 1-PHASE, 3-WIRE ARC FLASH BOUNDARY: 19 INCHES ARC FLASH PPE CATEGORY: 1	
LOAD CENTER FOR HANGAR "D1" AND HANGAR "D2" FEEDERS LOCATED AT EXTERIOR OF FBO HANGAR BUILDING "B"	WARNING ARC FLASH HAZARD APPROPRIATE PERSONAL PROTECT EQUIPMENT IS REQUIRED. NOMINAL VOLTAGE: 120/240 VAC, 1-PHASE, 3-WIRE ARC FLASH BOUNDARY: 19 INCHES ARC FLASH PPE CATEGORY: 1	
BUILDING "C" MAIN DISCONNECTING MEANS AND PANELS	WARNING ARC FLASH HAZARD APPROPRIATE PERSONAL PROTECT EQUIPMENT IS REQUIRED. NOMINAL VOLTAGE: 120/240 VAC, 1-PHASE, 3-WIRE ARC FLASH BOUNDARY: 19 INCHES ARC FLASH PPE CATEGORY: 1	
BUILDING "D1" T-HANGAR PANELBOARD	WARNING ARC FLASH HAZARD APPROPRIATE PERSONAL PROTECT EQUIPMENT IS REQUIRED. NOMINAL VOLTAGE: 120/240 VAC, 1-PHASE, 3-WIRE ARC FLASH BOUNDARY: 19 INCHES ARC FLASH PPE CATEGORY: 1	
BUILDING "D2" T-HANGAR PANELBOARD	WARNING ARC FLASH HAZARD APPROPRIATE PERSONAL PROTECT EQUIPMENT IS REQUIRED. NOMINAL VOLTAGE: 120/240 VAC, 1-PHASE, 3-WIRE ARC FLASH BOUNDARY: 19 INCHES ARC FLASH PPE CATEGORY: 1	
BUILDING "E" HANGAR MAIN DISCONNECTING MEANS	WARNING ARC FLASH HAZARD APPROPRIATE PERSONAL PROTECT EQUIPMENT IS REQUIRED. NOMINAL VOLTAGE: 120/240 VAC, 1-PHASE, 3-WIRE ARC FLASH BOUNDARY: 19 INCHES ARC FLASH PPE CATEGORY: 1	
BUILDING "E" HANGAR LOAD CENTER	WARNING ARC FLASH HAZARD APPROPRIATE PERSONAL PROTECT EQUIPMENT IS REQUIRED. NOMINAL VOLTAGE: 120/240 VAC, 1-PHASE, 3-WIRE ARC FLASH BOUNDARY: 19 INCHES ARC FLASH PPE CATEGORY: 1	
BUILDING "F" HANGAR PANEL 1	WARNING ARC FLASH HAZARD APPROPRIATE PERSONAL PROTECT EQUIPMENT IS REQUIRED. NOMINAL VOLTAGE: 120/240 VAC, 1-PHASE, 3-WIRE	

- ARC FLASH RISK LABELS ARE BASED ON FAULT CURRENT FROM UTILITY TRANSFORMER THAT IS LESS THAN 25,000 AMPS AT 240 VAC AT EACH RESPECTIVE PIECE OF EQUIPMENT.
- 2. FAULT CURRENT INFORMATION TO BE PROVIDED BY SERVING ELECTRIC UTILITY COMPANY OR FROM DATA OBTAINED FROM UTILITY TRANSFORMER NAMEPLATE. CONTACT PROJECT ENGINEER TO CONFIRM FAULT CURRENT CALCULATIONS.
- 3. CONTRACTOR SHALL PROVIDE APPROPRIATE LABELS ON ELECTRICAL EQUIPMENT, IN ACCORDANCE WITH NFPA 70E ARTICLE 130 WORK INVOLVING ELECTRICAL HAZARDS, PART 130.5 ARC FLASH RISK ASSESSMENT, (H) EQUIPMENT LABELING. WHERE MAXIMUM CALCULATED FAULT CURRENT EXCEEDS 25,000 AMPS CONTACT PROJECT ENGINEER.
- 4. ALL LABELING WILL BE CONSIDERED INCIDENTAL TO THE RESPECTIVE ELECTRIC SLIDE GATE WORK PAY ITEM OR OTHER ELECTRICAL WORK PAY ITEM.



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Illinois Licensed Professional Service Corporation #184-001084





DATE SIGNED: 11/17/23 LICENSE EXPIRES: 11/30/25

RECONSTRUCT WEST AIRCRAFT T-HANGAR AREA PAVEMENTS

IDA No: MTO-4816 SBG Project No: N/A

Contract No. CO072

NO. DATE DESCRIPTION DES DWN REV ISSUE: 11/17/2023 PROJECT NO: 22A0001D

CAD FILE: E-609.DWG DESIGN BY: KNL 09/27/2023

DRAWN BY: CWS 09/27/2023 REVIEWED BY: KNL 11/13/2023

SHEET TITLE

ARC FLASH RISK LABELS SHEET 1

ARC FLASH RISK LABEL		
EQUIPMENT	LABEL	
BUILDING "F" HANGAR PANEL 2	WARNING ARC FLASH HAZARD APPROPRIATE PERSONAL PROTECTIVE EQUIPMENT IS REQUIRED. NOMINAL VOLTAGE: 120/240 VAC, 1-PHASE, 3-WIRE ARC FLASH BOUNDARY: 19 INCHES ARC FLASH PPE CATEGORY: 1	
BUILDING "F" HANGAR PANEL 3	WARNING ARC FLASH HAZARD APPROPRIATE PERSONAL PROTECTIVE EQUIPMENT IS REQUIRED. NOMINAL VOLTAGE: 120/240 VAC, 1-PHASE, 3-WIRE ARC FLASH BOUNDARY: 19 INCHES ARC FLASH PPE CATEGORY: 1	
SNOW REMOVAL EQUIPMENT BUILDING MAIN DISCONNECTING MEANS	WARNING ARC FLASH HAZARD APPROPRIATE PERSONAL PROTECTIVE EQUIPMENT IS REQUIRED. NOMINAL VOLTAGE: 120/240 VAC, 1-PHASE, 3-WIRE ARC FLASH BOUNDARY: 19 INCHES ARC FLASH PPE CATEGORY: 1	
SNOW REMOVAL EQUIPMENT BUILDING MAIN DISTRIBUTION PANEL "A"	WARNING ARC FLASH HAZARD APPROPRIATE PERSONAL PROTECTIVE EQUIPMENT IS REQUIRED. NOMINAL VOLTAGE: 120/240 VAC, 1-PHASE, 3-WIRE ARC FLASH BOUNDARY: 19 INCHES ARC FLASH PPE CATEGORY: 1	
SNOW REMOVAL EQUIPMENT BUILDING DISTRIBUTION PANEL "B"	WARNING ARC FLASH HAZARD APPROPRIATE PERSONAL PROTECTIVE EQUIPMENT IS REQUIRED. NOMINAL VOLTAGE: 120/240 VAC, 1-PHASE, 3-WIRE ARC FLASH BOUNDARY: 19 INCHES ARC FLASH PPE CATEGORY: 1	
EACH SAFETY SWITCH IN THE SNOW REMOVAL EQUIPMENT BUILDING (FOR HEATING EQUIPMENT)	WARNING ARC FLASH HAZARD APPROPRIATE PERSONAL PROTECTIVE EQUIPMENT IS REQUIRED. NOMINAL VOLTAGE: 120/240 VAC, 1-PHASE, 3-WIRE ARC FLASH BOUNDARY: 19 INCHES ARC FLASH PPE CATEGORY: 1	

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- 4. ALL LABELING WILL BE CONSIDERED INCIDENTAL TO THE RESPECTIVE ELECTRIC SLIDE GATE WORK PAY ITEM OR OTHER ELECTRICAL WORK PAY ITEM.



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Illinois Licensed Professional Service Corporation #184-001084

COLES COUNTY AIRPORT AUTHORITY


COVERING ELECTRICAL DESIGN LIGHTFOOT 062-047643

DATE SIGNED: 11/17/23 LICENSE EXPIRES: 11/30/25

RECONSTRUCT WEST AIRCRAFT T-HANGAR AREA PAVEMENTS

IDA No: MTO-4816 SBG Project No: N/A

Contract No. CO072

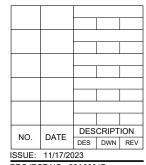

PROJECT NO: 22A0001D

CAD FILE: E-609.DWG DESIGN BY: KNL 09/27/2023 DRAWN BY: CWS 09/27/2023

REVIEWED BY: KNL 11/13/2023

SHEET TITLE

ARC FLASH RISK LABELS SHEET 2