

- 6 EX. STORM CATCHBASIN
RIM: 688.45 INV: UNKNWN
STA: 106+05 O/S: 16.8'R
- 7 EX. 12" FLARED END SECTION
INV: 687.14
STA: 106+04 O/S: 19.4'L
- 8 EX. STORM CATCHBASIN
RIM: 688.57 INV: 686.82
STA: 106+11 O/S: 17.8'R
TO BE REMOVED
- 9 EX. 10" END SECTION
INV: 687.72
STA: 106+11 O/S: 21.2'L
- 10 EX. STORM CATCHBASIN
RIM: 692.46 INV: 688.26
STA: 109+79 O/S: 18.8'R
TO BE ADJUSTED
- 4 EXISTING SANITARY MANHOLE
RIM: 689.21 INV: 679.31
STA: 106+53 O/S: 22.9'R
- 3 STORM SEWER CATCHBASIN
TY 'C' 48" TY 'B' GRATE
WITH 6" FLAT TOP
RIM: 688.10 INV: 686.00
STA: 106+12 O/S: 28.8'R
- 4 FLARED END SECTION
15" RCP INV: 685.50
STA: 106+11 O/S: 21.2'L
- 2 50 LF 15" SS, CL. A. TY 2, @ 1.00% TBF 7.38 CY
- x1 STORM OVER SANITARY
B/STORM = 686.05
T/SANITARY = 679.75
- x2 STORM OVER WATER
B/STORM = 685.40
T/WATER = 683.90


DRAINAGE & UTILITY PLAN LEGEND

- 10 EXISTING SANITARY STRUCTURE
- 10 EXISTING SANITARY SEWER
- 10 EXISTING WATERMAIN STRUCTURE
- W EXISTING WATERMAIN
- 10 EXISTING STORM SEWER STRUCTURE
- 10 EXISTING STORM SEWER
- 10 PROPOSED STORM SEWER STRUCTURE
- 10 PROPOSED STORM SEWER PIPE
- 10 PROPOSED STORM SEWER FLARED END SECTION
- PROPOSED STORM SEWER CATCHBASIN
- PROPOSED STORM SEWER INLET
- x1 PROPOSED UTILITY CROSSING

PLAN & PROFILE LEGEND

- HOT-MIX ASPHALT SURFACE COURSE, MIX "D", N50
- HOT-MIX DRIVEWAY PAVEMENT, 3"
- BRICK DRIVEWAY REMOVAL & REPLACEMENT
- AGGREGATE SHOULDERS (SPECIAL)
- HOT-MIX ASPHALT SURFACE REMOVAL - BUTT JOINT
- PERIMETER EROSION BARRIER

WILMOT ROAD

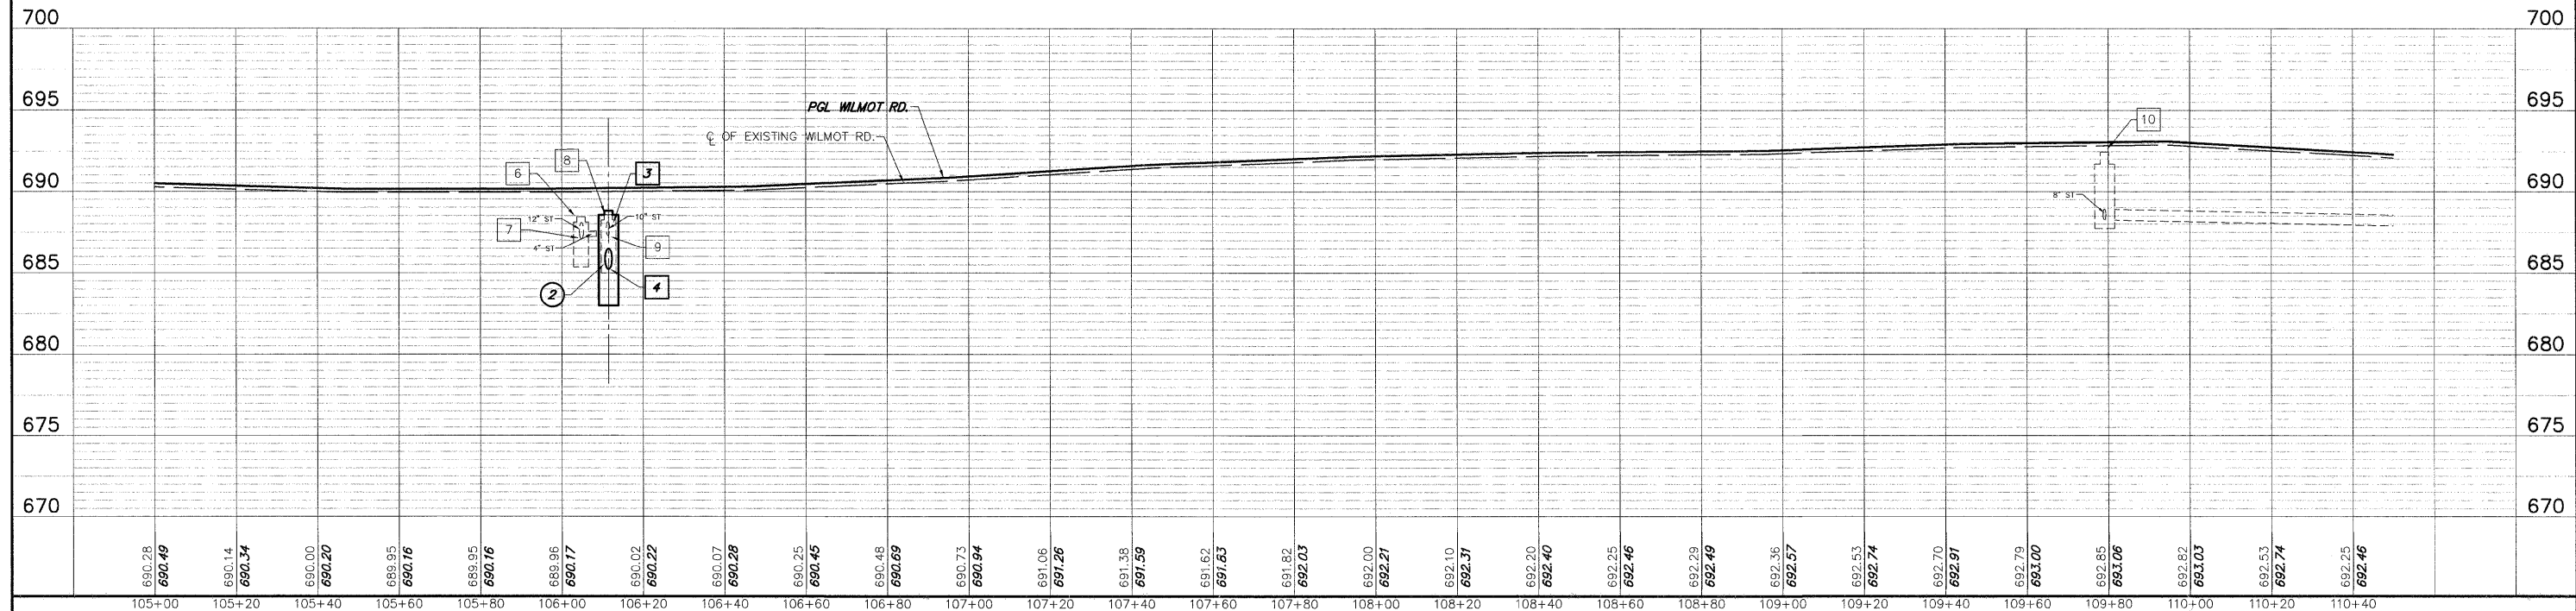

FILE NAME = 8101-055 PR4.DWG	USER NAME = GW3	DESIGNED - DJG	REVISED - 10.14.2011	STATE OF ILLINOIS DEPARTMENT OF TRANSPORTATION	PROPOSED PLAN & PROFILE			FAU. RTE 2718	SECTION 11-00012-00-RS	COUNTY LAKE	TOTAL SHEETS 40	SHEET NO. 12	
	PLOT SCALE = 1:1	DRAWN - GW3	REVISED - 10.28.2011		SCALE 1"=20'	SHEET NO. 12 OF 40 SHEETS	STA. 105+00 TO STA. 110+50	CONTRACT #:		63646			
	PLOT DATE = 8/24/2011	CHECKED - DJG	REVISED -		ILLINOIS FED. AID PROJECT								
		DATE - 08.24.2011	REVISED -										