
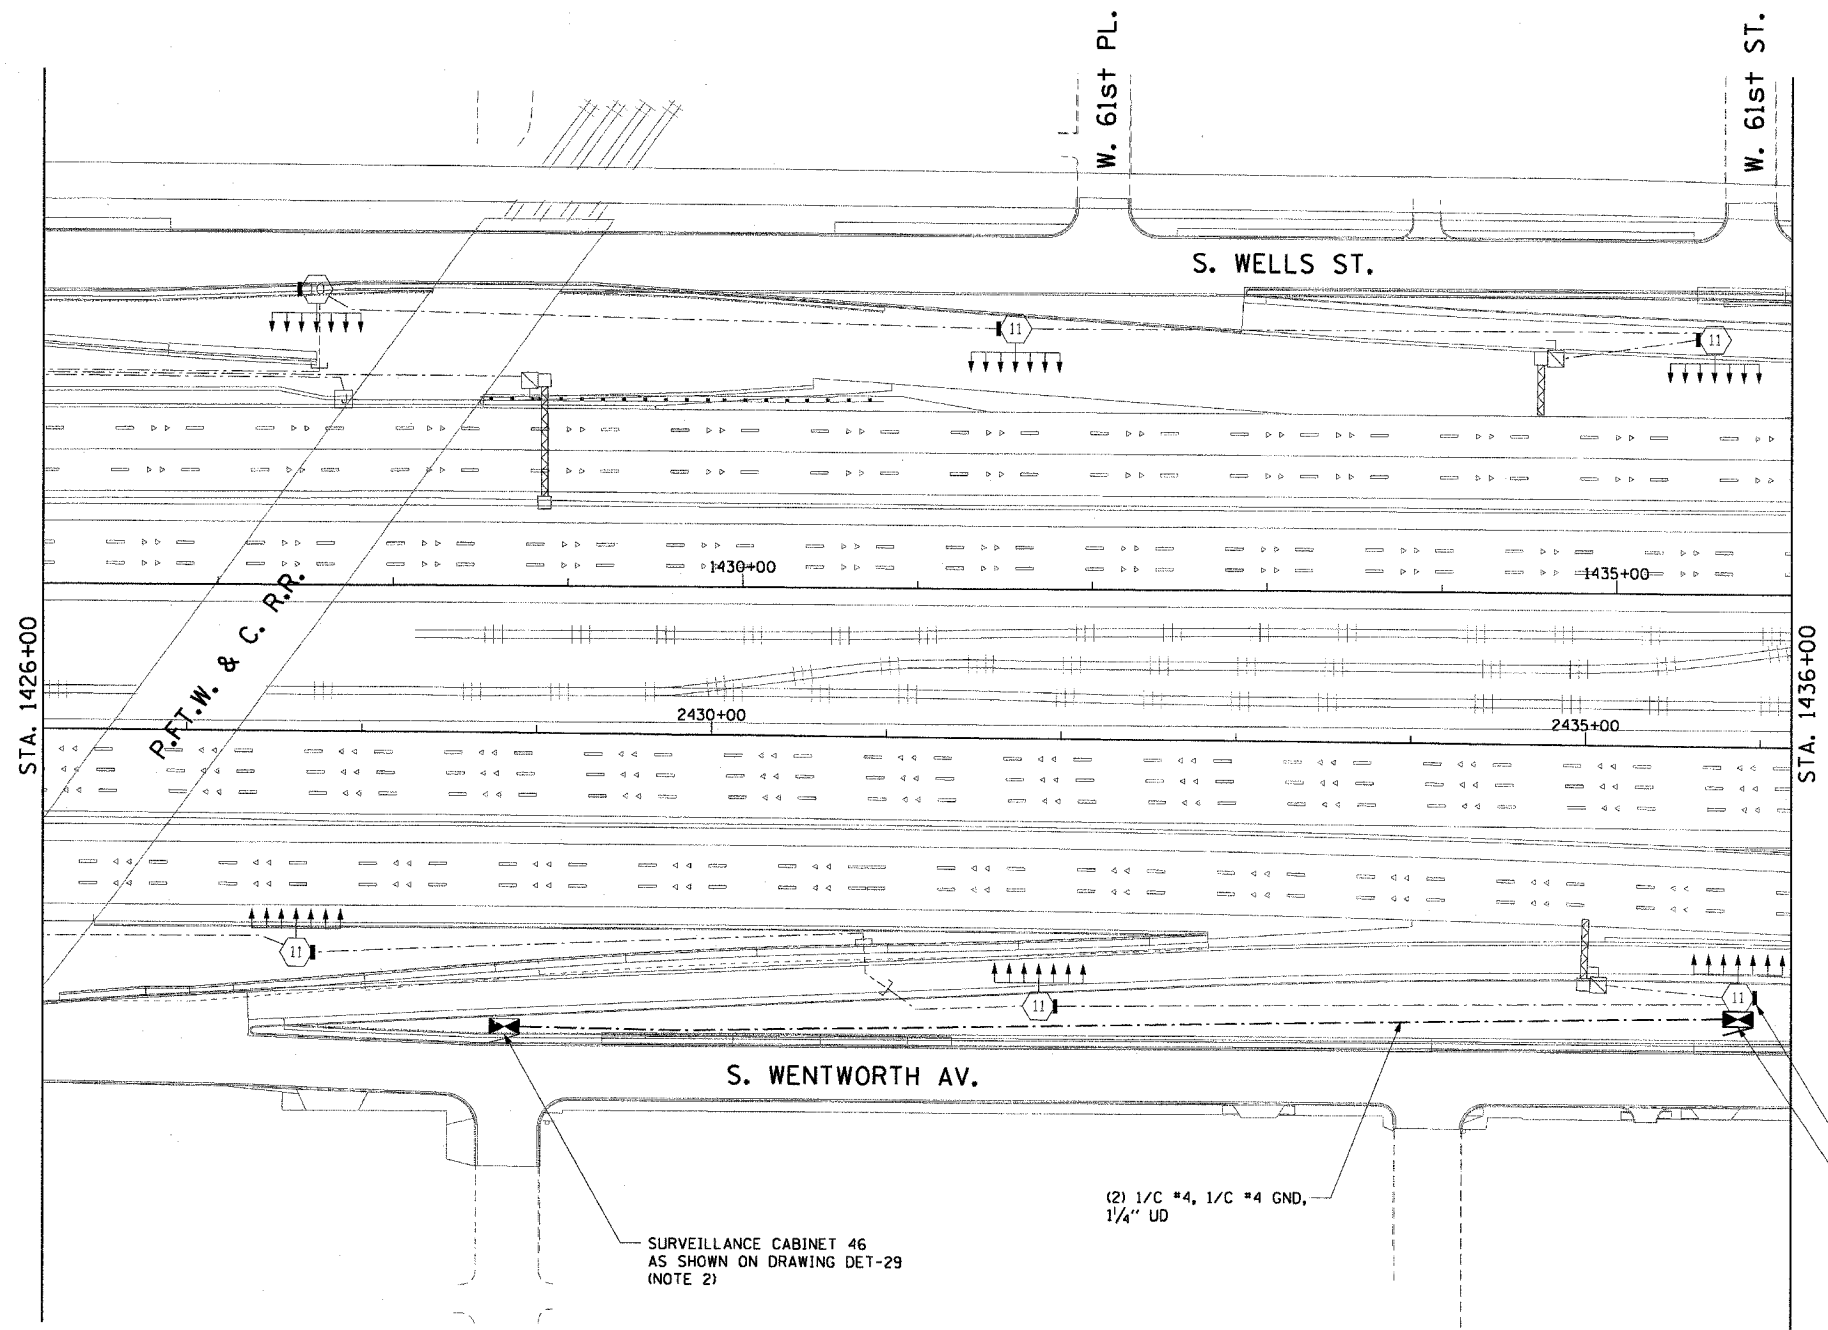


F.A.I. RTE.	SECTION	COUNTY	TOTAL SHEETS	SHEET NO.
90/94	2003-0311	COOK	976	492
STA. 1426+00.00		TO STA. 1436+00.00		
FED. ROAD DIST. NO. 1		ILLINOIS	FED. AID PROJECT	

62583

NOTES:

1. SEE DRAWINGS ME-01 AND ME-02 FOR ELECTRICAL SYMBOLS AND ABBREVIATIONS.
2. CONTRACTOR SHALL CONNECT CAMERA POWER FEED TO TERMINAL BLOCK TWO IN IDOT SURVEILLANCE CABINET 46 AS SHOWN ON DRAWING DT-36.
3. CONTRACTOR SHALL COIL A MINIMUM OF 20 FEET OF 120 VOLT POWER CABLE AT THE BASE OF THE LIGHT TOWER FOR FUTURE CCTV CAMERA.
4. SEE DRAWING COMM-29 FOR CCTV COMMUNICATIONS SYSTEM CONDUIT AND CABLE LAYOUT.
5. SEE DRAWING DT-17 FOR CCTV CABINET MOUNTING DETAILS ON A HIGH-MAST LIGHT TOWER.
6. THIS SHEET ONLY DEPICTS INSTALLATION OF CLOSED CIRCUIT TELEVISION SYSTEM. LIGHTING SYSTEM IS SHOWN FOR INFORMATION ONLY AND SHOULD BE INSTALLED AS SHOWN ON THE LIGHTING PLANS.

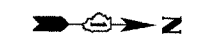

SURVEILLANCE CABINET 46
AS SHOWN ON DRAWING DET-29
(NOTE 2)

(2) 1/C #4, 1/C #4 GND,
1/4" UD

FUTURE CCTV CAMERA
LOCATION
(NOTES 3, 4)

INSTALL CCTV CABINET "DR-60" (NOTE 5)
TOWER 7 SGH4



CCTV-20

CTE ENGINEERS
CONSOER TOWNSEND ENGINEERS, INC.
303 EAST WACKER DRIVE, SUITE 600
CHICAGO, ILLINOIS 60601-5202, PHONE: (312) 938-0300

REVISIONS	
NAME	DATE

ILLINOIS DEPARTMENT OF TRANSPORTATION
F.A.I. 90/94 (DAN RYAN EXPRESSWAY)
31st STREET TO I-57

**CLOSED CIRCUIT TELEVISION
SITE LAYOUT
CAMERA DR-60**

SCALE: 1"=50'
DATE: October 29, 2004

DRAWN BY: HAR
CHECKED BY: BMW

10/15/2004 08:44:19 AM