










LEGEND

-  WORK AREA
-  IMPACT ATTENUATORS, TEMPORARY (NON-REDIRECTIVE) TEST LEVEL 3
-  TYPE III BARRICADE
-  TEMPORARY CONCRETE BARRIER
-  DRUM WITH STEADY BURN MONODIRECTIONAL LIGHT / DIRECTION INDICATOR BARRICADE WITH STEADY BURN MONODIRECTIONAL LIGHT (PER HWY. STD. 701321-10)
-  SIGN
-  DETECTOR LOOPS
-  TRAFFIC SIGNAL
-  DOUBLE VERTICAL PANELS

PRESTAGE CONSTRUCTION:

1. CONSTRUCT 5' TEMPORARY PAVEMENT ON THE WEST SIDE BETWEEN STA. 1259+98 TO STA. 1264+09 AND STA. 1265+70 TO STA. 1270+57 TO PROVIDE A MINIMUM 12'6" STAGE LANE WIDTH AS SHOWN IN THE PLANS. THIS WORK SHALL BE PERFORMED IN ACCORDANCE WITH HIGHWAY STANDARD 701326.



STAGE I CONSTRUCTION

1. REMOVE WEST SIDE EXISTING PAVEMENT MARKING EDGE LINE AND CENTER LINE IMMEDIATELY PRIOR TO BARRIER WALL PLACEMENT IN ACCORDANCE WITH HIGHWAY STANDARD 701201.
2. CLOSE EAST HALF OF IL 82 IN ACCORDANCE WITH HIGHWAY STANDARD 701321 AND AS SHOWN IN PLANS.
3. PERFORM EAST HALF STRUCTURAL, ROADWAY, AND SHOULDER RECONSTRUCTION.
4. APPLY TEMPORARY PAVEMENT MARKINGS FOR USE WITH STAGE 2 AS SHOWN IN THE PLANS.


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
1. ALL SIGNS SHALL BE MOUNTED WITH MONODIRECTIONAL FLASHING BEACONS.
2. SEE HIGHWAY STANDARD 701321 FOR PLACEMENT OF TRAFFIC SIGNAL DETECTOR LOOPS.

SEQUENCE OF OPERATIONS									
PHASE	A	B	C						
INTERVAL	1	2	3	4	5	6	7	8	9
NORTHBOUND	G	Y	R	R	R	R	R	R	R
SOUTHBOUND	R	R	R	G	Y	R	R	R	R

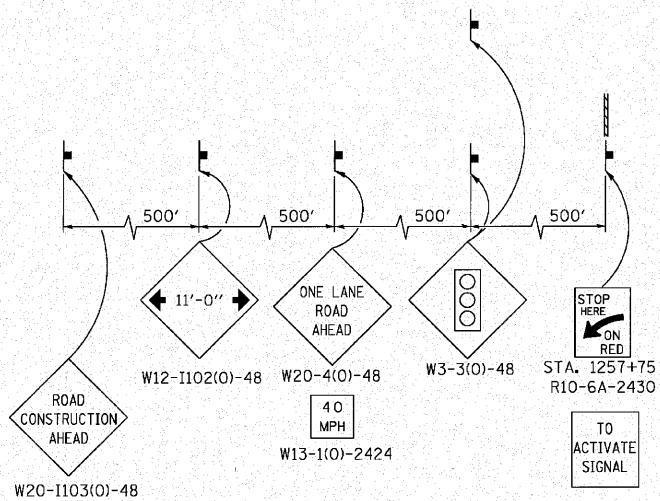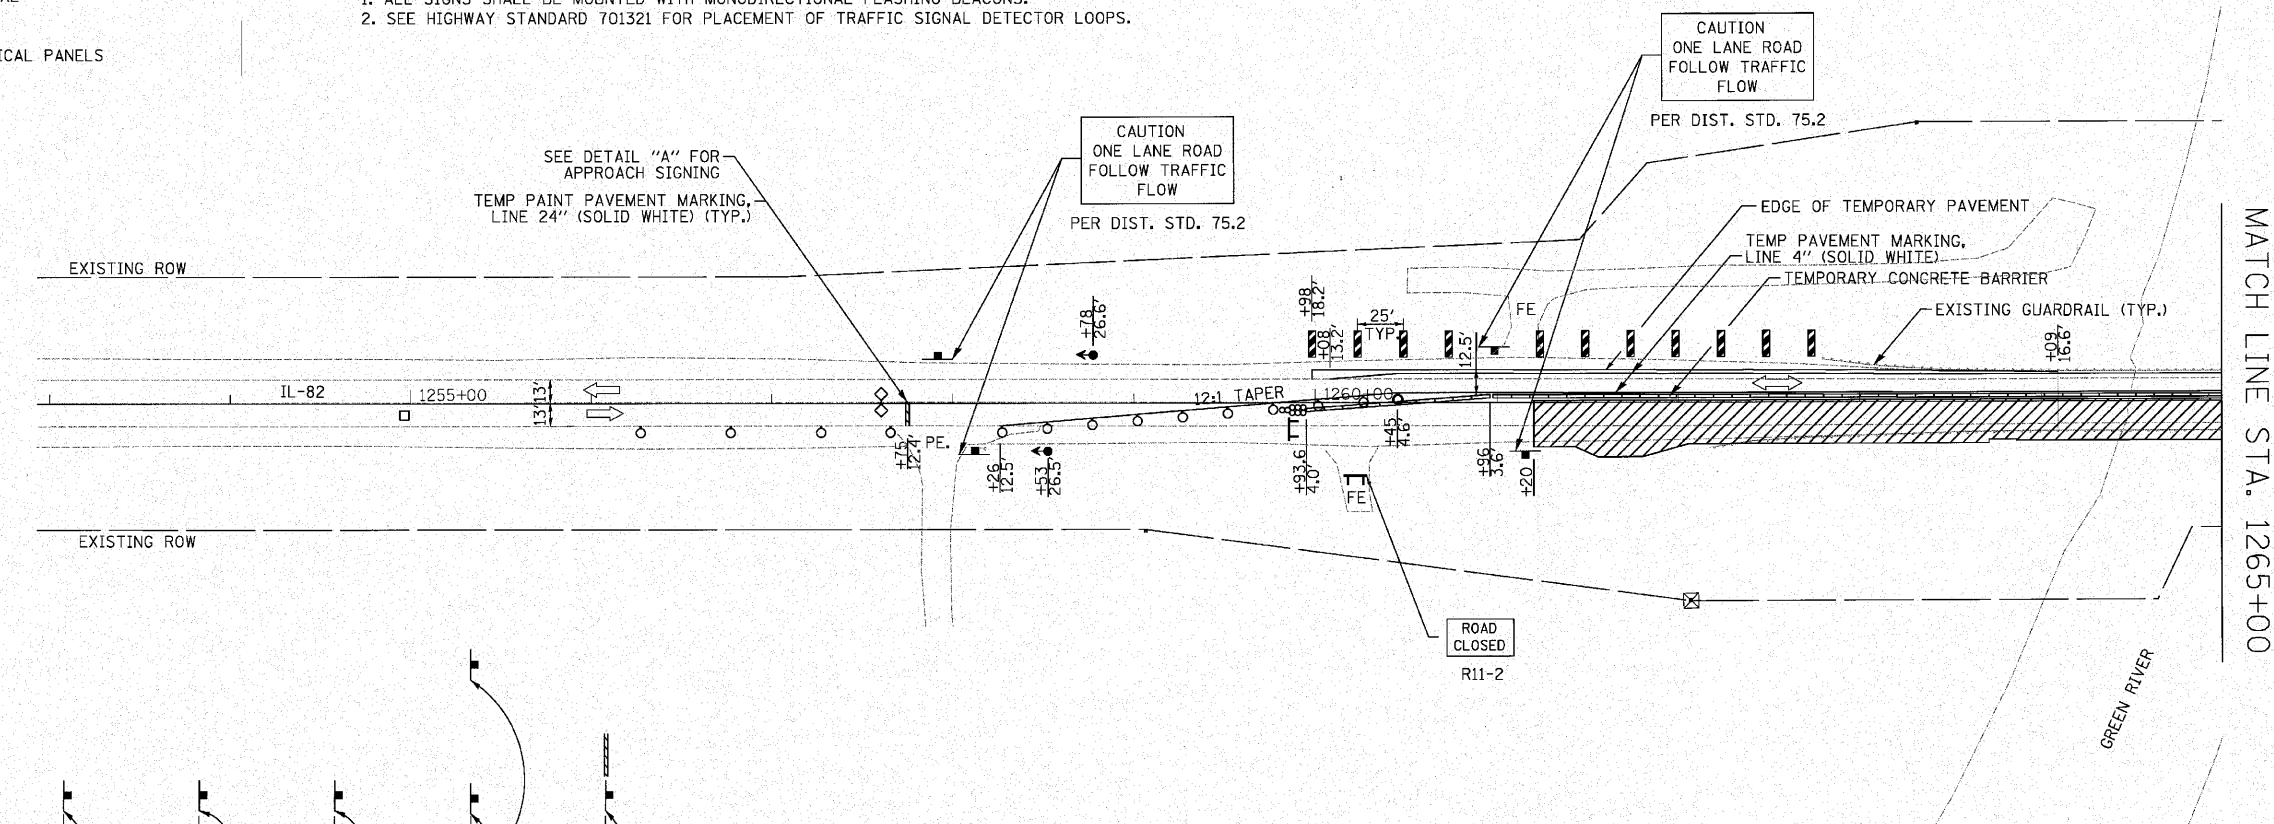

DETAIL "A"

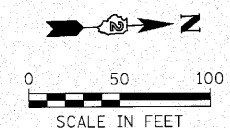

	USER NAME = #USER*	DESIGNED - CRV	REVISED -	STATE OF ILLINOIS DEPARTMENT OF TRANSPORTATION	MAINTENANCE OF TRAFFIC PLAN - STAGE 1 IL 82 OVER GREEN RIVER			F.A.P. RTE.	SECTION	COUNTY	TOTAL SHEETS	SHEET NO.	
	PLOT SCALE = #SCALE*	DRAWN - CRV	REVISED -		638	129BR-4	HENRY	93	17				
	PLOT DATE = #DATE*	CHECKED - ST	REVISED -		SCALE: 1" = 50'			SHEET NO. 1 OF 2 SHEETS		STA. 1253+00 TO STA. 1265+00		CONTRACT NO. 64D25	
		DATE - 07/2010	REVISED -		ILLINOIS FED. AID PROJECT								